






215 GOLD AVENUE S.W. ALBUQUERQUE, NEW MEXICO

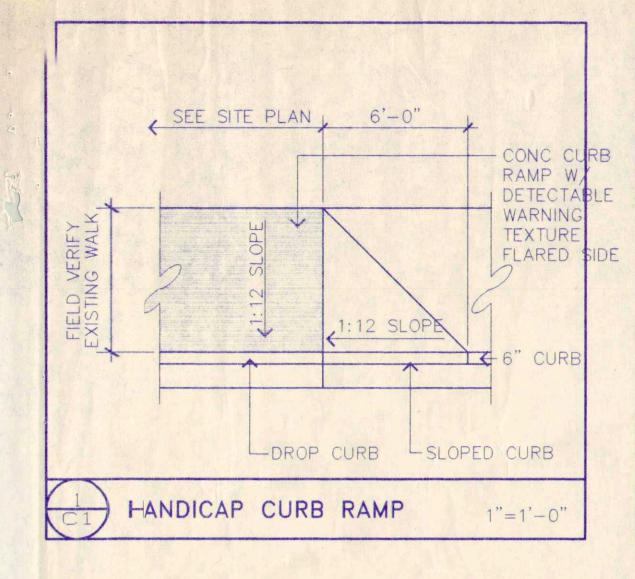

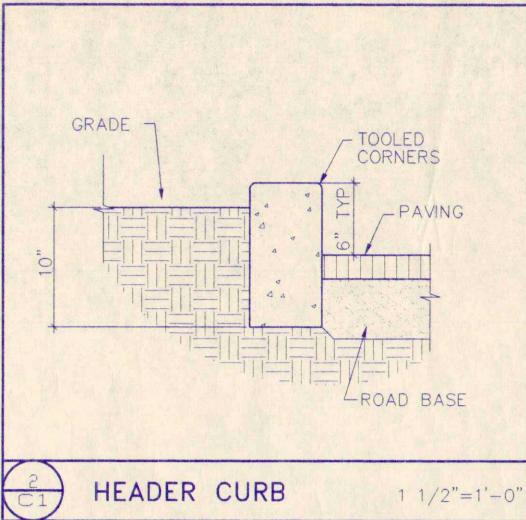

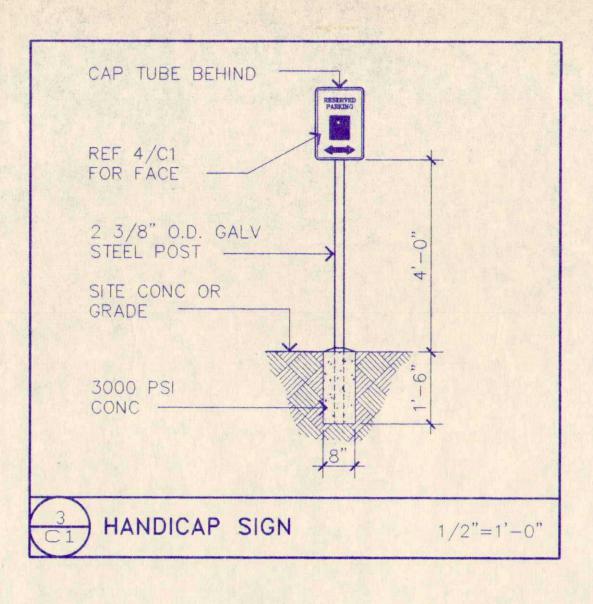

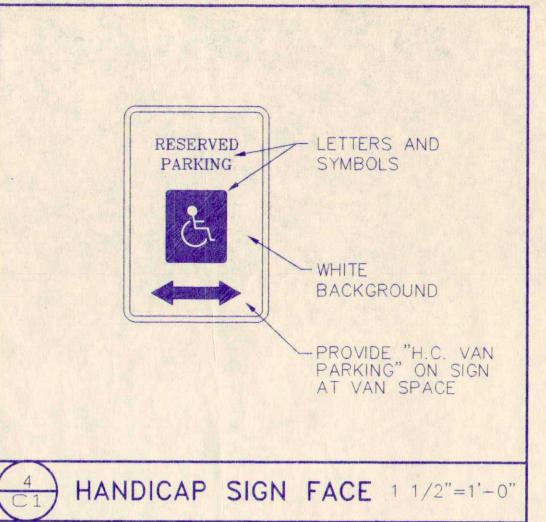


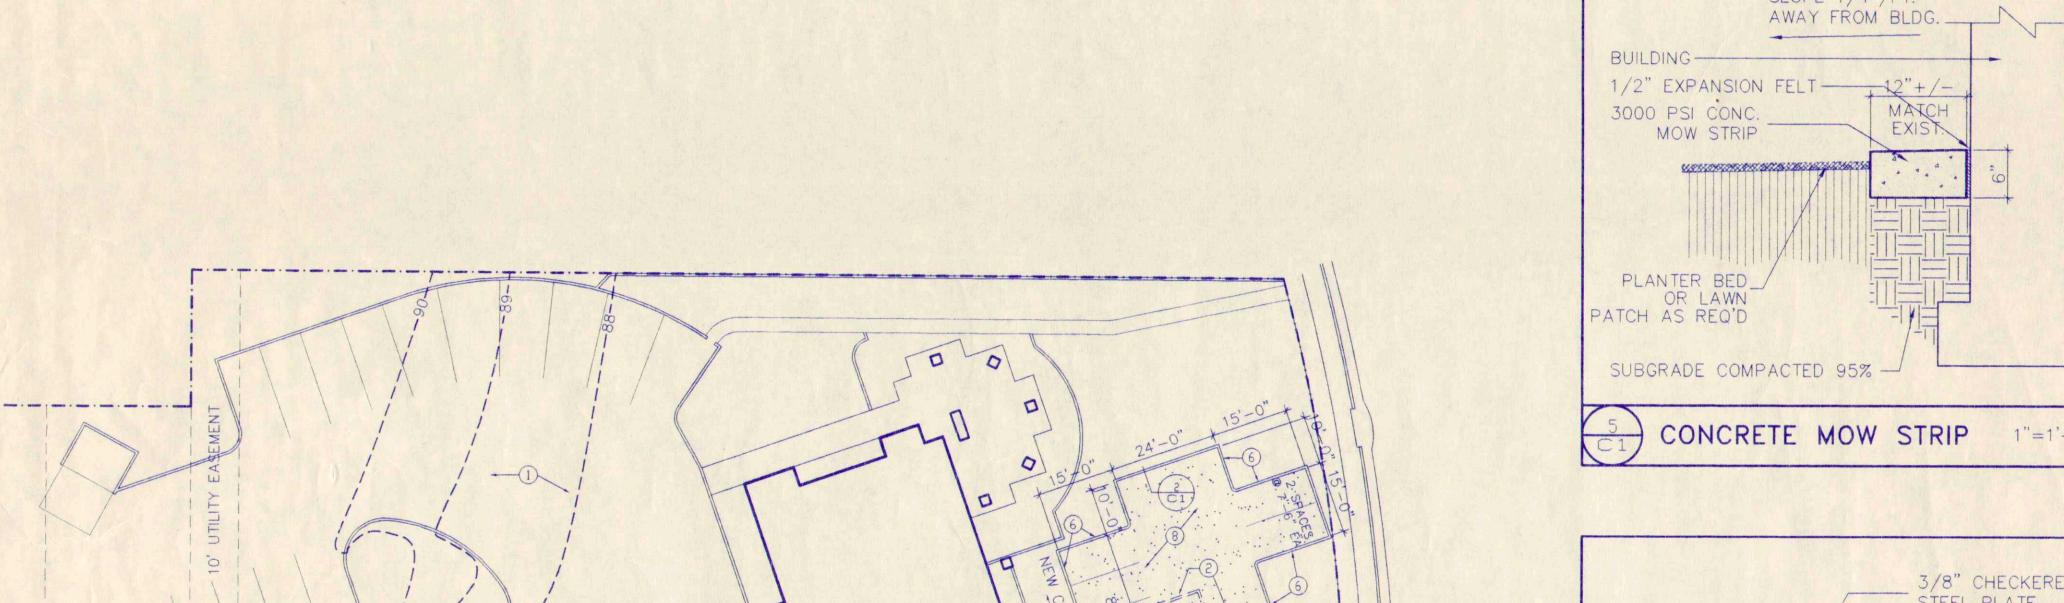



EXISTING FIRE STATION

NO. 13 (F.F. 5187.70)

7' UTILITY EASEMENT

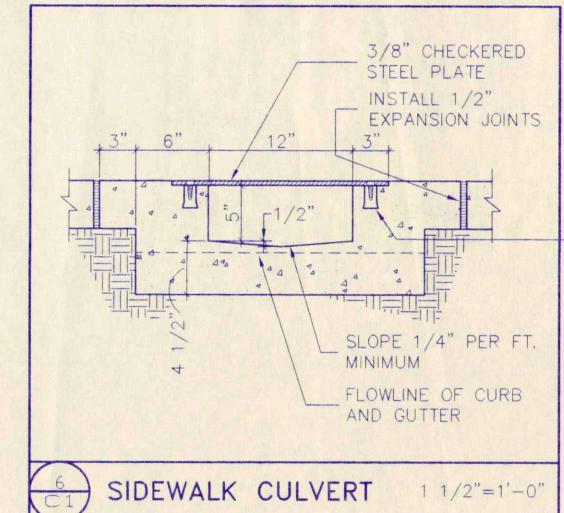

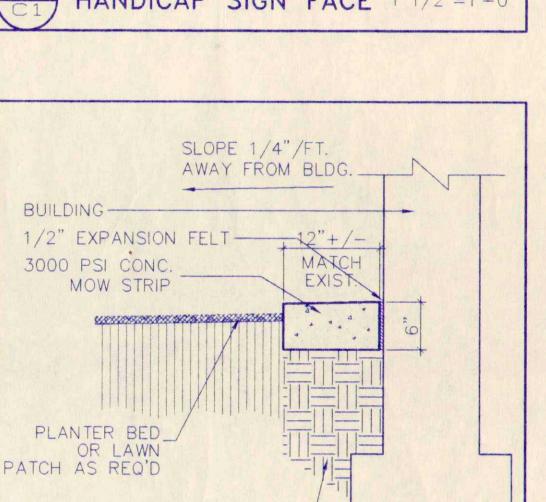

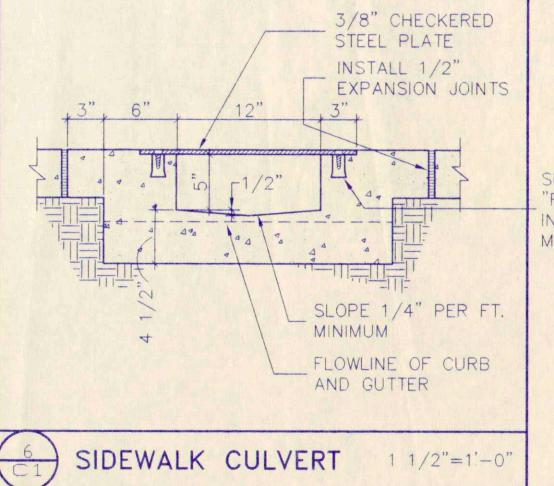

BUILDING CRITERIA

PROJECT: ADDITION TO FIRE MARSHAL'S OFFICE ADDRESS: 2510 QUINCY N.E. LEGAL: LOTS 1-B-7, BLOCK 1, VIDAS ADDITION OCCUPANCY TYPE: CONSTRUCTION TYPE: VN

BUILDING AREA

EXISTING BUILDING (REMODEL): NEW BUILDING (ADDITION):	2,334 S.F 1,525 S.F
TOTAL AREA:	3,859 S.F
ALLOWABLE AREA (TABLE #5-C, UBC)	8,000 S.F

OCCUPANT LOAD

EXISTING BUILDING (REMODEL) OFFICE SPACE - 1600 S.F./100 CONFERENCE ROOM - 384 S.F./15	16 26
NEW BUILDING (ADDITION) OFFICE SPACE - 1,329 S.F./100	14
TOTAL OCCUPANT LOAD	56

PARKING REQUIREMENTS

EXISTING BUILDING (REMODEL) FIRE MARSHAL OFFICE - 1,996 S.F./200 FIRE STATION BUILDING - NEW BUILDING (ADDITION) - 1,329 S.F./200	10 SPACES 23 SPACES 7 SPACES
TOTAL PARKING REQUIRED	40 SPACES

PARKING	PROVIDED			
	EXISTING SP.	ACES -		
	ADDITIONAL	SPACES	PROVIDED	Name of the last

33 SPACES 7 SPACES

40 SPACES

TOTAL PARKING PROVIDED

27 REGULAR 11 SMALL CAR 1 HANDICAP (CAR) 1 HANDICAP (VAN)

SECURE STEEL PLATE WITH 1" X 5" S.S. ROD ANCHOR. "RED HEAD" MULTI-SET II SRM-38 ANCHOR OR EQUAL. INSTALL PER MANUF. DIRECTIONS AT MAX. 24" O.C.. A MINIMUM OF 2 PER SIDE AND ONE WITHIN 6" OF EACH END.

PARKING SPACE BREAKDOWN

O GRADING KEYED NOTES

- 1. EXISTING ASPHALT PARKING AREA TO REMAIN.
- 2. EXISTING CURB TO BE REMOVED SHOWN DASHED. REMOVE ADDITIONAL +/- 24" OF EXISTING ASPHALT AND PREPARE FOR NEW ASPHALT PAVING.
- 3. EXISTING CONCRETE RAMP AND CURB TO BE REMOVED.
- 4. REMOVE PORTION OF EXISTING CONCRETE WALK AND CONSTRUCT H.C. RAMP AND CURB CUT PER DETAIL THIS SHEET. (4) 5. EXISTING ASPHALT PAVING TO REMAIN - RESTRIPE AS SHOWN.
- 6. NEW CONCRETE HEADER CURB, SEE DETAIL THIS SHEET.
- 7. EXISTING CONCRETE CURB TO REMAIN. SAW-CUT EXISTING CURB AT REMOVAL LOCATIONS.
- 8. NEW ASPHALT PAVING TO MATCH EXISTING. FEATHER NEW ASPHALT TO EXISTING.
- 9. EXISTING CURB CUT.
- 10. EXISTING CONCRETE WALK TO REMAIN.
- 11. NEW HANDICAP PARKING SIGNAGE, SEE DETAILS (A) THIS SHEET.
- 12. EXISTING SOD AREA TO REMAIN.
- 13. REMOVE EXISTING SOD, PLANTINGS AND IRRIGATION AS REQUIRED FOR NEW CONSTRUCTION. PATCH AS REQUIRED.
- 14. NEW 4" CONCRETE SIDEWALK.
- 15. NEW CONCRETE MOW STRIP. SEE DETAIL (2) THIS SHEET.
- 16. SIDEWALK CULVERT. SEE DETAIL (THIS SHEET.
- 17. REMOVE TREE STUMP/ROOTS AS REQUIRED FOR NEW CONSTRUCTION.

08 NIM

H

525 SAN PEDRO NE. SUITE 110 ALBUQUERQUE, NM 87108 (505) 255-6400

ALBUQUERQUE

LAS CRUCES 1400 EL PASEO ROAD, SUITE A LAS CRUCES, NM 88005

(505) 523-2000



MARSHAL'S OFFICE
510 QUINCY N.E.
RQUE, NEW MEXICO


CITY FIRE

JOB NUMBER: A93.46

04/04/94

SHEET NUMBER:

C1

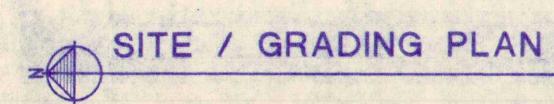

EXIST. MANHOLE
ELEV. = 5188.6 (APPROX.)
INV. ELEV. = 5180.7 (APPROX.)

EXISTING FIRE MARSHAL OFFICE (F.F. 5189.50)


ADDITION

QUINCY STREET N.E.

TO EXISTING

SCALE: 1"=20'-0"




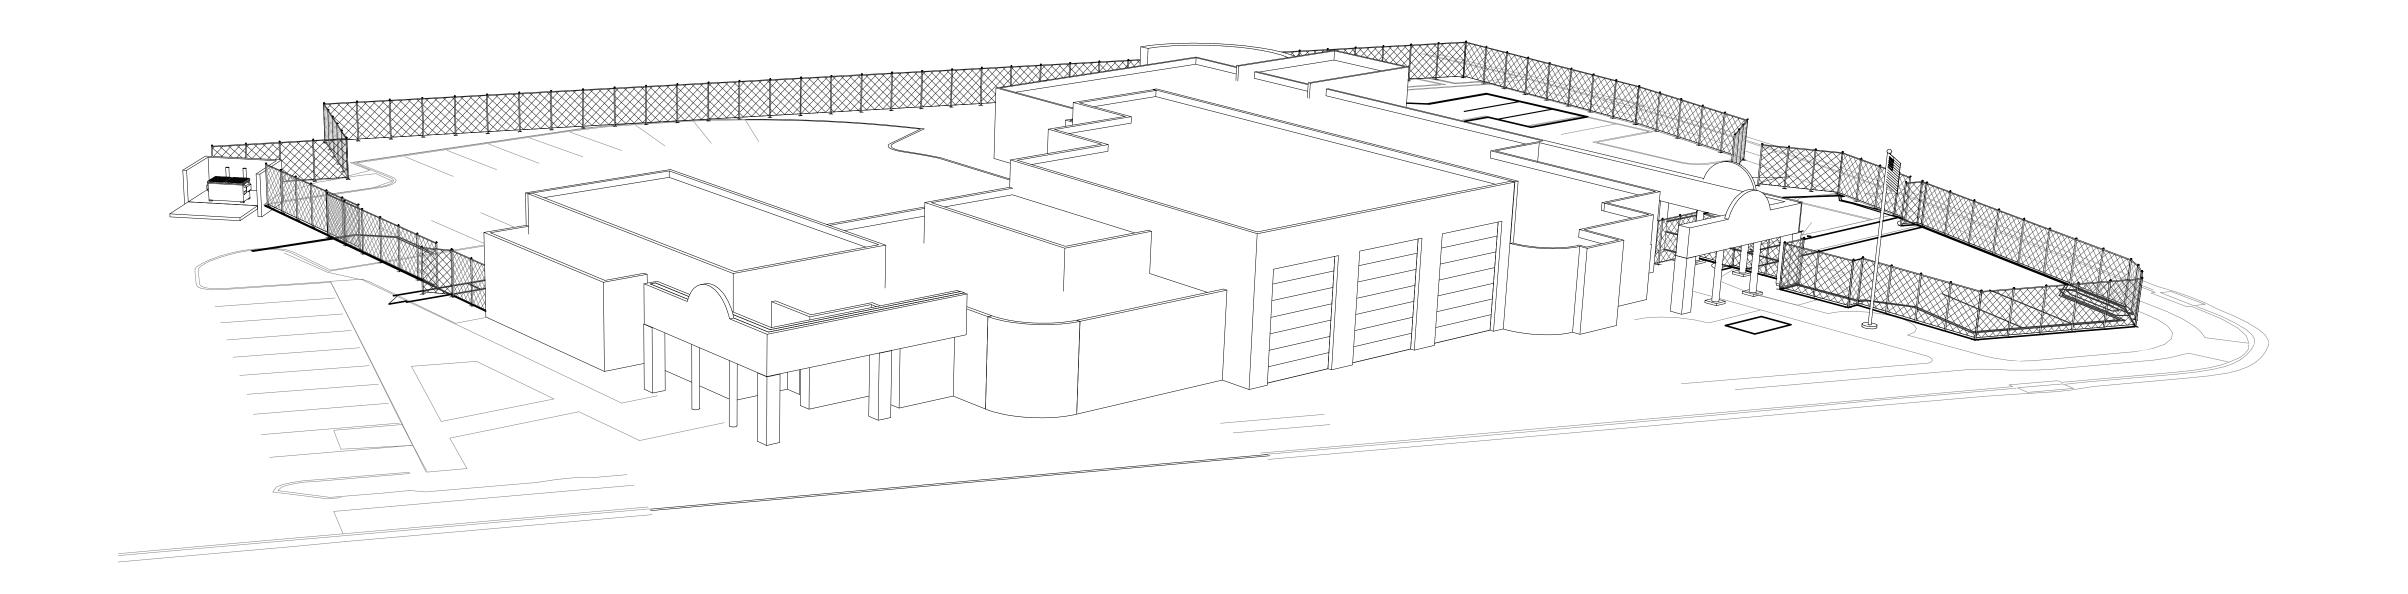




CITY OF ALBUQUERQUE DEPARTMENT OF MUNICIPAL DEVELOPMENT- Managing Department


APRIL 21, 2020 ALBUQUERQUE FIRE DEPARTMENT- Owner

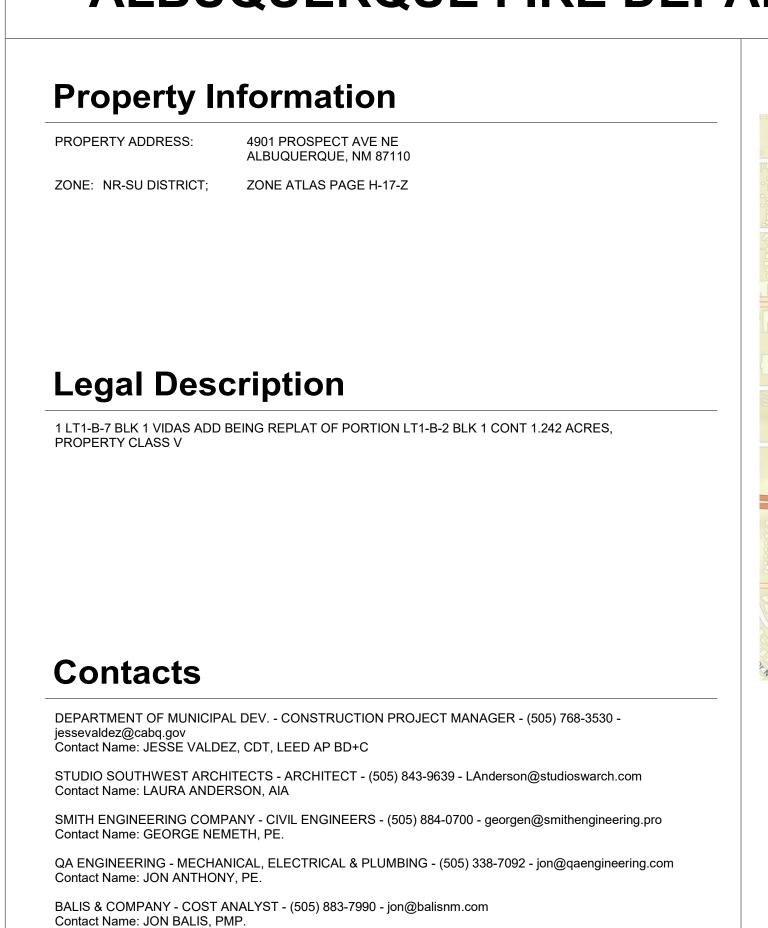

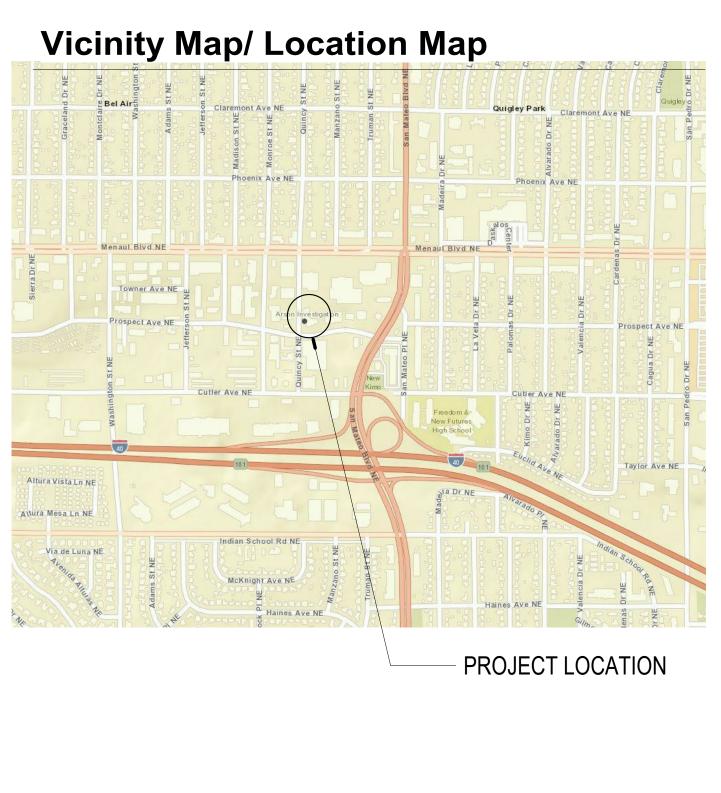


	General
G-001	COVER SHEET
	Fire
FIRE1	FIRE 1 PLAN
	Civil
C-201 C-202	SITE REMOVAL PLAN- NORTH SITE REMOVAL PLAN - SOUTH SITE LAYOUT PLAN - NORTH SITE LAYOUT PLAN - SOUTH SITE GRADING PLAN - NORTH SITE GRADING PLAN - SOUTH CIVIL DETAILS
	Architectural Site
AS102	EXISTING SITE PLAN - OVERALL DEMOLITION PLAN NEW SITE PLAN
	Electrical
_	ELECTRICAL SITE PLAN ELECTRICAL SCHEDULE

Drawing Index

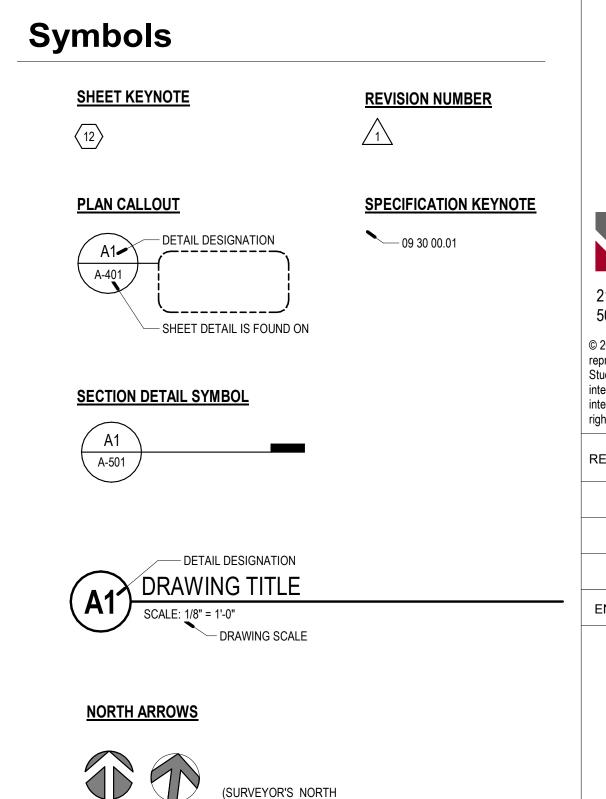

Plan North True North PLAN NORTH)

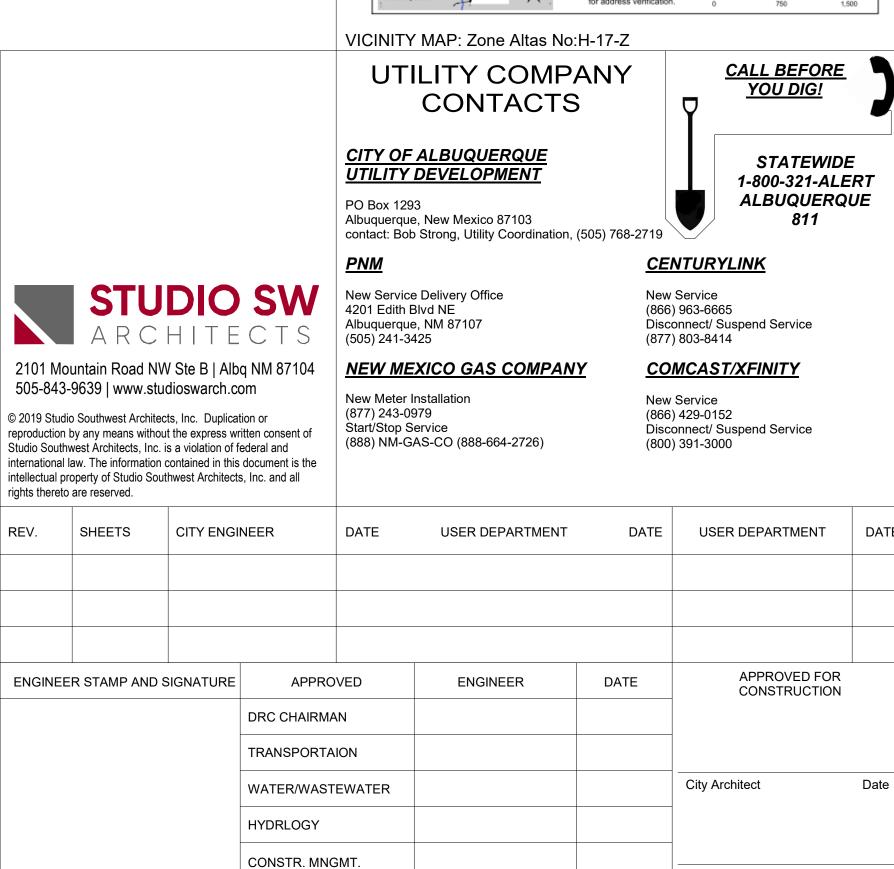

P7215.01 NTP#13

APRIL 21, 2020

H-17-Z

City Engineer

H-17-Z G-001 1 of 14

Zone Map No. DWG.


PROJECT LOCATION-

PROPERTY LINE EXISTING 30'-0" ACCESS EASEMENT ENTRANCE REMOTE ACCESS SECURITY GATE EXISTING

ARSON UNIT BUILDING EXISTING FIRE STATION 13 41'-0" EXISTING FIRE HYDRANT -PROSPECT AVE NE EXISTING FIRE HYDRANT FM Approved NEW SITE PLAN

1" = 20'-0"

GENERAL NOTES FIRE STATION 13 4901 PROSPECT AVE NE ALBUQUERQUE, NM 87110 ARSON UNIT BUILDING
3,859 SQ. FT.
OCCUPANCY GROUP: B - office
TYPE VN CONSTRUCITON
SPRINKLED ??
15'-6' BUILDING HEIGHT FIRE STATION BUILDING
9,504 SQ. FT.
OCCUPANCY GROUP - B fire station
TYPE 1b CONSTRUCITON
SPRINKLED ??
21'-4' BUILDING HEIGHT 2 EXISTING FIRE HYDRANTS NEAR SITE ALL ACCESS ROADS AND FIRE LANES HAVE GRADES LES<u>S THAN 10% AND</u> A LOAD CAPACITY OF 75,000 POUNDS. EXISTING FENCE/GATE TO REMAIN × × × × × × × NEW FENCE/GATE ___ _ EASEMENT LINE EXISTING FIRE HYDRANT © 2019 Studio Southwest Architects, Inc.
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The information contained in this document C.H. D.D. is the intellectual property of Studio Southwest Architects, Inc. and all rights thereto are reserved. 2101 Mountain Road NW Suite B | Albuquerque NM 87104 505-843-9639 | www.studioswarch.com CITY OF ALBUQUERQUE
DEPARTMENT OF MUNICIPAL DEVELOPMENT PROJECT TITLE: ABQ FIRE STATION 13 DRAWING TITLE: FIRE 1 PLANS Mo./Day/Yr. Mo./Day/Yr. City Engineer Approval Design Review Committee

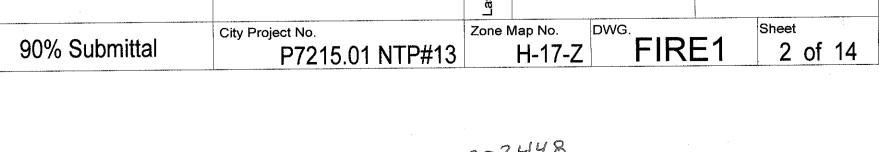

ZO-OOZUY8

HYDRANT AND FIRE ACCESS

HYDRANT AND FIRE ACCESS

ALBUQUEROUE FIRE MARSHAL'S OFFICE

ALBUQUEROUE FIRE OF HYDRANTS

SIGNATURE / MAIN NUMBER / DATE


SIGNATURE / MAIN NUMBER / DATE




△ 01 Mountain R				× × × ×		RE STATION 13 21 PROSPECT AVE BUQUERQUE, NM SON UNIT BUILDIE 59 SQ. FT. CCUPANCY GROUE PE VN CONSTRUCT RINKLED ?? -6' BUILDING HEIG 04 SQ. FT. CCUPANCY GROUE PE 1b CONSTRUCT RINKLED ?? -4' BUILDING HEIG EXISTING FIRE HYD		
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				FIELD NOTES		CONTRACTOR	DATE	
				NO. BY DATE		WORK STAKED BY	DATE	
						INSPECTOR'S ACCEPTANCE BY	DATE	
No. Date	REMARKS	By				FIELD VERIFICATION BY	DATE	
	REVISIONS					DRAWINGS CORRECTED BY	DATE	
	DESIGN					MICRO-FILM INFORMATION	ATION	
Designed By: L.A.	DATE	APRIL 21, 2020				RECORDED BY	DATE	
Drawn By: C.H.	DATE	APRIL 21, 2020				NO.		
Checked By: D.D.	DATE	APRIL 21, 2020						


DEPARTMENT OF MUNICIPAL DEVELOPMENT PROJECT TITLE: ABQ FIRE STATION 13

DRAWING TITLE:	FIRE 1 PLA	AN				
Design Review Committee	City Engineer Approval	ate	Мо	./Day/Yr.		Mo./Day/Yr.
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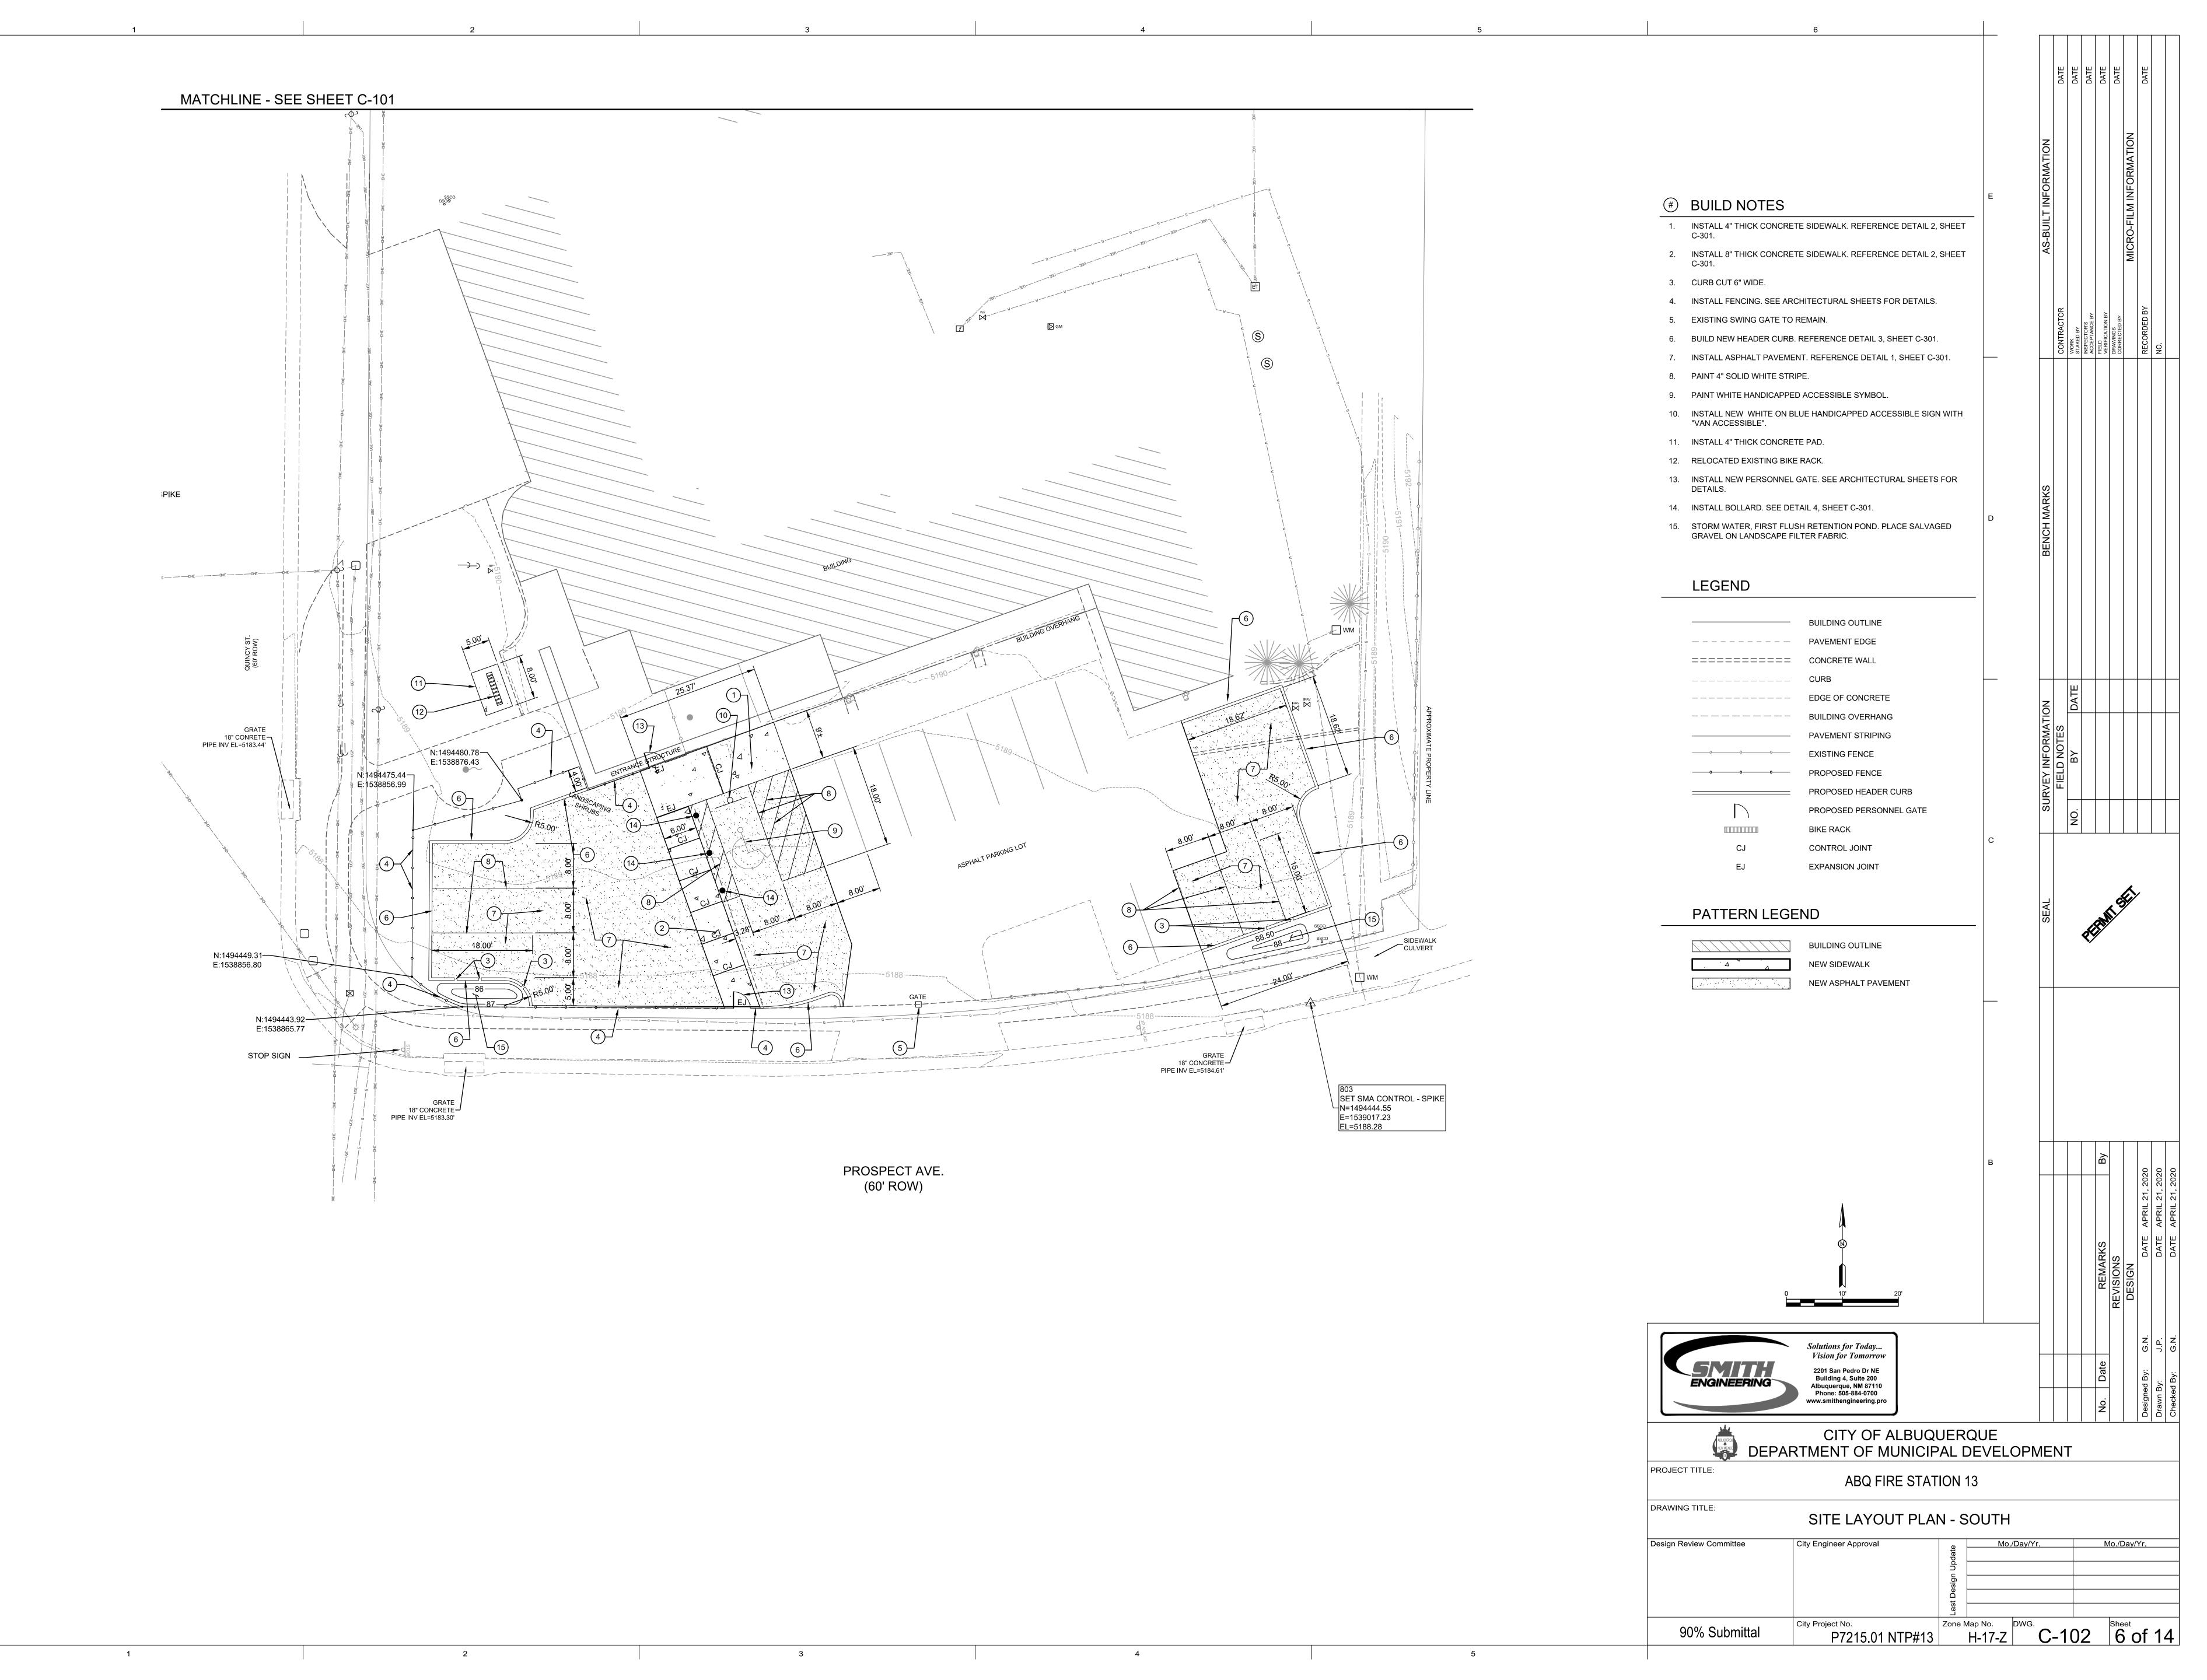


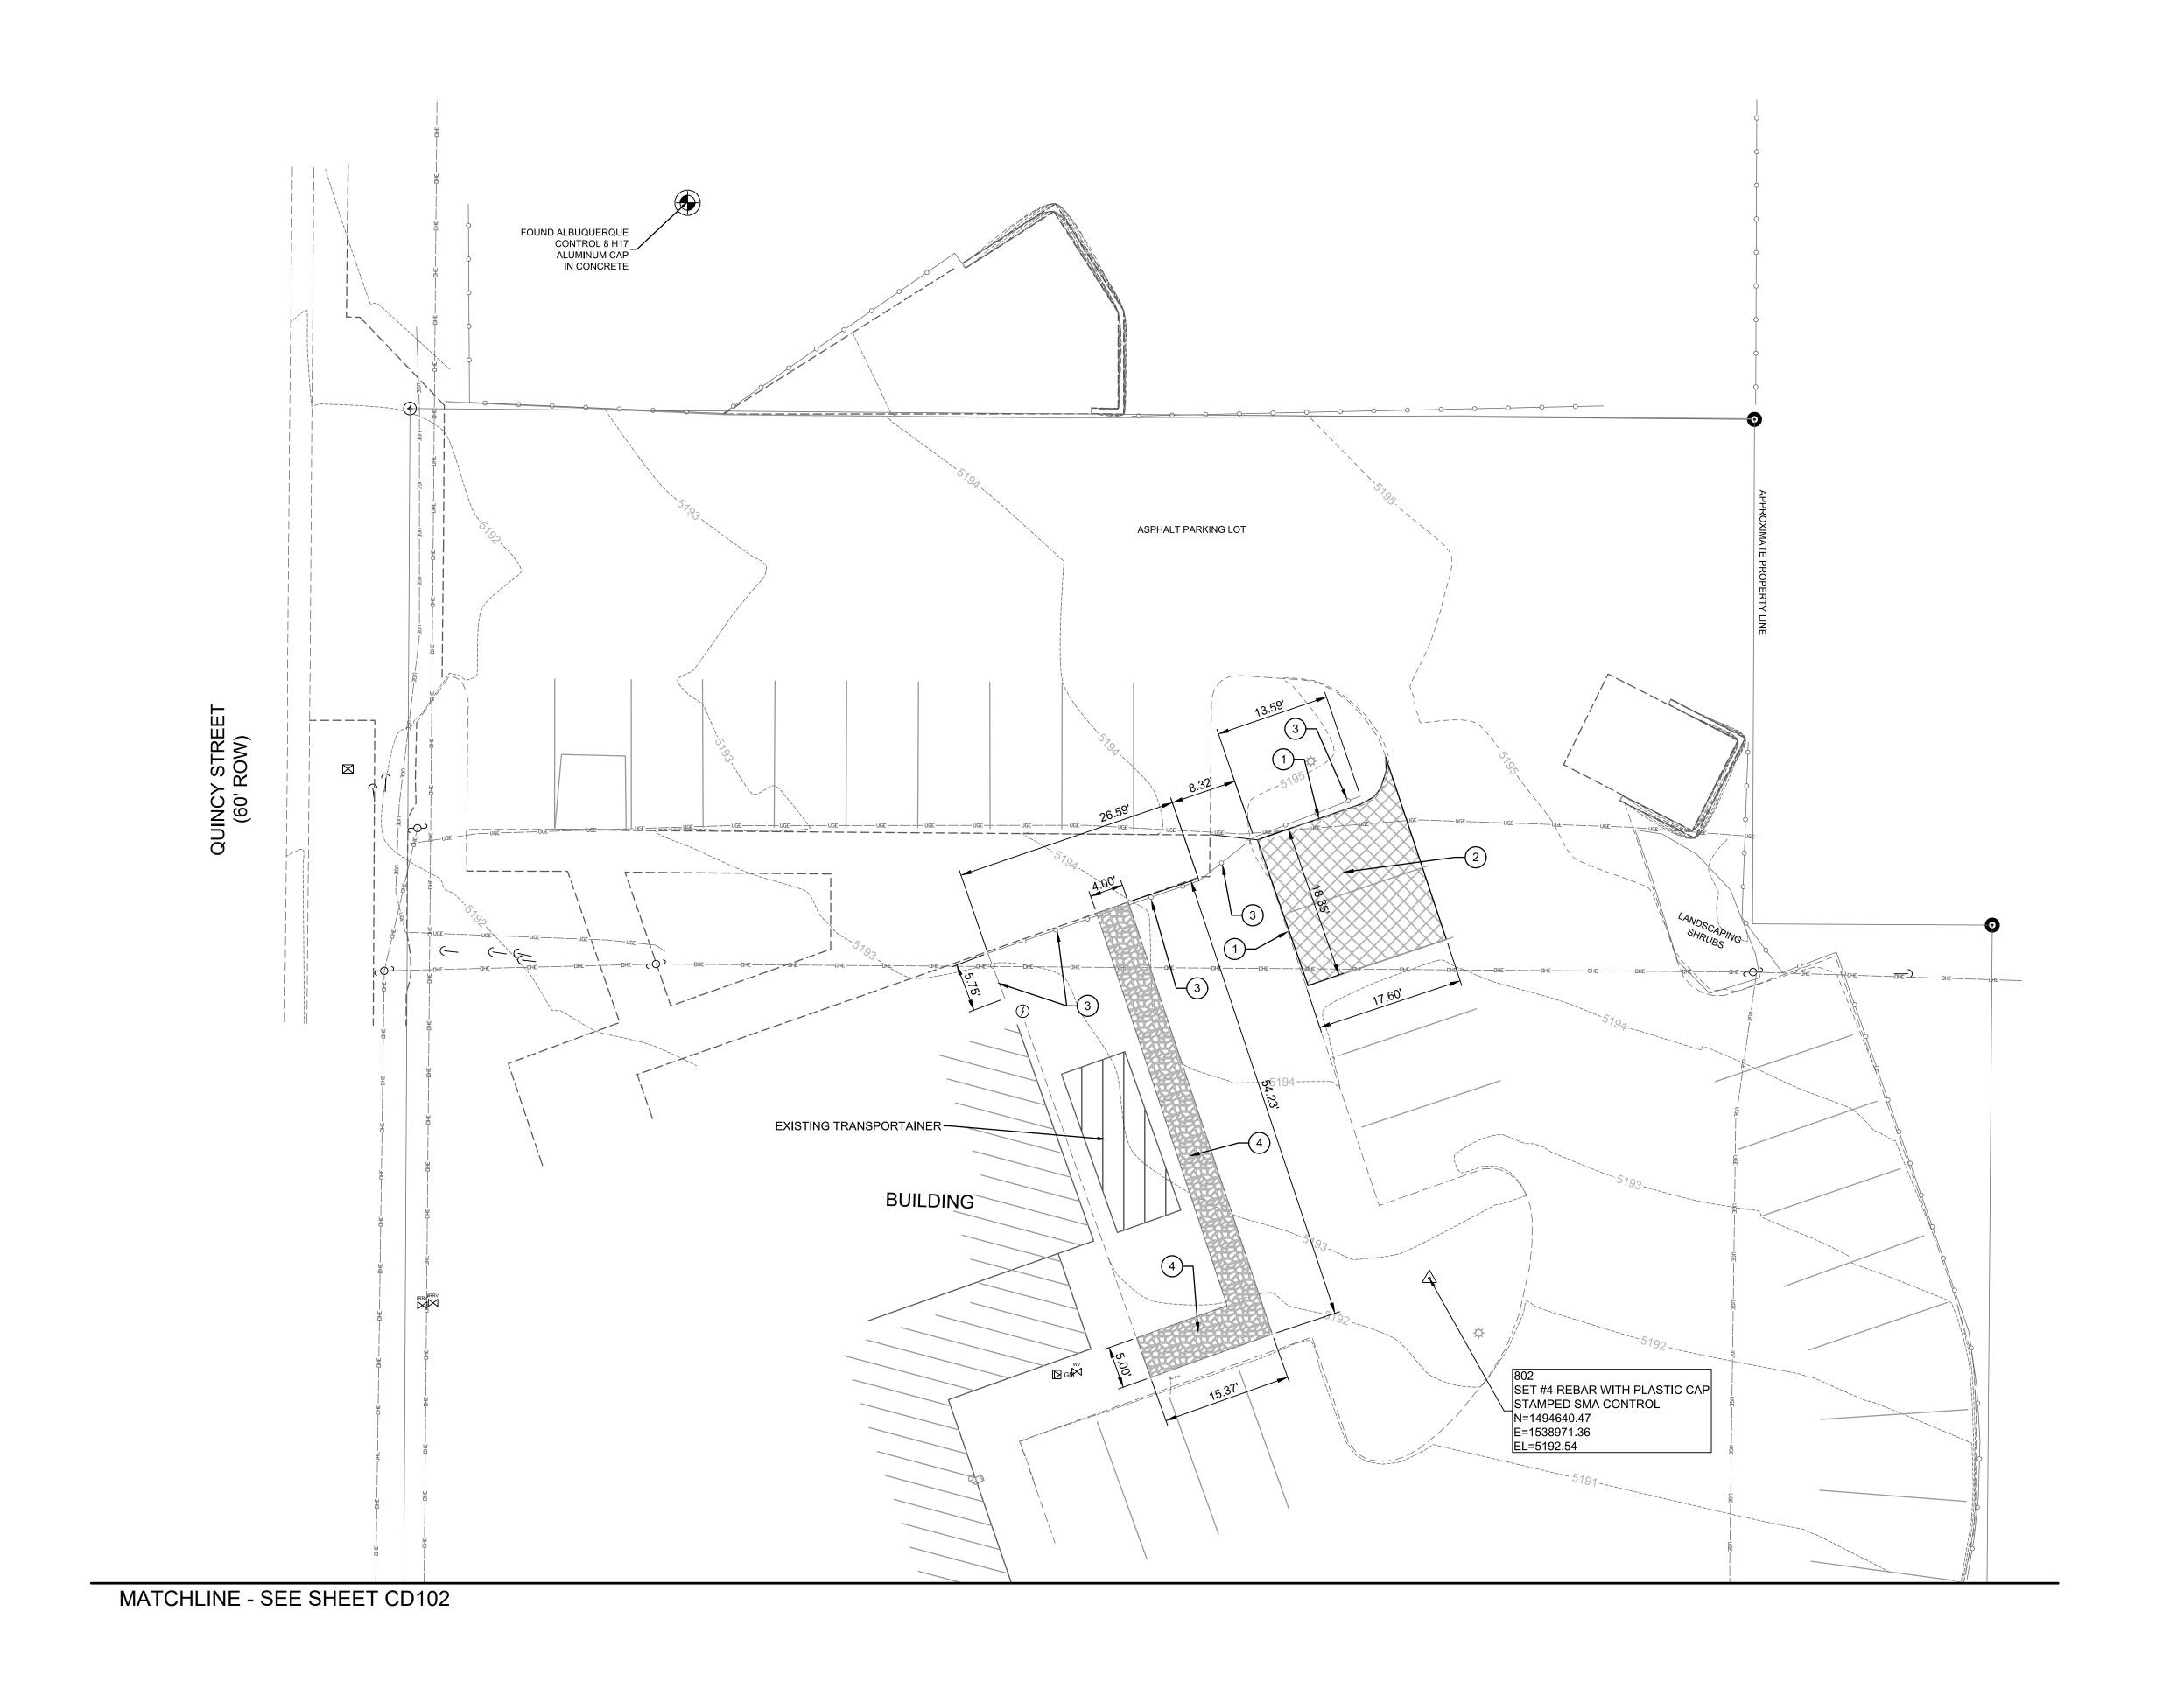
GENERAL NOTES A. PROPERLY DISPOSE OF ALL REMOVED MATERIALS AT AN OFF-SITE LOCATION. B. REMOVE CONCRETE SIDEWALK TO EXISTING JOINT. # REMOVAL NOTES 1. REMOVE AND DISPOSE OF EXISTING CURB. 2. REMOVE AND DISPOSE OF EXISTING ASPHALT PAVEMENT. 3. REMOVE AND DISPOSE OF EXISTING CHAINLINK FENCE. 4. REMOVE AND SALVAGE EXISTING GRAVEL. LEGEND BUILDING OUTLINE ---- PAVEMENT EDGE ======== CONCRETE WALL _____ CURB ---- EDGE OF CONCRETE ---- BUILDING OVERHANG PAVEMENT STRIPING ————————— EXITING FENCE PATTERN LEGEND ASPHALT REMOVAL GRAVEL/ROCK REMOVAL Solutions for Today... Vision for Tomorrow 2201 San Pedro Dr NE Building 4, Suite 200 Albuquerque, NM 87110 Phone: 505-884-0700 CITY OF ALBUQUERQUE
DEPARTMENT OF MUNICIPAL DEVELOPMENT PROJECT TITLE: **ABQ FIRE STATION 13** DRAWING TITLE: SITE REMOVAL PLAN- NORTH City Engineer Approval Mo./Day/Yr. Design Review Committee Mo./Day/Yr. 90% Submittal



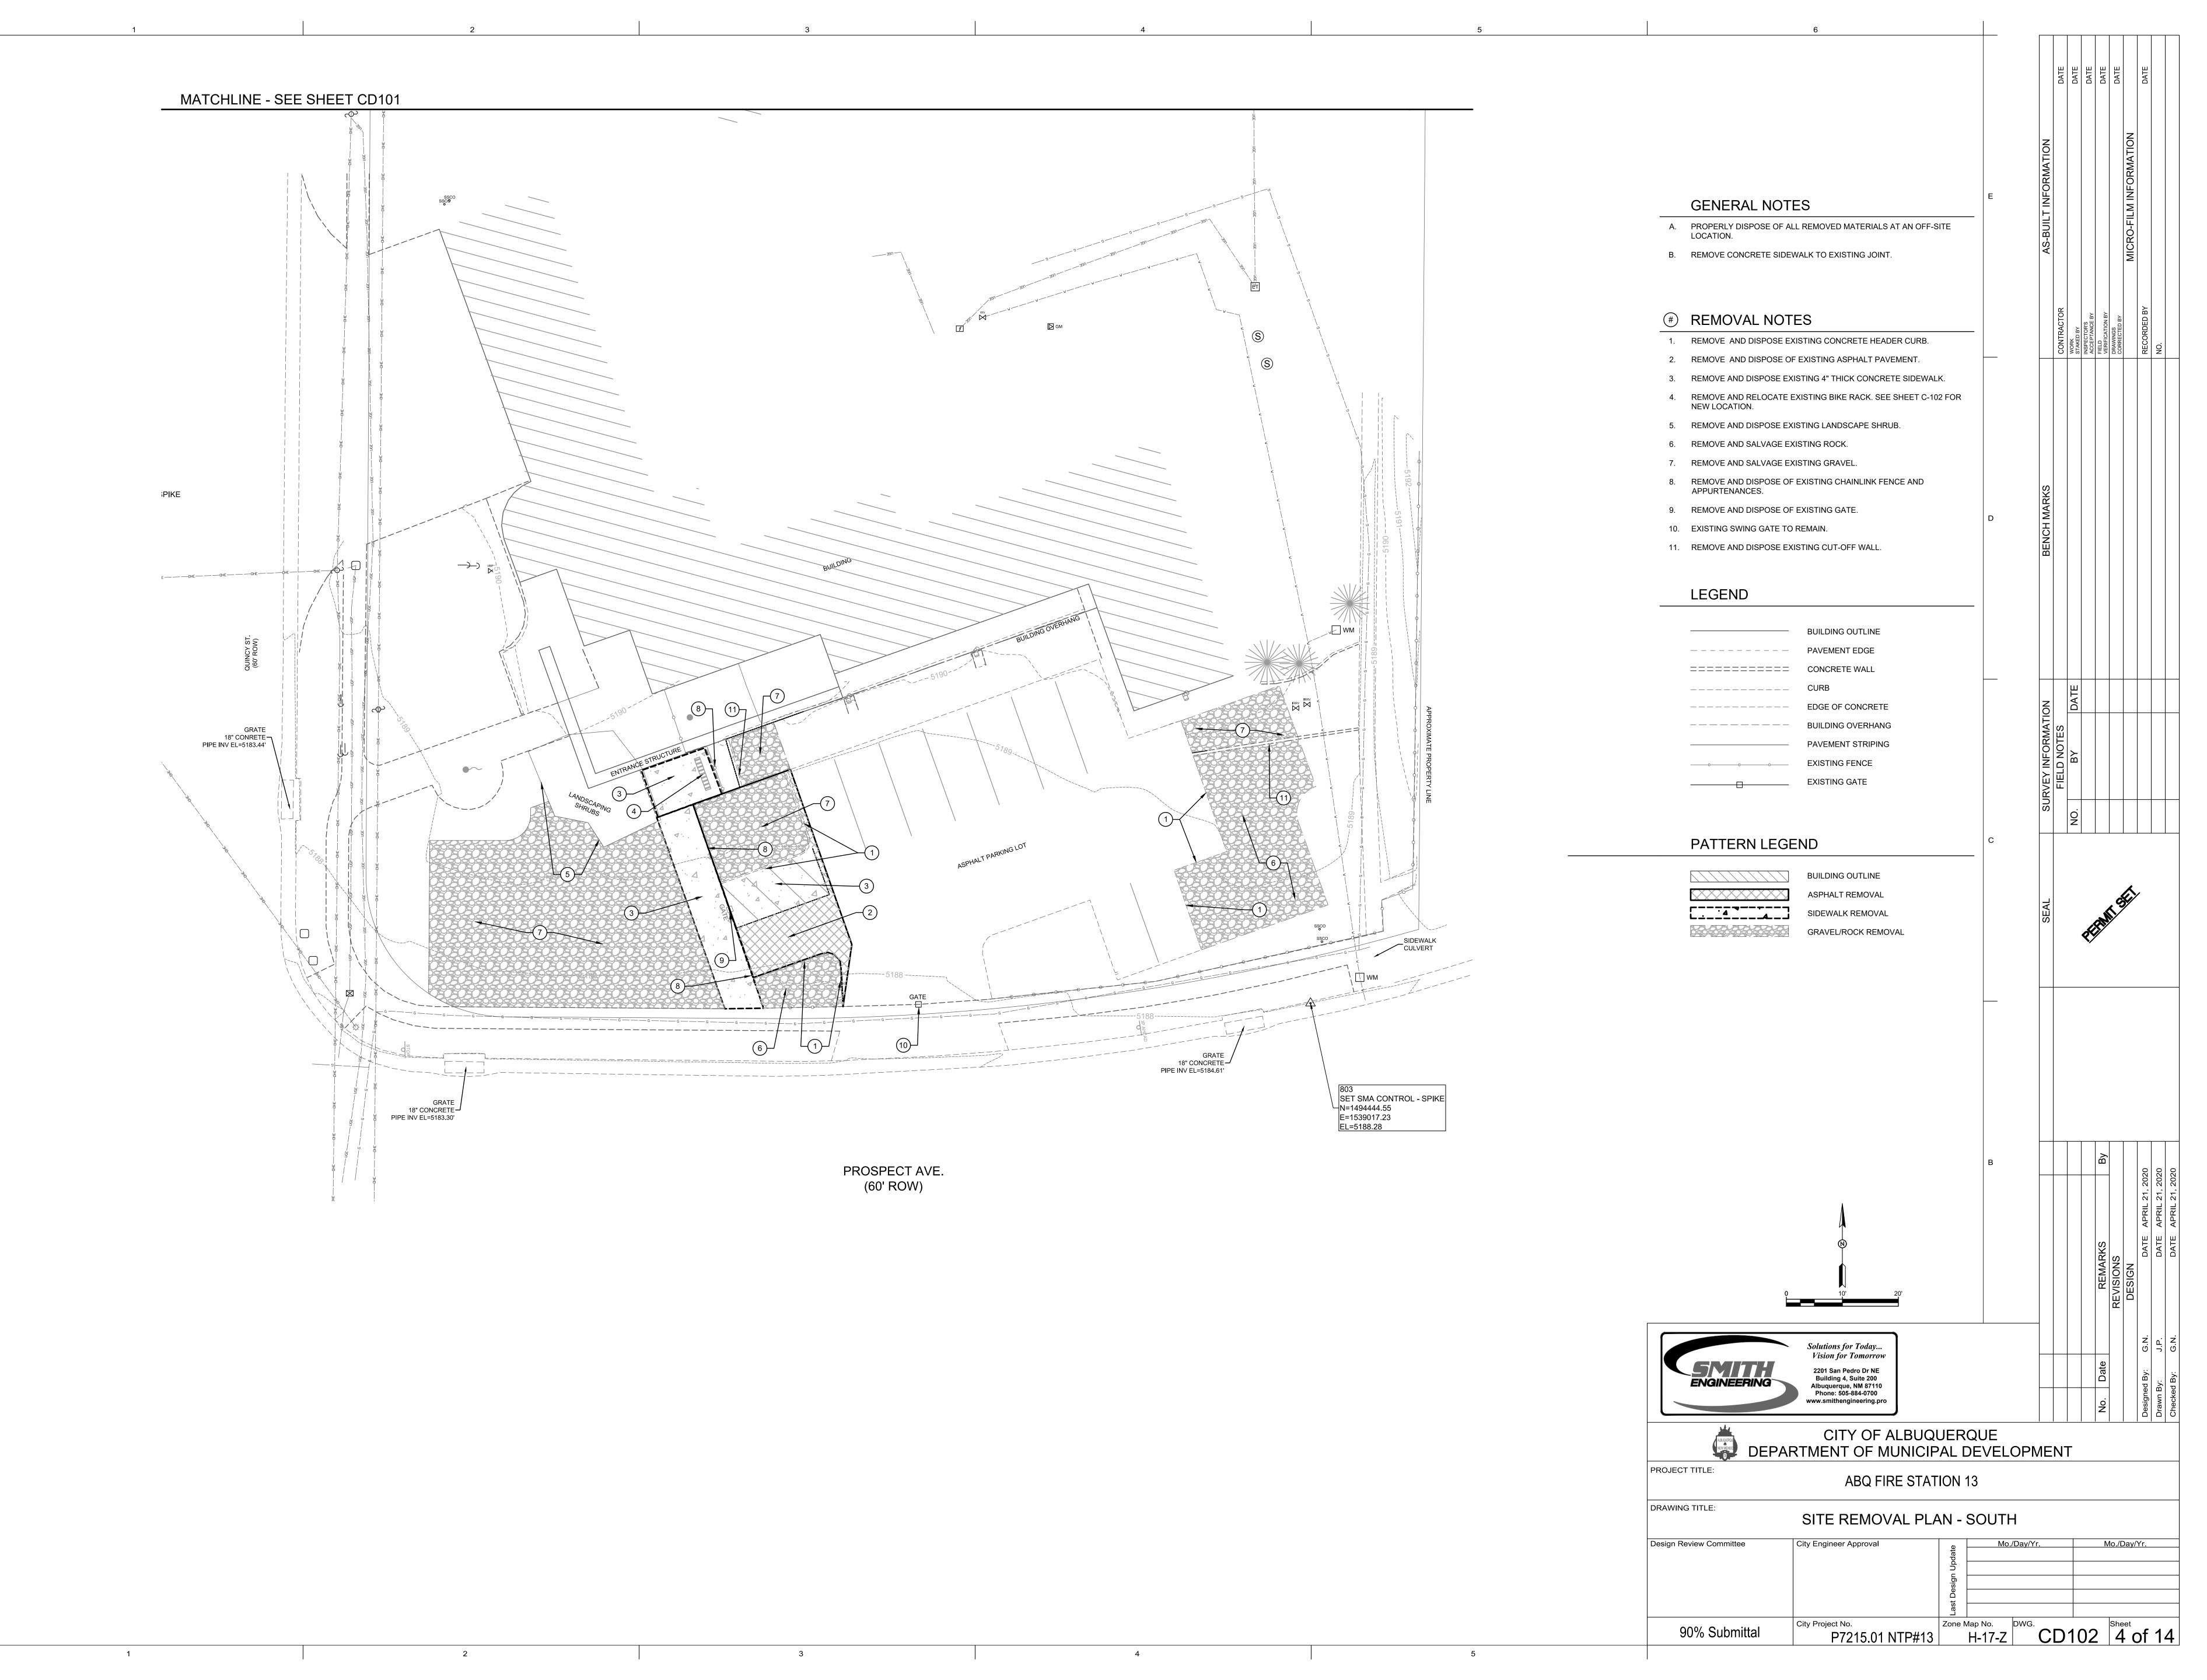


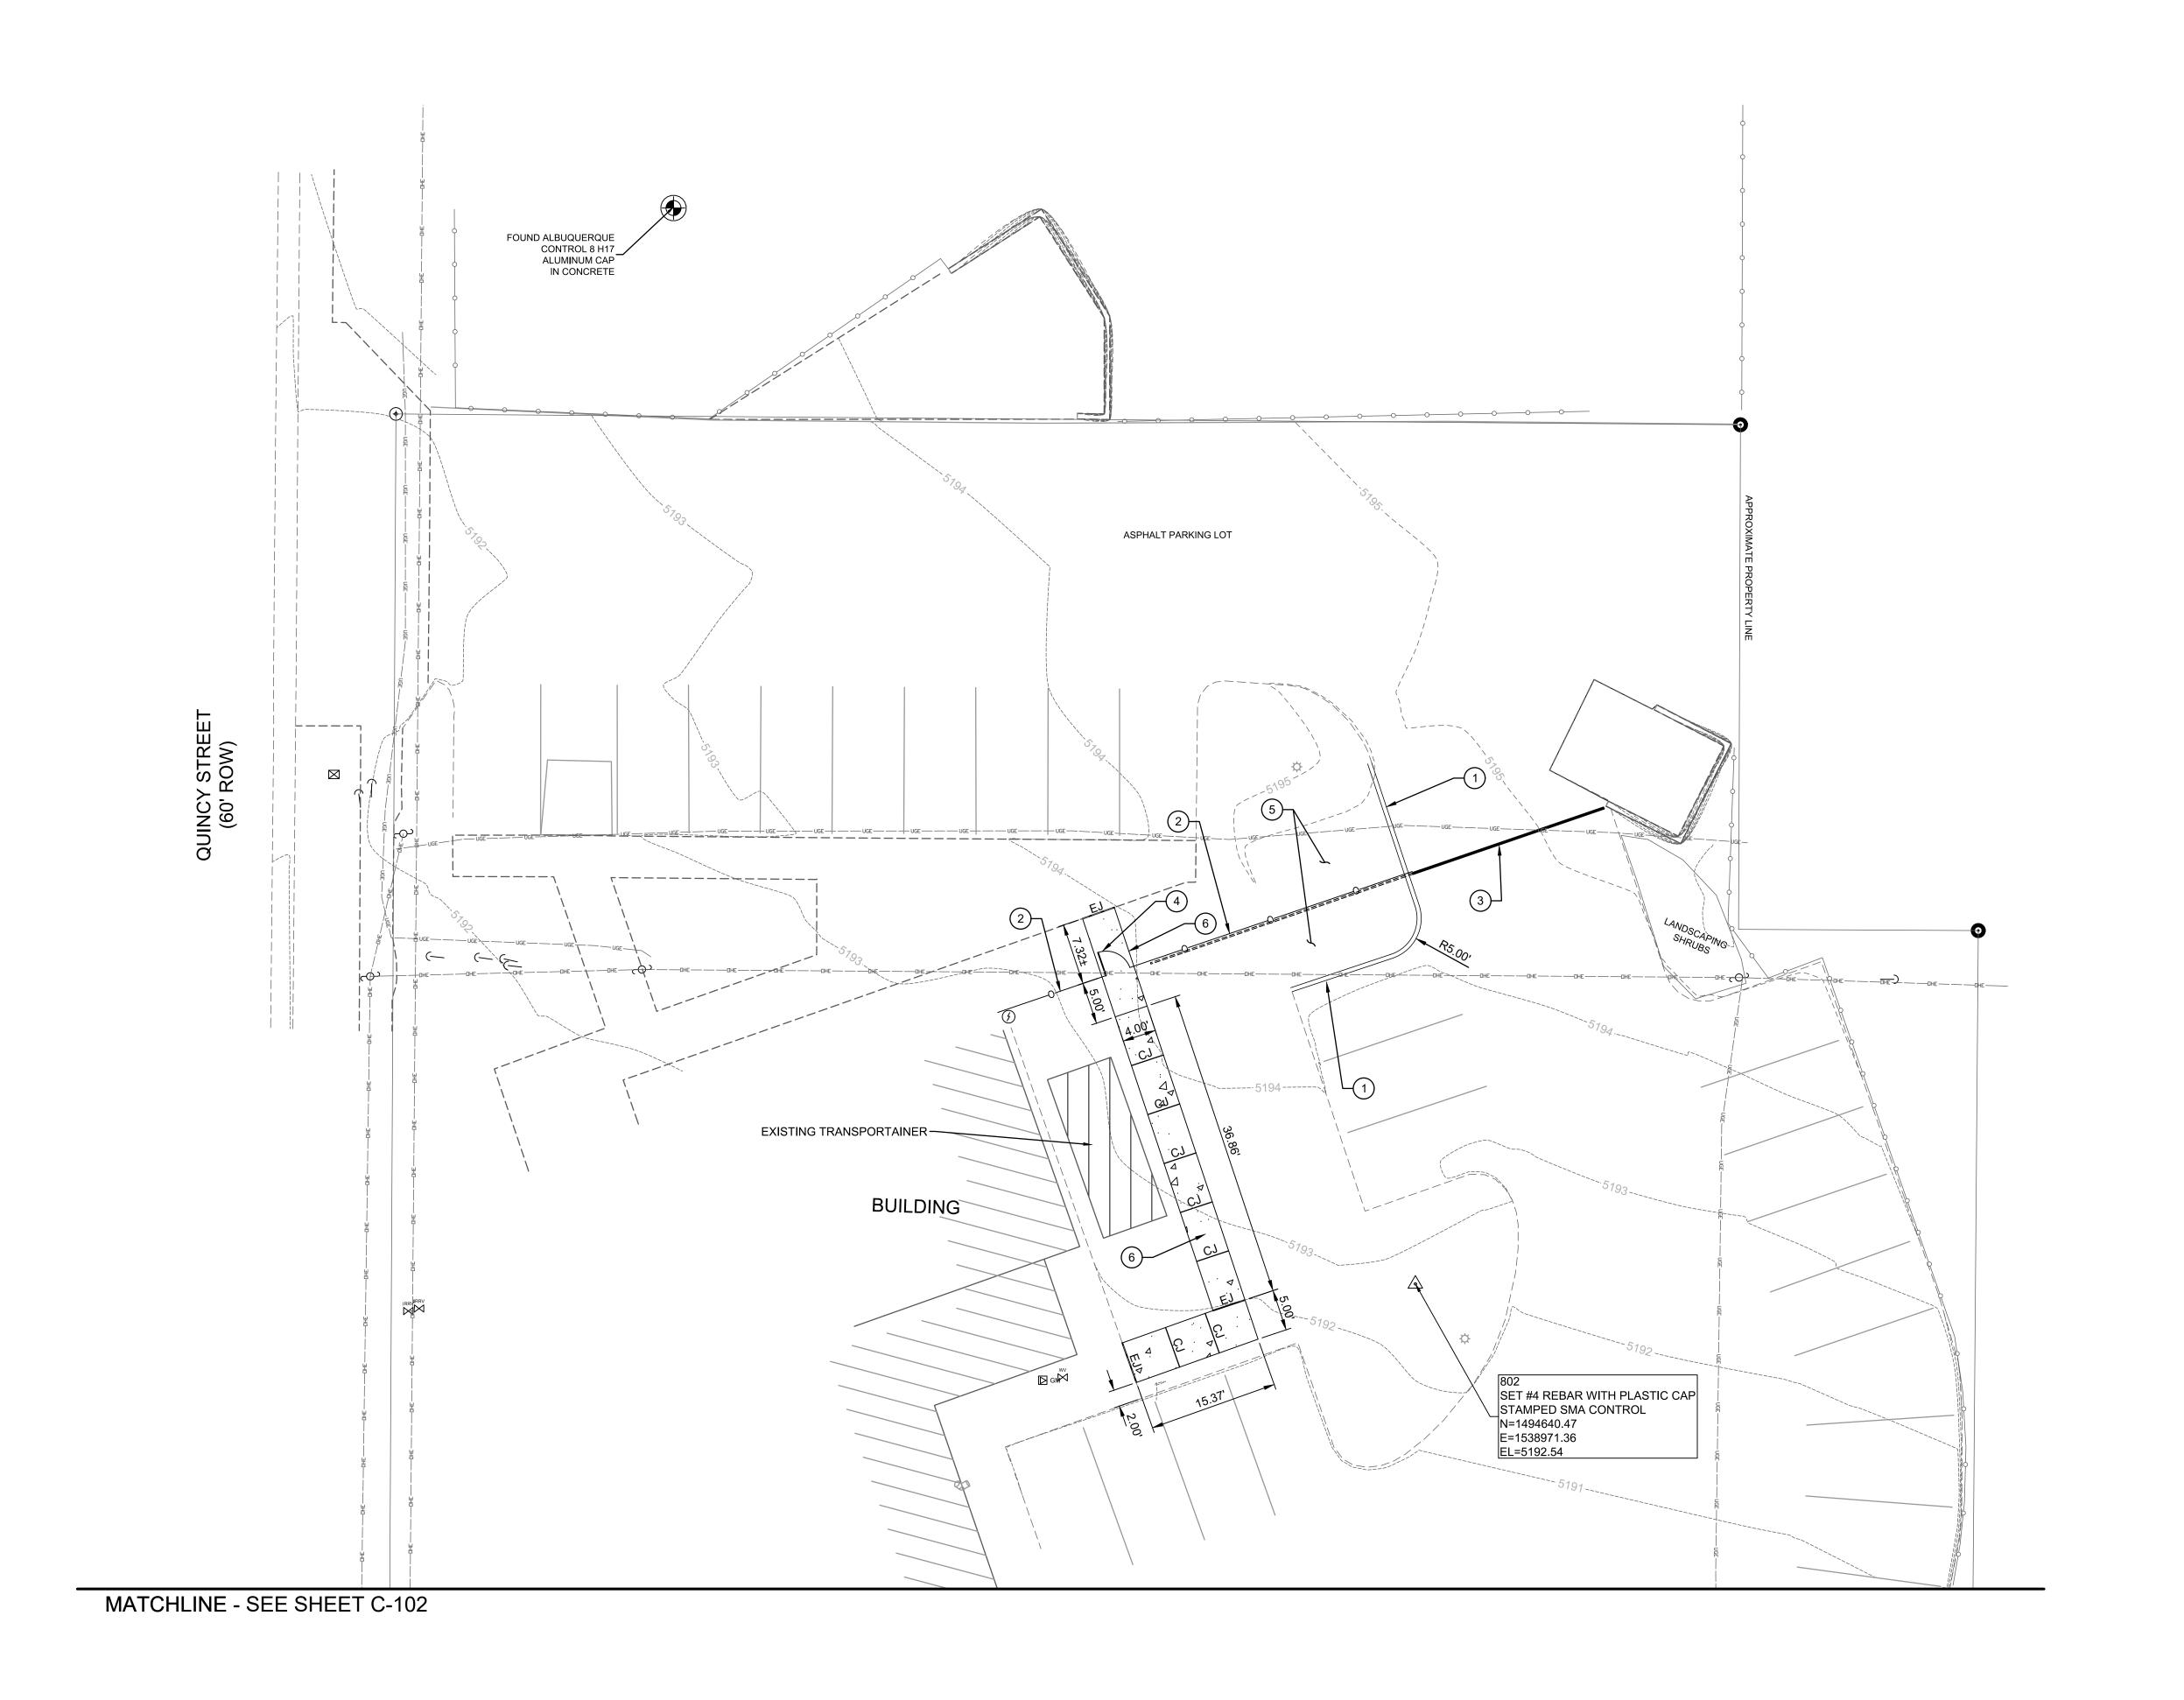
BUILD NOTES BUILD NEW CONCRETE HEADER CURB, REFERENCE DETAIL 3, SHEET C-301. 2. INSTALL FENCING. SEE ARCHITECTURAL SHEETS FOR DETAILS. NEW 24" WIDE SLIDING GATE. SEE ARCHITECTURAL SHEET FOR DETAILS. 4. INSTALL NEW PERSONNEL GATE. SEE ARCHITECTURAL SHEETS FOR DETAILS 5. PLACE SALVAGED GRAVEL ON LANDSCAPE FILTER FABRIC. 6. INSTALL 4" THICK CONCRETE SIDEWALK. REFERENCE DETAIL 2, SHEET LEGEND BUILDING OUTLINE ---- PAVEMENT EDGE ======== CONCRETE WALL _____ CURB ---- EDGE OF CONCRETE ---- BUILDING OVERHANG PAVEMENT STRIPING ——⊸——⊸—— EXISTING FENCE ————————————————PROPOSED FENCE PROPOSED HEADER CURB PROPOSED SLIDING GATE RADIUS OF CURVE CONTROL JOINT **EXPANSION JOINT** Solutions for Today... Vision for Tomorrow 2201 San Pedro Dr NE Building 4, Suite 200 Albuquerque, NM 87110 Phone: 505-884-0700 CITY OF ALBUQUERQUE
DEPARTMENT OF MUNICIPAL DEVELOPMENT PROJECT TITLE: **ABQ FIRE STATION 13** DRAWING TITLE: SITE LAYOUT PLAN - NORTH Mo./Day/Yr. Design Review Committee City Engineer Approval Mo./Day/Yr. 90% Submittal




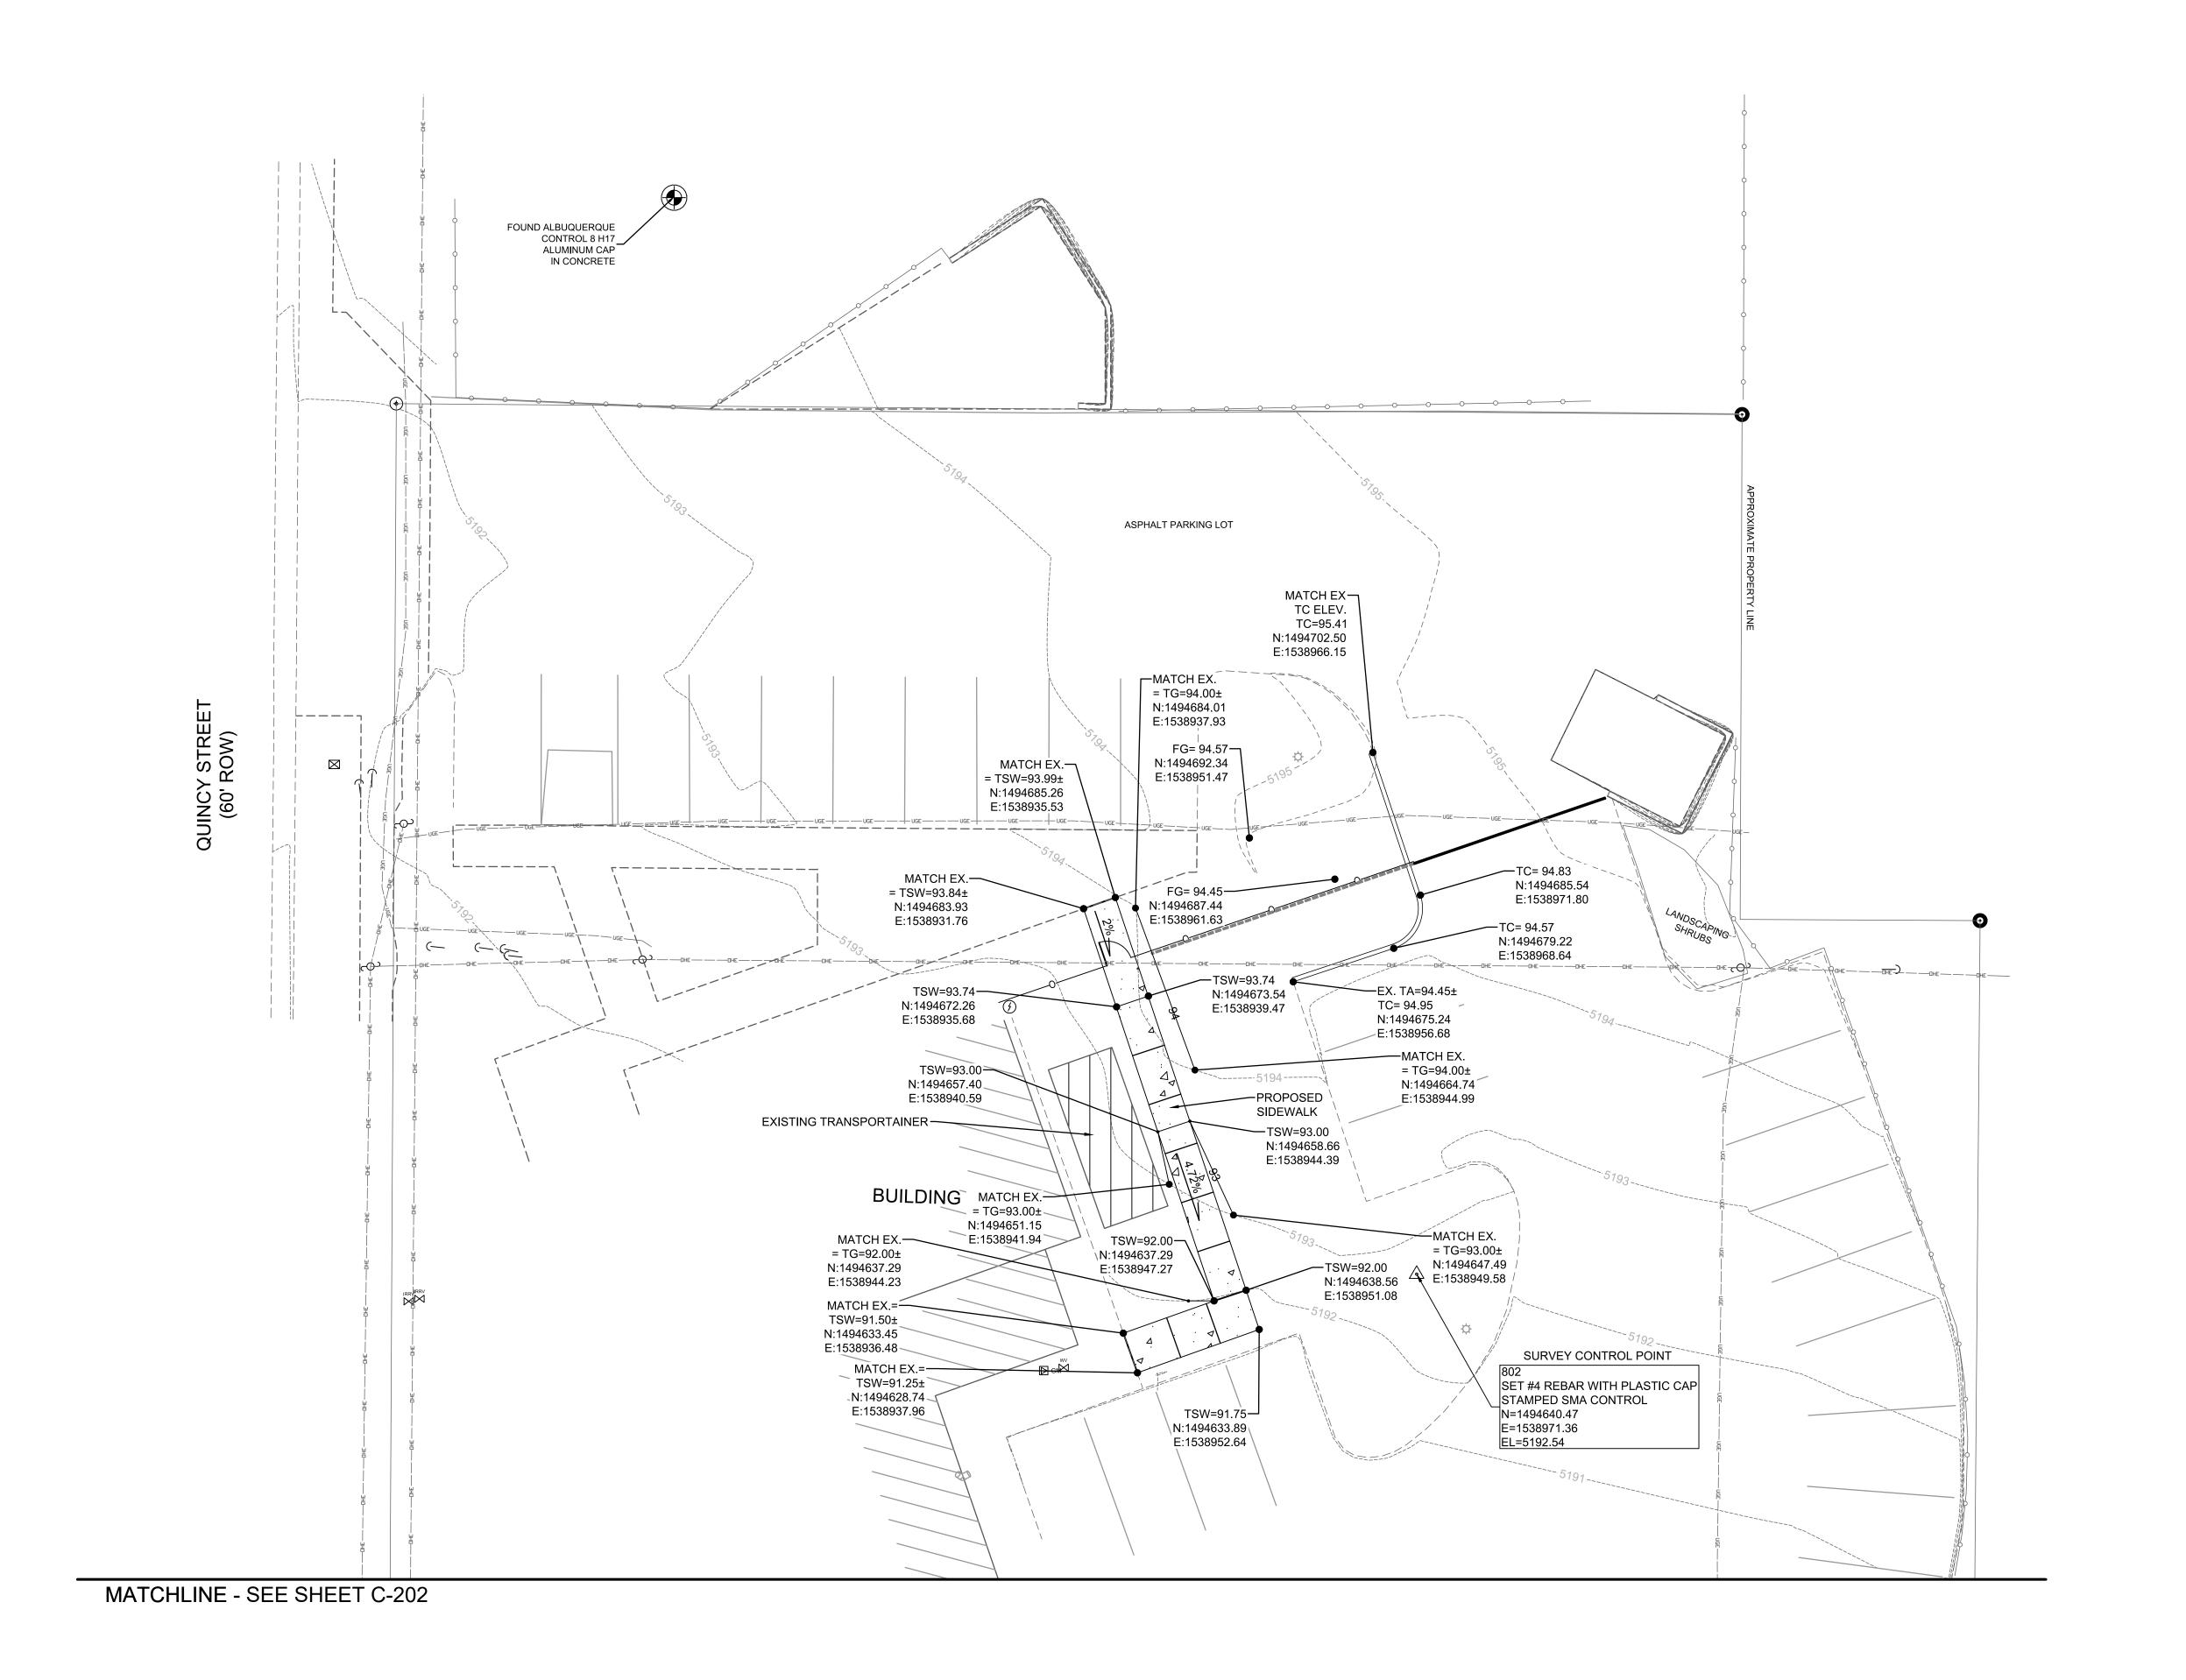


LEGEND BUILDING OUTLINE ---- PAVEMENT EDGE ======== BLOCK WALL FENCE ____CURB ---- EDGE OF CONCRETE ---- BUILDING OVERHANG PAVEMENT STRIPING ——⊸——⊸—— EXISTING FENCE PROPOSED HEADER CURB PROPOSED SLIDING GATE TOP OF SIDEWALK TOP OF CURB TOP OF ASPHALT **FLOWLINE EXISTING** TOP OF GROUND DIRECTION OF FLOW Solutions for Today... Vision for Tomorrow 2201 San Pedro Dr NE Building 4, Suite 200 Albuquerque, NM 87110 CITY OF ALBUQUERQUE
DEPARTMENT OF MUNICIPAL DEVELOPMENT PROJECT TITLE: **ABQ FIRE STATION 13** DRAWING TITLE: SITE GRADING PLAN - NORTH Mo./Day/Yr. Design Review Committee Mo./Day/Yr. City Engineer Approval City Project No. P7215.01 NTP#13 Zone Map No. DWG. C-201 Sheet 7 of 14 90% Submittal

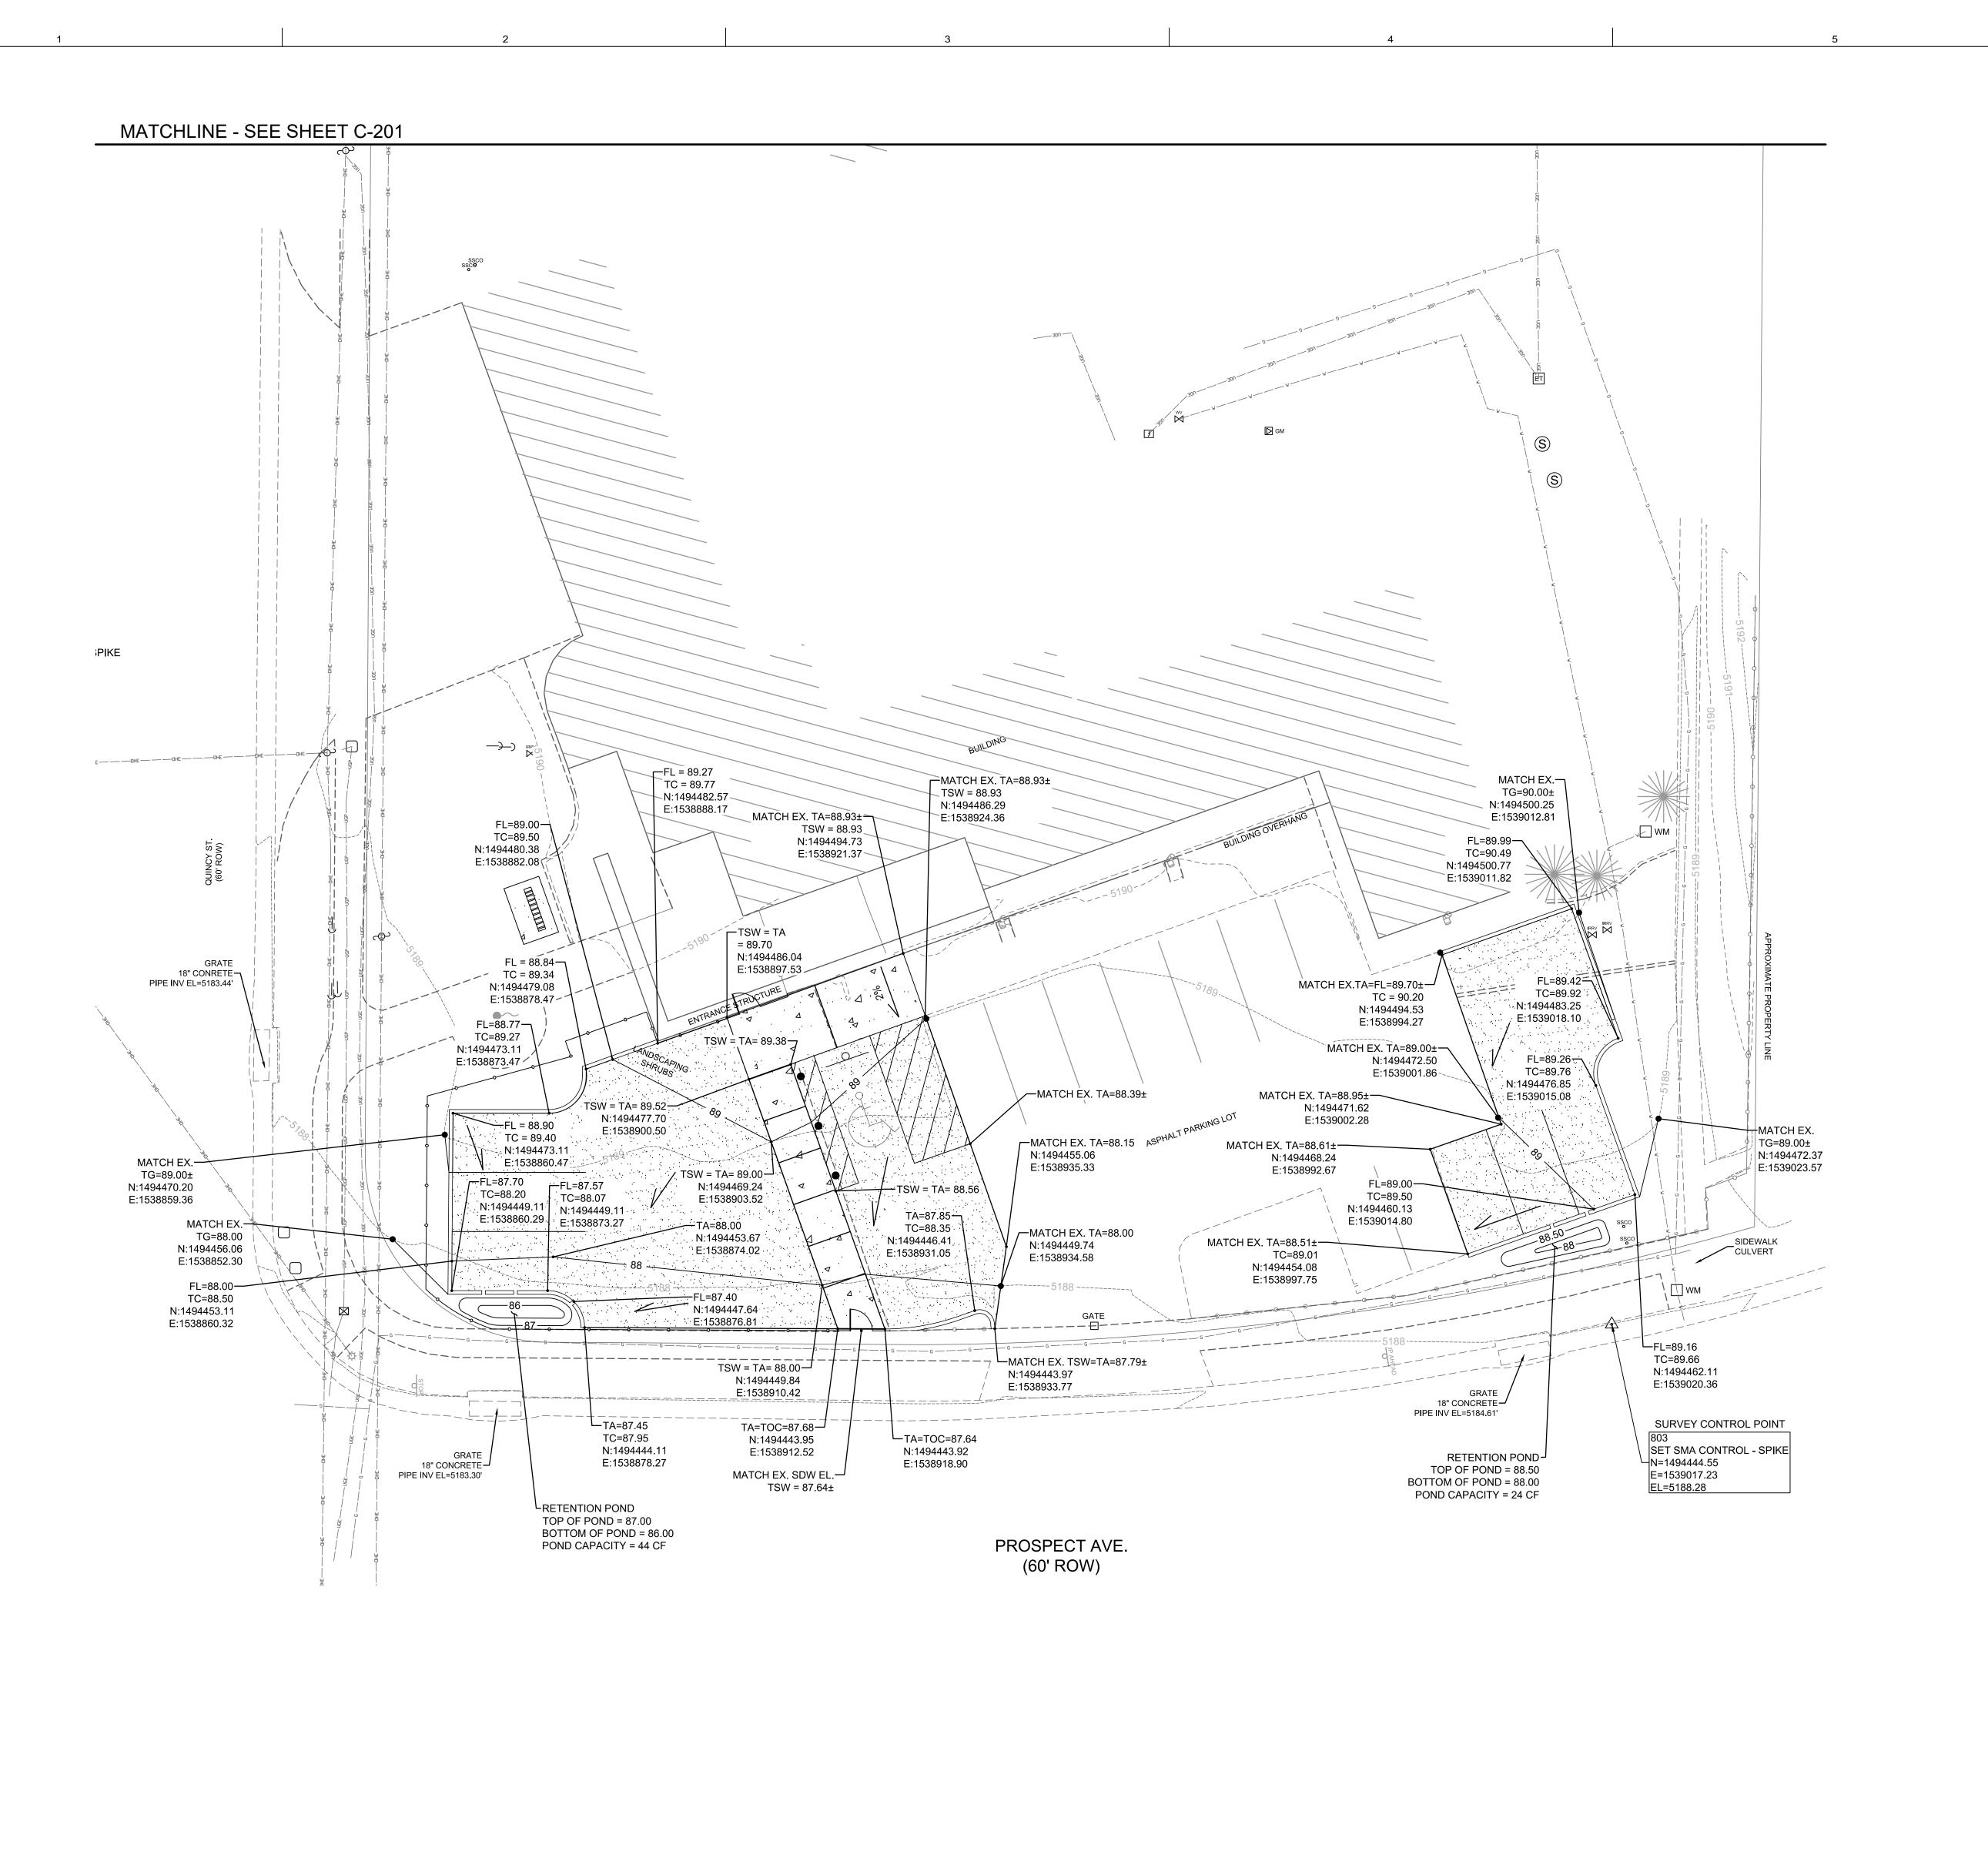

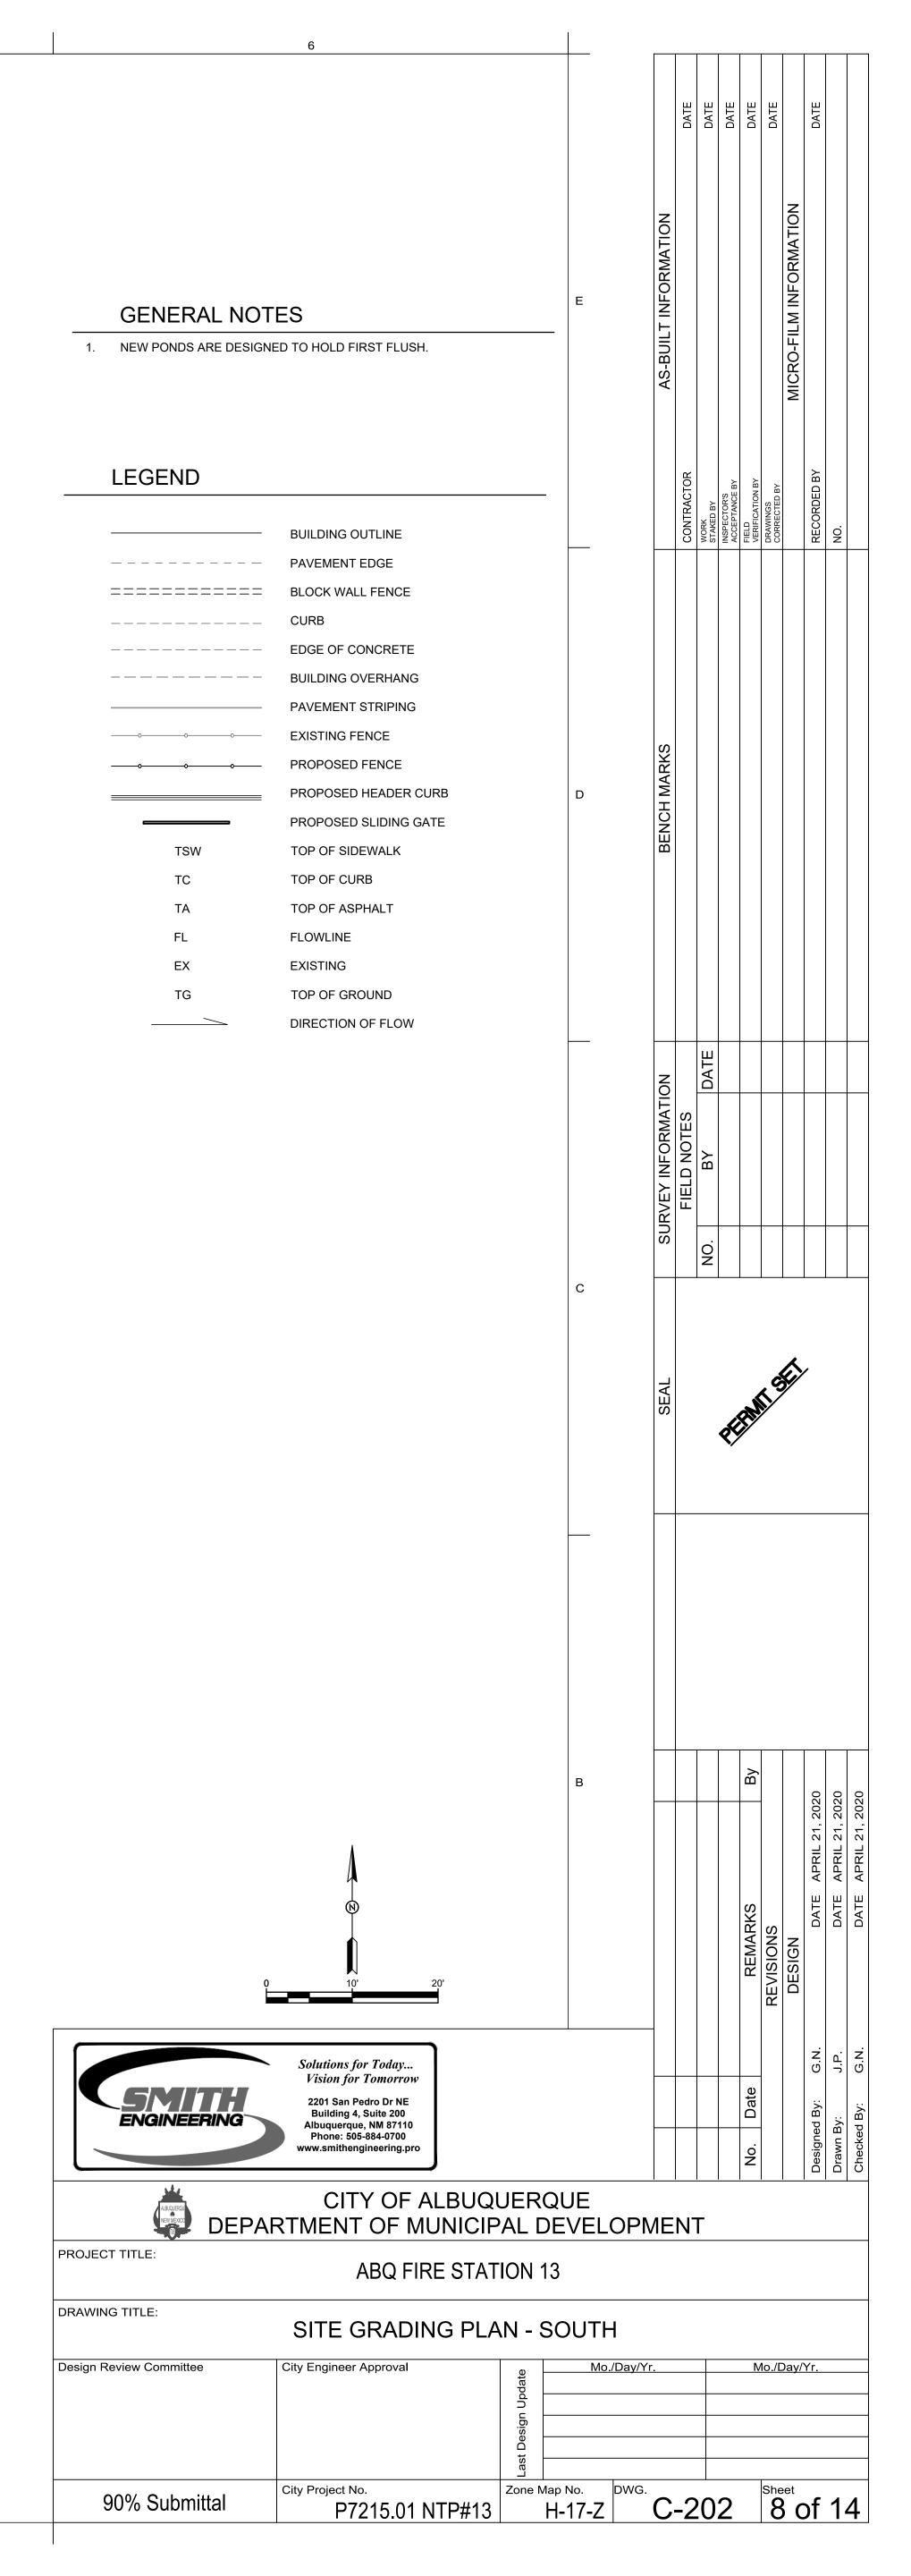


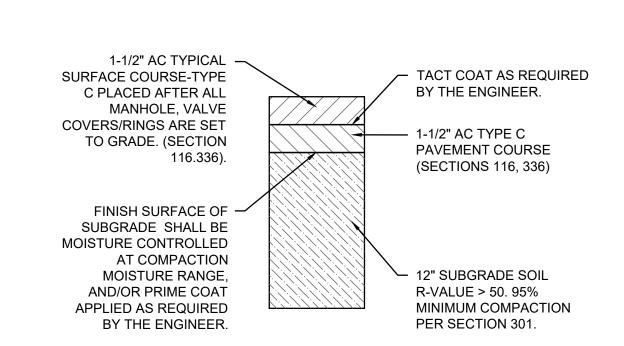




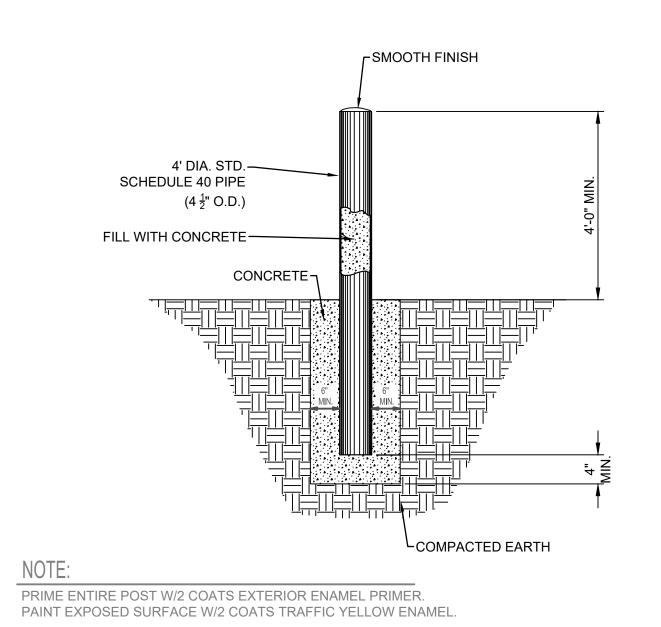

4 BOLLARD DETAIL
C-102 SCALE: NTS

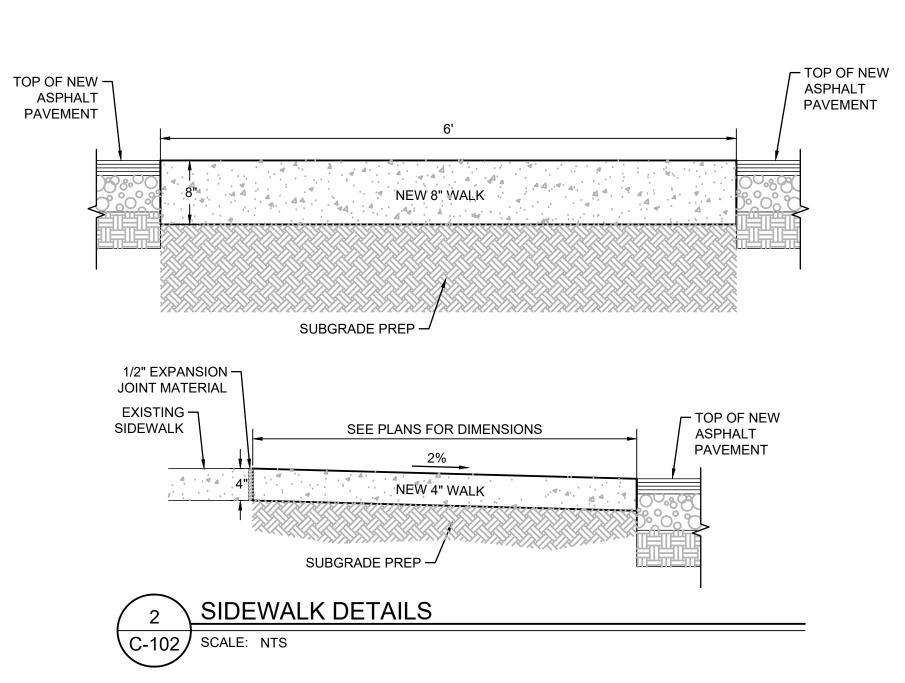

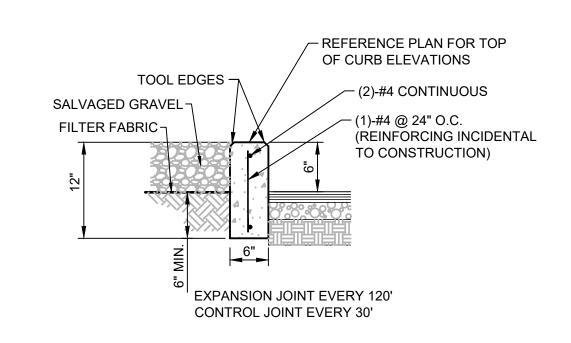

3 HEADER CURB
C-102 SCALE: NTS

Mo./Day/Yr. Mo./Day/Yr.

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Albuquerque, NM 87110
Phone: 506-684-0700
www.smithengineering.pro

CITY OF ALBUQUERQUE
DEPARTMENT OF MUNICIPAL DEVELOPMENT

PROJECT TITLE:

ABQ FIRE STATION 13

DRAWING TITLE:

CIVIL DETAILS

Design Review Committee

City Engineer Approval

City Engineer Approval

City Project No.
P7215.01 NTP#13

C-301

Sheet
9 of 14



PROSPECT AVE NE

SITE PLAN - EXISTING AND FOR REFERENCE ONLY

1" = 20'-0"



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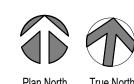
GENERAL NOTES

A. FIELD VERIFY ALL DIMENSIONS.

DATE
DATE
DATE
DATE
DATE
DATE



DEMOLITION PLAN



SELECTIVE DEMOLITION

- A. DEMOLITION WORK SHALL COMPLY WITH ANSI A10.6 AND NFPA 24.1
- B. ALL WORK SHALL COMPLY WITH APPLICABLE CODES AND REGULATIONS. HAZARDOUS WASTE SHALL BE HANDLED AND DISPOSED OF IN COMPLIANCE WITH HAZARDOUS MATERIALS REGULATIONS, REPORTS REGARDING THE PRESENCE OF HAZARDOUS MATERIALS ARE ON FILE AT THE OFFICE OF THE ARCHITECT AND ARE AVAILABLE FOR REVIEW AND USE BY THE CONTRACTOR. THE CONTRACTOR SHALL EXAMINE THE REPORTS AND THE SITE CONDITIONS PRIOR TO COMMENCING THE WORK.
- ALL DEMOLITION WORK SHALL BE PERFORMED BY PERSONS EXPERIENCED IN DEMOLITION WORK SIMILAR IN NATURE AND EXTENT TO THAT REQUIRED BY THIS PROJECT.
- DO NOT OBSTRUCT PUBLIC WAYS ADJACENT TO THE PROJECT WITHOUT WRITTEN AUTHORIZATION FROM AUTHORITIES HAVING JURISDICTION. ERECT TEMPORARY BARRICADES, PASSAGEWAYS, OR OTHER PROTECTION AS REQUIRED TO PREVENT INJURY TO PEOPLE AND DAMAGE TO ADJACENT BUILDINGS AND FACILITIES, AND AS REQUIRED BY JURISDICTIONAL
- E. PROTECT EXISTING SITEWORK, AND EXISTING BUILDING EXTERIOR CONDITIONS AND FEATURES.
- PROVIDE AND MAINTAIN SHORING, BRACING, OR STRUCTURAL SUPPORT TO PRESERVE THE STABILITY AND INTEGRITY OF THE EXISTING CONSTRUCTION TO REMAIN, AND AS NECESSARY TO PREVENT THE UNPLANNED COLLAPSE OF THE MATERIALS OF CONSTRUCTION BEING
- IN THE EVENT THAT UNANTICIPATED CONDITIONS ARE ENCOUNTERED, INCLUDING MECHANICAL, ELECTRICAL, OR STRUCTURAL ELEMENTS THAT CONFLICT WITH THE INTENT OF THE DEMOLITION DRAWINGS, REPORT SUCH CONDITIONS IMMEDIATELY TO THE ARCHITECT, AND DO NOT PROCEED WITH THE AFFECTED WORK UNTIL AUTHORIZED BY THE ARCHITECT.
- H. ITEMS TO BE REMOVED SHALL BE DETACHED FROM THE EXISTING CONSTRUCTION EMPLOYING CUTTING AND REMOVAL METHODS THAT ARE LEAST LIKELY TO DAMAGE ADJACENT CONSTRUCTION WHICH IS TO REMAIN.
- REMOVED ITEMS SHALL BE DISPOSED OF LEGALLY OFF-SITE, UNLESS DESIGNATED TO BE SALVAGED, OR REMOVED AND STORED.
- ITEMS DESIGNATED TO BE SALVAGED SHALL BE DETACHED FROM THE EXISTING CONSTRUCTION AND DELIVERED TO THE OWNER REPRESENTATIVE. THE OWNER REPRESENTATIVE IS ENTITLED TO SALVAGE AND/OR REMOVE EQUIPMENT, HARDWARE, FIXTURES, AND FURNISHINGS FROM ALL AREAS OF THIS CONTRACT PRIOR TO DEMOLITION.
- K. ITEMS DESIGNATED TO BE REMOVED AND STORED SHALL COMPLY WITH THE PROCEDURES AND REQUIREMENTS DESCRIBED UNDER HISTORIC TREATMENT PROCEDURES.
- MAINTAIN EXISTING UTILITY SERVICES AND FIRE PROTECTION FACILITIES, AND PROTECT THEM FROM DAMAGE DURING THE DEMOLITION OPERATIONS. INTERRUPTIONS OF UTILITIES TO THE

BUILDING SHALL BE COORDINATED WITH THE OWNER REPRESENTATIVE.

- M. TEMPORARILY SHUT OFF UTILITIES TO SELECTED PORTIONS OF THE BUILDING AS REQUIRED BY DEMOLITION OPERATIONS. CAP, VALVE, PLUG, OR SEAL ENDS OF PIPING AND CONDUIT REQUIRED TO BE CUT-OFF OR DISCONNECTED BY THE DEMOLITION WORK. MAINTAIN CONTINUITY OF UTILITIES TO OTHER PORTIONS OF THE BUILDING.
- N. COMPLY WITH THE OWNER REPRESENTATIVE REQUIREMENTS FOR USING AND PROTECTING ELEVATORS, STAIRS, BUILDING ENTRANCES, AND OTHER BUILDING FACILITIES DURING DEMOLITION OPERATIONS

BARRIER WHEN WORKERS ENTER OR EXIT.

- O. COMPLY WITH THE FOLLOWING DUST CONTROL MEASURES:
 - ISOLATE THE WORK AREA FOR THE DURATION OF THE WORK BY COMPLETELY SEALING OFF ALL OPENINGS AND FIXTURES IN THE WORK AREA, INCLUDING BUT NOT LIMITED TO, HEATING AND VENTILATION DUCTS, DOORWAYS, CORRIDORS, WINDOWS, AND LIGHTING WITH PLASTIC SHEETING TAPED SECURELY IN PLACE. BUILD DOUBLE BARRIERS OF PLASTIC SHEETING AT ALL ENTRANCES AND EXITS TO THE WORK AREA SO THAT THE WORK AREA IS ALWAYS CLOSED OFF BY ONE
 - 2. PROTECTION: COVER ALL FLOORS AND WALL SURFACES IN THE WORK AREA WITH PLASTIC SHEETING TAPED SECURELY IN PLACE TO PROTECT FROM DAMAGE.
 - BEFORE WORK IS BEGUN, REMOVE ALL REMOVABLE ITEMS AND EQUIPMENT FROM THE WORK AREA AND STORE AS DIRECTED.
 - COVER ALL NON-REMOVABLE ITEMS AND EQUIPMENT IN THE WORK AREA WITH PLASTIC SHEETING TAPED SECURELY IN PLACE.
 - REMOVE ALL HEATING, VENTILATION, AND AIR-CONDITIONING SYSTEM FILTERS, PACK THEM IN SEALABLE PLASTIC BAGS (6-MIL MINIMUM) FOR DISPOSAL IN THE APPROVED WASTE DISPOSAL SITE AND REPLACE THEM WITH NEW FILTERS. 3. POST WARNING SIGNS AND LABELS AS REQUIRED BY 29 CFR 1910.1001, ASTM E 849.
- P. MAINTAIN ALL FIRE EXITS DURING CONSTRUCTION.

SPECIAL PROCEDURES

- A. ALL PERSONNEL PERFORMING THE WORK SHALL BE FULLY TRAINED, EXPERIENCED, AND QUALIFIED TO DO THE WORK AND SHALL BE ADEQUATELY INSTRUCTED AND SUPERVISED TO INSURE THAT ALL PARTS AND FEATURES OF THE BUILDING THAT ARE TO BE LEFT IN PLACE ARE PROTECTED FROM DAMAGE DURING THE DEMOLITION OPERATIONS AND MAINTAINED IN THEIR CURRENT CONDITION OR STATE. SUPERVISORY PERSONNEL SHALL BE PRESENT AT ALL TIMES WHEN WORK IS IN PROGRESS.
- PRIOR TO COMMENCING THE DEMOLITION WORK THE CONTRACTOR SHALL HOLD A PRE-CONSTRUCTION CONFERENCE AT THE PROJECT SITE. ALL KEY PERSONNEL THAT WILL BE INVOLVED IN THE WORK, INCLUDING SUPERVISORY PERSONS, ARCHITECT AND OWNER'S REPRESENTATIVE SHALL ATTEND THE CONFERENCE. THE AGENDA FOR THE PRE-CONSTRUCTION CONFERENCE SHALL INCLUDE A REVIEW OF THE SCOPE OF THE PROJECT, AND

APPEARANCE OR FINISH OF SUCH ITEMS OR MATERIALS.

- SPECIAL CONDITIONS AND PROCEDURES INVOLVED IN THE WORK. THE MARKING, IDENTIFICATION OR CATALOGUING OF ANY ITEMS OR MATERIALS EXCEPT THOSE DESIGNATED FOR DEMOLITION, SHALL UTILIZE TEMPORARY MEANS OF IDENTIFICATION THAT ARE INCONSPICUOUS AND THAT DO NOT DAMAGE, MARK OR OTHERWISE ALTER THE
- THE CONTRACTOR SHALL TAKE ALL MEASURES NECESSARY TO PROTECT FROM DAMAGE, ALL WORK THAT IS TO REMAIN IN PLACE, INCLUDING GENERAL CONSTRUCTION; FLOOR, WALL AND CEILING FINISHES; HARDWARE, FIXTURES, AND ATTACHMENT OF TEMPORARY PROTECTION TO THE EXISTING CONSTRUCTION REMAIN SHALL BE APPROVED BY THE ARCHITECT PRIOR TO
- PRIOR TO COMMENCING THE WORK, THE CONTRACTOR SHALL IDENTIFY AND DOCUMENT EXISTING CONDITIONS, INCLUDING CONDITIONS OF ADJOINING CONSTRUCTION TO REMAIN IN PLACE, WHICH MAYBE MISCONSTRUED AS DAMAGE CAUSED BY THE OPERATIONS OF THIS PROJECT. SUBMIT THIS INFORMATION TO THE ARCHITECT BEFORE THE WORK BEGINS.
- IN THE EVENT OF DAMAGE TO ANY ITEM THAT IS TO REMAIN IN PLACE THE CONTRACTOR SHALL REPAIR AND RESTORE THE DAMAGED ITEM TO ITS ORIGINAL CONDITION.
- IN THE EVENT THAT PROTECTIVE MEASURES INCLUDE TEMPORARY REMOVAL OF ITEMS OR MATERIALS THAT ARE TO REMAIN, EMPLOY METHODS WHICH WILL PREVENT DAMAGE TO SUCH ITEMS OR MATERIALS DURING THEIR REMOVAL, STORAGE, AND REINSTALLATION, CLEARLY IDENTIFY ALL PARTS IN SUCH A MANNER THAT THEY CAN BE INSTALLED IN THEIR ORIGINAL LOCATION AND ORIENTATION.
- ALONG THE PATH OF TRAVEL FOR THE MOVEMENT OF EQUIPMENT THROUGHOUT THE BUILDING, REMOVAL OF DEMOLISHED MATERIALS, ETC. TEMPORARILY REMOVE DOORS FROM THEIR HINGES AND IDENTIFY TO ALLOW REPLACEMENT OF EACH DOOR IN ITS ORIGINAL OPENING AND PER ITS ORIGINAL ORIENTATION AND STORE SAFELY. PAD AND/OR OTHERWISE PROTECT DOOR FRAMES. MOLDINGS, BASE, FLOOR AND WALLS AS NECESSARY TO PREVENT DAMAGE DURING DEMOLITION PROCEDURES.
 - IN THE EVENT THAT THE CONTRACTOR PROPOSES PROCEDURES OTHER THAN THOSE DESCRIBED FOR THE WORK. PROVIDE A DESCRIPTION SUCH PROPOSED PROCEDURES FOR REVIEW AND APPROVAL BY THE ARCHITECT PRIOR TO PRECEDING WITH THAT PORTION OF THE
- ALL ITEMS TO BE REMOVED AND SALVAGED TO OWNER SHALL BE IDENTIFIED PER GENERAL NOTE "C" ABOVE, CATALOGUED PER THE DIRECTION OF OWNER, AND STORED ON PALLETS IN A LOCATION DESIGNATED BY THE OWNER.
- COMPLY WITH THE FOLLOWING PROCEDURES WHILE PERFORMING WORK WITH HEAT-GENERATING EQUIPMENT, INCLUDING WELDING, CUTTING, SOLDERING, BRAZING, PAINT REMOVAL WITH HEAT, AND OTHER OPERATIONS WHERE OPEN FLAMES OR IMPLEMENTS UTILIZING HEAT ARE USED:
- WELDING EQUIPMENT. a. NOTIFICATION SHALL BE GIVEN FOR EACH OCCURRENCE AND LOCATION OF WORK WITH HEAT- GENERATING EQUIPMENT. AS FAR AS PRACTICAL USE HEAT-GENERATING EQUIPMENT IN SHOP AREAS OR OUTSIDE

OBTAIN OWNERS APPROVAL FOR OPERATIONS INVOLVING USE OF OPEN-FLAME OR

- THE BUILDING. BEFORE WORK WITH HEAT-GENERATING EQUIPMENT COMMENCES FURNISH PERSONNEL TO SERVE AS A FIRE WATCH (OR WATCHES) FOR LOCATIONS WHERE
- WORK IS TO BE PERFORMED. DO NOT PERFORM WORK WITH HEAT-GENERATING EQUIPMENT IN OR NEAR ROOMS OR IN AREAS WHERE FLAMMABLE LIQUIDS OR EXPLOSIVE VAPORS ARE PRESENT OR THOUGHT TO BE PRESENT. USE A COMBUSTIBLE GAS INDICATOR TEST TO ENSURE THAT
- REMOVE AND KEEP THE AREA FREE OF COMBUSTIBLES, INCLUDING RUBBISH, PAPER, WASTE, ETC., WITHIN AREA OF OPERATIONS. a. IF COMBUSTIBLE MATERIAL CANNOT BE REMOVED, PROVIDE FIREPROOF
- BLANKETS TO COVER SUCH MATERIALS. WHERE POSSIBLE, FURNISH AND USE BAFFLES OF METAL OR GYPSUM BOARD TO PREVENT THE SPRAYING OF SPARKS OR HOT SLAG INTO SURROUNDING COMBUSTIBLE
- PREVENT THE EXTENSION OF SPARKS AND PARTICLES OF HOT METAL THROUGH OPEN WINDOWS, DOORS, HOLES AND CRACKS IN FLOORS, WALLS, CEILINGS, ROOFS, AND OTHER OPENINGS.
- INSPECT EACH LOCATION OF THE DAYS WORK NOT SOONER THAN 30 MINUTES AFTER COMPLETION OF OPERATIONS TO DETECT HIDDEN OR SMOLDERING FIRES AND TO ENSURE THAT PROPER HOUSEKEEPING IS MAINTAINED. WHERE SPRINKLER PROTECTION EXISTS AND IS FUNCTIONAL, MAINTAIN IT WITHOUT
- INTERRUPTION WHILE OPERATIONS ARE BEING PERFORMED. IF OPERATIONS ARE PERFORMED CLOSE TO AUTOMATIC SPRINKLER HEADS, SHIELD THE INDIVIDUAL HEADS TEMPORARILY WITH GUARDS.

GENERAL NOTES

A. FIELD VERIFY ALL DIMENSIONS.

SHEET KEYNOTES

EXISTING DUMPSTER AND WALL ENCLOSURE TO REMAIN. EXISITNG FENCE TO BE REMOVED.

EXISITNG TRANSPORTAINER TO REMAIN.

BUILDING FOOTPRINT AREA TO BE REMOVED - REFER TO CIVIL. CONCRETE SURFACE TO BE REMOVED - REFER TO


EXISTING GRAVEL

EXISTING FENCE/GATE TO REMAIN

— — — — — DEMOLITION

M. INSPECT THE LOCATION OF WORK AT THE COMPLETION OF OPERATIONS EACH DAY SMOKING BY PERSONNEL PERFORMING WORK IN OR NEAR THE PROJECT STRUCTURE SHALL

N. KEEP THE ROOF SEALED TIGHT DURING DEMOLITION AND CONSTRUCTION.

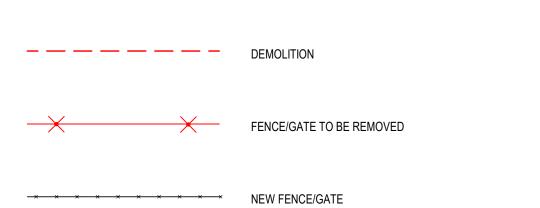

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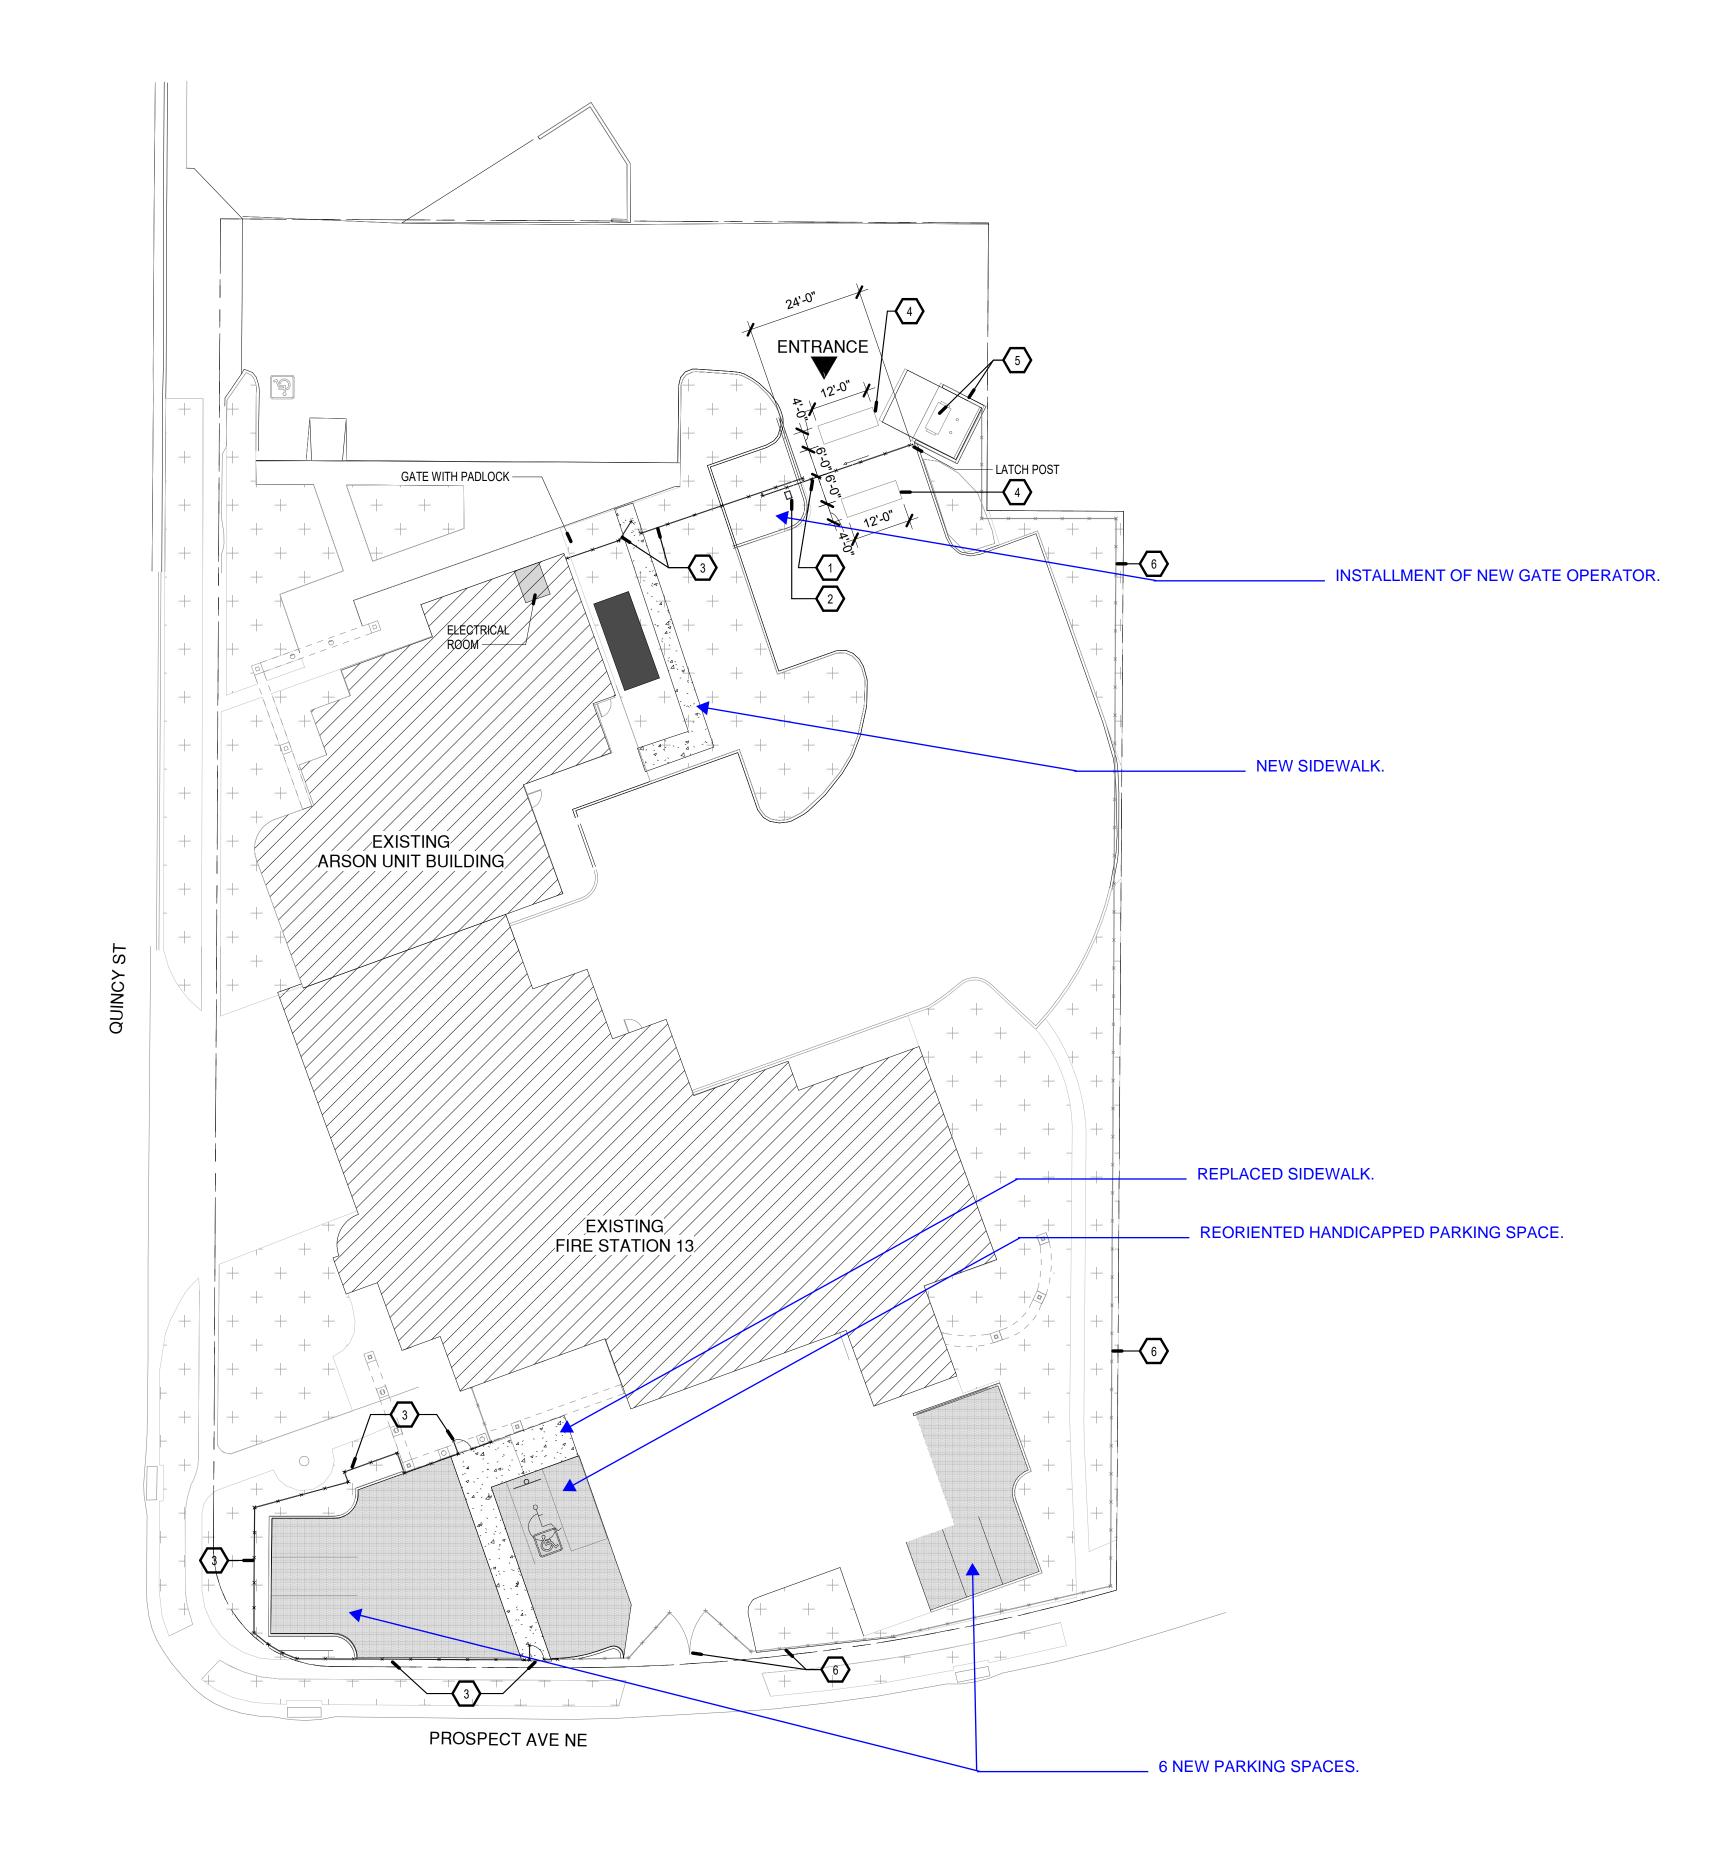
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PROJECT TITLE:

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CITY OF ALBUQUERQUE DEPARTMENT OF MUNICIPAL DEVELOPMENT


	ABQ FIRE STAT	ΓΙΟΝ	13			
DRAWING TITLE:	DEMOLITION	PLAI	N			
Design Review Committee	City Engineer Approval	ın Update	Mo	./Day/Yr.		Mo./Day/Yr.
		Last Design				
Permit Set	City Project No. P7215.01 NTP#13		Мар No. H-17-Z	DWG.	102	Sheet 11 of 1



NEW SITE PLAN

1" = 20'-0"


Plan North

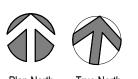


2 6

GENERAL NOTES A. FIELD VERIFY ALL DIMENSIONS. SHEET KEYNOTES 1 INSTALL NEW 32' -0" SLIDER GATE; BASIS OF DESIGN LIFT MASTER ELITE SERIES CSL24UL HIGH TRAFFIC COMMERCIAL SLIDE GATE OPERATOR, BASIS INSTALL NEW FENCE/GATE PER MANUFACTURER'S DETAILS ADDRESSED IN SPECIFICATIONS AS REQUESTED PER WARRANTY. 4 1.5" X 1/4" SAWCUT WITH POURABLE CRACK FILLER EXISTING DUMPSTER AND WALL ENCLOSURE TO REMAIN. 6 EXISTING CHAINLINK PERIMETER FENCE AND GATES SHALL REMAIN. **BUILDING FOOTPRINT** NEW PAVEMENT - REFER TO CIVIL NEW SIDEWALK - REFER TO CIVIL EXISTING GRAVEL + + + PROPERTY LINE × × × × × × × × × × EXISTING FENCE/GATE TO REMAIN $\times \hspace{-0.4cm} \times \hspace{$ __ _ _ _ EASEMENT LINE WATER VALVE EXISTING FIRE HYDRANT © 2019 Studio Southwest Architects, Inc. Duplication or reproduction by any means without the express written consent of Studio Southwest Architects, Inc. is a violation of federal and international law. The information contained in this document 2101 Mountain Road NW Suite B | Albuquerque NM 87104 is the intellectual property of Studio Southwest Architects, Inc. and all rights thereto are reserved. 505-843-9639 | www.studioswarch.com CITY OF ALBUQUERQUE DEPARTMENT OF MUNICIPAL DEVELOPMENT PROJECT TITLE: ABQ FIRE STATION 13 DRAWING TITLE: **NEW SITE PLAN** Mo./Day/Yr. City Engineer Approval Design Review Committee Mo./Day/Yr.

Permit Set

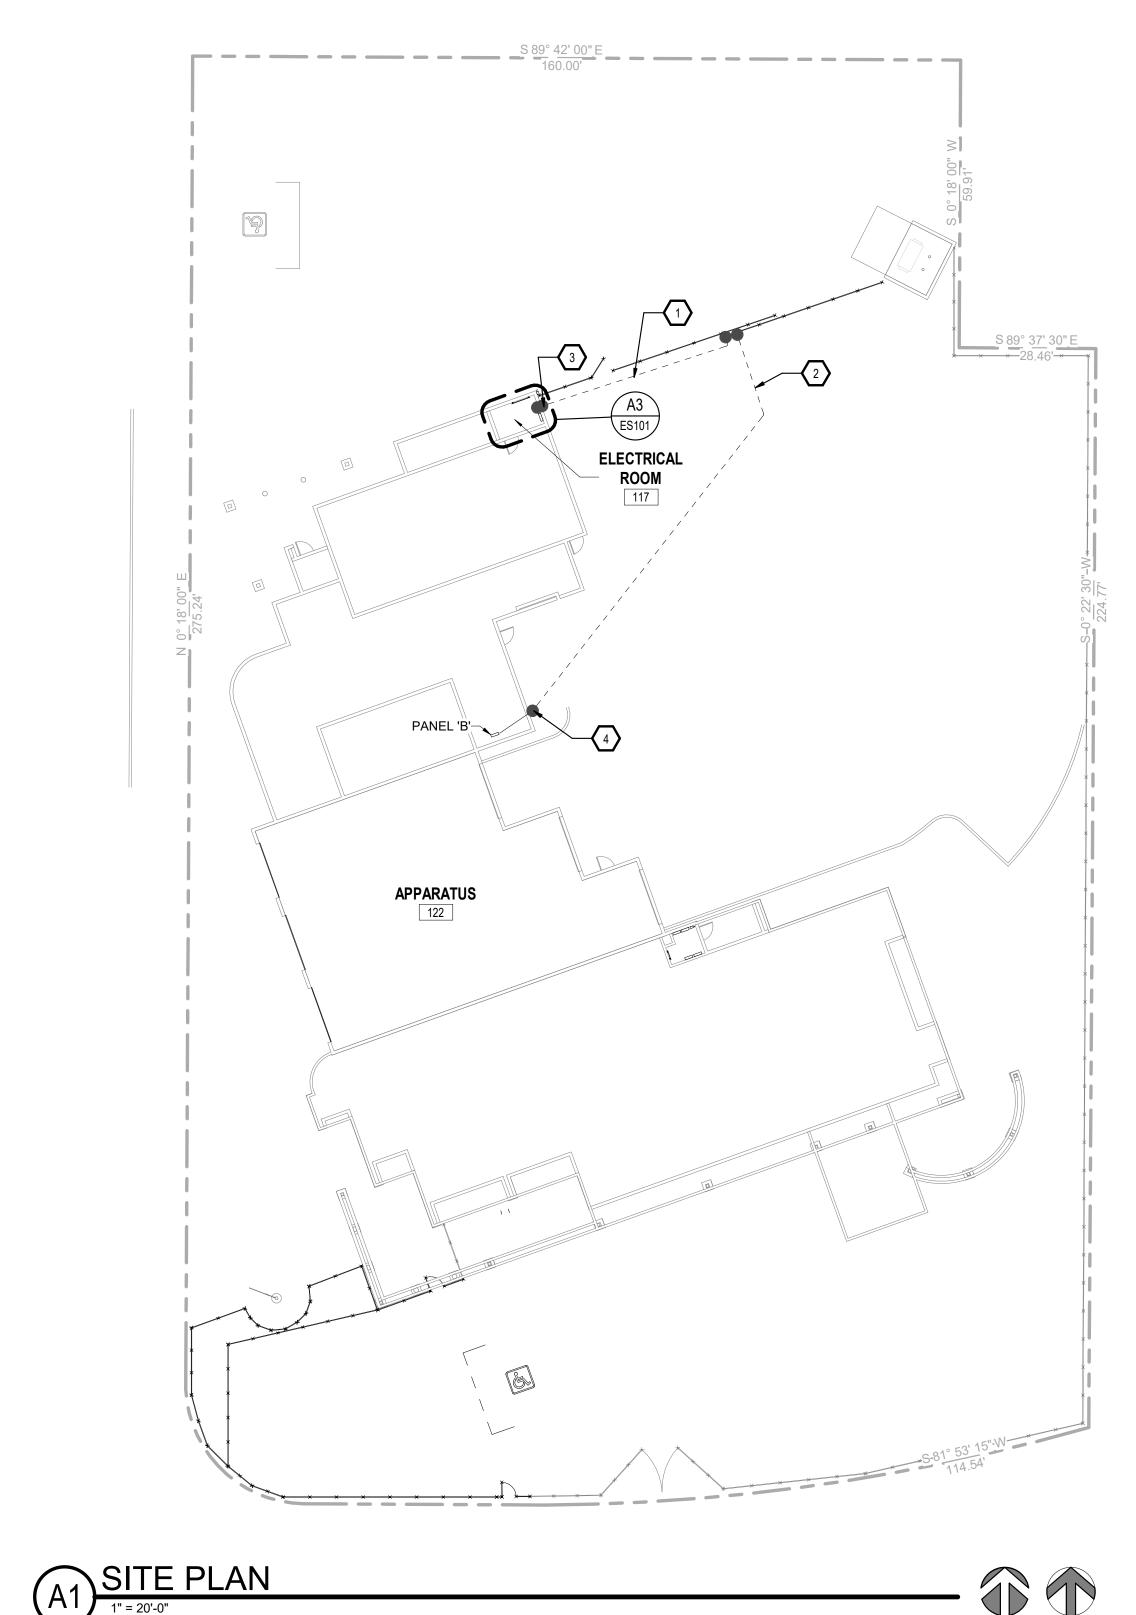

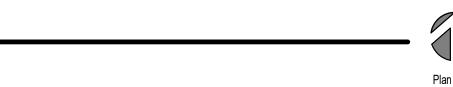





- A. THE ELECTRICAL CONTRACTOR SHALL BE RESPONSIBLE FOR COORDINATING AND PROVIDING ALL WORK INDICATED ON THE DRAWINGS, THIS CONSISTS OF FURNISHING ALL LABOR, EQUIPMENT, SUPPLIES, AND MATERIALS IN ADDITION TO PERFORMING ALL OPERATIONS.
- B. PERFORM ALL ELECTRICAL WORK IN A NEAT AND WORKMANLIKE MANNER IN FULL COMPLIANCE WITH ALL APPLICABLE CODES AND THE NATIONAL ELECTRICAL CODE (NEC). ALL LOCAL AND STATE REQUIREMENTS SHALL BE OBSERVED DURING THE PERFORMANCE OF THIS
- C. CONTRACTOR SHALL PROMPTLY NOTIFY THE ENGINEER OF ANY AND ALL DISCREPANCIES FOUND BETWEEN CONTRACT DOCUMENTS AND/OR LEGAL OR SAFETY REQUIREMENTS.
- CONTRACTOR SHALL FOLLOW ALL MANUFACTURER RECOMMENDED INSTALLATION GUIDELINES. CONTRACTOR SHALL FIELD VERIFY EXISTING CONDITIONS PRIOR TO COMMENCING WORK AND NOTIFY ENGINEER OF ANY DISCREPANCIES. ALL CONDUCTORS SHALL BE COPPER, RATED FOR 600 VOLTS WITH TYPE THHN/THWN, 90 DEGREE INSULATION UNLESS OTHERWISE NOTED. MINIMUM WIRE SIZE SHALL BE #12 AWG FOR POWER CIRCUITS. CONDUCTORS SHALL BE SOLID WIRE FOR #12 AWG AND STRANDED FOR #10 AWG OR LARGER. ALL WIRING SHALL BE RUN IN CONDUIT INCLUDING LOW VOLTAGE CONTROL WIRING. SIGNAL WIRING MAY BE RUN IN PVC
- CONDUIT OR PVC FLEXIBLE TUBING. G. GENERALLY, CONDUIT SHALL BE EMT, 3/4" MINIMUM. IN AREAS SUBJECT TO DAMAGE CONDUIT SHALL BE RIGID OR IMC TYPE. ALL CONDUIT
- SHALL BE CONCEALED UNLESS NOTED OTHERWISE. H. SUPPORT ALL CONDUIT INDEPENDENTLY FROM THE BUILDING STRUCTURE. DO NOT SUPPORT FROM VENTILATION DUCTS, MECHANICAL
- PIPING, SUSPENDED CEILING GRIDS, OR THEIR HANGERS. USE NEC ACCEPTABLE METHODS OF SUPPORT. INSTALL EXTERIOR WIRING AND DEVICES IN CONDUIT WITH WEATHERPROOF FITTINGS AND IN WEATHERPROOF BOXES. ALL DEVICES AND EQUIPMENT SHALL BE RATED FOR EXTERIOR USE.
- MAINTAIN A MINIMUM OF 24 INCH SEPARATION BETWEEN POWER CONDUITS AND SIGNAL CONDUITS AS PRACTICAL. ROUTE CONDUITS TO NOT CROSS EACH OTHER. EXPOSED CONDUIT AND DEVICE BOXES IN ALL AREAS FOR COMMUNICATION AND POWER.


KEYED NOTES:

- 1. PROVIDE AND INSTALL 3/4" UNDERGROUND CONDUIT W/ PULLSTRING FOR DATA TO ELECTRICAL ROOM.
- 2. PROVIDE AND INSTALL 3/4" UNDERGROUND CONUIT WITH #12, #12NEU, #12
- GND TO PANEL "B" WEIGHT ROOM. 3. TRANSITION TO DATA CONDUIT TO 3/4" EMT CONDUIT ABOVE GROUND.
- PROVIDE "LB" CONDUIT FITTINGS ON EACH SIDE OF WALL PENETRATION. SEAL WALL PENETRATION WITH FIRE SEALANT.
- 4. TRANSITION TO POWER CONDUIT TO 3/4" EMT CONDUIT ABOVE GROUND WITH #12, #12NEU, #12 GND. PROVIDE "LB" CONDUIT FITTINGS ON EXTERIOR SIDE OF WALL PENETRATION. SEAL WALL PENETRATION WITH FIRE SEALANT. ROUTE CONDUIT ABOVE CEILING TO PANEL.

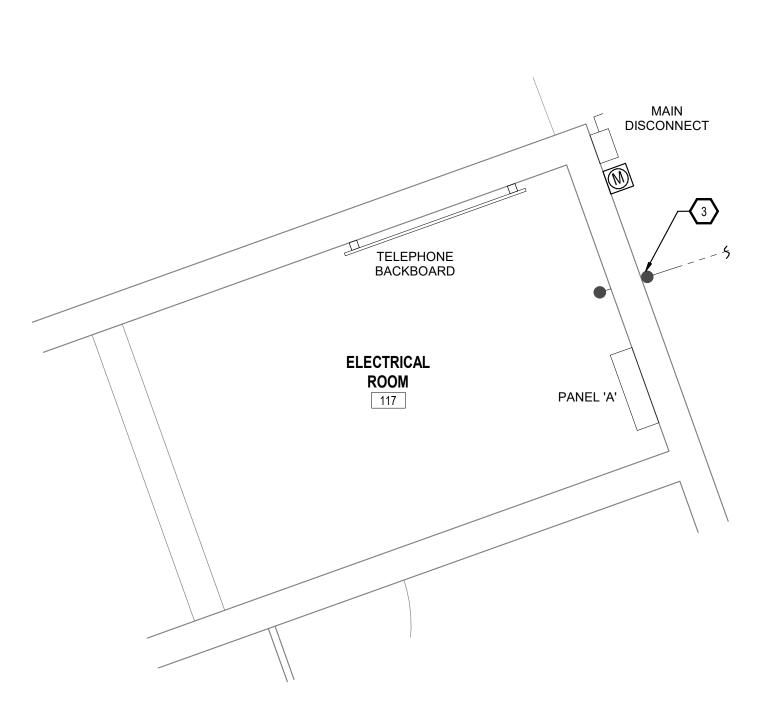

1	$\sqrt{\frac{1}{2}}$	ELECTRICAL ROOM 117
- ((HO	1/2" = 1'-0"

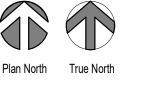

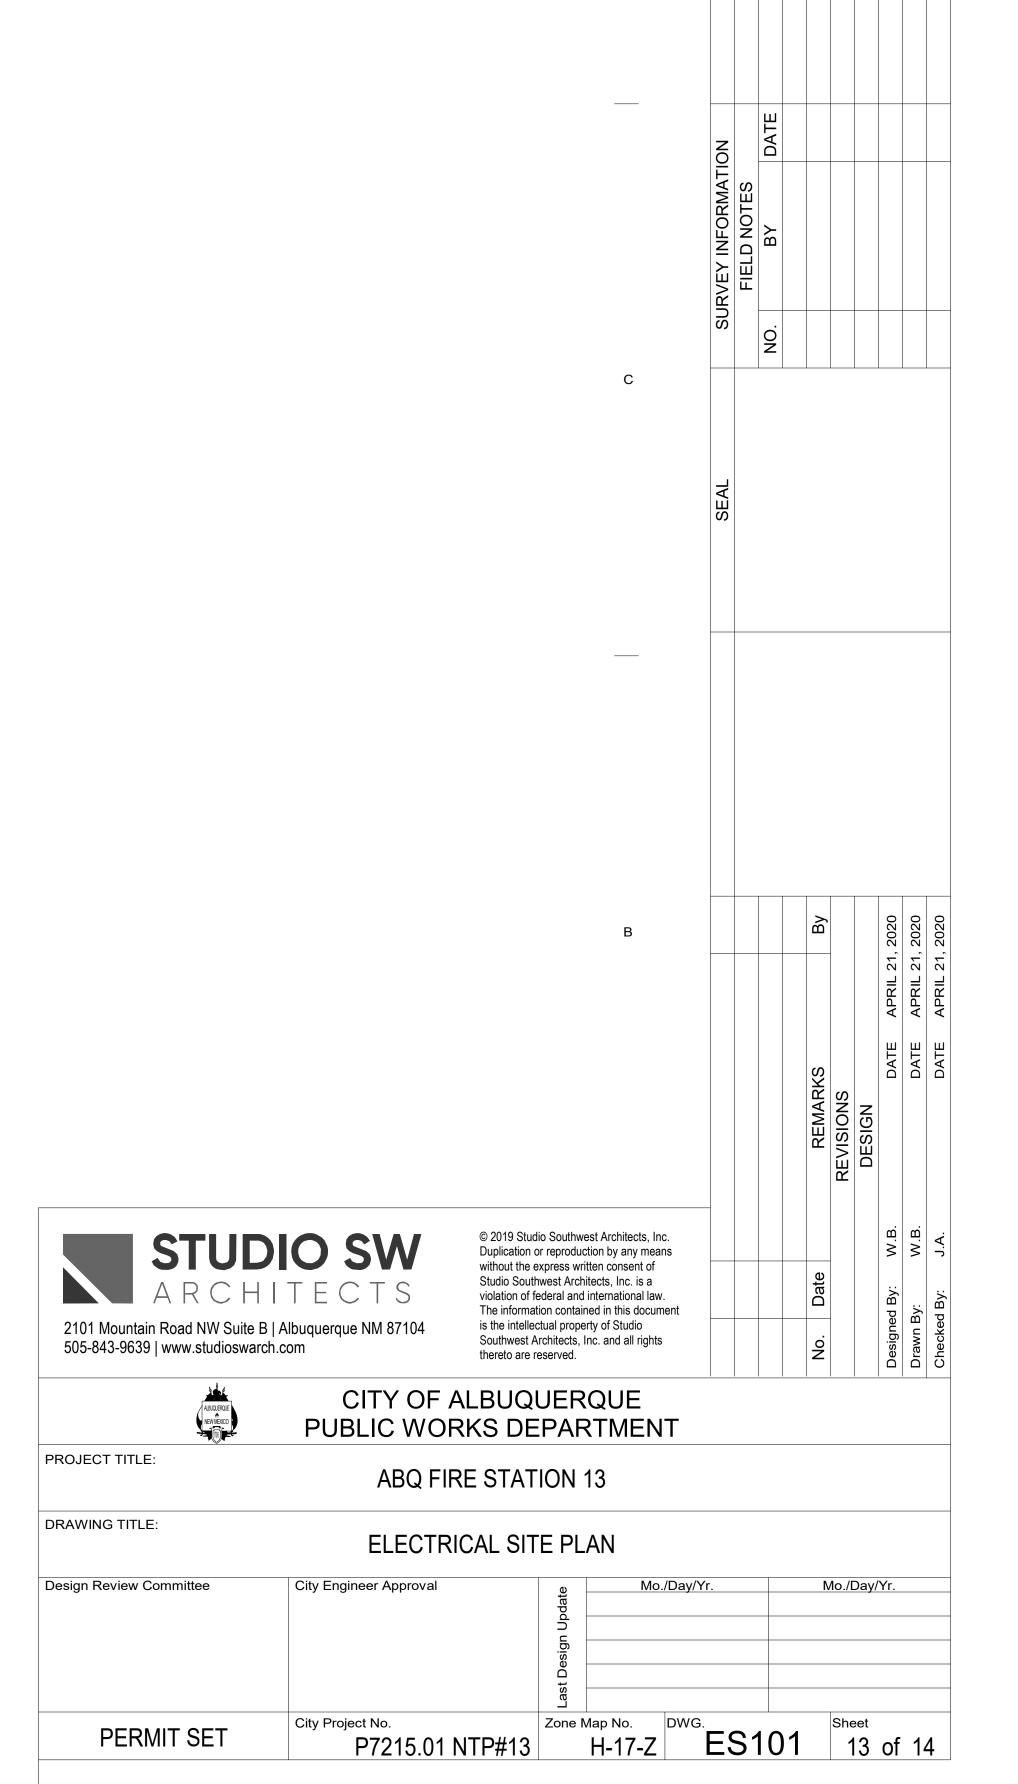

DATE DATE DATE DATE DATE DATE DATE

		PANEL 'B' (I	MODIF	IED	CI	RCU	ITS	S ARE SHADED)		
VOLT PHAS WIRE FEED	E: :	120/208V 3 PHASE 4 WIRE BOTTOM	FRAME: MAIN: ENCLOS LOCATIO	URE:	125A FRAM MAIL LUGS NEMA 1 DO ELECTRICA	ONLY OOR-IN-DO	OR	MIN AIC RATING: CIRCUITS: MOUNTING:	10,000 30 RECESSI	ED
СКТ	BKR	LOAD DESCRIPTION	VA	CONN	ECTED VA	LOAD	VA	LOAD DESCRIPTION	BKR	СКТ
NO	RTNG	LOAD DESCRIPTION	VA	Α	В	С	VA	EOAD DESCRIPTION	RTNG	NO
1	20A/1	RECEPT EAST/MIDDLE	720	1720			1000	HVAC UNIT	20A/1	2
3	20A/1	RECEPT EAST/MIDDLE	720		1440		720	LIGHTS	20A/1	4
5	20A/1	RECEPT EAST/MIDDLE	720			1440	720	LIGHTS	20A/1	6
7	20A/1	RECEPT WEST/MIDDLE	720	1440			720	RECEPT NORTH OF HALL	20A/1	8
9	20A/1	RECEPT WEST/MIDDLE	720		2880		2160	WATER HEATER (RESTROOM)	30A/1	10
11	20A/1	RECEPT WEST/MIDDLE	720			1620	900	ASST. CHIEF A.C. (WEST)	20A/1	12
13	20A/1	RECEPT CAPT. OFF./HALL	720	1920		N.	1200	GATE CONTROLLER	20A/1	14
15	20A/1	RECEPT CAPT. OFFICE	540	31	540			SPARE	20A/1	16
17	20A/1	RECEPT CAPT. OFFICE	540	A		540		SPARE	20A/1	18
19	20A/1	UNKNOWN	720	720			-	SPARE	20A/1	20
21			3120		6722		3602	3		22
23	50A/2	RANGE	3120	80		6722	3602	AIR COMPRESSOR	50A/3	24
25			1441	5043			3602			26
27	20A/3	RTU-5	1441		1441			SPACE		28
29			1441			1441		SPACE		30
	W	CONNECTED LOAD (V	/A) PER PHASE	10843	13023	11763	35629	TOTAL CONNECTED LOAD (VA)		
			non #20 muantos littipitati - ili			Wro(107538)	99.0	TOTAL CONNECTED LOAD (AMPS)		

LOAD SUMMARY

FEEDER NAME	DESIGN AMPS	CONNECTED AMPS	DEMAND AMPS	DEMAND %	SPARE AMPS	FEEDER LOAD %
В	100	99	69.3	69.30%	10.7	69.30%

1	2	3	4		
				DAT TAG	DATE DATE DATE DATE
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				FORMATION NOTES	Δ
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PANEL 'B' (MOD)	FIED CIRCUITS ARE SHADED)			c S	
VOLTAGE: 120/208V FR PHASE: 3 PHASE MA WIRE: 4 WIRE EN				AF AF	
CKT BKR LOAD DESCRIPTION V	CONNECTED VA LOAD A B C LOAD DESCRIPTION BKR RTNG	CKT S NO			
1 20A/1 RECEPT EAST/MIDDLE 7: 3 20A/1 RECEPT EAST/MIDDLE 7: 5 20A/1 RECEPT EAST/MIDDLE 7:					
7 20A/1 RECEPT WEST/MIDDLE 73 9 20A/1 RECEPT WEST/MIDDLE 73	0 1440 720 RECEPT NORTH OF HALL 20A/1 0 2880 2160 WATER HEATER (RESTROOM) 30A/1	1 8 1 10			
	0 1920 1200 GATE CONTROLLER 20A/1	1 12 1 14 1 16			
17 20A/1 RECEPT CAPT. OFFICE 5-19 20A/1 UNKNOWN 73	0 SPARE 20A/1	1 18 1 20			
21 50A/2 RANGE 31	0 6722 3602	22 3 24 26			35 00
25 27 20A/3 RTU-5 29	1 1441 SPACE -	28 30		В	By By APRIL 21, 2020
	SE 10843 13023 11763 35629 TOTAL CONNECTED LOAD (VA) 99.0 TOTAL CONNECTED LOAD (AMPS)				S)
	LOAD SUMMARY				REWARKS REVISIONS DESIGN
	FEEDER NAME DESIGN CONNECTED DEMAND AMPS DEMAND % AMPS AMPS			STUDIO SW © 2019 Studio Southwest Architects, Inc. Duplication or reproduction by any means without the express written consent of	
	7 0	69.30%		STUDIOSW ARCHITECTS 2101 Mountain Road NW Suite B Albuquerque NM 87104 505-843-9639 www.studioswarch.com © 2019 Studio Southwest Architects, Inc. Duplication or reproduction by any means without the express written consent of Studio Southwest Architects, Inc. is a violation of federal and international law. The information contained in this document is the intellectual property of Studio Southwest Architects, Inc. and all rights thereto are reserved.	Vo. Date
				CITY OF ALBUQUERQUE PUBLIC WORKS DEPARTMENT	
				PROJECT TITLE: ABQ FIRE STATION 13	
				DRAWING TITLE: ELECTRICAL SCHEDULES	M (D N)
				Design Review Committee City Engineer Approval prod City Engineer Approval Design Review Committee City Engineer Approval Prod City Engineer Approval Design Review Committee Mo./Day/Yr.	Mo./Day/Yr.
				PERMIT SET City Project No.	Sheet