



09/29/2020

DATE ISSUED: AUGUST 24, 2020 2020031 SITE PLAN

A101



ROUCH ARCHITECTS CITY OF ALBUQUERQUE CHANGE TO PLANS NARRATIVE

JPMorgan Chase Bank Eubank Blvd NE and Chico Rd NE 340 Eubank Blvd., Albuquerque, New Mexico 87123

DATE: 12/07/2020

LOCATION: 340 Eubank Blvd., Albuquerque, New Mexico 87123

CITY OF ALBUQUERQUE PERMIT #: BP-2020-36265

ROUCH PROJECT # 2020031

Hello,


With this letter, the applicant would like to remove the two drive-up ATM's from this project.

Please reference revised drawings A101 Site Plan, MEP102 MEP Site Plan, E202 Photometric Plan, and TC102 Telecom Site Plan, indicating removal, uploaded to the "Drawings" folder.

Please let us know if you have any questions or if we can provide any additional information.

Sincerely,

Mark A. Rouch, AIA LEED AP *Principal*

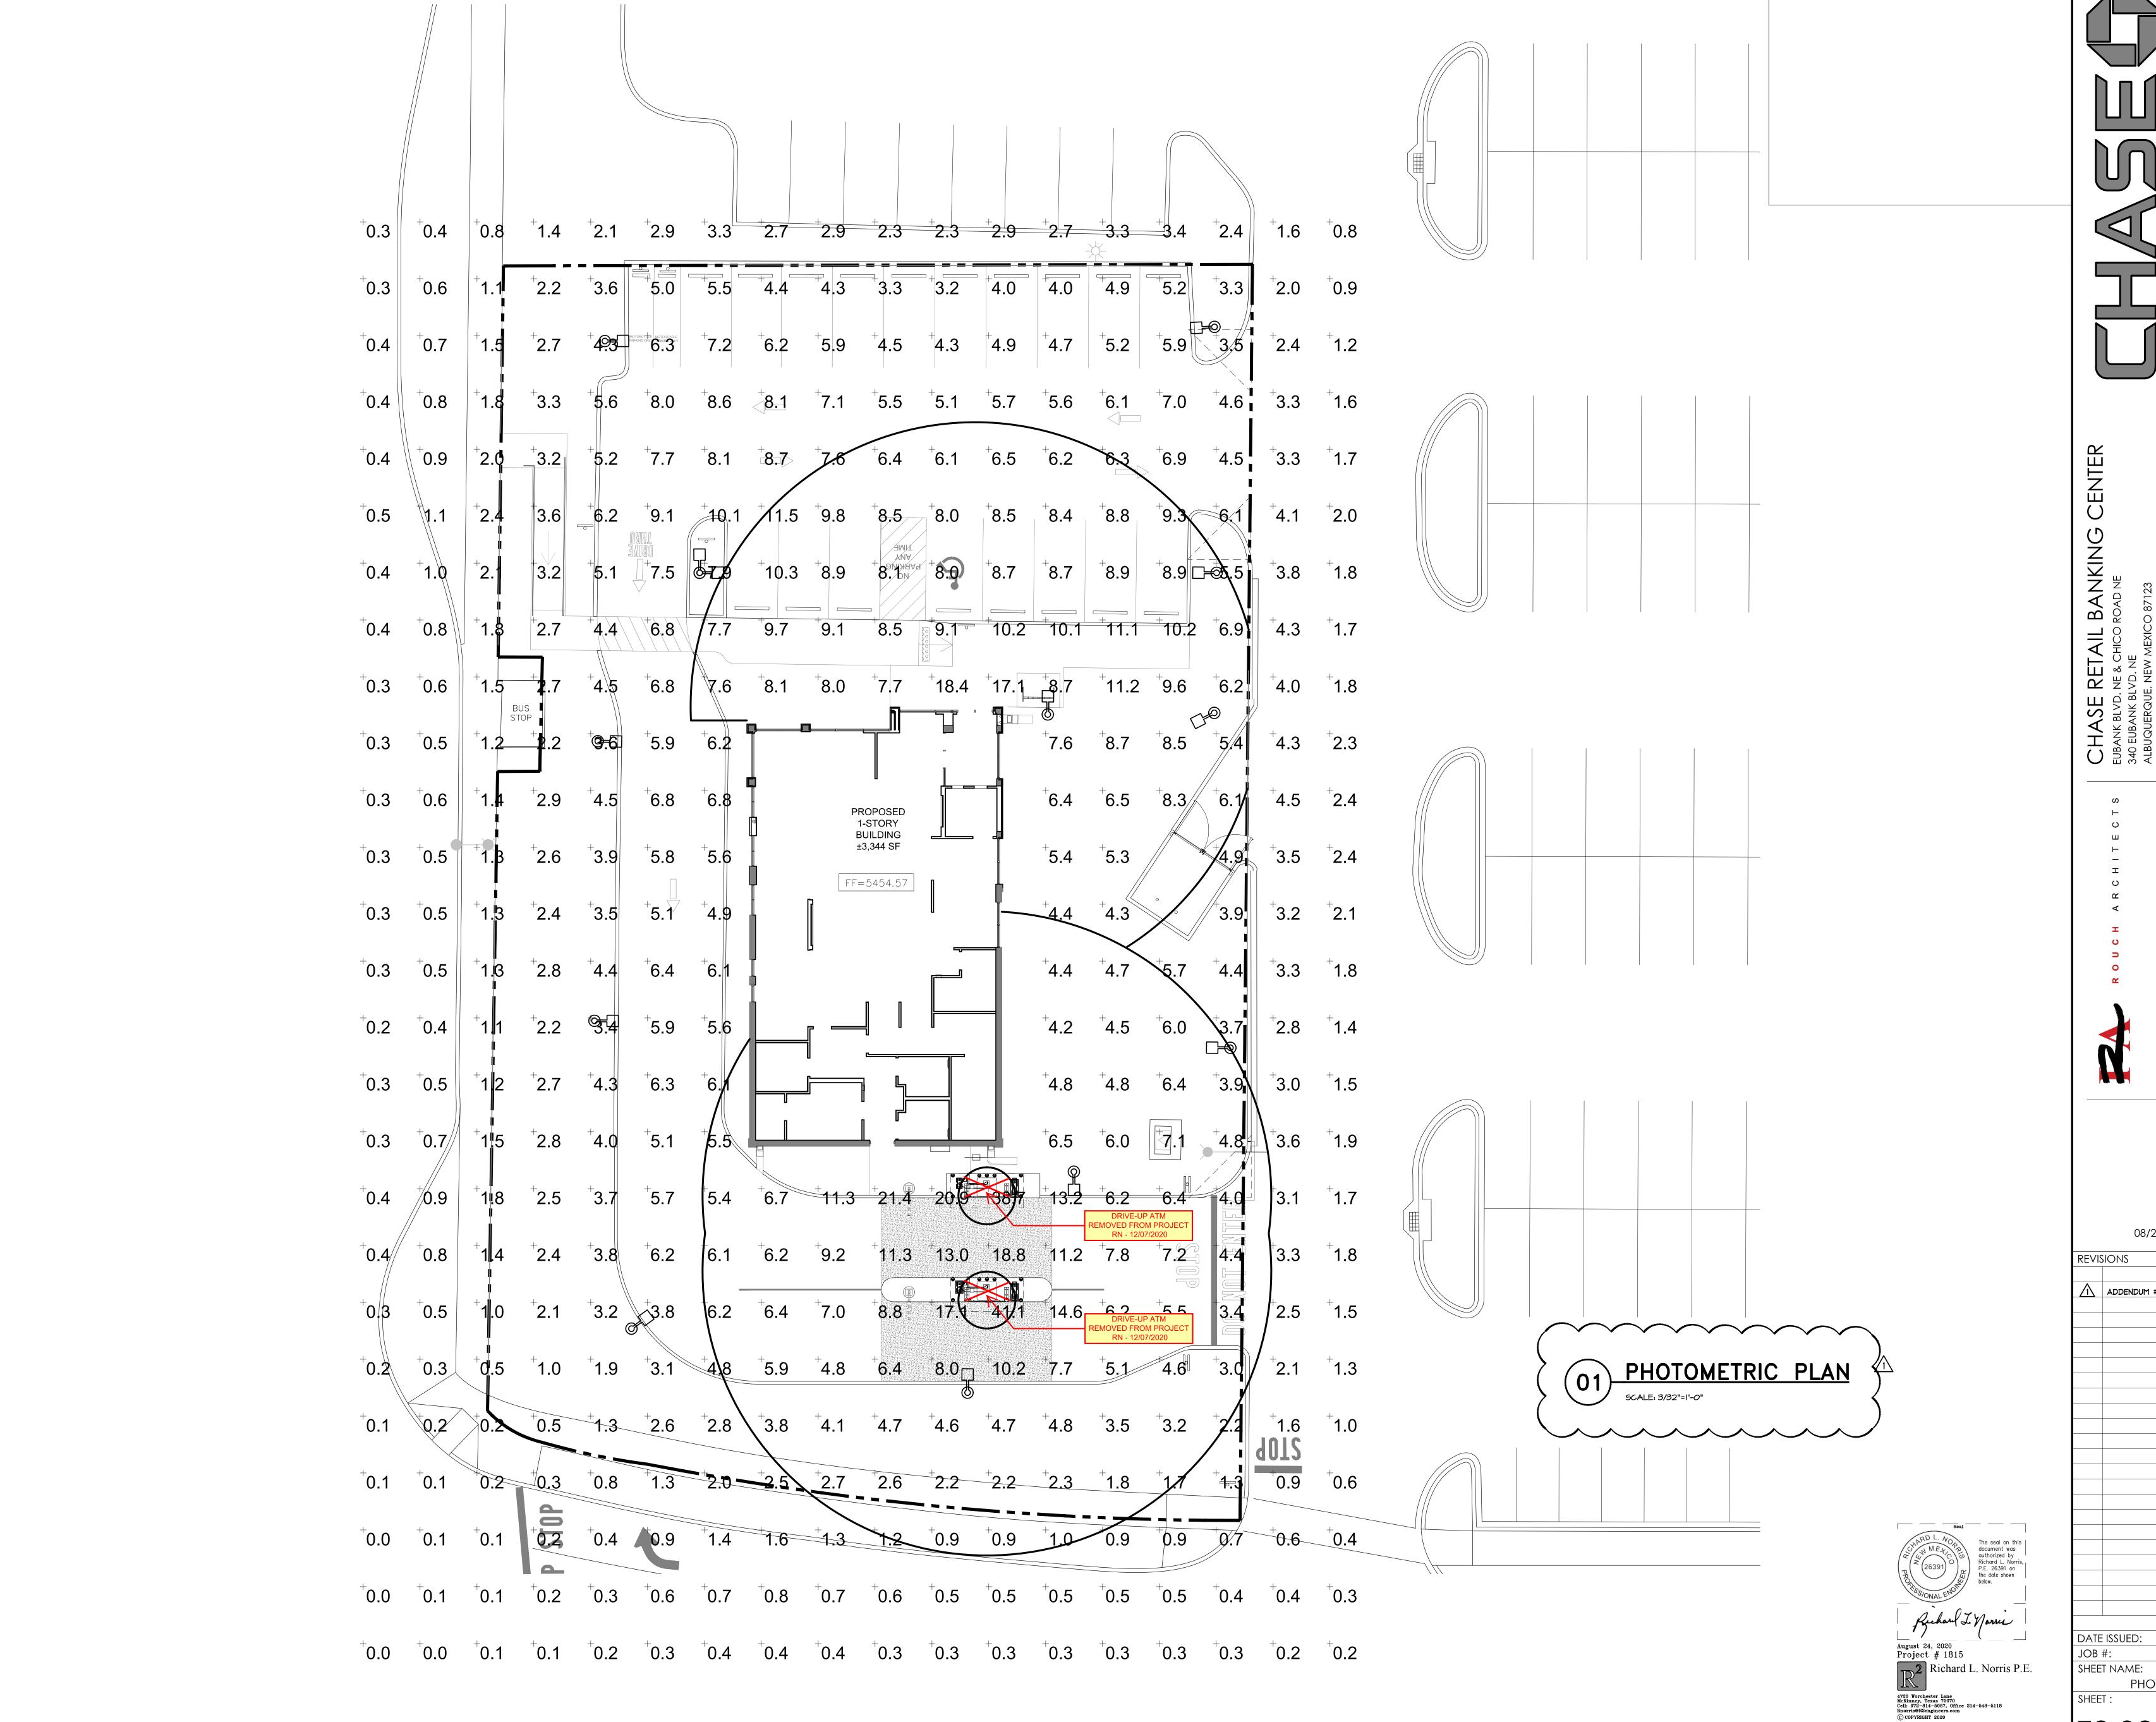


1445 ROSS AVER SUITE 5700 DALLAS, TEXAS 214.997.6029

08/24/2020

ADDENDUM #I 09.11.2020

AUGUST 24, 2020 DATE ISSUED: SHEET NAME: PHOTOMETRIC PLAN

E2.02

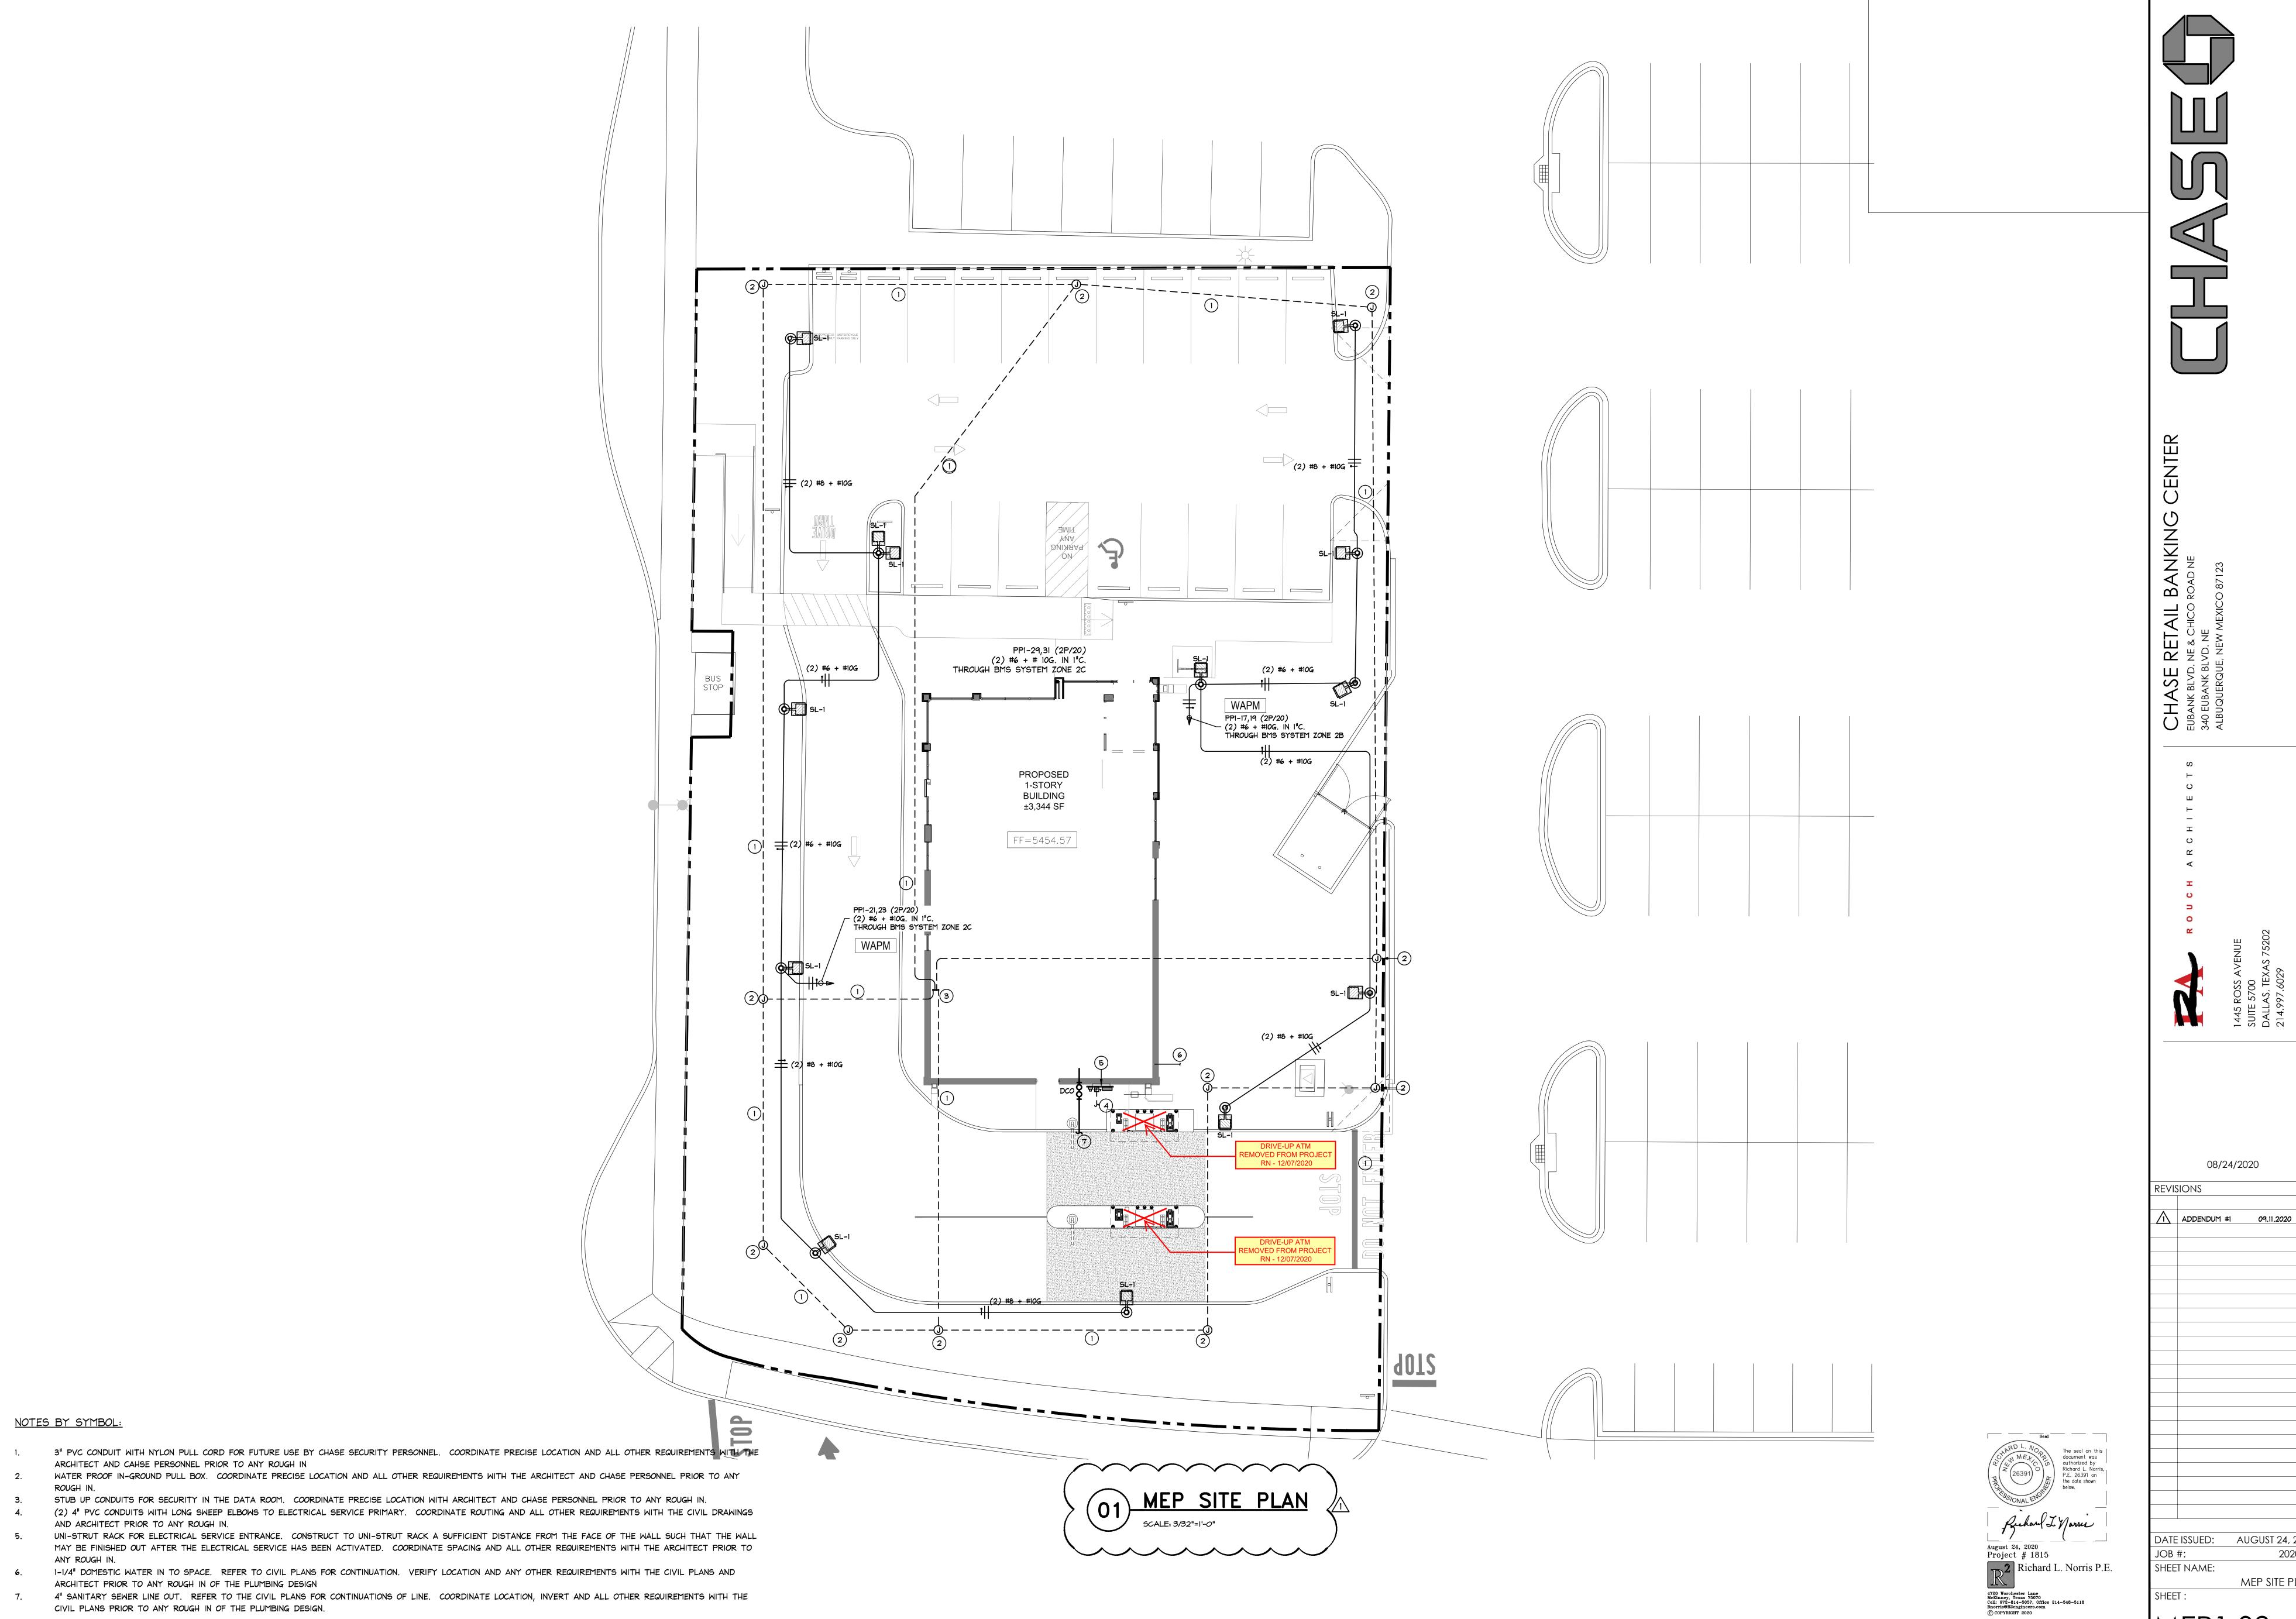

AUGUST 24, 2020 202003 MEP SITE PLAN

From: Carlos Iglesias
To: Wolfenbarger, Jeanne
Cc: "Matthew Cragun"

 Subject:
 RE: AA Comments Project # PR 2020-004485

 Date:
 Tuesday, October 6, 2020 1:58:14 PM

Attachments: <u>image005.jpg</u>

image006.jpg image002.jpg

CHASE - 340 EUBANK BOULEVARD.pdf

External

Ms. Wolfenbarger,

Good afternoon. I hope everything is well.

Please find the updated plans for PR 2020-004485 340 Eubank Blvd. NE

We replaced the bicycle rack and updated the curb to reflect dwg 2415.

Thank you in advance for your assistance and let us know if you have any questions.

Respectfully,

Carlos J. Iglesias

Designer Engineer Cumulus Design 2080 North Highway 360 Suite 240 Grand Prairie, Texas 75050

Tel: (214) 235 0367 Ext. 111

Fax: (214) 235 0546

CumulusLogo



From: Wolfenbarger, Jeanne [mailto:jwolfenbarger@cabq.gov]

Sent: Thursday, October 01, 2020 5:05 PM

To: Carlos Iglesias

Subject: RE: AA Comments Project # PR 2020-004485

Mr. Inglesias:

Thank you for your updates. The only comments I had left were on the curb and bike rack details. Our bike rack detail is specific per Albuquerque's "Integration Development Ordinance" (See

requirements below.)

Also, the curb detail you have shown is not the same as our requirements based on the flowline being in the middle of the curb shown on your detail. (You have called out 2415 on the site plan, but I was not sure which detail you are referring to. For Transportation, we just want to make sure it is 6" -8" high, basically.) You may call out a specific detail on 2415 or provide a separate detail. I just thought that the note on the site plan and the detail sheet under "Drainage" were conflicting.

- All bicycle racks shall be designed according to the following guidelines:
 - a. The rack shall be a minimum 30 inches tall and 18 inches wide.
 - b. The bicycle frame shall be supported horizontally at two or more places. Comb/toaster racks are not allowed.
 - c. The rack shall be designed to support the bicycle in an upright position. See the IDO for additional information.
 - d. The rack allows varying bicycle frame sizes and styles to be attached.
 - e. The user is not required to lift the bicycle onto the bicycle rack.
 - f. Each bicycle parking space is accessible without moving another bicycle.
- Bicycle racks shall be sturdy and anchored to a concrete pad.



JEANNE WOLFENBARGER

manager for transportation

- o 505.924-3991
- e <u>iwolfenbarger@cabq.gov</u>

cabq.gov/planning

From: Carlos Iglesias [mailto:Carlos@cumulusdesign.net]

Sent: Thursday, October 01, 2020 12:50 PM

To: Wolfenbarger, Jeanne

Subject: AA Comments Project # PR 2020-004485

Cc: 'Matthew Cragun'

External

Good afternoon. I hope everything is well.

Please find the requested updated plans and documents for project # PR 2020-004485.

Let us know if you have any questions.

Respectfully,

Carlos J. Iglesias

Designer Engineer Cumulus Design 2080 North Highway 360 Suite 240 Grand Prairie, Texas 75050

Tel: (214) 235 0367 Ext. 111

Fax: (214) 235 0546



From: Wolfenbarger, Jeanne [mailto:jwolfenbarger@cabg.gov]

Sent: Monday, September 28, 2020 3:25 PM

To: matt@cumulusdesign.net Subject: AA Comments

Mr. Cragun,

Please see attached comments for the Administrative Amendment. Thanks!



JEANNE WOLFENBARGER


manager for transportation

- 0 505.924-3991
- e jwolfenbarger@cabq.gov


cabq.gov/planning

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\\SERVER-PC\\SERVER\2020 CDC PROJECTS\\CDC20014 — EUBANK BLVD, ALBUQUERQUE\\PLANS\\SITE PLAN CDC20014.DWG

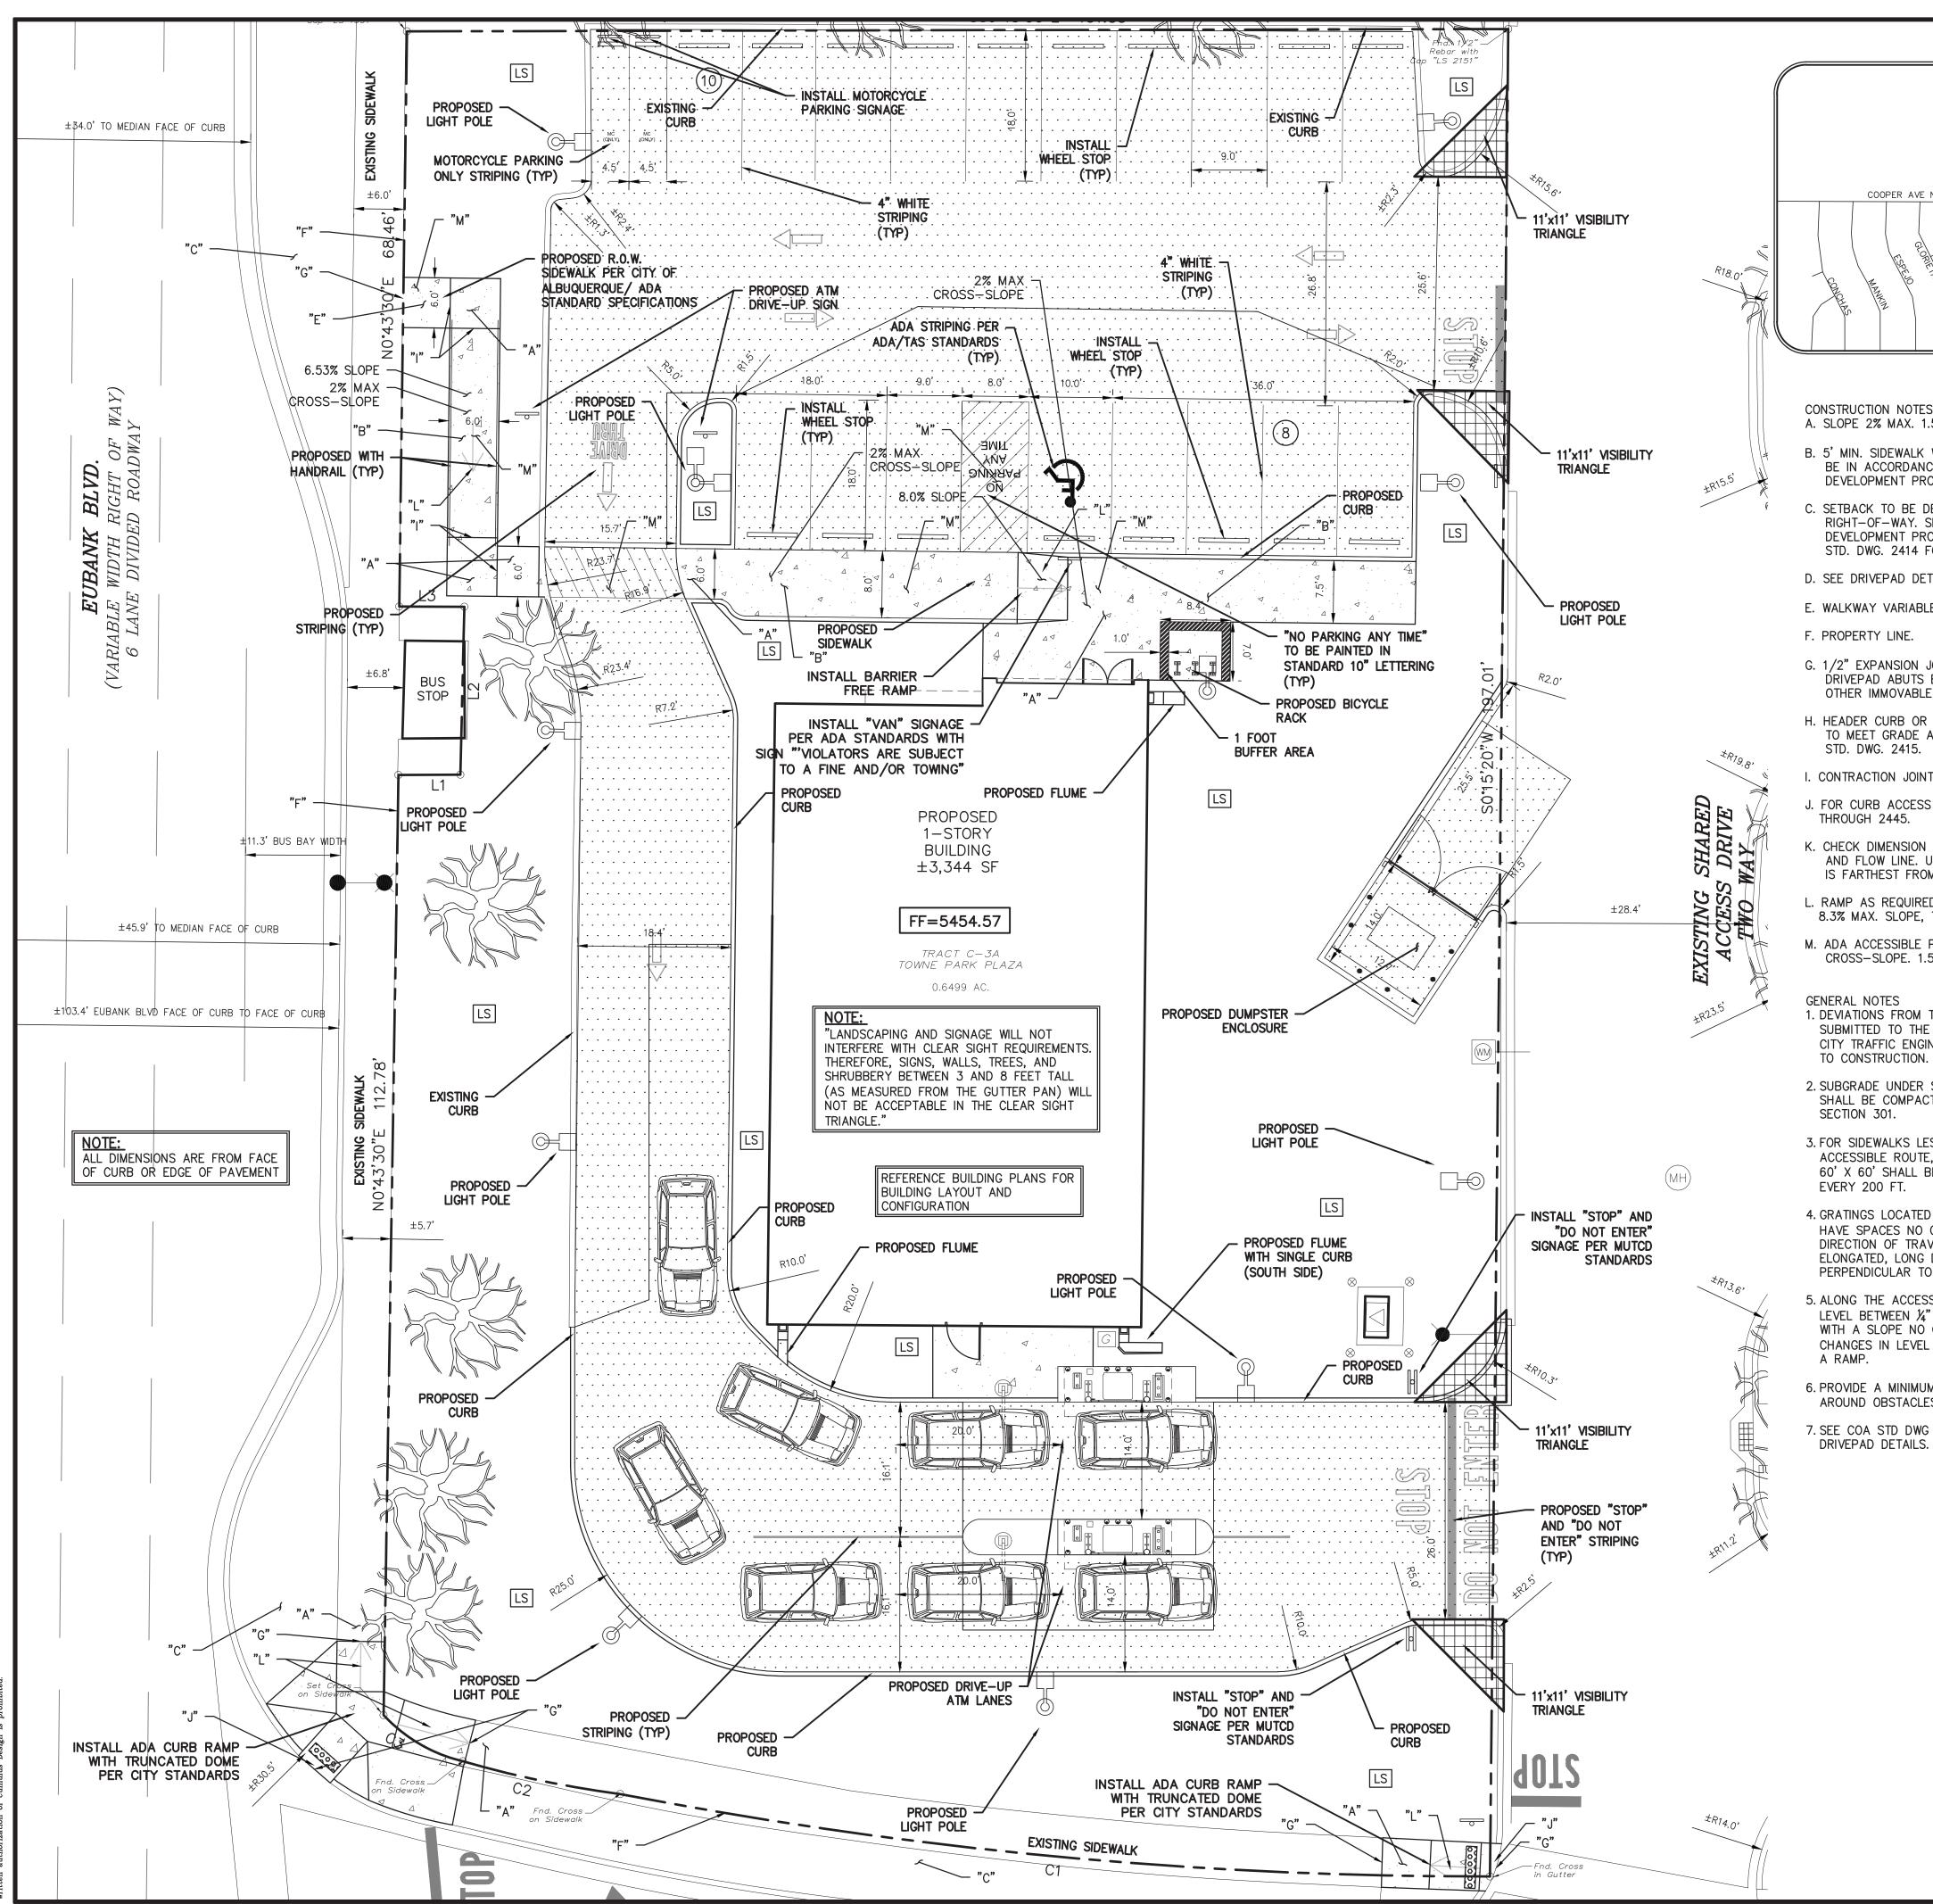

A. SLOPE 2% MAX. 1.5% PREFERRED SLOPE.

- B. 5' MIN. SIDEWALK WIDTH. SIDEWALK WIDTH SHALL BE IN ACCORDANCE WITH CHAPTER 23 OF DEVELOPMENT PROCESS MANUAL
- C. SETBACK TO BE DETERMINED BY AVAILABLE RIGHT-OF-WAY. SEE CHAPTER 7 OF DEVELOPMENT PROCESS MANUAL. ALSO SEE COA STD. DWG. 2414 FOR LANDSCAPE BUFFER.
- D. SEE DRIVEPAD DETAILS, DWG. 2425A AND 2425B.
- E. WALKWAY VARIABLE (4' MINIMUM).
- G. 1/2" EXPANSION JOINTS WHERE SIDEWALK OR DRIVEPAD ABUTS BUILDINGS, FENCES, WALLS OR OTHER IMMOVABLE OBJECTS.
- H. HEADER CURB OR INTEGRAL CURB AS REQUIRED TO MEET GRADE AT BACK OF SIDEWALK. SEE STD. DWG. 2415.
- I. CONTRACTION JOINTS.
- J. FOR CURB ACCESS RAMPS, SEE DWGS. 2440 THROUGH 2445.
- K. CHECK DIMENSION FROM BOTH PROPERTY LINE AND FLOW LINE. USE IN AREAS WHERE DRIVEPAD IS FARTHEST FROM INTERSECTION.
- L. RAMP AS REQUIRED TO MEET DRIVEPAD GRADE. 8.3% MAX. SLOPE, 7% PREFERRED SLOPE.
- M. ADA ACCESSIBLE PATHWAY. 2% MAX. CROSS-SLOPE. 1.5% PREFERABLE CROSS-SLOPE.
- 1. DEVIATIONS FROM THESE STANDARDS SHALL BE SUBMITTED TO THE CITY ENGINEER AND/OR CITY TRAFFIC ENGINEER FOR APPROVAL PRIOR TO CONSTRUCTION.
- 2. SUBGRADE UNDER SIDEWALKS AND DRIVEPADS SHALL BE COMPACTED IN ACCORDANCE WITH
- 3. FOR SIDEWALKS LESS THAN 60' WIDE ON ACCESSIBLE ROUTE, PASSING SPACE AT LEAST 60' X 60' SHALL BE PROVIDED AT LEAST EVERY 200 FT.
- 4. GRATINGS LOCATED IN WALKING SURFACE SHALL HAVE SPACES NO GREATER THAN 1/2" WIDE IN DIRECTION OF TRAVEL. IF OPENINGS ARE ELONGATED, LONG DIMENSION SHALL BE PLACED PERPENDICULAR TO DIRECTION OF TRAVEL.
- 5. ALONG THE ACCESSIBLE ROUTE, CHANGES IN LEVEL BETWEEN 1/4" AND 1/2" SHALL BE BEVELED WITH A SLOPE NO GREATER THAN 2H:1V. CHANGES IN LEVEL GREATER THAN 1/2" REQUIRE
- 6. PROVIDE A MINIMUM SIDEWALK WIDTH OF 4' AROUND OBSTACLES FOR ADA ACCESS.
- 7. SEE COA STD DWG 2425A AND 2425B FOR

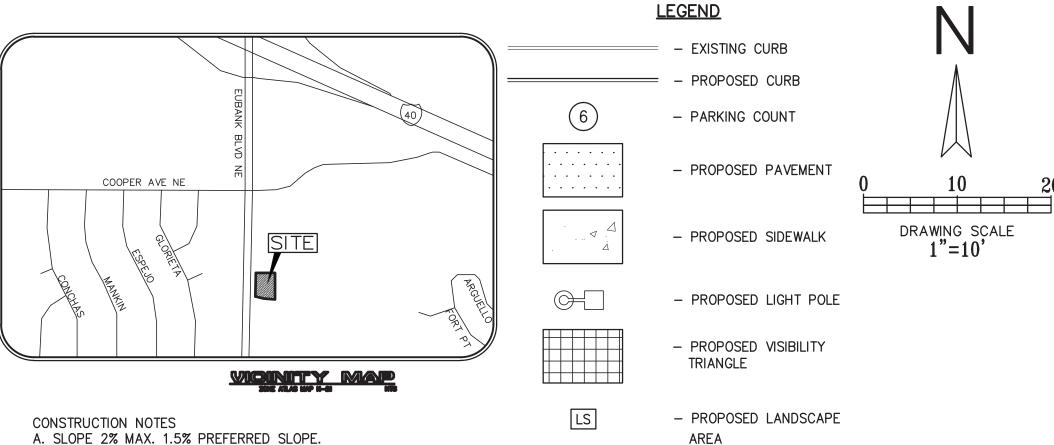SITE PLAN			
EXISTING ZONING: MX-L	/MIXED USE		
LAND USE:	FINANCIAL INSTITUTION		
LEASE ACREAGE:	0.650 ACRES (28,294 SF)		
BUILDING FOOT PRINT (TOTAL):	±3,344 SQUARE FEET		
OPEN SPACE REQUIRED (25% OF LOT ACREAGE):	±7,073 SQUARE FEET		
OPEN SPACE PROVIDED:	±10,283 SQUARE FEET (36.3%)		
BUILDING COVERAGE:	3,344/28,294: 11.82%		
APPROX EX. IMPERVIOUS AREA:	±18,636 SQUARE FEET (65.9%)		
APPROX PROPOSED IMPERVIOUS AREA::	±18,011 SQUARE FEET (63.7%)		
PARKING REQUIRED (3 PER 1000 SF OF PROPOSED BUILDING):	11 SPACES		
PARKING PROVIDED:	18 SPACES		
ACCESSIBLE PARKING REQUIRED (1 ACCESSIBLE SPACE/25 STANDARD SPACE):	1 SPACES		
PARKING PROVIDED (ACCESSIBLE):	1 SPACES		
REQUIRED STACKING SPACES:	4 SPACES PER ATM (8 TOTAL SPACES)		
PROVIDED STACKING SPACES:	4 SPACES PER ATM (8 TOTAL SPACES)		
BICYCLE SPACE: REQUIRED/PROVIDED	3/6 SPACES		
MOTORCYCLE SPACES: REQUIRED/PROVIDED	1/2 SPACES		

PROPERTY LINE CURVE TABLE						
CURVE	LENGTH	RADIUS	TANGENT	CHORD	CHORD BEARING	DELTA
C1	104.74	574.46	52.52	104.60	N84° 18' 39"W	10°26'49"
C2	19.72	574.46	9.86	19.72	N78° 06' 15"W	1°58'01"
С3	11.28	20.50	5.79	11.14	N61° 09' 34"W	31 ° 32'05"

NOTE:
LIGHT POLES SHOULD NOT BE INSTALLED IN PARKING SPACES AND DRIVEWAYS. CONTRACTOR MUST MAKE SURE THE LIGHT POLES ARE INSTALLED AWAY FROM EXISTING AND PROPOSED UNDERGROUND UTILITIES.

	PROF	PERTY LINE TABLE			
	LINE	BEARING LENGTH			
	L1	S89°16'30"E 8.00'			
	L2	N0°43'30"E 20.00'			
	L3	N89°16'30"W 8.00'			



CALL NM ONE-CALL SYSTEM SEVEN (7) DAYS PRIOR TO ANY EXCAVATION

THE BENCHMARKS ARE PROVIDED BASED ON THE ELEVATIONS PROVIDED BY SURVTEK CONSULTING SURVEYORS

BENCHMARK - ALBUQUERQUE CONTROL SURVEY BENCHMARK 5-K20 IS LOCATED IN THE NORTHEAST QUADRANT OF THE INTERSECTION OF MOON STREET AND CENTRAL AVENUE NE. THE STATION IS 39.1 FEET EAST OF THE CENTERLINE OF MOON STREET AND 43.5 FEET NORTH OF THE CENTERLINE OF CENTRAL AVENUE. THE STATION MARK IS A CITY OF ALBUQUERQUE SURVEY CONTROL DISC SET IN TOP OF THE CURB AND STAMPED 5-K20 ACS. PUBLISHED ELEVATION: 5429.995' (NAVD 1988).

ALBUQUERQUE MONUMENT "4-L22" N=1480509.445 E=1563610.492 CF=0.999643379 Delta $alpha = -00^{\circ}08'50.94"$ NMSP, Central Zone, NAD 27 Elevation=5586.425 NAVD88

CONTRACTOR SHALL COORDINATE WITH SURVEYOR FOR BENCHMARKS AND ELEVATIONS PRIOR TO CONSTRUCTION. ENGINEER NOT RESPONSIBLE FOR PROVIDING BENCHMARKS AND BEARINGS.

!!! CAUTION !!!

UNDERGROUND UTILITIES

EXISTING UTILITIES AND UNDERGROUND FACILITIES INDICATED ON THESE PLANS HAVE BEEN LOCATED FROM REFERENCE INFORMATION SUPPLIED BY VARIOUS PARTIES. THE ENGINEER DOES NOT ASSUME THE RESPONSIBILITY FOR THE UTILITY LOCATIONS SHOWN. IT SHALL BE THE SOLE RESPONSIBILITY OF THE CONTRACTOR(S) TO VERIFY THE HORIZONTALLY AND VERTICALLY LOCATION OF ALL UTILITIES AND UNDERGROUND FACILITIES PRIOR TO CONSTRUCTION, TO TAKE PRECAUTIONS IN ORDER TO PROTECT ALL FACILITIES ENCOUNTERED AND NOTIFY THE ENGINEER OF ALL CONFLICTS OF THE WORK WITH EXISTING FACILITIES. THE CONTRACTOR SHALL PROTECT AND MAINTAIN ALL UTILITIES FROM DAMAGE DURING CONSTRUCTION. ANY DAMAGE BY THE CONTRACTOR TO UTILITIES SHALL BE REPAIRED OR REPLACED BY THE CONTRACTOR AT THEIR OWN EXPENSE.

CALL: NEW MEXICO ONE CALL @ NM 811 AT LEAST 48 HRS PRIOR TO CONSTRUCTION.

SIT

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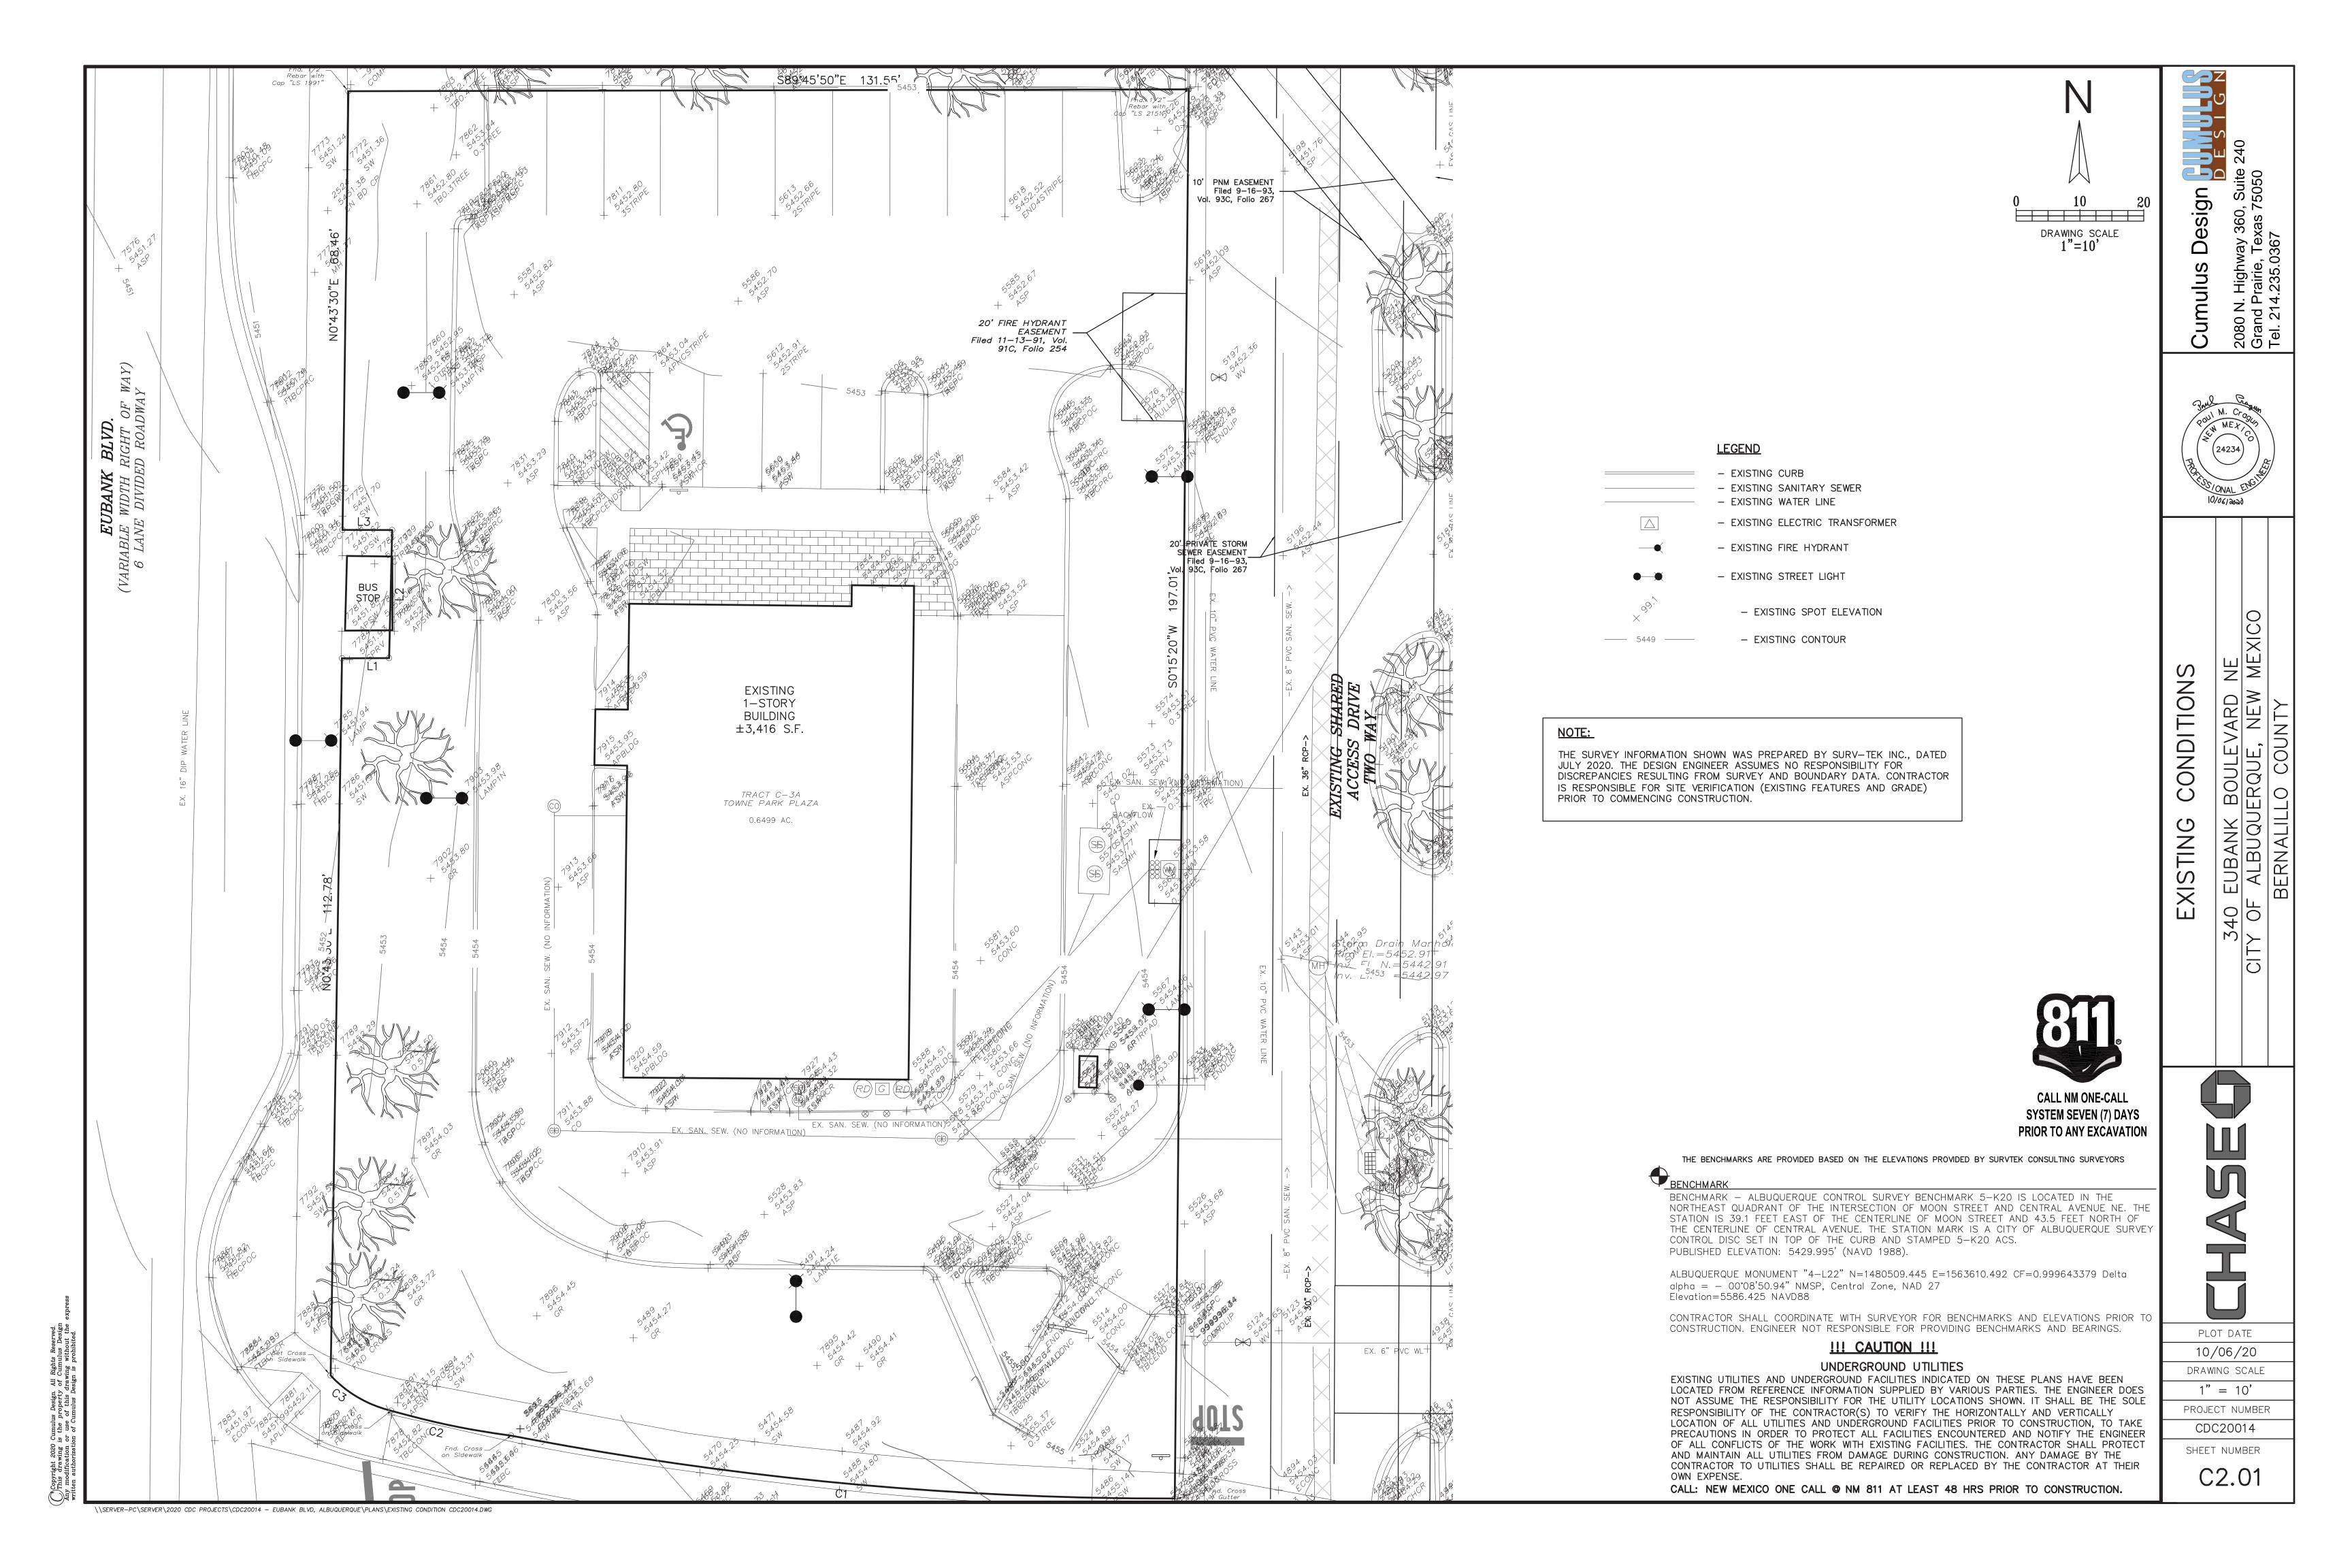
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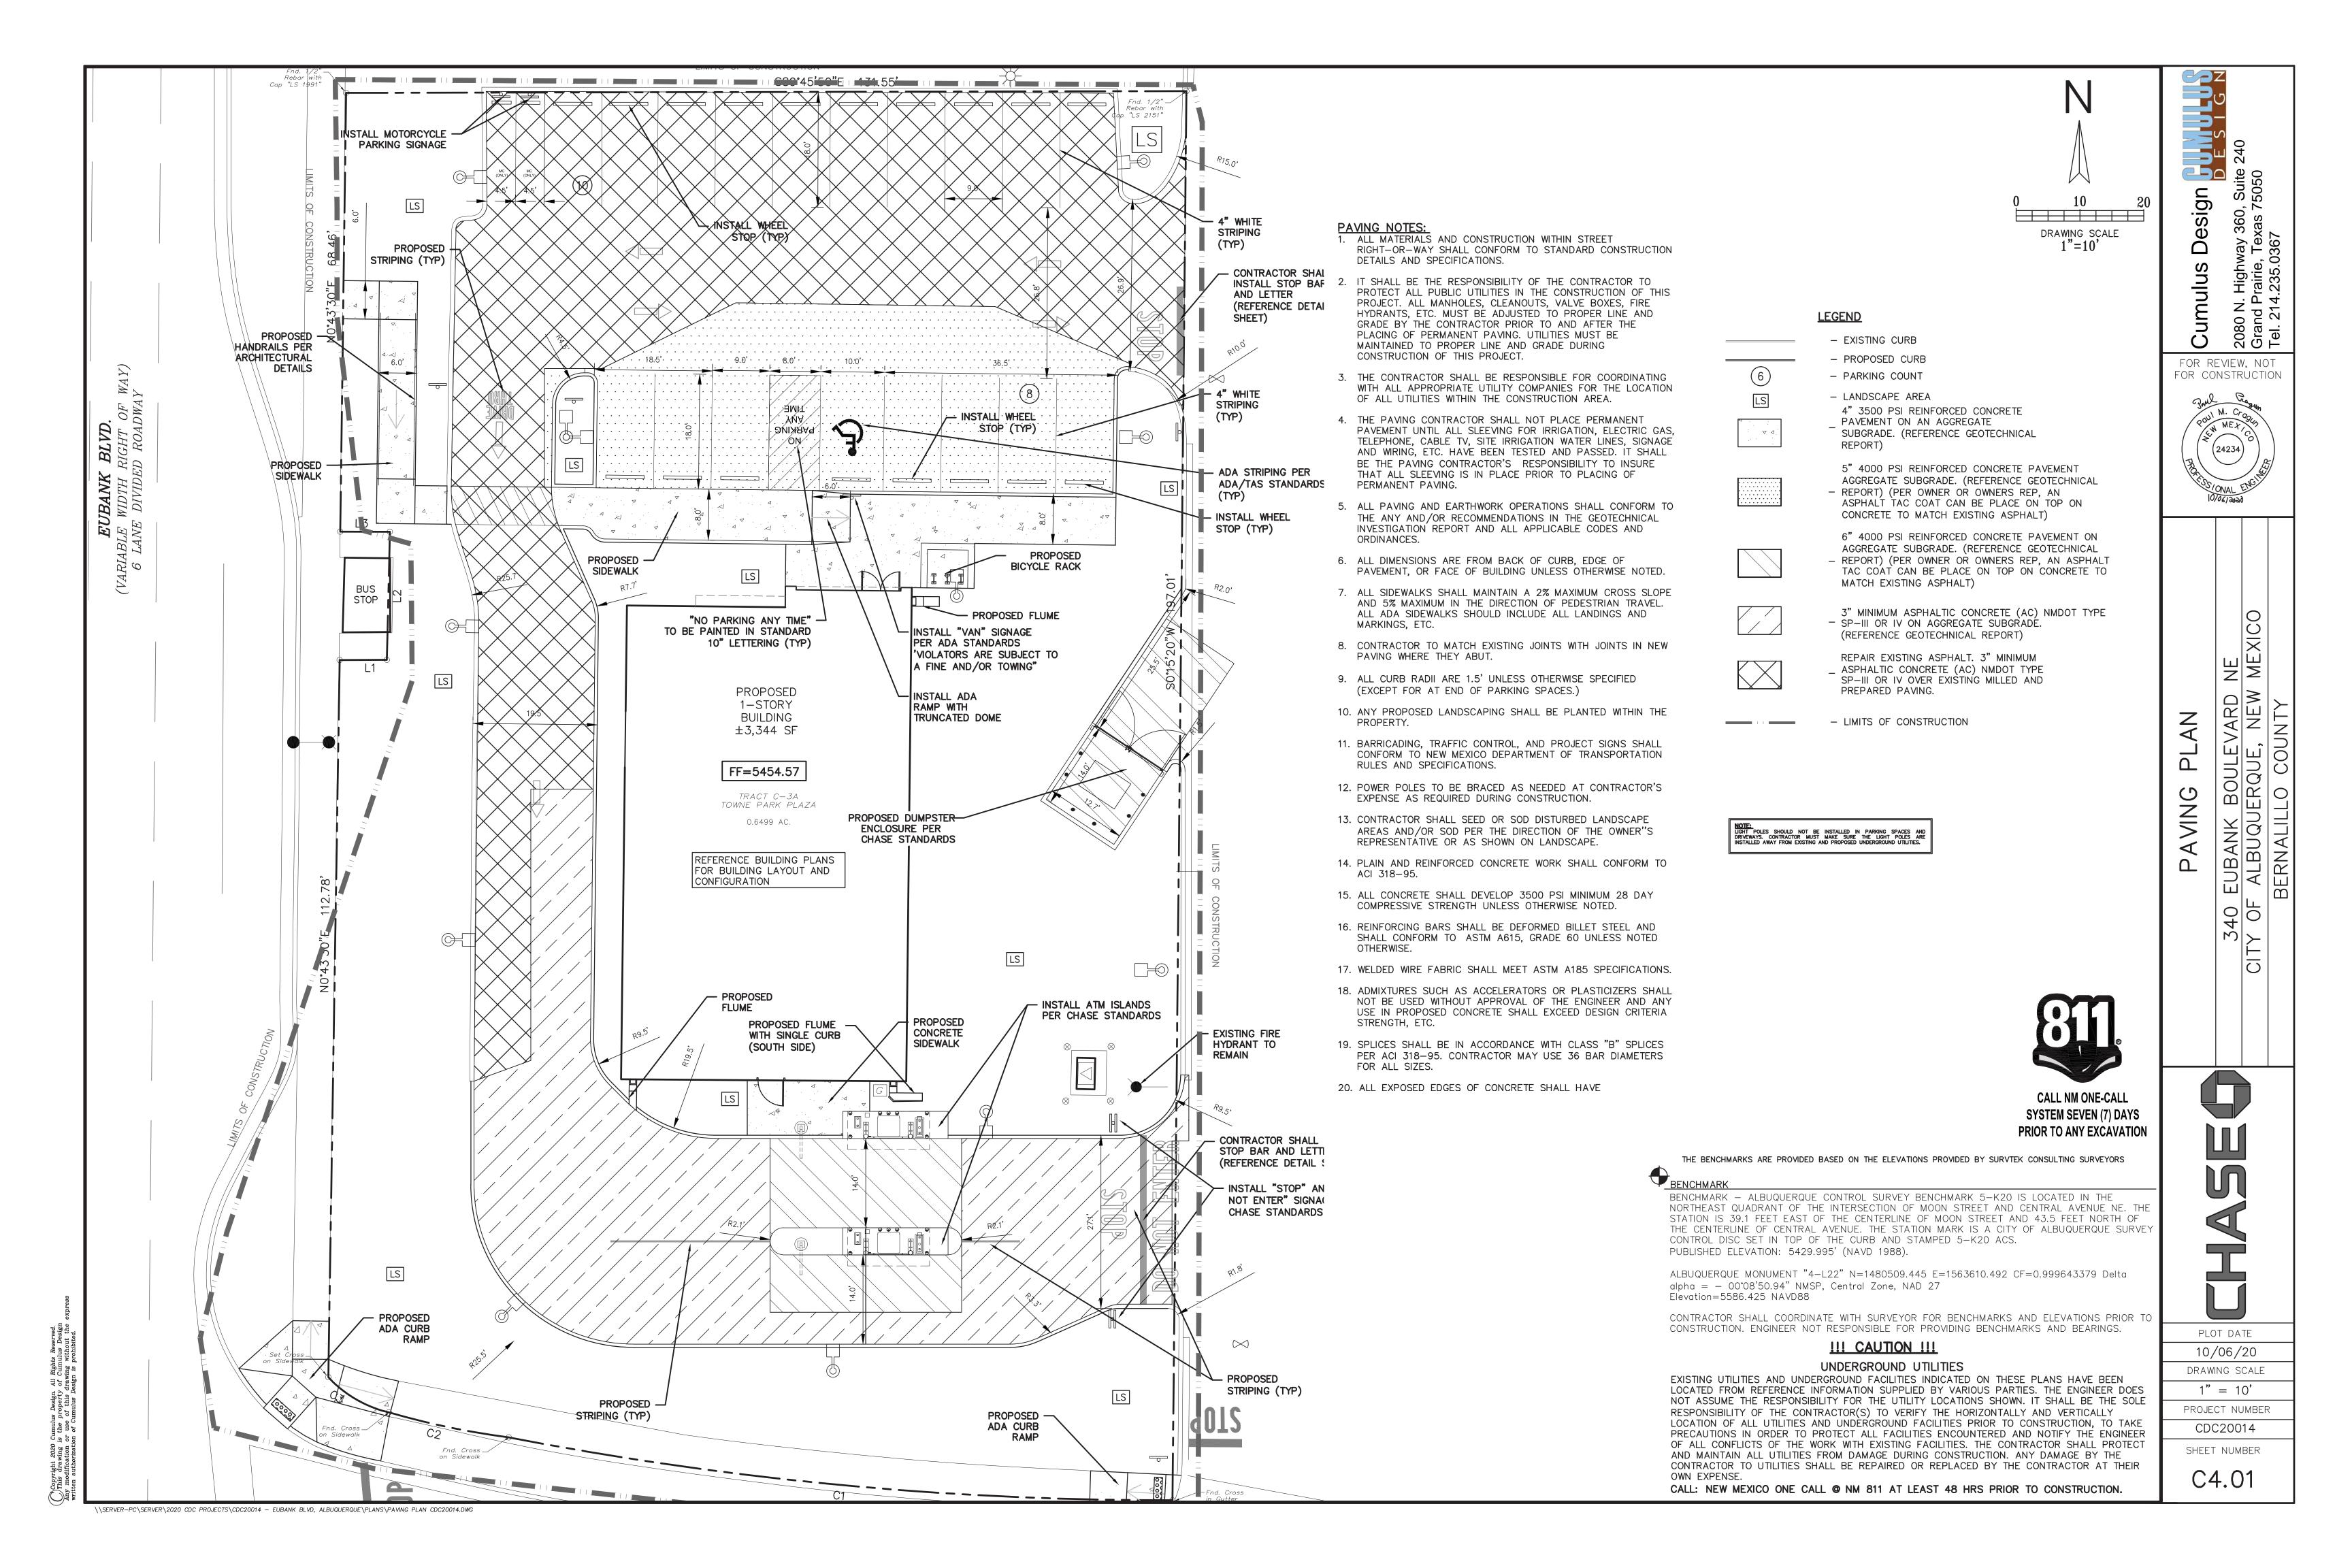
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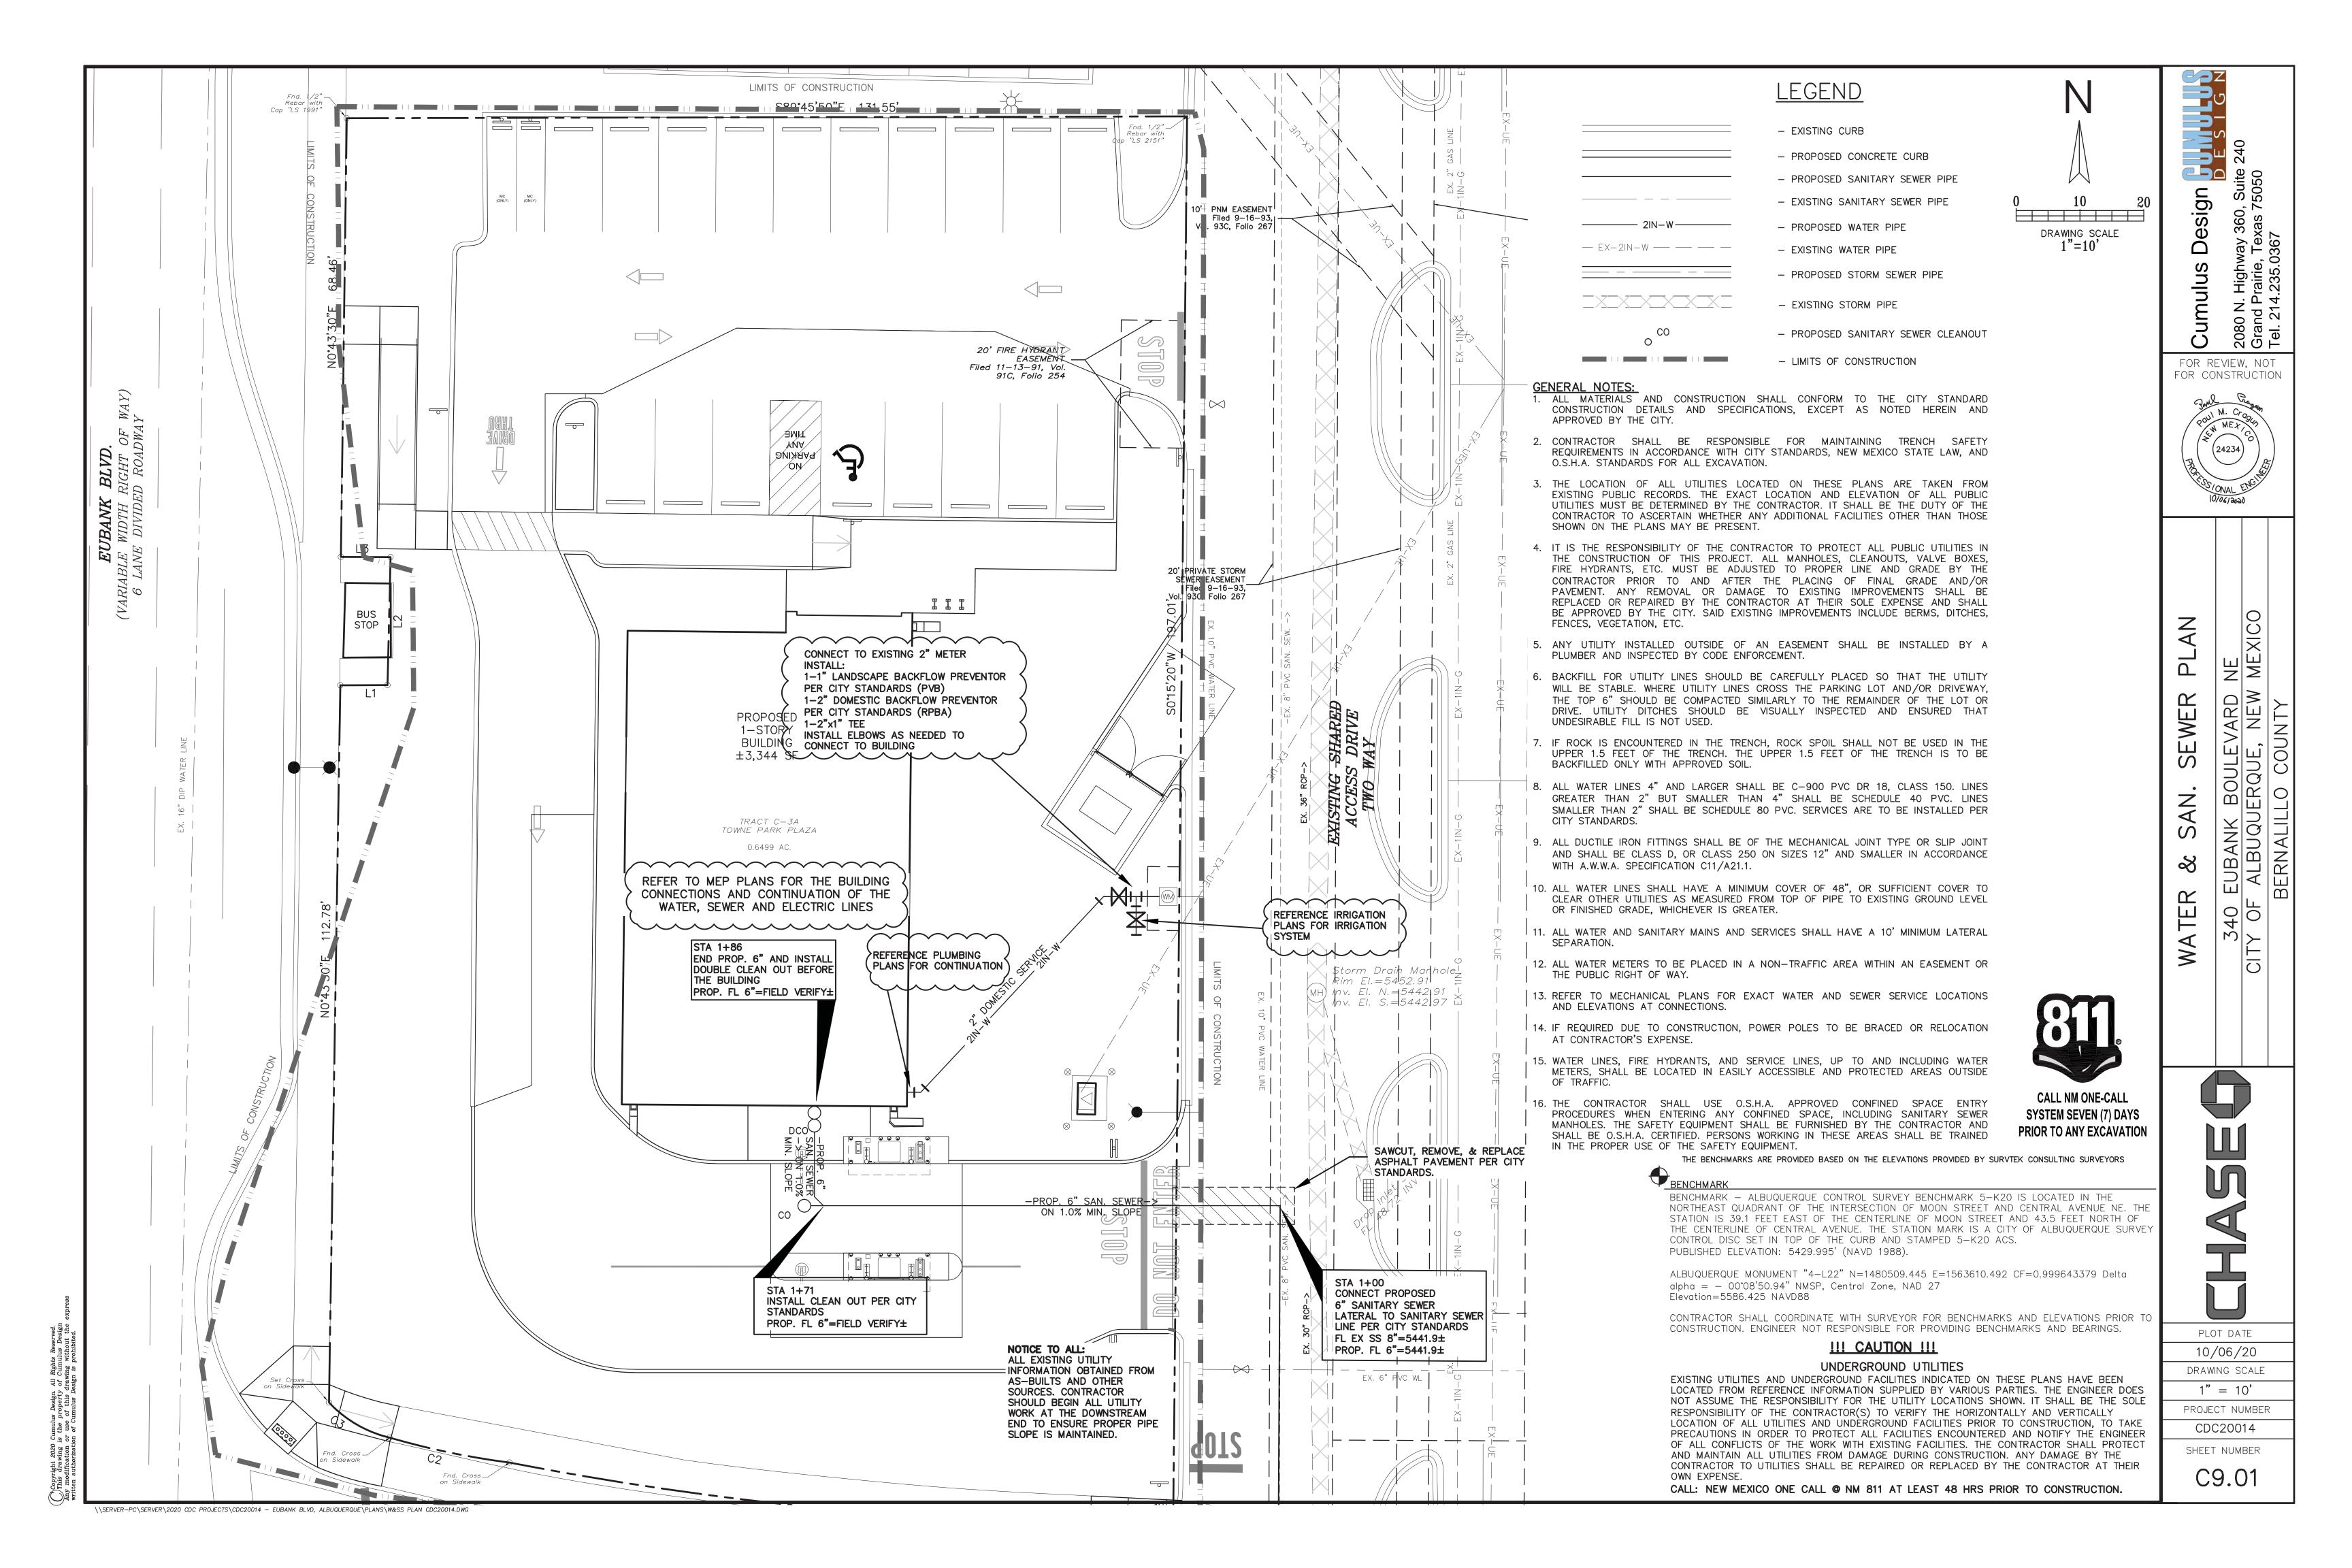
PLOT DATE 10/06/20 DRAWING SCALE


1" = 10'


PROJECT NUMBER CDC20014 SHEET NUMBER









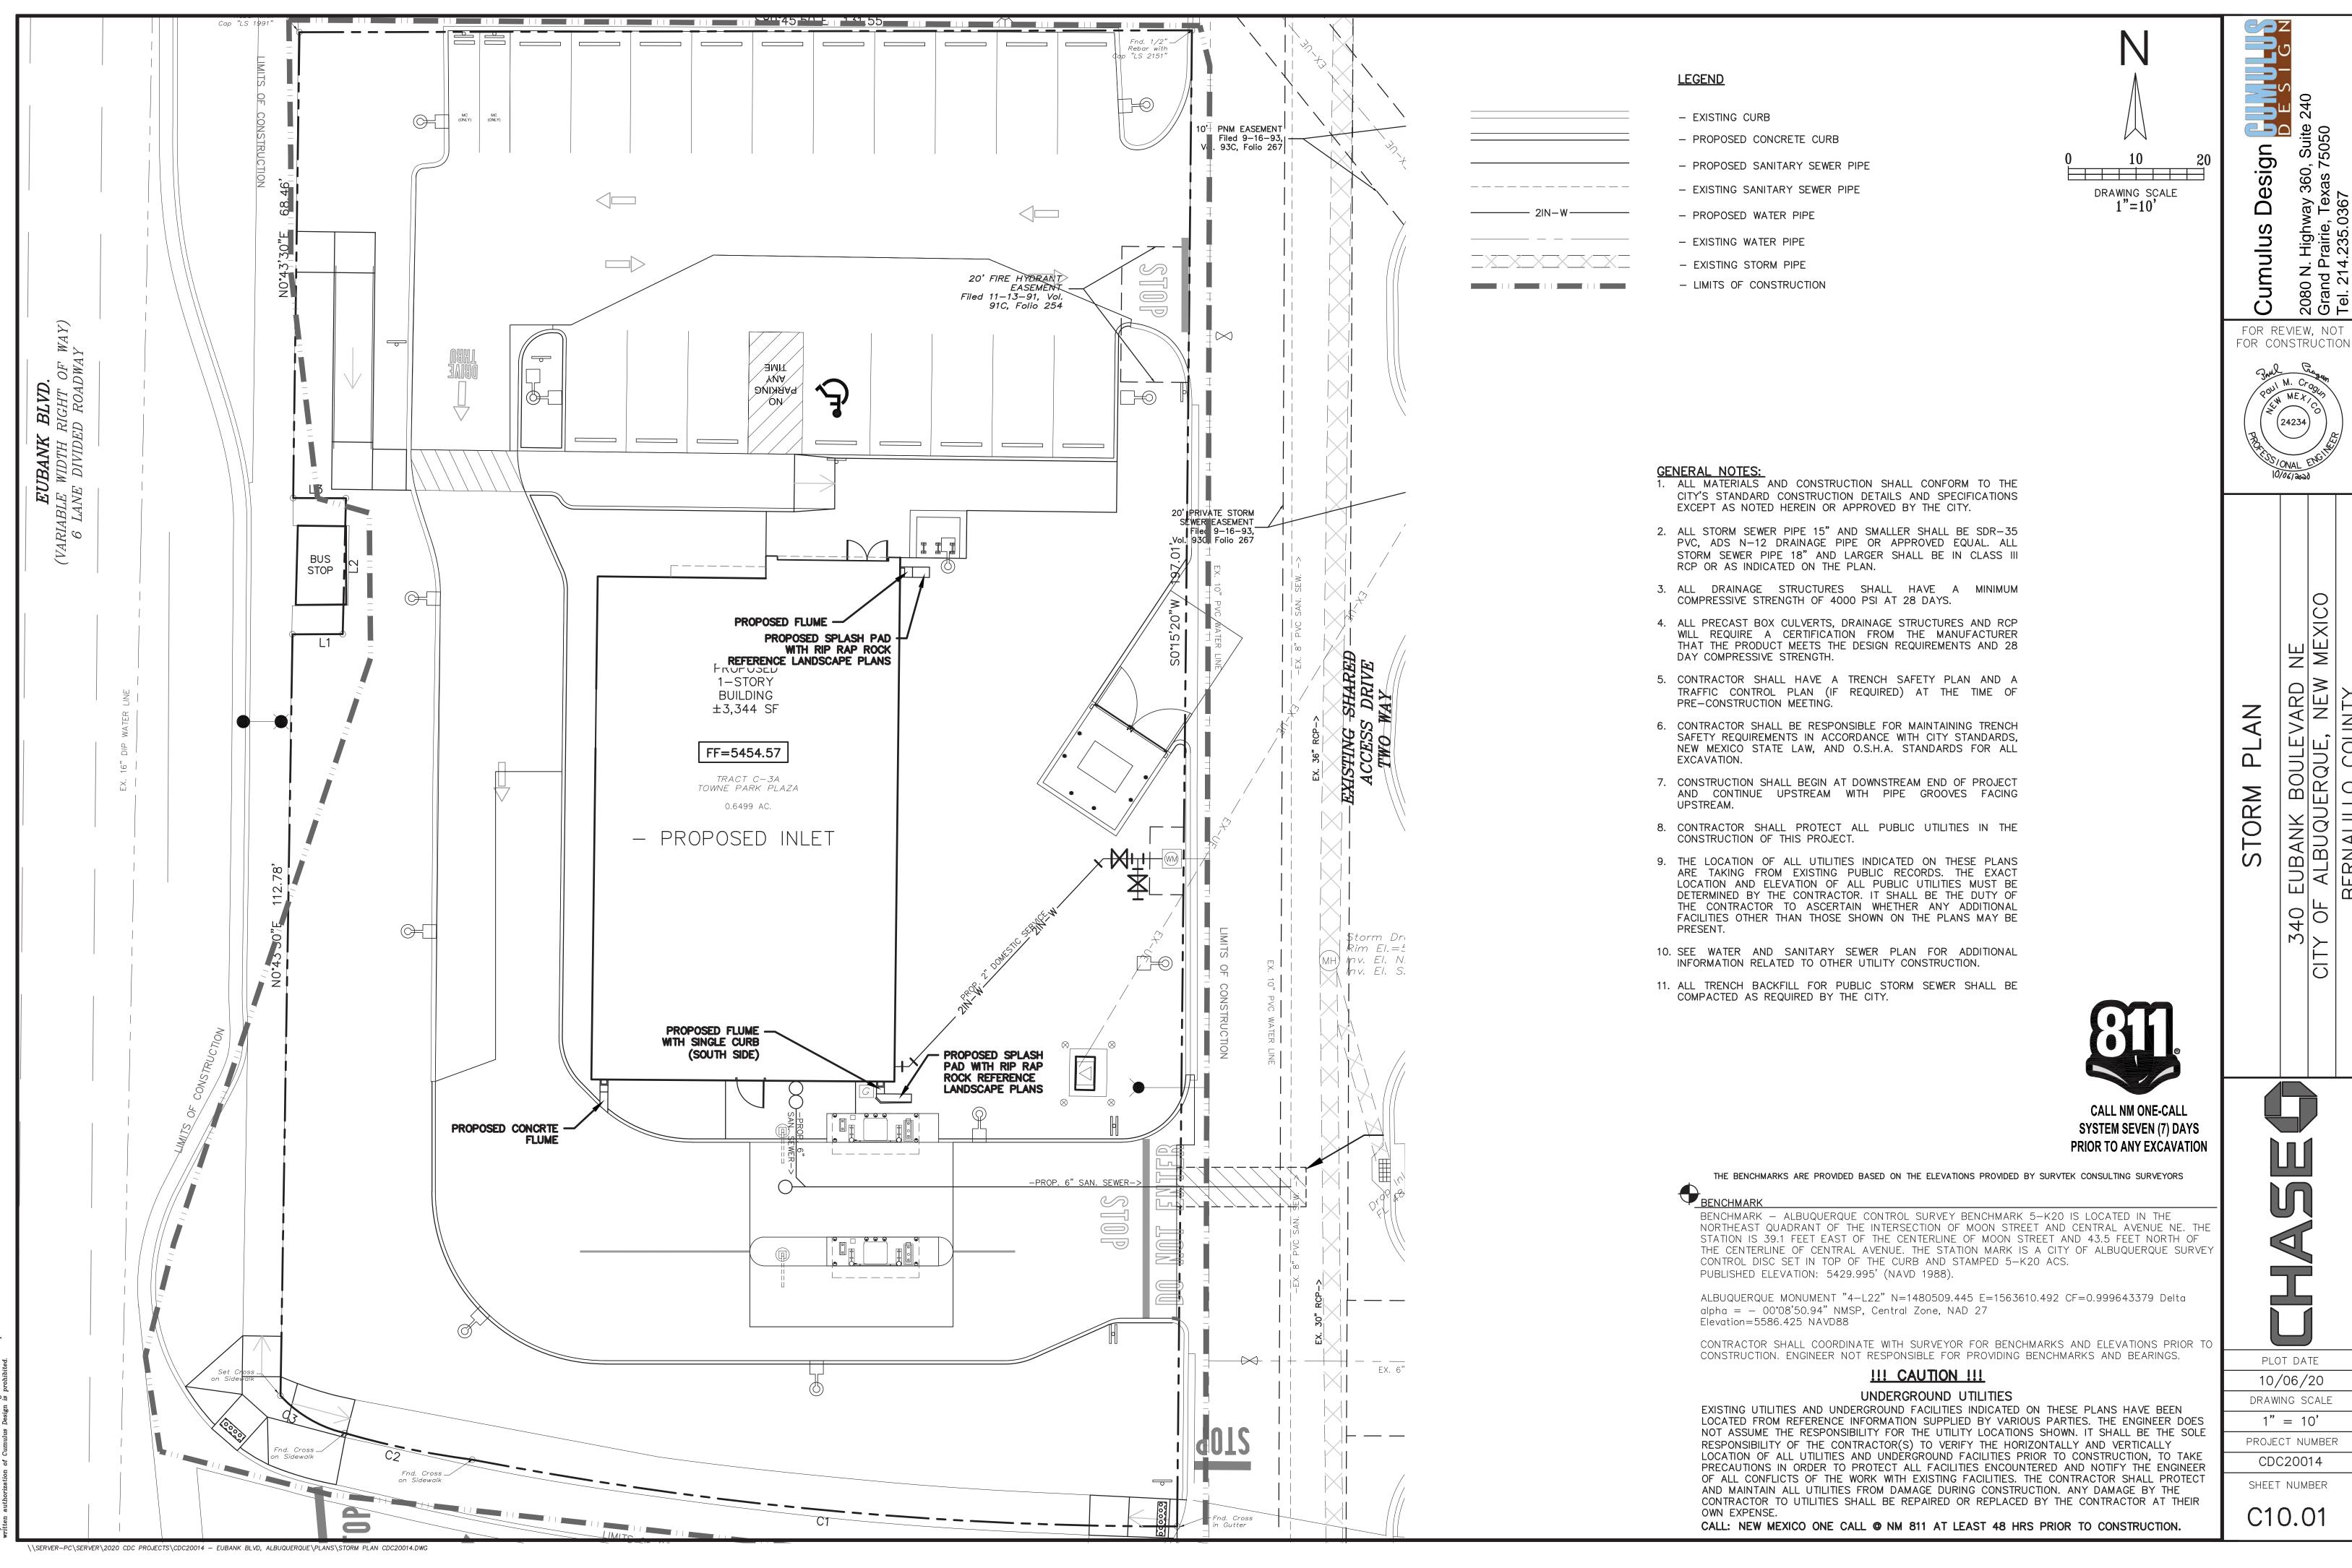

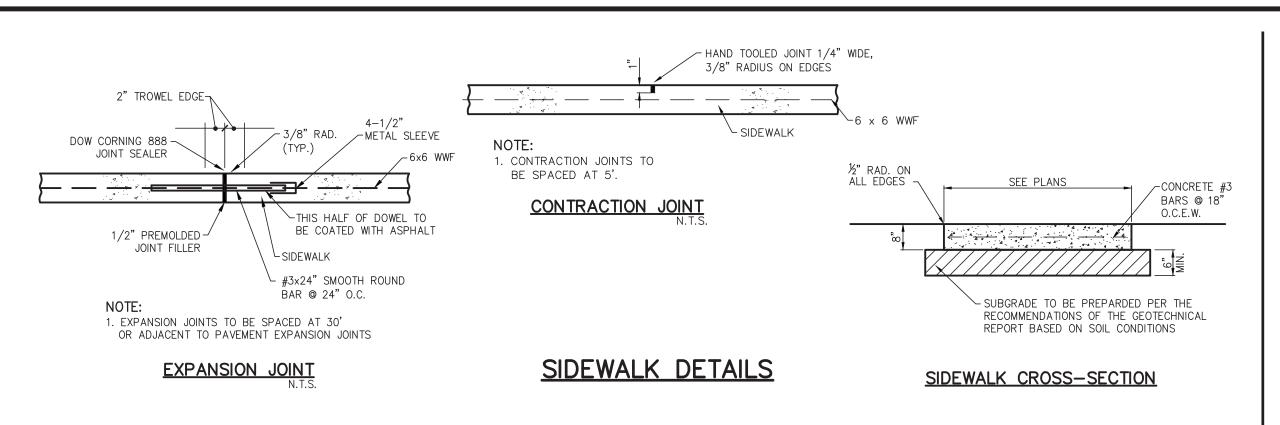

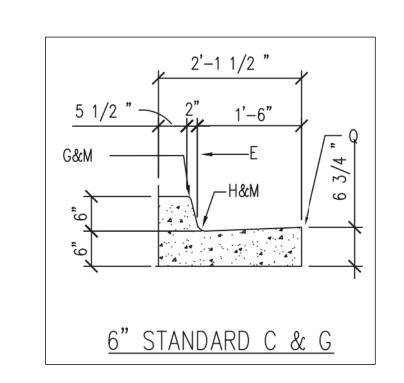

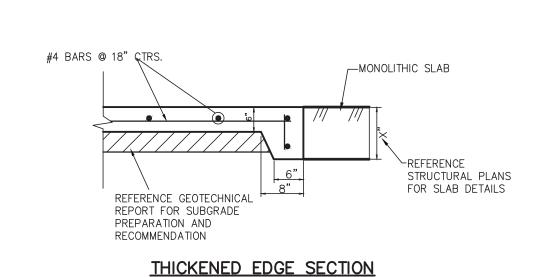

SAWCUT FULL DEPTH &

CURB & GUTTER

VERTICAL SAW

CUT 3/8" MIN.

PROPOSED PAVĖMENT¹

24" LUBRICATED SMOOTH

DOWELS AND REINFORCING BARS SHALL BE SUPPORTED BY AN APPROVED DEVICE.

LONGITUDINAL BUTT JOINT

1. NO. 5 SMOOTH DOWEL BAR MAY BE USED IN 5 INCH AND 6 INCH

2. LONGITUDINAL BUT CONSTRUCTION MAY BE UTILIZED IN PLACE OF PAVEMENT THICKNESS.

NO. 6 DOWEL BAR

ELASTOMERIC JOINT

SEALANT I


TOP 1/4" NO

EXISTING PAVEMENT

L DOWEL SPACED ON ONE (1) FOOT CENTER

TO CENTER, 6 INCHES OFF TIE BARS.


SEALING COMPOUND

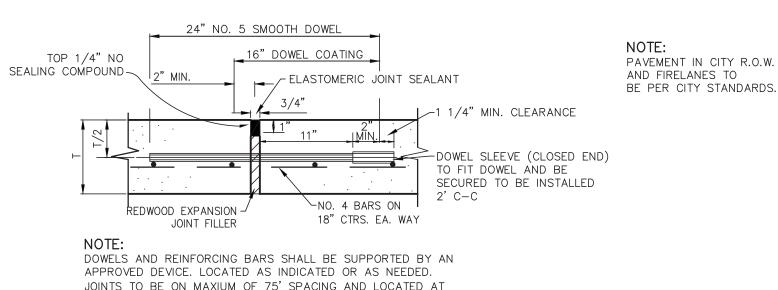

JOINTS TO BE ON MAXIUM OF 75' SPACING AND LOCATED AT POINTS OF INFLECTION AND MINIMUM CONCRETE WIDTH WHERE POSSIBLE.

T=THICKNESS OF PAVEMENT EXPANSION JOINT

NOTE: ALL JOINTS SHALL EXTEND THROUGH AND BE PERPENDICULAR CONCRETE CURBS AND SHALL MATCH SIDEWALK JOINTS WHERE APPLICABLE.

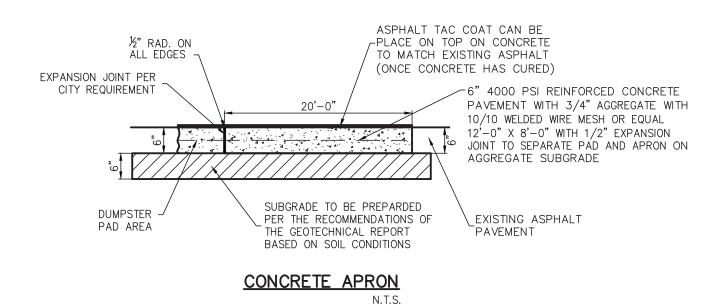


3. DOWEL BARS SHALL BE DRILLED INTO PAVEMENT HORIZONTALLY BY USE OF A MECHANICAL RIG. 4. DRILLED BY HAND IS NOT ACCEPTABLE, PUSHING DOWEL BARS INTO GREEN CONCRETE NOT ACCEPTABLE. r VERTICAL SAW CUT 3/8" WIDE MIN. TOP 1/4" NO ¬ SEALING COMPOUND ELASTOMERIC JOINT SEALANT

> └ NO. 4 BARS ON 18" CTRS. EA. WAY


MAXIMUM SPACING IS 15' CENTERS

PAVEMENT DETAILS

SAWED DUMMY (CONTROL) JOINT

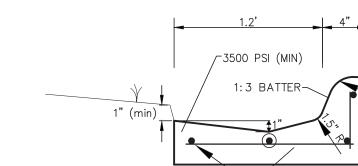

CONCRETE DRAINAGE FLUME (NO CURB)

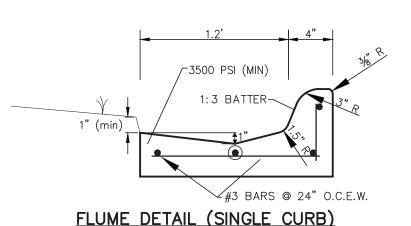


GRADE TO PREVENT RUNOFF FROM LEAVING SIŢE EXISTING FABRIC PROFILE VIEW

GRADE TO DRAIN AWAY FROM STABILIZED AND STREET PAVED SURFACE TRANSITION TO 50.0' PAVED SURFACE DRAINAGE MUST FLOW AWAY FROM ENTRANCE

PLAN VIEW

- 1. STONE SHALL BE 3 TO 5 INCH DIAMETER CRUSHED ROCK OR ACCEPTABLE CRUSHED PORTLAND CEMENT CONCRETE.
- 2. WHEN NECESSARY, VEHICLES SHALL BE CLEANED TO REMOVE SEDIMENT PRIOR TO ENTRANCE ONTO A PUBLIC ROADWAY. WHEN WASHING IS REQUIRED, IT SHALL BE DONE ON A AREA STABILIZED WITH CRUSHED STONE WITH DRAINAGE FLOWING AWAY FORM BOTH THE STREET AND THE STABILIZED ENTRANCE. ALL SEDIMENT SHALL BE PREVENTED FROM ENTERING ANY STORM DRAIN, DITCH OR WATERCOURSE USING APPROVED METHODS.
- 3. THE ENTRANCE SHALL MAINTAINED IN A CONDITION WHICH WILL PREVENT TRACKING OR FLOWING OF SEDIMENT ONTO PAVED SURFACES. THIS MAY REQUIRE PERIODIC TOP DRESSING WITH ADDITIONAL STONE A CONDITIONS DEMAND. ALL SEDIMENT SPILLED, DROPPED, WASHED OR TRACKED ONTO PAVED SURFACES, MUST BE REMOVED IMMEDIATELY.
- 4. THE ENTRANCE MUST BE PROPERLY GRADED OR INCORPORATE A DRAINAGE SWALE TO PREVENT RUNOFF FROM LEAVING THE CONSTRUCTION SITE.

STABILIZED CONSTRUCTION ENTRANCE

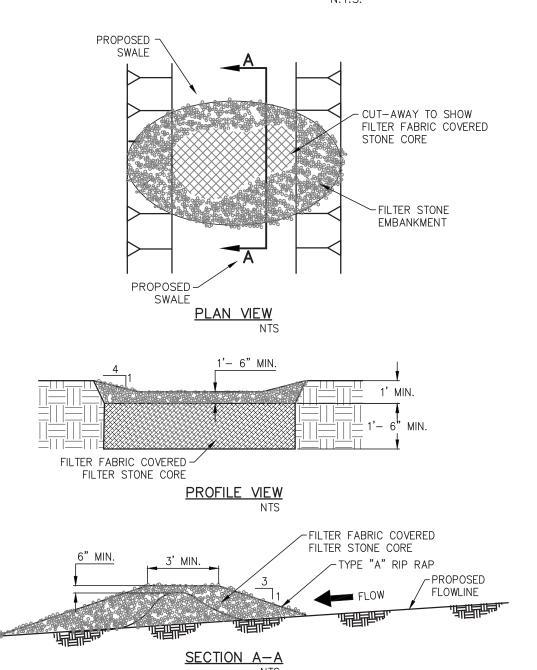

ROCK CHECK DAM

CRUSHED LIMESTONE,

FINE GRADATION PER


CITY STANDARDS

BLOCK AND GRAVEL PROTECTION CONCRETE BLOCKS ARE TO BE PLACED ON THEIR SIDES IN A SINGLE ROW AROUND THE PERIMETER OF THE INLET , WITH ENDS ABUTTING . OPENING IN THE BLOCKS SHOULD FACE OUTWARD, NOT UPWARD . WIRE MESH SHALL THEN BE PLACED OVER THE OUTSIDE FACE OF THE BLOCKS COVERING THE HOLES . FILTER STONE SHALL THEN BE PILED AGAINST THE WIRE MESH TO THE TOP OF THE BLOCKS WITH THE BASE OF THE STONE BEING A MINIMUM OF 18 INCHES FROMTHE BLOCKS. PERIODICALLY, WHEN THE STONE FILTER BECOMES CLOGGED , THE STONE MUST BE REMOVED AND CLEANED IN A PROPER MANNER OR REPLACED WITH NEW STONE AND PILED BACK AGAINST THE WIRE


- CONSTRUCTION NOTES INLET PROTECTION 1. THE CONTRACTOR SHALL PROVIDE ANY ADDITIONAL EROSION OR POLLUTION DEVICES AS REQUIRED DURING THE CONSTRUCTION PHASE IN ORDER TO COMPLETELY CONFORM TO THE UNITED STATES ENVIRONMENTAL PROTECTION AGENCY AND ALL OTHER AGENCIES HAVING JURISDICTION.
- 2. CONTRACTOR AND OWNER SHALL FILE N.O.I. PER EPA REQUIREMENTS.

3. ONSITE CURB INLET PROTECTION SHALL BE CONSTRUCTED UPON INSTALLATION OF APPLICABLE ON SITE STORM SEWER.

> —CONCRETE BLOCK — **DROP INLET PROTECTION**

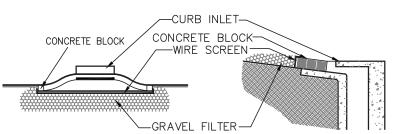

CURB INLET PROTECTION

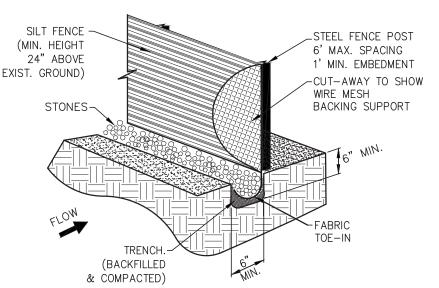

STEEL POSTS WHICH SUPPORT THE SILT FENCE SHALL BE INSTALLED ON A SLIGHT ANGLE TOWARD THE ANTICIPATED RUNOFF SOURCE.THE POST

MUST BE EMBEDDED A MINIMUM OF ONE FOOT. 2. THE TOE OF THE SILT FENCE SHALL BE TRENCHED IN WITH A SPADE OR MECHANICAL TRENCHER, SO THAT THE DOWNSLOPE FACE OF THE TRENCH IS FLAT AND PERPENDICULAR TO THE LINE OF FLOW.WHERE FENCE CANNOT BE TRENCHED IN (E.G. PAVEMENT), WEIGHT FABRIC FLAP WITH WASHED GRAVEL ON THE UPHILL SIDE TO PREVENT FLOW UNDER FENCE.

3. THE TRENCH MUST BE A MINIMUM OF 6 INCHES DEEP AND 6 INCHES WIDE TO ALLOW FOR THE SILT FENCE FABRIC TO BE LAID IN THE GROUND AND BACKFILLED WITH COMPACTED MATERIAL.

4. SILT FENCE SHALL BE SECURELY FASTENED TO EACH STEEL SUPPORT POST OR TO WOVEN WIRE, WHICH IS IN TURN ATTACHED TO THE STEEL SUPPORT POST. THERE SHALL BE A 6 INCH DOUBLE OVERLAP, SECURELY FASTENED WHERE ENDS OF FABRIC MEET.


5. INSPECTION SHALL BE MADE WEEKLY OR AFTER EACH RAINFALL.REPAIR OR REPLACEMENT SHALL BE MADE PROMPTLY AS NEEDED. 6. SILT FENCE SHALL BE REMOVED WHEN THE SITE IS COMPLETELY STABILIZED SO AS NOT TO BLOCK OR IMPEDE STORM FLOW OR DRAINAGE.

7. ACCUMULATED SILT SHALL BE REMOVED WHEN IT REACHED A DEPTH OF 6 INCHES.THE SILT SHALL BE DISPOSED OF AT AN APPROVED SITE AND IN SUCH A MANNER AS TO NOT CONTRIBUTE TO ADDITIONAL SILTATION.

SILT FENCE

DETAILS ON THIS SHEET ARE PRIVATE. ALL WORK WITHIN PUBLIC EASEMENTS OR RIGHT-OF-WAY SHALL BE PER CITY (OR STATE, IF APPLICABLE) STANDARD DETAILS. THE CONTRACTOR IS REQUIRED TO HAVE ON-SITE, AT ALL TIMES, A COPY OF THE CITY'S CONSTRUCTION DETAILS.

EROSION CONTROL

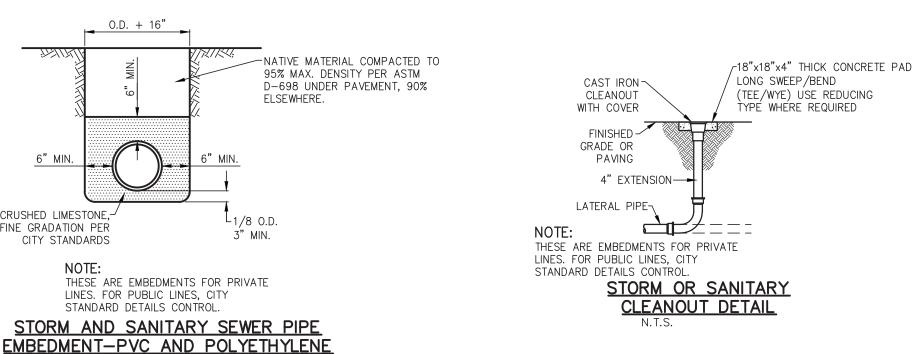

NATIVE MATERIAL COMPACTED TO 95% MAX. DENSITY PER ASTM D-698 UNDER PAVEMENT, 90% ELSEWHERE. SELECT OR GRANULAR -MATERIAL COMPACTED TO 95% UNDER PAVING, 90% ELSEWHERE -3" MIN. (6" IN ROCK) LINES. FOR PUBLIC LINES, CITY

THESE ARE EMBEDMENTS FOR PRIVATE W=24" OR O.D. PLUS 16" WHICH STANDARD DETAILS CONTROL. EVER IS GREATER RCP, DUCTILE IRON & PVC WATER PIPE EMBEDMENT

UTILITY DETAILS

PLOT DATE 10/06/20 DRAWING SCALE 1" = 10'PROJECT NUMBER CDC20014

C12.01

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sign

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FOR CONSTRUCTION

(24234)

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EUBANK ALBUQU BERNALIL

(PRIV.

TAIL

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SHEET NUMBER


FLUME DETAIL (SINGLE CURB) **DRAINAGE DETAILS**


-REINFORCED

CONCRETE

3 BARS @ 12" LONGITUDINALLY

#4 BARS @ 18" TRAVERSE

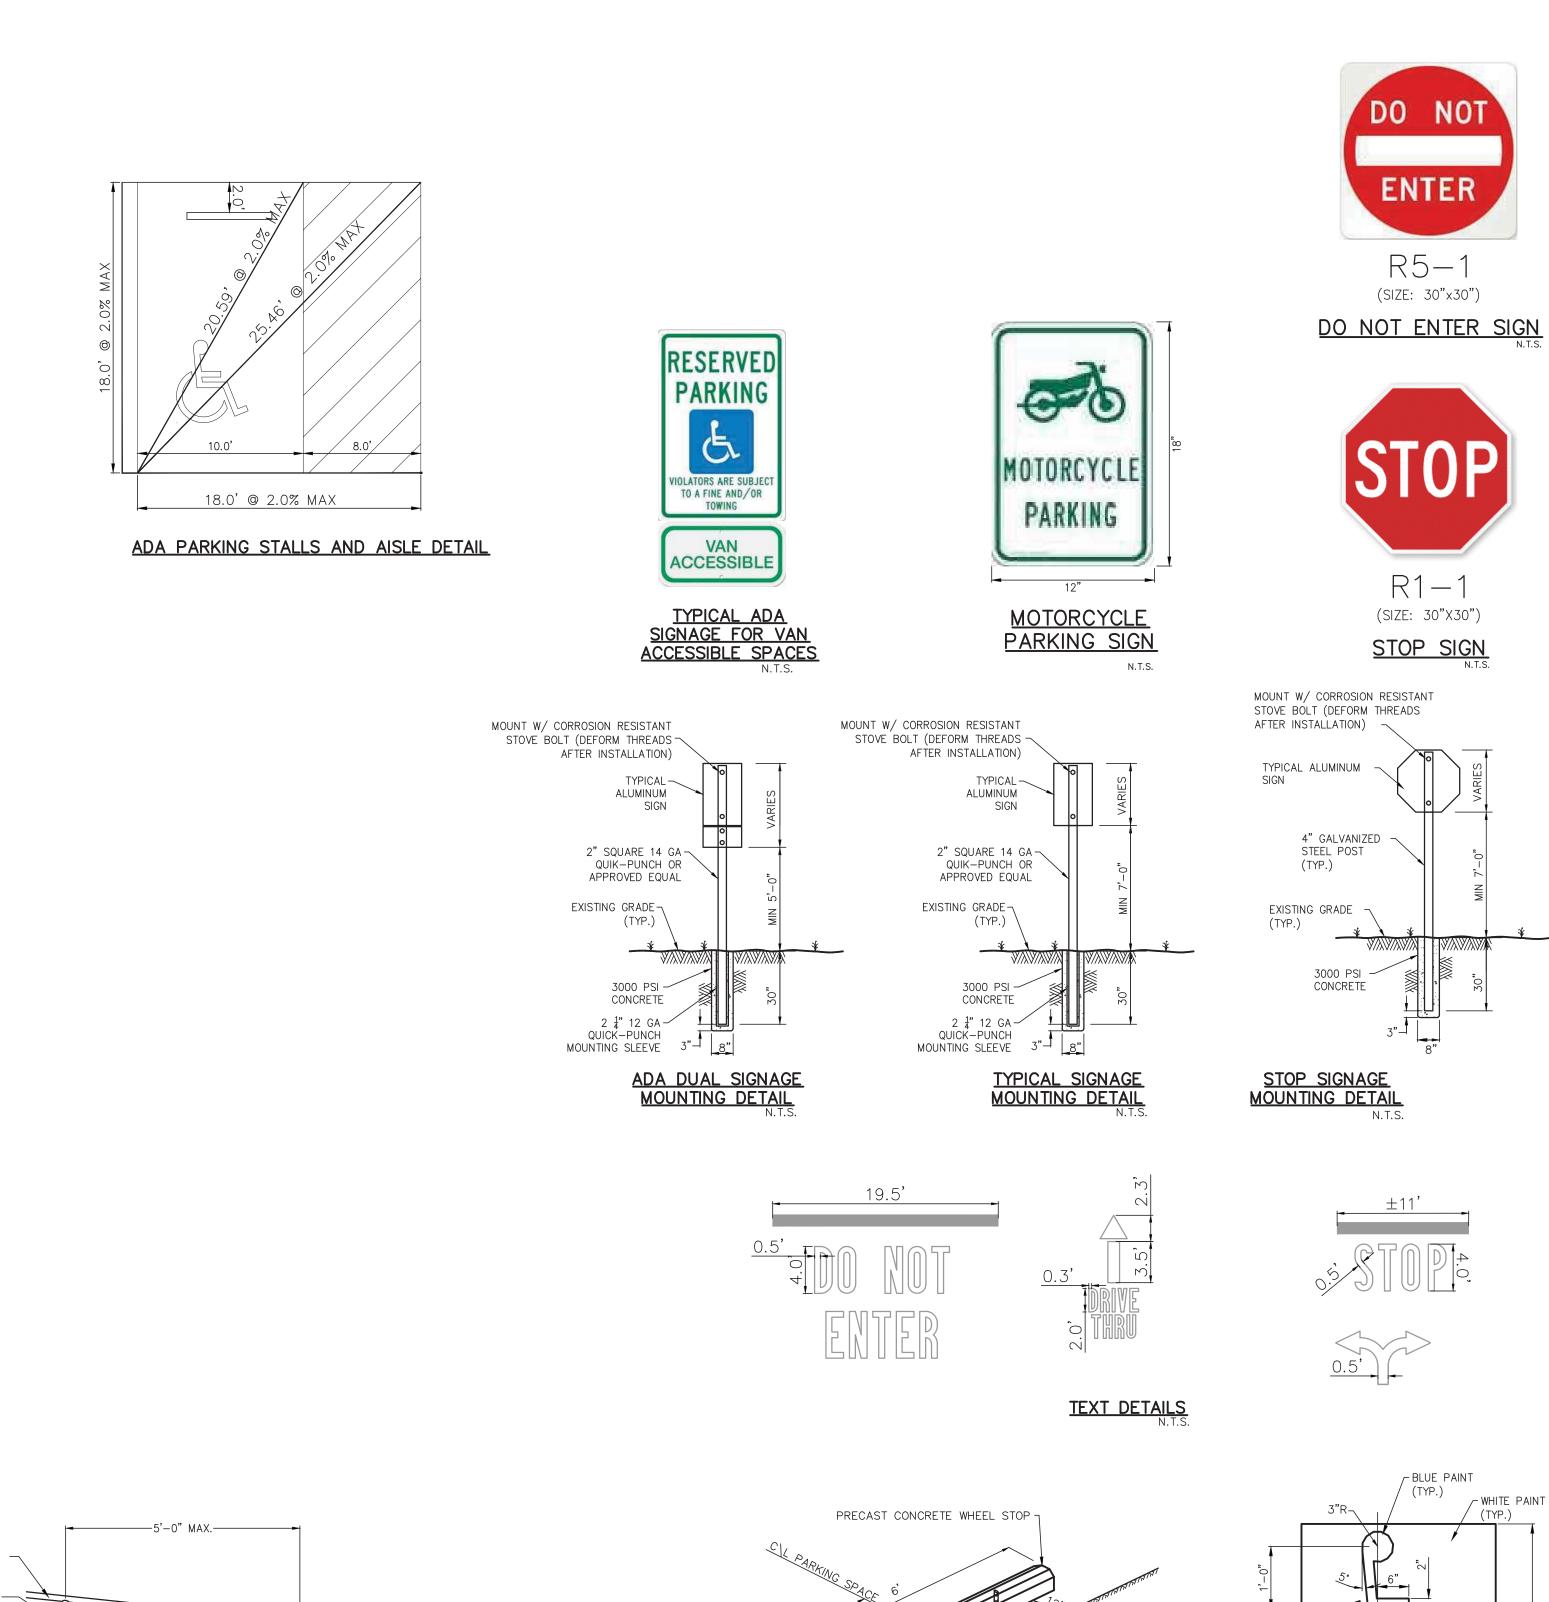

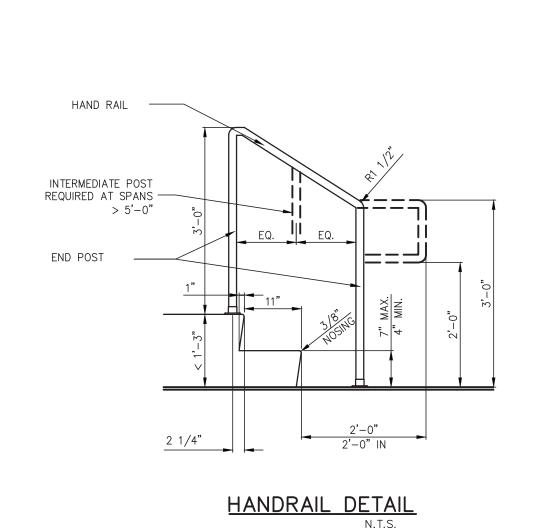


4.4'

1. INSTALLATION TO BE COMPLETED IN ACCORDANCE WITH MANUFACTURER'S SPECIFICATIONS.


BICYCLE RACK DETAIL


N.T.S.

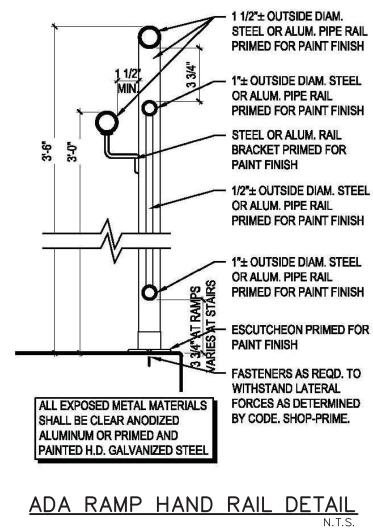


SURFACE PER CURRENT ADA STANDARDS

ADA CURB RAMP DETAIL

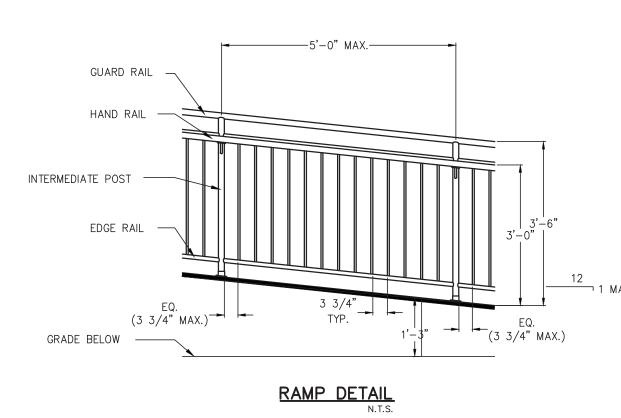

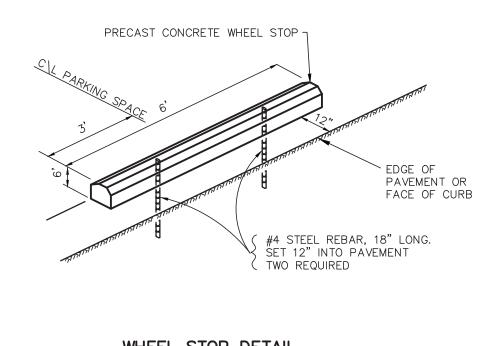

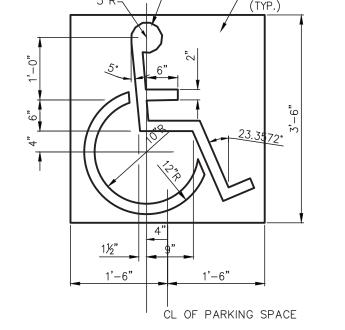

HANDICAP PARKING SYMBOL DETAIL

WHEEL STOP DETAIL

NOTE
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MISCELLANEOUS DETAILS

PLOT DATE

Design

Cumulus

(PRIVATE)

DETAIL

FOR CONSTRUCTION


10/06/20 DRAWING SCALE


1" = 10'


PROJECT NUMBER CDC20014 SHEET NUMBER


C12.01


\\SERVER-PC\SERVER\2020 CDC PROJECTS\CDC20014 - EUBANK BLVD, ALBUQUERQUE\PLANS\DETAILS (PRIVATE) CDC20014.DWG

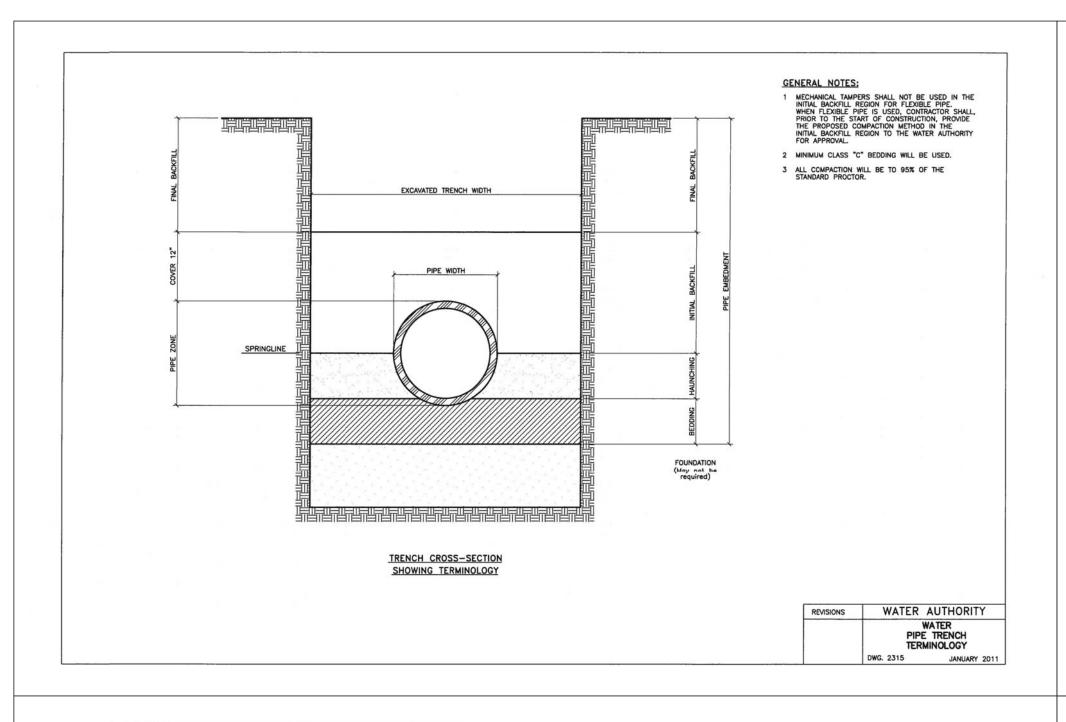


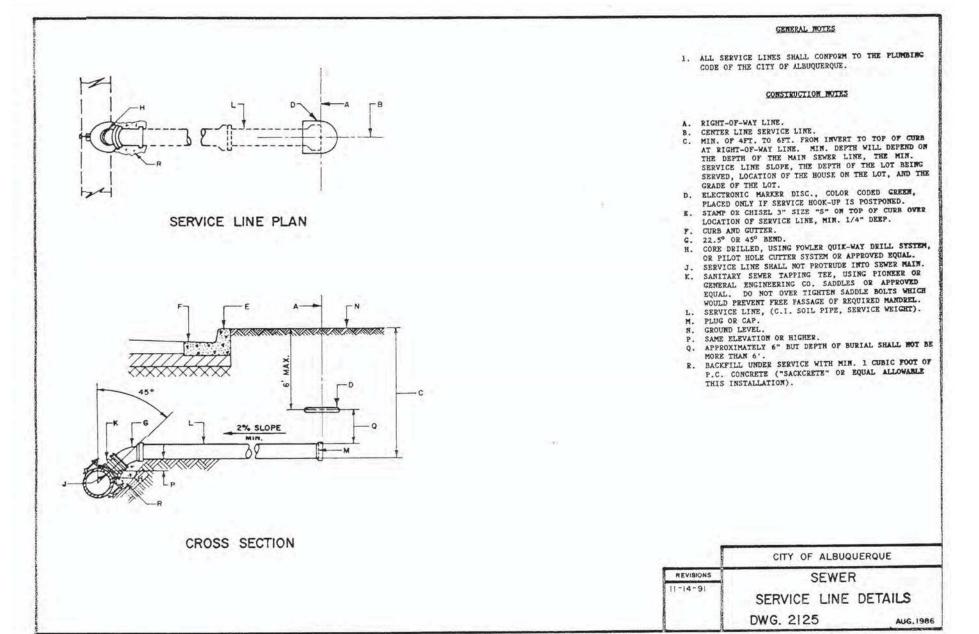


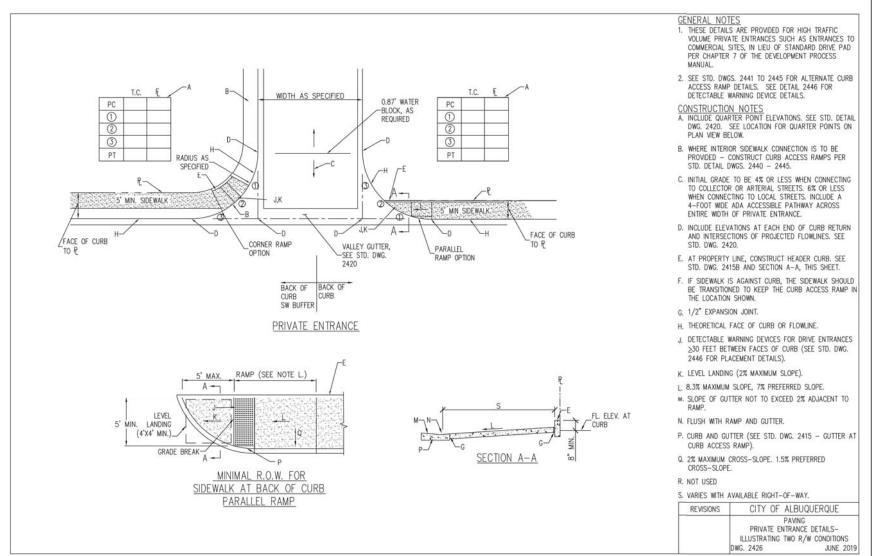


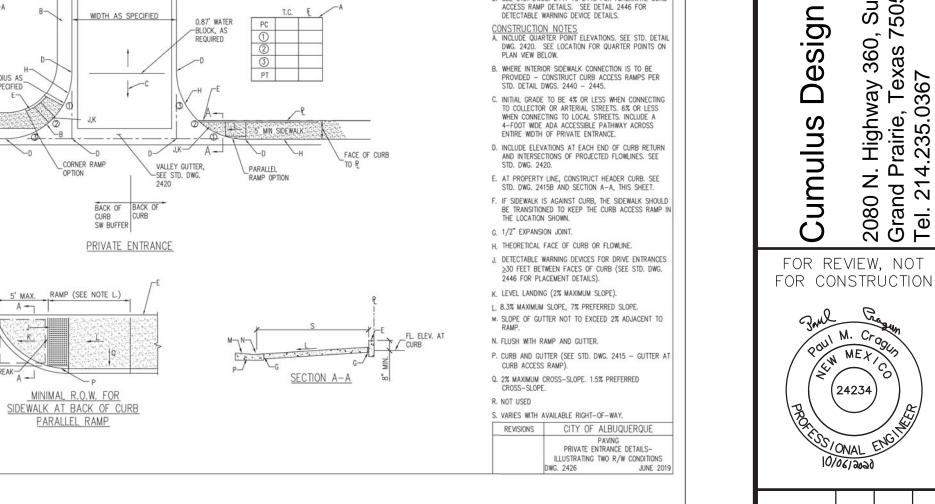

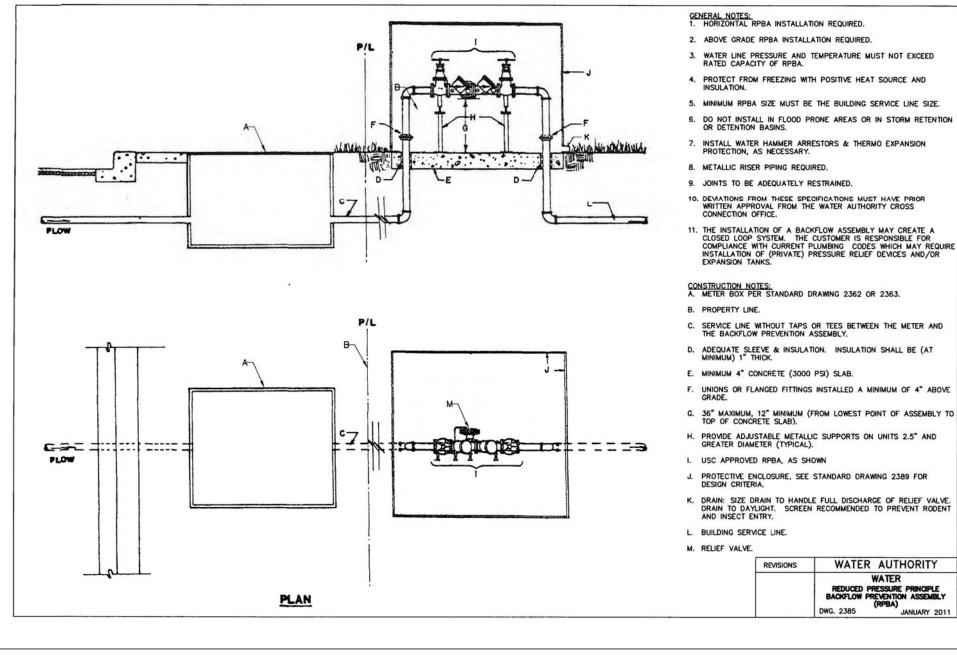


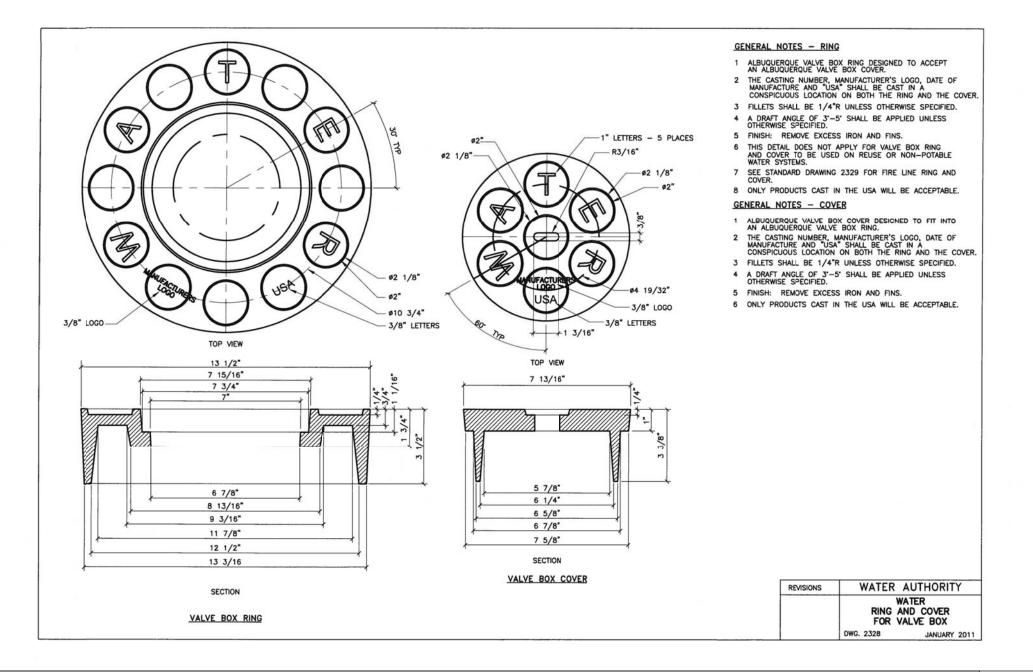

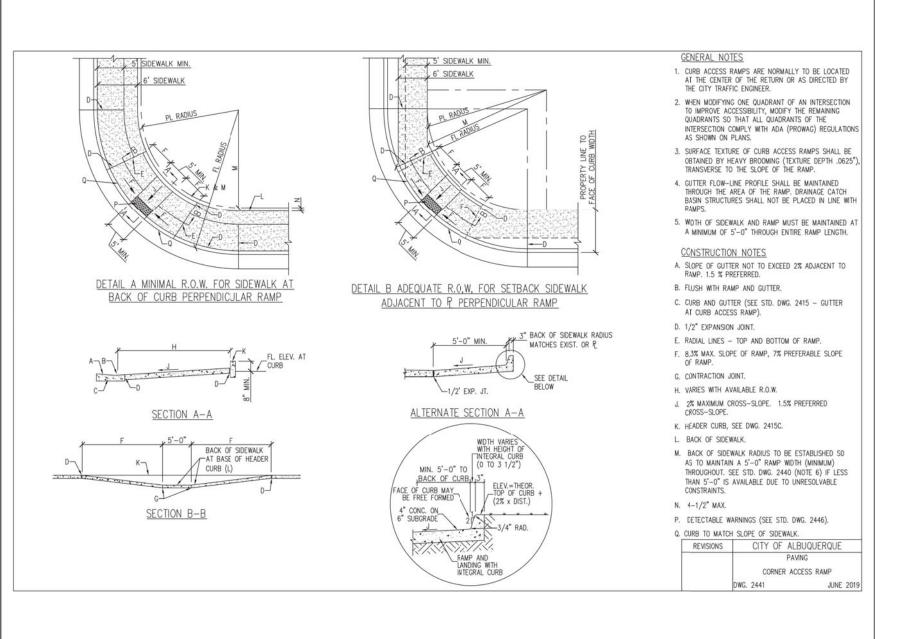

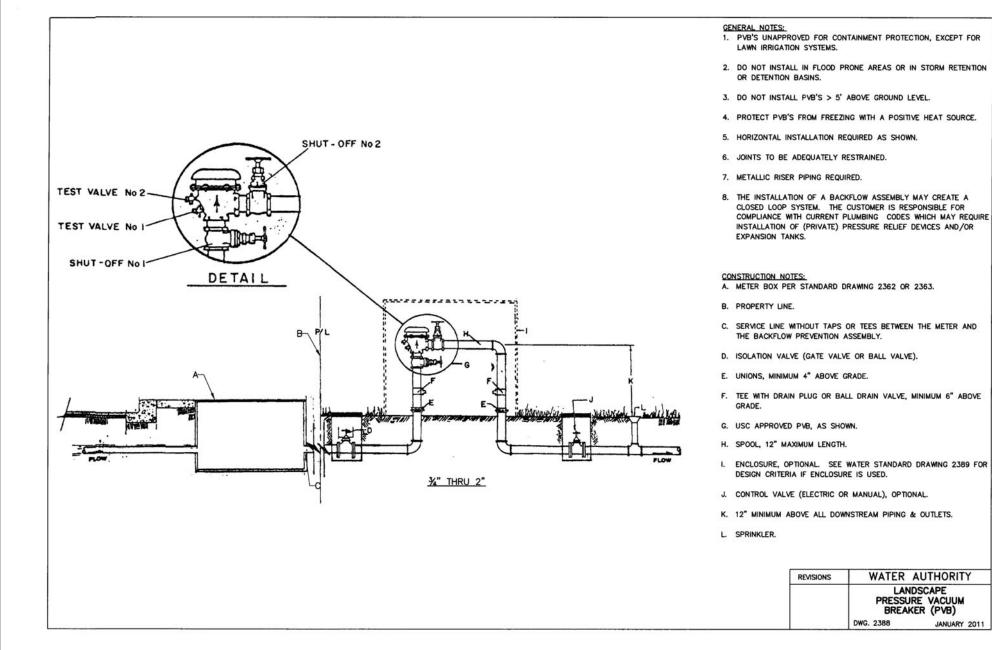

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NOTE: ALL RIGHT-OF-WAY WORK TO BE DONE PER CITY STANDARDS, REFERENCE CITY DETAILS FOR ADDITIONAL INFORMATION.

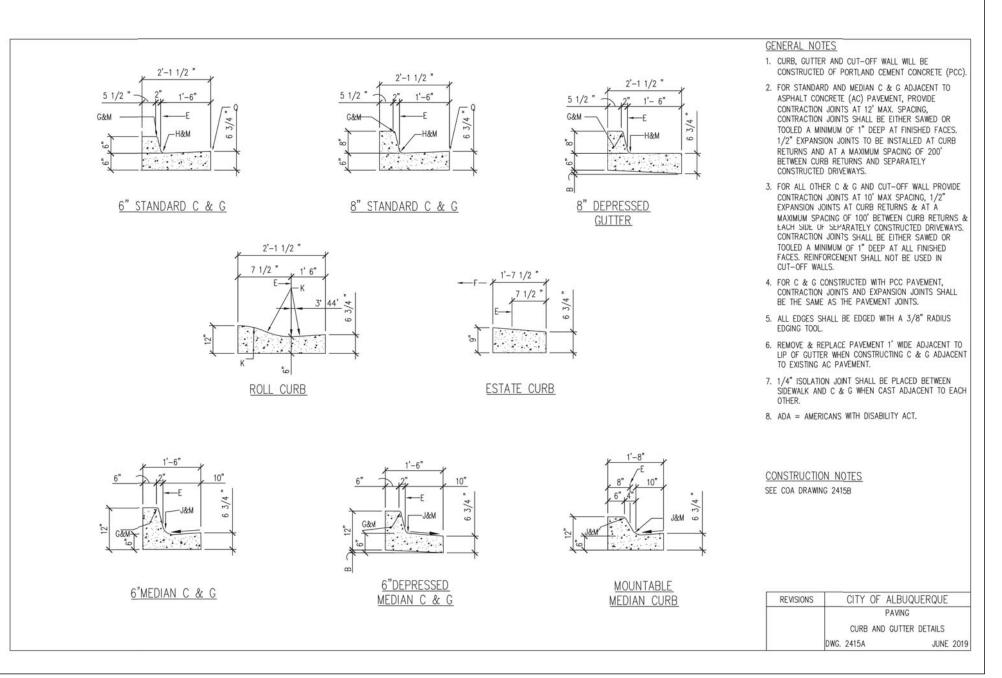EUBANK ALBUQU BERNALIL

TAIL

5-

21 21

PLOT DATE 10/06/20

DRAWING SCALE 1" = 10'

PROJECT NUMBER CDC20014

SHEET NUMBER

C13.01