

SCOUT ARCHITECTURE + DESIGN

ARCHITECT/ ENGINEER

4208 BALLOON PARK RD NE ALBUQUERQUE, NM 87109

REVISION DATE

 DATE
 9/15/2

 PROJECT NO
 2012

SITE PLAN TCL

SHEET NO.

AS101

SCOUT
ARCHITECTURE + DESIGN

ARCHITECT/ENGINEER

THOUSE RELOCAT

4208 BALLOON PARK RD NE

REVISION DATE


DATE 9/15/20
PROJECT NO 2012

SITE DETAILS

SHEET NO.

1 1/2" = 1'-0"

AS501

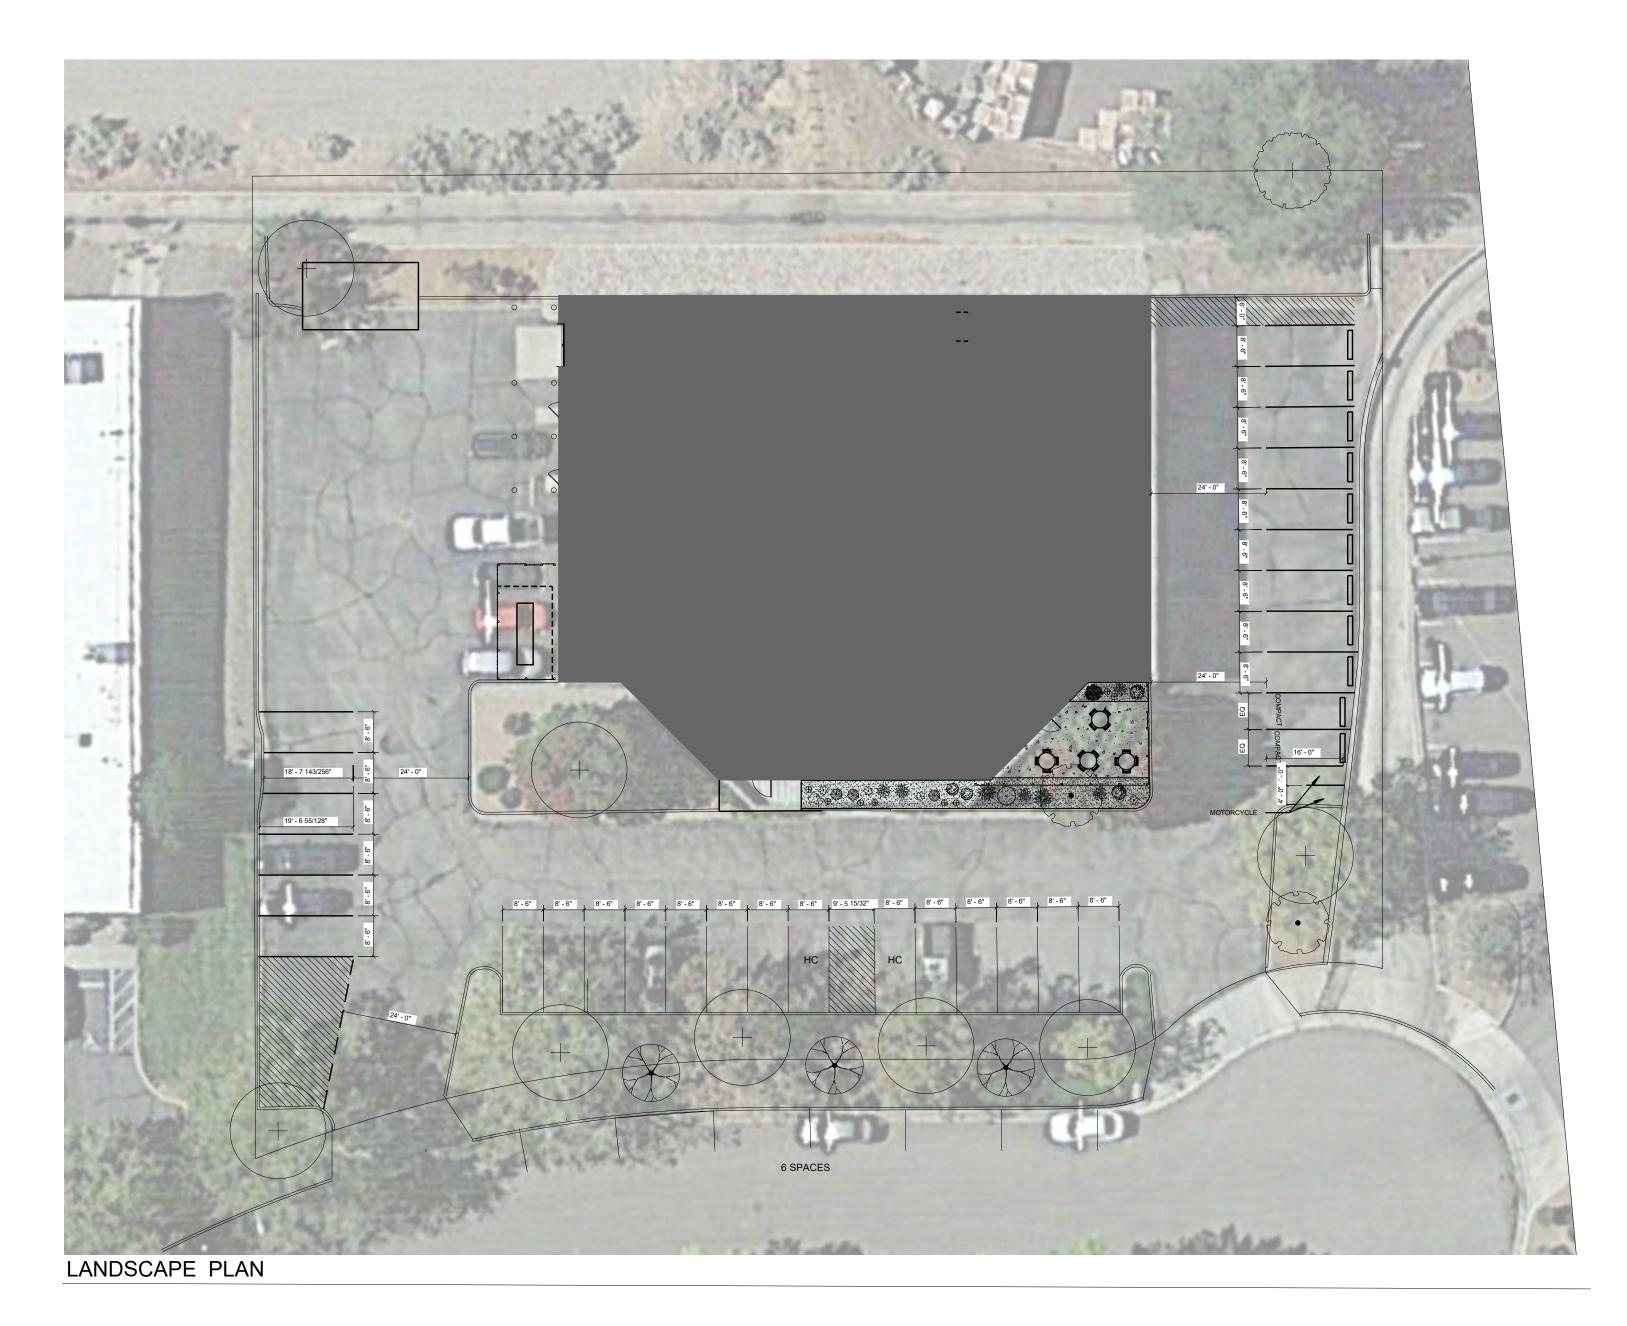

## PLANT SCHEDULE

TREES	<u>aty</u>	BOTANICAL / COMMON NAME	SIZE	$H \times M$	ALLOWANCE
+	8	EXISTING TREE	VARIES		
DECIDUOUS TREES	<u>QTY</u>	BOTANICAL / COMMON NAME	<u>SIZE</u>	$H \times M$	ALLOWANCE
	3	CERCIS RENIFORMIS 'OKLAHOMA' / OKLAHOMA RED BUD	2" B\$B	15' X 12'	144X3=432
	2	PYRUS CALLERYANA 'CLEVELAND SELECT' / CLEVELAND SELECT PEAR		25' X 15'	225×2=45 <i>0</i> <b>882 SF</b>
FLOWERING PLANTS	<u>aty</u>	BOTANICAL / COMMON NAME	SIZE	HXM HXM	ALLOWANCE
	4	GAILLARDIA X GRANDIFLORA / BLANKETFLOWER	I GAL	2' X 2'	4×4= 6
	5	SALVIA NEMOROSA 'MAY NIGHT' / MAY NIGHT SAGE	I GAL	1.5' × 1.5'	2X5=IO
<u>GRASSES</u>	QTY	BOTANICAL / COMMON NAME	<u>SIZE</u>	$H \times M$	ALLOWANCE
	3	HELICTOTRICHON SEMPERVIRENS / BLUE OAT GRASS	I GAL	2' X 2'	4×3=12
DECIDUOUS SHRUBS	QTY	BOTANICAL / COMMON NAME	<u>SIZE</u>	HXM	ALLOWANCE
	2	CARYOPTERIS X CLANDONENSIS 'DARK KNIGHT' / BLUE MIST SPIREA	I GAL	3' X 3'	9×2= 8
	I	RHUS AROMATICA 'GRO-LOW' / GRO-LOW FRAGRANT SUMAC	5 GAL	4' × 4'	6× = 6
	I	ROSA X 'KNOCKOUT' TM / ROSE	5 GAL	6' × 5'	25XI=25
	2	SALVIA GREGGII 'ULTRAVIOLET' / ULTRAVIOLET AUTUMN SAGE	I GAL	3' X 3'	9X2=18
EVERGREEN SHRUBS	QTY	BOTANICAL / COMMON NAME	<u>SIZE</u>	HXM	ALLOWANCE
	2	ROSMARINUS OFFICINALIS 'ARP' / ARP ROSEMARY	5 GAL	6' × 4'	16X2=32
<u>GROUNDCOVERS</u>	QTY	BOTANICAL / COMMON NAME	<u>SIZE</u>	HXM	ALLOWANCE
***	8	TEUCRIUM AROANIUM / CREEPING GERMANDER	I GAL	1' × 2'	4×8=32
	_		50B TOT.	TOTAL	179 SF 1061 SF
Material Sc					

<u>aty</u>

# SITE DATA

LANDSCAPE AREA (LAN.) PROVIDED 500 SF

**VEGETATION COVERAGE (VEG.)** REQUIRED 375 SF (75% OF LAN.) PROPOSED 1061 SF (212% OF LAN.)

**GROUND-LEVEL PLANTS COVERAGE** 

REQUIRED 94 SF (25% OF VEG.) PROPOSED 179 SF (48% OF VEG.)

STREET TREES (1 PER 25 LF)

REQUIRED 10 **EXISTING** PROPOSED 4

PARKING LOT TREES (1 PER 10 PARKING SPACES)

REQUIRED 4 **EXISTING** PROPOSED

### **TOTAL**

REQUIRED 9 TREES EXISTING PROPOSED 5 TREES

### **GENERAL NOTES:**

1. MAINTENANCE OF THE LANDSCAPE AND IRRIGATION PROVIDED BY THE PROPERTY

2. THE LANDSCAPE PLAN IS DESIGNED TO MEET ALL CITY OF ALBUQUERQUE, AND IDO REQUIREMENTS.

3. PLANT MATERIALS AND SIGNING WILL NOT INTERFERE WITH CLEAR SIGHT REQUIREMENTS. THEREFORE SIGNS, WALLS, TREES, AND SHRUBBERY BETWEEN 3 AND 8 FEET TALL (AS MEASURED FROM THE GUTTER PAN) ARE NOT ACCEPTABLE IN 'CLEAR SIGHT' AREAS.

4. THE LANDSCAPE PLAN IS DESIGNED TO COMPLY WITH THE GENERAL IDO LANDSCAPING REGULATIONS(section 14-16-5-6) INCLUDING PROVISION OF A MINIMUM OF 75% LIVE GROUND COVERAGE, MEASURED AT MATURITY, OF ALL REQUIRED LANDSCAPE AREAS, AND A MINIMUM OF 25% REQUIRED VEGETATIVE COVERAGE OF GROUND LEVEL PLANTS.

### **PLANTINGS NOTES:**

1. ALL PLANTINGS WILL BE UNDER WARRANTY BY CONTRACTOR FOR 1 YEAR. 2. THE LANDSCAPE DESIGN SHALL COMPLY WITH THE CITY OF ALBUQUERQUE WASTE WATER CONSERVATION, LANDSCAPE, IDO, AND WATER WASTE ORDINANCE. 3. THERE IS NO NEW TURF USED IN THE DESIGN OF THE LANDSCAPE. 4.THE R.O.W. (WHEN DEDICATED TO THE PUBLIC) SHALL BE MAINTAINED BY THE PROPERTY OWNER. THE PLAN SHALL FOLLOW THE COA DESIGN GUIDELINES FOR STREET TREES UNLESS OBSTRUCTED BY UTILITY EASEMENTS. 5. ALL LANDSCAPE AREAS SHALL BE COVERED WITH MULCH. USE GRAVEL MULCH AT 3" DEPTH OVER FILTER FABRIC.

6. WHERE MULCH IS ADJACENT TO THE CONCRETE, FINISH GRADE OF MULCH SHALL BE

APPROXIMATELY 1/2" BELOW THE TOP OF CONCRETE.

### **IRRIGATION NOTES:**

1. ALL NEW PLANTINGS TO BE WATERED BY AUTO DRIP IRRIGATION SYSTEM. 2. WATER MANAGEMENT AND THE MAINTENANCE OF THE IRRIGATION SYSTEM IS THE

DESCRIPTION

MOUNTAINAIR BROWN 7/8" GRAVEL OVER FILTER

3. THE IRRIGATION SYSTEM SHALL BE CONNECTED TO CITY WATER. THE POINT OF CONNECTION SHALL CONSIST OF A WATER METER, BACKFLOW PREVENTER, AND MASTER VALVE. SEE 1103 FOR DETAIL.

4. 6 EMITTERS PER EACH TREE AND TWO 2 GPH EMITTERS PER EACH


SOLE RESPONSIBILITY OF THE PROPERTY OWNER.


SHRUB/GROUNDCOVER. 5. INSTALL SLEEVES TWO SIZES LARGER THAN THE SLEEVED PIPE UNDER ALL HARD SURFACES.

6. THE BACKFLOW SIZE AND LOCATION IS ASSUMED ONLY, BASED ON THE LATEST AVAILABLE UTILITY PLAN. GENERAL CONTRACTOR TO PROVIDE THE IRRIGATION WATER STUB OUT AND ELECTRICITY FOR THE HOTBOX.

7. IRRIGATION EQUIPMENT IS SHOWN ON A LARGER SCALE FOR CLARITY. THE PIPE ROUTING ON THE PLAN IS SCHEMATIC AND MAY REQUIRE FIELD ADJUSTMENTS TO AVOID INSTALLING PIPE WITHIN THE ROOT ZONE OF PLANTS OR IN CONFLICT WITH UTILITY EASMENTS.

8. ALL SLEEVES ARE ASSUMED TO BE PLACED PRIOR HARDSCAPE WITHOUT THE NEED OF BORING.

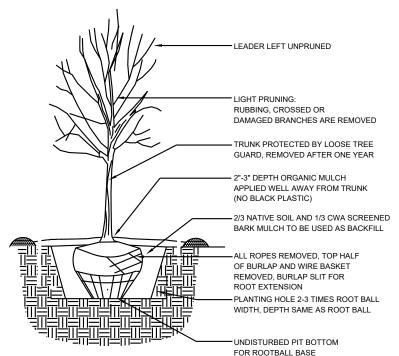

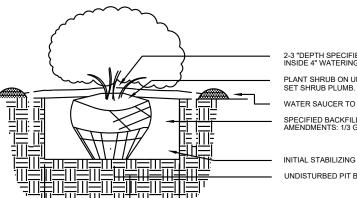


TREE PLANTING DETAIL

SHRUB PLANTING DETAIL

2-3 "DEPTH SPECIFIED MULCH AT EDGE OF RING, INSIDE 4" WATERING SAUCER WATER SAUCER TO BE 18" FROM CENTER OF SHRUB. SPECIFIED BACKFILL MIXTURE. AMENDMENTS: 1/3 GRD. BARK, 2/3 NATIVE SOIL INITIAL STABILIZING BACKFILL 1/3 DEPTH, COMPACTED. — UNDISTURBED PIT BOTTOM FOR BASE

Sheet Number:

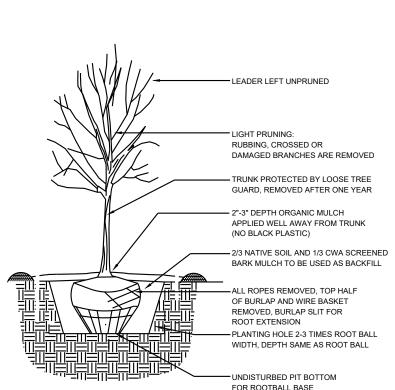

**NORTH** 

**Albuque** 

www.yellowstonelandscape.com PO Box 10597 Albuquerque, NM 87184 505.898.9615

design@yellowstonelandscape.com

Date: <u>9/9/2020</u>

Revisions:


Drawn by: CM

Reviewed by: CM

Scale: 1" = 10'

Sheet Title:

Landscape Plan -AA

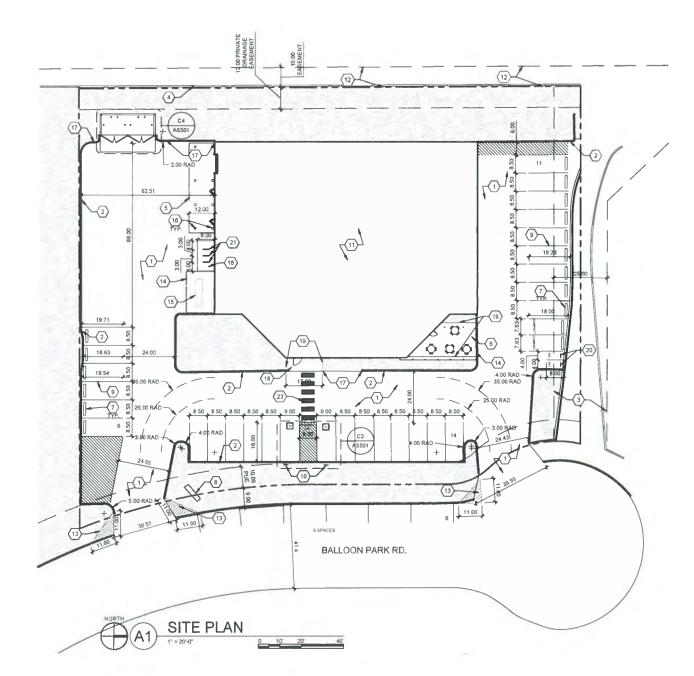



#### **GENERAL SHEET NOTES**

CONTRACTOR SHALL PROTECT EXISTING IMPROVEMENTS TO REMAIN INCLUDING BUT NOT LIMITED TO BUILDINGS PAVING CURBS, SITE WALLS, FOUNDATIONS AND UTILITIES EXISTING FOUNDATIONS SHALL MAINTAIN THEIR ORIGINAL STRUCTURAL INTEGRITY AS THEY WERE DESIGNED.

GENERAL CONTRACTOR SHALL PATCH REPAIR AND/OR REPLACE ITEMS TO REMAIN THAT HAVE BEEN DAMAGED DURING CONSTRUCTION TO THE OWNER'S SATISFACTION AND AT NO COST TO THE OWNER.

CONTRACTOR IS TO VERIFY ALL EXISTING UTILITY LOCATIONS BEFORE EXCAVATION. EXISTING UTILITIES AND ASSOCIATED EQUIPMENT SHOWN FOR REFERENCE ONLY ALL SITE PLAN DIMENSIONS ARE IN DECIMAL LUNIS SIDEWALK, JOINTS SHALL FOLLOW PATTERN AS SHOWN ON SITE PLAN. CONTRACTOR TO PRESERVE AND PROTECT ALL EXISTING PLANT MATERIAL TO REMAIN LANDSCAPING AND SICHAGE WILL NOT INTERFERE WITH CLEAR SIGHT REQUIREMENTS. THEREFORE SIGNS WALLS TREES AND SHUBBERT WETWEEN AS NO FETET TALL (AS MEASURED FROM THE GUITTER PAN) WILL NOT BE ACCEPTABLE IN THE CLEAR SIGHT TRIANGLE.

#### PROJECT INFORMATION

LEGAL DESCRIPTION
LOT NUMBERED NINE (9) OF BALLOON FIELD INDUSTRIAL PARK, ALBUQUERQUE, NEW
MEXICO, AS THE SAME IS SHOWN AND DESIGNATED ON THE CORRECTED PLAT FIELD IN
THE OFFICE OF THE COUNTY CLERK OF BERNALILLO COUNTY, NEW MEXICO ON MARCH
15TH 1984 RECORDED IN VOLUME C23 FOLIO 95 RECORDS OF BERNALILLO COUNTY, NEW
MEXICO.

PROJECT DESCRIPTION
LEVEL 3 INTERIOR RENOVATION

BUILDING INFORMATION TOTAL AREA 11 490 GSF WAREHOUSE 1 722 SF BUSINESS 9 768 SF

PARKING REQUIREMENT
BUISINESS: (3.5 \$P ACES1,000 \$F]
WAREHOUSE NO REQUIREMENTS
REQUIRED PARKING \$PACES
PROVIDED PARKING \$PACES
ONSTREET PARKING
ACCESSIBLE \$PACES \$PROVIDED
MOTORCYCLE \$PACES
BICYCLE \$TALLS REQUIRED
BICYCLE STALLS REQUIRED

34 STALLS 37 STALLS 6 STALLS 2 (1 VAN) 2 STALLS 3 STALLS 3 STALLS

#### ○ SHEET KEYED NOTES

CODE	DESCRIPTION
1	EXISTING ASPHALT PAVING TO REMAIN
2	EXISTING CURB TO REMAIN
3	25 DRAINAGE EASTMENT
4	EXISTING RETAINING WALL TO REMAIN
5	10"-0" TALL BUILDING OVERHANG
6	NEW CONCRETE PATIO CONCRETE TO SLOPE AT A MAXIMUM OF
_	2% AWAY FROM BUILDING TO LANDSCAPE AREA.
7	PARKING BUMPER, SEE A1/AS501
8	EXISTING MONUMENT SIGN
9	EXISTING PARKING STRIPING
10	ACCESSIBLE PARKING SIGN SEE B3/AS501
11	EXISTING BUILDING TO BE RENOVATED
12	10 -0" EXISTING PNM AND MT BELL EASEMENT
13	CLEAR SIGHT TRIANGLE LANDSCAPE AND SIGNAGE WILL NOT INTERFERE WITH CLEAR SIGHT REQUIREMENTS THEREFORE SIGNS WALLS TREES AND SHRUBBERY BETWEEN 3 AND 8 FEET TALL (AS MEASURED FROM THE GUTTER PAN) WILL NOT BE
	ACCEPTABLE IN THE CLEAR SIGHT TRIANGLE
14	5 -0" TALL PERFORATED METAL FENCE
15	GENERATOR
16	BUILDING COLUMN
17	NEW HEADER CURB, SEE 82/AS501
18	NEW CONCRETE SIDEWALK TO BE FLUSH WITH EXISTING ASPHALT MAXIMUM SLOPE NOT TO EXCEED 2% SEE B1/A5501
19	SIDEWALK WITH TURNDOWN EDGE SEE A4/AS501
20	MOTORCYCLE PARKING SIGN, SEE B3/AS501
21	BIKE RACK, SEE B4/AS501
22	EXISTING CONCRETE SIDEWALK TO REMAIN
23	PAINTED CROSSWALK, SEE D4/A5501

#### LEGEND

SYMBOL	DESCRIPTION
	PROPERTY LINE
	EASEMENT
	LANDSCAPE AREA

#### VICINITY MAP



Vicinity Map - Zone Atlas E-17-Z





LIGHTHOUSE RELOCATION
4208 BALLOON PARK RD NE
ALBUQUERQUE, NM 87109


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SITE PLAN TCL

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9/15/20

2012



#### Shannon Parks <shannon@scoutarch.com>
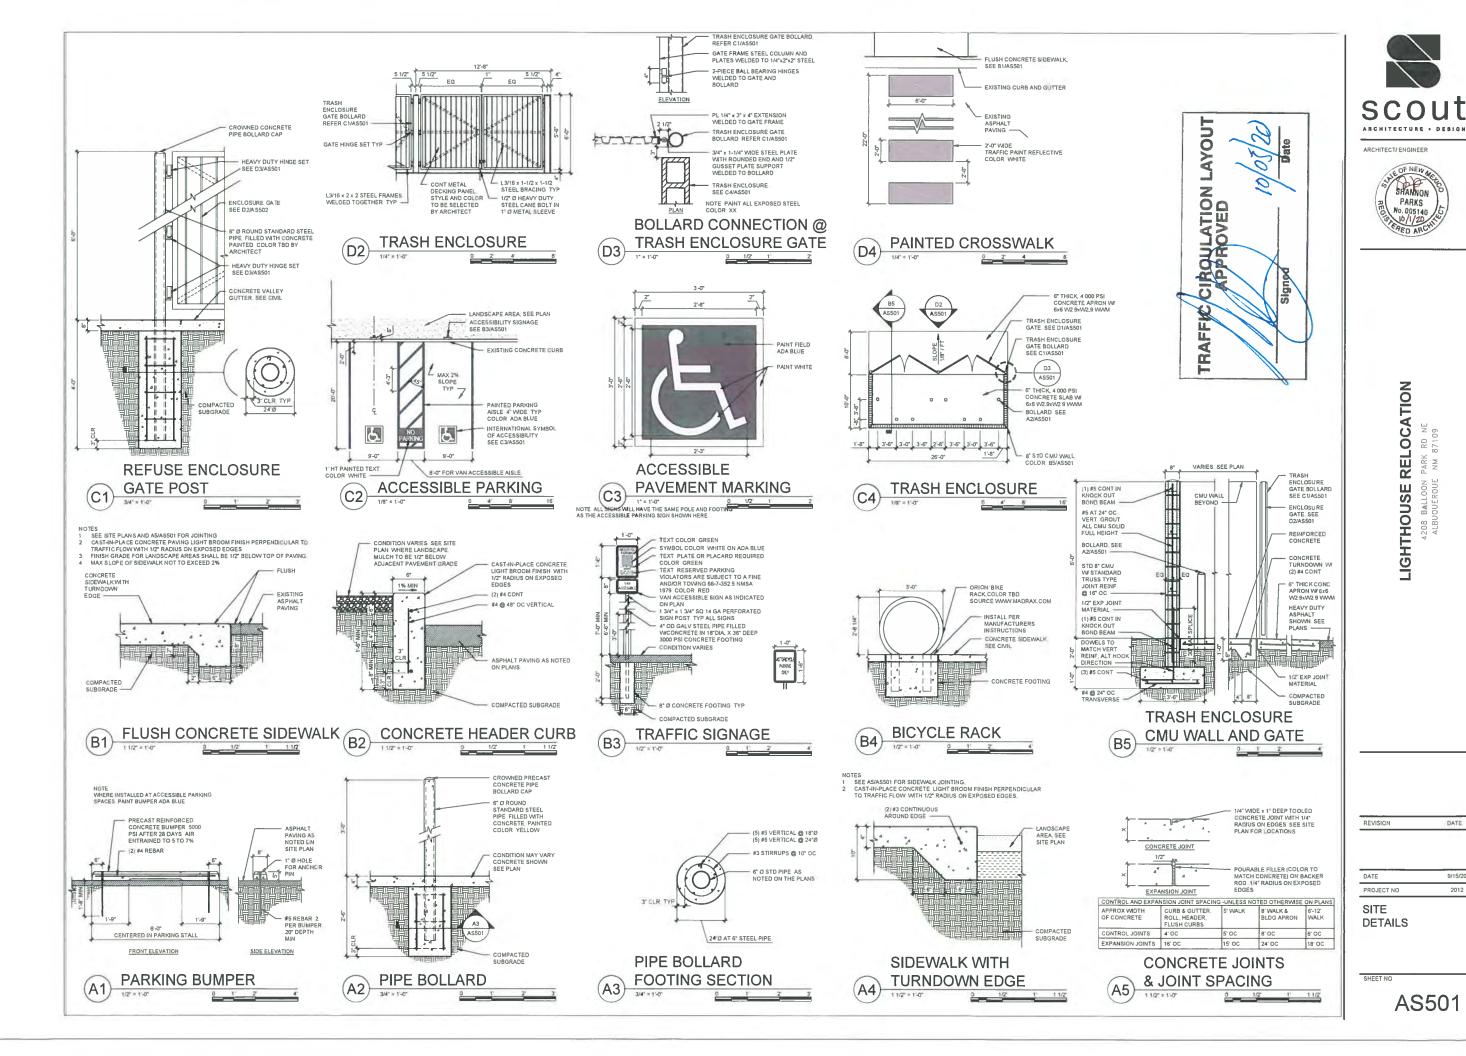
### TCL for LightHouse relocation - sidewalk waiver

Wolfenbarger, Jeanne < jwolfenbarger@cabq.gov> To: Shannon Parks <shannon@scoutarch.com> Cc: Bryan Handing <BHanding@lhbis.com>

Wed, Sep 30, 2020 at 8:22 AM

Good morning, Ms. Parks. A sidewalk waiver is granted for 4208 Balloon Park NE for Balloon Park and for Midway Pl. based on the reasons stated below.



#### JEANNE WOLFENBARGER

manager for transportation o 505.924-3991

e jwolfenbarger@cabq.gov

cabq.gov/planning

From: Shannon Parks [mailto:shannon@scoutarch.com]

Sent: Tuesday, September 29, 2020 4:27 PM

**To:** Wolfenbarger, Jeanne **Cc:** Bryan Handing

Subject: TCL for LightHouse relocation - sidewalk waiver

Hi Jeanne - thanks again for discussing review comments with me. Per our conversation, I am writing to request a sidewalk waiver for the LightHouse tenant improvement at 4208 Balloon Park Rd NE. The site is located at the end of a fully developed cul-de-sac. There is limited pedestrian traffic and no other adjacent properties along Balloon Park Rd NE have sidewalks therefore our site would have nothing to connect to. This request applies to TCL comments 11, 13, and

19 attached. thank you again for your help. please do not hesitate to contact me if you have any questions.

Shannon Parks LEED AP, Owner | Architect

#### **SCOUT ARCHITECTURE + DESIGN**

# CITY OF ALBUQUERQUE



October 5, 2020

Shannon Parks, RA Scout Architecture Design 745 Morningside Drive NE Albuquerque, NM 87XXX

Re: Lighthouse Relocaton
4208 Balloon Park Road NE
Traffic Circulation Layout
Architect's Stamp 09-21-2020 (E17-D019F)

Dear Ms. Parks,

The TCL submittal received 10-05-2020 is approved for Building Permit with. A copy of the stamped and signed plan will be needed for each of the building permit plans. Please keep the original to be used for certification of the site for final C.O. for Transportation.

When the site construction is completed and an inspection for Certificate of Occupancy (C.O.) is requested, use the original City stamped approved TCL for certification. Redline any minor changes and adjustments that were made in the field. A NM registered architect or engineer must stamp, sign, and date the certification TCL along with indicating that the development was built in "substantial compliance" with the TCL. Submit this certification, the TCL, and a completed <u>Drainage and Transportation Information Sheet</u> to front counter personnel for log in and evaluation by Transportation.

Once verification of certification is completed and approved, notification will be made to Building Safety to issue Final C.O. To confirm that a final C.O. has been issued, call Building Safety at 924-3690.

Sincerely

www.cabq.gov

PO Box 1293

Albuquerque

NM 87103

Nilo Salgado-Fernandez, P.E. Senior Engineer, Planning Dept. Development Review Services

C: CO Clerk, File

Albuquerque - Making History 1706-2006