




DEVELOPMENT REVIEW APPLICATION

Effective 4/17/19

Please check the appropriate box and refer to supplemental forms for submittal requirements. All fees must be paid at the time of application.									
Administrative Decisions	De	Decisions Requiring a Public Meeting or Hearing				Policy Decisions			
☐ Archaeological Certificate (Form P3)		☐ Site Plan – EPC including any Variances – EPC (Form P1)				☐ Adoption or Amendment of Comprehensive Plan or Facility Plan (Form Z)			
☐ Historic Certificate of Appropriateness (Form L)	s – Minor	☐ Master Development Plan (Form P1)				☐ Adoption or Amendment of Historic Designation (Form L)			
☐ Alternative Signage Plan (Form P3)		☐ Historic Certificate of Appropriateness – Major (Form L)				☐ Amendment of IDO Text (Form Z)			
☐ Minor Amendment to Site Plan (Form	P3) 🗆	Demo	olition Outside of HF	PO (Form L)	☐ Ann	☐ Annexation of Land (Form Z)			
☐ WTF Approval (Form W1)		☐ Historic Design Standards and Guidelines (Form L)			□ Ame	☐ Amendment to Zoning Map – EPC (Form Z)			
		☐ Wireless Telecommunications Facility Waiver (Form W2)			☐ Amendment to Zoning Map – Council (Form Z)				
					Appeals				
					☐ Decision by EPC, LC, ZHE, or City Staff (Form A)				
APPLICATION INFORMATION									
Applicant:					Phone:				
Address:					Em	nail:			
City:				State:	Zip	Zip:			
Professional/Agent (if any):						Phone:			
Address:						Email:			
City:				State:	Zip:				
Proprietary Interest in Site:				List <u>all</u> owners:					
BRIEF DESCRIPTION OF REQUEST									
Minor Amendment to the Cottonwood Mall's original Site Plan for the new construction of a 7,575-square foot Bubba's 33 restaurant.									
SITE INFORMATION (Accuracy of the existing legal description is crucial! Attach a separate sheet if necessary.)									
Lot or Tract No.:			Block:			Unit:			
Subdivision/Addition:			MRGCD Map No.:			UPC Code:			
Zone Atlas Page(s):			Existing Zoning:			Proposed Zoning:			
# of Existing Lots:	Existing Lots: # of Proposed Lots:			Total Area of Site (acres):					
LOCATION OF PROPERTY BY STREETS									
Site Address/Street: Between:				and:					
CASE HISTORY (List any current or prior project and case number(s) that may be relevant to your request.)									
Signature: Brandon Goldlers Date:									
Printed Name:									
FOR OFFICIAL USE ONLY									
Case Numbers	Action		Fees	Case Numbers		Action	Fees		
Meeting/Hearing Date:						Fee Total:			
Staff Signature: Date:					Project #				

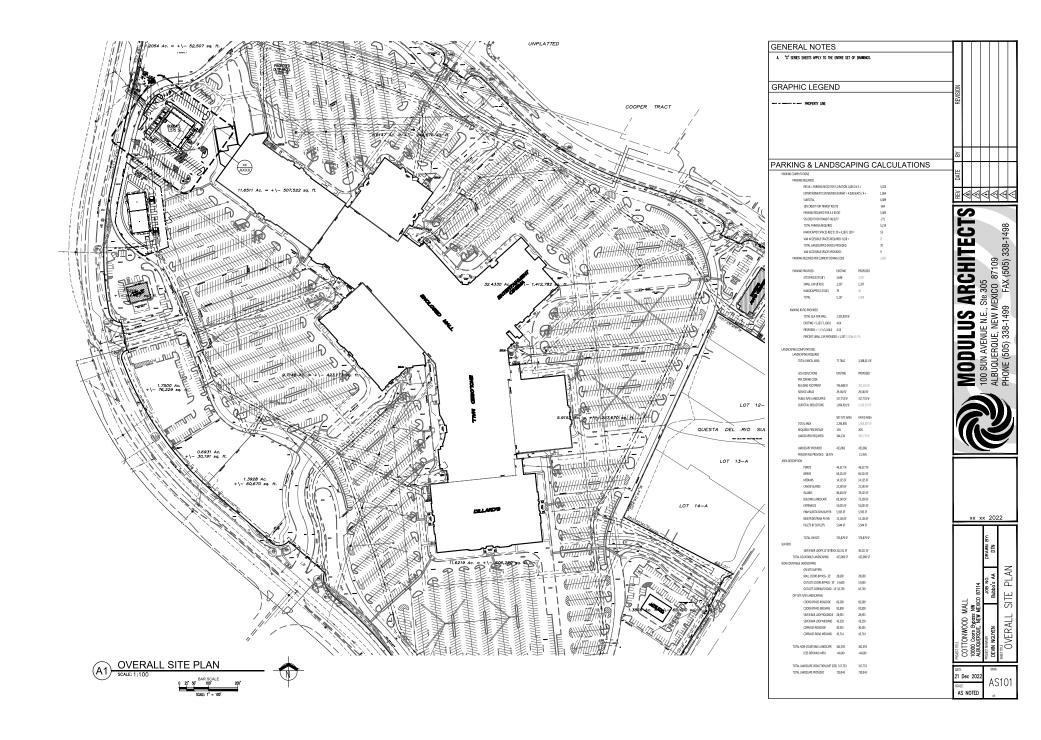

GENERAL SITE NOTES: I. CONTRACTOR SHALL OBTAIN ALL NECESSARY PERMITS PRIOR TO COMMENCEMENT OF CONSTRUCTION. . Contractor shall be responsible for providing safe and adequate WORKING CONDITIONS THROUGHOUT THE DURATION OF CONSTRUCTION OF THE PROPOSED SITE IMPROVEMENTS. . Contractor shall be responsible for verification of all site setbacks EASEMENTS AND DIMENSIONS PRIOR TO COMMENCEMENT OF CONSTRUCTION. H. ALL CONSTRUCTION MATERIALS AND WORKMANSHIP SHALL BE IN ACCORDANCE WITH THE LATEST STATE AND LOCAL GOVERNMENT CONSTRUCTION STANDARDS AND 5. ALL HANDICAP ACCESSIBLE SITE IMPROVEMENTS SHALL BE CONSTRUCTED ACCORDANCE WITH ALL FEDERAL. STATE AND LOCAL CODES AND REQUIREMENTS. 6. IF DURING THE COURSE OF CONSTRUCTION THE CONTRACTOR FINDS ANY DISCREPANCIES OR CONFLICTS BETWEEN THE PROPOSED SITE IMPROVEMENTS INDICATED ON THE PLANS AND THE PHYSICAL CONDITIONS OF THE SITE, OR ANY ERRORS OR OMISSIONS WITHIN THE PLANS OR IN THE SITE LAYOUT AS PROVIDED BY THE ENGINEER, IT SHALL BE THE RESPONSIBILITY OF THE CONTRACTOR TO IMMEDIATELY NOTIFY THE ENGINEER. UNTIL AUTHORIZED TO PROCEED, ANY WORK PERFORMED BY THE CONTRACTOR AFTER SUCH A DISCOVERY WILL BE AT THE CONTRACTOR'S SOLE RISK AND EXPENSE. CONTRACTOR SHALL COORDINATE ALL SITE IMPROVEMENTS WITH ARCHITECTURAL PLANS. ARCHITECTURAL PLANS SHALL BE USED FOR BUILDING STAKEOUT. B. CONTRACTOR SHALL COORDINATE ALL LANDSCAPE IMPROVEMENTS, INCLUDING NEW PLANTINGS AND TURF AREA RESTORATION REQUIREMENTS, WITH LANDSCAPE PLANS. CONSTRUCTION SURVEY AND STAKEOUT SHALL BE THE RESPONSIBILITY OF THE 10. ALL DIMENSIONS SHOWN ARE MEASURED FROM FACE OF CURB TO FACE OF CURB OR EDGE OF PAVEMENT TO EDGE OF PAVEMENT UNLESS OTHERWISE NOTED. 11. ALL CURB RADII ARE MEASURED AT THE FACE OF CURB UNLESS OTHERWISE 12. ALL NEW ASPHALT AND/OR CONCRETE PAVING SHALL MATCH EXISTING PAVEMENTS 13. CONTRACTOR SHALL RESTORE ALL DISTURBED AREAS OUTSIDE OF CONSTRUCTION LIMITS TO ORIGINAL CONDITION OR BETTER. 14. CONTRACTOR SHALL REPAIR AT HIS EXPENSE ANY DAMAGE TO EXISTING ASPHALT CONCRETE, CURBS, SIDEWALKS, ETC. RESULTING FROM CONSTRUCTION TRAFFIC AND/OR OPERATIONS. REPAIRS SHALL BE MADE TO THE SATISFACTION OF THE OWNER AND/OR ENGINEER. 15. ALL FIRE ACCESS LANES WITHIN THE PROJECT AREA SHALL REMAIN IN SERVICE, CLEAN OF DEBRIS, AND ACCESSIBLE FOR USE BY EMERGENCY VEHICLES. 16. ALL DETECTABLE WARNING PLATES SHALL BE PREFORMED PLASTIC INSERTS UNLESS OTHERWISE NOTED. 17. SEE GENERAL NOTES SHEET FOR ADDITIONAL INFORMATION AND REQUIREMENTS. SITE PLAN NOTES: REFER TO THE GEOTECHNICAL ENGINEERING REPORT PREPARED BY TERRACON CONSULTANTS, INC. AND DATED FEBRUARY 17TH, 2020 FOR ADDITIONAL INFORMATION REGARDING THE EXISTING SOIL CONDITIONS AND SUBGRADE PREPARATION REQUIREMENTS AND PROPOSED PAVEMENT RECOMMENDATIONS (TERRACON PROJECT NO. 66145007). SEE CONSTRUCTION DETAILS SHEET C7.0 FOR PAVEMENT SECTION DETAILS SEE GENERAL NOTES SHEET C1.0 FOR EXISTING LEGEND. PAVEMENT HATCH LEGEND: PROPOSED CONCRETE SIDEWALK 5" PORTLAND CEMENT CONCRETE 4" AGGREGATE BASE PROPOSED INTEGRAL BLACK CONCRETE SIDEWALK 5" PORTLAND CEMENT CONCRETE 4" AGGREGATE BASE PROPOSED CONCRETE LANDING 6" PORTLAND CEMENT CONCRETE (SEE STRUCTURAL PLANS FOR REINFORCEMENT, AGGREGATE, AND SUBGRADE REQUIREMENTS) PROPOSED INTEGRAL BLACK COLORED CONCRETE LANDING 6" PORTLAND CEMENT CONCRETE (SEE STRUCTURAL PLANS FOR REINFORCEMENT, AGGREGATE, AND SUBGRADE REQUIREMENTS) PROPOSED HEAVY DUTY INTEGRAL BLACK COLORED CONCRETE 6" PORTLAND CEMENT CONCRETE 6" PORTLAND CEMENT CONCRETE (SEE STRUCTURAL PLANS FOR REINFORCEMENT, AGGREGATE, AND SUBGRADE REQUIREMENTS) PROPOSED HEAVY DUTY INTEGRAL BLACK COLORED CONCRETE SLAB 6" PORTLAND CEMENT CONCRETE 6" AGGREGATE BASE (SEE GEOTECHNICAL REPORT) PROPOSED ASPHALT PAVEMENT 2" ASPHALT SURFACE COURSE 6" AGGREGATE BASE (SEE GEOTECHNICAL REPORT) PROPOSED HEAVY DUTY ASPHALT PAVEMENT 3" ASPHALT SURFACE COURSE 6" AGGREGATE BASE (SEE GEOTECHNICAL REPORT) PROPOSED LANDSCAPE AREA (SEE LANDSCAPE PLANS FOR ADDITIONAL INFORMATION AND DETAILS) SEVEN BAR NORTH SKYVIEW ACRES

TRAILS AT SEVEN BAR RANCH EAGLE RANCH S MANZANOS

VICINITY MAP N.T.S.



5065

COTTONWOOD LOOP CROSS SECTION: PROJECT INFORMATION:

5065

PROPOSED-

PROFILE SCALE

1" = 20' H

1" = 4' V

EXISTING PROPERTY LINE—

SITE DISTANCE TRIANGLE-

CROSS SECTION-

TTONWOOD

SITE DISTANCE TRIANGLE-

EXISTING PROPERTY LINE

SITE AREA: ZONED: PROPOSED BUILDING AREA: PROPOSED USE: BUILDING HEIGHT: PARKING REQUIRED: PARKING PROVIDED:

BICYCLE PARKING REQUIRED:

BICYCLE PARKING PROVIDED:

MOTORCYCLE PARKING PROVIDED:

(S18B)-\

MX-M - MIXED-USE-MODERATE INTENSITY ZONE DISTRICT 7,575 SQ. FT. RESTAURANT 25'-6" 66 STALLS ON SITE

GARAGE BAR

IN SIDEWALK

2% MAX SLOPE-

IN SIDEWALK

/(S10) / SPACE/ (TYP. ØF 5)

N\54°02'31\"

SEE ARCHITECTURAL PLANS

FOR BUILDING FOOTPRINT

FFE: 5065.50'

61 STALLS (1 STALL PER 1,000 SF TIMES 8, 7,575/1000*8 = 60.6) (INCLUDING 6 ADA STALLS)

7 STALLS (10% OF REQUIRED OFF-STREET PARKING SPACES = 0.1*61 = 6.1 => 7) 10 STALLS (2 STALLS PER RACK)

±1.03 ACRES

REQUIRED TO PROVIDE 3-MOTORCYCLE, MOPED, OR SCOOTER PARKING SPACES)

MOTORCYCLE PARKING REQUIRED: 3 (SITES THAT ARE REQUIRED TO PROVIDE BETWEEN 51-100 PARKING SPACES WILL BE

GRAPHIC SCALE

SITE DISTANCE NOTE:

-Proposed property

LINE TO BE RECORDED

 $\overleftarrow{\lambda}$ -proposed property

 λ line to be recorded

LANDSCAPING, SIGNAGE, WALLS, FENCES, TREES, AND SHRUBBERY BETWEEN

ARE NOT ÁLLOWED WITHIN THÈ CLEAR SÌGHT TRIANGLE.

THREE (3') AND EIGHT FEET (8') TALL (AS MEASURED FROM THE GUTTER PAN)

(IN FEET)

1 inch = 20 ft.

PROPOSED LEGEND:

---- PROPOSED FLUSH CURB PROPOSED PARKING STALL COUNT PROPOSED CONCRETE WHEEL STOP PROPOSED SIGN PROPOSED PYLON SIGN PROPOSED LIGHT POLE PROPOSED STORM SEWER STRUCTURES

PROPOSED SANITARY SEWER GREASE INTERCEPTOR

PROPOSED WATER SERVICE TAP PROPOSED TRANSFORMER PAD AND STEEL BOLLARDS

PROPOSED GAS METER

FOR ADDITIONAL INFORMATION AND DETAILS) S3A PROPOSED CONCRETE CURB AND GUTTER (SEE DETAIL ON SHEET C7.0)

S3B PROPOSED 1.5' WIDE CONCRETE SWALE (SEE DETAIL ON SHEET C7.1) PROPOSED CONCRETE BARRIER CURB (SEE DETAIL ON SHEET C7.0) S5 PROPOSED MONOLITHIC CONCRETE CURB AND SIDEWALK (SEE DETAIL ON

S6A PROPOSED CONCRETE SIDEWALK (SEE DETAIL ON SHEET C7.0) S6B PROPOSED INTEGRAL BLACK CONCRETE SIDEWALK (SEE DETAIL ON SHEET

S7A PROPOSED CONCRETE LANDING (SEE STRUCTURAL PLANS FOR ADDITIONAL

S7B PROPOSED INTEGRAL BLACK COLORED CONCRETE LANDING (SEE STRUCTURAL PLANS FOR ADDITIONAL INFORMATION AND DETAILS)

AND DETAILS)

GEOTECHNICAL REPORT FOR ADDITIONAL INFORMATION AND DETAILS. SEE DETAIL ON SHEET C7.0)

INFORMATION AND DETAILS, SEE DETAIL ON SHEET C7.0)

ADDITIONAL INFORMATION AND DETAILS, SEE DETAIL ON SHEET C7.0) S13 PROPOSED LANDSCAPE AREA (SEE LANDSCAPE PLANS FOR ADDITIONAL

(TYP. OF 11, SEE DETAIL ON SHEET C7.1)

S16 PROPOSED 4" WHITE PAVEMENT STRIPING PER LOCAL CODE

S18B PROPOSED 24"X36" R6-2L "ONE WAY" SIGN (SEE DETAILS ON SHEET C7.2) S18C PROPOSED 24"X36" R6-2R "ONE WAY" SIGN (SEE DETAILS ON SHEET C7.2) S19 PROPOSED HANDICAP ACCESSIBLE PARKING SIGN PER LOCAL CODE,

S20 PROPOSED BLUE HANDICAP ACCESSIBLE PARKING STALL STRIPING AND SYMBOL PER LOCAL CODE, 66-1-4.1.B NMSA 1978 (TYP., SEE DETAIL ON

S21 PROPOSED HANDICAP ACCESSIBLE CURB RAMP AT 12:1 MAXIMUM SLOPE PER

LOCAL CODES S22 PROPOSED CONCRETE TRANSFORMER PAD WITH STEEL BOLLARD PROTECTION

S25 PROPOSED MAGLIN MBR501 BIKE RACKS WITH BLACK POWDER COATED FINISH (TOTAL OF 5 BIKE RACKS PROVIDING 10 BICYCLE PARKING SPACES – SEE

S31 PROPOSED 8" THICK CONCRETE COLLAR (SEE STORM SEWER STRUCTURE

ZONING CODE (TYP. OF 3, SEE DETAIL ON SHEET C7.2)

ZONING CODE (TYP. OF 3).

PROPERTY LINE PROPOSED CONCRETE CURB AND GUTTER

PROPOSED SANITARY SEWER STRUCTURES

PROPOSED FIRE DEPARTMENT CONNECTION (FDC)

PROPOSED ELECTRIC METER, CT CABINET AND DISCONNECT

NOTE: SEE SHEET C1.0 FOR EXISTING LEGEND

SITE KEY NOTES:

S1 PROPOSED BUBBA'S 33 BUILDING (SEE ARCHITECTURAL AND STRUCTURAL PLANS FOR ADDITIONAL INFORMATION AND DETAILS) PROPOSED TRASH ENCLOSURE (SEE ARCHITECTURAL AND STRUCTURAL PLANS

INFORMATION AND DETAILS)

S8 PROPOSED HEAVY DUTY INTEGRAL BLACK COLORED CONCRETE (SEE THE STRUCTURAL S8 DUMPSTER ENCLOSURE PLANS FOR ADDITIONAL INFORMATION

PROPOSED HEAVY DUTY INTEGRAL BLACK COLORED CONCRETE SLAB (SEE

S10 PROPOSED ASPHALT PAVEMENT (SEE GEOTECHNICAL REPORT FOR ADDITIONAL

S11 PROPOSED HEAVY DUTY ASPHALT PAVEMENT (SEE GEOTECHNICAL REPORT FOR

INFORMATION AND DETAILS) S15 PROPOSED PRECAST CONCRETE WHEEL STOP ADJACENT TO FLUSH CURB

S17 PROPOSED DIRECTIONAL TRAFFIC ARROW (SEE DETAIL ON SHEET C7.0) S18A PROPOSED 30" R5-1 "DO NOT ENTER" SIGN (SEE DETAILS ON SHEET C7.2)

66-7-352.4C NMSA 1978 (TYP. OF 6, SEE DETAIL ON SHEET C7.0)

(CONTRACTOR SHALL COORDINATE CONCRETE TRANSFORMER PAD LOCATION,

SIZE AND THICKNESS WITH ELECTRIC COMPANY PRIOR TO INSTALLATION)

DETAIL ON SHEET C7.2)

DETAILS ON SHEET C7.1) S32 PROPOSED CURB TRANSITION (SEE STORM SEWER STRUCTURE DETAILS ON

S33 PROPOSED MOTORCYCLE PARKING SIGN PER THE CITY OF ALBUQUERQUE

S34 PROPOSED MOTORCYCLE PARKING STALLS TO HAVE "MC" PAINTED IN WHITE AT THE REAR OF THE PARKING STALLS PER THE CITY OF ALBUQUERQUE

S35 CURB TRANSITION FOR 0" TO 6" IN HEIGHT S40 EXISTING ASPHALT PAVEMENT TO REMAIN S41A EXISTING CONCRETE CURB AND GUTTER TO REMAIN S43 EXISTING LIGHT POLE TO REMAIN S44 EXISTING PAVEMENT STRIPING TO REMAIN

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Arlington Heights, IL 60005

PROJECT TEAM

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DESCRIPTION

02/26/21 COORDINATION SET

03/19/21 PERMIT SET 04/09/21 SITE PLAN 04/14/21 PERMIT RESPONSE 04/30/21 PERMIT RESPONSE

2 06/17/21 PERMIT RESPONSE #2

PROFESSIONAL SEAL



expires 12/31/22

date 6/18/21 PROFESSIONAL IN CHARGE **MICHAEL HAAS** PROFESSIONAL ENGINEER

LICENSE NO. 26056 **PROJECT MANAGER** EDWARD GOSS **QUALITY CONTROL** EDWARD GOSS

DRAWN BY MITCH HEFFERNAN

PROJECT NAME **TEXAS**

ALBUQUERQUE

ROADHOUSE


NEW MEXICO 10000 COORS BYPASS NW ALBUQUERQUE, NM 87114



PROJECT NUMBER

SHEET TITLE

SITE **PLAN**

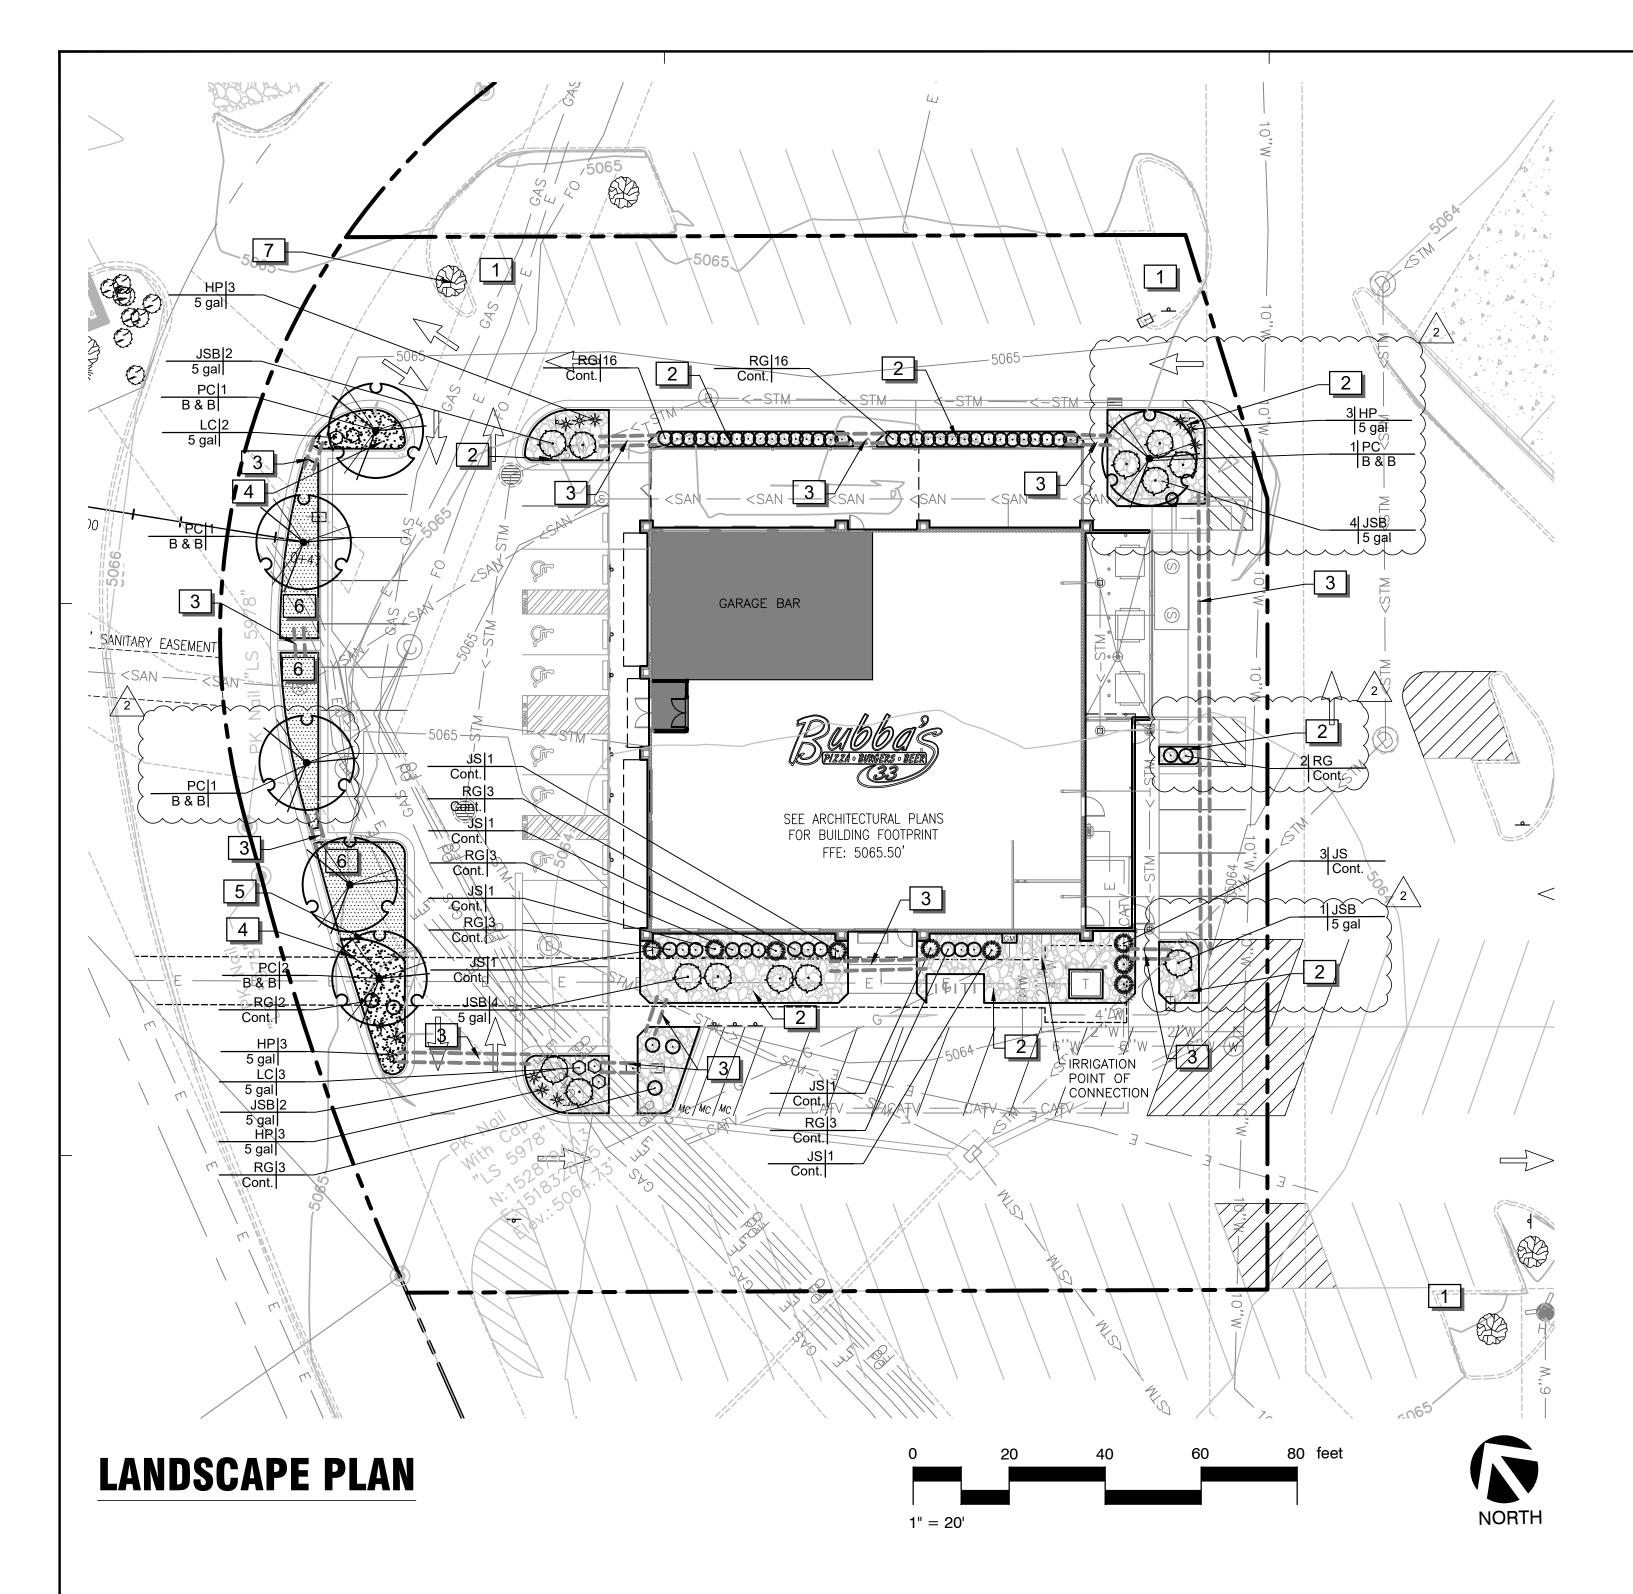

LANDSCAPE CALCULATIONS:

REQUIRED:

PROVIDED:

OFF-STREET PARKING LANDSCAPING
1 TREE PER 10 PARKING SPACES

7 TREES (68/10=6.8) 7 TREES (INCLUDING 1 EXISTING TREE)

REFERENCE NOTES SCHEDULE

SYMBOL DESCRIPTION

ANY DAMAGE

4

6

7

ANY DAMAGE TO ADJACENT PROPERTY OR AREAS OF WORK BY OTHERS IS TO BE REPAIRED TO ITS ORIGINAL CONDITION WITH NO ADDITIONAL COST TO OWNER.

INSTALL RIVER ROCK MULCH 5"-7" DIAMETER ON WEED BARRIER IN PLANT BED ADJACENT TO BUILDING FOUNDATION AND WHERE INDICATED ON PLAN. RIVER ROCK MULCH TO BE INSTALLED FLUSH WITH TOP OF SIDEWALK.

4", SCHEDULE 40 PVC IRRIGATION SLEEVE

INSTALL 3" DEPTH GRAVEL MULCH 1" MINUS DIAMETER, TAN/BROWN COLOR ON FILTER FABRIC WEED BARRIER IN LANDSCAPE AREAS, AND LEVELED TO A NEAT CLEAN APPEARANCE, 1/2" BELOW CONCRETE LEVEL.

CULTIVATED BEDLINE 4" DEPTH. (TYP.)

ALL LAWNS ARE TO BE ESTABLISHED BY SEEDING WITH VARIETY

COMMON TO LOCALITY.

EXISTING TREE TO REMAIN. PROVIDE PROTECTION DURING THE ENTIRE CONSTRUCTION PROCESS.

PLANT SCHEDULE

TREES	CODE	<u>QTY</u>	BOTANICAL NAME	COMMON NAME	ROOT	SIZE
Regional Control of the Control of t	PC	6	PISTACIA CHINENSIS	CHINESE PISTACHE	B & B	2"CAL
SHRUBS	CODE	<u>QTY</u>	BOTANICAL NAME	COMMON NAME	SIZE	<u>HEIGHT</u>
*	HP	12	HESPERALOE PARVIFLORA	RED YUCCA	5 GAL	
SWAMPER STATE OF THE STATE OF T	JS	9	JUNIPERUS CHINENSIS `SPARTAN`	SPARTAN JUNIPER	CONT.	7` HT. MIN.
\odot	JSB {	13	JUNIPERUS SABINA `BUFFALO`	BUFFALO JUNIPER	5 GAL	
\bigcirc	LC	5	LEUCOPHYLLUM FRUTESCENS 'COMPACTA'	COMPACT TEXAS RANGER	5 GAL	
0	RG (51	ROSMARINUS OFFICINALIS 'GORIZIA'	ROSEMARY 'GORIZIA'	CONT.	24" HT. MIN
GROUND COVERS	CODE	<u>QTY</u>	BOTANICAL NAME	COMMON NAME	<u>CONT</u>	
	BD	782 SF	BOUTELOUA DACTYLOIDES	BUFFALO GRASS	SOD	

SHRUB HEIGHT MEASUREMENTS ARE TO BE AS MEASURED FROM TOP OF ROOTBALL (TYP.)

GROUND COVERS QTY

356 SF 3" DEPTH GRAVEL MULCH ON FILTER FABRIC WEED BARRIER

1" MINUS DIAMETER, TAN/BROWN COLOR .

GENERAL NOTES:

- 1. GRAPHIC SYMBOLS TAKE PRECEDENCE OVER WRITTEN QUANTITIES AND KEYS ON PLAN.
- 2. CONTRACTOR TO REPAIR AND REPLACE ANY PLANT MATERIAL DAMAGED BY THIS CONSTRUCTION OUTSIDE PROJECT LIMITS. ANY EXISTING PLANT MATERIAL DAMAGED BY CONTRACTOR DURING CONSTRUCTION SHALL BE REPLACED WITH LIKE MATERIAL OF SIMILAR SPECIES AND SIZE AT THE CONTRACTOR'S EXPENSE WITH NO ADDITIONAL COST TO OWNER OR TENANT.
- 3. TWO WEEKS PRIOR TO PLANTING, THE CONTRACTOR SHALL SUBMIT TO THE OWNER / OWNER'S REPRESENTATIVE A PLANT PHOTO SUBMITTAL FOR APPROVAL. IF REQUESTED, BY THE OWNER, THE LANDSCAPE ARCHITECT WILL TAG THE MATERIAL.
- 4. EACH PHOTO SHALL CLEARLY SHOW THE SIZE, FORM, AND BRANCHING STRUCTURE AND QUALITY OF THE PLANT.
- 5. EACH PHOTO SHALL HAVE THE PLANT NAME, SIZE AND SPECIFICATIONS LABELED ON THE PHOTO.
- 6. ANY PHOTO SHOWING A GROUP OF PLANTS CLOSE TOGETHER WILL NOT BE ACCEPTED.
- 7. NO PARTIAL OR INCOMPLETE SUBMITTAL WILL BE ACCEPTED FOR REVIEW. ANY REJECTED SPECIES WILL BE SUBJECT TO RESUBMITTAL.
- 8. SAMPLES OF RIVER ROCK COBBLESTONE ARE TO BE PROVIDED TO OWNER/TENANT FOR REVIEW AND APPROVAL TWO (2) WEEKS PRIOR TO CONSTRUCTION. NO COBBLESTONE IS TO BE INSTALLED WITHOUT PRIOR APPROVAL FROM TEXAS ROADHOUSE.
- 9. REFER TO THE LATEST CIVIL PLANS FOR DISTURBED AREAS TO BE RESTORED. ADDITIONAL RESTORATION MAY BE NEEDED DUE TO FIELD CONDITIONS. SEE CIVIL SITE PLAN.
- 10. CONTRACTOR TO PROVIDE SITE IRRIGATION FOR ALL LANDSCAPE AREAS. IRRIGATION FOR THESE AREAS TO PROVIDE 100% COVERAGE OF ALL PLANTED AREAS. SHRUB BEDS TO BE WATERED WITH SUBSURFACE IRRIGATION. LAWN AREAS TO BE KEPT ON SEPARATE ZONES FROM SHRUB BEDS, DO NOT SPRAY ONTO BUILDING. IRRIGATION SYSTEM TO BE DESIGNED INSTALLED PER ALL LOCAL, STATE AND FEDERAL CODES.
- 11. REFER TO PLUMBING PLANS FOR BACKFLOW PREVENTER INFORMATION (IF LOCATED WITHIN THE BUILDING). IF BACKFLOW PREVENTOR IS LOCATED OUTSIDE, REFER TO SHEET L2.1 IRRIGATION NOTES AND DETAILS.

MAINTENANCE OF LANDSCAPING:

THE OWNER, TENANT, OR AGENT, IF ANY, SHALL BE RESPONSIBLE FOR PROVIDING, PROTECTING AND MAINTAINING ALL LANDSCAPING IN HEALTHY GROWING CONDITIONS, REPLACING IT WHEN NECESSARY TO ENSURE CONTINUOUS CONFORMANCE WITH THESE GUIDELINES AND KEEPING IT FREE FROM REFUSE AND DEBRIS. MAINTENANCE SHALL INCLUDE THE REPLACEMENT OF ALL DEAD PLANT MATERIAL WITHIN THE GUARANTEED CONTRACT PERIOD.



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 DATE
 DESCRIPTION

 03/19/21
 PERMIT SET

 04/14/21
 PERMIT RESPONSE

 04/30/21
 PERMIT RESPONSE

 06/17/21
 PERMIT RESPONSE #2

PROFESSIONAL SEAL

PROFESSIONAL IN CHARGE

PROFESSIONAL ENGINEER LICENSE NO.

PROJECT MANAGER
EDWARD GOSS
QUALITY CONTROL

DRAWN BY JEAN SHI

PROJECT NAME

TEXAS ROADHOUSE

ALBUQUERQUE NEW MEXICO

10000 COORS BYPASS NW ALBUQUERQUE, NM 87114




PROJECT NUMBER

SHEET TITLE

LANDSCAPE PLAN

SHEET NUMBER

L1.0

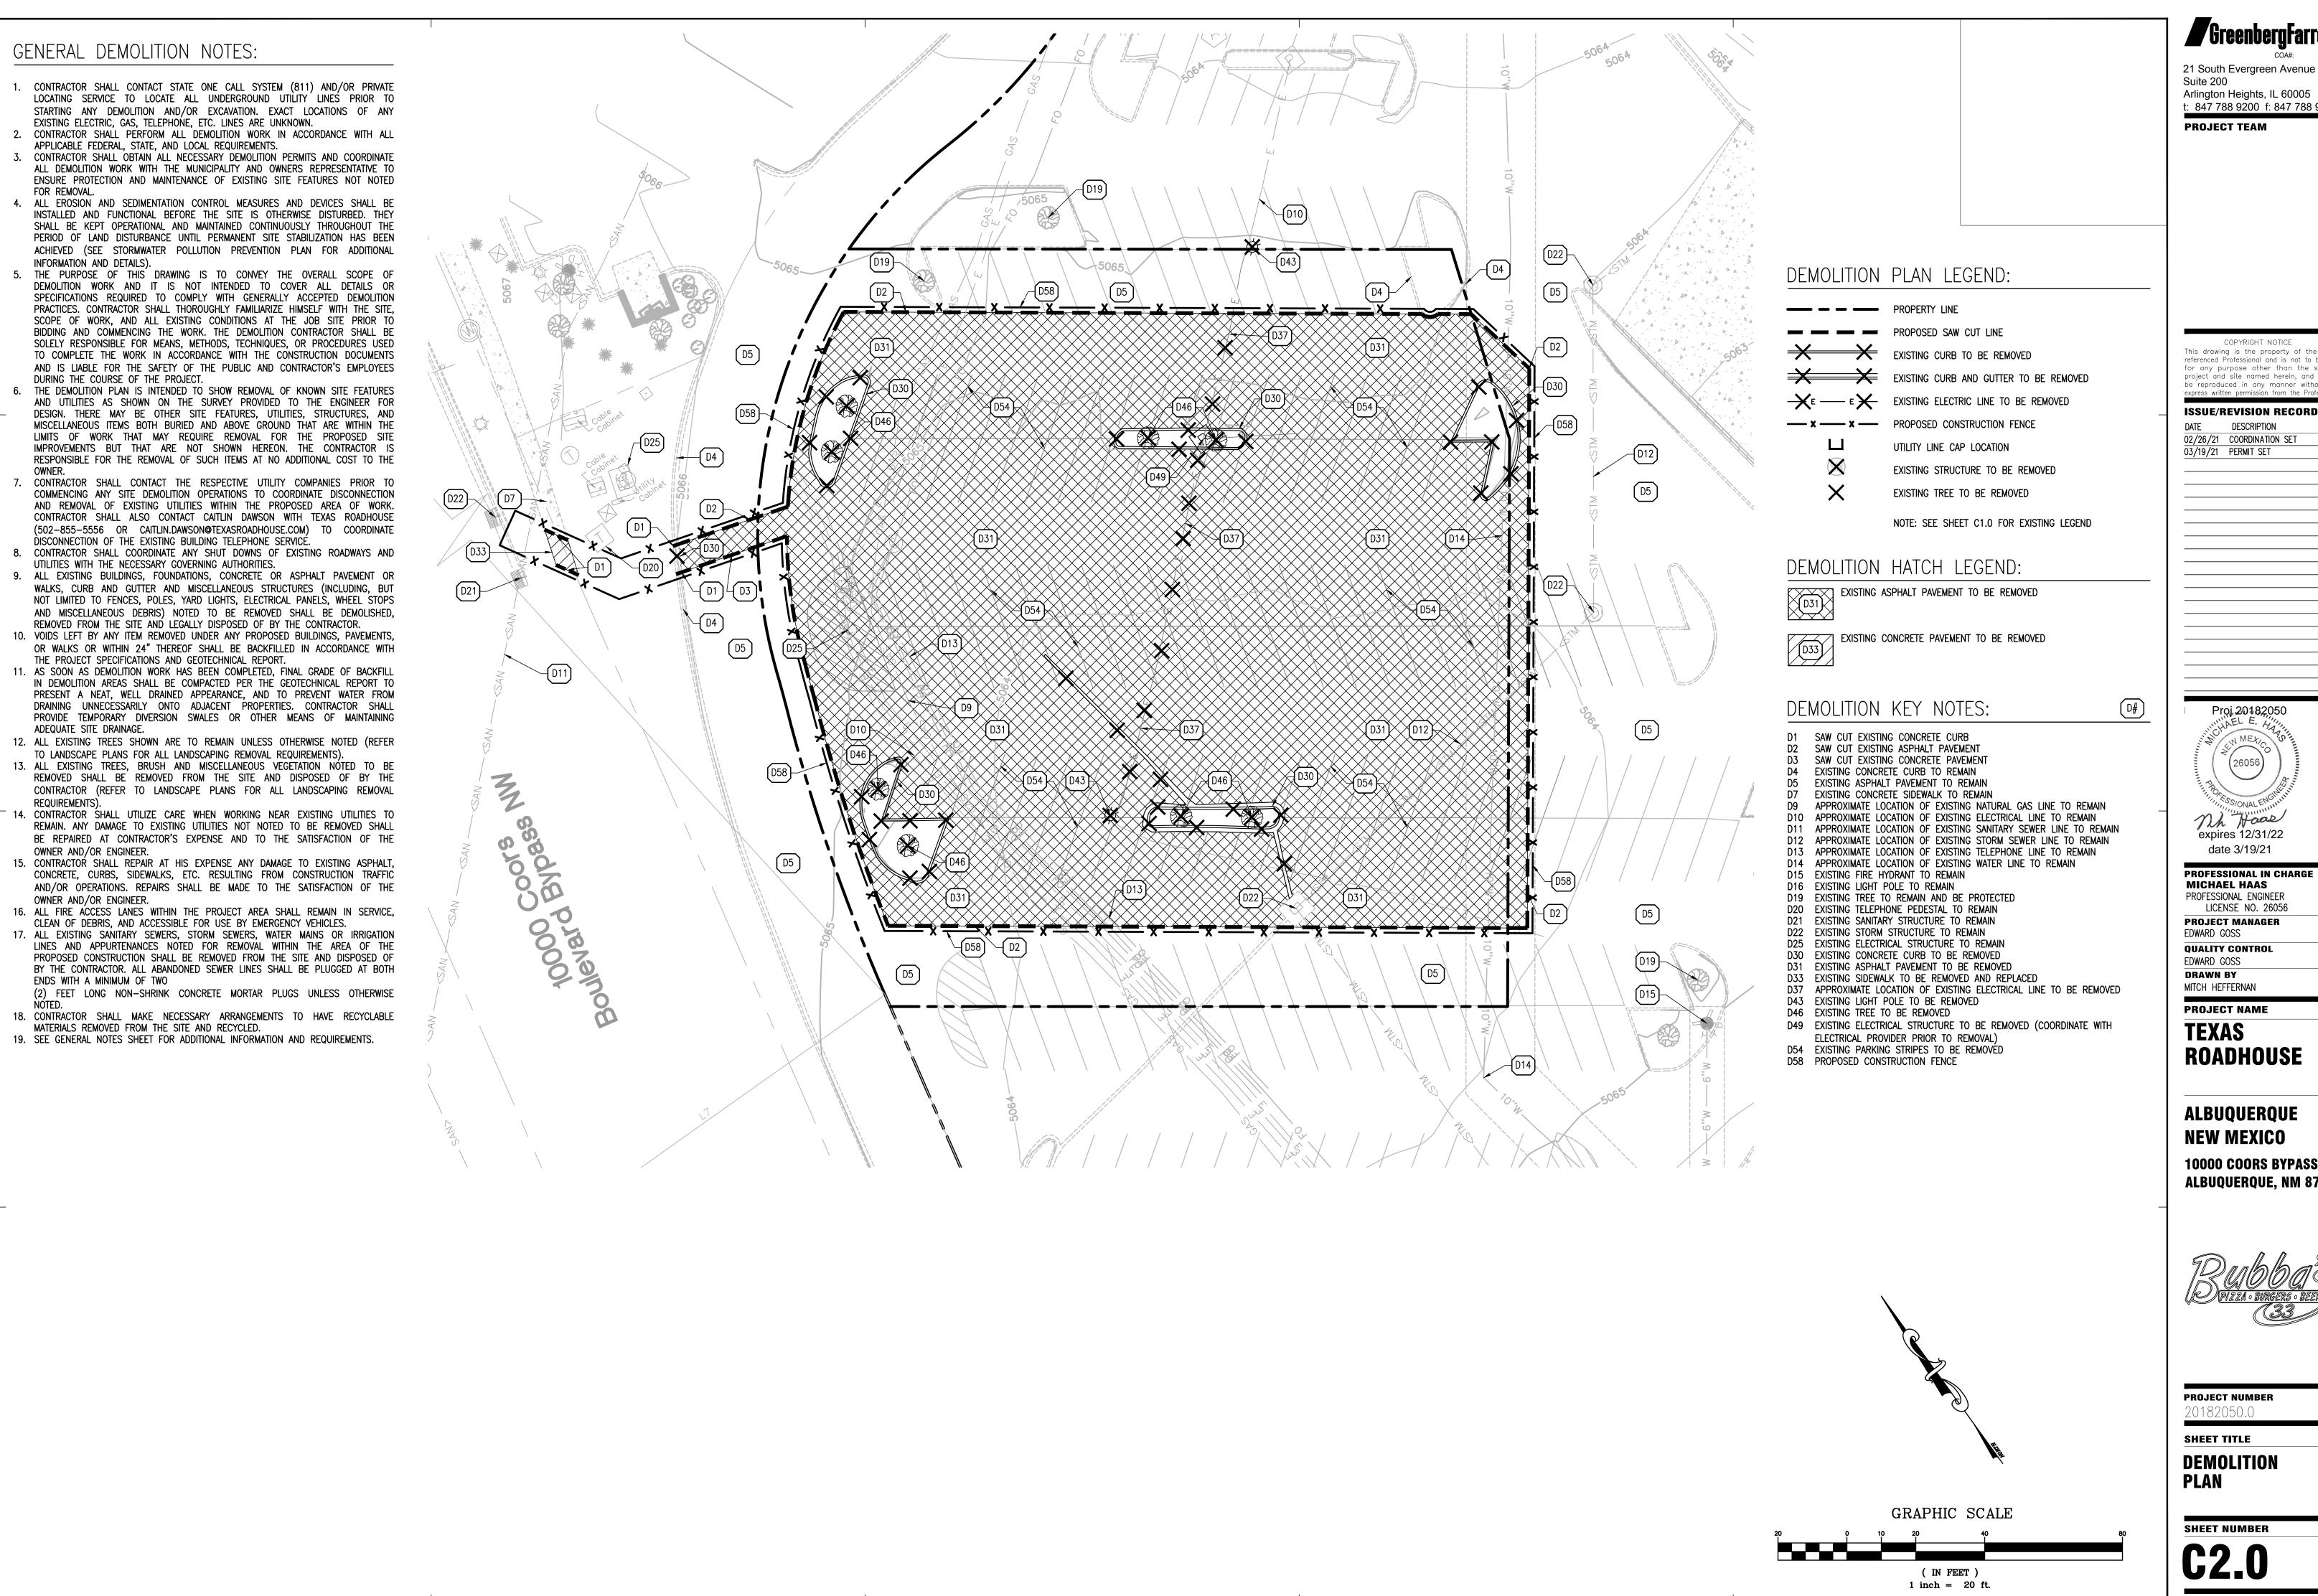

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ISSUE/REVISION RECORD DESCRIPTION

Proj. 20182050

Mh Have expires 12/31/22 date 3/19/21

MICHAEL HAAS PROFESSIONAL ENGINEER LICENSE NO. 26056 PROJECT MANAGER EDWARD GOSS

QUALITY CONTROL EDWARD GOSS **DRAWN BY** MITCH HEFFERNAN

TEXAS

ROADHOUSE

ALBUQUERQUE NEW MEXICO


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PROJECT NUMBER 20182050 0

SHEET TITLE

DEMOLITION PLAN



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TRAFFIC ARROW

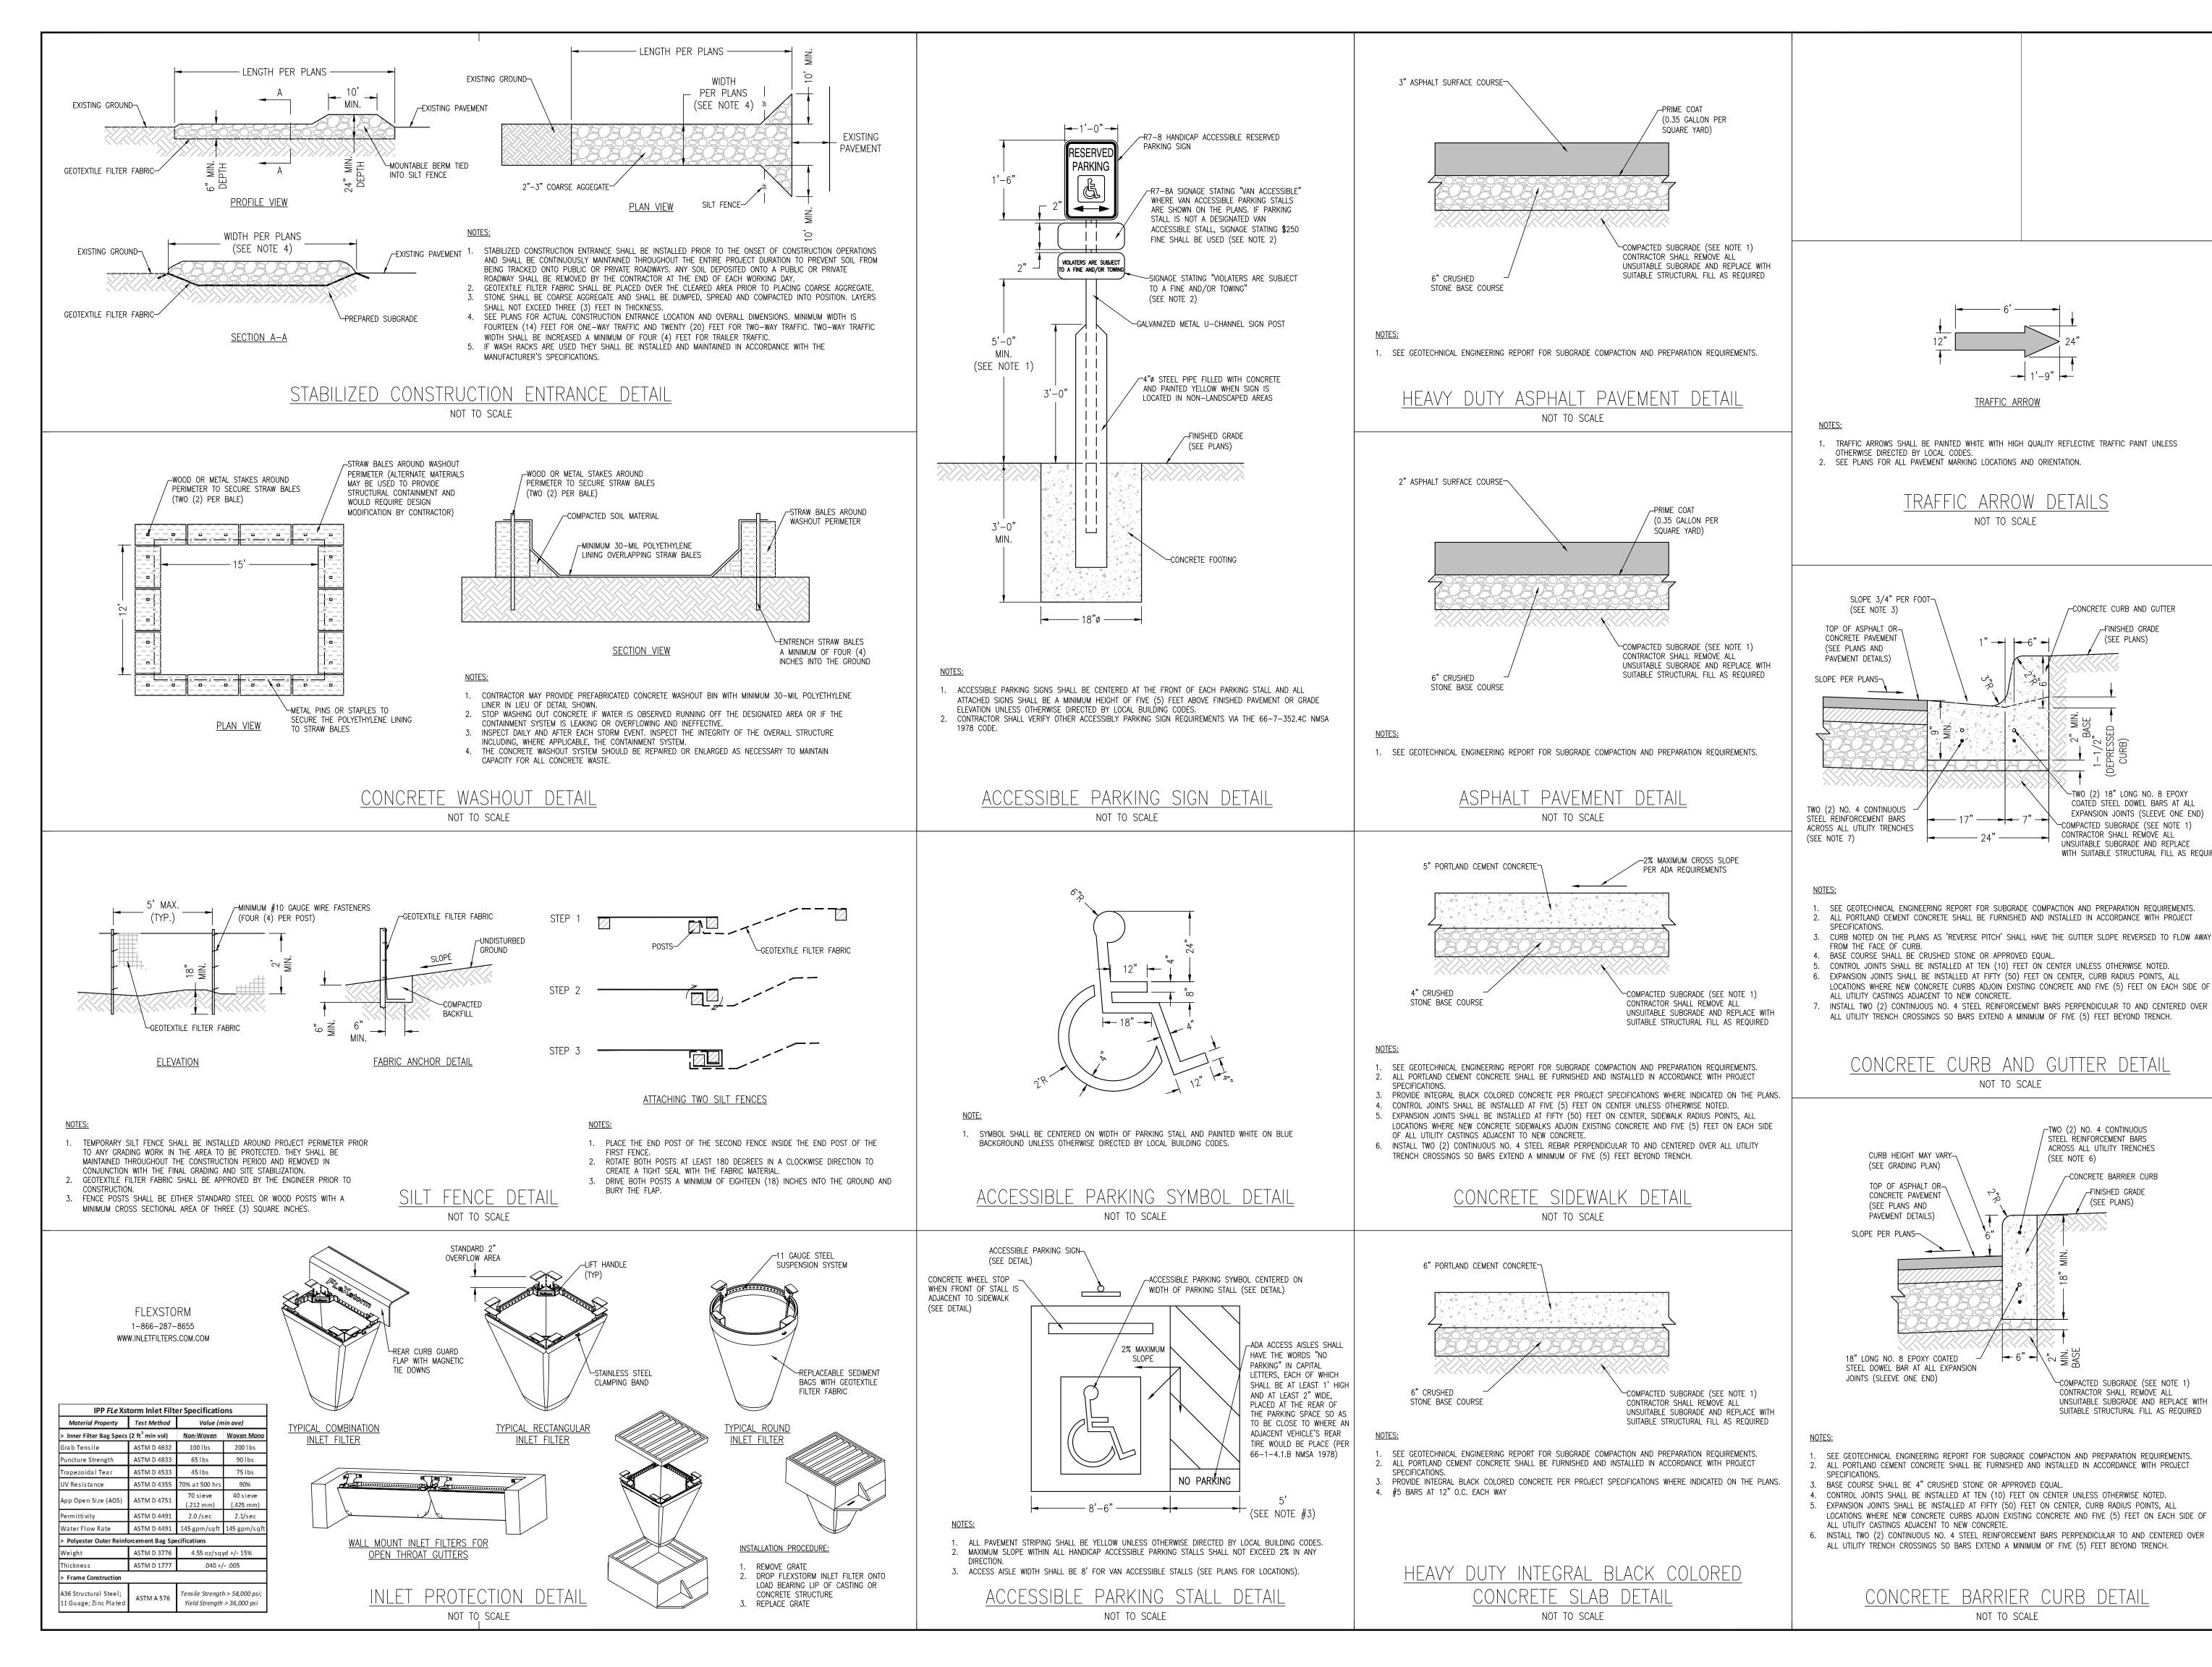NOT TO SCALE

NOT TO SCALE

NOT TO SCALE

CONCRETE CURB AND GUTTER

(SEE PLANS)

FINISHED GRADE

-TWO (2) 18" LONG NO. 8 EPOXY COATED STEEL DOWEL BARS AT ALL

-COMPACTED SUBGRADE (SEE NOTE 1)

UNSUITABLE SUBGRADE AND REPLACE

CONTRACTOR SHALL REMOVE ALL

_TWO (2) NO. 4 CONTINUOUS

STEEL REINFORCEMENT BARS

(SEE NOTE 6)

ACROSS ALL UTILITY TRENCHES

CONCRETE BARRIER CURB

(SEE PLANS)

-COMPACTED SUBGRADE (SEE NOTE 1)

UNSUITABLE SUBGRADE AND REPLACE WITH

SUITABLE STRUCTURAL FILL AS REQUIRED

CONTRACTOR SHALL REMOVE ALL

EXPANSION JOINTS (SLEEVE ONE END)

WITH SUITABLE STRUCTURAL FILL AS REQUIRED

DESCRIPTION 02/26/21 COORDINATION SET 03/19/21 PERMIT SET 04/09/21 SITE PLAN

04/14/21 PERMIT RESPONSE 04/30/21 PERMIT RESPONSE

Mh Hoose expires 12/31/22

date 4/30/21 PROFESSIONAL IN CHARGE MICHAEL HAAS

PROFESSIONAL ENGINEER LICENSE NO. 26056 PROJECT MANAGER

EDWARD GOSS **QUALITY CONTROL**

EDWARD GOSS **DRAWN BY** MITCH HEFFERNAN

PROJECT NAME

TEXAS ROADHOUSE

ALBUQUERQUE NEW MEXICO


10000 COORS BYPASS NW ALBUQUERQUE, NM 87114



PROJECT NUMBER

SHEET TITLE


CONSTRUCTION DETAILS

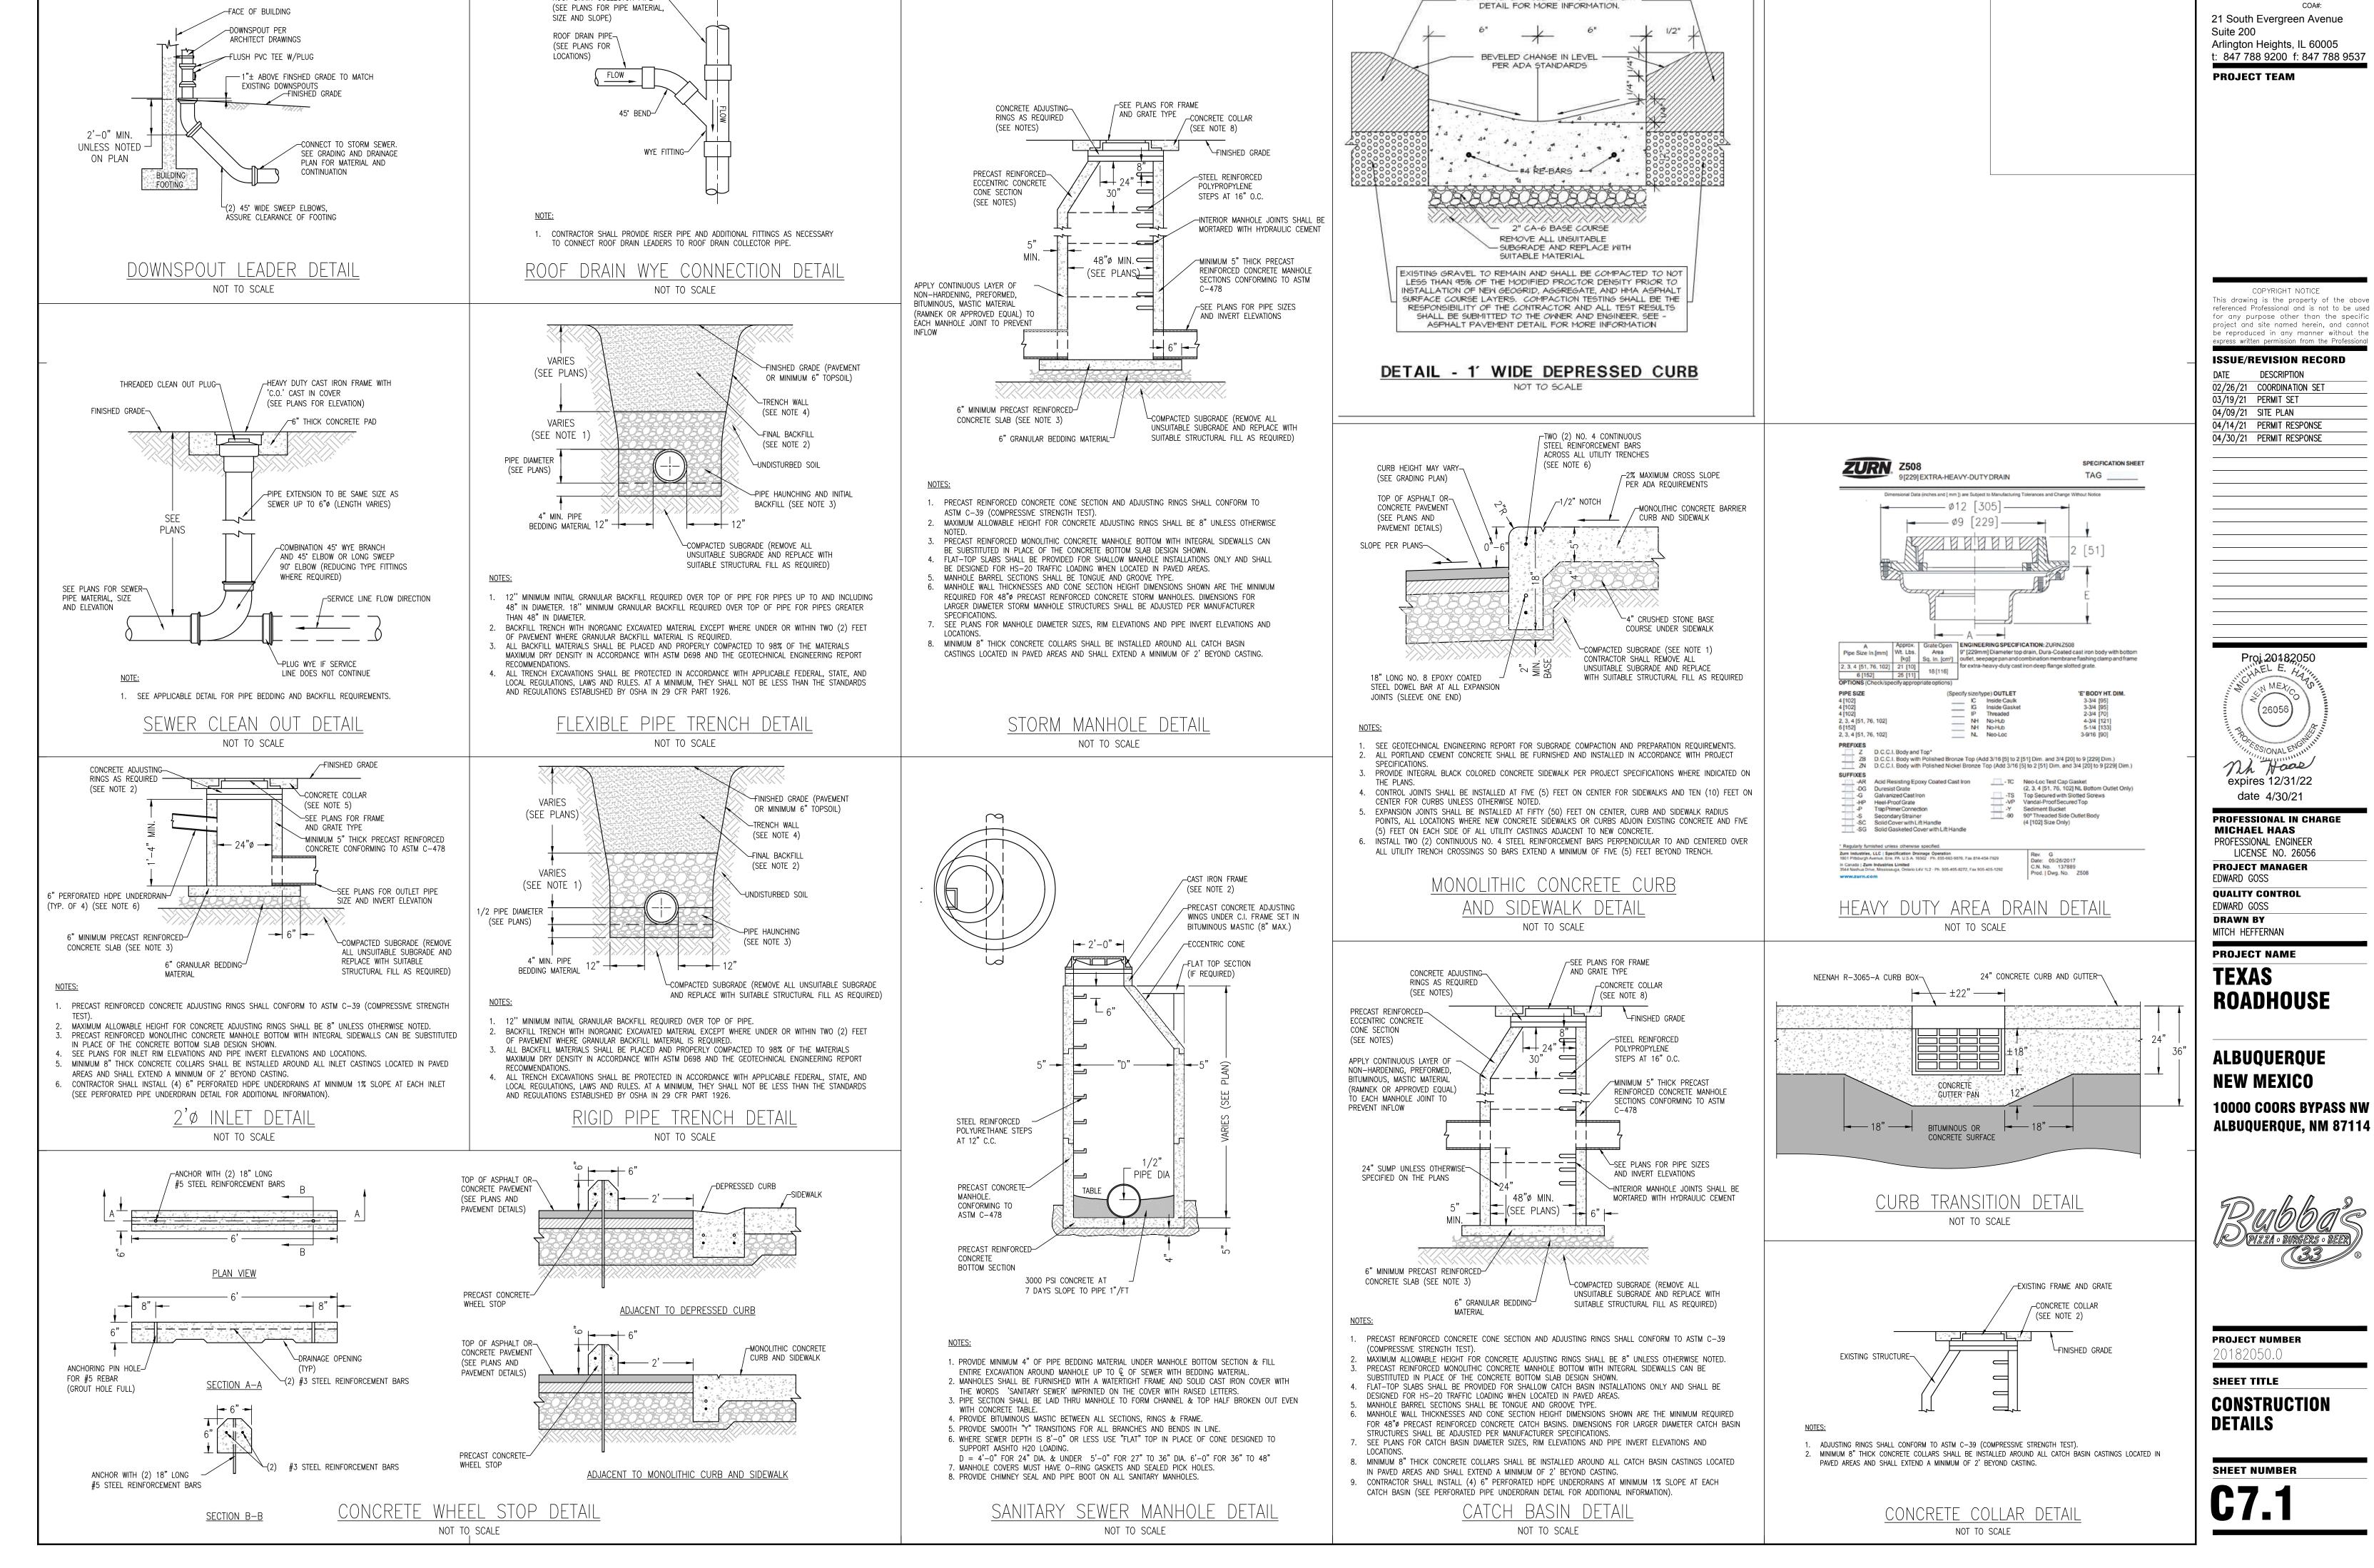

ROOF DRAIN COLLECTOR PIPE


OWNERS OF TESSES AND DAYSOMENT

NEW PAVEMENT. SEE ASPHALT PAVEMENT

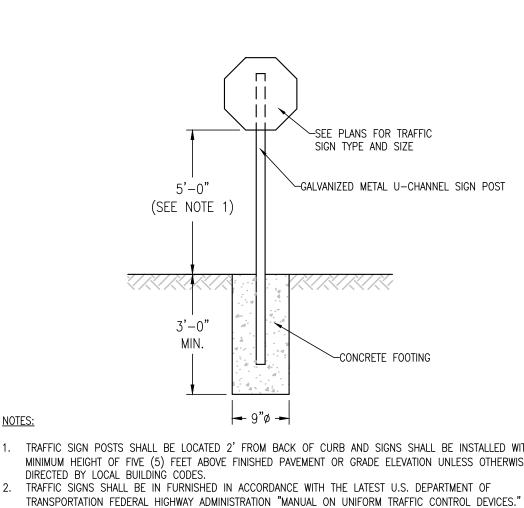

- 1. TRAFFIC SIGN POSTS SHALL BE LOCATED 2' FROM BACK OF CURB AND SIGNS SHALL BE INSTALLED WITH A MINIMUM HEIGHT OF FIVE (5) FEET ABOVE FINISHED PAVEMENT OR GRADE ELEVATION UNLESS OTHERWISE
- TRAFFIC SIGN DETAIL GRASS AREA

NOT TO SCALE

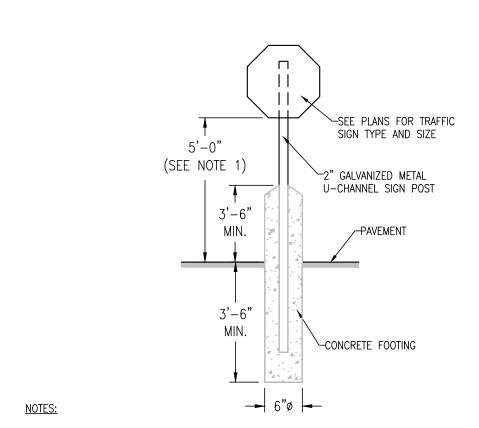

- 1. TRAFFIC SIGN POSTS SHALL BE LOCATED 2' FROM BACK OF CURB AND SIGNS SHALL BE INSTALLED WITH A MINIMUM HEIGHT OF FIVE (5) FEET ABOVE FINISHED PAVEMENT OR GRADE ELEVATION UNLESS OTHERWISE
- DIRECTED BY LOCAL BUILDING CODES. 2. TRAFFIC SIGNS SHALL BE IN FURNISHED IN ACCORDANCE WITH THE LATEST U.S. DEPARTMENT OF TRANSPORTATION FEDERAL HIGHWAY ADMINISTRATION "MANUAL ON UNIFORM TRAFFIC CONTROL DEVICES."

SIGN, POST & BOLLARD DETAIL -PAVED AREAS NOT TO SCALE




R5-1 DO NOT ENTER SIGN DETAIL NOT TO SCALE



(left) sign detail NOT TO SCALE



R6-2L ONE WAY (ARROW) R6-2R ONE WAY (ARROW (RIGHT) SIGN DETAIL NOT TO SCALE

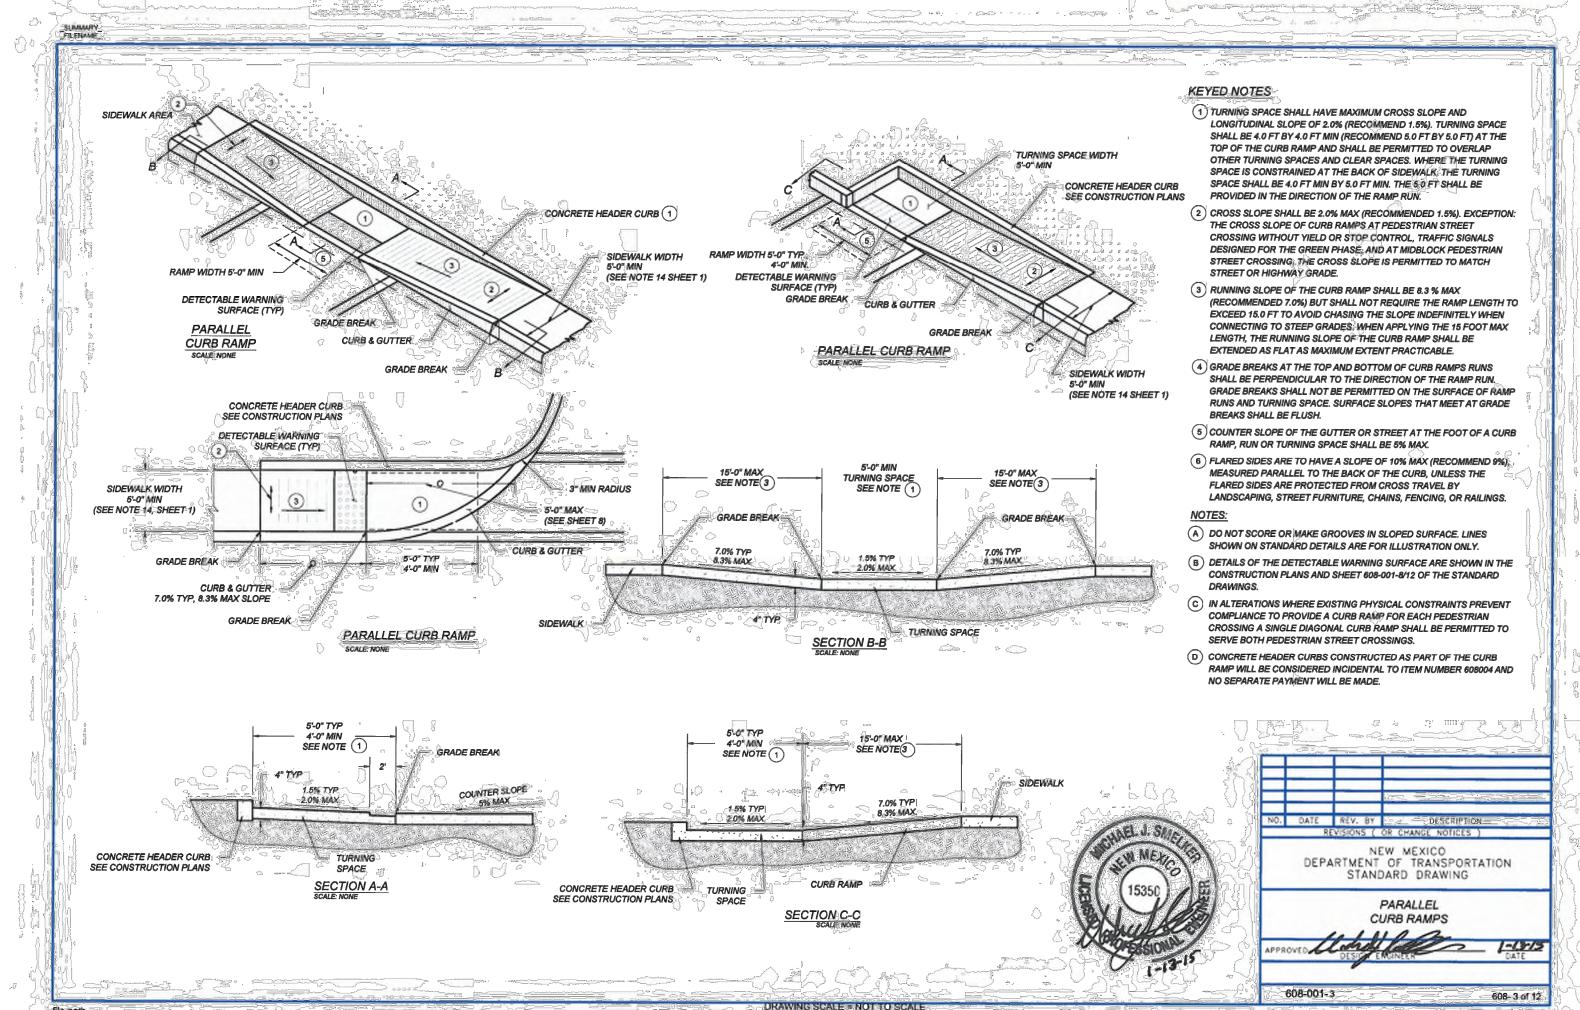

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ISSUE/REVISION RECORD

21 South Evergreen Avenue

Arlington Heights, IL 60005 t: 847 788 9200 f: 847 788 9537

PROJECT TEAM

Suite 200

DESCRIPTION 02/26/21 COORDINATION SET 03/19/21 PERMIT SET 04/09/21 SITE PLAN

04/14/21 PERMIT RESPONSE 04/30/21 PERMIT RESPONSE

expires 12/31/22

date 4/30/21 PROFESSIONAL IN CHARGE MICHAEL HAAS

PROFESSIONAL ENGINEER LICENSE NO. 26056 PROJECT MANAGER

EDWARD GOSS **QUALITY CONTROL** EDWARD GOSS

DRAWN BY MITCH HEFFERNAN

PROJECT NAME

TEXAS ROADHOUSE

ALBUQUERQUE NEW MEXICO

10000 COORS BYPASS NW ALBUQUERQUE, NM 87114




PROJECT NUMBER

SHEET TITLE


CONSTRUCTION DETAILS

SHEET NUMBER

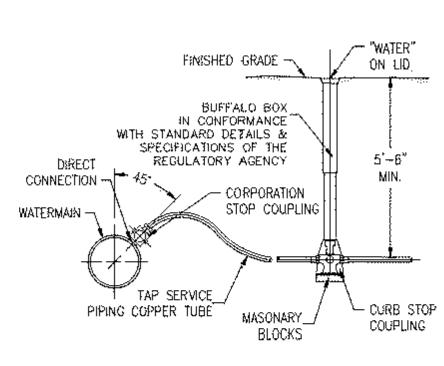

- 1. SERVICE PIPE TO BE WEAVED IN TRENCH TO ALLOW AT LEAST ONE (1) FOOT EXTRA LENGTH
- 2. UPON COMPLETION OF WATER SERVICE CONSTRUCTION ALL BOXES ARE TO BE FULLY EXTENDED AND LEFT PROTRUDING
- 3. GRANULAR BACKFILL TO BE PLACED UNDER PAVEMENT AS

WATER SERVICE DETAIL

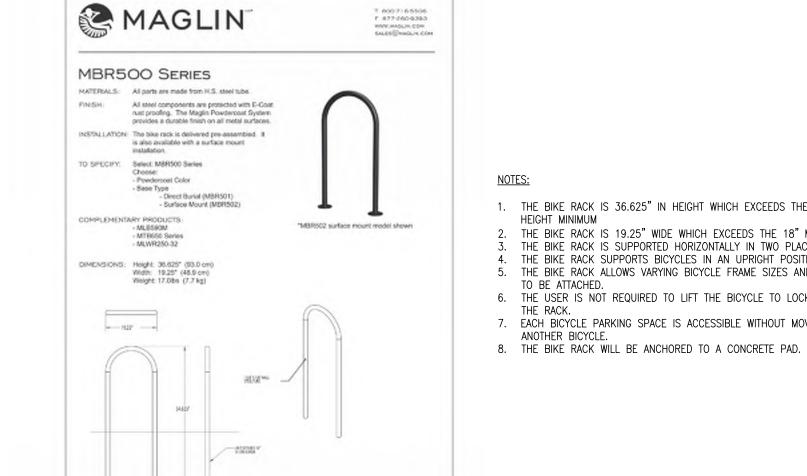

1. THE BIKE RACK IS 36.625" IN HEIGHT WHICH EXCEEDS THE 30" HEIGHT MINIMUM THE BIKE RACK IS 19.25" WIDE WHICH EXCEEDS THE 18" MINIMUM. THE BIKE RACK IS SUPPORTED HORIZONTALLY IN TWO PLACES. THE BIKE RACK SUPPORTS BICYCLES IN AN UPRIGHT POSITION.

5. THE BIKE RACK ALLOWS VARYING BICYCLE FRAME SIZES AND STYLES TO BE ATTACHED. 6. THE USER IS NOT REQUIRED TO LIFT THE BICYCLE TO LOCK IT TO 7. EACH BICYCLE PARKING SPACE IS ACCESSIBLE WITHOUT MOVING ANOTHER BICYCLE.

> DETAIL - 1' WIDE DEPRESSED CURB NOT TO SCALE

BIKE RACK DETAIL NOT TO SCALE

- FRAME & COVER AS SPECIFIED MARKED WITH 'WATER' PRECAST CONCRETE — FINISHED GRADE ADJUSTING RINGS (8" MAX.) **ECCENTRIC** - BITUMINOUS MASTIC BED CONE - PRECAST CONCRETE RISER SECTION - PROVIDE ½" PREFORMED JOINT FILLER BETWEEN PIPE AND TAPPING VALVE AS SPECIFIED BY THE LOCAL AUTHORITY -PEDESTAL --- PIPE OPENINGS TO BE CAST IN WALL TAPPING SLEEVE -AND SEALED WITH BITUMINOUS MASTIC EXISTING WATERMAIN -MORTAR CONCRETE THRUST BLOCK FOR FULL WIDTH OF SLEEVE 8" PRECAST REINFORCED CONCRETE BASE PROVIDE 1/2" PREFORMED JOINT FILLER BETWEEN PIPE AND PEDESTAL CONCRETE PEDESTAL. WIDTH OF PIPE WIDE BY LENGTH TO MATCH VALVE BOX

-"MOTORCYCLE PARKING ONLY" PARKING SIGN,

GALVANIZED METAL U-CHANNEL SIGN POST

√4"ø STEEL PIPE FILLED WITH CONCRETE

AND PAINTED YELLOW WHEN SIGN IS

LOCATED IN NON-LANDSCAPED AREAS

FINISHED GRADE

(SEE PLANS)

/X/*X*//X//X//X

CONCRETE FOOTING

OR APPROVED EQUAL

DTORCYCL

PARKING

ONLY

ELEVATION UNLESS OTHERWISE DIRECTED BY LOCAL BUILDING CODES.

1. MOTORCYCLE PARKING SIGNS SHALL BE CENTERED AT THE FRONT OF EACH PARKING STALL AND ALL

MOTORCYCLE PARKING SIGN DETAIL

NOT TO SCALE

ATTACHED SIGNS SHALL BE A MINIMUM HEIGHT OF FIVE (5) FEET ABOVE FINISHED PAVEMENT OR GRADE

5'-0"


MIN.


(SEE NOTE 1)

NOTES:

ABOVE THE PROPOSED GRADE. SPECIFIED. 4. JET ALL TRENCHES. TAPPING SLEEVE, VALVE & VALVE VAULT DETAIL SCALE: NONE SCALE: NONE


NEW PAVEMENT, SEE ASPHALT PAVEMENT DETAIL FOR MORE INFORMATION. BEVELED CHANGE IN LEVEL : PER ADA ŞTANDARDS 2" CA-6 BASE COURSE REMOVE ALL UNSUITABLE --- SUBGRADE AND REPLACE WITH SUITABLE MATERIAL EXISTING GRAVEL TO REMAIN AND SHALL BE COMPACTED TO NOT LESS THAN 95% OF THE MODIFIED PROCTOR DENSITY PRIOR TO INSTALLATION OF NEW GEOGRID, AGGREGATE, AND HMA ASPHALT SURFACE COURSE LAYERS. COMPACTION TESTING SHALL BE THE L RESPONSIBILITY OF THE CONTRACTOR AND ALL TEST RESULTS SHALL BE SUBMITTED TO THE OWNER AND ENGINEER, SEE -ASPHALT PAVENENT DETAIL FOR MORE INFORMATION

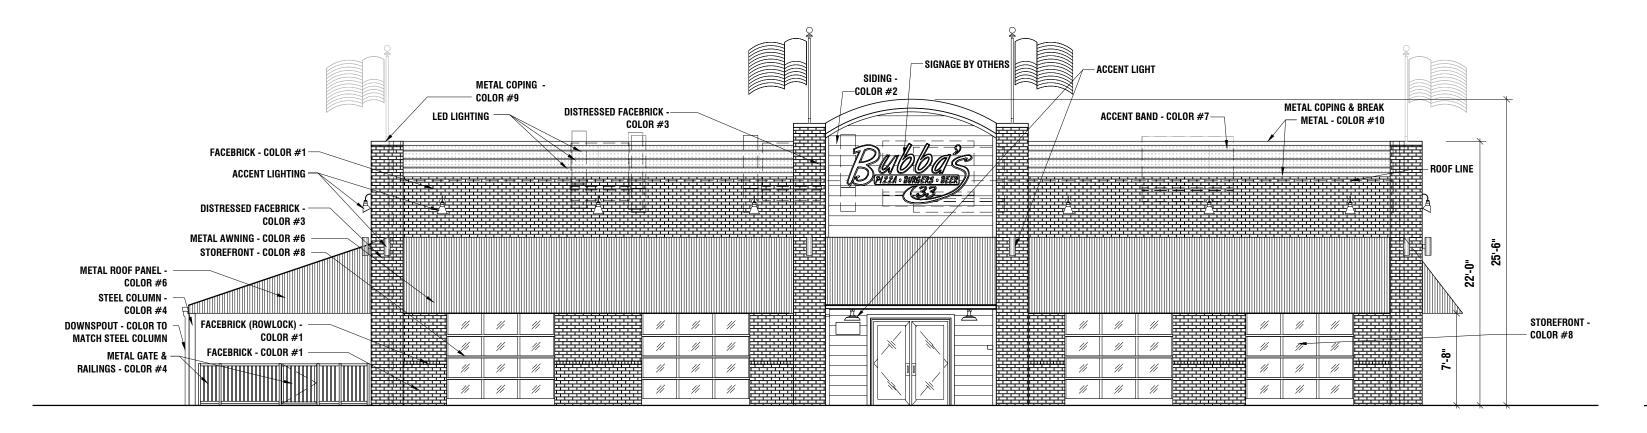


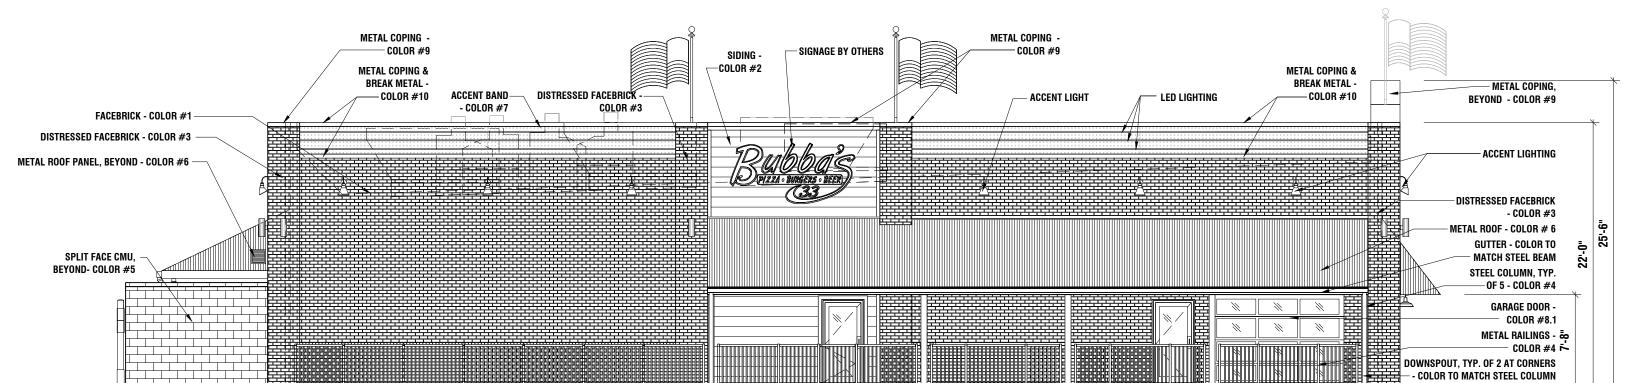

FRONT ELEVATION NORTHWEST

LEFT ELEVATION NORTHEAST

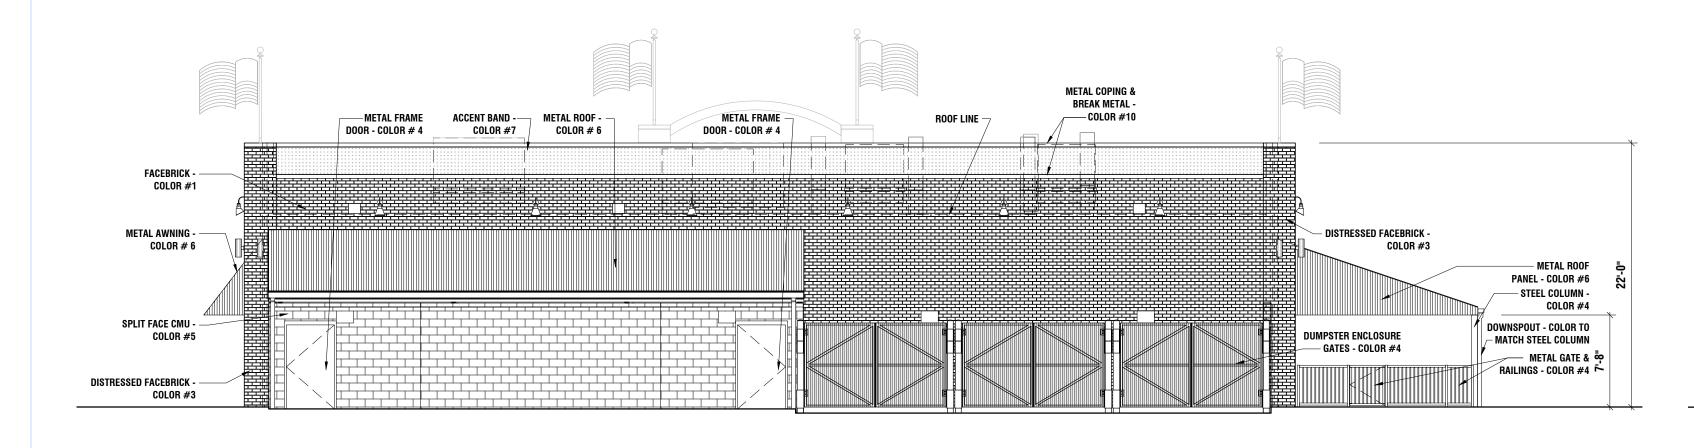

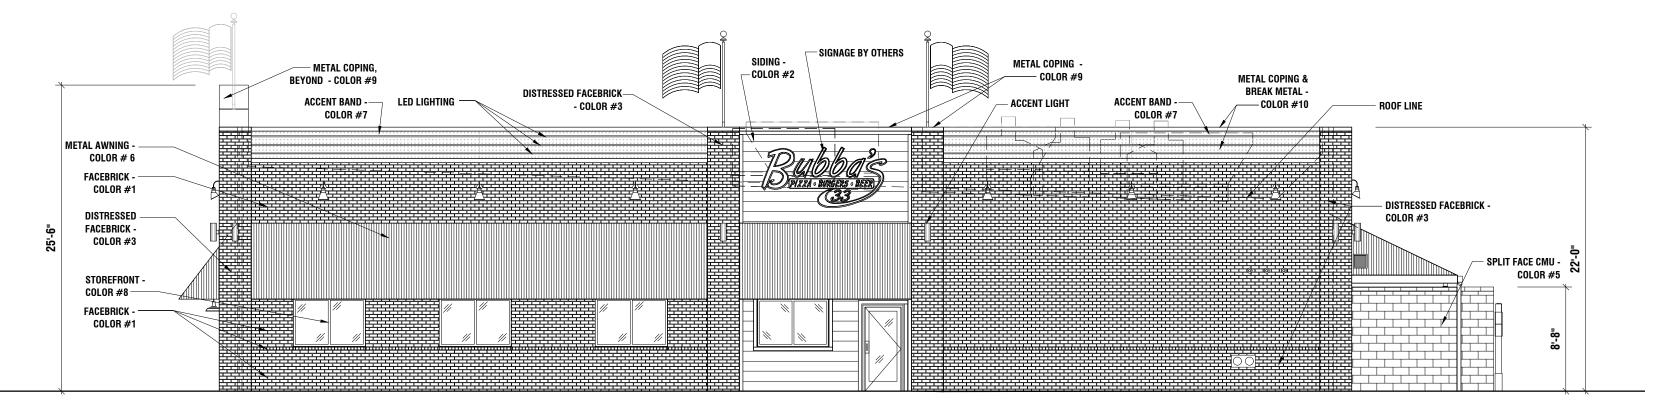

REAR ELEVATION SOUTHEAST

EXTERIOR FINISH SCHEDULE BUILDING ITEMS COLOR #1 **FACEBRICK** STATESVILLE OLDE JEFFERSON - "AUTHENTIC TUMBLED" COLOR #2 FIBER CEMENT SIDING SHERWIN-WILLIAMS: SW1770 "LESS WHITE INDIGO BATIK" DISTRESSED FACEBRICK STATESVILLE SHERWOOD FOREST - "AUTHENTIC TUMBLED" METAL DOORS, FRAMES, STEEL COLUMNS, COLOR #4 BEAMS, DUMPSTER GATES, & BOLLARDS | PORTER PAINTS: EXTERIOR; COLOR: BLACK **SPLIT FACE** CMU WALL SHERWIN-WILLIAMS: SW1770 "LESS WHITE INDIGO BATIK" METAL AWNING METAL SALES: CORRUGATED; COLOR: GALVALUME **ACCENT BAND** COLOR #7 DIAMOND PLATED METAL STOREFRONT COLOR #8 DARK BRONZE **GARAGE DOORS** COLOR #8.1 PRE-FINISHED BLACK METAL COPING COLOR #9 PRE-FINISHED WHITE **METAL COPING & BREAK METAL** COLOR #10 FLASHING PRE-FINISHED GALVALUME

THE COLORS DEPICTED ON THESE ELEVATIONS ARE FOR GRAPHIC REPRESENTATION PURPOSES ONLY. PLEASE REFER TO MATERIAL BOARD FOR ACTUAL SAMPLE OF COLORS AND TEXTURES

RIGHT ELEVATION SOUTHWEST


CLIENT



20180205.0

CITY OF ALBUQUERQUE

Planning Department Brennon Williams, Director

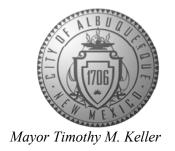

May 3, 2021

Michael E. Haas, P.E. GreenbergFarrow 21 South Evergreen Avenue - Suite 200 Arlington Heights, IL 60005

Bubba's 33 RE:

> 10000 Coors Bypass NW **Grading and Drainage Plan** Engineer's Stamp Date: 04/14/21 Hydrology File: B14D004H

Dear Mr. Haas:

Based upon the information provided in your resubmittal received 04/19/2021, the Grading & PO Box 1293 Drainage Plan is approved for Building Permit.

Please attach a copy of this approved plan in the construction sets for Building Permit processing along with a copy of this letter. Prior to approval in support of Permanent Release of Occupancy

by Hydrology, Engineer Certification per the DPM checklist will be required.

If the project total area of disturbance (including the staging area and any work within the NM 87103

adjacent Right-of-Way) is 1 acre or more, then an Erosion and Sediment Control (ESC) Plan and Owner's certified Notice of Intent (NOI) is required to be submitted to the Stormwater Quality

Engineer (Doug Hughes, PE, jhughes@cabq.gov, 924-3420) 14 days prior to any earth

disturbance.

Also, the Payment-in-Lieu of \$5,952.00 must be paid prior to Hydrology's Permanent Release of Occupancy approval. Due to COVID-19, please follow the instructions:


Please use the attached City of Albuquerque Treasury Deposit form and when ready please email this form to Shannon Cordero (sdcordero@cabq.gov). She will then produce and email back with a receipt and instructions on how to pay online. Once paid, please email me proof of payment. This will insure that Hydrology with be able to process Permanent Release of Occupancy approval when officially submitted.

Albuquerque

www.cabq.gov

CITY OF ALBUQUERQUE

Planning Department Brennon Williams, Director

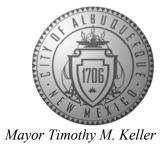

If you have any questions, please contact me at 924-3995 or rbrissette@cabq.gov .

Sincerely, Renée C. Brissette

Renée C. Brissette, P.E. CFM Senior Engineer, Hydrology Planning Department

PO Box 1293

Albuquerque

NM 87103

www.cabq.gov




Transmittals for: PROJECTS Only

Payment-in-Lieu for Storm Water Quality Volume Requirement

CASH COUNT	AMOUNT	ACCOUNT NUMBER	FUND NUMBER	BUSINESS UNIT	PROJECT ID	ACTIVITY ID	AMOUNT
TOTAL CHECKS	\$ 5,952.00	461615	305	PCDMD	24_MS4	7547210	\$ 5,952.00
TOTAL AMOUNT						TOTAL DEPOSIT	\$ 5,952.00

Hydrology#: _[_ Name:	Bubba's 33				
	Payment In-Lieu for Storm Water Quality /olume Requirement						
·	Todalio Modalio Monta						
Address/Legal Description:	10000 Coors Bypass NW						
DEPARTMENT NAME: Planning Department/Development Review Services, Hydrology							
PREPARED BY	PREPARED BY Renée C. Brissette, P.E. CFM PHONE 505-924-3995						
BUSINESS DATE May 3, 2021							
DUAL VERIFIC	CATION OF DEPOSIT Renée C. EMPLOYEE SIGNA		cetto				
AND BY EM	MPLOYEE SIGNATURE						
REMITTER:							
AMOUNT:							
BANK:							
CHECK #:	DATE ON CHECK:						

The Payment-in-Lieu can be paid at the Plaza del Sol Treasury, 600 2nd St. NW. **Bring three copies of this invoice to the Treasury** and provide a copy of the receipt to Hydrology, Suite 201, 600 2nd St. NW, or e-mail with the Hydrology submittal to PLNDRS@cabq.gov.

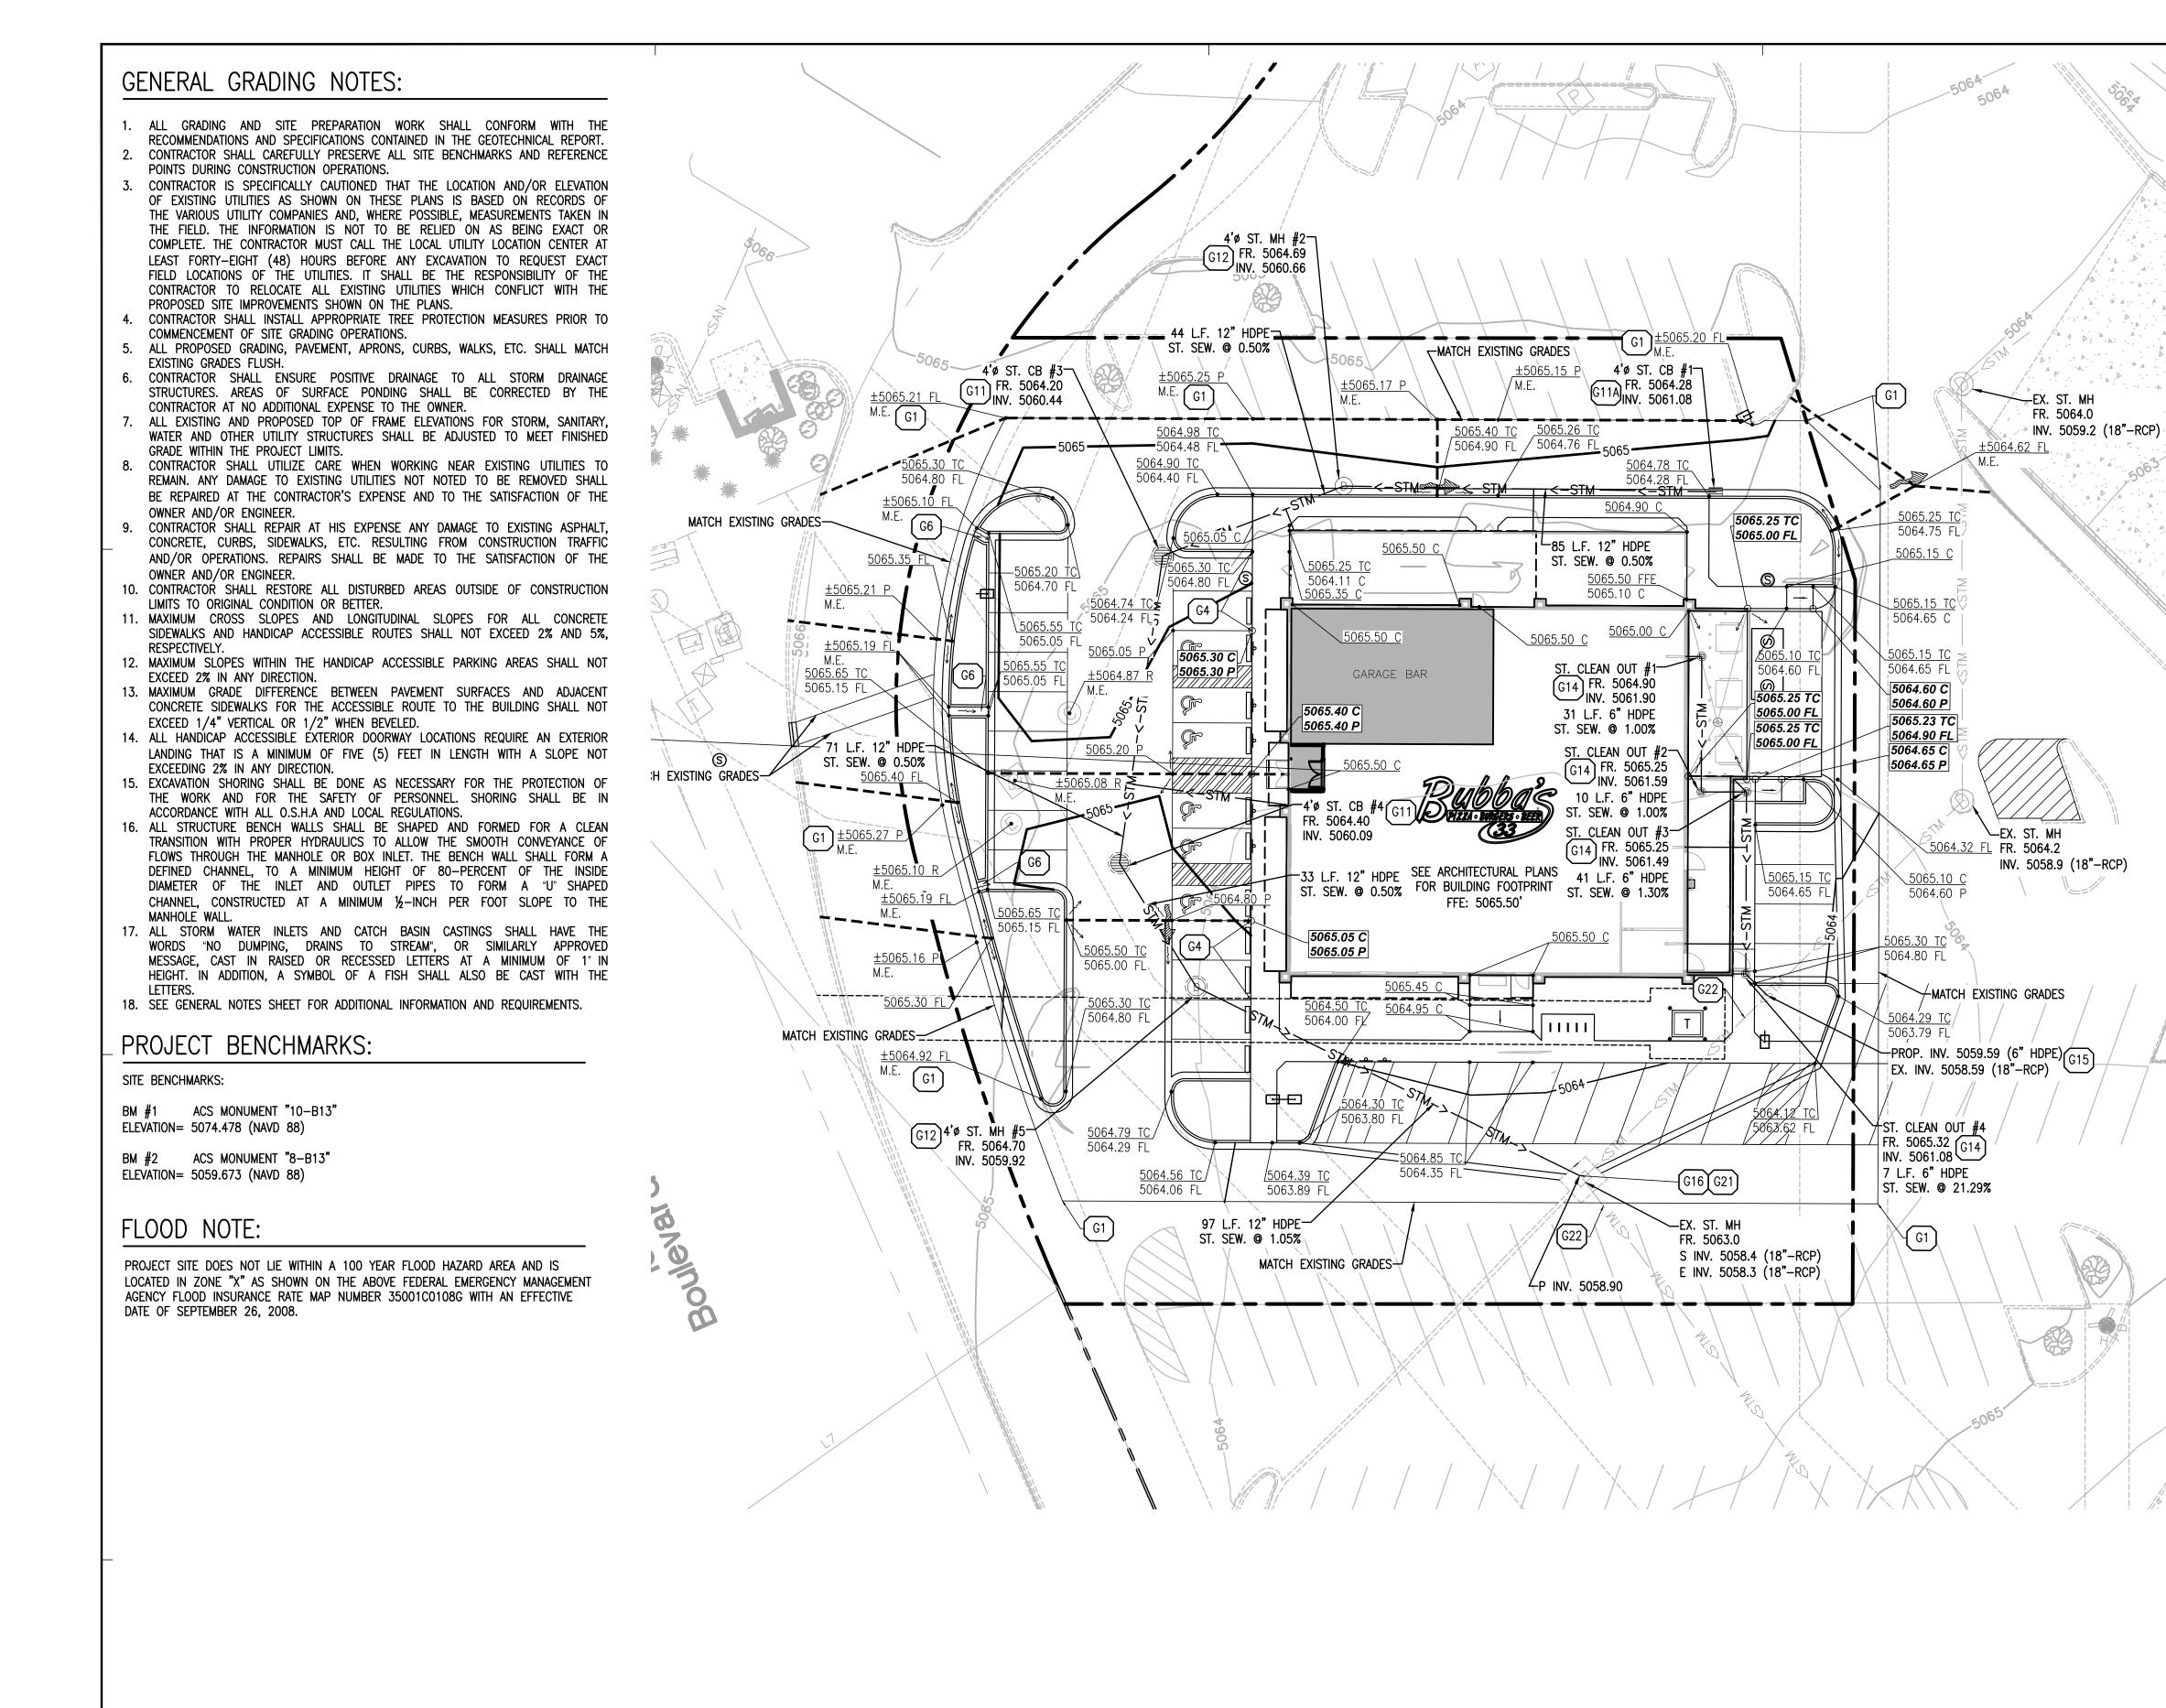



- - PROPERTY LINE

PROPOSED CONCRETE CURB AND GUTTER

PROPOSED DEPRESSED CONCRETE CURB AND GUTTER

PROPOSED REVERSE PITCH CONCRETE CURB AND GUTTER

PROPOSED CONTOUR

PROPOSED SPOT ELEVATION

FFE: FINISHED FLOOR ELEVATION

TC: TOP OF CURB ELEVATION FL: CURB FLOWLINE ELEVATION C: TOP OF CONCRETE ELEVATION P: TOP OF PAVEMENT ELEVATION

FG: FINISHED GRADE ELEVATION ME: MATCH EXISTING ELEVATION

PROPOSED SPOT ELEVATION EXPOSED CURB FACE VARIES

SITE BENCH MARK (SEE SURVEY FOR ADDITIONAL INFORMATION)

PROPOSED GRADING RIDGE LINE

PROPOSED DRAINAGE FLOW DIRECTION

PROPOSED OVERLAND FLOOD ROUTE

PROPOSED STORM SEWER STRUCTURE WITH OPEN GRATE

PROPOSED STORM SEWER STRUCTURE WITH CLOSED LID

PROPOSED STORM SEWER CLEAN OUT

PROPOSED HEAVY DUTY AREA DRAIN

PROPOSED STORM SEWER

GRADING & DRAINAGE KEY NOTES:

- G1 FIELD VERIFY AND MATCH EXISTING ELEVATION AT PROJECT SCOPE OF WORK
- LIMITS (TYP.)
- G4 CURB TRANSITION FOR 0" TO 6" IN HEIGHT G6 PROPOSED 2' WIDE CURB OPENING FOR DRAINAGE
- G11 PROPOSED 4'Ø PRECAST CONCRETE CATCH BASIN WITH NEENAH R-2502-D
- FRAME AND GRATE AND CONCRETE COLLAR PER CATCH BASIN DETAIL G11A PROPOSED 4'Ø PRECAST CONCRETE CATCH BASIN WITH NEENAH R-3065-A
- CURB BOX G12 PROPOSED 4'Ø PRECAST CONCRETE MANHOLE WITH NEENAH R-1772 FRAME
- and Lid G13 PROPOSED BUILDING ROOF DRAIN CONNECTION (COORDINATE EXACT LOCATIONS AND PIPE SIZES WITH ARCHITECTURAL AND PLUMBING PLANS).
- CONTRACTOR SHALL INSTALL NEW WYE FITTING AT PROPOSED STORM SEWER CONNECTION POINTS G14 PROPOSED STORM SEWER CLEAN OUT
- G15 CORE DRILL AND CONNECT PROPOSED 6" STORM SEWER LINE TO EXISTING STORM SEWER LINE WITH AN INSERTA TEE AND RISER SECTION (CONTRACTOR SHALL VERIFY EXISTING INVERT ELEVATION PRIOR TO STORM SEWER
- INSTALLATION) G16 CORE DRILL AND CONNECT PROPOSED STORM SEWER LINE TO EXISTING
- STORM SEWER STRUCTURE PER LOCAL CODES (CONTRACTOR TO FIELD VERIFY ELEVATION OF EXISTING INVERTS PRIOR TO CONSTRUCTION.) G21 EXISTING STORM SEWER STRUCTURE TO REMAIN
- G22 EXISTING STORM SEWER LINE TO REMAIN

Planning Department Development Review Services

HYDROLOGY SECTION

HydroTrans# B14D004H

APPROVED 05/03/21

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21 South Evergreen Avenue

Arlington Heights, IL 60005

PROJECT TEAM

t: 847 788 9200 f: 847 788 9537

ISSUE/REVISION RECORD

DESCRIPTION 02/26/21 COORDINATION SET

03/19/21 PERMIT SET

04/09/21 SITE PLAN 04/14/21 PERMIT RESPONSE

Proj. 20182050

Mh Hoose

expires 12/31/22 date 4/14/21

PROFESSIONAL IN CHARGE **MICHAEL HAAS**

PROFESSIONAL ENGINEER LICENSE NO. 26056

PROJECT MANAGER EDWARD GOSS

QUALITY CONTROL EDWARD GOSS **DRAWN BY**

MITCH HEFFERNAN PROJECT NAME

TEXAS

ROADHOUSE

ALBUQUERQUE NEW MEXICO

10000 COORS BYPASS NW ALBUQUERQUE, NM 87114




PROJECT NUMBER 20182050 0

SHEET TITLE

GRADING AND DRAINAGE PLAN

SHEET NUMBER

GRAPHIC SCALE (IN FEET) 1 inch = 20 ft.

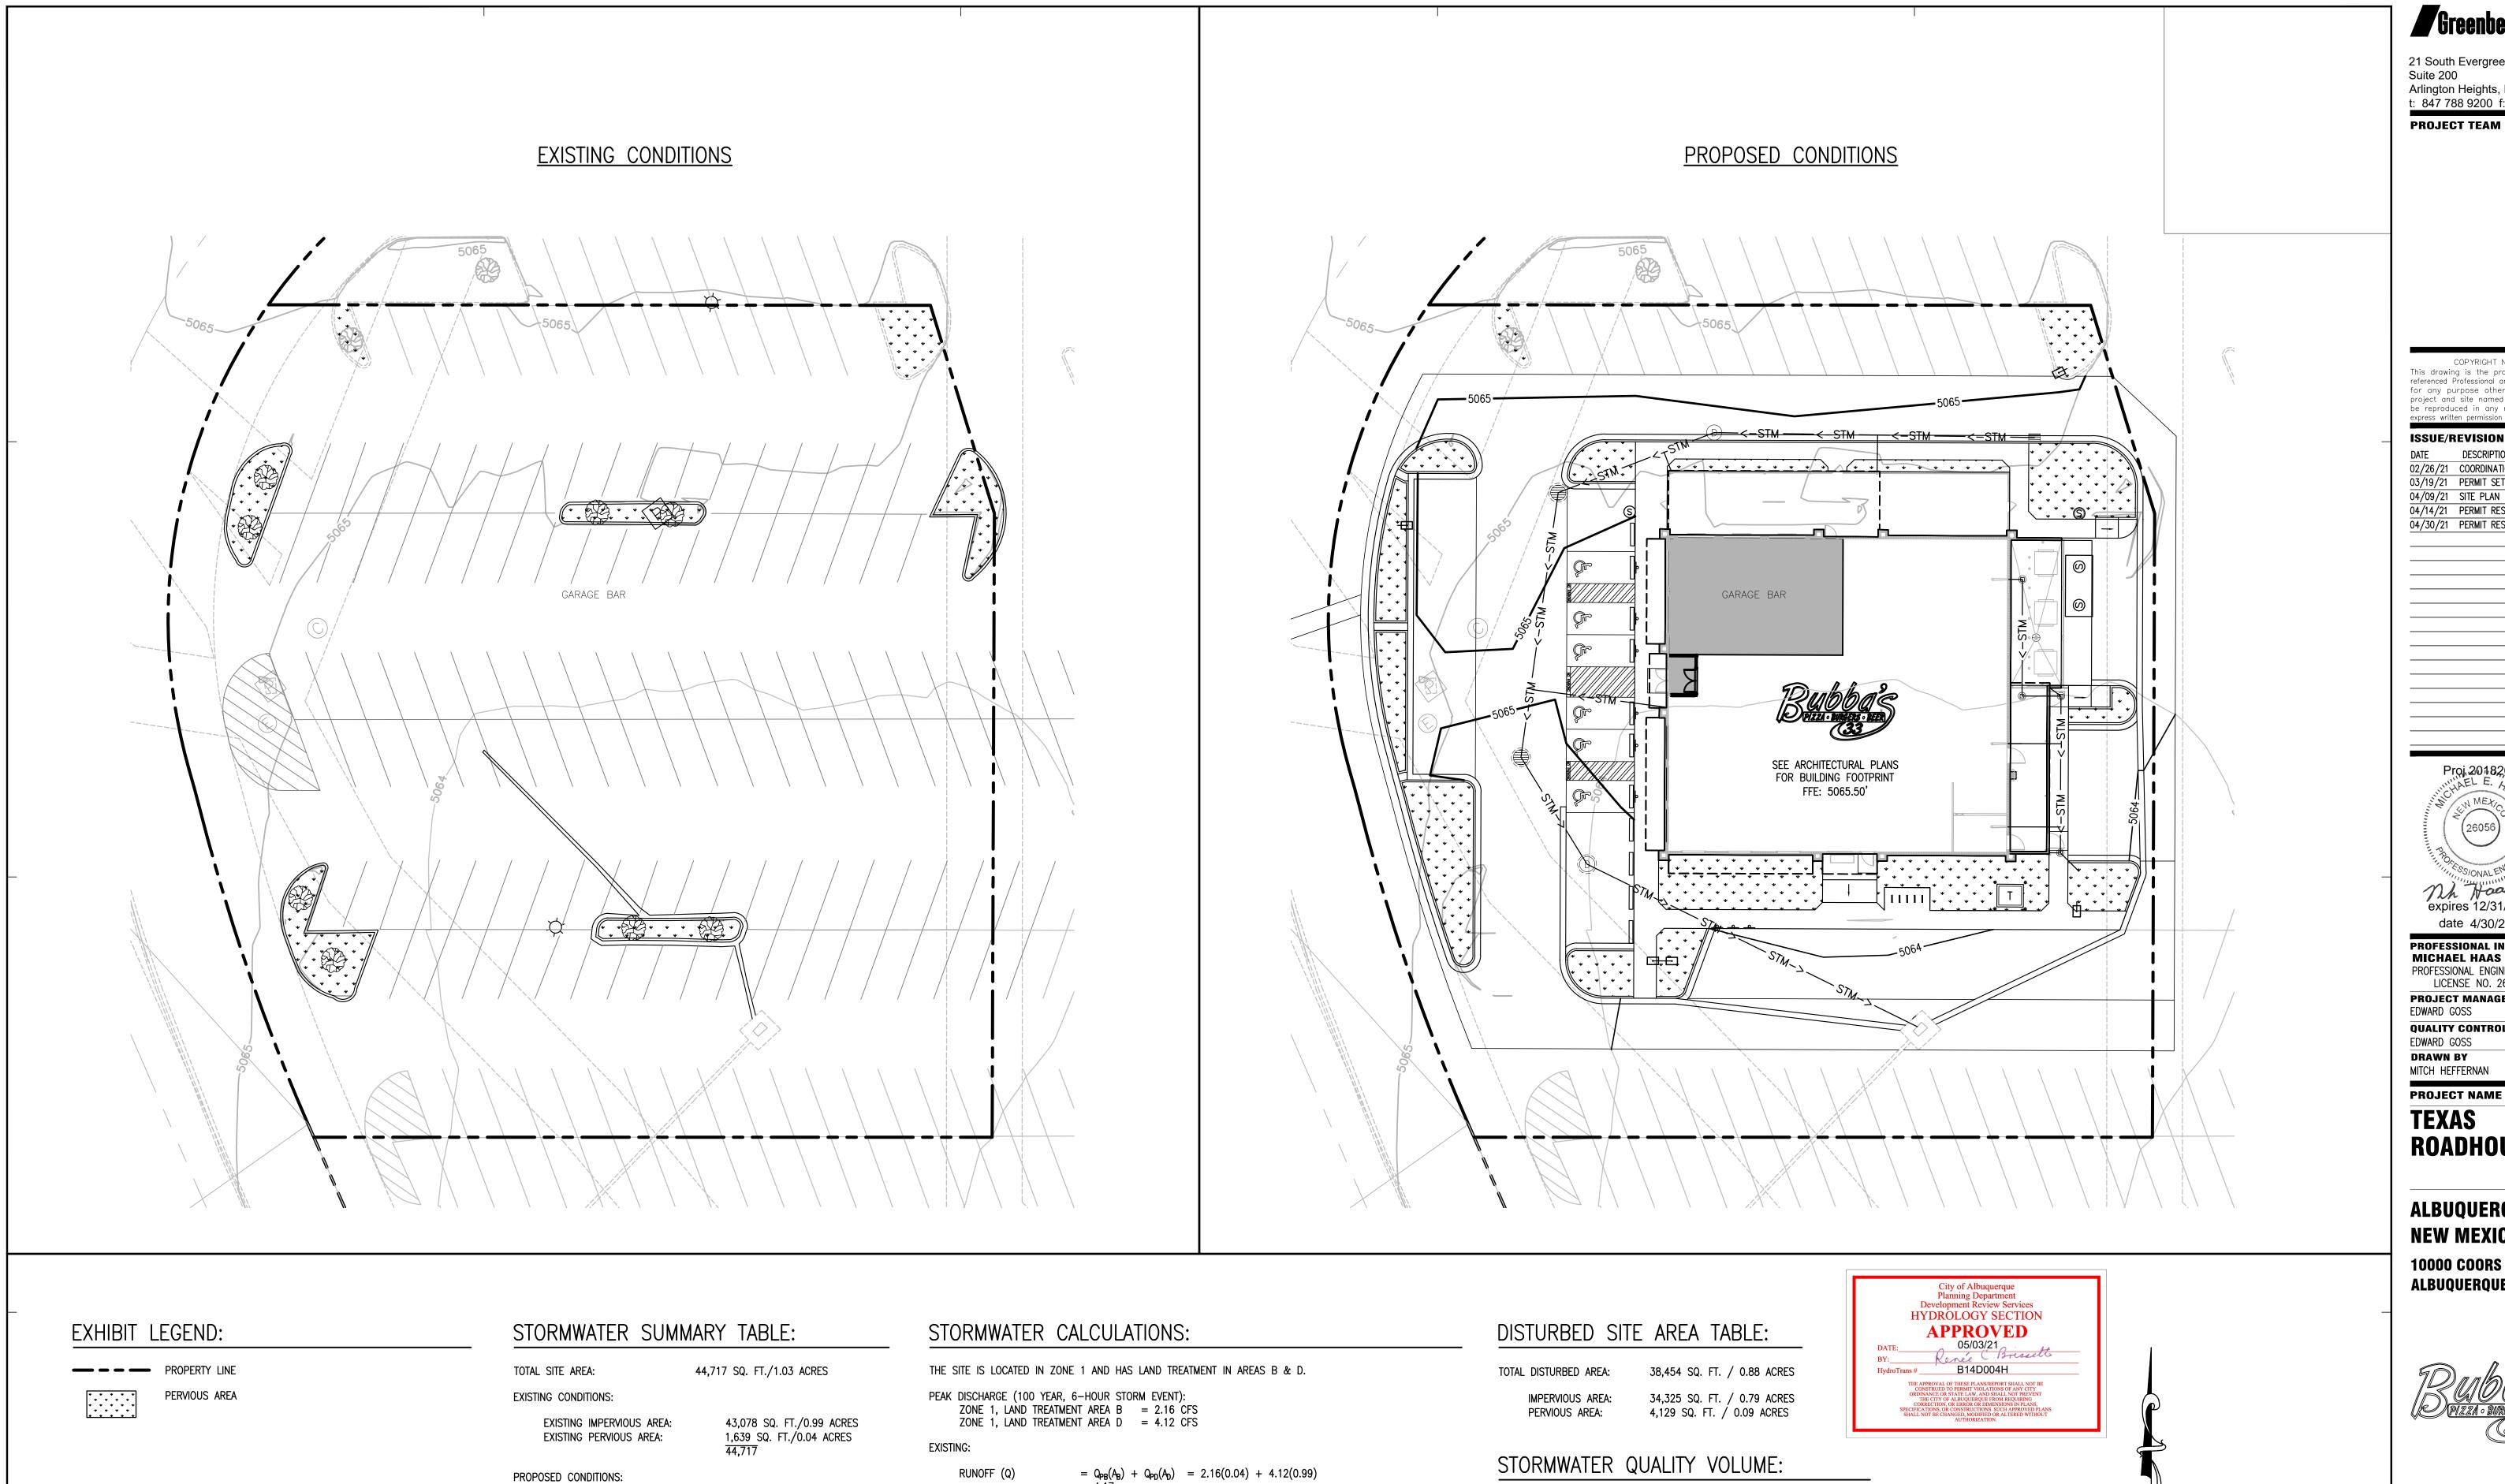

 $= Q_{PB}(A_B) + Q_{PD}(A_D) = 2.16(0.10) + 4.12(0.93)$

STORMWATER DESIGN IS BASED ON ARTICLE 6-2(A) FROM THE THE CITY OF ALBUQUERQUE DEVELOPMENT

STORMWATER QUALITY VOLUME

THE PAYMENT-IN-LIEU WILL BE \$5,952.

= 0.26*(NEW IMPERVIOUS AREA)*(1/12)

= 0.26'*34,325*(1/12)

= 744 CF

= \$8/CF*744

= \$5,952

THE OWNER HAS ELECTED TO PAY FOR THE STORMWATER QUALITY VOLUME.

SWQ VOLUME PAYMENT CALCULATION = \$8/CF*(SWQ VOLUME)

40,482 SQ. FT./0.93 ACRES

4,235 SQ. FT./0.10 ACRES 44,717

PROPOSED:

RUNOFF (Q)

PROCESS MANUAL.

THE RUNOFF IS DECREASED IN THE PROPOSED CONDITIONS.

PROPOSED IMPERVIOUS AREA:

PROPOSED PERVIOUS AREA:

GreenbergFarrow

21 South Evergreen Avenue Suite 200 Arlington Heights, IL 60005 t: 847 788 9200 f: 847 788 9537

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ISSUE/REVISION RECORD

DATE DESCRIPTION 02/26/21 COORDINATION SET 03/19/21 PERMIT SET

04/09/21 SITE PLAN 04/14/21 PERMIT RESPONSE 04/30/21 PERMIT RESPONSE

Mass expires 12/31/22

date 4/30/21

PROFESSIONAL IN CHARGE MICHAEL HAAS PROFESSIONAL ENGINEER

LICENSE NO. 26056 PROJECT MANAGER EDWARD GOSS **QUALITY CONTROL**

EDWARD GOSS **DRAWN BY** MITCH HEFFERNAN

PROJECT NAME

ROADHOUSE

ALBUQUERQUE NEW MEXICO

10000 COORS BYPASS NW ALBUQUERQUE, NM 87114



PROJECT NUMBER 20182050.0

SHEET TITLE PRE/POST

GRAPHIC SCALE

(IN FEET) 1 inch = 20 ft. **LAND USE COMPARISON**