

fbt architects

6501 Americas Pkwy NE., Ste. 300 Albuquerque, NM 87110 P 505.883.5200 WEB: www.fbtarch.com

CONSULTANTS

Cottonwood Classical Preparatory School -Portable Addition

7801 Jefferson St NE, Albuquerque, NM 87109


DESCRIPTION

06/04/21 ADDENDUM#1

MAY 2021


SITE PLAN FOR ADMINISTRATIVE AMENDMENT

AA-1

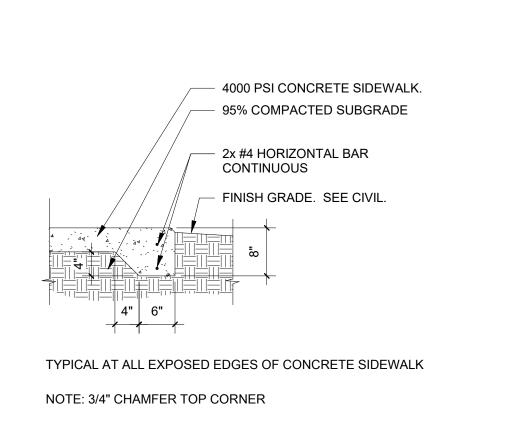

8 IN CONCRETE TURNDOWN EDGE

8 1 CONCRETE TURNDOWN EDGE

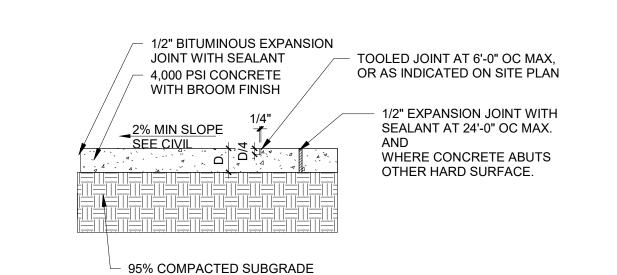


NOTES: 1. SEE GEOTECHNICAL REPORT FOR ADDITIONAL REQUIREMENTS AND

E2 CONCRETE PAVEMENT

- INFORMATION. 2. SEE SITE PLAN FOR FOR CONCRETE JOINT PATTERN.
- 3. VERIFY SIDEWALK LAYOUT WITH ARCHITECT PRIOR TO FORMING AND POURING CONCRETE. NO EXCEPTIONS. 4. HEAVY DUTY CONCRETE SHALL BE 6" THICK WITH 6X6X10 GA. WELDED WIRE
- FABRIC IN CENTER OF SLAB. 5. STANDARD DUTY CONCRETE SHALL BE 4" THICK. 6. TURN DOWN EDGE AT ALL EXPOSED EDGES OF CONCRETE PAVEMENT. SEE DETAIL E1 THIS SHEET.

6' - 0" 6' - 0" 6' - 0" DETECTABLE WARNING FINISH AT CONCRETE ACCESSIBLE RAMP. └ HEADER CÜRB. SEE CIVIL ACCESSIBLE RAMP CONCRETE SIDEWALK OR PAVING -

E3 CONCRETE CURB RAMP

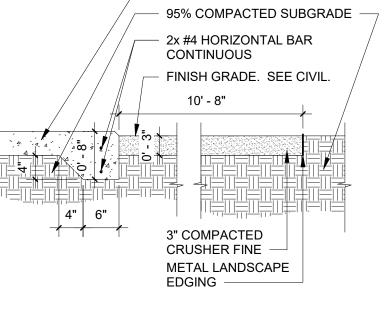


NOTE: CONTRACTOR SHALL INSTALL A 3" DEPTH OF 'MOUNTAINAIR BROWN' CRUSHER FINES AS AVAILABLE FROM JPR GRAVEL (505-877-4913). INSTALL CRUSHER FINES OVER FILTER FABRIC, MIN. 3 OZ/SY NONWOVEN NEEDLE PUNCHED POLYPROPLYENE (MIRAFI MSCAPE OR EQUIVALENT). OVERLAP FABRIC ENDS 3", TURN DOWN EDGES 6". TOP OF CRUSHER FINES SHALL BE 1" BELOW TOP OF ADJACENT PAVING. PROVIDE SAMPLE OF CRUSHER FINES FOR REVIEW AND APPROVAL PRIOR TO INSTALLATION.

4000 PSI CONCRETE SIDEWALK.


NOTE: 3/4" CHAMFER TOP CORNER


2x2x 1/4" STL TUBE, TYP.

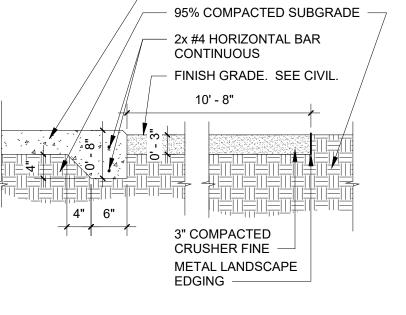

CRUSHER FINE PATH

3/4" = 1'-0"

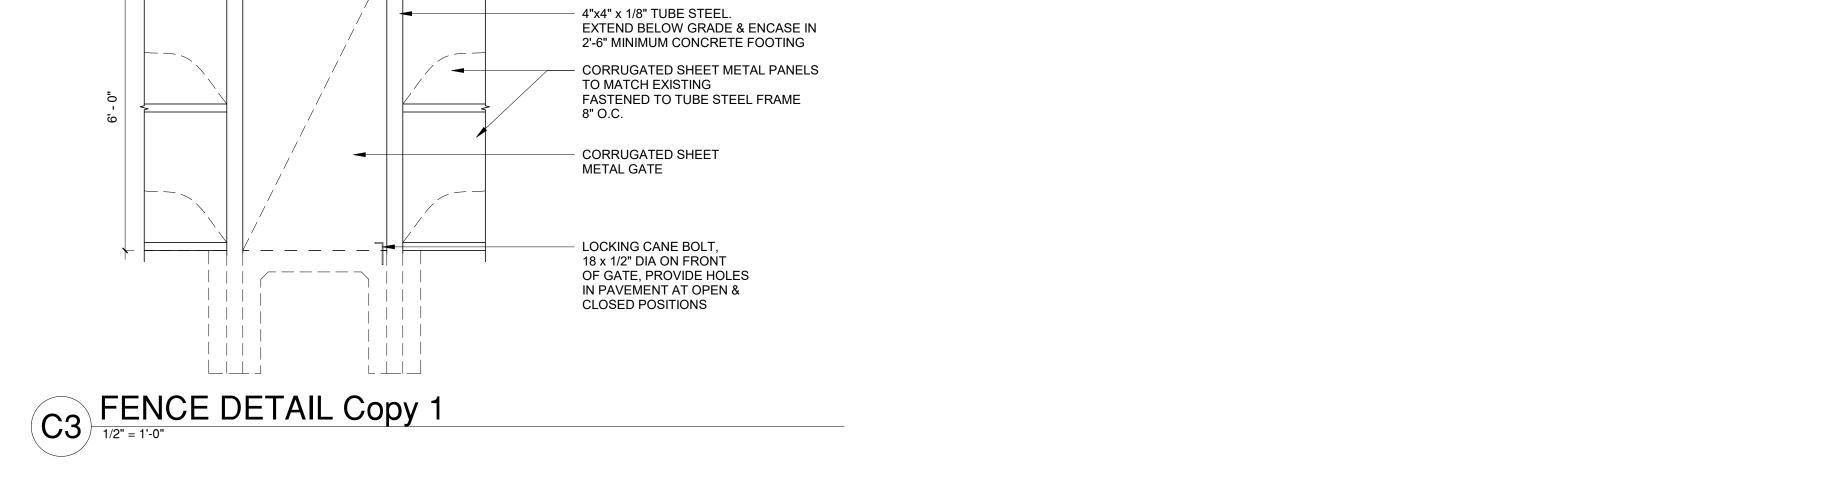

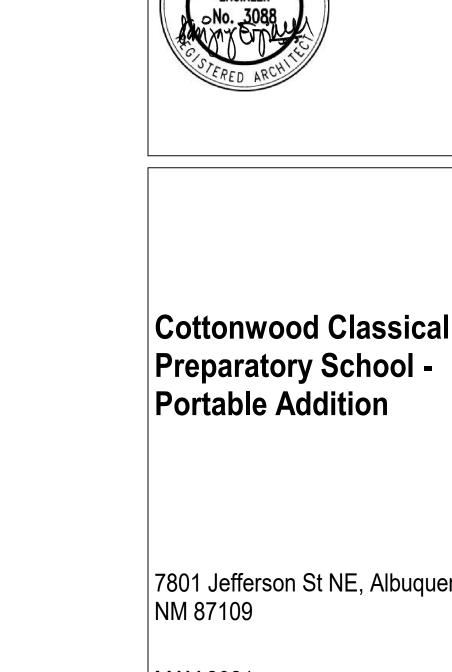

7801 Jefferson St NE, Albuquerque,

fbt architects

P 505.883.5200 WEB: www.fbtarch.com

6501 Americas Pkwy NE., Ste. 300

Albuquerque, NM 87110

CONSULTANTS

GENERAL NOTES

A. SUB GRADE PREPERATION AND SOIL COMPACTION AT ALL CONCRETE WORK SHALL COMPLY WITH REQUIREMENTS NOTED ON CIVIL DRAWINGS AND

E. FURNISH AND INSTALL SELF LEVELING SEALANT AT ALL CONCRETE EXPANSION

B. PROVIDE BROOM FINISH ON CONCRETE SIDEWALKS AND MOW STRIPS

GEOTECHNICAL REPORT

D. PAINT ALL EXPOSED STEEL.

C. VERIFY SIDEWALK LAYOUT WITH

MAY 2021


MARK DATE DESCRIPTION


ISSUE:	
DATE:	MAY 2021
PROJECT NO:	00000
DRAWN BY:	Author
CHECKED BY:	Checker


SHEET TITLE


SITE DETAILS

AS-102

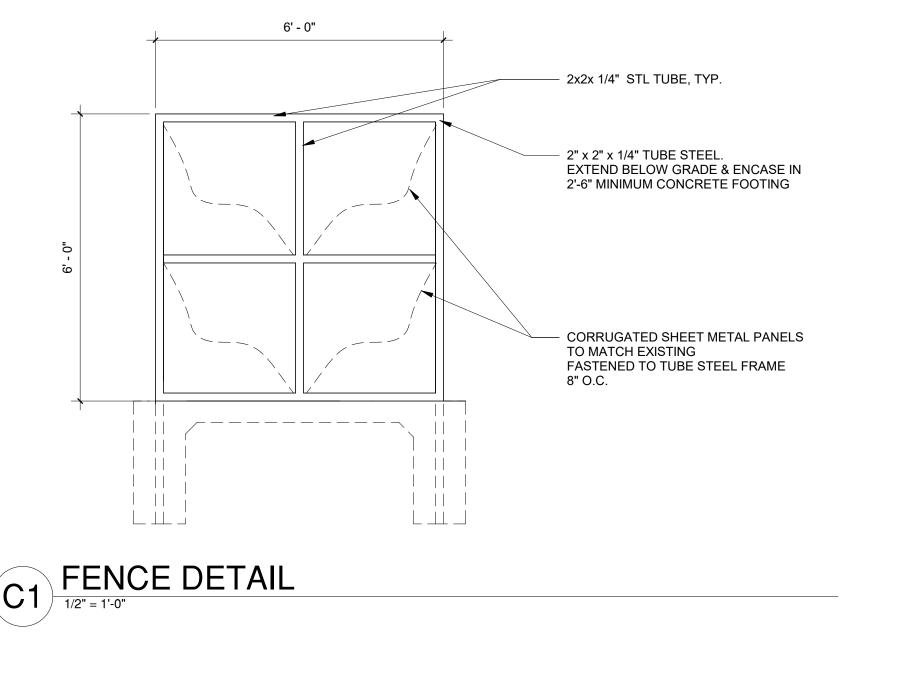

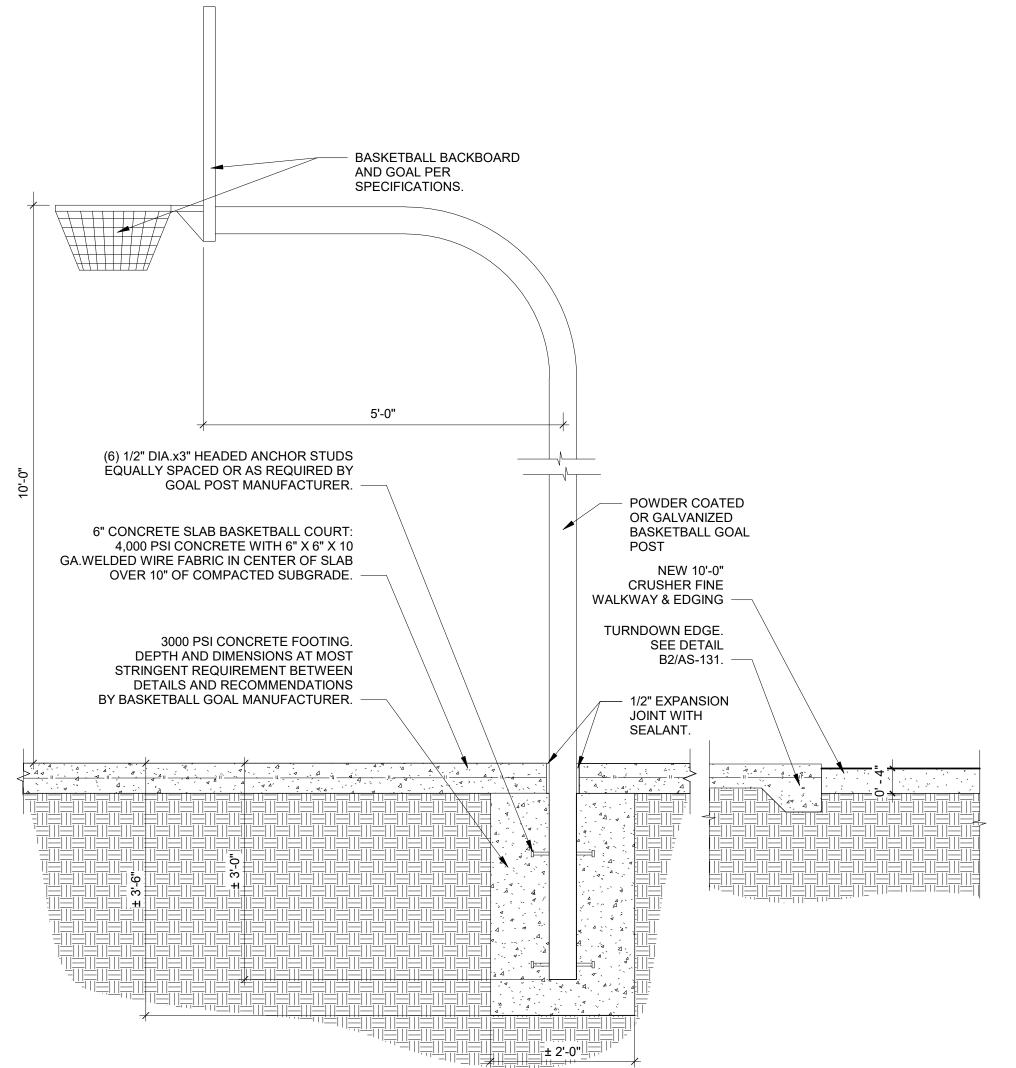

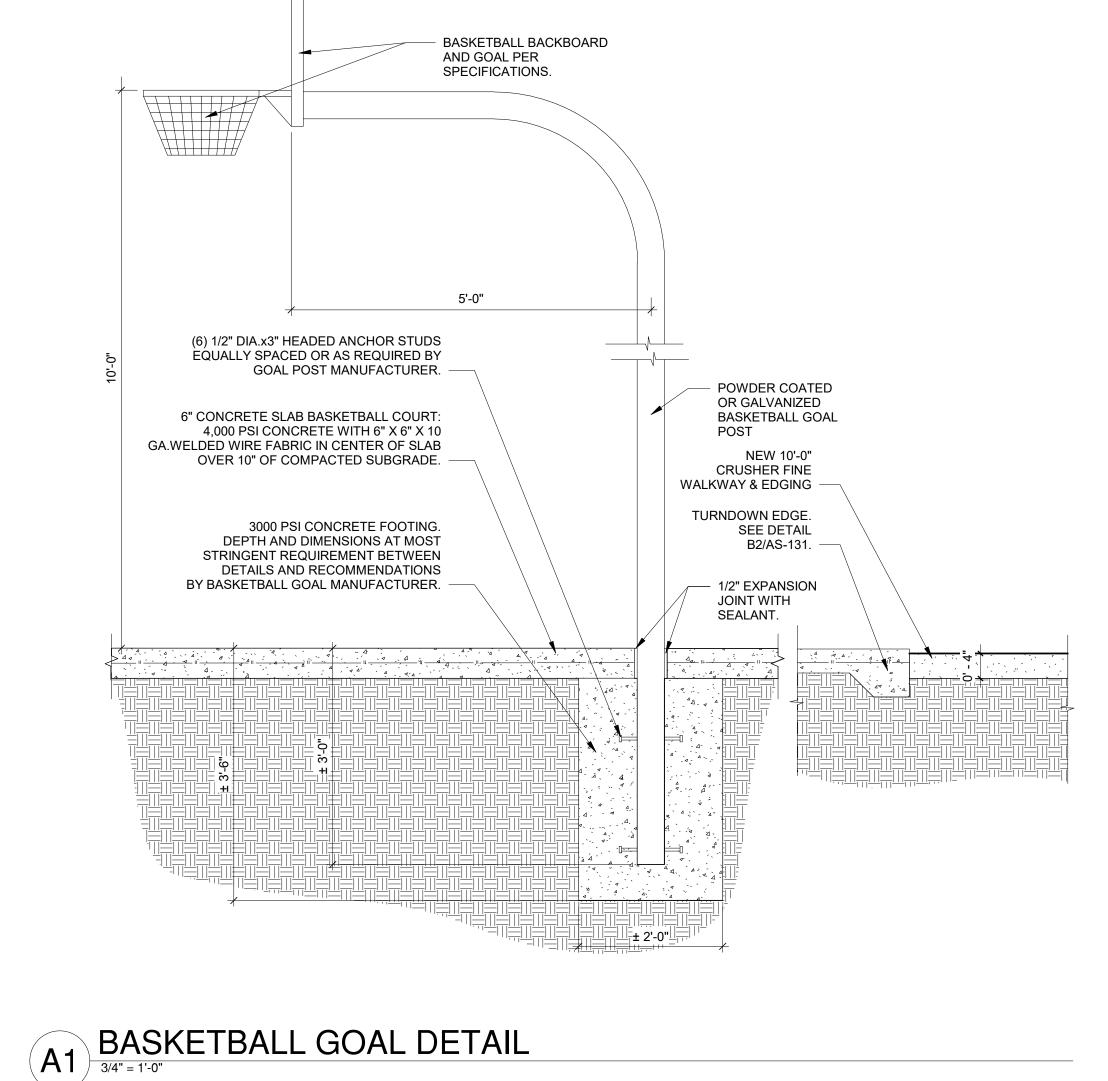

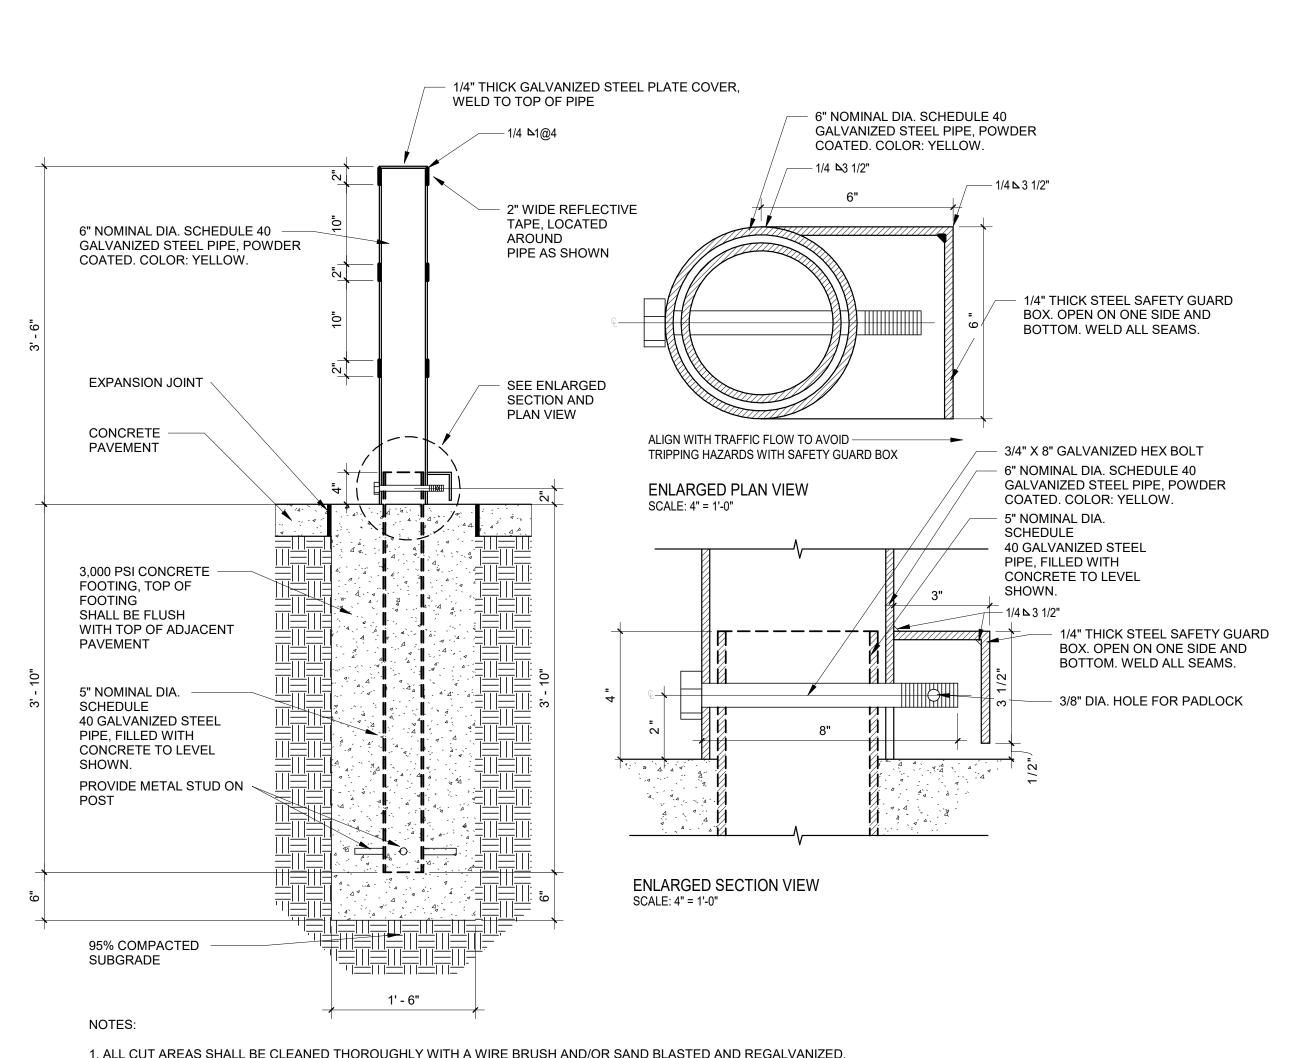

1. ALL CUT AREAS SHALL BE CLEANED THOROUGHLY WITH A WIRE BRUSH AND/OR SAND BLASTED AND REGALVANIZED. REGALVANIZING SHALL BE WITH SHERWIN WILLIAMS ZINC CLAD 7 PRIMER OR EQUAL.

A3 REMOVABLE BOLLARD

2. ALL METAL SHALL BE POWDER COATED, COLOR: YELLOW.

CITY OF ALBUQUERQUE

Planning Department
Brennon Williams, Director



Mayor Timothy M. Keller

July 15, 2021

Jeremy Trumble 6501 Americas Pkwy NE, Ste 300 Albuquerque, NM 87110

Re: Cottonwood Classical – Portable Addition 7801 Jefferson St NE Traffic Circulation Layout Architect's Stamp 05-19-2021 (D17-D003A)

Dear Mr. Trumble,

The TCL submittal received 07-14-2021 is approved for Building Permit with. A copy of the stamped and signed plan will be needed for each of the building permit plans. Please keep the original to be used for certification of the site for final C.O. for Transportation.

When the site construction is completed and an inspection for Certificate of Occupancy (C.O.) is requested, use the original City stamped approved TCL for certification. Redline any minor changes and adjustments that were made in the field. A NM registered architect or engineer must stamp, sign, and date the certification TCL along with indicating that the development was built in "substantial compliance" with the TCL. Submit this certification, the TCL, and a completed <u>Drainage and Transportation Information Sheet</u> to front counter personnel for log in and evaluation by Transportation.

Albuquerque

PO Box 1293

Once verification of certification is completed and approved, notification will be made to Building Safety to issue Final C.O. To confirm that a final C.O. has been issued, call Building Safety at 924-3690.

NM 87103

www.cabq.gov

Sincerely

Nilo Salgado-Fernandez, P.E.

Senior Traffic Engineer, Planning Dept.

Development Review Services

C: CO Clerk, File

Page 1 of 1



