

LEGAL DESCRIPTION:

TRACT 27-A-1 AND 27-A-2 OF TAYLOR RANCH, REDMISION OF TRACT 27A INTO TRACTS 27-A-1 AND 27-A-2 OF THE PLAT OF TRACTS 27-A, S-1, S-2, AND S-3 TAYLOR RANCH, SITUATED WITHIN SECTIONS 23, 25 AND 26 T11N R2E, BLOCK 0000

LEGEND

CURB & GUTTER
BOUNDARY LINE
EASEMENT
CENTERLINE
RIGHT-OF-WAY
BUILDING
SIDEWALK
SCREEN WALL
RETAINING WALL
STREET LIGHTS
LANE
STRIPING
EXISTING CURB & GUTTER
EXISTING BOUNDARY LINE
EXISTING SIDEWALK
EXISTING LANE
EXISTING STRIPING

PROJECT NUMBER: __2020-003461

DRB Chairperson, Planning Department

APPLICATION NUMBER: _

This plan is consistent with the specific Site Development Plan approved by the Environmental Planning Commission (EPC), dated ______, and the Findings and Conditions in the Official Notification of Decision are satisfied.

Is an Infrastructure List required? () Yes () No If Yes, then a set of approved DRC plans with a work order is required for any construction within Public Right—of—Way or for construction of public improvements.

DRB SITE DEVELOPMENT PLAN SIGNOFF APPROVAL:

Jeanne Wolfenbarger	Sep 24, 2020
Traffic Engineer, Transportation Division	Date
Wristonber Cadena (Sep. 25, 2020 15:00 MDT)	Sep 25, 2020
Water Utility Development	Date
Chery Americal (Sep 23, 2020 22:47 MDT)	Sep 23, 2020
Parks & Recreation Department	Date
Ernet any	Sep 24, 2020
City Engineer	Date
* Environmental Health Department (condition	nal) Date
Herman Gallegos (Sep 25, 20% 09:30 MDT)	Sep 25, 2020
Solid Waste Management	Date
Throbas.	Oct 9, 2020

* Environmental Health, if necessary

all Garcia

Carl Garcia (Sep 14, 2020 08:41 MDT)


Code Enforcement


Sep 24, 2020

Date

Date

ENGINEER'S SEAL	SARANAM AT	DRAWN BY BF
OR. BOHAND ON MEXICO Z	4701 MONTANO RD NW	DATE 7 /28 /2020
12 MET 3		7/28/2020
((7868))	SITE PLAN	2019080_SPE
PROPERTY OF THE PROPERTY OF TH		SHEET #
6.121/2-	TIERRA WEST, LLC 5571 MIDWAY PARK PLACE NE	C1
7/28/2020	ALBUQUERQUE, NM 87109	
RONALD R. BOHANNAN P.E. #7868	(505) 858-3100 www.tierrawestllc.com	JOB # 2019080

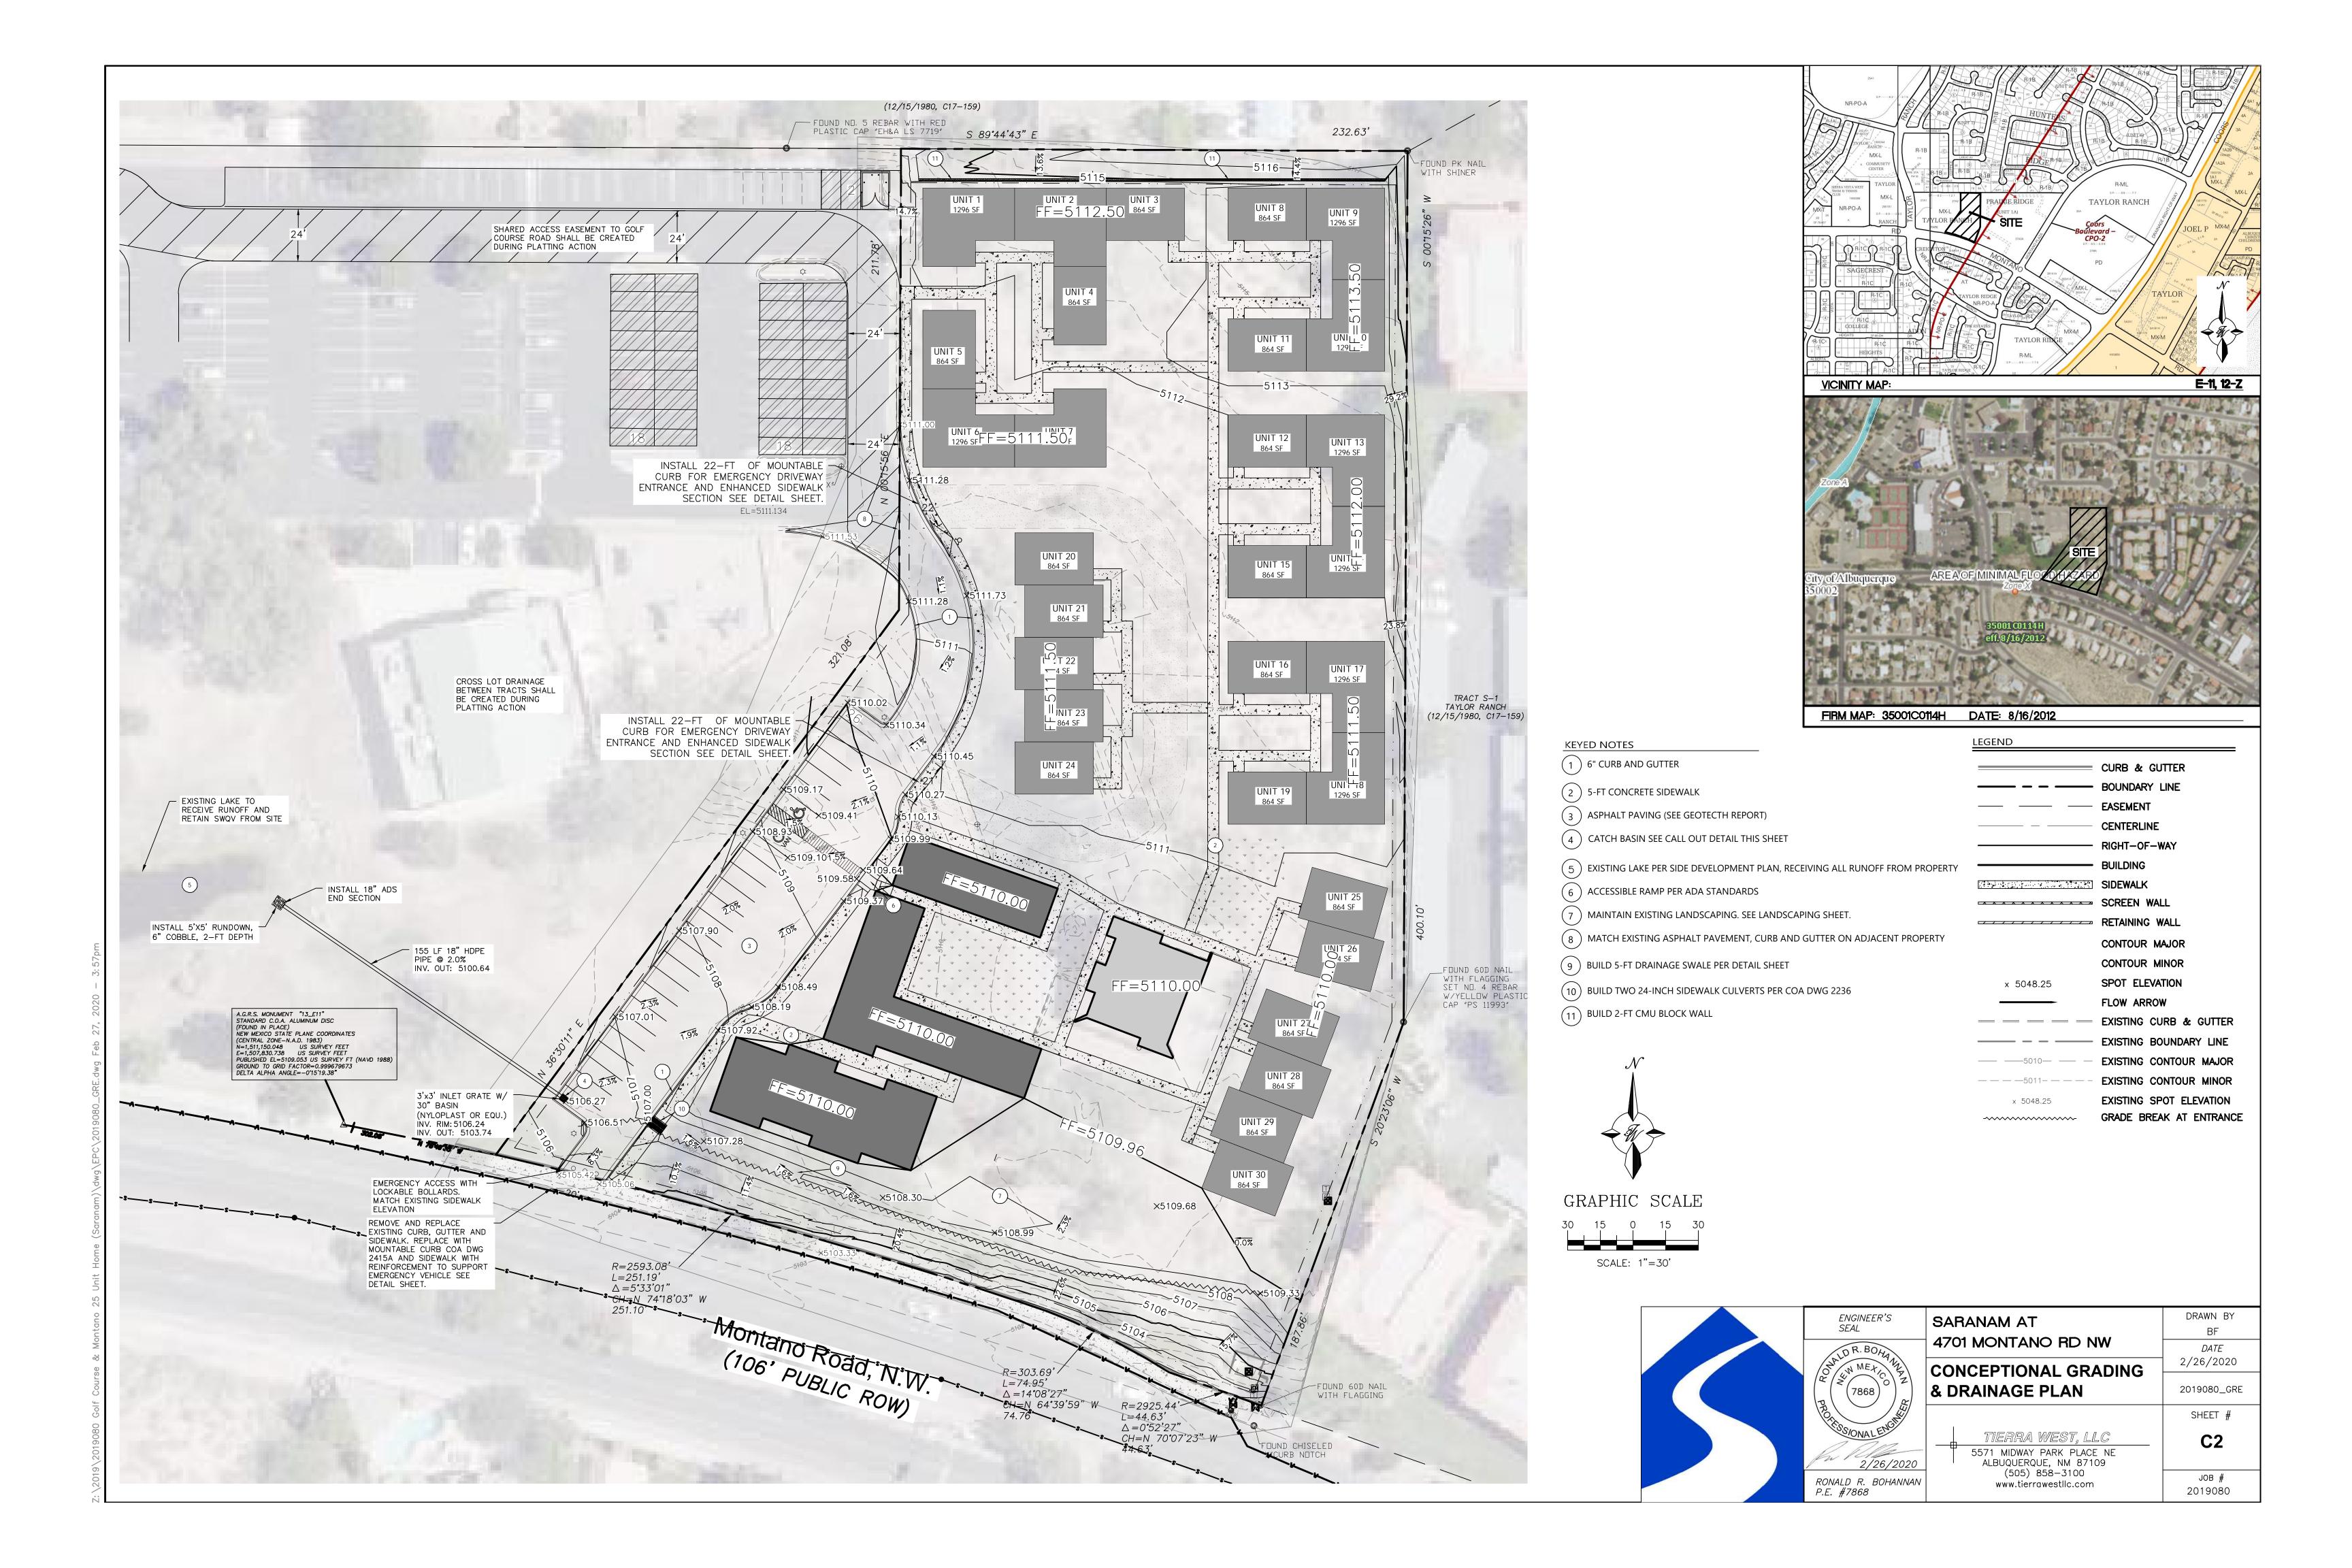

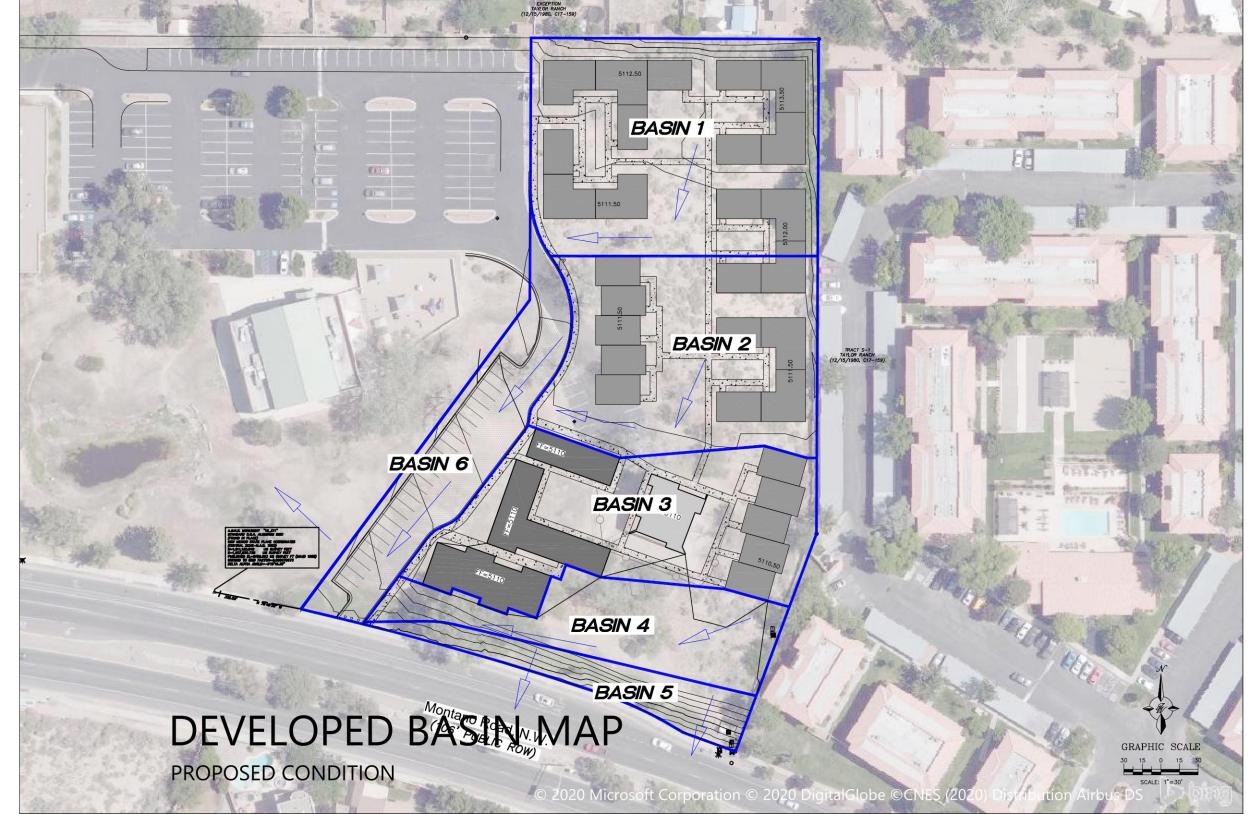

INTRODUCTION & REFERENCE FILES FILE #: E11D013

THE SITE IS LOCATED ON THE NORTH EAST CORNER OF MONTANO RD NW AND TAYLOR RANCH RD NW. THE PROPERTY WILL BE SUBDIVIDED TO CREATE THE NEW TRACT TO SUPPORT THE 32 UNIT RESIDENTIAL COMMUNITY HOUSING DEVELOPMENT. THE PURPOSE OF THIS SUBMITTAL IS TO PROVIDE A CONCEPTUAL GRADING AND DRAINAGE MANAGEMENT PLAN. THE ENTIRE PARCEL CURRENTLY DRAINS TO AN EXISTING LAKE IN THE SOUTH WEST CORNER. THE SITE IS NOT WELL DOCUMENTED WITH ANY SPECIFIC HYDROLOGY REPORTS ON RECORD DETAILING THE DRAINAGE FOR THE SITE AND THEREFORE AT TIME OF BUILDING PERMIT SUBMITTAL AN OVERALL MASTERPLAN DRAINAGE SHALL BE COMPLETED TO VERIFY THE LAKE HAS ADEQUATE CAPACITY TO RECEIVE THE DEVELOPED FLOWS. THE LAKE IS ALSO PROPOSED TO BE USED TO MEET THE FIRST FLUSH RETENTION VOLUME FOR THE NEW DEVELOPMENT.

FLOOD PLAIN

THE PROJECT AREA IS INCLUDED ON FEDERAL EMERGENCY MANAGEMENT AGENCY (FEMA) FLOOD INSURANCE RATE MAP (FIRM) PANEL 35001C0114H DATED AUGUST 16, 2012 AND IS SHOWN ON THIS PAGE. THE MAP INDICATES THE SITE LIES WITHIN FLOOD ZONE X, AN AREA OF MINIMAL FLOOD HAZARD.

HISTORIC DRAINAGE:

THERE IS NO OFFSITE FLOWS INTO THE PARCEL. THE HISTORIC DRAINAGE RUNOFF IS RETAINED ONSITE WITH THE PARCEL DRAINING TO THE EXISTING LAKE AT THE SOUTHWEST CORNER. IT APPEARS FROM A CURSORY REVIEW OF THE AVAILABLE DOCUMENTS THE LAKE WAS SIZED TO ACCOMMODATE THE ENTIRE PARCEL IN A DEVELOPED STATE, AS DETAILED ON THE SITE DEVELOPMENT PLAN. THE LAKE IS AT LEAST 6 FEET DEEP AND THERE IS AN EXISTING MARSH/WETLAND AREA THAT WAS PLANTED AND IS IN GOOD HEALTH FOR ALBUQUERQUE. A SMALL PORTION OF THE EMBANKMENT ALONG THE FRONTAGE DRAINS DIRECTLY INTO MONTANO RD. THIS SLOPED LANDSCAPED AREA WILL REMAIN IN THE DEVELOPED CONDITION AND FREELY DISCHARGE.

PROPOSED DRAINAGE:

THE WEIGHTED E METHOD FROM THE "CITY OF ALBUQUERQUE DEVELOPMENT PROCESS MANUAL VOLUME I - DESIGN CRITERIA, 2006 REVISION" WAS USED TO CALCULATE THE RUNOFF AND VOLUME FOR THE SITE. THE HYDROLOGY TABLES ARE SHOWN ON THIS PAGE. THE SITE WAS DIVIDED INTO 6 BASINS WITH THE APPROPRIATE LAND TREATMENT DETERMINED AS SHOWN IN THE DRAINAGE TABLE. THE MAJORITY OF THE SITE WILL SHEET FLOW AND BE DIRECTED BY CURB AND GUTTER TO A 3'X3' GRATE INLET IN THE PARKING LOT IN THE SOUTH WEST CORNER OF THE SITE WHICH HAS THE INLET CAPACITY FOR THE EXPECTED FLOW. ROOF DRAINS FROM THE RESIDENTIAL BUILDINGS SHALL BE DIRECTED INTO THE PARKING LOT AREA AND SHEET FLOW ACROSS THE PROPERTY. THE RUNOFF SHALL THEN BE DISCHARGED DIRECTLY TO THE LAKE VIA AN 18-INCH HDPE PIPE THAT HAS THE CAPACITY TO CONVEY THE DESIGN FLOWS. THE LANDSCAPED EMBANKMENT ALONG MONTANO WILL FREELY DISCHARGE INTO THE STREET AND DOES NOT CONTRIBUTE SIGNIFICANT FLOWS. A SMALL PORTION OF THE DRIVEWAY ENTRANCE SHALL ALSO FLOW INTO MONTANO RD. NEW DEVELOPMENT SITES ARE REQUIRED TO CAPTURE AND INFILTRATE THE "STORMWATER QUALITY VOLUME" FROM THE 90TH PERCENTILE STORM. THE METHODOLOGY USED IN THE EPA REPORT "ESTIMATING PREDEVELOPMENT HYDROLOGY IN THE MIDDLE RIO GRANDE WATERSHED" APRIL 2014, YIELDS A RUNOFF VALUE OF 0.42 INCHES FOR THE 90TH PERCENTILE STORM. THEREFORE THE REQUIRED STORMWATER QUALITY VOLUME TO BE CAPTURED AND INFILTRATED IS THE PRODUCT OF THE IMPERVIOUS AREA MULTIPLIED BY 0.42 INCHES FOR NEW DEVELOPMENT SITES.

THE PEAK DISCHARGE FOR THE ENTIRE SITE IS 9.3 CFS WHICH IS MORE THAN THE HISTORIC FLOWS DUE TO THE IMPERVIOUS AREAS BEING PROPOSED BUT THE LAKE WILL HAVE THE CAPACITY TO RETAIN THE ADDITIONAL VOLUME GENERATED FROM THIS DEVELOPMENT AND WILL THEREFORE MEET THE FIRST FLUSH REQUIREMENTS. THE 10 DAY VOLUME WAS CALCULATED AND THE CAPACITY OF THE LAKE WILL BE VERIFIED TO CONFIRM THERE IS EXCESS CAPACITY AT THE TIME OF THE FINAL REPORT.

DPM Weighted E Method

Precipitation Zone 1 East of Mesa View United Methodist Church 4701 Montaño Rd NW, Albuquerque, NM 87120

Existing Conditions

	Basin Descriptions								100-\	∕ear, 6-Hr		10-Y	ear, 6-Hr				
Basin	Area	Area	Area	Treatme	ent A	Treat	ment B	Treatr	nent C	Treatr	nent D	Weighted E	Volume	Flow	Weighted E	Volume	Flow
ID	(sf)	(acres)	(sq miles)	%	(acres)	%	(acres)	%	(acres)	%	(acres)	(in)	(ac-ft)	cfs	(in)	(ac-ft)	cfs
1	126,434	2.90	0.00454	88%	2.554	0%	0.000	0%	0.000	12%	0.348	0.624	0.151	4.82	0.219	0.053	1.62
												Total On Site F	Retention p	ond			
2	23,437	0.54	0.00084	100%	0.538	0%	0.000	0%	0.000	0%	0.000	0.440	0.020	0.69	0.080	0.004	0.13
												Total Montaño	Rd				
Total	149,871	3.44	0.00538		3.092		0.000		0.000		0.348		0.171	5.51		0.057	1.75

Propose	Proposed Conditions																					
					Basin Des	criptions						100-\	'ear, 6-Hr		10-Y	ear, 6-Hr		100-Year, 10 <i>-</i> day		ау	SWQV	
Basin	Area	Area	Area	Treatme	ent A	Treatr	nent B	Treatm	nent C	Treatr	nent D	Weighted E	Volume	Flow	Weighted E	Volume	Flow	Weighted E	Volume	Volume	Required	Provided
ID	(sf)	(acres)	(sq miles)	%	(acres)	%	(acres)	%	(acres)	%	(acres)	(in)	(ac-ft)	cfs	(in)	(ac-ft)	cfs	(in)	(ac-ft)	(cf)	(cf)	(cf)
1	40,617	0.93	0.00146	0%	0.000	65%	0.606	0%	0.000	35%	0.326	1.125	0.087	2.66	0.577	0.045	1.40	1.125	0.130	5,676	498	
2	33,156	0.76	0.00119	0%	0.000	67%	0.510	0%	0.000	33%	0.251	1.099	0.070	2.13	0.557	0.035	1.11	1.099	0.110	4,797	383	
3	33,504	0.77	0.00120	0%	0.000	55%	0.423	0%	0.000	45%	0.346	1.255	0.080	2.37	0.679	0.044	1.32	1.255	0.136	5,905	528	
4	16,888	0.39	0.00061	100%	0.388	0%	0.000	0%	0.000	0%	0.000	0.440	0.014	0.50	0.080	0.003	0.09	0.440	0.014	619	0	
5	8,212	0.19	0.00029	100%	0.189	0%	0.000	0%	0.000	0%	0.000	0.440	0.007	0.24	0.080	0.001	0.05	0.440	0.007	301	0	
6	17,494	0.40	0.00063	0%	0.000	20%	0.080	0%	0.000	70%	0.281	1.513	0.051	1.39	0.912	0.031	0.87	1.513	0.136	5,941	429	
Total	149,871	3.44	0.00538		0.576		1.619		0.000		1.205		0.309	9.296		0.158	4.851		0.534	23,239	1,837	-

			_			
Excess I	Precipitation	on, E (in.)		Peak	Discharg	je (cfs/acre)
Zone 1	100-Year	10-Year		Zone 1	100-Year	10-Year
Ea	0.44	0.08		Qa	1.29	0.24
Eb	0.67	0.22		Qb	2.03	0.76
Ec	0.99	0.44		ç	2.87	1.49
Ed	1.97	1.24		Qd	4.37	2.89

Equations: Weighted E = Ea*Aa + Eb*Ab + Ec*Ac + Ed*Ad / (Total Area)Volume = Weighted E * Total Area

Flow = Qa*Aa + Qb*Ab + Qc*Ac + Qd*Ad


Stormwater Quality Volume Total Impervious Area = ΣArea in "Treatment D"

VICINITY MAP:


Retainage depth = 0.42" Per DPM Pg. 272 0.035 Retention Volume = = 0.035 x area


Cubic Fee

E-11, 12-Z

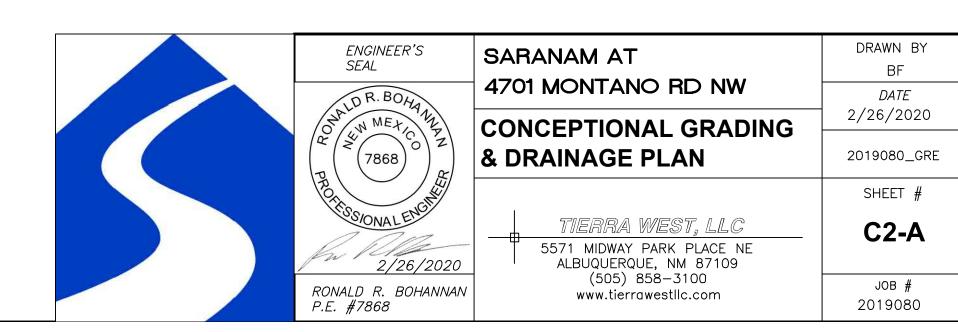


FIRM MAP: 35001C0114H DATE: 8/16/2012

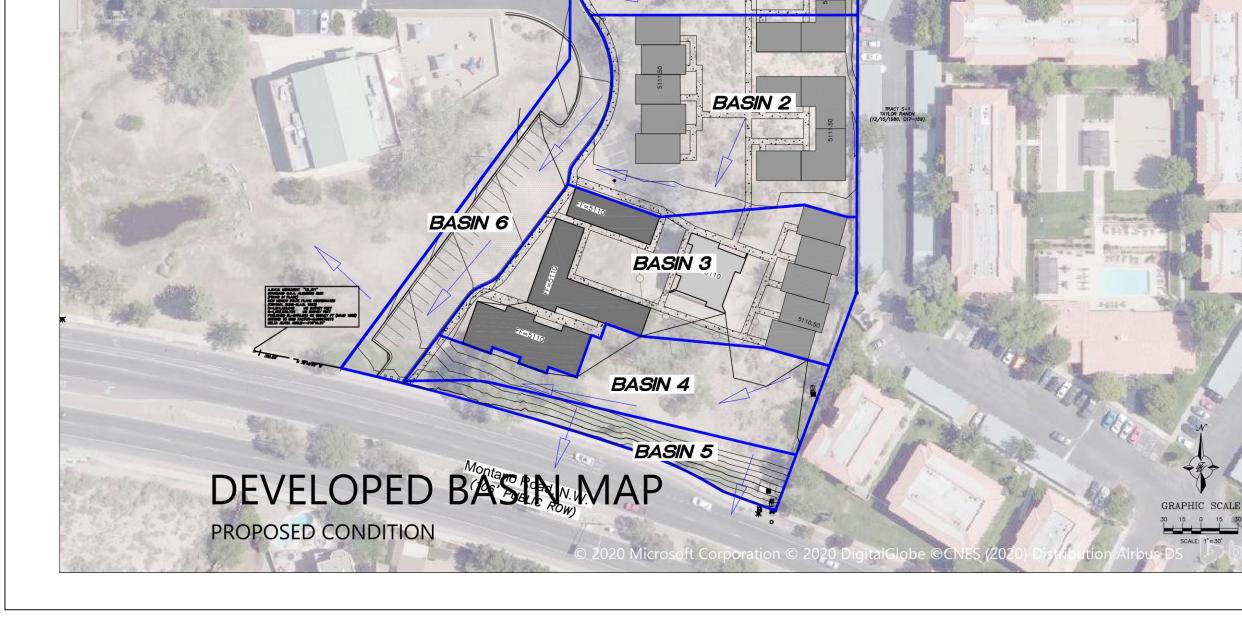

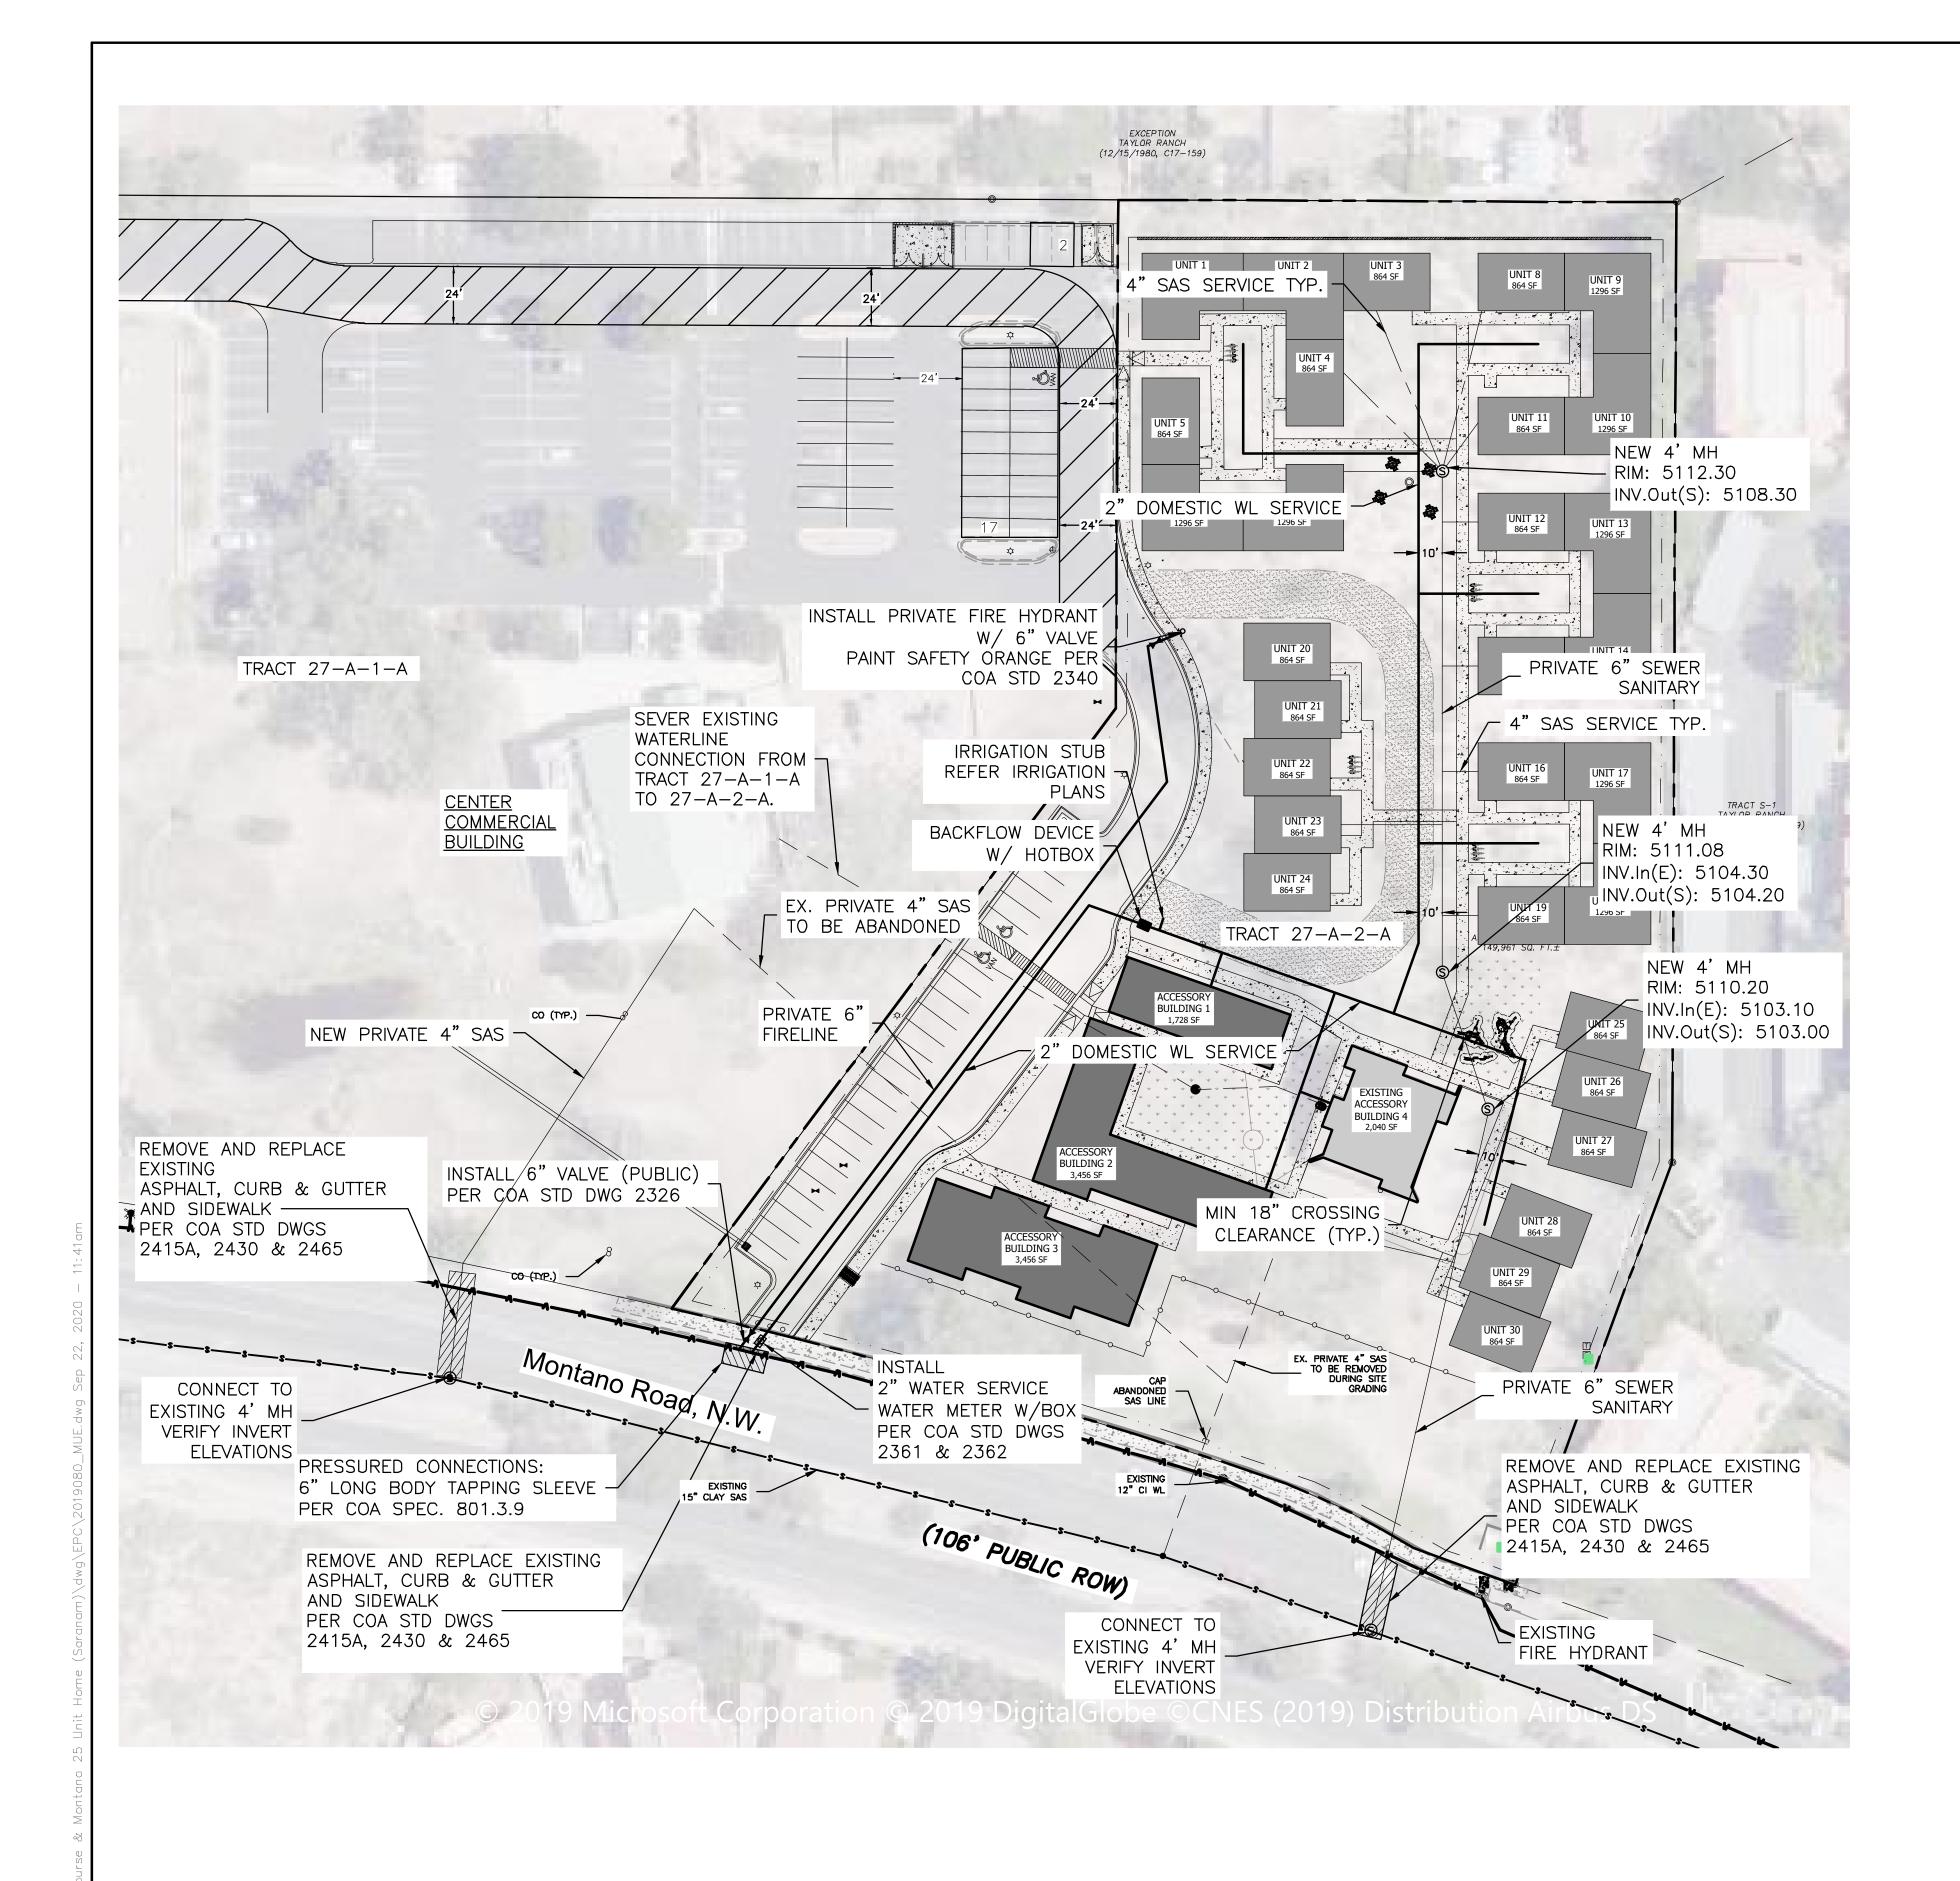


GENERAL UTILITY NOTES:

- 1. CONTRACTOR MUST COORDINATE WATER SYSTEM WITH SEWER SYSTEM TO PREVENT ANY CONFLICTS WHERE THESE LINES INTERSECT ONE ANOTHER.
- 2. PROVIDE 4 FEET OF COVER MINIMUM FOR ALL PROPOSED WATER LINES.
- AREAS WHERE WATER PIPES CROSS OVER SEWER PIPES SHALL NOT HAVE ANY JOINTS.
- 4. PROPOSED WATER LINE SHALL BE 8' FROM CENTERLINE (North and East), UNLESS OTHERWISE NOTED.
- 5. NO FENCES, SIGNS, TREES OR ROCKWALLS TO BE PLACED WITHIN UTILITY EASEMENTS.
- CONTACT UTILITY COMPANIES FOR EXACT LOCATION OF UNDERGROUND UTILITIES IN THIS AREA BEFORE EXCAVATION.
- 7. INSTALL A TRENCH SAFETY SYSTEM TO PROVIDE FOR THE SAFE EXCAVATION OF ALL TRENCHES EXCEEDING A DEPTH OF (5') FEET AS PER O.S.H.A. STANDARDS.
- PROVIDE ADEQUATE CONCRETE THRUST BLOCKING AT THE FOLLOWING: TAPPING SLEEVES, TEES, BENDS, PLUGS AND ALL FITTINGS.
- 9. P.V.C. PIPE SHALL BE PLACED WITH SELECT BEDDING MATERIAL ALL
- 10. CAUTION: VERIFY LOCATION & DEPTH OF EXISTING GAS MAIN IN THE AREA OF CONSTRUCTION, BEFORE INSTALLING WATER LINE.

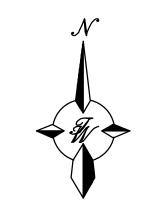

GRAPHIC SCALE

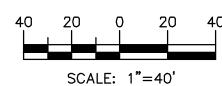

WATER NOTES:

- 1. CONTACT UTILITY COMPANIES FOR EXACT LOCATION FOR UNDERGROUND UTILITIES IN THE AREA.
- 2. PROVIDE ADEQUATE CONCRETE THRUST BLOCKING AT THE FOLLOWING: TAPPING, SLEEVES, TEES, BENDS, PLUGS - ALL FITTINGS. REFER TO ABCWUA STANDARD DETAIL DRAWING 2320
- 3. INSTALL A TRENCH SAFETY SYSTEM TO PROVIDE FOR THE SAFE EXCAVATION OF ALL TRENCHES EXCEEDING A DEPTH OF (5') FIVE FEET AS PER O.S.H.A. STANDARDS.
- 4. ALL P.V.C. PIPE ON THIS PLAN SHALL BE ENCASED WITH SELECT BEDDING WHEN PLACED IN CITY ROW. IN SITU (ACCEPTABLE) MATERIAL CAN BE USED IN PRIVATE LINES.
- 5. ALL VALVES ON P.V.C. WATER MAINS SHALL BE ANCHORED IN CONCRETE.
- 6. CITY PAVING CUT PERMIT REQUIRED BEFORE EXCAVATION.
- 7. RECONNECTION OF EXISTING WATER LINE SYSTEM SHOWN ON THESE PLANS MUST BE MADE, SUCH THAT MINIMAL INTERRUPTION OF SERVICE TO CUSTOMER IS MADE.
- 8. ALL EXISTING LINES CURRENTLY IN SERVICE MUST REMAIN IN SERVICE THROUGHOUT CONSTRUCTION. CONTRACTOR IS RESPONSIBLE FOR PROTECTING 8" SEWER LINES (INCLUDING SERVICES) FROM DAMAGE AS A RESULT OF CONSTRUCTION.
- 9. CONTRACTOR SHALL VERIFY LOCATION OF SERVICES BEFORE CONSTRUCTION.
- 10. CONTRACTOR SHALL COORDINATE WITH CITY & COUNTY CONSTRUCTION SEQUENCE AND TRAFFIC CONTROL PLANS.
- 11. CONTRACTOR SHALL PROVIDE TEMPORARY SERVICE TO CUSTOMERS IF SERVICE WILL BE INTERRUPTED FOR MORE THAN (4) HOURS IN A 24-HOUR PERIOD.
- 12. CONTRACTOR TO ADJUST WATER VALVES TO FINAL GRADE WHERE NECESSARY.

LEGEND

	CURB & GUTTER
	BOUNDARY LINE
	EASEMENT
	CENTERLINE
	RIGHT-OF-WAY
	BUILDING
	SIDEWALK
	SCREEN WALL
	RETAINING WALL
	EXISTING CURB & GUTTER
	EXISTING BOUNDARY LINE
 36" SD 	STORM SEWER LINE
8" SAS	SANITARY SEWER LINE
8" WL	WATERLINE
•	SINGLE CLEAN OUT
œ	DOUBLE CLEAN OUT
<u>.D</u>	EXISTING SD MANHOLE
	EXISTING INLET
S	EXISTING SAS MANHOLE
	EXISTING FIRE HYDRANT
wv _	EXISTING WATER VALVE
	EXISTING WATER METER
•	EXISTING POWER POLE
Ê	EXISTING GAS VALVE
	EXISTING OVERHEAD UTILITIES
— — — — EX. UGE — — — —	EXISTING UNDERGROUND UTILITIES
——————————————————————————————————————	EXISTING GAS
EX. 8" SAS	EXISTING SANITARY SEWER LINE
— — — EX. 10" WL— — —	EXISTING WATER LINE
— · —EX. 18" RCP——	EXISTING STORM SEWER LINE

MATERIALS (OR EQUIVALENT APPROVED):

- 1. SEWER TO BE SDR-35 PVC
- 2. WATER LINE TO BE C900-PVC DR18

ABCWUA NOTES:

THE CONTRACTOR SHALL COORDINATE WITH THE WATER AUTHORITY SEVEN (7) DAYS IN ADVANCE OF PERFORMING WORK THAT WILL AFFECT THE PUBLIC WATER OR SANITARY SEWER INFRASTRUCTURE. WORK REQUIRING SHUTOFF OF FACILITIES DESIGNATED AS MASTER PLAN FACILITIES MUST BE COORDINATED WITH THE WATER AUTHORITY 14 DAYS IN ADVANCE OF PERFORMING SUCH WORK. ONLY WATER AUTHORITY CREWS ARE AUTHORIZED TO OPERATE PUBLIC VALVES. SHUTOFF REQUESTS MUST BE MADE ONLINE AT


HTTP://ABCWUA.ORG/CONTENT/VIEW/463/729/.

ISSUED ENGII SEAL RONALD R. P.E. #7868

O FOR DRB ONLY								
GINEER'S L	SARANAM AT	DRAWN BY BF						
MEXICO Z	4701 MONTANO RD NW	<i>DATE</i> 7/28/2020						
7868)	MASTER UTILITY PLAN	2019080_MU						
DNAL ENGINE		SHEET #						
/28/2020	TIERRA WEST, LLC 5571 MIDWAY PARK PLACE NE ALBUQUERQUE, NM 87109	С3						
R. BOHANNAN 368	(505) 858-3100 www.tierrawestllc.com	ЈОВ # 2019080						

CAUTION:

ALL EXISTING UTILITIES SHOWN WERE OBTAINED FROM RESEARCH, AS-BUILTS, SURVEYS OR INFORMATION PROVIDED BY OTHERS. IT SHALL BE THE SOLE RESPONSIBILITY OF THE CONTRACTOR TO CONDUCT ALL NECESSARY FIELD INVESTIGATIONS PRIOR TO AND INCLUDING ANY EXCAVATION, TO DETERMINE THE ACTUAL LOCATION OF UTILITIES AND OTHER IMPROVEMENTS, PRIOR TO STARTING THE WORK. ANY CHANGES FROM THIS PLAN SHALL BE COORDINATED WITH AND APPROVED BY THE ENGINEER.

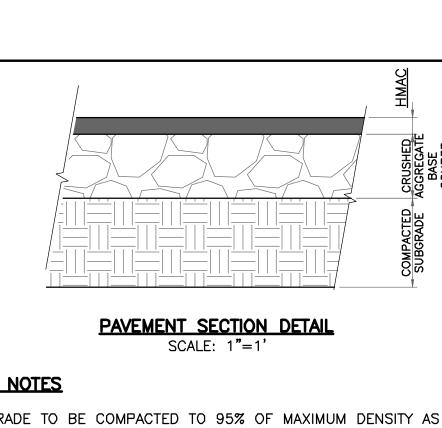

PAVEMENT NOTES

- 1. SUBGRADE TO BE COMPACTED TO 95% OF MAXIMUM DENSITY AS PER ASTM D1557.
- BASE TO BE COMPACTED TO NOT LESS THAN 100% DENSITY IN ACCORDANCE WITH ASTM D1557. TYPE A, GRADE 1 OR 2.
- BITUMINOUS MATERIAL SHALL CONFORM TO AC-10 OR AC-20, TYPE "C" IN ACCORDANCE WITH ASTM D3318.
- 4. PRIME COAT TO BE 0.25 GAL. PER SQUARE YARD (MINIMUM COVERAGE)
- COMPACTION TESTS WHERE REQUIRED BY THE CITY ENGINEER MUST BE PAID
- FOR BY THE DEVELOPER. C.B.R. TESTS WILL BE REQUIRED AT 500 FOOT INTERVALS AFTER SUBGRADE IS PLACED AND/OR A MINIMUM OF TWO TESTS IF STREET IS LESS THAN 500
- 7. STRICT VERTICAL CONTROL OF ALL CURB AND GUTTER ELEVATIONS WILL BE MAINTAINED. BLUE TOPPING WILL BE REQUIRED THROUGHOUT.

TRENCHING

ALL TRENCHING SHALL BE DONE IN STRICT ACCORDANCE WITH OSHA-2226.

CONC. HC RAMP

CURB<

∠TOP OF RAMP

SECTION A-A

UNIDIRECTIONAL HC RAMP

CONC. HC RAMP

SLOPE 12:1 MAX.


NOT TO SCALE


PLAN

→ 5' MIN. LANDING I

SLOPE 12:1 MAX.

SIDEWALK

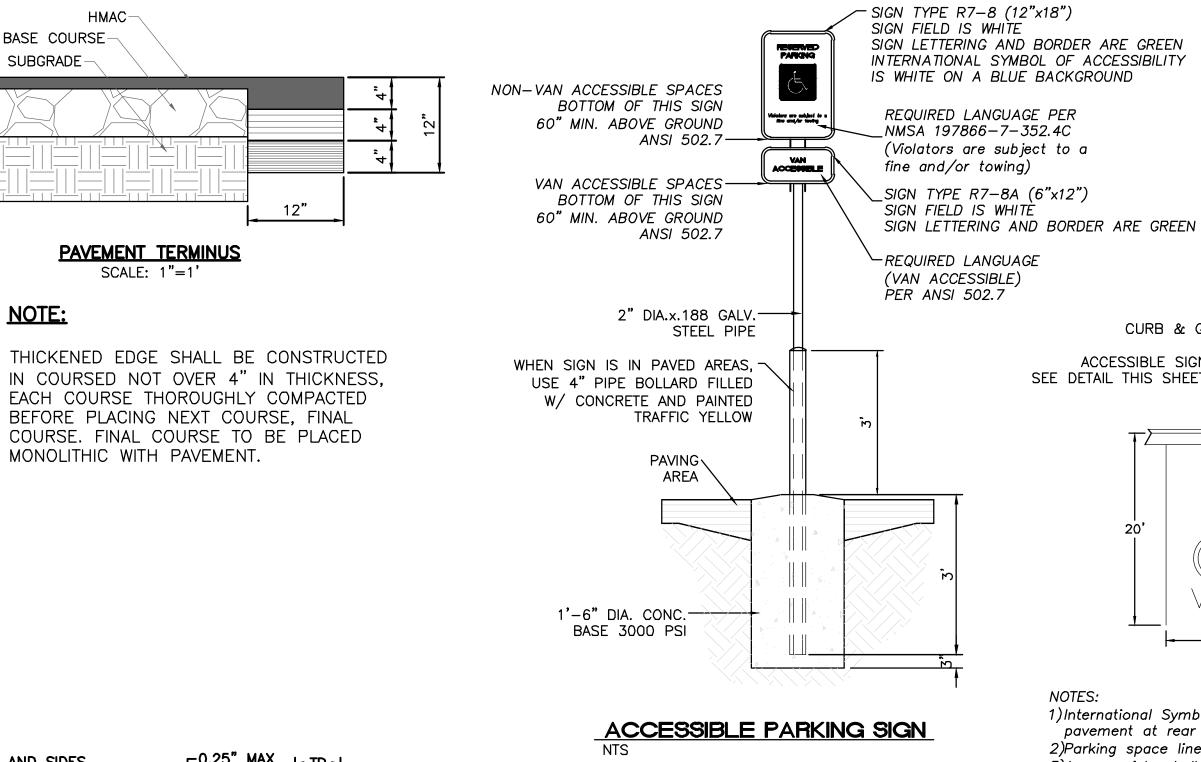

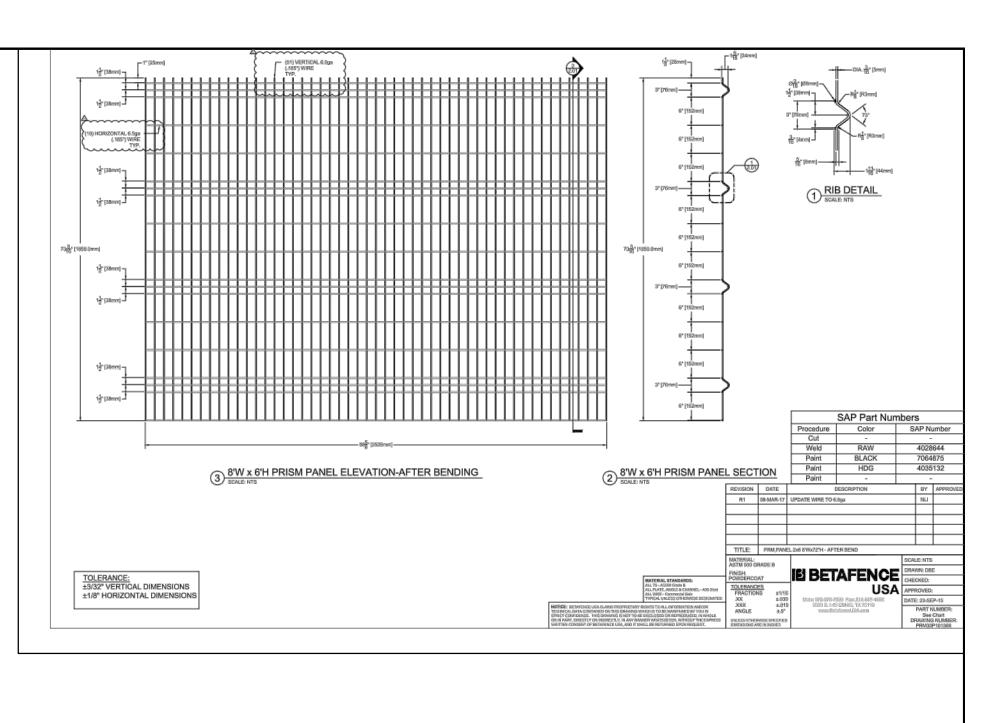

GRAIER MANUFACTURING, DC.
1801 BMCR (RTVF
1801 BMCR (RTVF
1801 BMCR (RTVF
1802)
PC8000 448-7931, PC680 R47-908, FC800 B47-908
VVV MADRACCIM, E-MAIL: SALESIMADRAXCOB

3" X 6" X 2/8" THEX 2 EA 7/16" SQ. HOLE TYP. SPIKE

NUTES
L. DISTALL BINE RICKS ACCORDING TH WANFACTURER'S SPECIFICATIONS.
E. CONSULTANT TO SELECT CLOR GRACIA), SEE MANFACTURER'S SPECIFICATIONS.
3. SEE SITE PLAN FOR LOKATION OR CONSULT INVER.

CHECK DESIRED MOUNT

5' SIDEWALK

← 2% MAX SLOPE

D IN GROUND HOUNT (CE)

PRODUCT: UP38-7055*)
IL SORPFION "V DICE PACK
IL SORPFION" V DICE PACK
TO SORPFION PRODUCT OR IN GROUND HOUNT

CONFIDERTIAL CRANING AND INFERMATION IS NOT IT IN EXCEPTED OR DISCUSSE THE OTHERS VITIGUE THE CONSENT OF GRAVER MAINFACTURING, INC. SPECIFICATURIS ARE SUBJECT TO CHAMBE VITIOUS INSTITUTE.

VARIES


CURB & GUTTER -

ACCESSIBLE SIGN-


SEE DETAIL THIS SHEET

1)International Symbol of Accessibility shall be painted on the pavement at rear of space, white symbol on blue background. 2)Parking space lines and diagonal striping to be painted blue. 3)Access aisle shall have the words "NO PARKING" in capital letters, each of which shall be at least one foot high and at least two inches wide, placed at the rear of the parking space so as to be close to where an adjacent vehicle's rear tires would be placed.

HC PARKING DETAIL

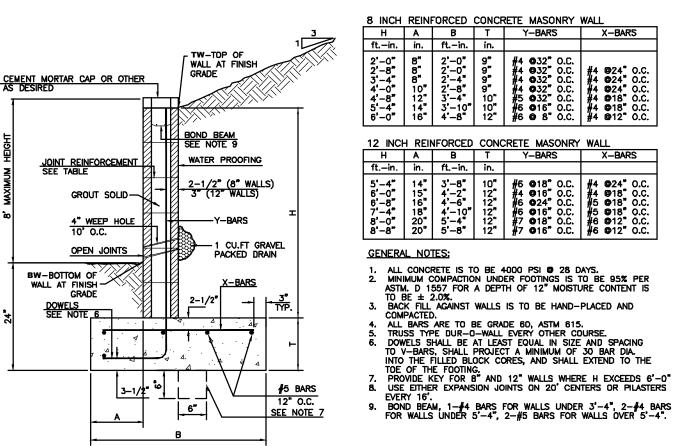


RETAINING WALL DETAIL

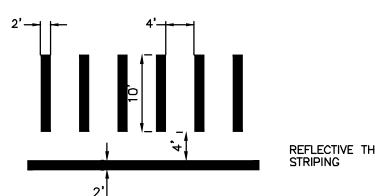

ALL PAVEMENT MARKINGS SHALL CONFORM TO M.U.T.C.D. SPECS (LATEST EDITION)

CROSSWALK DETAIL

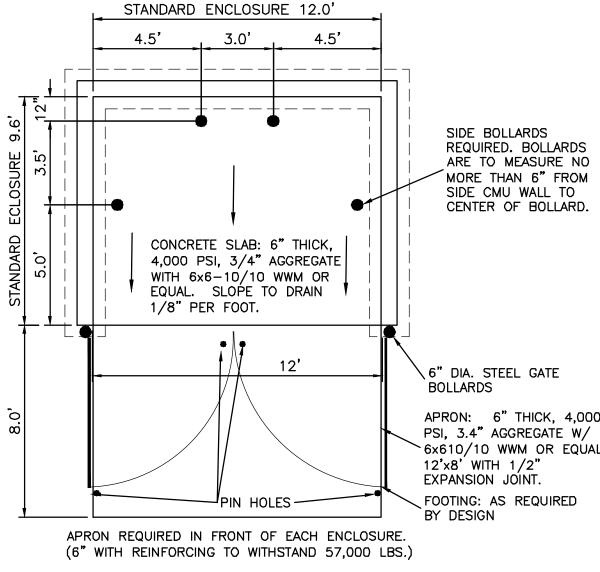


6" OUTSIDE DIA. CONCRETE

FILLED STEEL PIPE SHALL BE

/ENCASED IN 12" CONCRETE ALL AROUND AND EMBEDDED 2.0'

1. THESE ARE THE MINIMUM REQUIREMENTS FOR TRASH ENCLOSURES. DESIGNS MAY VARY TO FIT THE SELECTED ENCLOSURE.

2. SOLID WASTE IS TO PROVIDE ALL INSPECTIONS ON THE TRASH ENCLOSURE SUCH AS PRE-POUR FOR SLAB AND APRON, BOND BEAM, BOLLARD, AND FINAL INSPECTION WILL BE CONTINGENT FOR SOLID WASTE SIGN OFF FOR FINAL CO.

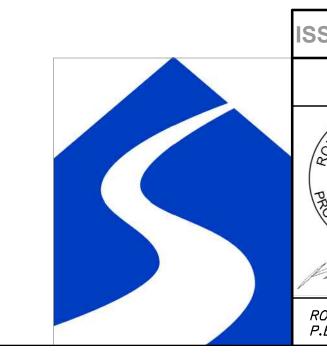

ISSUED FOR DRB ONLY DRAWN BY ENGINEER'S SARANAM AT SEAL 4701 MONTANO RD NW DATE 7/28/2020 IN MEX **CONSTRUCTION DETAILS** 2019080_DTE SHEET # TIERRA WEST. LLC C4 5571 MIDWAY PARK PLACE NE 7/28/2020 ALBUQUERQUE, NM 87109 (505) 858-3100 JOB # RONALD R. BOHANNAN www.tierrawestllc.com 2019080 P.E. #7868

REFLECTIVE THERMOPLASTIC DUMPSTER ENCLOSURE DETAIL

VARIES EXPANSION-JOINT R=1 1/2" △ CURB GUTTER -EXPANSION JOINT 24"

END SECTION

PLAN VIEW

HMAC-

PAVEMENT TERMINUS

SCALE: 1"=1'

EACH COURSE THOROUGHLY COMPACTED

BEFORE PLACING NEXT COURSE, FINAL

COURSE, FINAL COURSE TO BE PLACED

_0.25" MAX

DOME SECTION

DOME SPACING

CC - CENTER TO CENTER SPACING 2.35"

BB - BASE TO BASE SPACING 1.48" MIN

BD - BASE DIAMETER 0.9" MIN

65% OF BD MAX

TD - TOP DIAMETER 50% OF BD MIN TO

MONOLITHIC WITH PAVEMENT.

12"

BASE COURSE-

SUBGRADE -

NOTE:

1. NO EXPANSION JOINT WILL BE REQUIRED EXCEPT AT THE END OF CURB RETURNS. (POINT OF

NOTES:

DETECTABLE WARNING

50:1 MAX

SURFACE (TRUNCATED DOME)

1. THE SURFACE OF RAMP AND SIDES

2. CONSTRUCT PER A.D.A. STANDARDS.

SURROUNDING SIDEWALK.

SHALL HAVE A TRANSVERSE BROOMED

SURFACE TEXTURE ROUGHER THAN THE

DETECTABLE WARNING

SURFACE

CONC. HC RAMP

SLOPE 50:1 MAX.

- TANGENGY WITH STRAIGHT LINE).
- 2. CONTRACTION JOINTS (1/2" INCH MIN.) MUST BE SCORD EVERY 10 FEET IN CURB AND GUTTER. 3. ALL EXPANSION JOINTS WILL BE OF PREFORMED BITUMINOUS FIBER 1/2" INCH THICK.
- 4. CONCRETE: CLASS "A" 3000 PSI.
- 5. EXPANSION JOINTS REQUIRED AT 5' O.C. WHEN FORMING FOR CURBS. 6. THIS DETAIL APPLIES TO PRIVATE CURB WORK ONLY.

STANDARD 6" CURB & GUTTER <u>DETAIL</u> SCALE: 1"=1'

CONCRETE SHALL BE 3000 P.S.I. MINIMUM.

SEE CURB -

SHEET

DETAIL THIS

MATCH -


SLOPE |

PAVEMENT

NOTES:

- DUMMY JOINTS REQUIRED AT 10' O.C. FOR CURB/GUTTER AND 5' O.C. FOR SIDEWALK.
- EXPANSION MATERIAL REQUIRED AT CURB RETURNS WITH 1/2" PREMOLDED ASPHALT IMPREGNATED EXPANSION MATERIAL OR EQUAL.
- EXPANSION JOINTS REQUIRED AT 50' O.C. WHEN FORMING FOR CURBS.
- WHENEVER SIDEWALK ABUTS ROCK OR MASONRY STRUCTURES SUCH AS CURBS OR BUILDINGS, EXPANSION JOINT FILLER SHALL BE USED IN ACCORDANCE WITH STANDARD SPECIFICATIONS.

CURB & GUTTER AND SIDEWALK <u>DETAIL</u> SCALE: 1"=2'

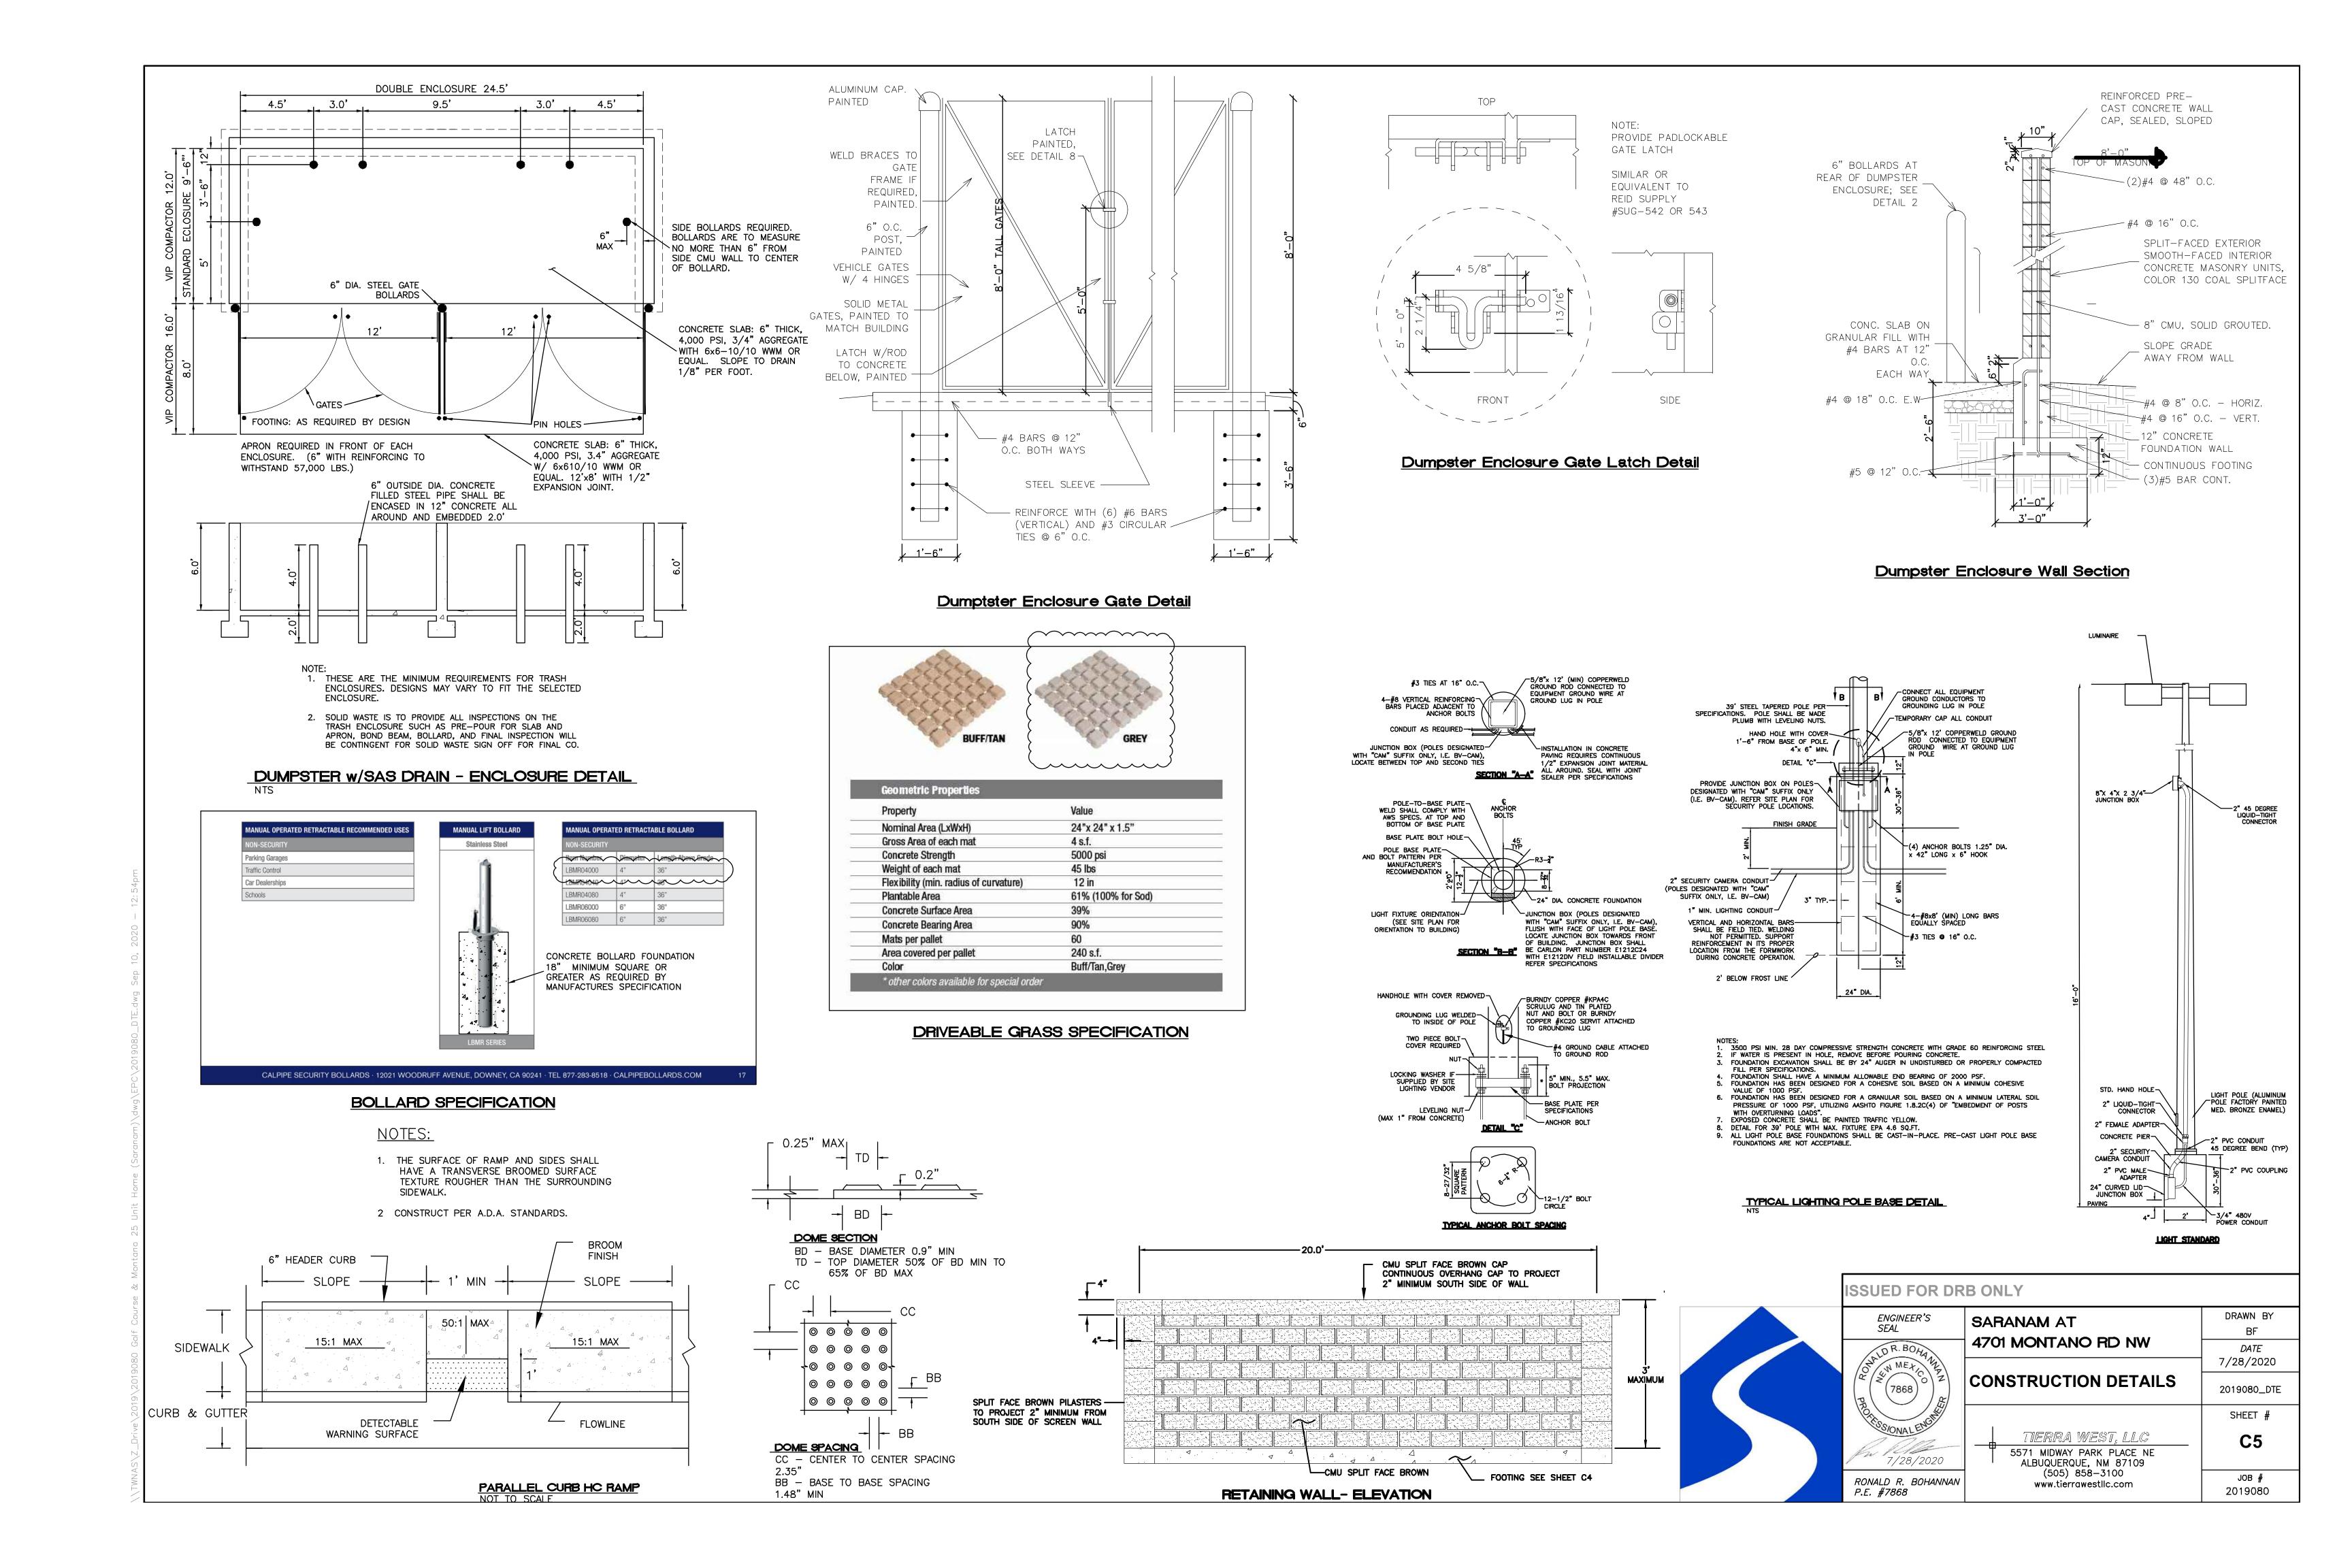



EXISTING SITE SETBACK PER EDGE BUFFERING 5-6(E)(1)(b) IN THE IDO THE REQUIRED BUFFERING IS NOT REQUIRED.

OPTIONAL 6" MOW CURB BETWEEN SOD AREA AND GRAVEL AREAS.

EXISTING TREES TO REMAIN AND BE PROTECTED DURING CONSTRUCTION.

SITE DATA

TOTAL REQUIRED TREES:

LESS BUILDING(S)

GROSS LOT AREA (4.03 ACRES)

NET LOT AREA 108,951	SF					
	SF SF					
TOTAL PROPOSED LANDSCAPE 81,128	SF					
PERCENT OF NET LOT AREA	%					
REQUIRED STREET TREES	14					
PROVIDED/EXISTING AT 25' O.C. SPACING ALONG ST	REET 14					
REQUIRED PARKING LOT TREES	5					
PROVIDED AT 1 PER 10 SPACES (45 SPACES/10)	5					
REQUIRED DWELLING UNIT TREE						
PROVIDED AT 1 PER DWELLING UNIT(30 UNITS)	66					

149,871 SF

______40,920_ SF

TOTAL PROVIDED TREES**: **(does not include 10 existing trees to remain)**

REQUIRED LANDSCAPE COVERAGE 75% LIVE VEGETATIVE MATERIAL 12,256 SF MIN. (16,342 SF PROPOSED LANDSCAPE X 75%) PROVIDED GROUNDCOVER COVERAGE 8,155 SF PERCENT GROUNDCOVER COVERAGE OF REQUIRED LANDSCAPE AREAS 861 SF PARKING LOT COVERAGE (10% OF 8,605SF) PARKING LOT COVERAGE PROVIDED 3,161SF/36% PROVIDED NATIVE SEED GROUNDCOVER 58,856 SF PERCENT GROUNDCOVER COVERAGE OF REQUIRED LANDSCAPE AREAS 351% TOTAL PERCENT GROUND COVER COVERAGE OF REQUIRED LANDSCAPE AREAS 416%

IRRIGATION NOTE

DRIP SYSTEM RUN CYCLES: ESTABLISHMENT AND SUMMER: 1 HOUR/4 DAYS A WEEK SPRING: 1 HOUR/2-3 DAYS A WEEK 1 HOUR/2-3 DAYS A WEEK WINTER: 1 HOUR/2 DAYS PER MONTH

LEGAL DESCRIPTION:

LOT 27A2 SUBDIVISION- TAYLOR RANCH. IDO-ZONE MX-L **GENERAL NOTES:**

1. MAINTENANCE OF THE LANDSCAPE AND IRRIGATION PROVIDED BY THE PROPERTY

2. LANDSCAPE AREAS SHALL BE DEPRESSED TO PROVIDE POSITIVE DRAINAGE FOR SITE RUN OFF. SEE CIVIL DRAWINGS FOR DRAINAGE INFORMATION AND PLACEMENT OF

3. THE LANDSCAPE PLAN IS DESIGNED TO MEET ALL CITY OF ALBUQUERQUE, AND IDO

REQUIREMENTS. 4. PLANT MATERIALS AND SIGNING WILL NOT INTERFERE WITH CLEAR SIGHT REQUIREMENTS. THEREFORE SIGNS, WALLS, TREES, AND SHRUBBERY BETWEEN 3 AND 8 FEET TALL (AS MEASURED FROM THE GUTTER PAN) ARE NOT ACCEPTABLE IN 'CLEAR

SIGHT' AREAS. 5. THE LANDSCAPE PLAN IS DESIGNED TO COMPLY WITH THE GENERAL IDO LANDSCAPING REGULATIONS(section 14-16-5-6) INCLUDING PROVISION OF A MINIMUM OF 75% LIVE GROUND COVERAGE, MEASURED AT MATURITY, OF ALL REQUIRED LANDSCAPE AREAS, AND A MINIMUM OF 25% REQUIRED VEGETATIVE COVERAGE OF GROUND LEVEL PLANTS.

PLANTINGS NOTES:

1. THE LANDSCAPE DESIGN SHALL COMPLY WITH THE CITY OF ALBUQUERQUE WASTE WATER CONSERVATION, LANDSCAPE, IDO, AND WATER WASTE ORDINANCE.. 2.THE R.O.W. (WHEN DEDICATED TO THE PUBLIC) SHALL BE MAINTAINED BY THE PROPERTY OWNER. THE PLAN SHALL FOLLOW THE COA DESIGN GUIDELINES FOR STREET TREES UNLESS OBSTRUCTED BY UTILITY EASEMENTS. 3. ALL LANDSCAPE AREAS SHALL BE COVERED WITH MULCH. USE GRAVEL MULCH AT

2"-3" DEPTH OVER FILTER FABRIC. 4. WHERE MULCH IS ADJACENT TO THE CONCRETE, FINISH GRADE OF MULCH SHALL BE

APPROXIMATELY 1/2" BELOW THE TOP OF CONCRETE. 5. ORGANIC MULCH, SUCH AS WOOD CHIPS OR PECAN SHELLS, IS REQUIRED AS GROUND COVER OVER THE PORTION OF ANY LANDSCAPED AREAS SURROUNDING THE VEGETATION ROOT BALL, AS WELL AS BENEATH THE ENTIRE TREE CANOPY OR DRIPLINE

, IN EACH REQUIRED LANDSCAPE AREA. 6. ALL NATIVE SEED AREA SOILS ARE TO BE AMENDED WITH COMPOST MULCH BEFORE

7. BROWN STEEL EDGING IS TO BE PLACED BETWEEN ALL AREAS OF GRAVEL AND NATIVE SEEDING. BETWEEN AREAS OF GRAVEL AND SOD, OPTIONAL 6" MOW CURB OR GREEN STEEL EDGING IS TO BE PLACED.

IRRIGATION NOTES:


- 1. ALL NEW PLANTINGS TO BE WATERED BY AUTO DRIP IRRIGATION SYSTEM. 2. WATER MANAGEMENT AND THE MAINTENANCE OF THE IRRIGATION SYSTEM IS THE SOLE RESPONSIBILITY OF THE PROPERTY OWNER.
- 3. THE IRRIGATION SYSTEM SHALL BE CONNECTED TO CITY WATER. THE POINT OF CONNECTION SHALL CONSIST OF A WATER METER, BACKFLOW PREVENTER, AND MASTER VALVE.
- 4. USE SIX 2 GPH EMITTERS PER EACH TREE AND TWO 2 GPH EMITTERS PER EACH SHRUB/GROUNDCOVER. USE SIX 2 GPH DRIP EMITTERS PER TREES IN POTS. SEPARATE IRRIGATION ZONES SHALL BE DESIGNED FOR TREES AND SHRUBS/GROUNDCOVERS. 5. ALL NATIVE SEED TO BE SPRAY IRRIGATED.
- 6. INSTALL THRUST BLOCKS WHEREVER THE MAINLINE BENDS IN NINETY DEGREE 7. INSTALL SLEEVES TWO SIZES LARGER THAN THE SLEEVED PIPE UNDER ALL HARD
- 8. THE BACKFLOW SIZE AND LOCATION IS ASSUMED ONLY, BASED ON THE LATEST AVAILABLE UTILITY PLAN. GENERAL CONTRACTOR TO PROVIDE THE IRRIGATION WATER

STUB OUT AND ELECTRICITY FOR THE HOTBOX.

9. ALL SLEEVES ARE ASSUMED TO BE PLACED PRIOR HARDSCAPE WITHOUT THE NEED OF BORING.



PO Box 10597 Albuquerque, NM 87184 505.898.9615 design@yellowstonelandscape.com

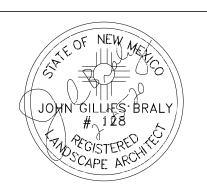

2/25/2020 Date:

Revisions:


2.26.20 2.27.20 07.23.20 08.19.20

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09.14.20


Drawn by: VBlount Reviewed by: JB

r Ranch Rd NW Jew Mexico

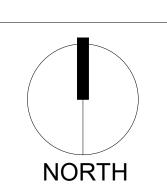

Montano Rd & Albuquer

Scale: 1" = 30'

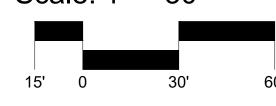

Sheet Title:

Landscape Plan


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PLANT SCHEDILLE BASE 20 07 23


PLANT SC	HEDU	LE BASE 20.07.25			
TREES	QTY	BOTANICAL / COMMON NAME	SIZE		
	3	EXISTING TREE	VARIES		
DECIDUOUS TREES	QTY	BOTANICAL / COMMON NAME	SIZE		
	16	PISTACIA CHINENSIS / CHINESE PISTACHE	2" B&B		
	24	PYRUS CALLERYANA `CLEVELAND SELECT` / CLEVELAND SELECT PEAR	2" B&B		
	14	ULMUS PARVIFOLIA `ALLEE` / ALLEE LACEBARK ELM	2" B&B		
EVERGREEN TREES	QTY	BOTANICAL / COMMON NAME	SIZE		
The state of the s	21	PINUS NIGRA / AUSTRIAN BLACK PINE	6`-8` B&B		
DESERT ACCENTS	QTY	BOTANICAL / COMMON NAME	SIZE	WATER USE	REBATE ALLOW.
*	28	HESPERALOE PARVIFLORA / RED YUCCA	5 GAL	LOW+	20
TANKEN TO THE PARTY OF THE PART	25	NOLINA MICROCARPA / BEARGRASS	5 GAL	RW	30
GRASSES	QTY	BOTANICAL / COMMON NAME	SIZE	WATER USE	REBATE ALLOW.
	118	CALAMAGROSTIS X ACUTIFLORA 'KARL FOERSTER' / FEATHER REED GRASS	1 GAL	MEDIUM	10
DECIDUOUS SHRUBS	QTY	BOTANICAL / COMMON NAME	SIZE	WATER USE	REBATE ALLOW.
	32	CARYOPTERIS X CLANDONENSIS 'DARK KNIGHT' / BLUE MIST SPIREA	1 GAL	LOW+	15
	58	RHUS AROMATICA `GRO-LOW` / GRO-LOW FRAGRANT SUMAC	5 GAL	LOW+	30
	19	SALVIA GREGGII / AUTUMN SAGE CHERRY	1 GAL	LOW+	15
EVERGREEN SHRUBS	QTY	BOTANICAL / COMMON NAME	SIZE	WATER USE	REBATE ALLOW.
	42	RHAPHIOLEPIS INDICA / INDIAN HAWTHORN	5 GAL	MEDIUM	20
SOD/SEED	QTY	BOTANICAL / COMMON NAME	TYPE		
	58,856 SF	NATIVE GRASS SEED MIX -NATIVE WONDER / 4LBS/1000SF SEED IRRIGATED WITH ROTORS AT APPROX. 75% COVERAGE SEEDING TO BE PERFORMED BETWEEN JUNE 1st AND SEPTEMBER 15th	AREA		
V V V	4,786 SF	SOD- PARK BLEND / IRRIGATED- 1804 POP UP PRS SPRAY	AREA		

REFERENCE NOTES SCHEDULE BASE 20.07.23

SYMBOL	DESCRIPTION	QTY
4	Medium Boulder	32
SYMBOL	DESCRIPTION	QTY
0 0 0	3/4" Grey Crushed Gravel 2" Depth over Filter Fabric	17,486 sf
SYMBOL	PAVING DESCRIPTION	QTY
	Belgard Hardscapes Turfstone Modified Running Bond	7,022 sf

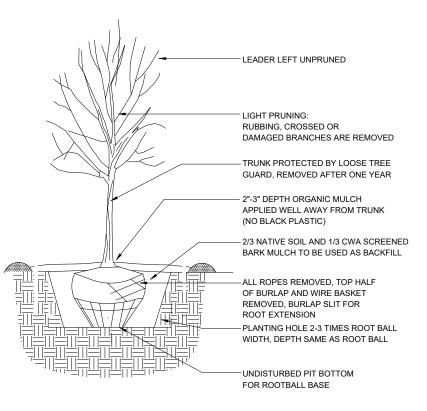

TREE PLANTING DETAIL

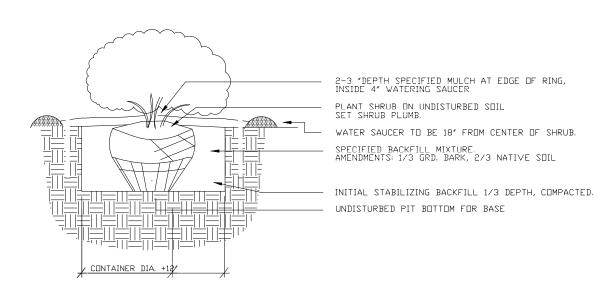


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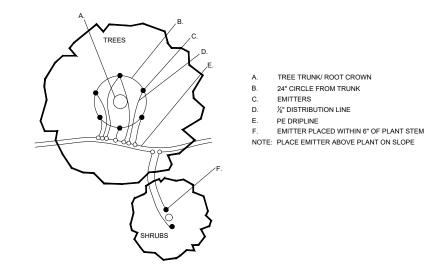
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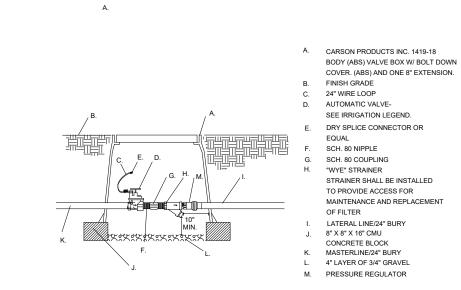
SHRUB PLANTING DETAIL



RP BACKFLOW/MASTER VALVE DETAIL

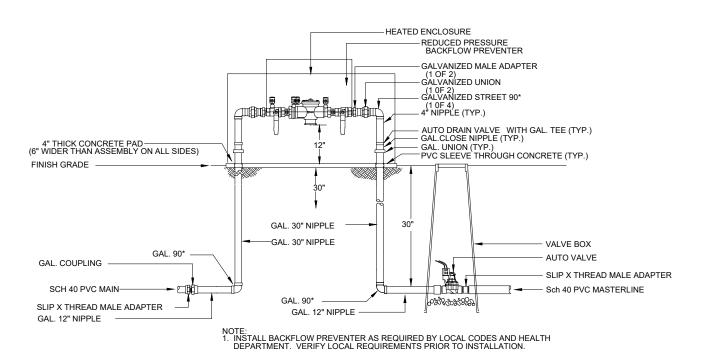

EMITTER PLACEMENT DETAIL



SITE DATA

GROSS LOT AREA (4.03 ACRES) LESS BUILDING(S) NET LOT AREA	149,871 SF 40,920 SF 108,951 SF
REQUIRED LANDSCAPE 15% OF NET LOT AREA PROPOSED LANDSCAPE PROPOSED OFFSITE LANDSCAPE TOTAL PROPOSED LANDSCAPE PERCENT OF NET LOT AREA	16,342 SF 81,128 SF 0 SF 81,128 SF 72 %
DECLUDED CEDEET EDEEC	

REQUIRED STREET TREES	14
PROVIDED/EXISTING AT 25' O.C. SPACING ALONG STREET	14
REQUIRED PARKING LOT TREES	5
ROVIDED AT 1 PER 10 SPACES (45 SPACES/10)	5
REQUIRED DWELLING UNIT TREE	30
ROVIDED AT 1 PER DWELLING UNIT(30 UNITS)	66
TOTAL REQUIRED TREES:	49
TOTAL PROVIDED TREES**:	68
(does not include 10 existing trees to remain)	

*(does not include 10 existing trees to remain)

REQUIRED LANDSCAPE COVERAGE 75% LIVE VEGETATIVE MATERIAL	
(16,342 SF PROPOSED LANDSCAPE X 75%)	12,256 SF MI
PROVIDED GROUNDCOVER COVERAGE PERCENT GROUNDCOVER COVERAGE	8,155 SF
OF REQUIRED LANDSCAPE AREAS	65%
PARKING LOT COVERAGE (10% OF 8,605SF) PARKING LOT COVERAGE PROVIDED	861 SF 3,161SF/36%
PROVIDED NATIVE SEED GROUNDCOVER	58,856 SF
PERCENT GROUNDCOVER COVERAGE	30,030 31
OF REQUIRED LANDSCAPE AREAS	351%
TOTAL PERCENT GROUND COVER COVERA OF REQUIRED LANDSCAPE AREAS	GE 416%

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IRRIGATION NOTE

LEGAL DESCRIPTION: LOT 27A2 SUBDIVISION- TAYLOR RANCH. IDO-ZONE MX-L

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DRIP VALVE WITH FILTER & PRESSURE REGULATOR



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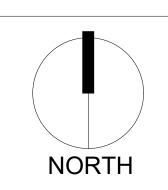



www.yellowstonelandscape.com PO Box 10597 Albuquerque, NM 87184 505.898.9615 design@yellowstonelandscape.com



2/25/2020 Revisions: 2.26.20 2.27.20 7.23.20 08.19.20 09.14.20 09.17.20 Drawn by: VBlount

Reviewed by: JB



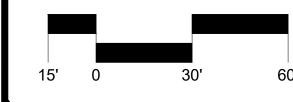


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Landscape Plan


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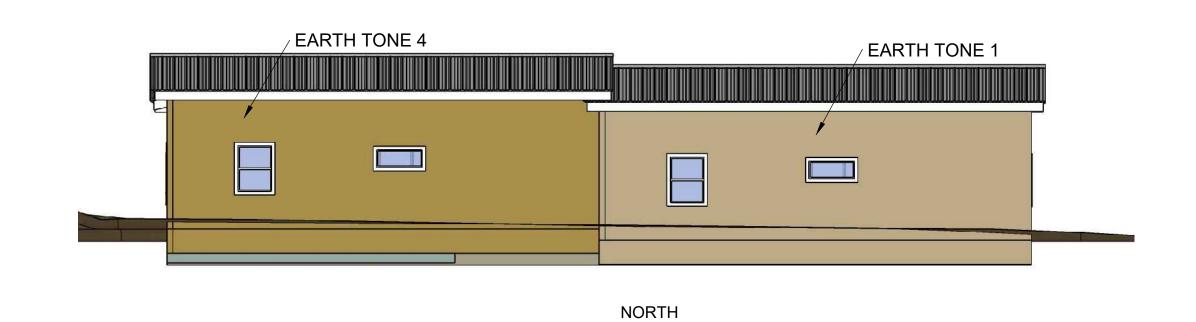
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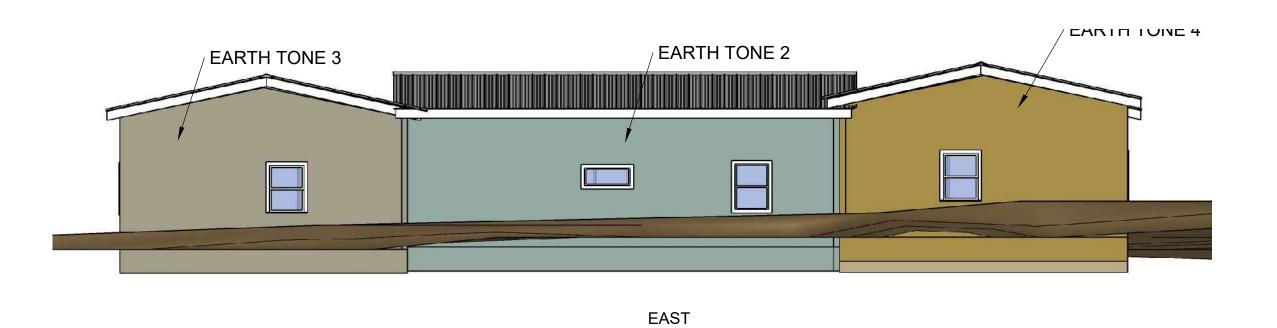





UNIT NO. 9 - TYPICAL

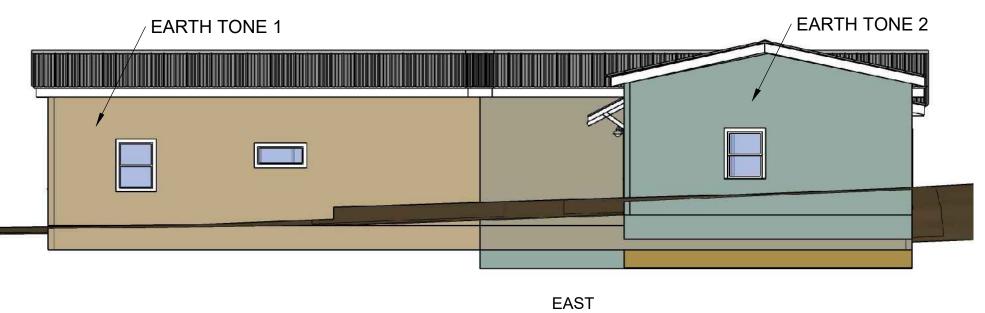



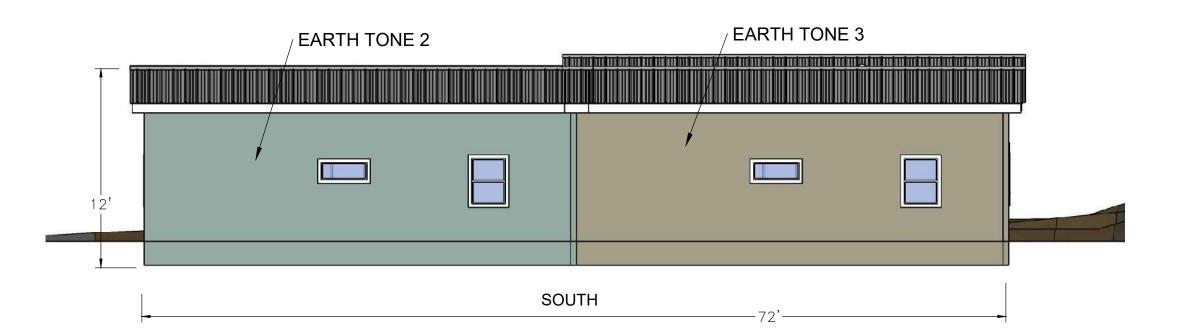

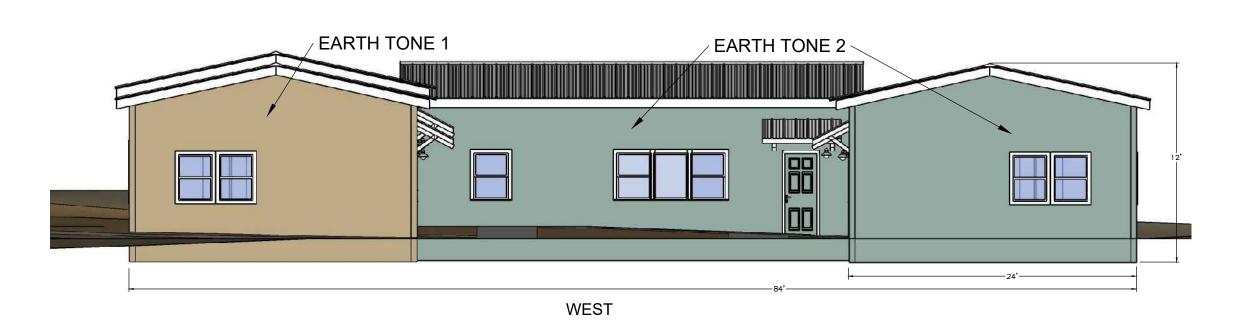



BUILDING NOTES

ALL BUILDINGS TO BE STUCCO FINISH
ALL BUILDING ROOFS ARE TO BE METAL CORRUGATED COLOR BEIGE
BUILDING FRAME TO BE STEEL OR WOOD
WINDOW TRIM TO BE PAINTED WHITE AND WOOD OR SIMILAR MATERIAL


BUILDING COLORS


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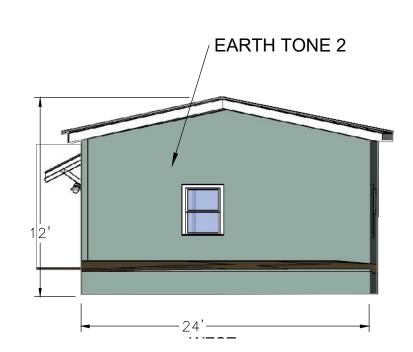


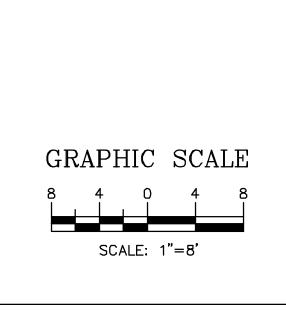ACCESSORY BUILDING 1

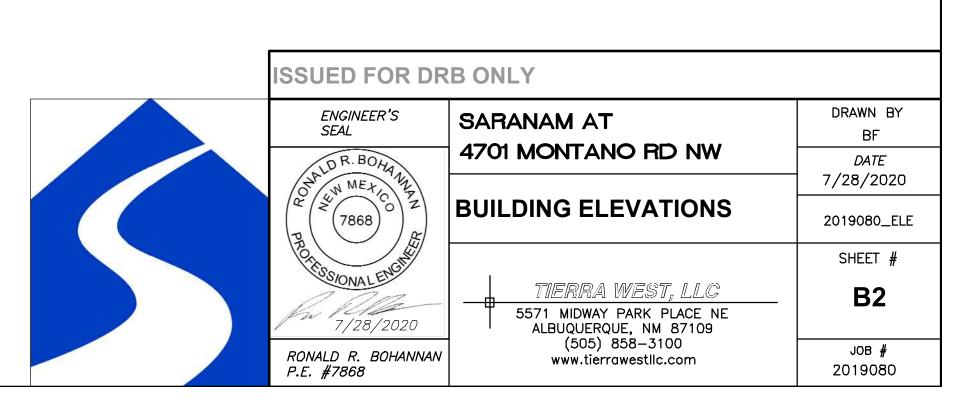



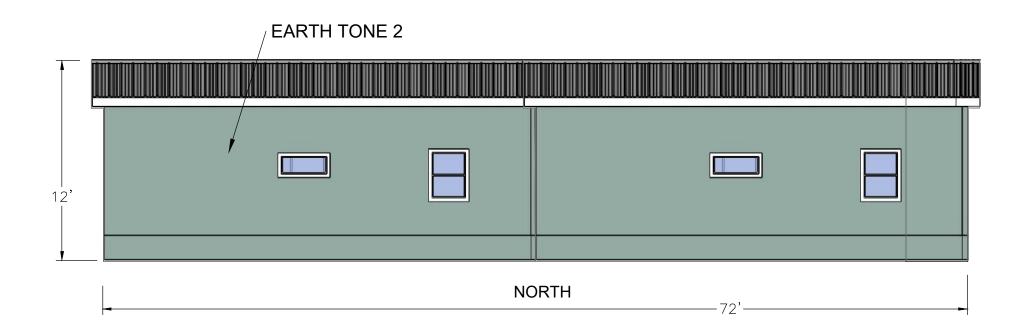

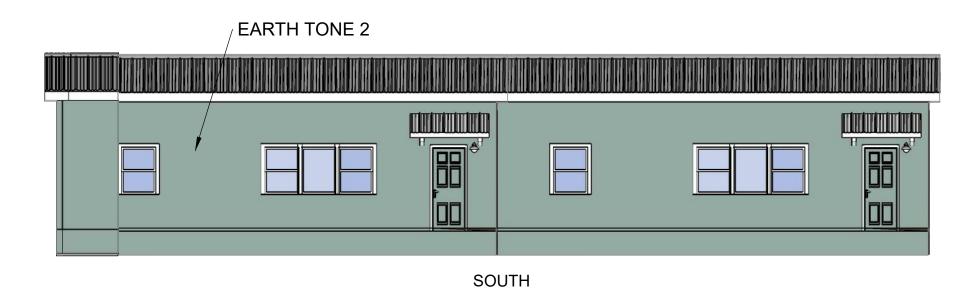


BUILDING NOTES


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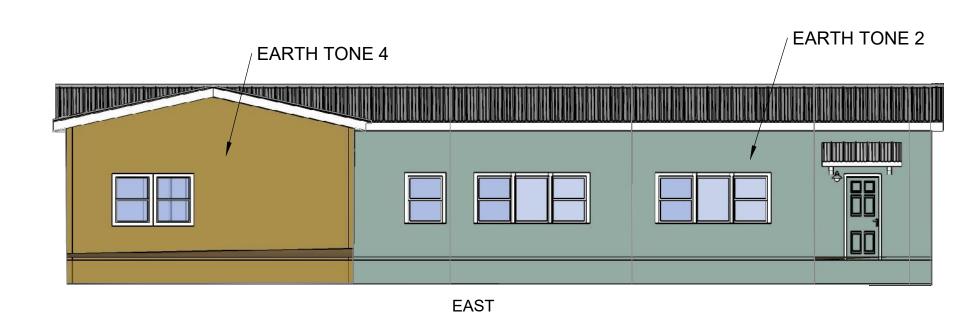
BUILDING COLORS


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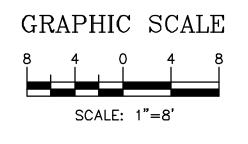
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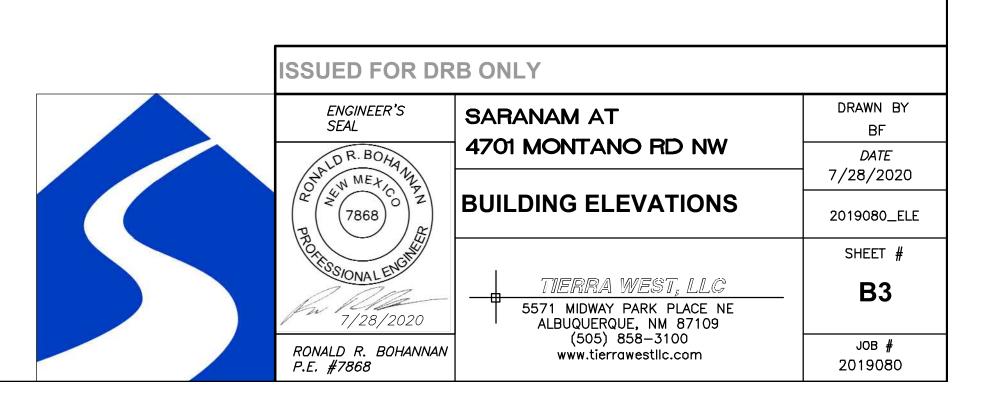






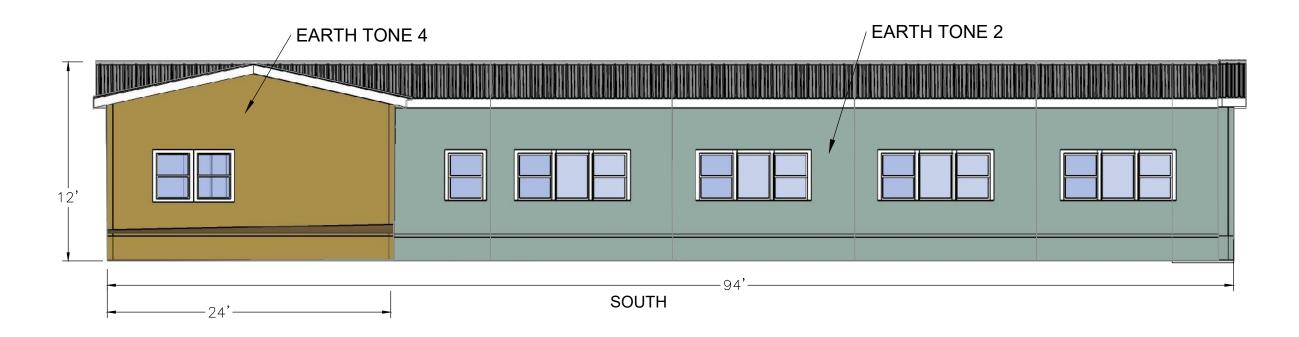

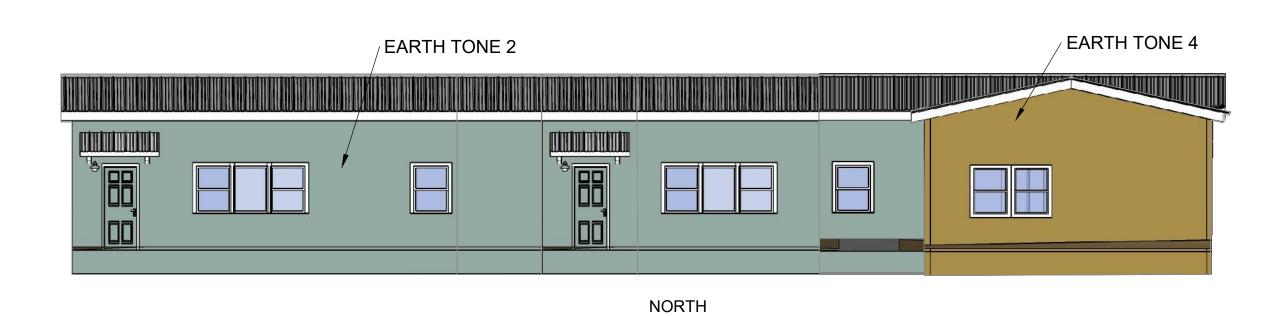


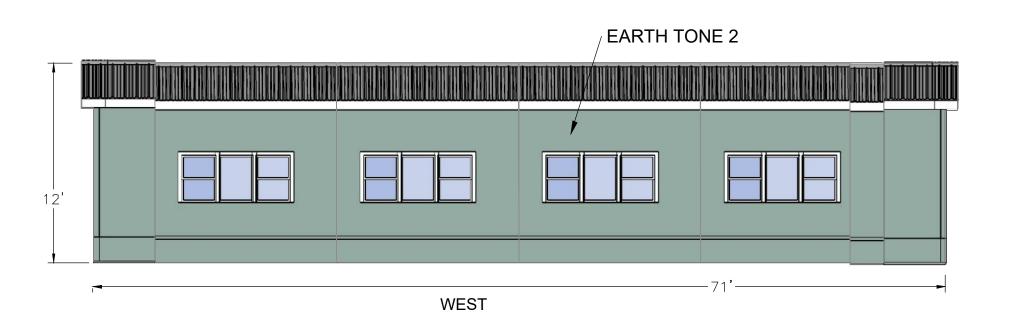


ACCESSORY BUILDING 3





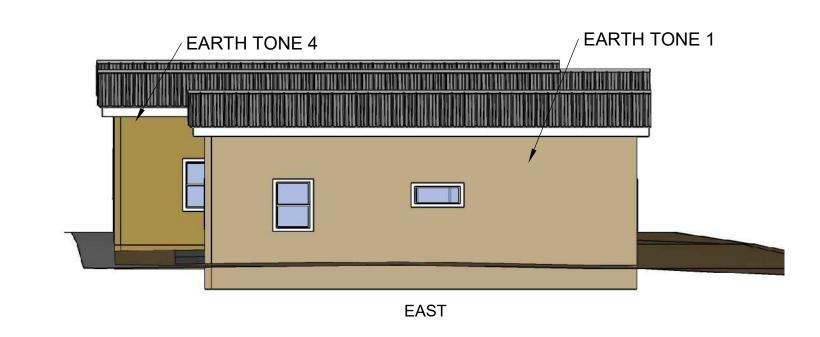

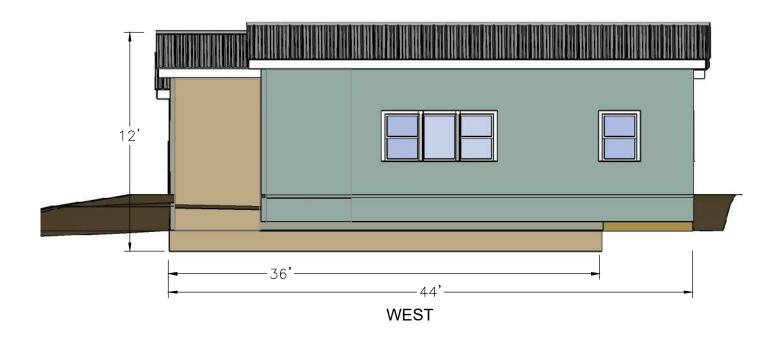

BUILDING NOTES

ALL BUILDINGS TO BE STUCCO FINISH
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BUILDING FRAME TO BE STEEL OR WOOD
WINDOW TRIM TO BE PAINTED WHITE AND WOOD OR SIMILAR MATERIAL

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GRAPHIC SCALE

8 4 0 4 8

SCALE: 1"=8'



19\2019080 Golf Course & Montano 25 Unit Home (Saranam)\dwg\EPC\2019080_ELE.d