


Architectural Site Plan

PROJECT DESCRIPTION:

THIS PROJECT IS NEW CONSTRUCTION OF A 2,000 SF NEW CLASSROOM BUILDING, ASSOCIATED SITE WORK AND LANDSCAPING, AND AN ADA ACCESSIBLE RAMP AND STAIRS. THE PROPOSED BUILDING WILL BE LOCATED NORTH OF AND ADJACENT TO AN EXISTING VOCATIONAL SCHOOL AND IS PART OF THE SCHOOL CAMPUS.

13 PARKING SPACES WILL BE REMOVED FOR THE ADDITION OF THE NEW BUILDING. THERE IS NO MODIFICATION TO THE EXISTING SITE OTHER THAN THE WORK ASSOCIATED WITH THE NEW CLASSROOM.

THE CAMPUS IS SITUATED IN THE PAVILIONS AT SAN MATEO, AN EXISTING RETAIL SHOPPING DISTRICT WITH A MIX OF RETAIL, RESTAURANT AND SERVICE TENANTS. EXISTING INFRASTRUCTURE INCLUDES STANDARD, COMPACT AND HC PARKING, EXISTING FIRE HYDRANTS, SIDEWALKS, BICYCLE SPACES, LOADING DOCK AND SOLID WASTE DUMPSTER.

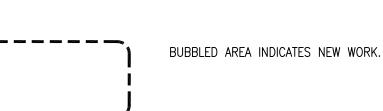

BUILDING ADDRESS: 4400 CUTLER AVE NE LEGAL DESCRIPTION:

ALBUQUERQUE, NM 87110 TR 1A REVISED PLAT OF PAVILIONS AT SAN MATEO CONT 4.2761 ACM/L OR 186,267 SF M/L

OCCUPANCY GROUP: B

IDO ZONING INFORMATION:

NR-C: COMMERCIAL ZONE DISTRICTS

SITE ACREAGE: 4.28 ACRES BUILDING GROSS SQUARE FOOTAGE:

EXISTING BUILDING: PROPOSED CLASSROOM TOTAL BUILDINGS:

THE PROPOSED CLASSROOM BUILDING SHALL BE COMPLETED UNDER ONE PHASE.

EXISTING RADIUS INFORMATION: | NEW RADIUS INFORMATION:

 $\langle 1 \rangle = 25' - 0" \quad \langle 3 \rangle = 21' - 6" \quad \langle 5 \rangle = 3' - 0"$ $\langle 2 \rangle = 23'-6" \langle 4 \rangle = 3'-0"$

- [A] THE PARKING LOT DIMENSIONS ARE FROM FACE OF CURB TO FACE OF CURB. LANDSCAPING AND SIGNING WILL NOT INTERFERE WITH CLEAR SIGHT REQUIREMENTS. THEREFORE, SIGNS. WALLS, TREES, AND SHRUBBERY BETWEEN 3 AND 8 FEET TALL (AS
- MEASURED FROM THE GUTTER PAN) WILL NOT BE ACCEPTABLE IN THIS AREA. [C] ANY ENCROACHMENT OR OVERHANG INTO THE ROW FROM SIGNS, FENCES, CANOPY,
- ROOF LINES, ETC. WILL REQUIRE AN ANNUAL REVOCABLE ENCROACHMENT PERMIT. [D] ALL CURBS SURROUNDING LANDSCAPING, SHALL PROVIDE WATER RUNOFF OPENINGS TO
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- AND AESTHETICS CREATED BY THE TWO BUILDINGS IN THIS SUBMITTAL.
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- L] GROUND-MOUNTED EQUIPMENT SCREENING WILL BE DESIGNED TO ALLOW FOR ACCESS TO UTILITY FACILITIES. ALL SCREENING AND VEGETATION SURROUNDING GROUND-MOUNTED TRANSFORMERS AND UTILITY PADS ARE TO ALLOW 10 FEET OF CLEARANCE IN FRONT OF THE EQUIPMENT DOOR AND 5-6 FEET OF CLEARANCE ON THE REMAINING THREE SIDES FOR SAFE OPERATION, MAINTENANCE, AND REPAIR

AND GUTTER PER COA STANDARD DETAILS 2430 AND 2415, RESPECTIVELY.

[M] ALL SITE LIGHTING IS EXISTING TO REMAIN 'AS IS'.

KEYED NOTES:

44,877 GSF

GENERAL NOTES:


EXISTING CITY SIDEWALK TO REMAIN.

- EXISTING CITY CURB AND GUTTER TO REMAIN. EXISTING PROPERTY LINE.
- NOT USED.
- PROPOSED HEADER CURB.
- EXISTING FIRE HYDRANT TO REMAIN.
- CITY REFUSE TRUCK AND TURNING RADIUS, FOR REFERENCE ONLY. NOT USED.
- PROPOSED ADA ACCESSIBLE RAMP.
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- PROPOSED MOTORCYCLE SPACES WITH SIGNAGE AT EACH SPACE, WITH 12" HIGH
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- PROPOSED PAINTED CURB 'FIRE LANE'.
- EXISTING TRASH COMPACTOR TO REMAIN.
- EXISTING LOADING DOCK TO REMAIN.
- EXISTING BICYCLE PARKING TO REMAIN.

ACCEPTABLE IN THE CLEAR SIGHT TRIANGLE.

- [19] EXISTING COMPACT PARKING SPACE TO REMAIN. [20] EXISTING SIDEWALK TO REMAIN.
- [21] EXISTING SIDEWALK RAMP TO REMAIN.
- [22] EXISTING ENTRY DRIVE TO REMAIN. EXISTING ASPHALT PARKING LOT TO REMAIN.
- [24] PROPOSED STAIR AND LANDING.
- [25] EXISTING PAINTED FIRE LANE TO REMAIN. [26] PROPOSED BIKE RACK WITH 6 SPACES. SEE DETAIL 1/A002.
- EXISTING CURB TO REMAIN.
- EXISTING HC. PARKING AND ACCESS AISLE TO REMAIN.
- EXISTING DESIGNATED CROSSWALK TO REMAIN. PROPOSED LANDSCAPE AREA.
- EXISTING 10' UTILITY EASEMENT. EXISTING 20' WATERLINE EASEMENT.
- [33] THESE SPACES NOT COUNTED IN PARKING CALCULATIONS AS THEY ARE OVER THE PROPERTY LINE.
- [34] EXISTING LANDSCAPE TO REMAIN.
- [35] EXISTING BUILDING SETBACK.
- [36] EXISTING ELECTRICAL EQUIPMENT TO REMAIN. [37] EXISTING TRANSFORMER TO REMAIN.
- [38] EXISTING SITE LIGHT TO REMAIN.


VICINITY MAP

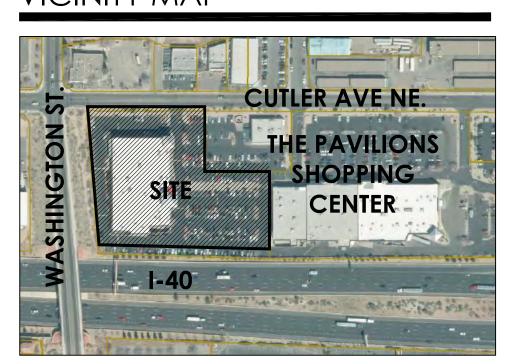

SITE

ZONING MAP



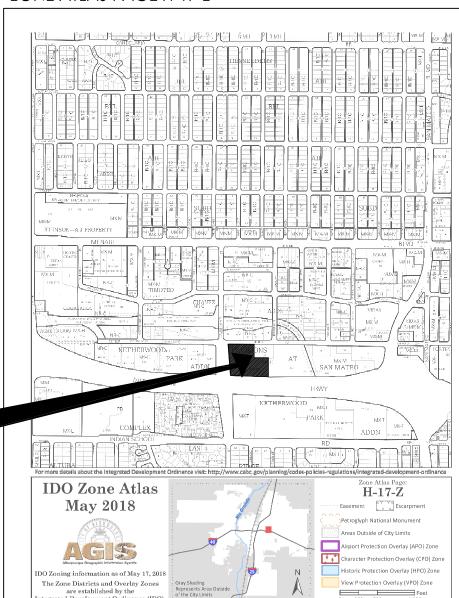

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Albuque

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MULLEN HELLER ARCHITE

1718 CENTRAL AVE SW

ALBUQUERQUE, NM | 8

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JOB NUMBER

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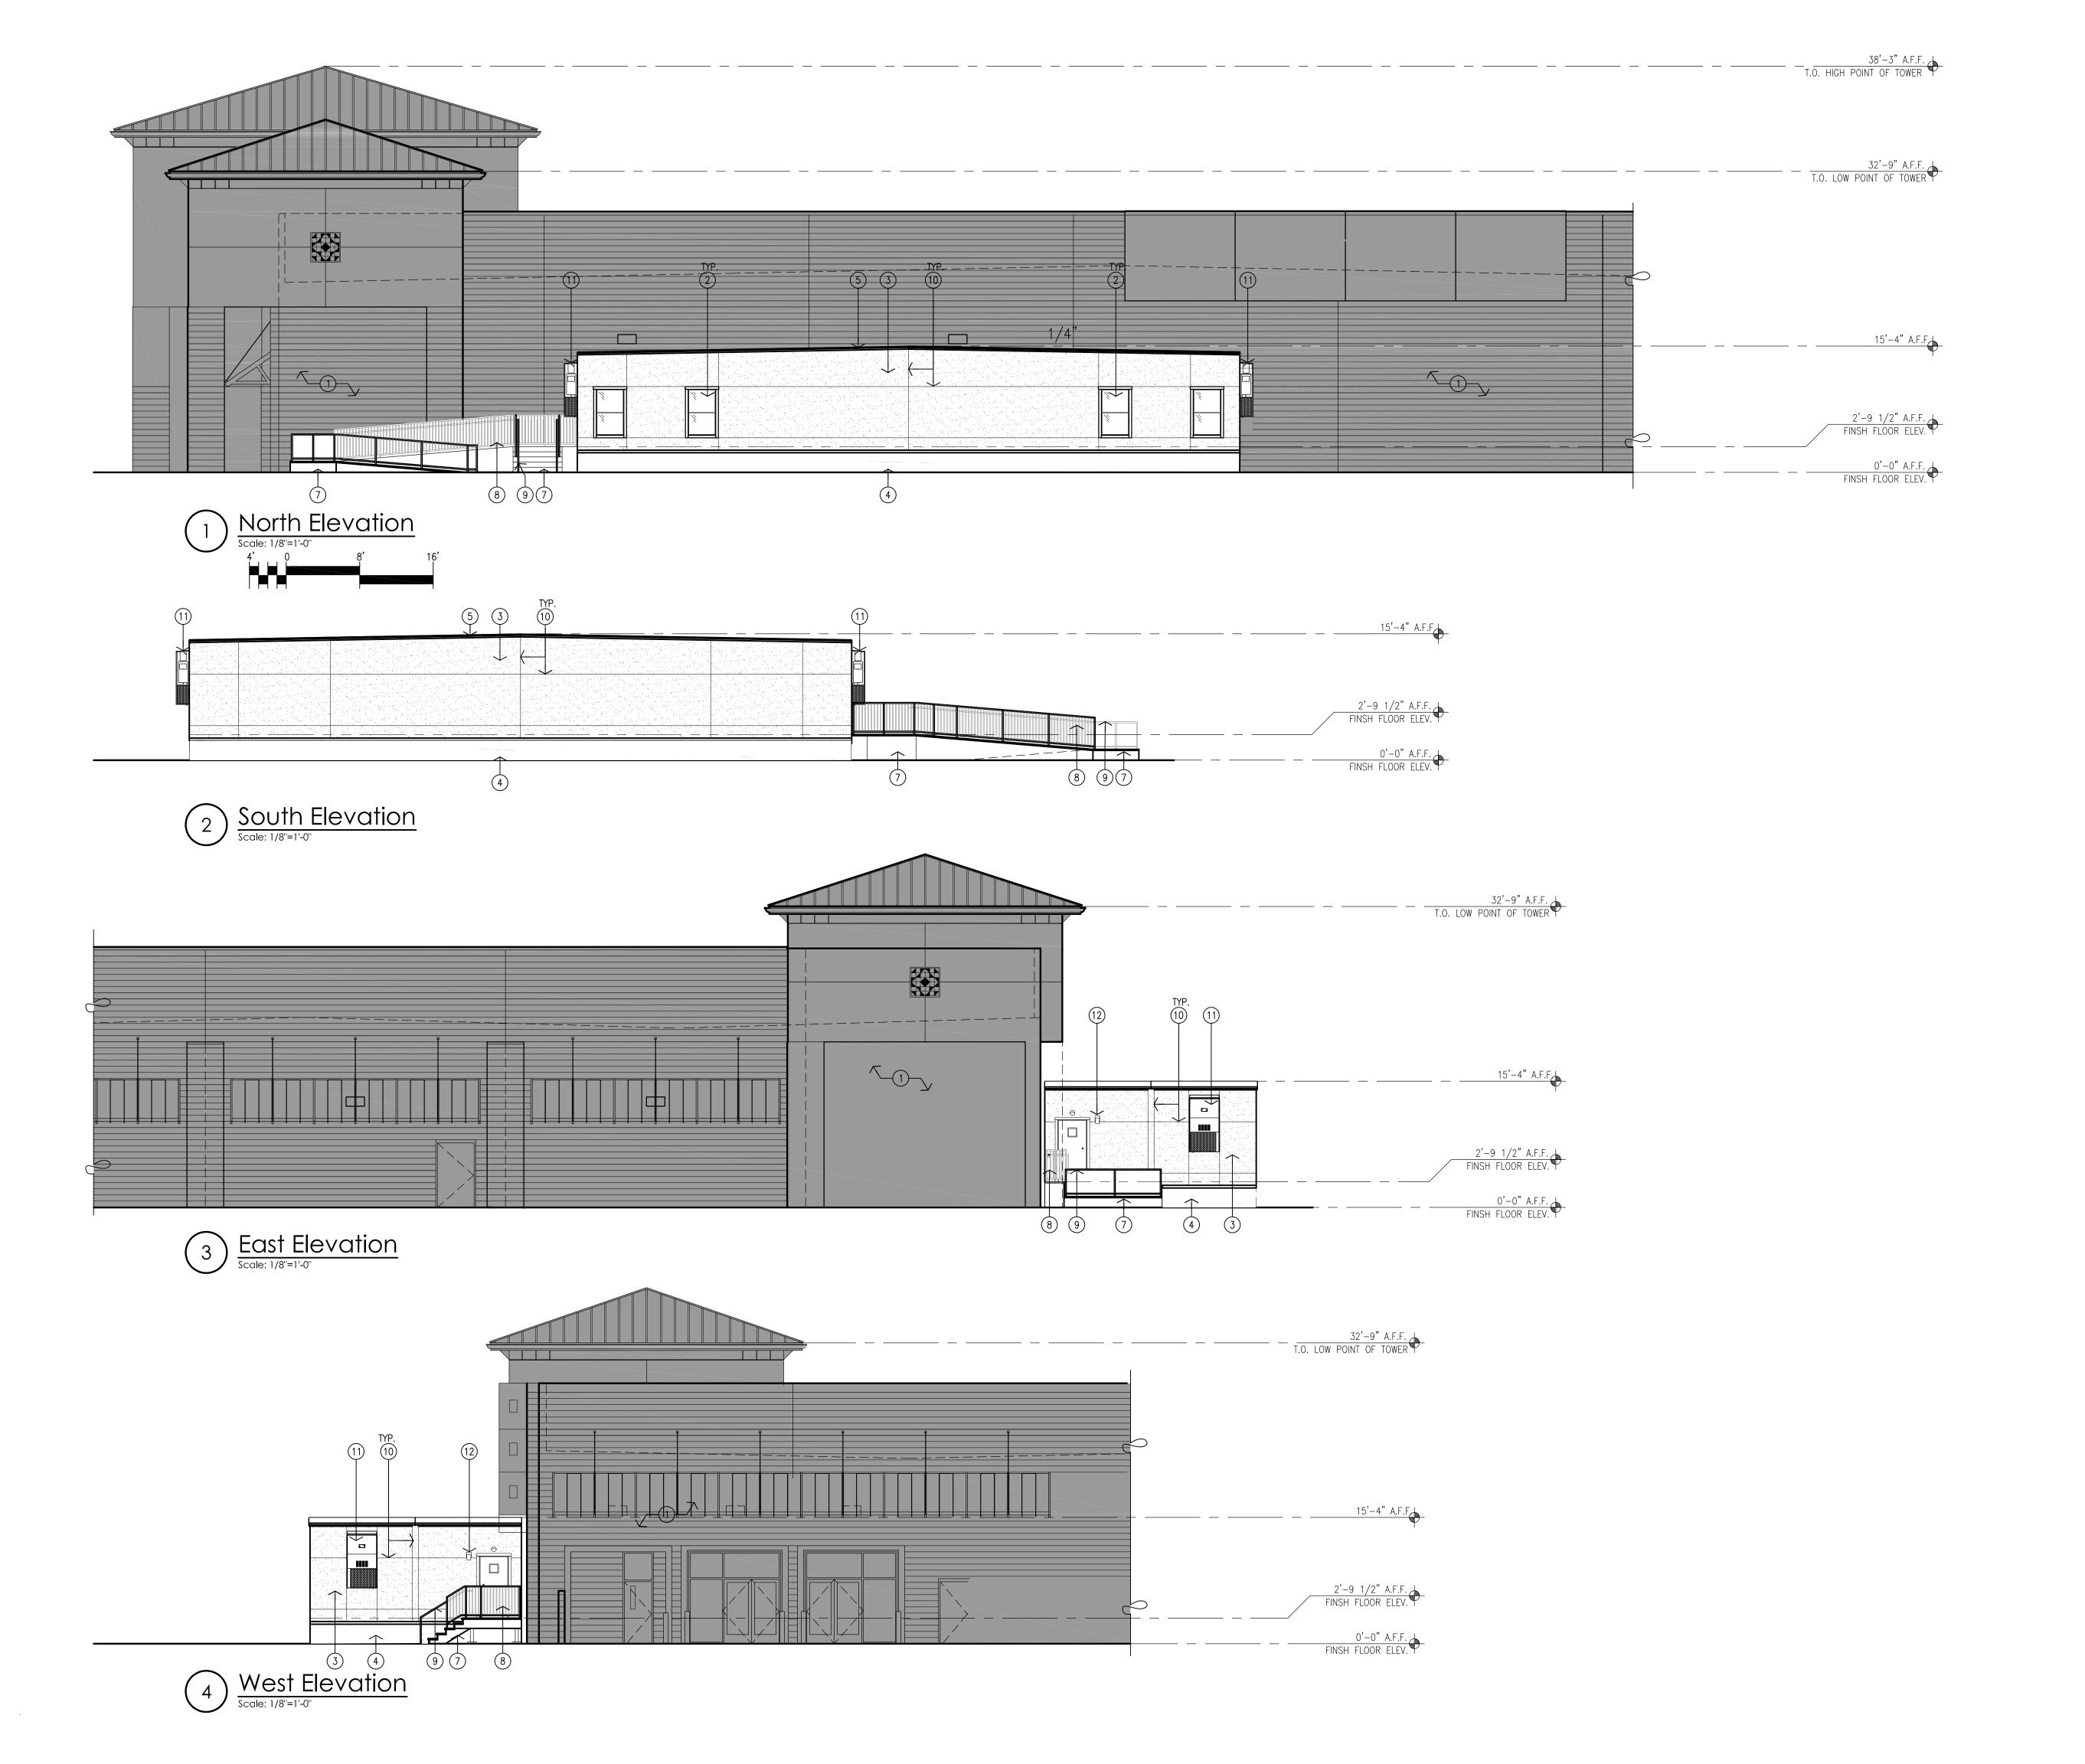
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PROJECT MGR

SHEET A001



[1] EXISTING EXTERIOR MASONRY WALL.

NEW WINDOW.

KEYED NOTES:

NEW STUCCO SYSTEM. COLOR TO MATCH EXISTING

[4] NEW WOOD SKIRTING COLOR TO MATCH EXISTING BUILDING NEW EPDM ROOFING SYSTEM.

NEW HOLLOW METAL DOOR AND TRIM.

NEW COMPOSITE DECKING STAIR AND RAMP SYSTEM.


NEW GUARDRAIL SYSTEM. NEW HANDRAIL SYSTEM.

0] NEW STUCCO CONTROL JOINT.

11] NEW MECHANICAL EQUIPMENT. REFER TO MECHANICAL.

[12] NEW WALL PACK.

THERE IS NO NEW SIGNAGE PROPOSED FOR THIS PHASE OF THE PROJECT

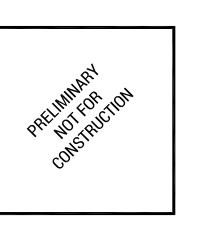

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AG/MP DRAWN BY PROJECT MGR JDH

04-13-22 DATE PHASE CD

Building Classroom

PROJECT
Pima Medical Institute New 4400 Cutler Ave. NE Albuquerque, NM 87110 Exterior Elevations

SHEET A401 UTILITY EASEMENT

THIS PROJECT IS NEW CONSTRUCTION OF A 2,000 SF NEW CLASSROOM BUILDING, ASSOCIATED SITE WORK AND LANDSCAPING, AND AN ADA ACCESSIBLE RAMP AND STAIRS. THE PROPOSED BUILDING WILL BE LOCATED NORTH OF AND ADJACENT TO AN EXISTING VOCATIONAL SCHOOL AND IS PART OF THE SCHOOL CAMPUS.

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EXISTING FIRE HYDRANTS, SIDEWALKS, BICYCLE SPACES, LOADING DOCK AND SOLID WASTE DUMPSTER.

CODE DATA FOR THE PROPOSED CLASSROOM

FIRE FLOW CALCULATIONS: LEGAL DESCRIPTION: TR 1A REVISED PLAT OF PAVILIONS AT SAN MATEO CONT 4.2761 ACM/L OR 186,267 SF M/L UPC: 101705929110840209 CONSTRUCTION TYPE: V-B OCCUPANCY GROUP: OCCUPANT LOAD: PER IBC 2015, TABLE 1004.1.2 NEW MODULAR BUILDING TOTAL OCCUPANTS: OCCUPANCY PER IBC 2015 TABLE 508.4: TYPE "B" - NOT REQUIRED DISTRIBUTION: SEPARATION:

FIRE HYDRANT PER 2015 IFC: APPENDIX B, TABLE C105.1

> 3 EXISTING FIRE HYDRANTS PROVIDED AVERAGE SPACING BETWEEN HYDRANTS SHALL BE 500 FEET

MAXIMUM DISTANCE FROM ANY POINT ON STREET OR ROAD FRONTAGE TO HYDRANT SHALL BE <u>250 FEET</u>

1 FIRE HYDRANT REQUIRED PER APPENDIX C (1,500 GPM FIRE FLOW)

FIRE ACCESS ROAD

GALLONS/MINUTE)

ACCESS ROAD SHALL NOT EXCEED 10% IN GRADE.

PER 2015 IFC: APPENDIX B, TABLE B105.1

PROPOSED CLASSROOM BUILDING: V-B @ 2,000 SF

TOTAL BUILDING FIRE FLOW = 1,500 GALLONS/MINUTE

EXISTING VOCATIONAL SCHOOL BUILDING: II-B @ 44,877 SF

= 1,125 GALLONS/MINUTE (WITH REDUCTION) - UNDER MIN.

= 1,500 GALLONS/MINUTE (2 HOUR DURATION)

(NO REDUCTION FOR FIRE SPRINKLER SYSTEM)

= 4,500 GALLONS/MINUTE (4 HOUR DURATION)

= 1,500 GALLONS/MINUTE (2 HOUR DURATION)


ACCESS ROAD TO BE CONSTRUCTED OF ASPHALT MATERIAL CAPABLE OF SUPPORTING THE IMPOSED LOAD OF A FIRE APPARATUS WEIGHING AT LEAST 75,000 POUNDS

(75% REDUCTION FOR FIRE SPRINKLER SYSTEM BUT SHALL NOT BE LESS THAN 1,500

ZONING MAP VICINITY MAP



ZONE ATLAS PAGE H-17-Z IDO Zone Atlas May 2018

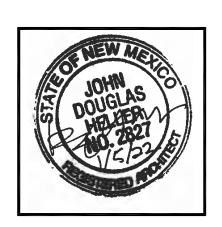

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DRAWN BY PROJECT MGR

DATE 01-05-22 PHASE

Building \mathbb{H}_0 $\frac{C}{a}$ Institute NE 87110

Medical Cutler Ave. erque, NM

SHEET FIRE

Fire Safety Site Plan

PROPOSED CLASSROOM

BUILDING 2,000 GSF

NON-SPRINKLERED

CUTLER AVE. N. E.

EXISTING VOCATIONAL SCHOOL 44,877 GROSS SF (FULLY SPRINKLERED)

Fire truck - COA

NEW PAINTED FIRE LANE ALONG NEW

50'

- DISTANCE TO

EXISTING HYDRANT

BUILDING ADDRESS: 4400 CUTLER AVE NE ALBUQUERQUE, NM 87110

2,000 GROSS SF 2,000 GROSS SF SQUARE FOOTAGE: NEW MODULAR BUILDING: TOTAL BUILDING:

BUILDING HEIGHT: 20'-0" ABOVE FINISH FLOOR LEVEL.

FIRE PROTECTION: NON-SPRINKLERED

FIRE SEPARATION: NO FIRE SEPARATION REQUIRED.

REQUIREMENTS:


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4400 CUTLER AVE NE



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prior to Certificate of Occupancy, please have the city sidewalk easement in place as requested by Mr. Salgado.

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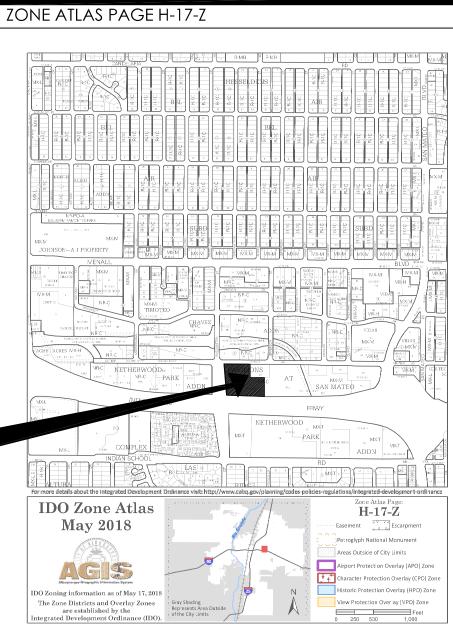
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- 36] EXISTING ELECTRICAL EQUIPMENT TO REMAIN. 37] EXISTING TRANSFORMER TO REMAIN.
- [38] INSTALL TRUNCATED DOMES ON EXISTING CURB RAMPS PER COA STANDARD DETAIL #2446.
- [39] NEW 6' WIDE DESIGNATED CROSSWALK.

VICINITY MAP

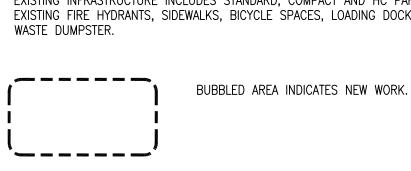

SITE '

ZONING MAP



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MULLEN HELLER ARCHITECTURE

1718 CENTRAL AVE SW | STE. D

ALBUQUERQUE, NM | 87109

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AG/MP

04-26-22

JOB NUMBER

PROJECT MGR

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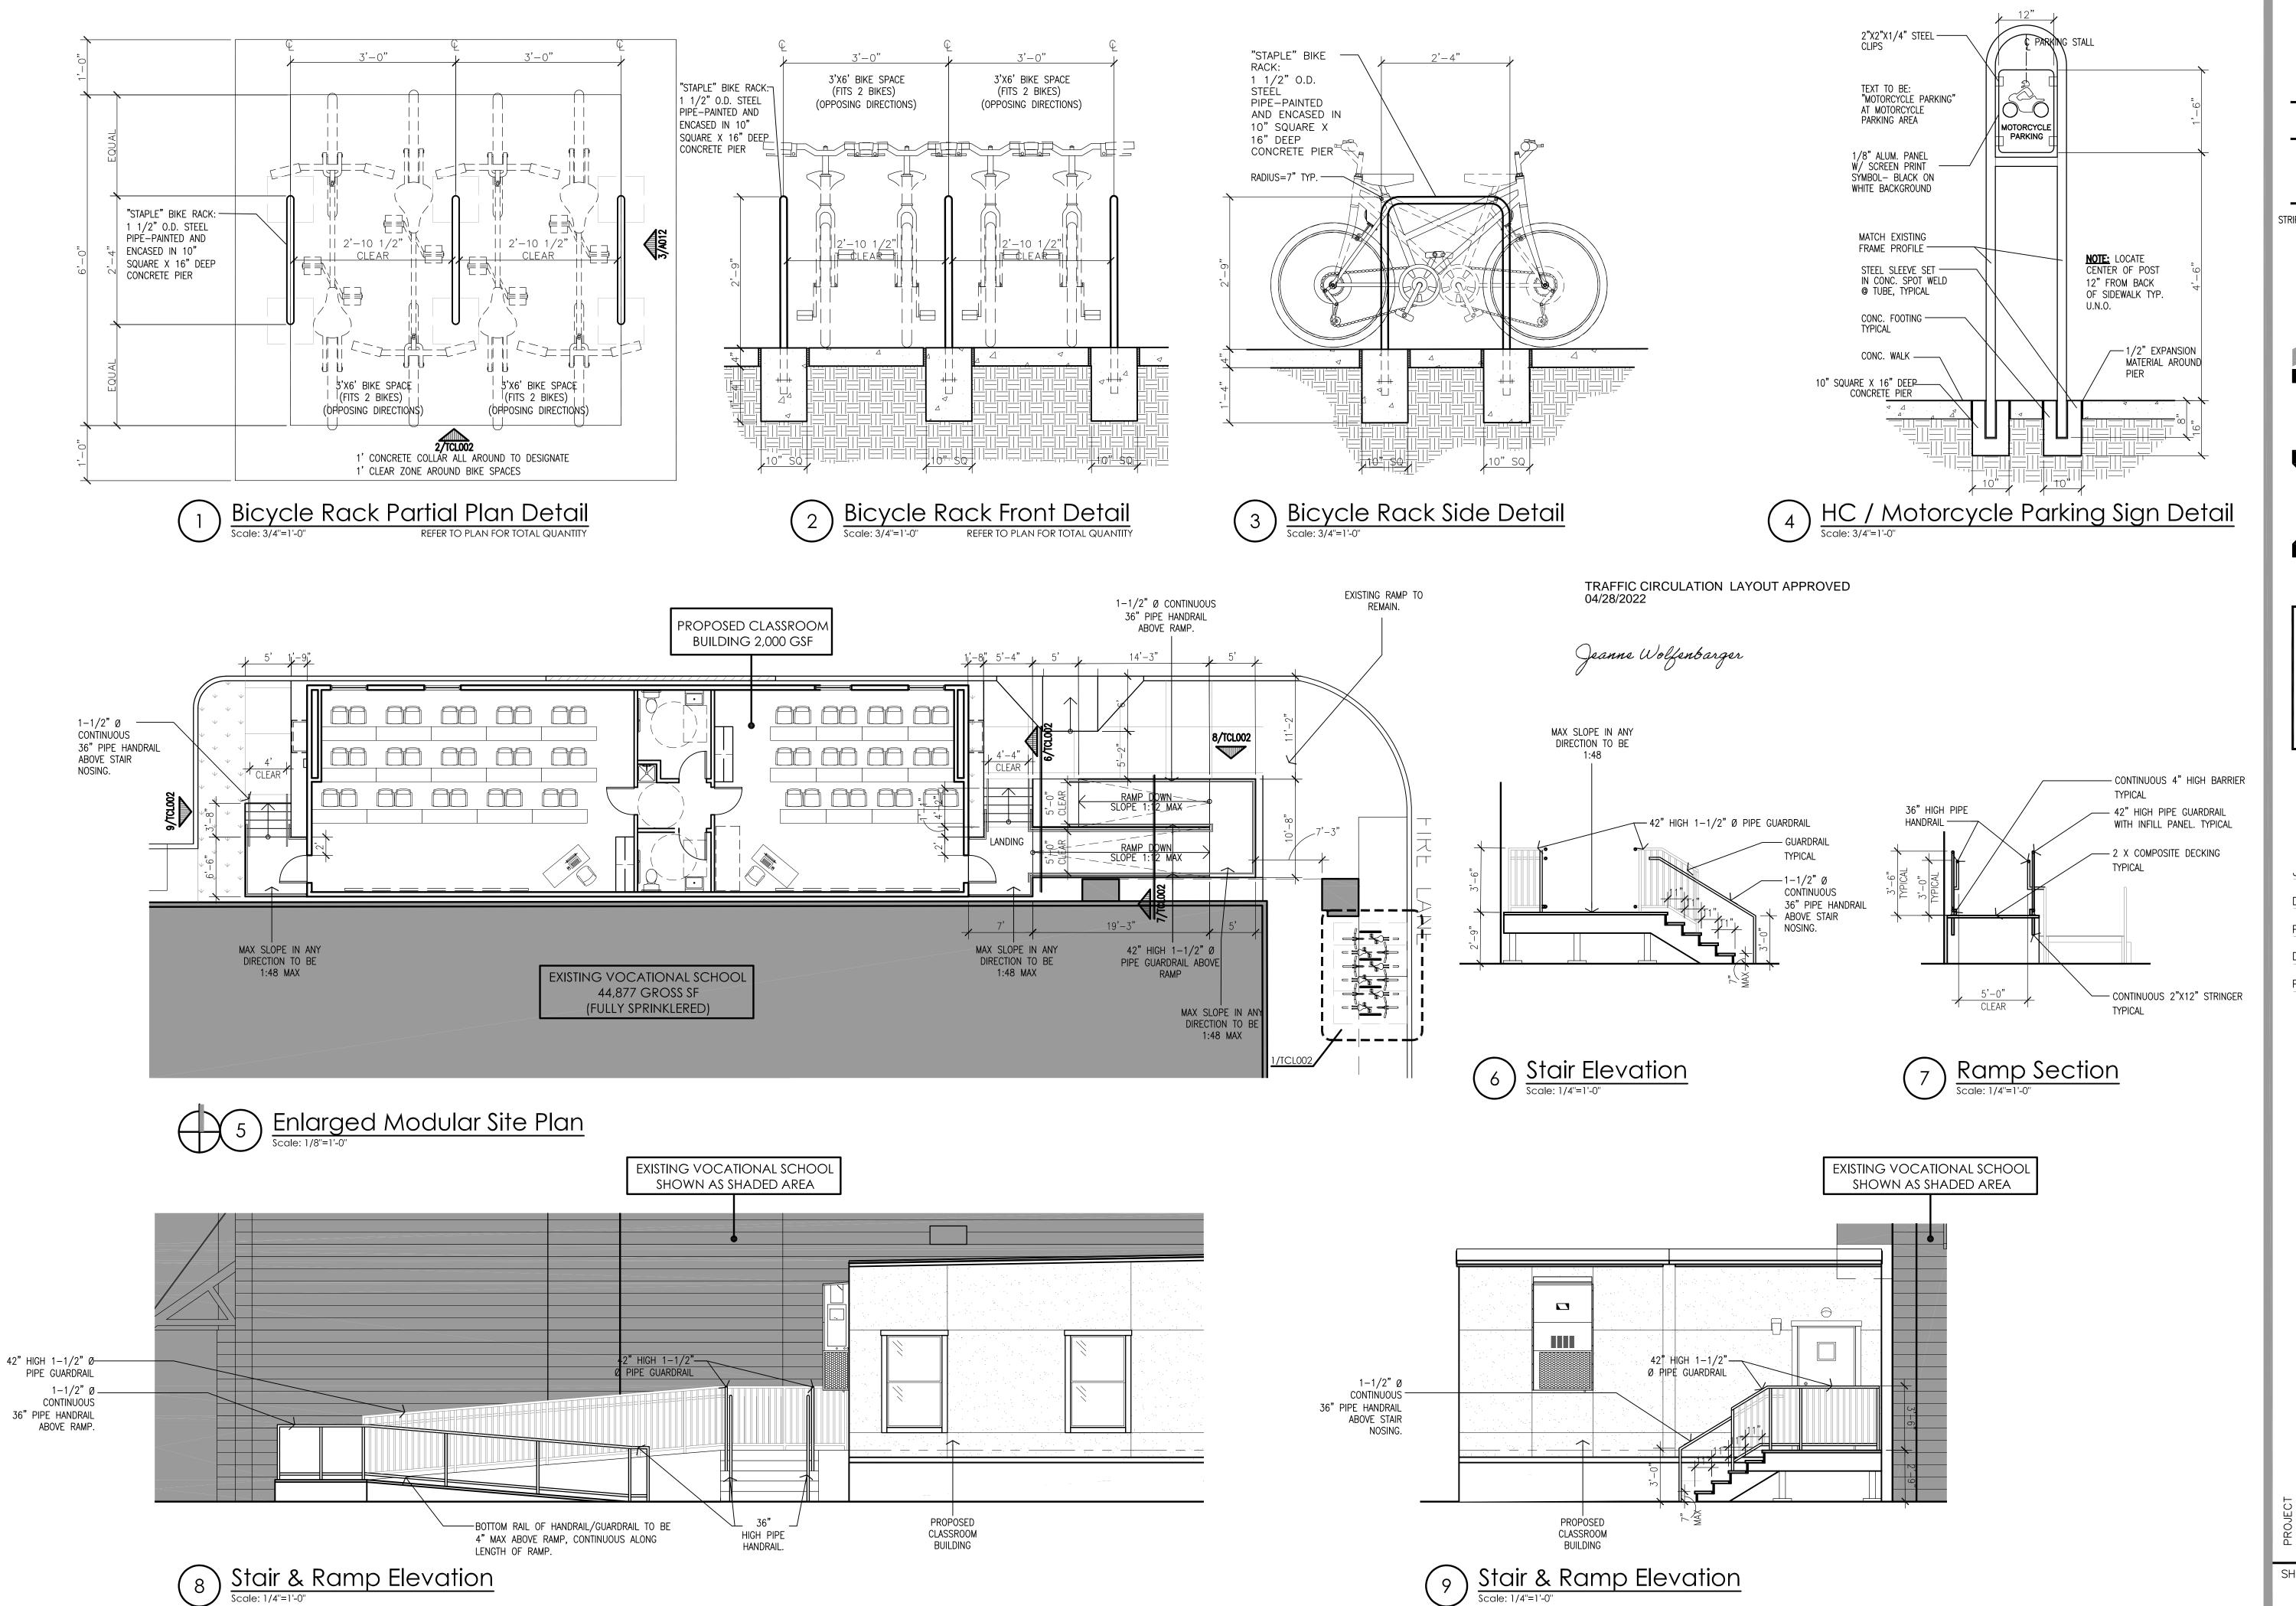
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20-08 JOB NUMBER AG/MP DRAWN BY PROJECT MGR 04-26-22


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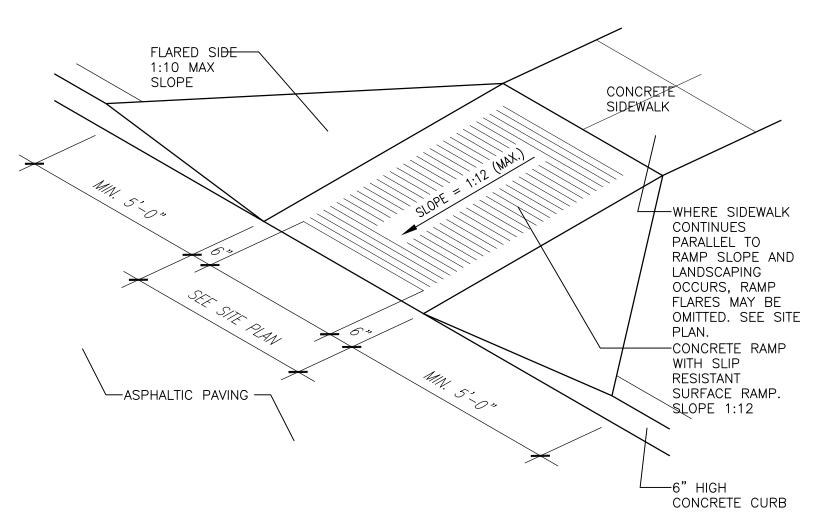
Building Classroom

 e^{M} Institute NE 87110 Medical Cutler Ave.


TCL002

Jeanne Wolfenbarger



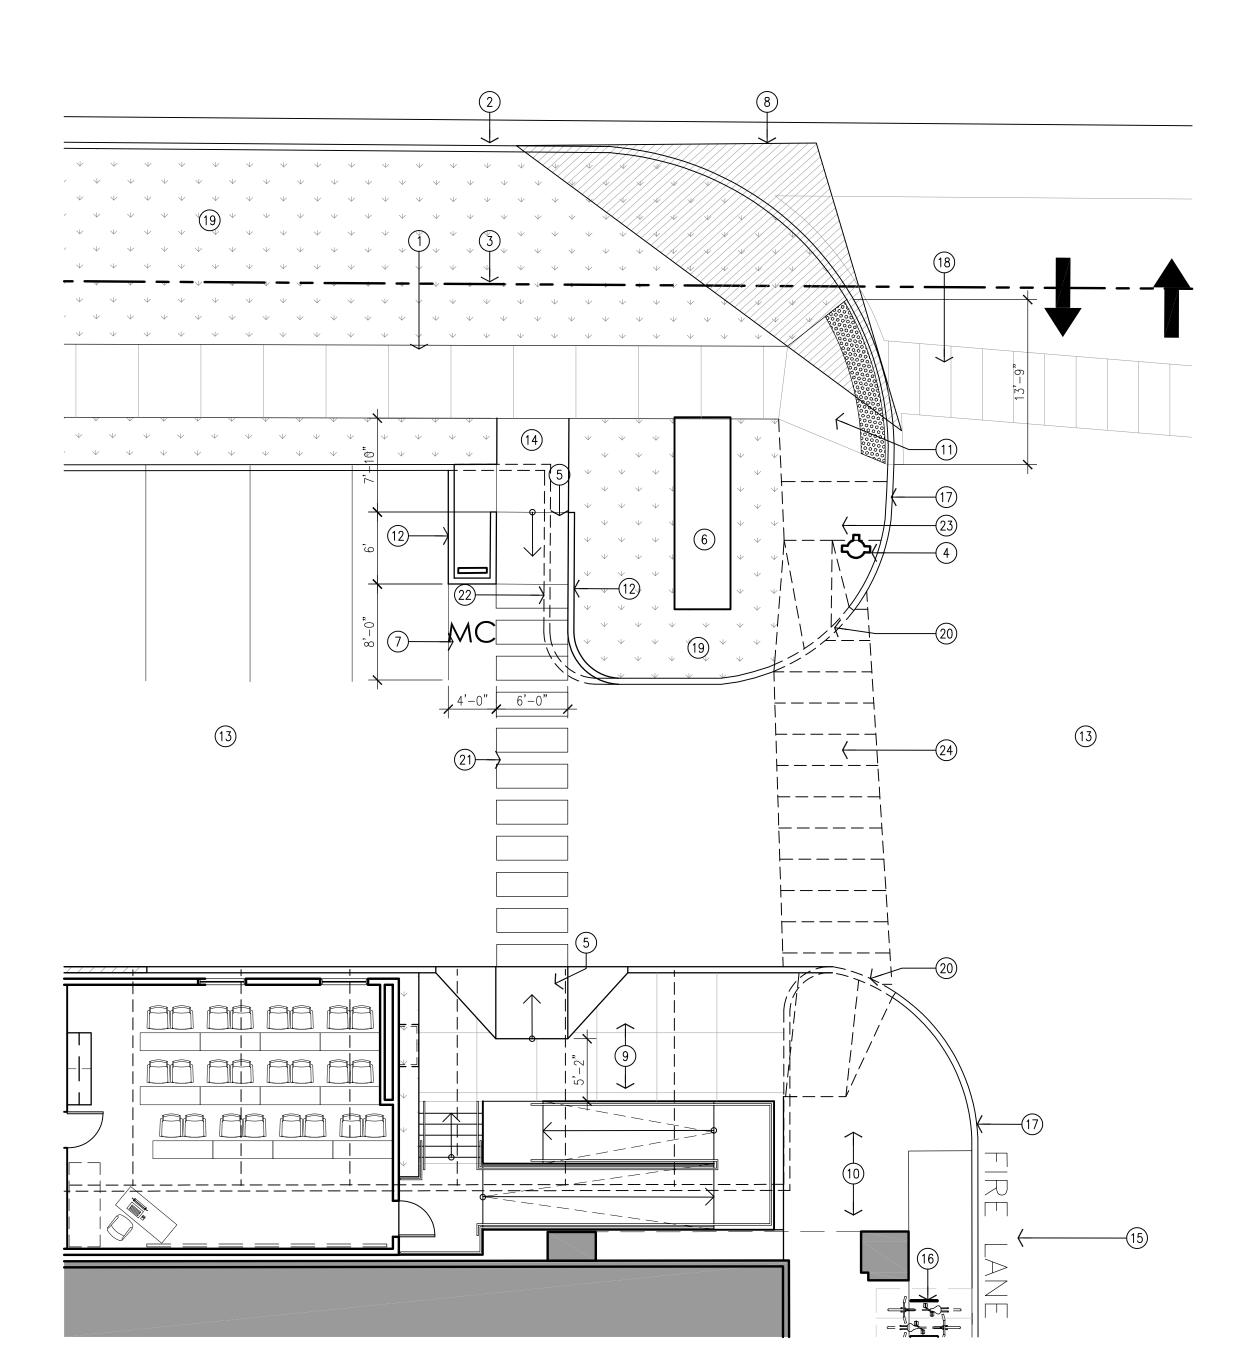

2 H.C. Ramp Detail
Scale: Not To Scale (Isometric) FOR INFORMATION ONLY

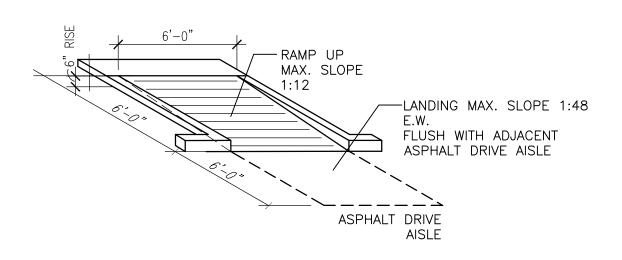

H.C. Ramp Details

Scale: Not To Scale (Isometric)

EXISTING PROPERTY LINE.

EXISTING FIRE HYDRANT TO REMAIN.

EXISTING SIGN TO REMAIN.

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[11] EXISTING CURB RAMP TO REMAIN. INSTALL TRUNCATED DOMES PER COA STANDARD DETAIL

[14] NEW 6'-0" WIDE CONCRETE SIDEWALK CONNECTION FROM CITY SIDEWALK.

[15] EXISTING PAINTED FIRE LANE TO REMAIN.

[17] EXISTING CURB TO REMAIN.

[19] EXISTING LANDSCAPE TO REMAIN.

[20] EXISTING SIDEWALK RAMP TO BE REMOVED AND REPLACED WITH NEW CONCRETE CURB.

[22] REMOVE PORTION OF CURB.

[23] REMOVE CONCRETE PAVING AND INSTALL LANDSCAPING.

[24] REMOVE CONCRETE PAVING. PATCH WITH ASPHALT PAVING.

KEYED NOTES:

[1] EXISTING CITY SIDEWALK TO REMAIN. EXISTING CITY CURB AND GUTTER TO REMAIN.

PROPOSED ADA ACCESSIBLE RAMP. SEE 2 AND 3/TCL003.

WITH EXPANSION JOINTS EVERY 20'-0".

[10] EXISTING SIDEWALK TO REMAIN.

#2446. CROSSWALK SLOPE 2% MAX AND RUN SLOPE 8.3% MAX.

[12] PROPOSED CONCRETE CURB. [13] EXISTING ASPHALT PARKING LOT TO REMAIN.

[16] PROPOSED BIKE RACK WITH 6 SPACES. SEE DETAIL 1/TCL002.

[18] EXISTING DESIGNATED CROSSWALK TO REMAIN.

[21] PROPOSED DESIGNATED CROSSWALK.

JOHN DOUGLAS HELLER NO. 2827 MULLEN HELLER ARCHITECTURE

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JOB NUMBER 20-08 AG/MP DRAWN BY

PROJECT MGR 04-26-22 DATE

PHASE CD

m00.

SSL

Building

 $\frac{C}{a}$ e^{M} Institute NE 87110

Medical Cutler Ave. Jerque, NM

TCL003

MISCELLANEOUS NOTES (MN1) Bearings are grid based on NM State Plane Coordinate System Central Zone, NAD83 datum. Distances are ground. Bearings and distances shown in parentheses are record data. MN2 All property corners were found as shown hereon. MN3 No evidence of recent earth moving work, building construction, or building additions was observed during the field inspection of the subject property on 11/3/2017. (MN4) No information was available to the surveyor regarding any proposed changes in street right of way lines. No evidence of recent street or sidewalk construction or repairs was observed during the field inspection of the subject property on 11/3/2017. (MN5) The subject property has direct physical access to and from Cutler Avenue N.E, a dedicated public **CUTLER AVENUE N.E.** right-of-way owned and maintained by the City of Albuquerque. (60' DEDICATED PUBLIC R.O.W.) OWNER: CITY OF ALBUQUERUQE (MN6) The address of the subject property is 4400 Cutler Avenue N.E., Albuquerque, NM 87110. The address was observed in the field. The number of striped parking spaces located on the subject property is 282, including 8 handicap LANDSCAPED 5' FRONT SETBACK □ S 89°35'36" E. 346.57' MN8 No cemeteries, gravesites, and burial grounds were (i) disclosed in the record documents provided to the surveyor, or (ii) observed in the process of conducting the survey of the subject property on No evidence of any wetlands located or marked on the subject property was observed during the field inspection of the subject property on 11/3/2017. (MN10) The subject property contains 186,148 square feet, 4.2734 acres, more or less. PAVILIONS AT SAN MATEO OWNER: SAN MATEO STATION LLC C/O PHILLIPS EDISON & COMPANY LTD PAVED STREET 4400 CUTLER AVENUE N.E. 1-STORY COMMERCIAL BUILDING FOOTPRINT = 45,412 SQ. FT. PARCEL 1 -TRACT 1A TRACT 3A-1 PAVILIONS AT SAN MATEO OWNER: SAN MATEO STATION LLC C/0 PHILLIPS EDISON & COMPANY LTD 20' W/L EASMT. FND. T-RAIL ROW MARKER (96C-453) (11) N 87°53'40" W, 502.72' (N 87°53'11" W, 502.67') **INTERSTATE 40** (DEDICATED PUBLIC R.O.W., WIDTH VARIES, ACCESS CONTROLLED) OWNER: STATE OF NEW MEXICO

LEGEND OF SYMBOLS & ABBREVIATIONS

- ★ BUILDING MEASUREMENT SPOT SMH MANHOLE
- → INGRESS/EGRESS ☐ TR TRANSFORMER PAD X LT LIGHT POLE
- O WM WATER METER IIIDI DROP INLET WATER VALVE
- WCR WHEEL CHAIR RAMP □ EB ELECTRIC BOX □ EM ELECTRIC METER

OT TELEPHONE MANHOLE

- L HANDICAP PARKING SPACE ¤FP FLAG POLE
- TUP UTILITY POLE OVERHEAD LINES
- ---- A ANCHOR 10 P.S. PARKING SPACE COUNT

UTILITY NOTE

- Location of underground utilities is approximate only and is based on location of surface appurtenances of underground utilities. Other utilities exist that are not shown. No utility maps or plans were provided to the surveyor by the client or the owner of the subject property.
- Based on observed evidence and previous survey, electric, gas, sanitary sewer, water lines, storm drain and telephone/communication services are available for the subject property within the public roads rights-of-ways and within utility easements shown hereon.

SIGNIFICANT OBSERVATIONS

A No encroachments or other significant observations were observed during the field inspection of the subject property on 11/3/2017.

FLOOD NOTE

The subject property is located within an area having a Zone Designation "X" by the Federal Emergency Management Agency, on Flood Insurance Rate Maps No. 35001C0351H and 35001C0352H, with dates of identification of 8/16/2012, for Community Number 350002 (City of Albuquerque), in Bernalillo County, State of New Mexico, which are the current Flood Insurance Rate maps for the community in which said Property is

| PROJECT REVISION RECORD | | | | | |
|-------------------------|-------------------------------|-------------|----------------|------------------------|-------------------|
| ATE | С | DESCRIPTION | DATE | DESCRIPTION | |
| 2017 | First Draft | | 11/14/2017 | Revised Setbacks - 28' | |
| 2017 | Added Zoning Report, Setbacks | | | | |
| 3/2017 | Revised Setbacks | | | | |
| D WORK: VJ | | DRAFTED: ZS | CHECKED BY: VJ | | FB & PG: 20131/48 |

ZONING INFORMATION

Zoning data obtained from Zoning Report #7201701583:001 dated 11/7/2017 prepared by Bock & Clark

Address: 4400 Cutler Avenue N.E., Albuquerque, NM

Jurisdiction: City of Albuquerque Zoning Destrict: C-3 (Highway Commercial)

Adjacent Property Zoning: North, East and West - C-3 Highway Comercial District; South - Interstate 40

Setbacks: Front/Corner Side - 5 feet, and 11 feet from junction of a driveway or alley and a public sidewalk Different setbacks apply near residential zones - not applicable to the subject property Maximum Building Height - 26 feet at any legal location, heights over 26 feet shall fall within 45° angle planes drawn from internal boundaries and centerlines of public right-of-ways (Surveyor's Note - per clarification from Code Compliance Administrator, City of Albuquerque Planning Department, all setbacks from property lines are equal to building height)


Minimum lot area: No requirement Minimum lot width: No requirement Minimum lot depth: No requirement

Maximum lot coverage: No requirement Maximum floor area ratio: No requirement

Parking formula: 1 space for each two seats or two students and employee stations

LEGAL

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ITEMS CORRESPONDING TO SCHEDULE B-II

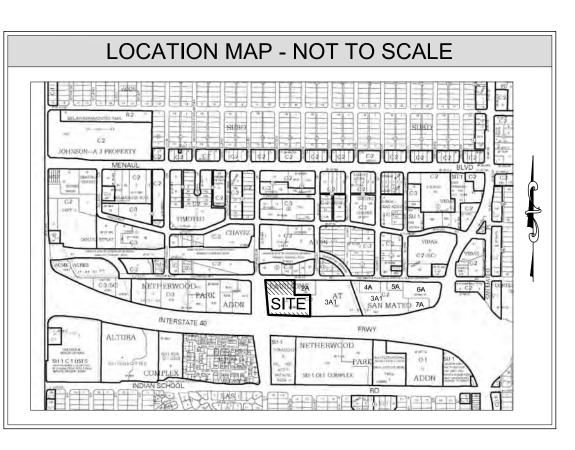Commitment for title insurance No. 1707036 dated 9/7/2017 by Old Republic National Title Insurance Company

- Items 1-9, 13-15 are standard exceptions or items not related to surveying and survey matters.
- (10) Easement, and rights incident thereto, reserved in the Judgment recorded February 14, 1972 in Book Misc 248, Page 9 as Document No. 70382, records of Bernalillo County, New Mexico. Not located on the subject property. Not plotted.
- (11) Easements, maintenance responsibilities and notes as shown, noted and provided for on the Redivision Plat recorded November 5, 1996 in Plat Book 96C, Page 453, records of Bernalillo County, New Mexico. Easements plotted.
- (12) Reciprocal Easement Agreement by and between Pavilion Partners, L.L.C., an Arizona limited liability company, and Washburn Piano Co., an Arizona corporation, recorded February 15, 2000 in Book A2, Page 5054 as Doc. No. 2000015129, as amended by First Amendment to Reciprocal Easement Agreement by and between S/W Albuquerque, L.P. a Texas limited partnership, and Herhode Development, LLC, an Arizona limited liability company, recorded March 31, 2010 as Doc. No. 2010027116, records of Bernalillo County, New Mexico. Blanket easement affecting Tracts 1A, 2A, 3A1, 4A, 5A, 6A and 7A of the Pavilions at San Mateo development. Not plottable. Not plotted. See location map for all tracts.

RECORD DESCRIPTION

Tract "1A", Revised Plat of Pavilions at San Mateo, Albuquerque, New Mexico, as the same is shown and designated on the Plat thereof, filed in the office of the County Clerk of Bernalillo County, New Mexico, on November 5, 1996, in Plat Book 96C, Page 453.

A non-exclusive appurtenant easement as described in that Reciprocal Easement Agreement by and between Pavilion Partners, L.L.C., an Arizona limited liability company, and Washburn Piano Co., an Arizona corporation, dated February 15, 2000, recorded February 15, 2000 in Book A2, Page 5054 as Doc. No. 2000015129, as amended by First Amendment to Reciprocal Easement Agreement by and between S/W Albuquerque, L.P. a Texas limited partnership, and Herhode Development, LLC, an Arizona limited liability company, dated March 30, 2010, recorded March 31, 2010 as Doc. No. 2010027116, records of Bernalillo County, New Mexico.

The above legal description describes the same parcel of land as described in the commitment for title insurance No. 1707036 dated 9/7/2017 by Old Republic National Title Insurance Company.

ALTA/NSPS LAND TITLE SURVEY

PIMA

B&C Project No. 201703519/Site 1 4400 Cutler Avenue N.E., Albuquerque, NM 87110

Based upon Old Republic National Title Insurance Company Commitment No. 1707036 bearing an effective date of September 7, 2017

Surveyor's Certification

To: Broadstone PMI Portfolio, LLC; Vaisey Nicholson & Nearpass PLLC; Broadstone Net Lease Acquisitions, LLC; Old Republic National Title Insurance Company; and Bock & Clark Corporation


This is to certify that this map or plat and the survey on which it is based were made in accordance with the 2016 Minimum Standard Detail Requirements for ALTA/NSPS Land Title Surveys, jointly established and adopted by ALTA and NSPS, and includes Items 1, 2, 3, 4, 6a, 6b, 7a, 7b1, 7c, 8, 9, 13, 14, 16, 17, 18, and 20 of Table A thereof. The field work was completed on November 3, 2017.

Vladimir Jirik Registration No. 10464 in the State of New Mexico Date of Survey: 11/6/2017 Date of Last Revision: 11/14/2017

Bock & Clark NSN Project No. 201703519/1

Survey Performed by: Professional Surveying LLC P.O. Box 94595, Albuquerque, NM 87199 1102 Marigold Drive N.E., Albuquerque, NM 87122 Phone: 505.892.4597, Cell 505.620.4228 professional.surveying@comcast.net

SHEET 1 OF 1

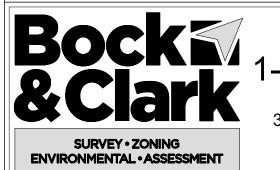

National Coordinators 1-(800)-SURVEYS (787-8397)

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