



## **DEVELOPMENT REVIEW APPLICATION**


Effective 4/17/19

Please check the appropriate box ar	nd refer to supp	olemental forms	for sub	mittal requirements. All fe	es mus	t be paid at the time of	application.
Administrative Decisions Decisions Requiring a Public Meeting or Hearing Policy Decisions							
□ Archaeological Certificate (Form P3) □ Site Plan – EPC including any Variances – EPC □ Adoption or Amendment of Comprehensive Plan or Facility Plan (Form Z)					Comprehensive		
☐ Historic Certificate of Appropriatene (Form L)	ss – Minor	Master Developr	nent Pla	n <i>(Form P1)</i>	The state of the s	option or Amendment of nation <i>(Form L)</i>	Historic
☐ Alternative Signage Plan (Form P3)	The state of the s	Historic Certificati Form L)	te of App	oropriateness – Major	□ Am	endment of IDO Text (Fo	orm Z)
✓Minor Amendment to Site Plan (For	m P3) □	Demolition Outsi	de of HF	PO (Form L)	□ Anı	nexation of Land (Form 2	<u>z</u> )
□ WTF Approval (Form W1)		Historic Design S	Standard	ls and Guidelines <i>(Form L)</i>	□ Am	endment to Zoning Map	– EPC (Form Z)
	0.32	Wireless Telecor orm W2)	mmunica	ations Facility Waiver	□ Am	☐ Amendment to Zoning Map – Council (Form Z)	
					Appe	als	
					□ De <i>A</i> )	cision by EPC, LC, ZHE	, or City Staff <i>(Form</i>
APPLICATION INFORMATION	*						
Applicant: Chick-fil-A, Inc.					Ph	none:	
Address: 5200 Buffington Roa	ıd				Er	nail:	
<sup>City:</sup> Atlanta				State: GA	Zij	o: <b>30349</b>	
Professional/Agent (if any): Interpla	n LLC Agent				Pł	none: 407-645-5008	3
Address: 220 East Central Parkway Ste 4000 Email: Abishop@interplanllc.com							
City: Altamonte Springs State: FL Zip: 32701							
Proprietary Interest in Site: List all owners: Levine Investments Limited Partnership / Red Shamrock 4 LLC							
BRIEF DESCRIPTION OF REQUEST	(						
Parking Lot Addition, approximately 22,000sf needed for fire lane/escape lane, DT Modification & Existing Single Lane OMD Canopy Extension to Dual Lane, Transformer Relocation							
SITE INFORMATION (Accuracy of th			rucial!	Attach a separate sheet i	necess	ary.)	
Lot or Tract No.: LT 6 PLAT OF LOTS 1 THRU 9 COORS PAVILION Block: Unit:							
Subdivision/Addition:			1000E 2	MRGCD Map No.:		PC Code:	
Zone Atlas Page(s):		Existing Zoning			. 25 2	oposed Zoning: NR-C	
# of Existing Lots:		# of Proposed L	.ots:		To	otal Area of Site (acres):	
LOCATION OF PROPERTY BY STRE	ETS	To the state of th			1		
Site Address/Street; 4001 Coors Boulevard N	Site Address/Street: 4001 Coors Boulevard NW, Albuquerque Between: and:						
CASE HISTORY (List any current or	prior project a	nd case number	(s) that	may be relevant to your r	equest.)		
signature: Amanda Bis	shop Digital	ly signed by Amand 2022 06 28 12:54:27	la Dishop -04'00'		Da	ate:	
Printed Name: Amanda Bishop; Interplan LLC a/o Chick-fil-A, Inc.   □ Applicant or  □ Applicant or  □ Applicant or □ Agent							
FOR OFFICIAL USE ONLY						1,1	
Case Numbers	Action	Fees	<b></b>	Case Numbers		Action	Fees
Macrosola (1000 000 MTM (2017) 999 (1 100)		10.250		Legospaces 4 - Colored Colored		outrepressing designates 2.7	9902900048T
Meeting/Hearing Date:		ı			Fe	ee Total:	
Staff Signature:				Date:	Pr	oject#	

### FORM P3: ADMINISTRATIVE DECISIONS AND MINOR AMENDMENTS

A single PDF file of the complete application including all plans and documents being submitted must be emailed to <a href="PLNDRS@cabq.gov">PLNDRS@cabq.gov</a> prior to making a submittal. Zipped files or those over 9 MB cannot be delivered via email, in which case the PDF must be provided to City Staff using other on-line resources such as Dropbox or FTP.


<ul> <li>INFORMATION REQUIRED FOR ALL ADMINISTRATIVE DECISIONS OR AMENDMENTS</li> <li>Letter of authorization from the property owner if application is submitted by an agent</li> <li>Zone Atlas map with the entire site clearly outlined and label</li> </ul>
ARCHEOLOGICAL CERTIFICATE  Archaeological Compliance Documentation Form with property information section completed  Only the information above is required unless the City Archaeologist determines that the application does not qualify for a Certificate of No Effect, in which case a treatment plan prepared by a qualified archaeologist that adequately mitigates any archeological impacts of the proposed development must be submitted and reviewed for a Certificate of Approval per the criteria in IDO Section 14-16-6-5(A)(3)(b)
MINOR AMENDMENT TO SITE PLAN – ADMIN, EPC, or DRB  V Justification letter describing, explaining, and justifying the request per the criteria in IDO Section 14-16-6-4(Y)(2)  V The approved Site Plan being amended Copy of the Official Notice of Decision associated with the prior approval  The proposed Site Plan, with changes circled and noted Refer to the Site Plan Checklist for information needed on the proposed Site Plan.  Completed Site & Building Design Considerations Form in accordance with IDO Section 5-2(D) for new commercial and multifamily development except if the development is industrial or the multifamily is less than 25 units
Minor Amendments must be within the thresholds established in IDO TABLE 6-4-4. Any amendment beyond these thresholds is considered a Major Amendment and must be processed through the original decision-making body for the request.
MINOR AMENDMENT TO SITE DEVELOPMENT PLAN APPROVED PRIOR TO THE EFFECTIVE DATE OF THE IDO  Justification letter describing, explaining, and justifying the request per the criteria in IDO Section 14-16-6-4(Z)(1)(a)  The approved Site Development Plan being amended  Copy of the Official Notice of Decision associated with the prior approval  The proposed Site Development Plan, with changes circled and noted  Refer to the Site Plan Checklist for information needed on the proposed Site Plan.  Completed Site & Building Design Considerations Form in accordance with IDO Section 5-2(D) for new commercial and multifamily development except if the development is industrial or the multifamily is less than 25 units
Minor Amendments must be within the thresholds established in IDO TABLE 6-4-4. Any amendment beyond these thresholds is considered a Major Amendment and must be processed through the original decision-making body for the request.
ACCELERATED EXPIRATION SITE PLAN  Justification letter describing, explaining, and justifying the request per the criteria in IDO Section 14-16-6-4(X)(2)(c)  Site Plan to be Expired
ALTERNATIVE SIGNAGE PLAN  Proposed Alternative Signage Plan compliant with IDO Section 14-16-5-12(F)(5)  Justification letter describing, explaining, and justifying the request per the criteria in IDO Section 14-16-6-5(C)(3)(b)  Required notices with content per IDO Section 14-16-6-4(K)  Office of Neighborhood Coordination notice inquiry response and proof of emailed notice to affected Neighborhood Association representatives  Sign Posting Agreement
ALTERNATIVE LANDSCAPE PLAN
<ul> <li>Justification letter describing, explaining, and justifying the request per the criteria in IDO Section 14-16-5-6(C)(16)</li> <li>Landscape Plan</li> </ul>

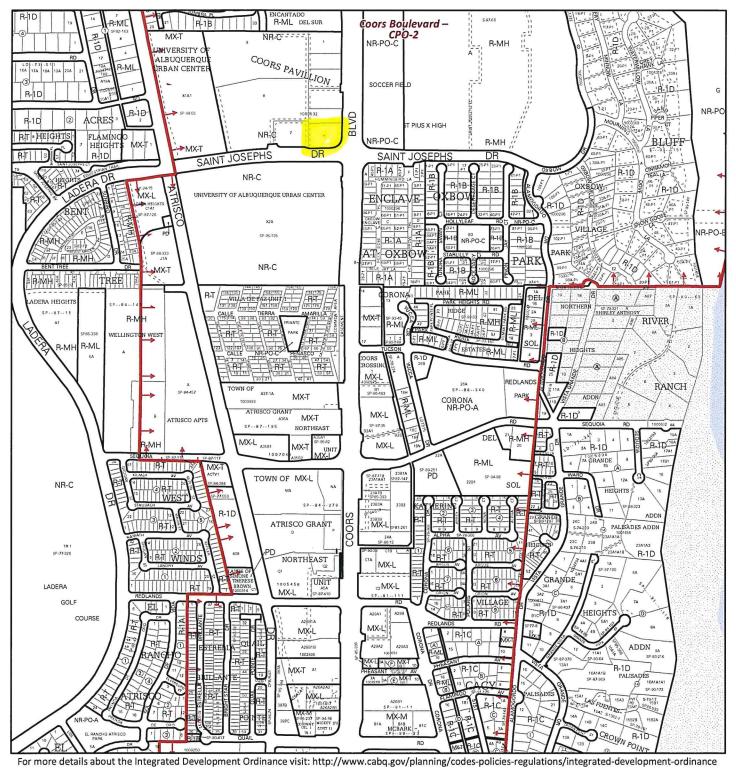

IDO Zone Atlas G-11-Z



IDO Zoning information as of May 17, 2018
The Zone Districts and Overlay Zones
are established by the
Integrated Development Ordinance (IDO).

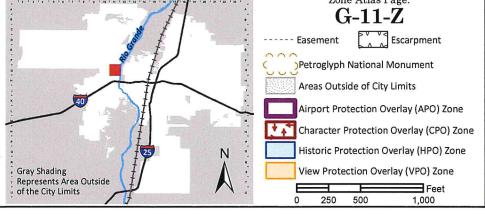

### March 4, 2022

Reference:

Chick-fil-A #04107 Coors Boulevard FSU

4001 Coors Boulevard Northwest, Albuquerque, NM 87120

IP No.: 2021.1239

Letter of Authorization

To Whom It May Concern:

Please accept this letter as authorization for Interplan LLC, to act as agent in correspondence and representation of all approval and permitting matters required for (project name) at the location referenced above.

If you have any questions, please contact me at 505-998-9093 or via email, josh@retailSouthwest.com.

Sincerely, Red Shamrack 4, LC

Title managing member

Subscribed and sworn to before me this 14 day of July , 2022.

Notary Public\_

Seal

My Commission Expires: 4/10/2025

STATE OF NEW MEXICO
NOTARY PUBLIC
TRISHA A. KVERN
Commission # 1101649
My Comm. Exp. April 10, 2025



407-645-5008 Interplanllc.com

July 22, 2022

Jay Rodenbeck
City of Albuquerque Planning Department
Development Review Services
600 Second NW
Albuquerque, NM 87102
505-924-3994
irodenbeck@cabq.gov

Reference: Chick-fil-A #4107 Coors Boulevard FSU

4001 Coors Boulevard, Albuquerque, NM 87120

IP No.: 2021.1239
Justification Letter

To Whom It May Concern,

Chick-fil-A is proposing modifications to the existing restaurant located at the address referenced above. The scope of work involves a Parking Lot Addition, approximately 22,000sf needed for fire lane/escape lane, DT Modification, Transformer relocation & Existing Single Lane OMD Canopy Extension to Dual Lane, which will serve to protect employees and customers against the elements as well as help expedite the ordering process and alleviate traffic.

Below are the justifications which address the criteria in 14-16-6-4(y)(2) of the Integrated Development Ordinance.

- 1. The amendment is necessary because of site conditions or user requirements that were not known, and could not reasonably have been known, at the time the City approved the approval that is proposed to be amended, and that were not created by the actions of the owner of the property as traffic congestion and circulation issues have increased for the site and adjacent properties.
- 2. The amendment does not increase or decrease the dimension of any standard beyond thresholds allowed as Minor Amendments pursuant to Table 6-4-4 (cumulative of any earlier deviations or amendments.
- 3. The amendment does not decrease the total amount of open space in the development and does not reduce the size of any open space abutting a lot containing a residential use.
- 4. The amendment does not reduce any building setback adjacent to development containing residential uses by any amount.



Chick-fil-A #04107 Coors Boulevard July 22, 2022 Page 2 of 3

- 5. The amendment does not increase the maximum number of residential selling units in the development from that shown in the existing permit, approval, or plan. If the property is located in DT-UC-MS-PT area, the amendment does not decrease the required number of residential dwellings units in the development from that shown in the existing permit, approval or plan.
- 6. The amendment does not adjust a building design standard unless doing so improves the perception of building quality, variety, durability, and articulation when viewed from adjacent streets and abutting properties.
- 7. The amendment does not reduce the amount of total landscaping installed on the subject property or the amount of screening or buffering required on portions of the site abutting any property containing residential dwelling units and does not waive or weaken any other landscaping or buffering requirement unless the ZEO determines that alternative building design elements included in the amendment improve the visual quality and screening and buffering effect of landscaping as viewed from adjacent streets and public areas.
- 8. The amendment does not increase the traffic accessing the subject property from local streets and does not increase or decrease the number of through streets, sidewalks, trails or trail connections passing through the property or connecting or connecting to or designed to connect to abutting properties.
- 9. The amendment does not require major public infrastructure or significant changes to access or circulation patters on the subject property.
- 10. The amendment does not change a specific condition attached by a decision-making body listed in Table 6-1-1 to a prior development permit, approval, or plan for or including the subject property. For example, a specific condition attached to a prior approval requiring additional buffering to mitigate development impacts shall not be removed through a minor amendment process.
- 11. The amendment does not affect a property in an Overlay zone as regulated pursuant to 0, in which case amendments may be granted per the original approval process for the Site Plan governing the site.
- 12. The amendment does not approve any land use that was not authorized by the permit or approval or that is not allowed by right on the subject property.
- 13. The amendment does not expand a nonconformity as regulated per Section 14-16-6-8 (Nonconformities).



Chick-fil-A #04107 Coors Boulevard July 22, 2022 Page 3 of 3

Upon review, please let me know if you have any questions or require additional information regarding the Letter of Justification which addresses the criteria in 14-16-6-4(Y)(2) of the Integrated Development Ordinance (IDO).

Sincerely,

### **INTERPLAN LLC**

Amanda Bishop


Amanda Bishop Development Services/ Permit Coordinator


### enclosures

ec: K. Teresa, C. Efford; Chick-fil-A, Inc.

E. Cogswell, R. Osegueda, M. McRae; JLL D. Jenkins, M. Medina; Ensign Engineering

N. Carreras, T. Vu; Interplan LLC

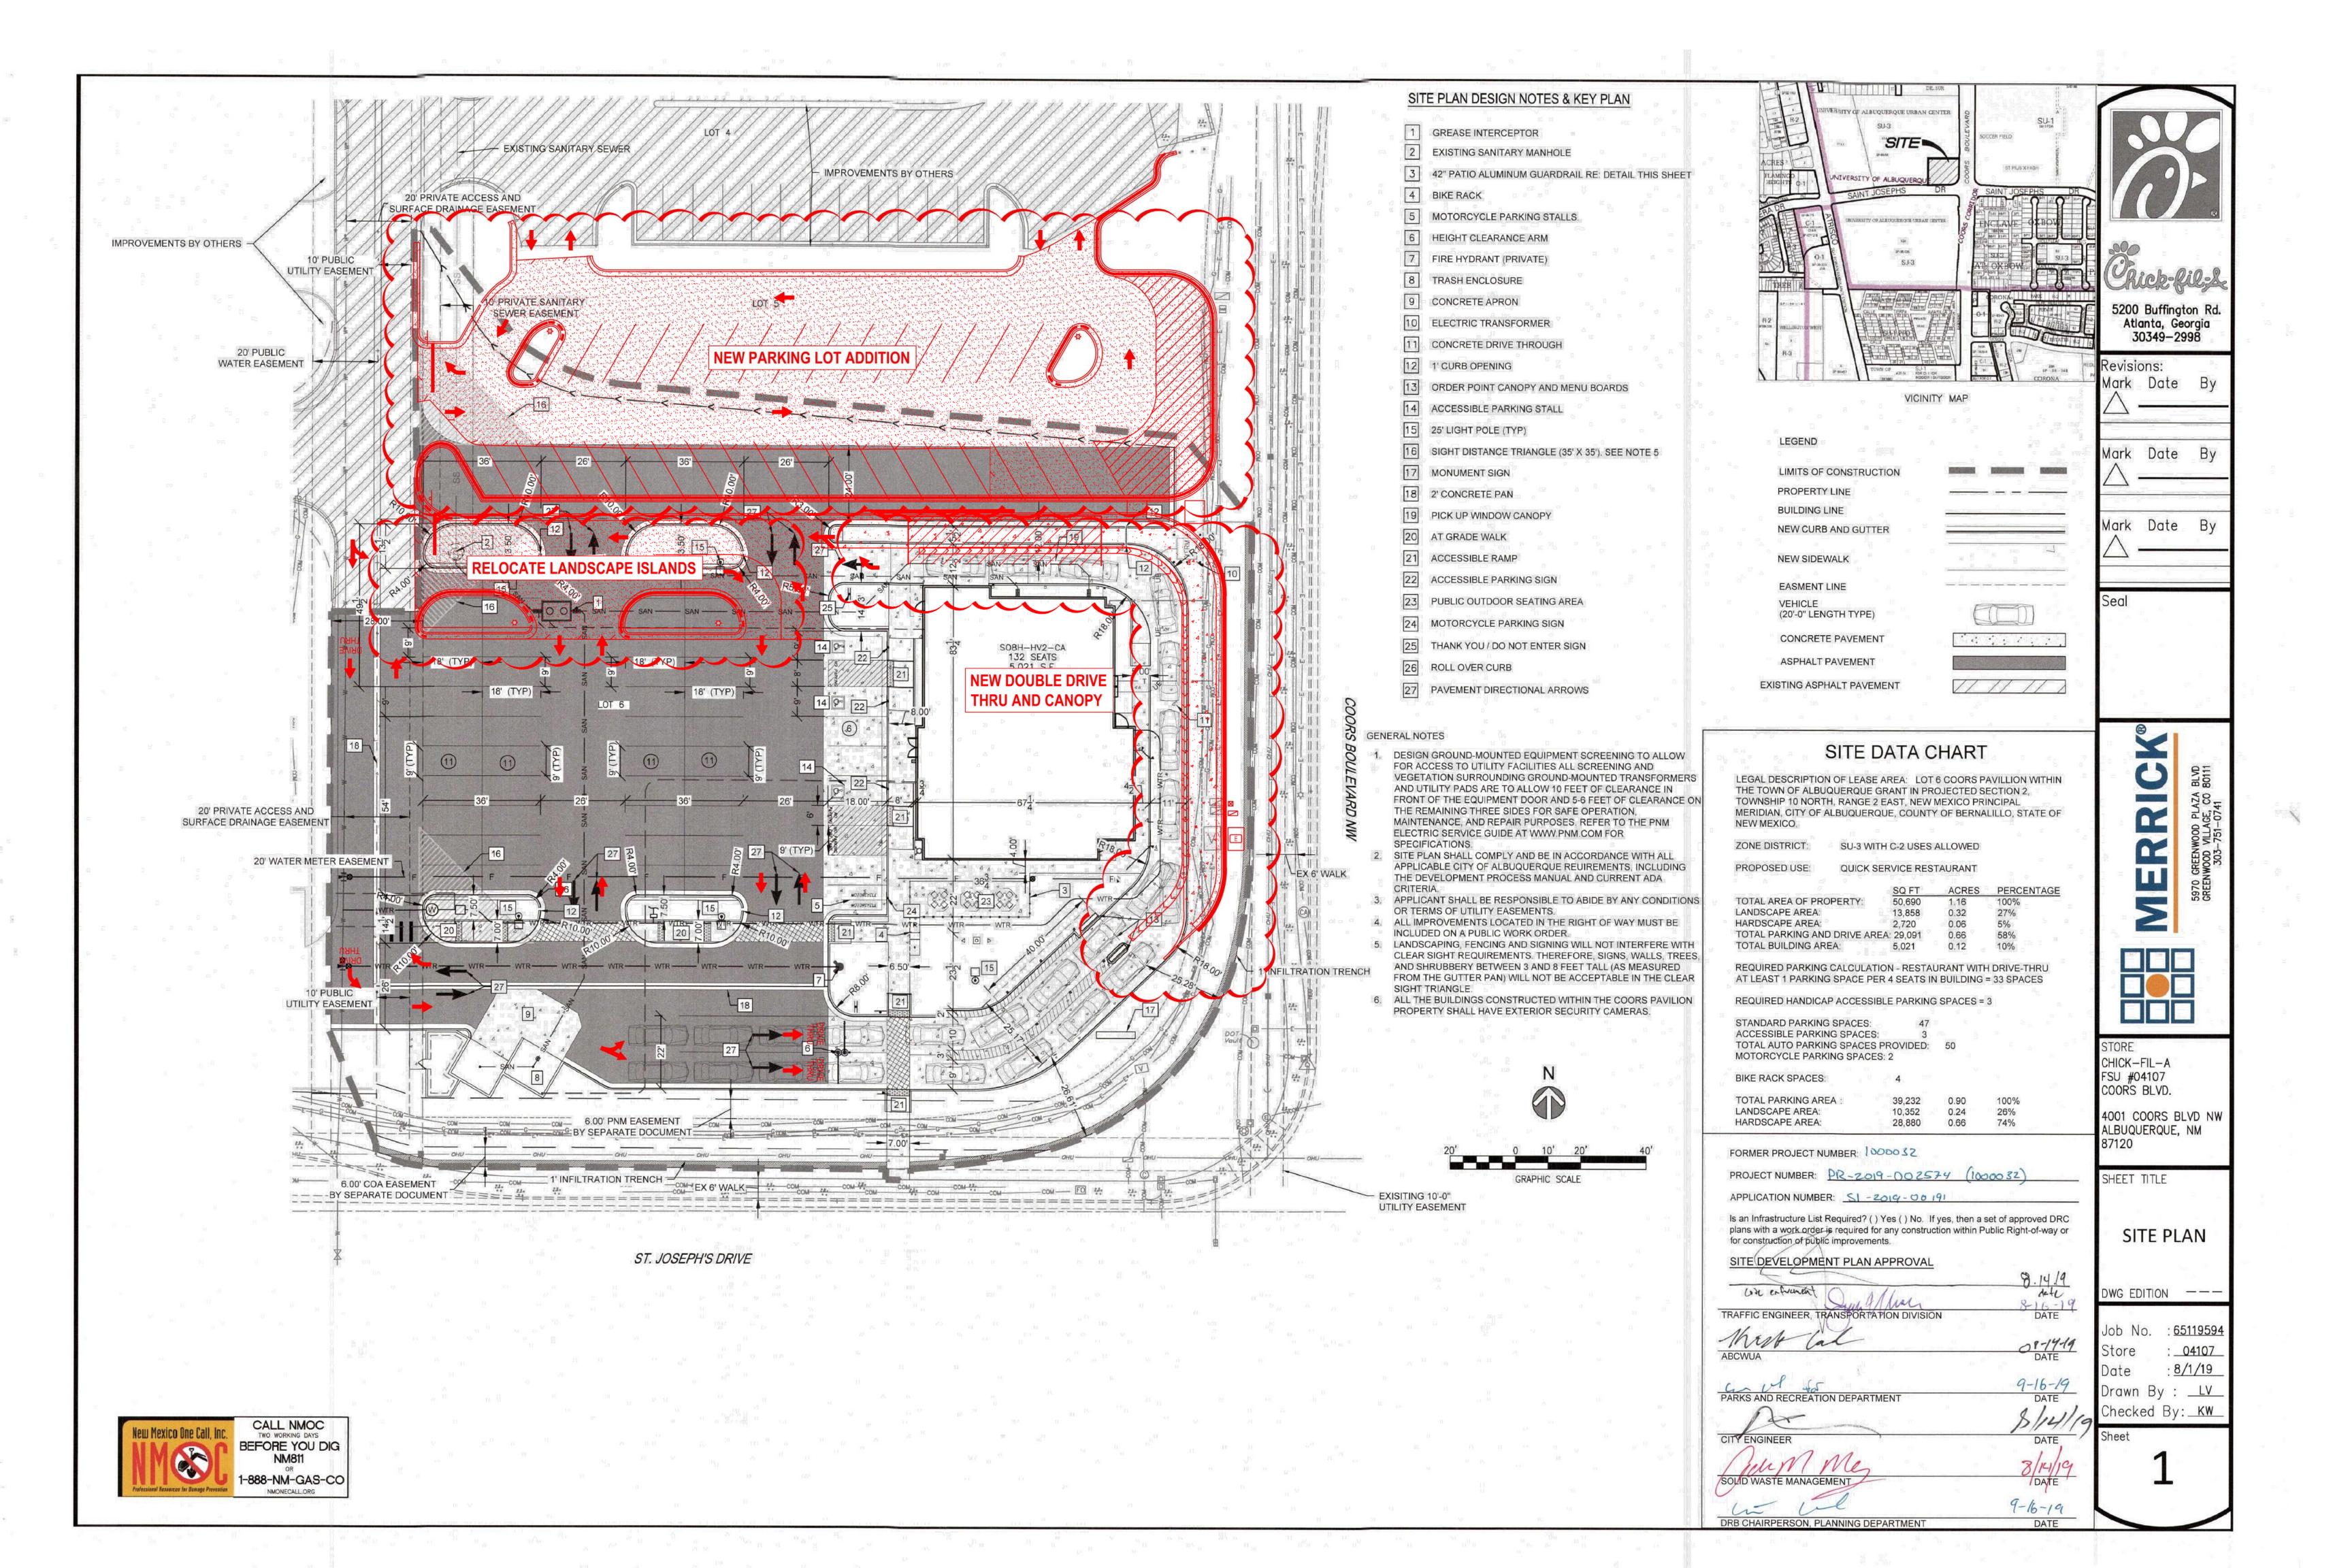

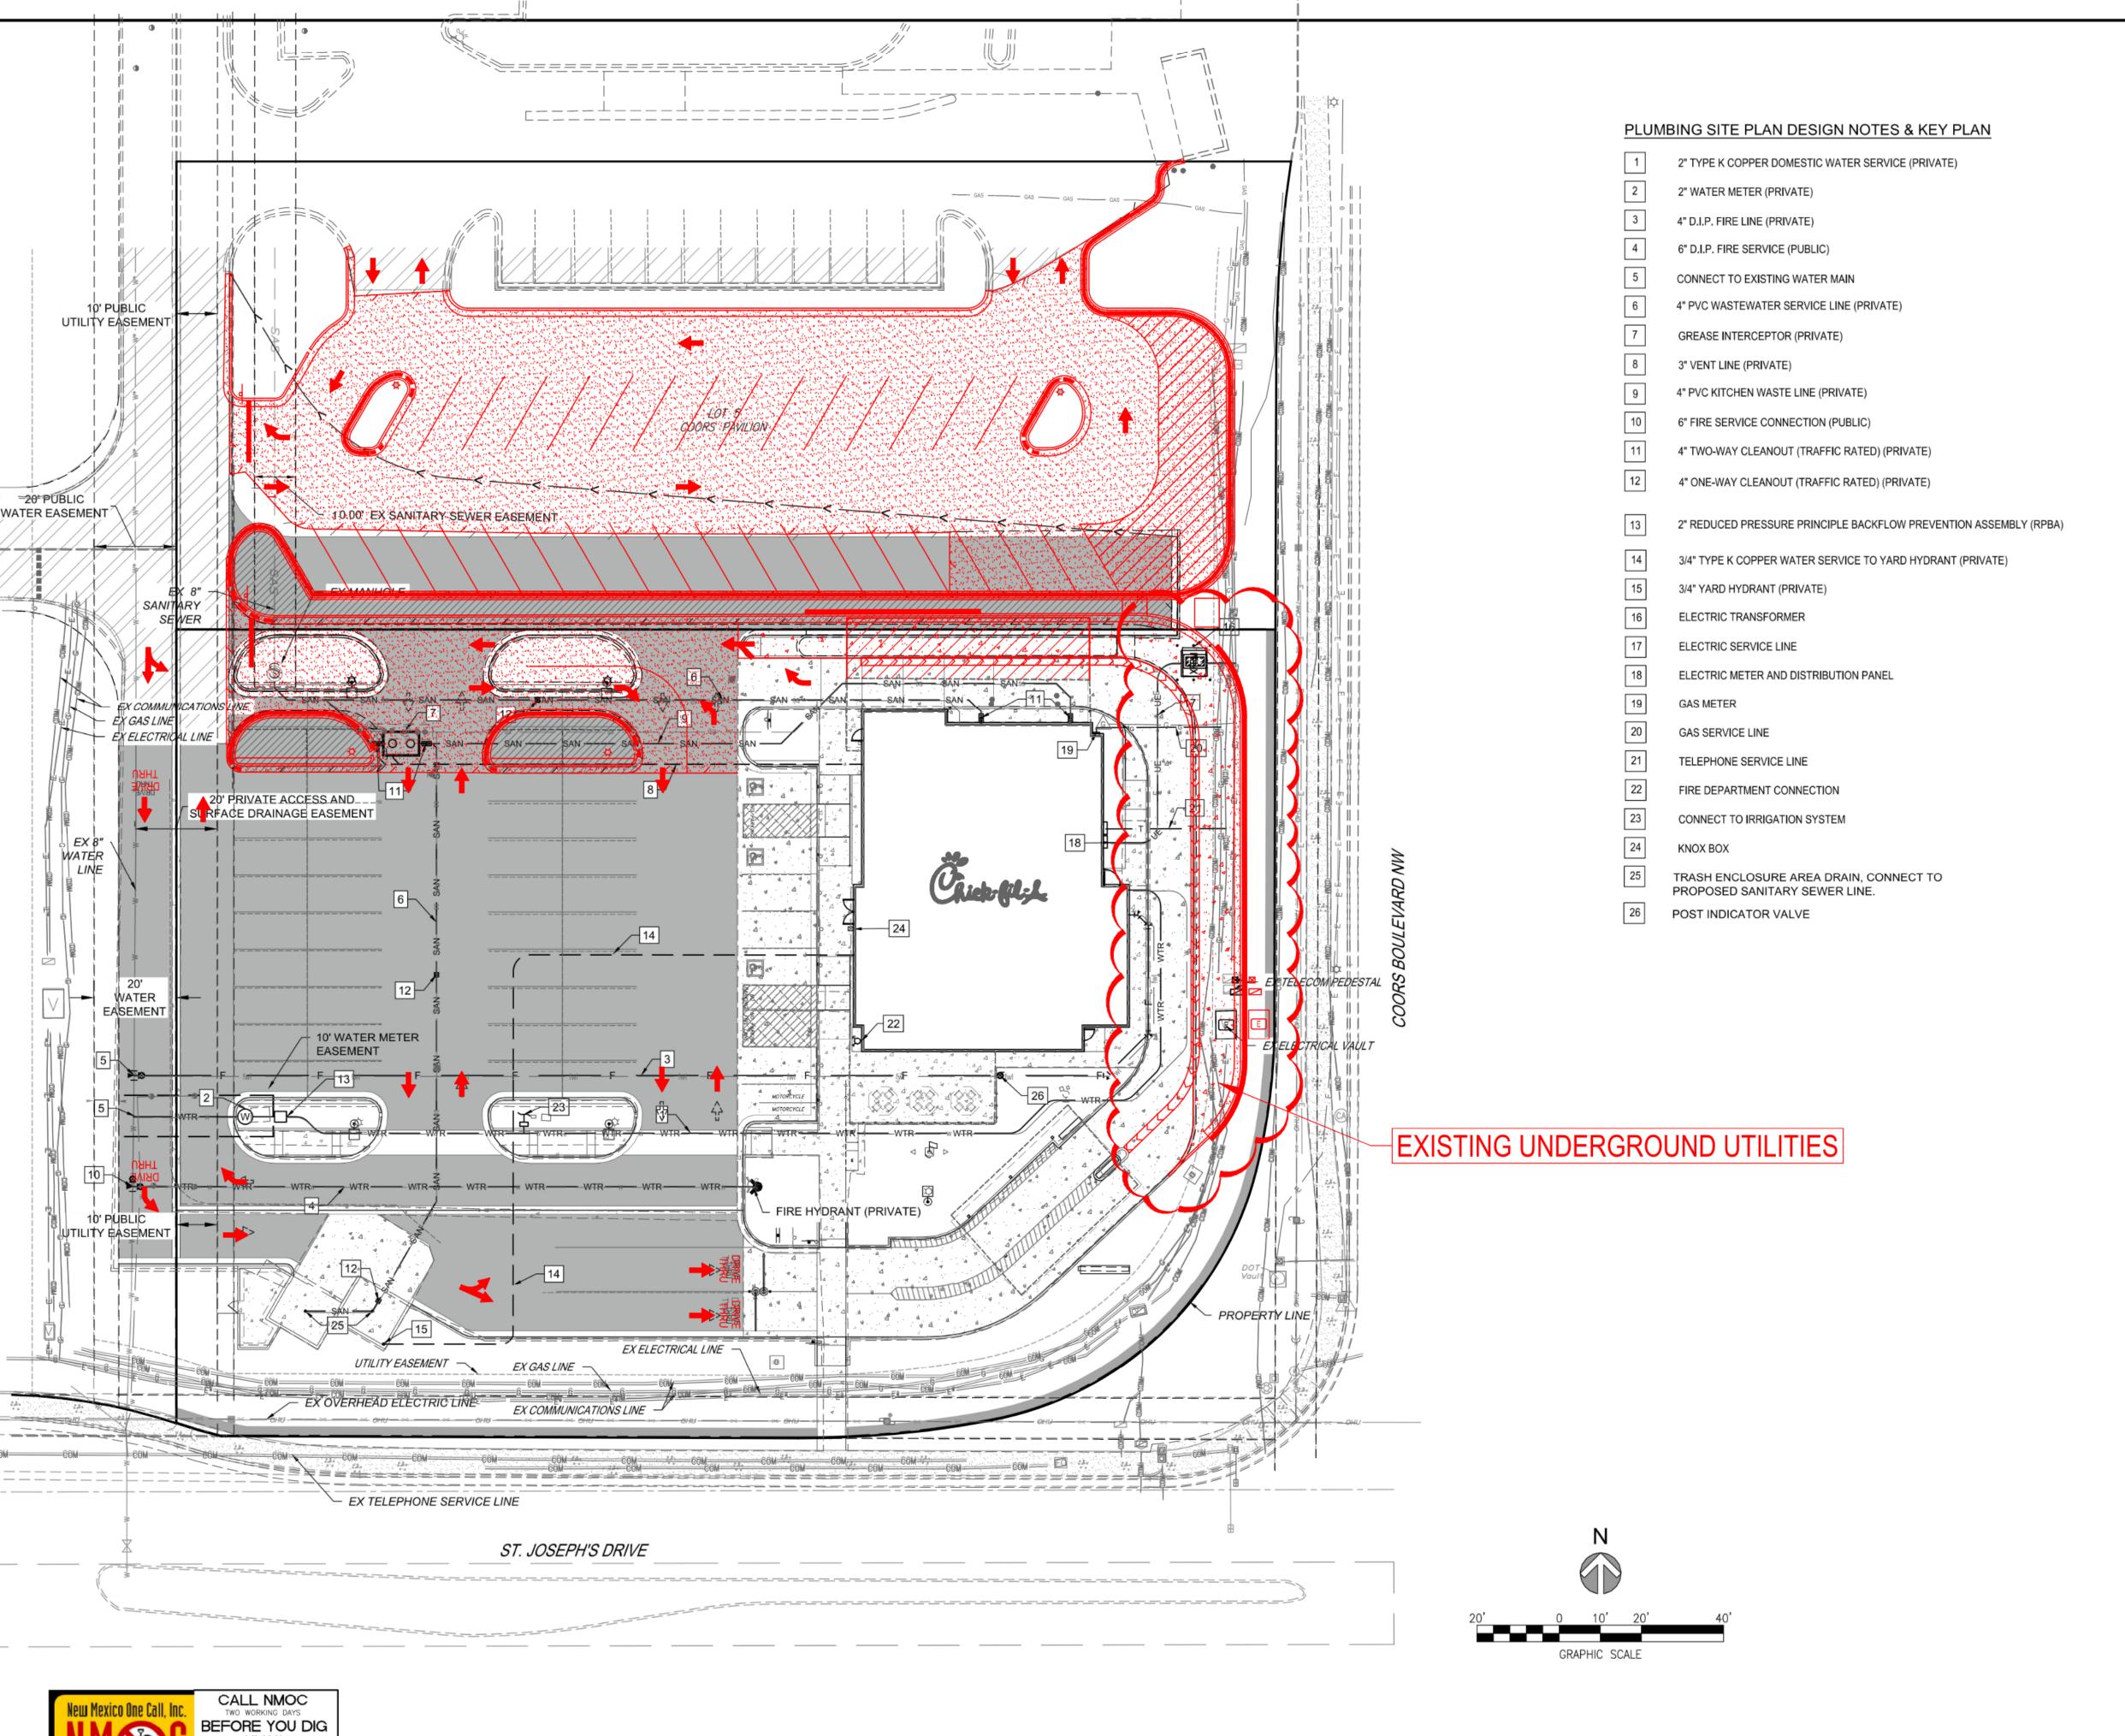

## LEGEND

GEND:	
	PROPERTY LINE
(a)	WATER METER
6	IRRIGATION METER
00	GREASE TRAP
<b>P</b>	SINGLE CLEANOUT
 	TWO-WAY CLEANOUT
XFRM	TRANSFORMER
	STORM INLET
	STORM MANHOLE
e B	LIGHT POLE
<del></del>	PROPOSED TRAFFIC SIGN
DRIVE THRU	PAVEMENT STRIPING
(25)	PARKING STALL COUNT
— F ——	FIRE LINE
WTR	WATER LINE
SAN	SANITARY SEWER
G	GAS SERVICE
— Е ——	ELECTRIC SERVICE
— т ——	TELEPHONE SERVICE
	STORM SEWER
5555	PROPOSED MAJOR CONTOUR
5555	PROPOSED MINOR CONTOUR
$\bigcirc$	EX STORM MANHOLE
S	EX SANITARY MANHOLE
	EX STORM INLET
<b>\$</b>	EX LIGHT POLE
UE	EX UNDERGROUND ELECTRIC
— G ——	EX GAS SERVICE
	EX WATER LINE
	EX STORM SEWER
SS	EX SANITARY SEWER
UT	EX TELEPHONE SERVICE
	EX GUARDRAIL
•	EX FIRE HYDRANT
-	EX TRAFFIC SIGN
	EX MAJOR CONTOUR
5555	EX MINOR CONTOUR
<b>**</b> **	EX TREE
	EX IRRIGATION VALVE
	EX TELEPHONE BOX
Ш	EX TELEPHONE BOX
IF1	EX ELECTRIC BOX

EX ELECTRIC BOX

EX STORM SEWER

EX RECLAIMED WATER MAIN





5200 Buffington Rd. Atlanta, Georgia 30349—2998

Revisions:

Mark Date By

Mark Date By

Mark Date By

Seal





STORE
CHICK-FIL-A
FSU #04107
COORS BLVD.

4001 COORS BLVD NW ALBUQUERQUE, NM 87120

SHEET TITLE


UTILITY PLAN

DWG EDITION ---

Job No. : 65119594
Store : \_\_04107\_
Date : 8/1/19
Drawn By : \_\_LV
Checked By: \_\_KW

Sheet

4

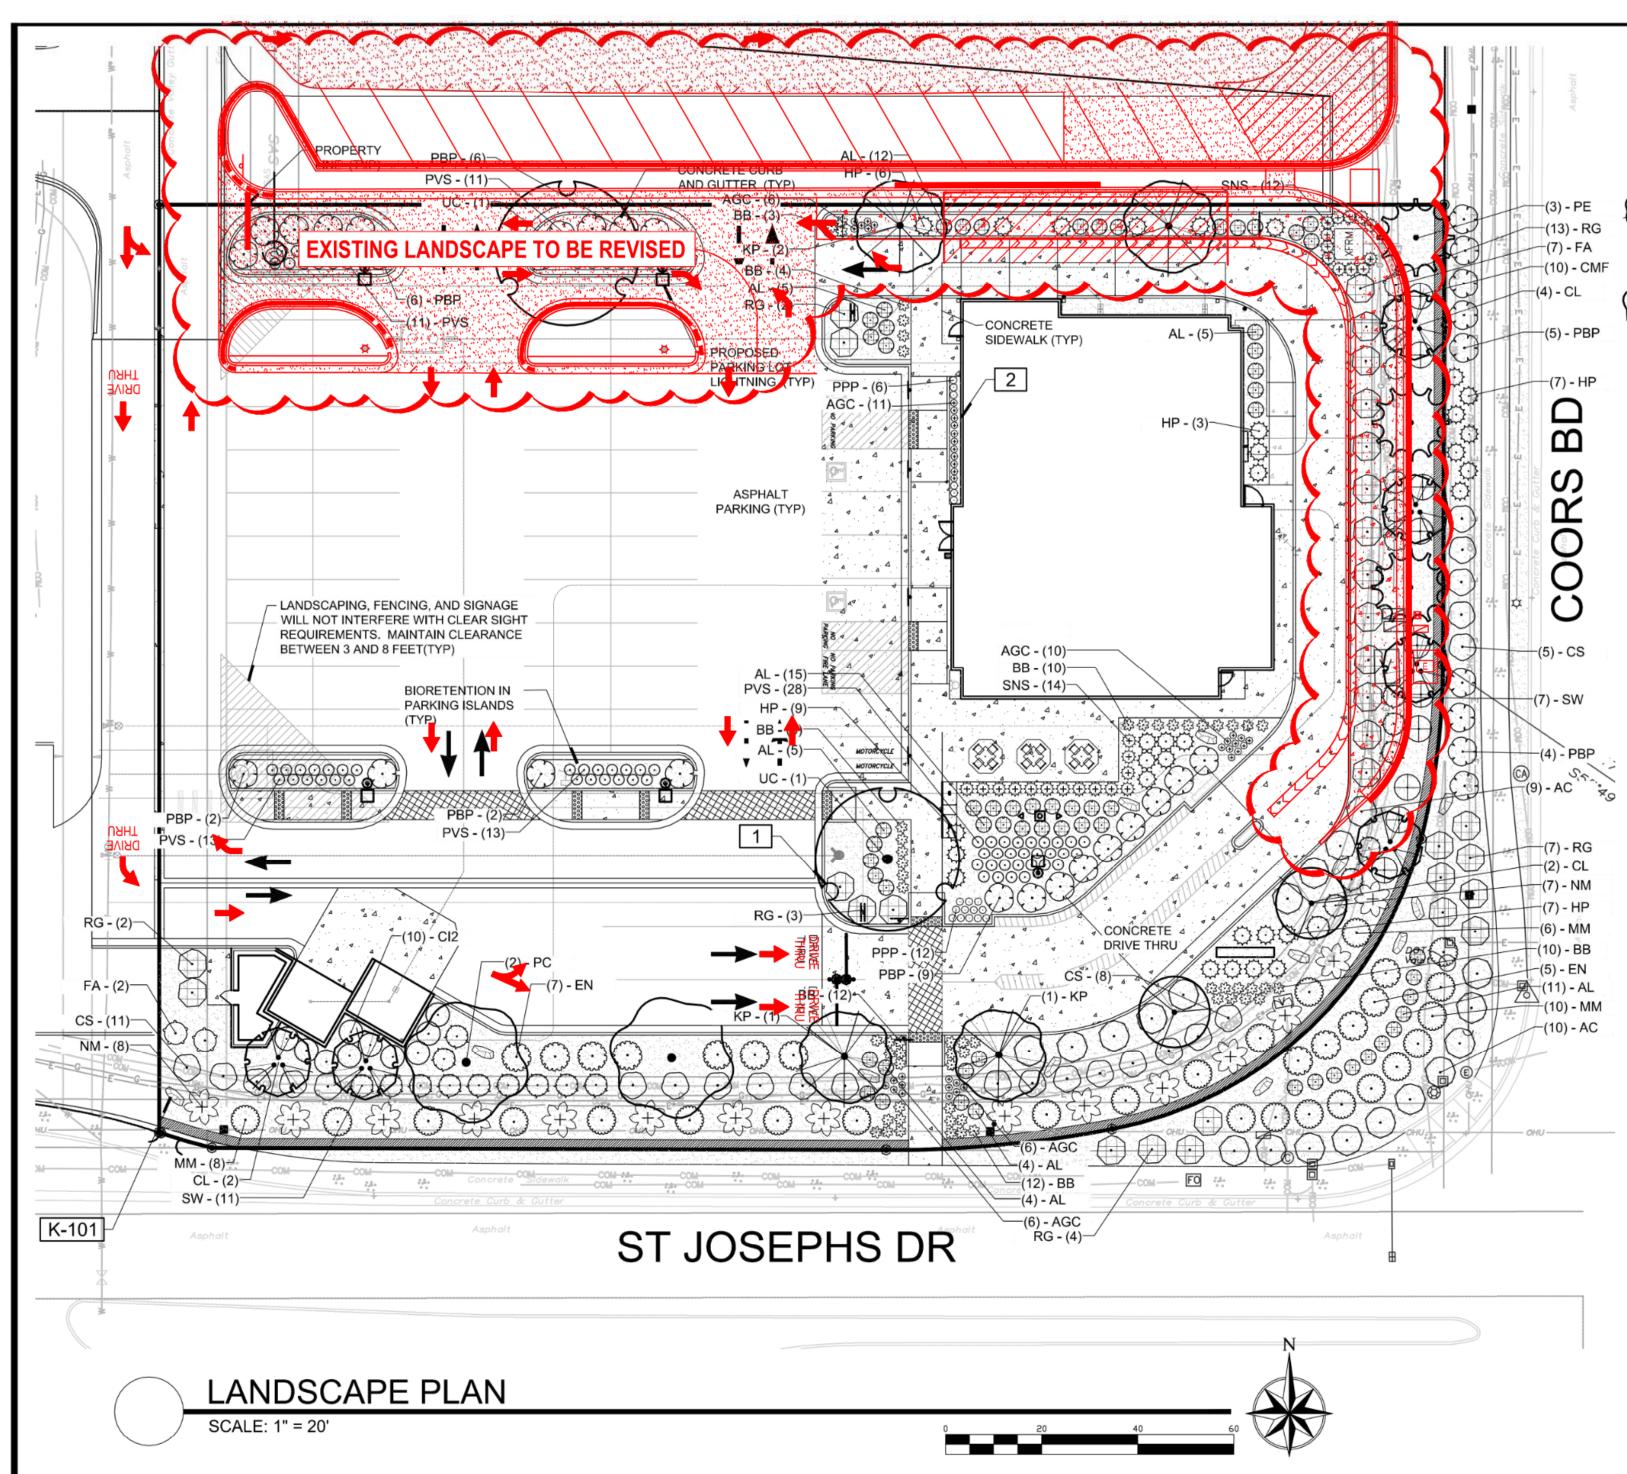

OVERALL LANDSCAPING PR Groundplane Veg Cover % Req/ Provided Tot 13214 *.75 = 9910 Req 19 10,215 sf provided = 77.30% cover)	tal Trees Total Shrubs	Site Area: 50,691 SF Building Area: 4,867 Net Lot Area: 45,824 Required Landscap 6,874 sf Provided Landscap Percentage = 28.689	SF ing (15%) ing = 13,125	
PARKING BUFFERS / INTER Frontage and LF South St Josephs NW - 316 East Coors Bd NW 164 If	Bed Width / Coverage %	# of Spaces 53	Trees Req / Prov 5 / 5 (1 per 10)	Shade Trees Req / Prov 5 / 5
NO PARKING SPACE MAY B STREET TREES (1 ~ 30 LF)	BE LOCATED MORE THAN 100	FROM TREE TRUNK		
Frontage and LF East164 LF South316 LF	Trees Req / Provided 5 / 5 9 / 9			

(1) Landscaping shall be installed according to the approved plan; installation shall be completed within 60 days of the related building's occupancy.

(2) Any damage to utility lines resulting from the negligence of the abutting landowner, his agents, or employees in the installation and maintenance of the landscaped area in the public right-of-way shall be the responsibility of such landowner. Any damage to utility lines resulting from the growth of plant materials, which have been approved by the applicable public utility as part of a plan for landscaping on the public right-of- way, shall be the responsibility of such public utility. If a public utility disturbs a landscaped area in the public right-of-way, it shall make every reasonable effort to preserve the landscaping materials and return them to their prior locations after the utility work. If, nonetheless some plant materials die, it is the obligation of the abutting landowner to replace the plant materials.

(3) Landscaping shall have adequate maintenance. Landscaping which dies shall be replaced by the owner as expeditiously as possible, but in no case longer than 60 days after notification.

## PLAN NOTES:

- 1. STREET TREE PROVIDED PER SECTION 6-1-1-1.
- 2. NO SOD IS PROPOSED.
- PROVIDE A 2' PARKING OVERHANG FOR ALL PLANTS WHERE APPLICABLE.
- LANDSCAPING AND SIGNING WILL NOT INTERFERE WITH CLEAR SIGHT REQUIREMENTS. THEREFORE, SIGNS, WALLS, TREES, AND SHRUBBERY BETWEEN 3 AND 8 FEET TALL (AS MEASURED FROM THE GUTTER PAN) WILL NOT BE ACCEPTABLE IN THESE AREAS.
- ALL IRRIGATION TO COMPLY WITH WATER CONSERVATION LANDSCAPING AND WATER WASTE ORDINANCE FOR ALBUQUERQUE.
- 6. PROPOSED LANDSCAPING COMPLIES WITH CITY OF ALBUQUERQUE
- WATER CONSERVATION ORDINANCE (RE: SEC. 6-1-1)
- LANDSCAPE BEDS TO BE DEPRESSED AT LEAST 6" BELOW GRADE TO ALLOW FOR RAINWATER HARVESTING.
- THIS PLAN COMPLIES WITH CITY CODE 14-16-3-10, GENERAL LANDSCAPING REGULATIONS, WITH THE INCLUSION OF REQUIREMENTS TABLE AND REQUIRED LANDSCAPE MATERIAL SIZE AND LOCATIONS AS SPECIFIED IN AFOREMENTIONED CODE.

## PLANT SCHEDULE ON-SITE

PLANT S	SCHE	DULE O	N-SITE		
TREES	CODE	QTY	BOTANICAL / COMMON NAME	CONT	CAL
	CL	8	CHILOPSIS LINEARIS / DESERT WILLOW	В¢В	2.0" CAL MULTISTEM
	KP	4	KOELREUTERIA PANICULATA / GOLDEN RAIN TREE	B¢B	2"CAL
3.4	PE	3	PINUS EDULIS / PINION PINE	10-12`HT	
	PC	2	PISTACHIA CHINENSIS / CHINESE PISTACHE	B # B	2"CAL
$\left(\cdot\right)$	UC	2	ULMUS `ACCOLADE` / ACCOLADE ELM	В¢В	2"CAL
SHRUBS	CODE	QTY	BOTANICAL / COMMON NAME	SIZE	
$\bigcirc$	AL	61	AMORPHA CANESCENS / LEADPLANT	2 GAL	
$\odot$	AC	19	ARCTOSTAPHYLOS X COLORADOENSIS `CHIEFTAIN` / MANZANITA	5 GAL	
$\odot$	CI2	10	CERCOCARPUS INTRICATUS / LITTLE LEAF MOUNTAIN MAHOGONY	5 GAL	
$\bigoplus$	CMF	10	CHAMAEBATIARIA MILLEFOLIUM `FERNBUSH` / FERNBUSH	5 GAL	
$\odot$	C5	24	CYTISUS SCOPARIUS `MOONLIGHT` / MOONLIGHT SCOTCH BROOM	5 GAL	
$\bigcirc$	EN	12	ERICAMERIA NAUSEOSA / RUBBER RABBITBRUSH	5 GAL	
$\odot$	FA	9	FALLUGIA PARADOXA / APACHE PLUME I 2356D	5 GAL	
$\Leftrightarrow$	HP	32	HESPERALOE PARVIFOLIA / RED YUCCA	5 GAL	
$\odot$	PBP	34	PRUNUS BESSEYI `PAWNEE BUTTES` / SAND CHERRY	5 GAL	
	RG	31	RHUS TRILOBATA `AUTUMN AMBER` / AUTMN AMBER SUMAC	5 GAL	
<b>GRASSES</b>	CODE	QTY	BOTANICAL / COMMON NAME	SIZE	
£;3	ВВ	57	BOUTELOUA GRACILIS `BLONDE AMBITION` / BLUE GRAMA	I GAL	
£3	NM	15	NOLINA MICROCARPA / SACAHUISTA	I GAL	
$\odot$	PV5	76	PANICUM VIRGATUM `SHENENDOAH` / BURGUNDY SWITCH GRASS	I GAL	
<del>(+)</del>	SNS	26	SORGHASTRUM NUTANS `SIOUX BLUE` / INDIAN GRASS	I GAL	
$\odot$	SW	18	SPOROBOLUS WRIGHTII / BIG SACATON	I GAL	
PERENNIALS	CODE	QTY	BOTANICAL / COMMON NAME	SIZE	
+	AGC	39	AGASTACHE CANA `SONORAN SUNSET` / SONORAN SUNSET HYSSOP	I GAL	
$\odot$	ММ	24	MIRABILIS MULTIFLORA / COLORADO FOUR O`CLOCK	I GAL	
	PPP	18	PENSTEMON PINIFOLIUS / THREADLEAF BEARDTONGUE	4"POT	
MULCHES	CODE	QTY	BOTANICAL / COMMON NAME	CONT	
	RM	16,739 SF	ROCK MULCH / RIVER ROCK MIXTURE PER OWNER APPROVAL. PLACE TO A UNIFORM DEPTH OF 3" OVER PERMEABLE WEED BARRIER FABRIC.	MULCH	

## REFERENCE NOTES SCHEDULE

SYMBOL	DESCRIPTION	QTY	DETAIL
1	PLACE SHREDDED CEDAR MULCH AROUND BASE OF ALL PERENNIALS AND GRASSES IN LARGE COBBLE AREAS. MASSED PERENNIALS TO RECEIVE LARGE RING AROUND ENTIRE GROUP (TYP).		
2	MINIMUM 3' ROOTBALL OFFSET FROM BUILDING, TYP.		
SYMBOL	ROCK DESCRIPTION	QTY	DETAIL
K-101	GRANITE/MOSS ROCK BOULDERDECORATIVE. 1/2 TON AVG	16	

- NO SUBSTITUTIONS WITHOUT PREVIOUS APPROVAL OF LANDSCAPE ARCHITECT. UNAPPROVED DEVIATIONS FROM THIS PLAN WILL BE RECTIFIED AT CONTRACTORS EXPENSE.
- DEVIATIONS FROM THIS PLAN WILL BE RECTIFIED AT 2. NO FABRIC UNDER WOOD MULCH IN ANY AREAS.
- 3. DRIPLINE TO BE PLACED OVER WEED BARRIER FABRIC AND STAKED ON TOP OF WEED BARRIER.
- WEED BARRIER CUTOUTS FOR PLANTS IN ROCK AREAS SHALL ACCOUNT FOR MATURE SIZE OF PLANTS, AND EQUAL AT LEAST THE DIAMETER OF THE ROOTBALL.
- 5. ALL EMITTERS PER IRRIGATION PLAN UNLESS OTHERWISE NOTED.
- ALL EMITTERS TO BE PLACED AT THE APPROPRIATE LOCATIONS. ALL EMITTERS TO USE MICRO TUBING, STAKES, AND BUG CAPS AS NECESSARY.
- 7. SEE LANDSCAPE DETAILS SHEET FOR ADDITIONAL NOTES AND DETAILS.
- ALL NATIVE AND XERIC PLANTING AREAS TO BE AMENDED FOR DRAINAGE AS NECESSARY AND IN ACCORDANCE WITH CURRENT LANDSCAPE BMPs.

NATURAL DESIGN SOLUTIONS

Landscape Architecture

Land Planning · Irrigation Design

5539 Colt Drive, Longmont, CO 80503 (303) 443-0388 · neil@ndscolorado.com



Prick-Gil-

5200 Buffington Rd. Atlanta, Georgia 30349—2998

Revisions: Mark Date By

Mark Date By

Mark Date By

Sec





STORE
CHICK-FIL-A
FSU #04107
COORS BLVD.

COORS BLVD NW & St. JOSEPHS DR NW ALBUQUERQUE, NM

SHEET TITLE

LANDSCAPE PLAN

DWG EDITION -

Job No. : 65119594
Store : 04107
Date : 08/02/19
Drawn By : \_\_JRO
Checked By: \_NAM

Sheet

L10

Project #: CFA# 4107 Coors Boulevard Application #: 4001 Coors Boulevard NW, Albuquerque, NM

This checklist will be used to verify the completeness of site plans submitted for review by the Planning Department. Because development proposals vary in type and scale, there may be submittal requirements that are not specified here. Also there may additional requirements if a site is located in CPO, HPO, and/or VPO or if located in DT-UC-MS or PT areas. See the IDO or AGIS for boundaries. Nonetheless, applicants are responsible for providing a complete submittal. Certification as specified below is required.

I CERTIFY THAT THE SUBMITTED SITE PLAN IS COMPLETE AND ACCURATE, AND THAT ALL APPLICABLE INFORMATION AS SPECIFIED IN THIS CHECKLIST IS PROVIDED. FURTHER, I UNDERSTAND THAT THIS APPLICATION IS BEING ACCEPTED PROVISIONALLY AND THAT INACCURATE AND/OR INCOMPLETE INFORMATION MAY RESULT IN THE SUBSEQUENT REJECTION OF THE APPLICATION OR IN

A DELAY OF ONE MONTH OR MORE IN THE DATE THE APPLICATION IS SCHEDULED FOR PUBLIC HEARING.

Amanda Bishop
Digitally signed by Amanda
Bishop
Date: 2022.06.28 12:46:34 -04'00'

Applicant or Agent Signature / Date

Site plan packets shall be composed of the following plan sheets (unless otherwise approved in writing prior to submittal by the Planning Department):

- 1. Site Plan (including utilities and easements)
- 2. Landscaping Plan
- 3. Grading and Drainage Plan
- 4. Utility Plan
- 5. Building and Structure Elevations
- 6. Previously approved Development Plan (if applicable)

The electronic format must be organized in the above manner.

The following checklist describes the minimum information necessary for each plan element. The Applicant must include all checklist items on their site plan drawings and confirm inclusion by checking off the items below. Non-applicable items must be labeled "N/A." Each non-applicable designation must be explained by notation on the Checklist.

NOTE: There may be addition information required if site is located with a CPO, VPO or HPO and/or any other special areas as defined by the IDO.

NOTE: If there requests for deviations (Section 14-16-6-4(O), they must be clearly labelled on the site plan (Sheet 1) as well as addressed in the application letter made with the submittal.

### SHEET #1 - SITE PLAN

### A. General Information

**✓** 1. ✓ 2.

Date of drawing and/or last revision

Scale: 1.0 acre or less 1" = 10'
1.0 - 5.0 acres 1" = 20'
Over 5 acres 1" = 50'
Over 20 acres 1" = 100'

3. Bar scale
4. North arrow
5. Legend
6. Scaled vicinity map
7. Property lines (clearly identify)
8. Existing and proposed easements (identify each)
9. Phases of development, if applicable

## **B.** Proposed Development

## 1. Structural

<u>✓</u> A.	Location of existing and proposed structures (distinguish between existing & proposed) and
_	include any accessory structures
<b>√</b> B.	Square footage of each structure
✓C. ✓D. ✓E.	Proposed use of each structure
<b>∑</b> D.	Signs (freestanding) and other improvements
¥E.	Walls, fences, and screening: indicate height, length, color and materials
¥F.	Dimensions of all principal site elements or typical dimensions
<b>⋰</b> G.	Loading facilities
<b>√</b> F. <b>√</b> G. <u>−</u> H.	Site lighting (indicate height & fixture type)
<b>∠</b> I.	Indicate structures within 20 feet of site
<b>∨</b> _J.	Elevation drawing of refuse container and enclosure, if applicable.
<b>∠</b> J. <b>X</b> K.	Existing zoning/land use of all abutting properties

## 2. Parking, Loading and Internal Circulation

<b>✓</b> A.	Parking layout with spaces numbered per aisle and totaled.
<b>—</b>	1. Location and typical dimensions, including motorcycle spaces, bicycle spaces, ADA
	accessible spaces, and compact spaces  2. Calculations: spaces required and proposed (include any reduction calculations) for motorcycle, bicycle, compact and ADA spaces
	3. On street parking spaces
<b>✓</b> B.	Bicycle parking & facilities
•	1. Bicycle racks – location and detail
	2. Other bicycle facilities, if applicable
<b>√</b> C.	Vehicular Circulation (Refer to DPM and IDO)
	1. Ingress and egress locations, including width and curve radii dimensions
	2. Drive aisle locations, including width and curve radii dimensions
	3. End aisle locations, including width and curve radii dimensions
	4. Location & orientation of refuse enclosure, with dimensions
	5. Loading, service area, and refuse service locations and dimensions
✓D.	Pedestrian Circulation
•	1. Location and dimensions of all sidewalks and pedestrian paths (including ADA connection from ROW to building and from ADA parking to building)

	2. 3.	Location and dimension of drive aisle crossings, including paving treatment Location and description of amenities, including patios, benches, tables, etc.
E.	. Off-Stree	et Loading
•	1.	Location and dimensions of all off-street loading areas
<u> </u>	Off-Stree1.  Vehicle S123.	stacking and Drive-Through or Drive-Up Facilities Location and dimensions of vehicle stacking spaces and queuing lanes Landscaped buffer area if drive-through lanes are adjacent to public R/W Striping and Sign details for one-way drive through facilities
3. Streets		
<u>√</u> A	. Locate an 1 2 3 4 5 6 7 8.	d identify adjacent public and private streets and alleys.  Existing and proposed pavement widths, right-of-way widths and curve radii Identify existing and proposed turn lanes, deceleration lanes and similar features related to the functioning of the proposal, with dimensions  Location of traffic signs and signals related to the functioning of the proposal Identify existing and proposed medians and median cuts  Sidewalk widths and locations, existing and proposed  Location of street lights  Show and dimension clear sight triangle at each site access point  Show location of all existing driveways fronting and near the subject site.
В.	Identify Alt 1 2 3.	ernate transportation facilities within site or adjacent to site Bikeways and bike-related facilities Pedestrian trails and linkages Transit facilities, including routes, bus bays and shelters existing or required
<b>4. Phasi</b> n A.	Proposed pro	phasing of improvements and provision for interim facilities. Indicate phasing plan, ocation and square footage of structures and associated improvements including parking and landscaping.
SHEET #2	- LANDSO	CAPING PLAN
$\frac{\checkmark}{\checkmark}$	<ol> <li>Bar Sca</li> <li>North A</li> <li>Propert</li> <li>Existing</li> <li>Identify</li> <li>A.</li> <li>B.</li> </ol>	arrow y Lines y and proposed easements y nature of ground cover materials

$\checkmark$	7.	Identify type, location and size of plantings (common and/or botanical names).
		<ul> <li>A. Existing, indicating whether it is to preserved or removed.</li> <li>B. Proposed, to be established for general landscaping.</li> <li>C. Proposed, to be established for screening/buffering.</li> </ul>
$\overline{\checkmark}$		Describe irrigation system – Phase I & II Planting Beds, indicating square footage of each bed
	10.	Turf Area - only 20% of landscaped area can be high water turf; provide square footage and percentage.
	11.	Responsibility for Maintenance (statement)
•		Landscaped area requirement; square footage and percent (specify clearly on plan) Landscaped buffer areas provided; dimensions, label clearly that it is a landscape buffer, square
		footage and percent (specify clearly on plan)
		Planting or tree well detail
<b>✓</b>	<u>.</u> 15.	Street Trees (only trees from the Official Albuquerque Plant Palette and Sizing list or 8 inch caliper or larger will be counted)
$\checkmark$	16.	Parking lot edges and interior – calculations, dimensions and locations including tree requirements
$\checkmark$	17.	Show Edge Buffer Landscaping (14-16-5-6(D)) — location, dimensions and plant material

### SHEET #3 -GRADING AND DRAINAGE PLAN

A separate grading and drainage plan (and drainage report) must be submitted to the DRS Hydrology Section prior to the DRB submittal for a site plan (See DRWS Form).

### A. General Information

Scale - must be same as Sheet #1 - Site Plan
 Bar Scale
 North Arrow
 Property Lines
 Existing and proposed easements
 Building footprints
 Location of Retaining walls

## **B.** Grading Information

On the plan sheet, provide a narrative description of existing site topography, proposed grading improvements and topography within 100 feet of the site.
 Indicate finished floor elevation and provide spot elevations for all corners of the site (existing and proposed) and points of maximum cut or fill exceeding 1 foot.
 Identify ponding areas, erosion and sediment control facilities.
 Cross Sections

 Provide cross section for all perimeter property lines where the grade change is greater than 4 feet at the point of the greatest grade change. Provide one additional cross section in each direction within no more than 100 feet of the reference point.

## SHEET #4- UTILITY PLAN

_	L	٩.	Fire hydrant locations, existing and proposed. (or submit signed off Fire One Plan)
_	<b>_</b> E	3.	Distribution lines
_ <b>`</b>	<u>/</u> (	Ξ.	Right-of-Way and easements, existing and proposed, on the property and adjacent to the
`			boundaries, with identification of types and dimensions.
V	<u>/</u> [	٥.	Existing water, sewer, storm drainage facilities (public and/or private).
_	<u>/</u> E	Ξ.	Proposed water, sewer, storm drainage facilities (public and/or private)
ر بد	<b>/</b> F	Ξ.	Existing electric lines both overhead and underground. Power Poles shown with dimensions t
•			osed buildings and structures must be clearly shown.

## SHEET #5 - BUILDING AND STRUCTURE ELEVATIONS

## A. General Information

<b>✓</b> A. <b>✓</b> B.	Scale Bar Scale
<b>√</b> C.	Detailed Building Elevations for each facade1. Identify facade orientation
	<ul> <li>Dimensions of facade elements, including overall height and width</li> <li>Location, material and colors of windows, doors and framing</li> <li>Materials and colors of all building elements and structures</li> <li>Location and dimensions of mechanical equipment (roof and/or ground mounted)</li> </ul>

## B. Building Mounted Signage $\checkmark$

1.	Site location(s)
2.	Sign elevations to scale
<u>3</u> .	Dimensions, including height and width
4.	Sign face area - dimensions and square footage clearly indicated
5.	Lighting
6.	Materials and colors for sign face and structural elements.
7·	List the sign restrictions per the IDO

# COORS BLVD AND ST. JOSEPHS DRIVE ALBUQUERQUE, NM

## INDEX OF DRAWINGS

C 3.0

**DEMOLITION PLAN** 

C 1.0 SITE DIMENSION PLAN

C 1.1 TRAFFIC CIRCULATION LAYOUT

SITE UTILITY PLAN

C 2.0 SITE GRADING PLAN

LANDSCAPE PLAN L -1

NOT FOR CONSTRUCTION
FOR REVIEW

NOTICE TO DEVELOPER/ CONTRACTOR

UNAPPROVED DRAWINGS REPRESENT WORK IN PROGRESS, ARE SUBJECT TO CHANGE, AND DO NOT CONSTITUTE

A FINISHED ENGINEERING PRODUCT. ANY WORK UNDERTAKEN BY DEVELOPER OR CONTRACTOR BEFORE PLANS ARE APPROVED IS UNDERTAKEN AT THE SOLE RISK OF THE DEVELOPER, INCLUDING BUT NOT LIMITED TO BIDS,

ESTIMATION, FINANCING, BONDING, SITE CLEARING, GRADING, INFRASTRUCTURE CONSTRUCTION, ETC.

**UTILITY DISCLAIMER** 

THE CONTRACTOR IS SPECIFICALLY CAUTIONED THAT THE LOCATION AND / OR ELEVATIONS OF EXISTING UTILITIES AS SHOWN ON THESE PLANS IS BASED ON RECORDS OF THE VARIOUS UTILITY COMPANIES AND WHERE POSSIBLE, CONTRACTOR MUST CALL THE LOCAL UTILITY LOCATION CENTER AT LEAST 48 HOURS BEFORE ANY EXCAVATION TO REQUEST EXACT FIELD LOCATIONS OF UTILITIES. IT SHALL BE THE RESPONSIBILITY OF THE CONTRACTOR TO RELOCATE

## NOTICE TO CONTRACTOR

ALL CONTRACTORS AND SUBCONTRACTORS PERFORMING WORK SHOWN ON OR RELATED TO THESE PLANS SHALL CONDUCT THEIR OPERATIONS SO THAT ALL EMPLOYEES ARE PROVIDED A SAFE PLACE TO WORK AND THE PUBLIC IS PROTECTED. ALL CONTRACTORS AND SUBCONTRACTORS SHALL COMPLY WITH THE "OCCUPATIONAL SAFETY AND HEALTH REGULATIONS OF THE U.S. DEPARTMENT OF LABOR AND THE STATE OF UTAH DEPARTMENT OF INDUSTRIAL RELATIONS CONSTRUCTION SAFETY ORDERS." THE CIVIL ENGINEER SHALL NOT BE RESPONSIBLE IN ANY WAY FOR THE CONTRACTORS AND SUBCONTRACTORS COMPLIANCE WITH SAID REGULATIONS AND ORDERS.

CONTRACTOR FURTHER AGREES TO ASSUME SOLE AND COMPLETE RESPONSIBILITY FOR JOB-SITE CONDITIONS DURING THE COURSE OF CONSTRUCTION OF THIS PROJECT, INCLUDING SAFETY OF ALL PERSONS AND PROPERTY, THAT THIS REQUIREMENT SHALL APPLY CONTINUOUSLY AND NOT BE LIMITED TO NORMAL WORKING HOURS, AND THAT THE CONTRACTOR SHALL DEFEND, INDEMNIFY AND HOLD THE OWNER AND THE CIVIL ENGINEER HARMLESS FROM ANY AND ALL LIABILITY, REAL OR ALLEGED IN CONNECTION WITH THE PERFORMANCE OF WORK ON THIS PROJECT, EXCEPTING FOR LIABILITY ARISING FROM THE SOLE NEGLIGENCE OF THE OWNER OR ENGINEER.

MAGGIE NUCKOLS 17877 VON KARMAN AVE, SUITE 500 **IRVINE, CA 92614** PHONE: 602-741-5695

**OWNER** 



## **GENERAL NOTES**

1. ALL WORK SHALL CONFORM WITH ALBUQUERQUE CITY, AND CHICK-FIL-A STANDARDS & SPECIFICATIONS.

3. CONTROL POINT: 60D NAIL WITH ALUMINUM DISK STAMPED "SURV-TEK CONTROL" N=1,502,746.35' E=


- 2. CALL NMOC 48 HOURS PRIOR TO DIGGING.
- I. CONTRACTOR SHALL FIELD VERIFY LOCATIONS OF ALL EXISTING UTILITIES BEFORE CONSTRUCTING ANY IMPROVEMENTS.


## ENGINEER/SURVEYOR:

# VICINITY MAP



# SALT LAKE CITY LAYTON 45 W. 10000 S., Suite 500 Phone: 801.547.1100 TOOELE Phone: 801.255.0529 Phone:435.843.3590 Fax: 801.255.4449 **CEDAR CITY** WWW.ENSIGNUTAH.COM Phone:435.865.1453

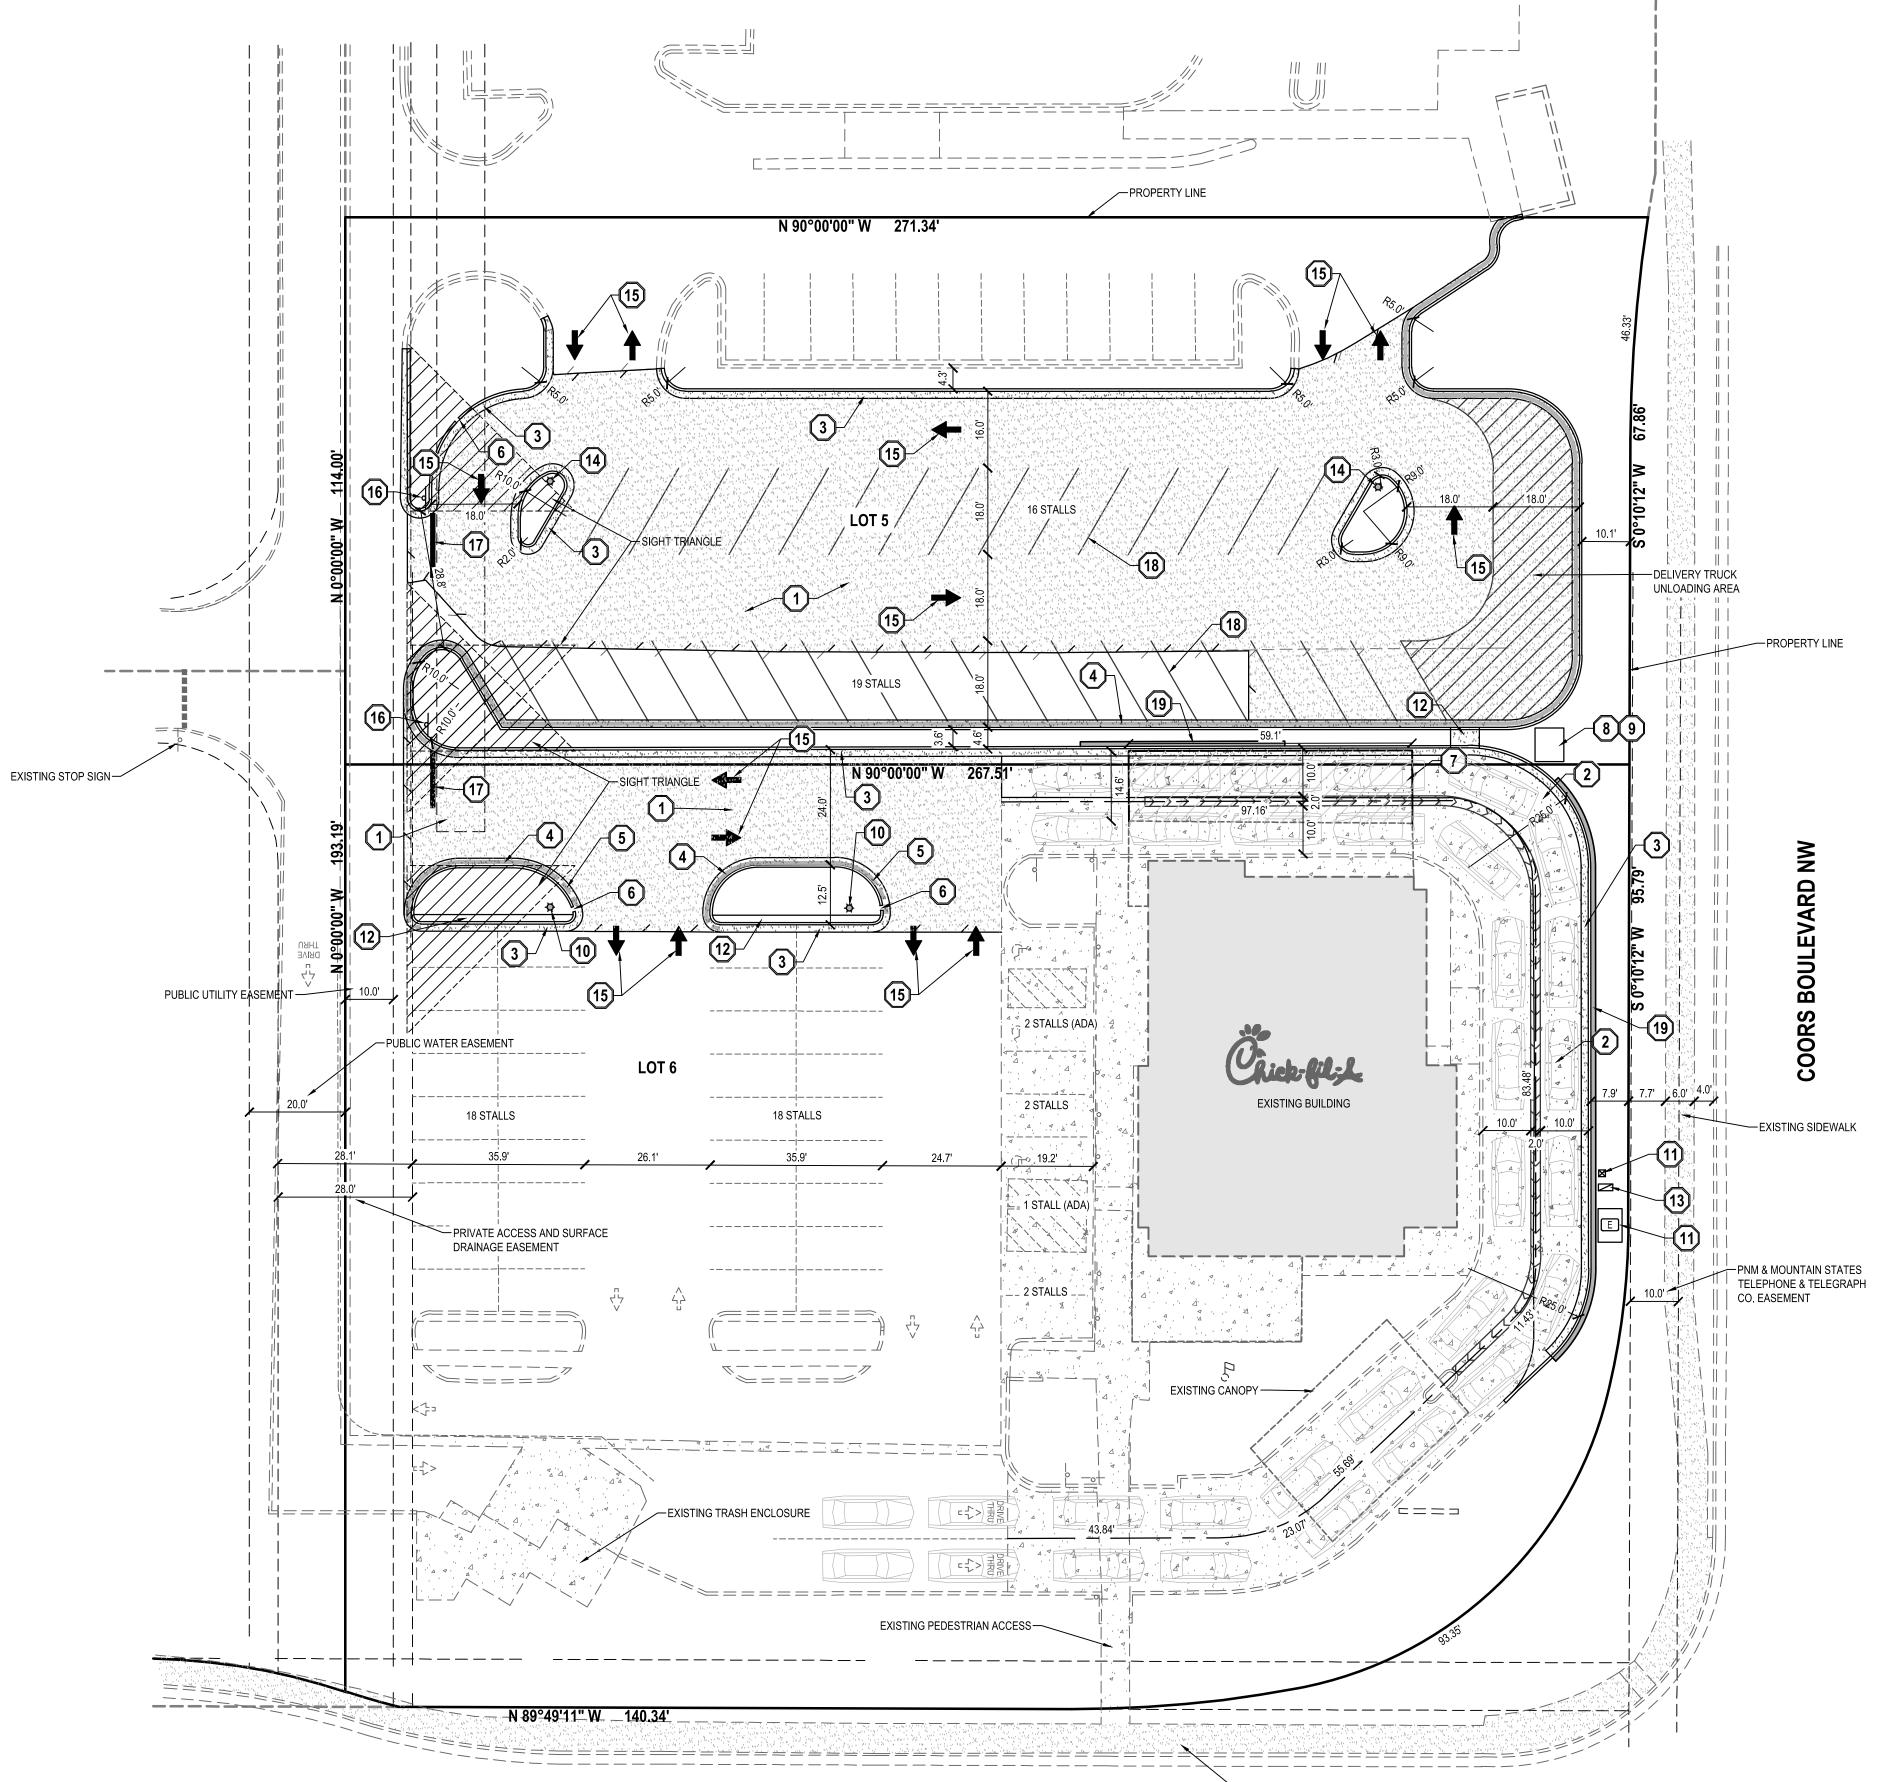

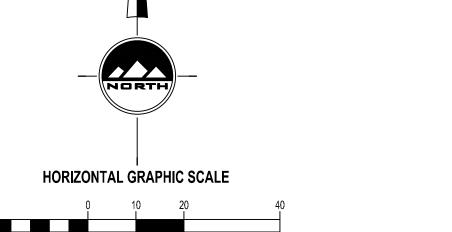


HORZ: 1 inch = 20 ft.

ST. JOSEPHS DRIVE

EXISTING SIDEWALK

## VICINITY MAP

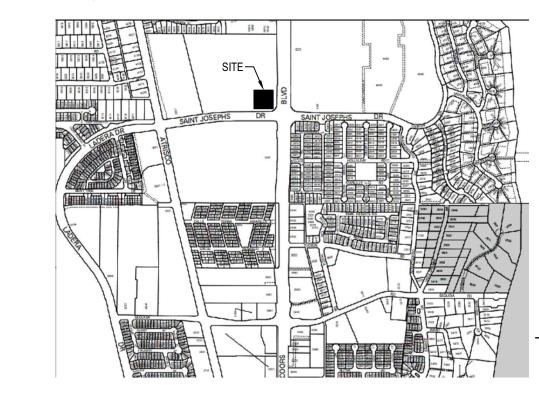

## **GENERAL NOTES**

- 1. ALL WORK TO COMPLY WITH THE GOVERNING AGENCY'S STANDARDS AND SPECIFICATIONS.
- 2. ALL IMPROVEMENTS MUST COMPLY WITH ADA STANDARDS AND RECOMMENDATIONS.
- 3. SEE LANDSCAPE/ARCHITECTURAL PLANS FOR CONCRETE MATERIAL, COLOR, FINISH, AND SCORE PATTERNS THROUGHOUT SITE.
- 4. ALL PAVEMENT MARKINGS SHALL CONFORM TO THE LATEST EDITION OF THE M.U.T.C.D. (MANUAL ON UNIFORM TRAFFIC CONTROL DEVICES).
- 5. ALL SURFACE IMPROVEMENTS DISTURBED BY CONSTRUCTION SHALL BE RESTORED OR REPLACED, INCLUDING TREES AND DECORATIVE SHRUBS, SOD, FENCES, WALLS AND STRUCTURES, WHETHER OR NOT THEY ARE SPECIFICALLY SHOWN ON THE CONTRACT DOCUMENTS.
- 6. NOTIFY ENGINEER OF ANY DISCREPANCIES IN DESIGN OR STAKING BEFORE PLACING CONCRETE OR ASPHALT.
- 7. THE CONTRACTOR IS TO PROTECT AND PRESERVE ALL EXISTING IMPROVEMENTS, UTILITIES, AND SIGNS, ETC UNLESS OTHERWISE NOTED ON THESE PLANS.

## SCOPE OF WOR

PROVIDE, INSTALL AND/OR CONSTRUCT THE FOLLOWING PER THE SPECIFICATIONS GIVEN OR REFERENCED, THE DETAILS NOTED, AND/OR AS SHOWN ON THE CONSTRUCTION DRAWINGS:

- 1 ASPHALT PAVEMENT. SEE DETAIL 1/C-3.0.
- 2 CONCRETE PAVEMENT DRIVE-THRU. SEE DETAIL 2/C-3.0.
- 24" CATCHING CURB AND GUTTER PER DETAIL 3/C-3.0.
- 4 24" SPILLING CURB AND GUTTER PER DETAIL 3/C-3.0.
- TRANSITION BETWEEN CATCHING AND SPILLING CURB AND GUTTER.
- 6 1' CURB OPENING.
- 7 PROPOSED CANOPY. SEE ARCHITECTURAL DRAWINGS.
- 8 CONCRETE PAD FOR ELECTRICAL EQUIPMENT. SEE ELECTRICAL PLANS FOR ADDITIONAL INFORMATION.
- 9 RELOCATED ELECTRICAL TRANSFORMER. SEE ELECTRICAL PLANS FOR ADDITIONAL INFORMATION.
- 10 RELOCATED LIGHT POLE. SEE ELECTRICAL PLANS FOR ADDITIONAL INFORMATION.
- RELOCATED ELECTRICAL EQUIPMENT. SEE ELECTRICAL PLANS FOR ADDITIONAL INFORMATION.
- (12) CONCRETE SIDEWALK. SEE DETAIL 5/C-3.0.
- RELOCATED COMMUNICATIONS EQUIPMENT. COORDINATE WITH SERVICE PROVIDER.
- PROPOSED LIGHT POLE. SEE ELECTRICAL PLANS FOR ADDITIONAL INFORMATION.
- 15 PAINTED LANE-USE ARROWS. SEE DETAIL 4/C-3.0.
- 16 "STOP" SIGN.
- 17 12' SOLID STOP BAR.
- 4" WIDE SOLID PAVEMENT MARKING PER PARKING LOT STRIPING SPECIFICATIONS. SEE 5/C-3.0.
- 19 RETAINING WALL. SEE GRADING PLANS FOR ELEVATIONS.

PARKING DATA TABLE	
EXISTING STALLS TO BE REMOVED	4
PROPOSED STALLS	35
EXISTING STALLS (TO REMAIN)	40
EXISTING ADA STALLS (TO REMAIN)	3
TOTAL STALLS	78

## LEGEND

- EXISTING BOLLARD
- O PROPOSED BOLLARD
- EXISTING SIGN
- PROPOSED SIGN
- EXISTING FLAG POLE
- PROPOSED EDGE OF ASPHALT
- ---- EXISTING STRIPING
- PROPOSED STRIPING
- EXISTING WALL

  PROPOSED ASPHALT
- PROPOSED CURB AND GUTTER
- PROPOSED CURB AND GUTTER

  PROPOSED REVERSE PAN CURB AND GUTTER
- TRANSITION TO REVERSE PAN CURB
- EXISTING CONCRETE

  PROPOSED CONCRETE
- EXISTING BUILDING

  EXISTING MONUMENT SIGN





5200 Buffington Rd Atlanta Georgia,

atianta Georgia, 30349-2998

Revisions:

Mark Date By

Mark Date By

Mark Date By





**SALT LAKE CITY**45 W. 10000 S., Suite 500
Sandy, UT 84070
Phone: 801.255.0529

WWW.ENSIGNENG.COM

Fax: 801.255.4449

STORE CHICK-FIL-A

FSU #04107 COORS BLVD.

COORS BLVD NW & ST JOSEPHS DR NW

ALBUQUERQUE, NM

87120

SHEET TITLE
SITE PLAN

VERSION:

ISSUE DATE:

 Job No.
 : 11274


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 : 04107


 Date
 : 6/21/22

Drawn By : MM Checked By: DJ

Sheet

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Mark Date	

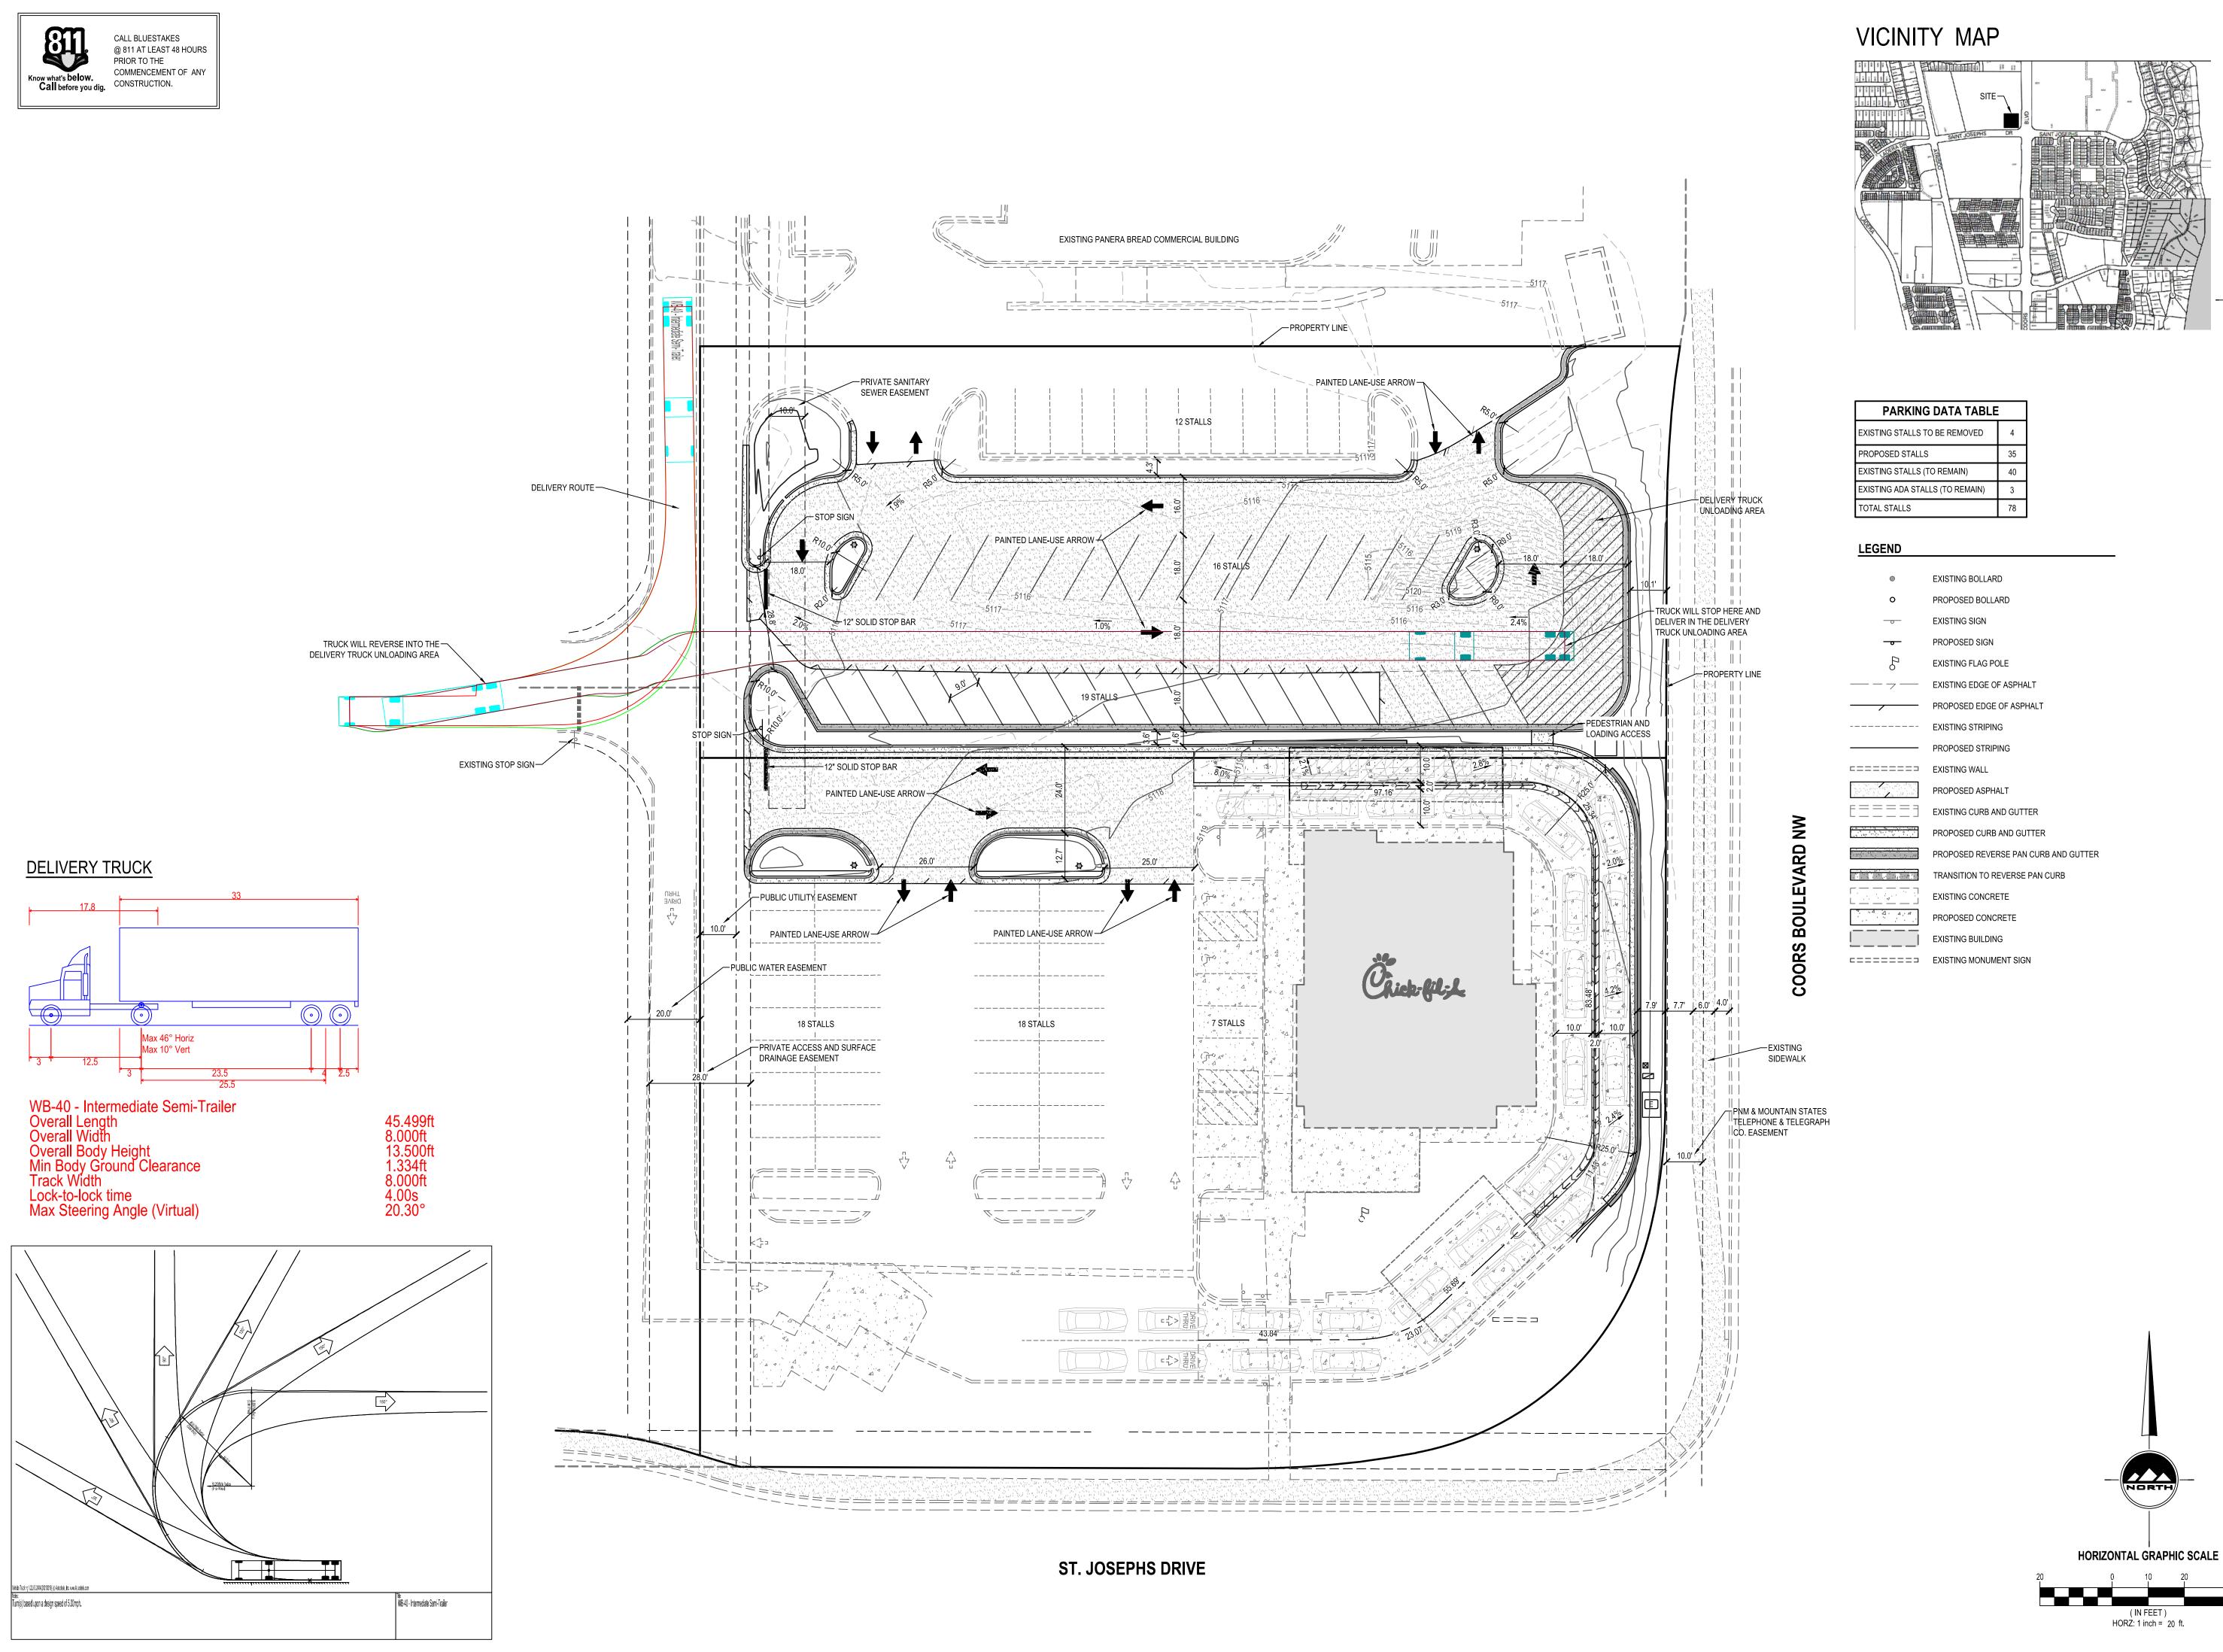

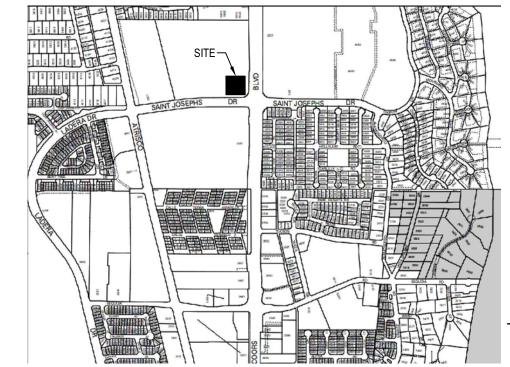Mark Date By



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STORE CHICK-FIL-A FSU #04107 COORS BLVD.

COORS BLVD NW & ST JOSEPHS DR NW ALBUQUERQUE, NM

SHEET TITLE TRAFFIC CIRCULATION LAYOUT

VERSION: ISSUE DATE:

Job No. : <u>11274</u> : <u>04107</u> Store :6/21/22 Drawn By : MM Checked By: DJ

Sheet




## FIRM MAP NO 35001C0114H



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FFE = 5120.00

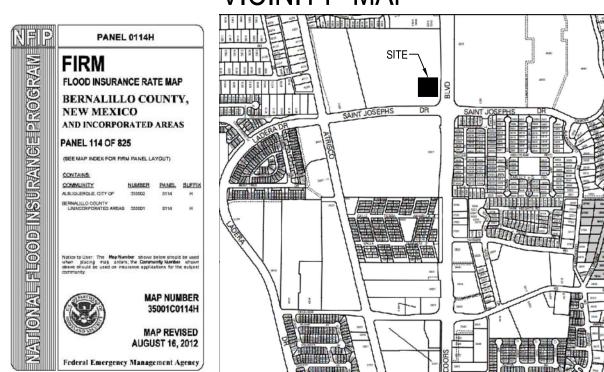

1. ALL WORK TO COMPLY WITH THE GOVERNING AGENCY'S STANDARDS AND SPECIFICATIONS. 2. ALL IMPROVEMENTS MUST COMPLY WITH ADA STANDARDS AND RECOMMENDATIONS.

3. THE CONTRACTOR SHALL BECOME FAMILIAR WITH THE EXISTING SOIL CONDITIONS. 4. ELEVATIONS HAVE BEEN TRUNCATED FOR CLARITY. XX.XX REPRESENTS AN ELEVATION OF 51XX.XX ON 5. LANDSCAPED AREAS REQUIRE SUBGRADE TO BE MAINTAINED AT A SPECIFIC ELEVATION BELOW FINISHED

6. ALL STORM DRAIN INFRASTRUCTURE TO BE INSTALLED PER GOVERNING AGENCY OR APWA STANDARD PLANS

GRADE AND REQUIRE SUBGRADE TO BE PROPERLY PREPARED AND SCARIFIED. SEE LANDSCAPE PLANS FOR

7. THE CONTRACTOR SHALL ADJUST TO GRADE ALL EXISTING UTILITIES AS NEEDED PER LOCAL GOVERNING

AGENCY'S STANDARDS AND SPECIFICATIONS. 8. NOTIFY ENGINEER OF ANY DISCREPANCIES IN DESIGN OR STAKING BEFORE PLACING CONCRETE, ASPHALT, OR STORM DRAIN STRUCTURES OR PIPES.

9. THE CONTRACTOR IS TO PROTECT AND PRESERVE ALL EXISTING IMPROVEMENTS, UTILITIES, AND SIGNS, ETC. UNLESS OTHERWISE NOTED ON THESE PLANS.

 $[\frac{h(j,k)}{h_{j,k}}] = [-1]$ 

- [종]중기 - [[-]

MS 11

[M] [A] | [H]

- MA III 

THE PROPOSED SITE IS LOT 5 OF COORS PAVILION AND IS 0.7 ACRES LOCATED ON THE NORTH SIDE OF ST. JOSEPH'S BLVD. AND THE WEST SIDE OF COORS BLVD. THE PROPOSED DEVELOPMENT WILL BE A PARKING LOT TO EXPAND THE EXISTING PARKING LOT.

THE PROJECT, AS SHOWN ON FEMA'S FLOOD INSURANCE RATE MAP 35001C011H, DATED AUGUST 16, 2012 IS NOT WITHIN A DESIGNATED 100-YEAR FLOODPLAIN. AN EXHIBIT WITH THE SITE SHOWN ON THE FIRM PANEL IS INCLUDED

THE HYDROLOGY FOR THIS PROJECT WAS ANALYZED USING THE RATIONAL METHOD.

THE 100-YR 12-MIN DURATION STORM WAS USED AS THE DESIGN STORM FOR THIS ANALYSIS. THIS SITE IS WITHIN ZONE 1 AS IDENTIFIED IN THE CITY OF ALBUQUERQUE DEVELOPMENT MANUAL, SECTION 22.2

THE SITE IS WITHIN THE AREA OF THE COORS PAVILION DRAINAGE MASTER PLAN DATED FEBRUARY 22, 2017. THE EXISTING DRAINAGE FLOWS TO THE NORTHWEST TO A PROPOSED POND FOR SHARED USE BY LOTS INCLUDED IN THE MASTER DRAINAGE PLAN.

THE SITE WILL BE DEVELOPED WITH SITE FLOWS FROM LOT 5 AND PART OF LOT 6 DIRECTED INTO A CONCRETE PAN IN THE MIDDLE OF THE PRIVATE DRIVE ON THE WEST SIDE OF THE SITE VIA A COMBINATION OF CURB AND GUTTER AND OVERLAND FLOW. THE PAN WILL ULTIMATELY DIRECT THE FLOW INTO THE FIRST FLUSH POND PROVIDED BY THE DEVELOPMENT. THE 100 YEAR PEAK RUNOFF FROM THIS DEVELOPMENT IS IN ACCORDANCE WITH THE MASTER DRAINAGE REPORT. RUNOFF ADJACENT TO COORS BLVD AND ST. JOSEPH'S DR WILL BE CAPTURED BY AN EXISTING INFILTRATION TRENCH AT THE REAR OF THE EXISTING SIDEWALK, ALLOWING NO RUNOFF FROM THIS SITE TO ENTER EITHER ROADWAY RIGHT-OF-WAY.

LOT DRAINAGE AS DEPICTED ON THIS PLAN SHALL BE MAINTAINED. LOT DEPICTED HEREON SHALL BE RESPONSIBLE FOR MAINTAINING FIRST FLUSH RUNOFF RETENTION INDICATED

ON THE LOT IMMEDIATELY PRIOR TO DISCHARGE. THE TOTAL VOLUME SHALL BE EQUAL TO: IMPERVIOUS AREA \* (0.44-0.10) / 12 IN CUBIC FEET.

IMPERVIOUS AREA = 22946 SQ.FT.

REQUIRED VOLUME = 650 CU.FT.

PROVIDED VOLUME ON SITE (BASIN A) = 0 CU.FT.

PROVIDED VOLUME IN POND = 1289 CU.FT.

AREA = .41 AC

1) 100 YR RUNOFF (CFS) = 1.68 10 YR RUNOFF (CFS) = 1.04 2 YR RUNOFF (CFS) = .65

AREA = .12 AC 100 YR RUNOFF (CFS) = .49 10 YR RUNOFF (CFS) = .31


2 YR RUNOFF (CFS) = 19


**EROSION CONTROL NOTES** CONTRACTOR IS RESPONSIBLE FOR OBTAINING A TOPSOIL DISTURBANCE PERMIT PRIOR TO BEGINNING


2. CONTRACTOR IS RESPONSIBLE FOR MAINTAINING RUN-OFF ON SITE DURING CONSTRUCTION.

3. CONTRACTOR IS RESPONSIBLE FOR CLEANING ALL SEDIMENT THAT GETS INTO EXISTING RIGHT-OF-WAY. 4. REPAIR OF DAMAGED FACILITIES AND CLEANUP OF SEDIMENT ACCUMULATION ON ADJACENT PROPERTIES AND IN PUBLIC FACILITIES IS THE RESPONSIBILITY OF THE CONTRACTOR.

5. ALL EXPOSED EARTH SURFACES MUST BE PROTECTED FROM WIND AND WATER EROSION PRIOR TO FINAL (CITY) ACCEPTANCE OF ANY PROJECT.

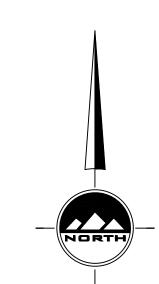

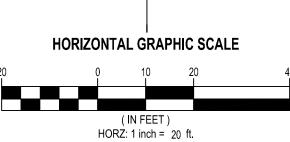

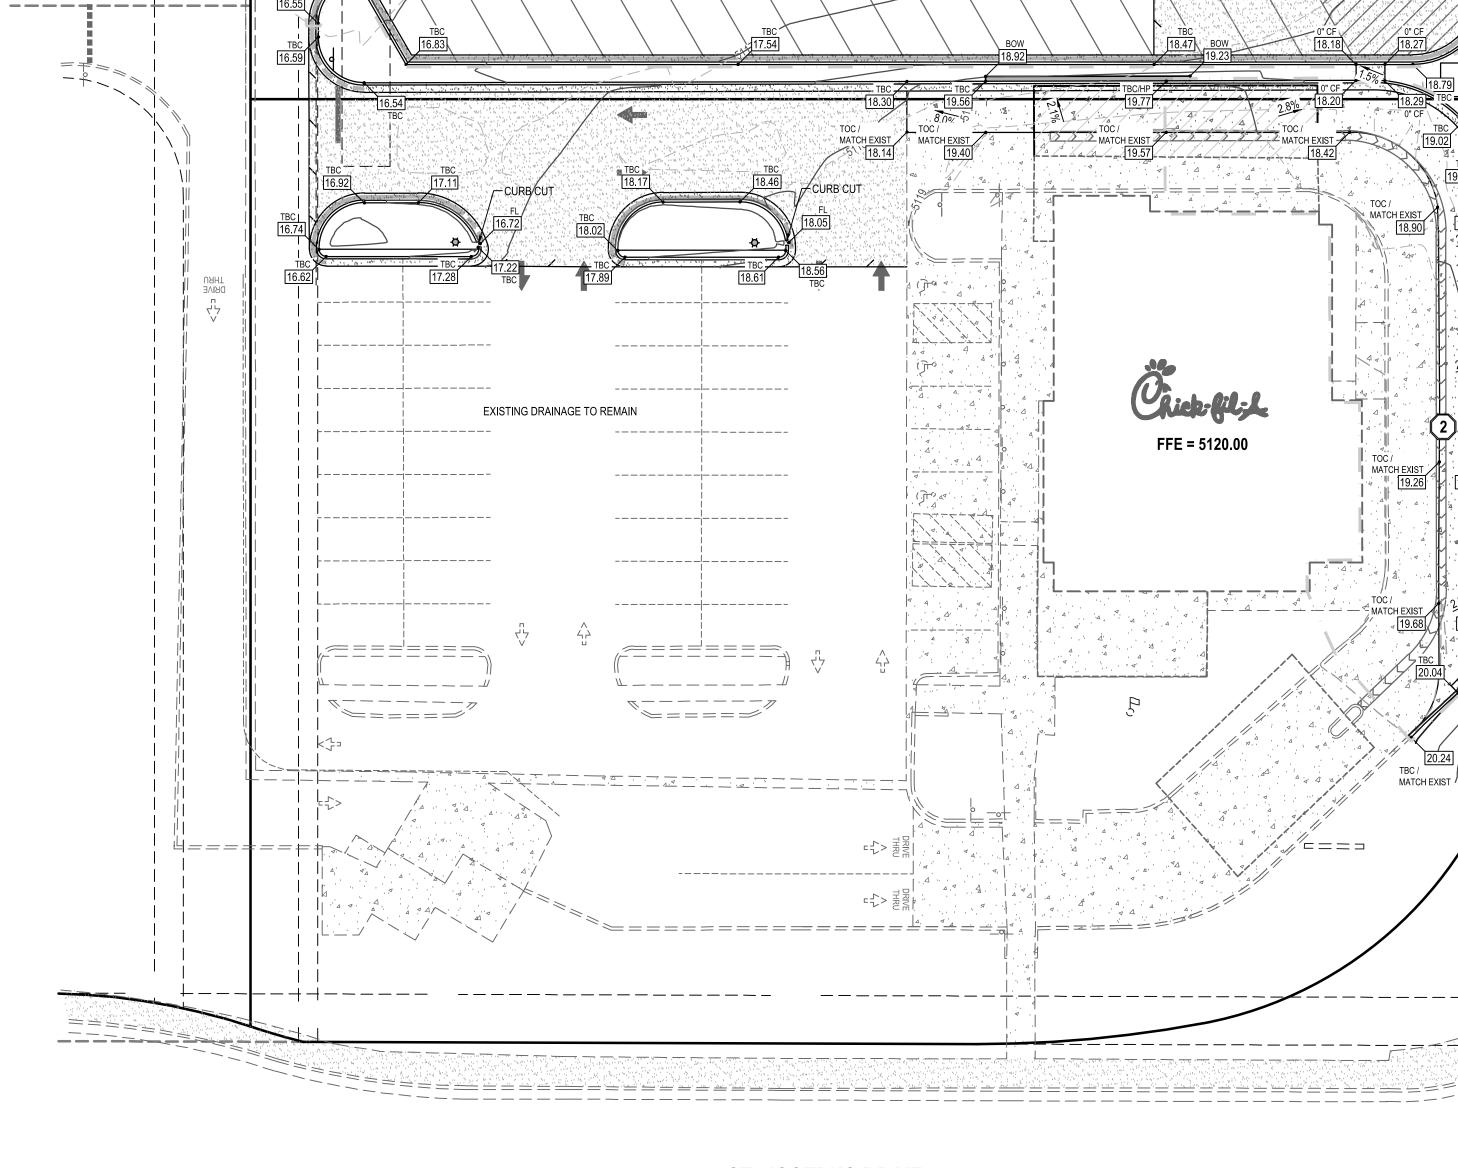

ST. JOSEPHS DRIVE

5200 Buffington Rd Atlanta Georgia, 30349-2998

Revisions: Mark Date By

Mark Date By

|Mark Date By



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CHICK-FIL-A FSU #04107 COORS BLVD.


COORS BLVD NW & ST JOSEPHS DR NW ALBUQUERQUE, NM 87120

SHEET TITLE GRADING AND DRAINAGE PLAI

VERSION: ISSUE DATE:

Job No. : 11274 Store :6/21/22 Drawn By : MM

Checked By: DJ Sheet

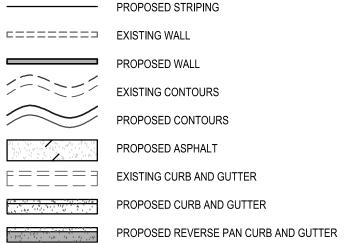

EXISTING BOLLARD

PROPOSED BOLLARD

EXISTING SIGN

PROPOSED SIGN

EXISTING FLAG POLE

EXISTING EDGE OF ASPHALT


PROPOSED EDGE OF ASPHALT

TRANSITION TO REVERSE PAN CURB **EXISTING CONCRETE** 

PROPOSED CONCRETE EXISTING BUILDING

LEGEND

EXISTING MONUMENT SIGN CATCHMENTS / BASINS

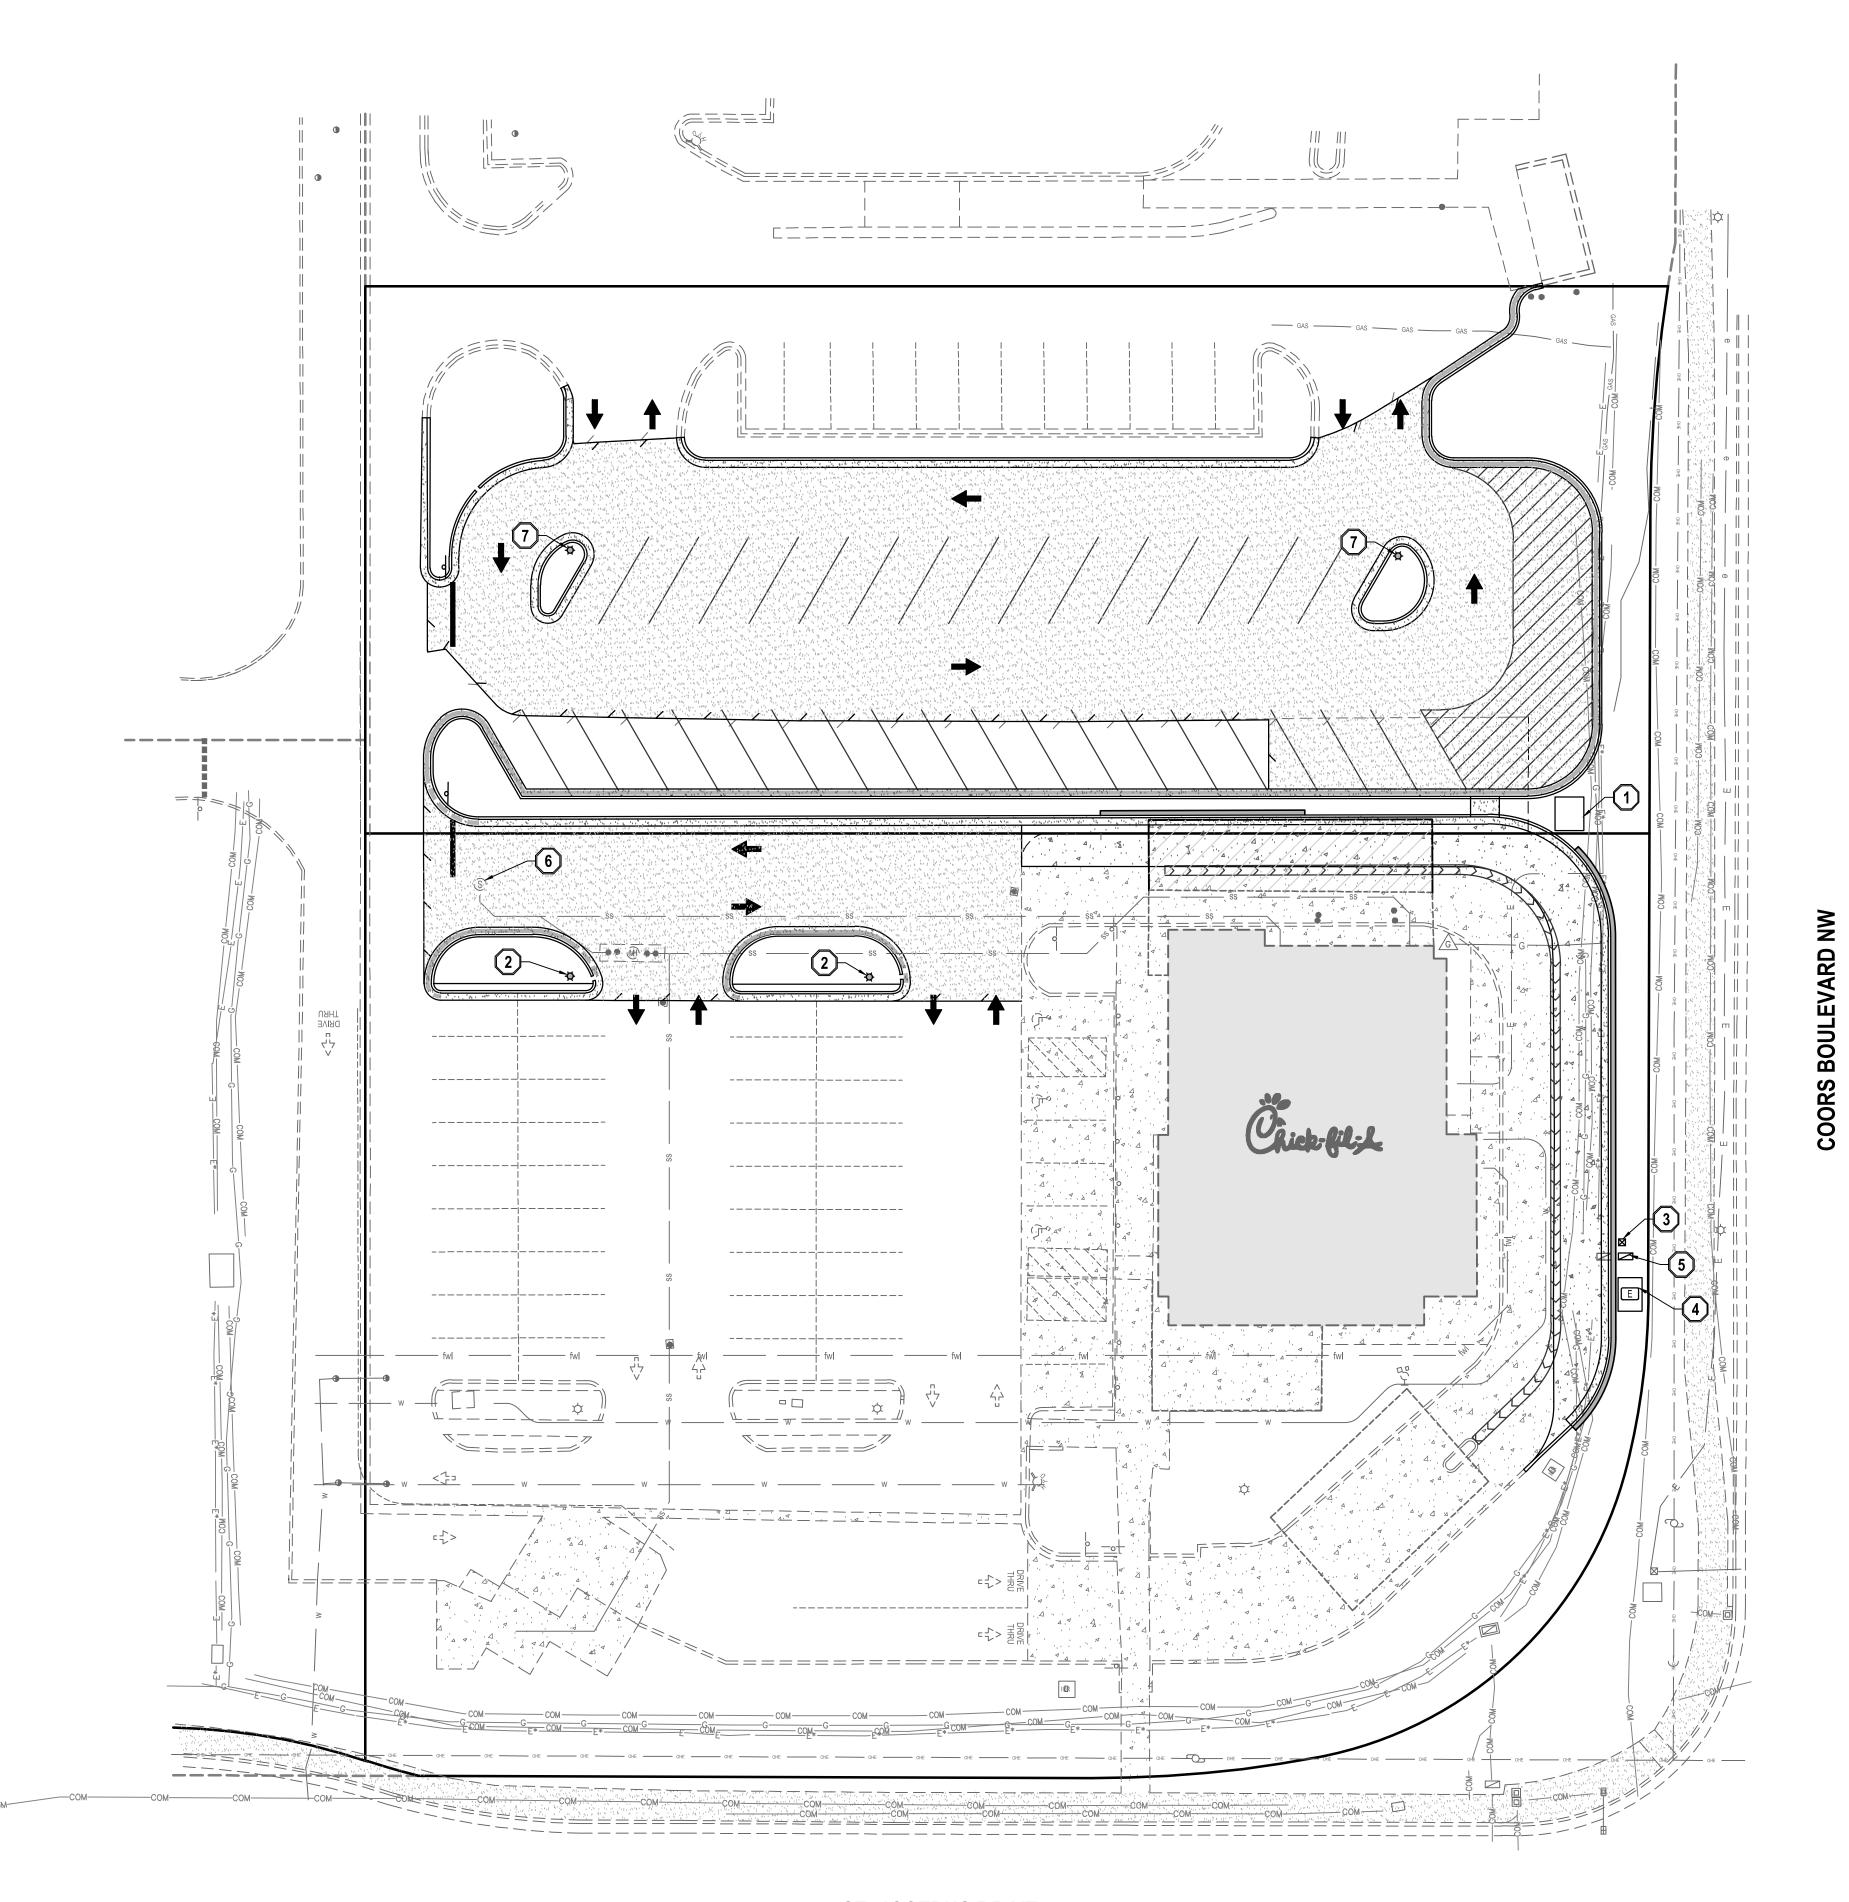

ST. JOSEPHS DRIVE

## **GENERAL NOTES**

- 1. ALL WORK TO COMPLY WITH THE GOVERNING AGENCY'S STANDARDS AND SPECIFICATIONS.
- 2. EXISTING UNDERGROUND UTILITIES AND IMPROVEMENTS ARE SHOWN IN THEIR APPROXIMATE LOCATIONS BASED UPON RECORD INFORMATION AVAILABLE AT THE TIME OF PREPARATION OF THESE PLANS. LOCATIONS MAY NOT HAVE BEEN VERIFIED IN THE FIELD AND NO GUARANTEE IS MADE AS TO THE ACCURACY OR COMPLETENESS OF THE INFORMATION SHOWN. IT SHALL BE THE RESPONSIBILITY OF THE CONTRACTOR TO DETERMINE THE EXISTENCE AND LOCATION OF THE UTILITIES SHOWN ON THESE PLANS OR INDICATED IN THE FIELD BY LOCATING SERVICES. ANY ADDITIONAL COSTS INCURRED AS A RESULT OF THE CONTRACTOR'S FAILURE TO VERIFY THE LOCATIONS OF EXISTING UTILITIES PRIOR TO THE BEGINNING OF CONSTRUCTION IN THEIR VICINITY SHALL BE BORNE BY THE CONTRACTOR AND ASSUMED INCLUDED IN THE CONTRACT. THE CONTRACTOR IS TO VERIFY ALL CONNECTION POINTS WITH THE EXISTING UTILITIES. THE CONTRACTOR IS RESPONSIBLE FOR ANY DAMAGE CAUSED TO THE EXISTING UTILITIES AND UTILITY STRUCTURES THAT ARE TO REMAIN. IF CONFLICTS WITH EXISTING UTILITIES OCCUR, THE CONTRACTOR SHALL NOTIFY THE ENGINEER PRIOR TO CONSTRUCTION TO DETERMINE IF ANY FIELD ADJUSTMENTS SHOULD BE MADE.
- 3. ALL SANITARY SEWER INFRASTRUCTURE TO BE INSTALLED PER GOVERNING AGENCY STANDARD PLANS AND SPECIFICATIONS.
- 4. ALL WATER INFRASTRUCTURE TO BE INSTALLED PER GOVERNING AGENCY OR APWA STANDARD PLANS AND SPECIFICATIONS.
- 6. DEFLECT OR LOOP ALL WATERLINES TO AVOID CONFLICTS WITH OTHER UTILITIES PER GOVERNING AGENCY'S STANDARDS AND SPECIFICATIONS.
- 7. PROJECT SHALL COMPLY WITH ALL NEW MEXICO DIVISION OF DRINKING WATER RULES AND REGULATIONS INCLUDING, BUT NOT LIMITED TO, THOSE PERTAINING TO BACKFLOW PROTECTION AND CROSS CONNECTION DREVENTION.
- 8. THE CONTRACTOR IS TO COORDINATE ALL UTILITIES WITH MECHANICAL/PLUMBING PLANS.
- 9. CONTRACTOR TO FIELD VERIFY LOCATION OF UTILITY LINES.

UNLESS OTHERWISE NOTED ON THESE PLANS.

- 10. NOTIFY ENGINEER OF ANY DISCREPANCIES IN DESIGN OR STAKING BEFORE PLACING UTILITY STRUCTURES OR PIPES.
- THE CONTRACTOR SHALL ADJUST TO GRADE ALL EXISTING UTILITIES AS NEEDED PER LOCAL GOVERNING AGENCY'S STANDARDS AND SPECIFICATIONS.
- 12. THE CONTRACTOR IS TO PROTECT AND PRESERVE ALL EXISTING IMPROVEMENTS, UTILITIES, AND SIGNS, ETC.

## SCOPE OF WORK:

PROVIDE, INSTALL AND/OR CONSTRUCT THE FOLLOWING PER THE SPECIFICATIONS GIVEN OR REFERENCED, THE DETAILS NOTED, AND/OR AS SHOWN ON THE CONSTRUCTION DRAWINGS:

- 1 RELOCATED ELECTRICAL TRANSFORMER. SEE ELECTRICAL PLANS FOR ADDITIONAL INFORMATION.
- (2) RELOCATED LIGHT POLE. SEE ELECTRICAL PLANS FOR ADDITIONAL INFORMATION.
- 3 RELOCATED ELECTRICAL PEDESTAL. SEE ELECTRICAL PLANS FOR ADDITIONAL INFORMATION.
- RELOCATED ELECTRICAL VAULT. SEE ELECTRICAL PLANS FOR ADDITIONAL INFORMATION.
- (5) RELOCATED TELEPHONE PEDESTAL. COORDINATE WITH SERVICE PROVIDER.
- 6 ADJUST SEWER MAHOLE RIM TO GRADE.
- 7 PROPOSED LIGHT POLE. SEE ELECTRICAL PLANS FOR ADDITIONAL INFORMATION.

## LEGEND

- EXISTING WATER METER
- EXISTING WATER MANHOLE
- W EVICTING WATER
- W EXISTING WATER BOX
- EXISTING WATER VALVEEXISTING FIRE HYDRANT
- EXISTING SECONDARY WATER VALVE
- EXISTING IRRIGATION BOX
- EXISTING IRRIGATION VALVE
- EXISTING SANITARY SEWER MANHOLE

EXISTING GREASE TRAP MANHOLE

- EXISTING SANITARY CLEAN OUT
- EXISTING STORM DRAIN CLEAN OUT BOX
- EXISTING STORM DRAIN INLET BOX
- EXISTING STORM DRAIN CATCH BASIN
- EXISTING STORM DRAIN COMBO BOX
- EXISTING STORM DRAIN CLEAN OUT


  EXISTING ELECTRICAL PEDESTAL
- E EXISTING ELECTRICAL BOX
- EXISTING TRANSFORMER
- © EXISTING POWER POLE
- ▶ PROPOSED LIGHT
- EXISTING OVERHEAD TRAFFIC LIGHT POLE

EXISTING GAS METER

- EXISTING GAS VALVE
- EXISTING TRAFFIC SIGNAL BOX
- CABLE EXISTING CABLE BOX
- — ss — EXISTING SANITARY SEWER
- — w EXISTING CULINARY WATER LINE
- — fwl — EXISTING SECONDARY WATER LINE
- irr EXISTING IRRIGATION LINE

  OHE EXISTING OVERHEAD POWER LINE
- — E — EXISTING ELECTRICAL LINE
- G EXISTING GAS LINE
- — COM— EXISTING COMMUNICATIONS LINE

NOTE: MAY CONTAIN SYMBOLS THAT ARE NOT USED.

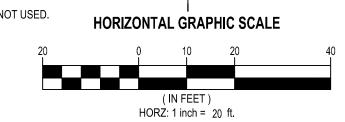



Chick-fil;&

5200 Buffington Rd. Atlanta Georgia,

30349-2998

Revisions: Mark Date By

Mark Date By

Mark Date By

Seal

NEXTON

12354



**SALT LAKE CITY**45 W. 10000 S., Suite 500
Sandy, UT 84070
Phone: 801.255.0529

WWW.ENSIGNENG.COM

Fax: 801.255.4449

STORE
CHICK-FIL-A
FSU #04107

COOR'S BLVD.

COORS BLVD NW & ST
JOSEPHS DR NW
ALBUQUERQUE, NM

SHEET TITLE UTILITY PLAN

87120

VERSION:


ISSUE DATE:

Job No. : 11274 Store : 04107 Date : 6/21/22

Drawn By : MM Checked By: DJ

Sheet

C-3.0

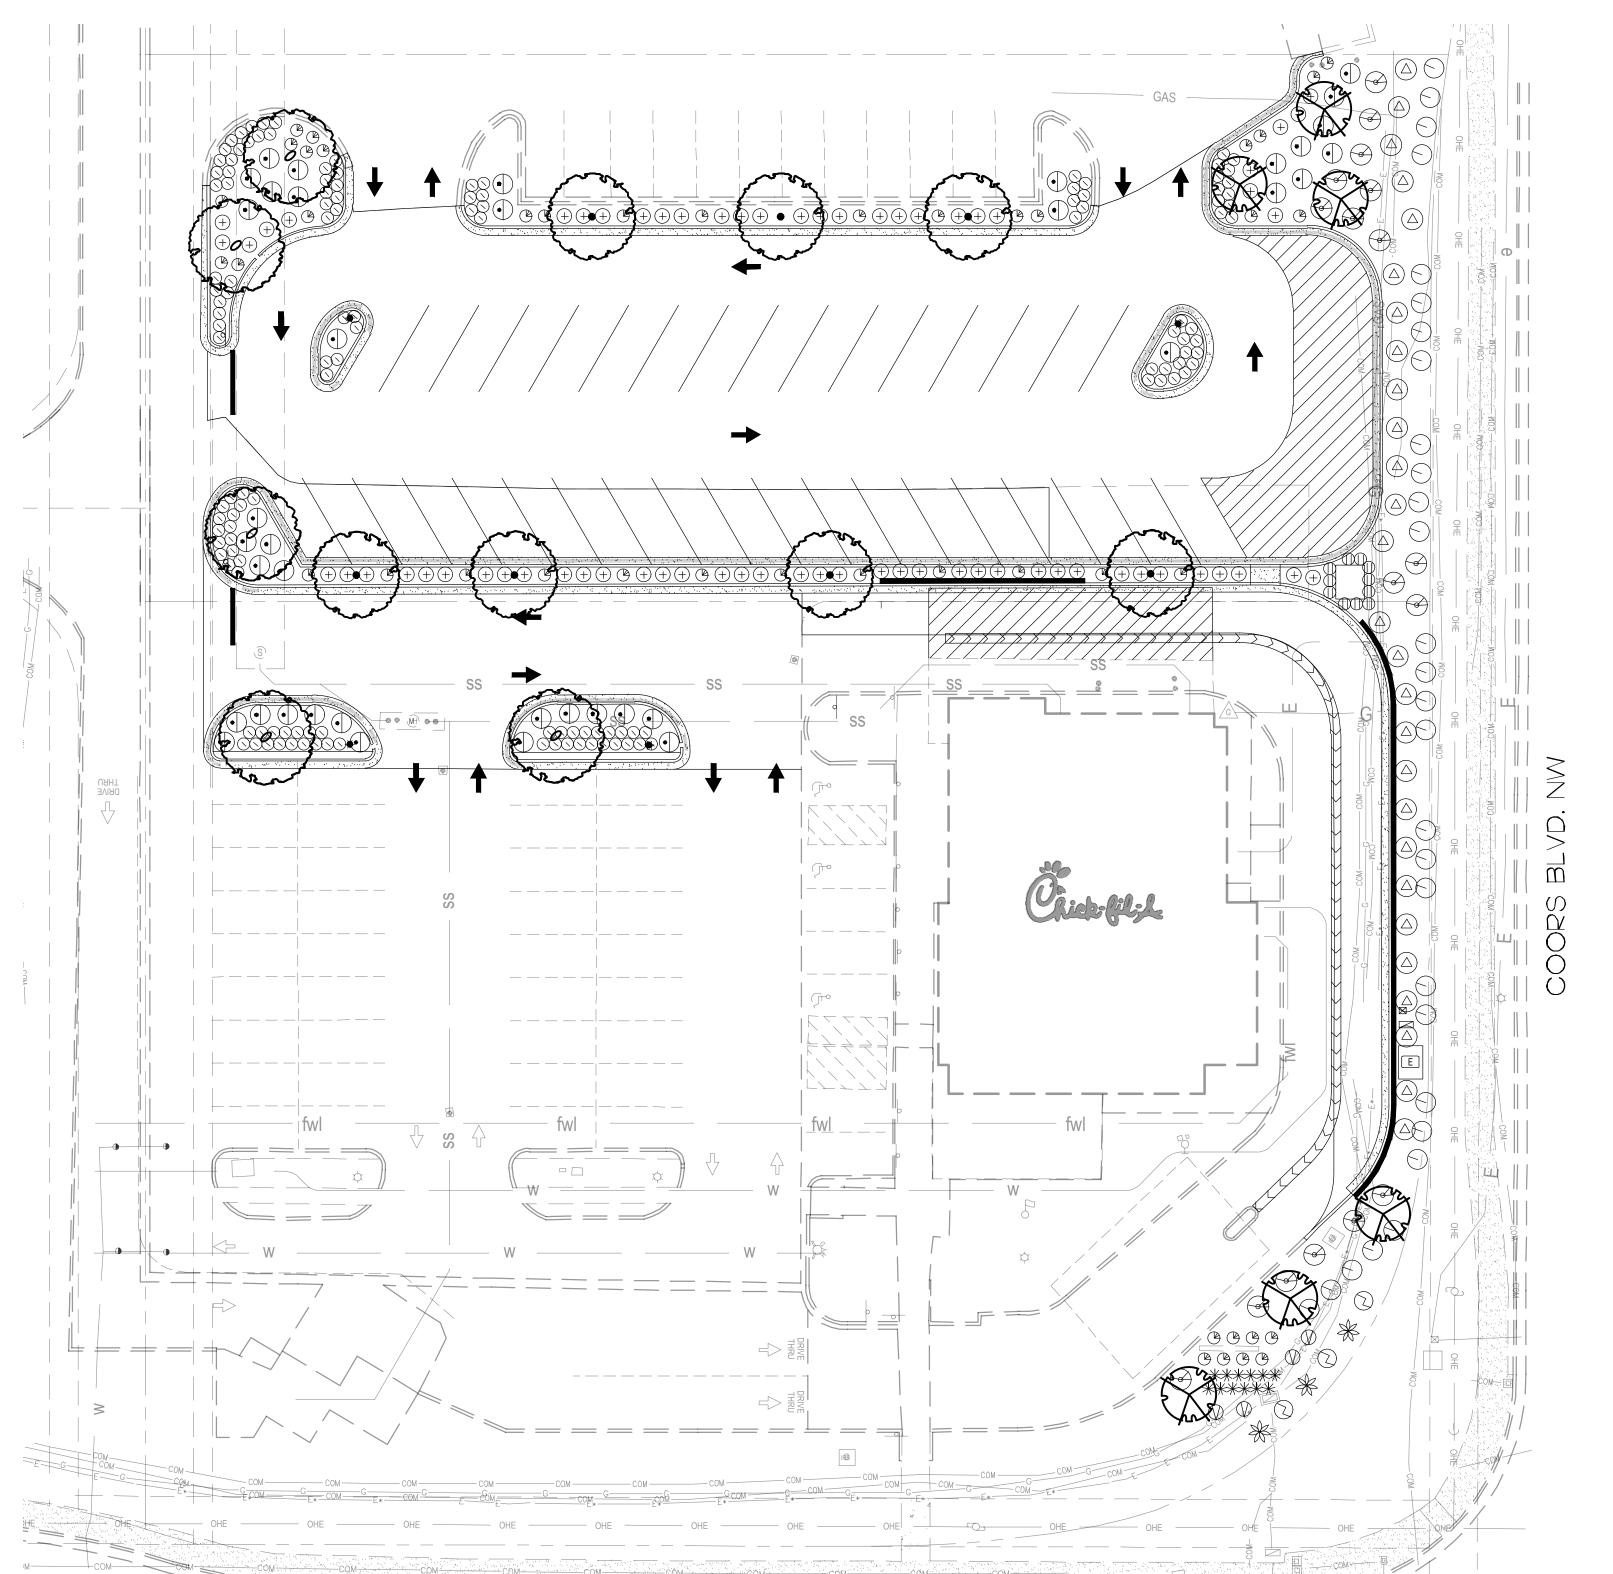

ST. JOSEPH'S DR.

PLANTING LEGEND

SYMBC		BOTANICAL NAME EES	COMMON NAME	SIZE	QTY.	REMARKS
پرچمر <sub>کو</sub>						
Se de la company	Secretary of the	ULMUS 'ACCOLADE'	ACCOLADE ELM	24" BOX	5	STANDARD 2" MIN. CALIPER
No.		COELREUTERIA PANICULATA	GOLDEN RAIN TREE	24" BOX	7	STANDARD 2" MIN. CALIPER
	) was	CHILOPSIS LINEARIS	DESERT WILLOW	24" BOX	6	STANDARD 2" MIN. CALIPER
<b>, –</b> .	<u>SH</u>	<u>RUBS</u>				
	*	NOLINA MICROCARPA	SACAHUISTA	5 GAL.	3	AS SHOWN
		ARCTOSTAPHYLOS X, C, 'CHIEFTAIN'	MANZANITA	5 GAL	17	AS SHOWN
	(+)	AMORPHA CANESCENS	LEADPLANT	5 GAL.	67	AS SHOWN
	*	BOUTELOUA G. 'BLONDE AMBITION'	BLUE GRAMA	1 GAL	12	2'-6" O.C.
	•	PRUNUS B. 'PAWNEE BUTTES'	SAND CHERRY	5 GAL	39	AS SHOWN
	$\odot$	PANICUM V. 'SHENENDOAH'	BURGUNDY SWITCH GRASS	I GAL.	132	2'-6" O.C.
	$\bigcirc$	CYTISUS S. 'MOONLIGHT'	MOONLIGHT SCOTCH BROOM	5 GAL.	4	AS SHOWN
	<b>(</b>	HESPERALOE PARVIFOLIA	RED YUCCA	5 GAL	43	AS SHOWN
		SORGHASTRUM N. 'SIOUX BLUE'	INDIAN GRASS	I GAL	11	2'-6" O.C.
		FALLUGIA PARADOXA	APACHE PLUM	5 GAL	29	AS SHOWN
		MIRABILIS MULTIFLORA	COLORADO FOUR O' CLOCK	1 GAL	3	AS SHOWN
	$\triangle$	RHUS T. 'AUTUMN AMBER'	AUTUMN AMBER SUMAC	5 GAL	27	AS SHOWN

NOTE: ALL PLANTER AREAS SHALL BE TOP DRESSED WITH A 3" DEEP LAYER OF A ROCK MULCH/RIVER ROCK MIXTURE TO MATCH CENTER - PLACED OVER FILTER FABRIC

## LANDSCAPE AREAS

SHRUBS/TREES - LOW/MOD. WATER USE = 7,647 S.F. IRRIGATION - HIGH EFFICIENCY DRIP TUBING PERCENTAGE OF LANDSCAPED AREA - 100%

PLANTING NOTES

I. CONTRACTOR IS TO REVIEW PLANS, VERIFY SITE CONDITIONS AND PLANT QUANTITIES PRIOR TO INSTALLATION. CONFLICTS BETWEEN THE SITE AND THESE PLANS OR WITHIN THESE PLANS SHALL BE BROUGHT TO THE ATTENTION OF THE OWNER'S AUTHORIZED REPRESENTATIVE PRIOR TO LANDSCAPE INSTALLATION. ANY DEVIATION(S) FROM THE PLANS OR SPECIFICATIONS IS TO HAVE WRITTEN APPROVAL.

- 2. ALL PLANT MATERIAL SHALL BE IN ACCORDANCE WITH THE LATEST EDITION OF "AMERICAN NURSERY AND LANDSCAPE ASSOCIATION" STANDARDS. WWW.ANLA.ORG
- 3. LANDSCAPE ARCHITECT SHALL APPROVE PLANT MATERIAL PLACEMENT BY CONTRACTOR PRIOR TO INSTALLATION.
- 4. CONTRACTOR TO INCLUDE IN HIS BID THE REPAIR OF ANY AND ALL DAMAGE RESULTING FROM INSTALLATION OF PLANTING ITEMS. CONNECT TO EXISTING CONDITIONS.

- 5. ALL TREES WITHIN 5' OF ANY HARDSCAPE SURFACE TO HAVE A ROOT BARRIER TO REDIRECT ROOT GROWTH PER MANUFACTURER'S SPECIFICATIONS.
- 6. FINISH GRADE TO BE 2" BELOW TOP OF CURB OR SIDEWALK FOR PLANTING AREAS.
- 7. FERTILIZER FOR ALL PLANTING AREAS SHALL BE AS SPECIFIED WITHIN THE SOILS REPORT.
- 8. ALL PLANTING AND IRRIGATION ON THIS PROJECT TO MEET OR EXCEED CITY LANDSCAPE GUIDELINES, STANDARDS AND AGENCY REQUIREMENTS.
- 9. ALL PLANTER AREAS SHALL BE TOP DRESSED WITH 3" MINIMUM MULCH COVER.
- 10. THE LANDSCAPE CONTRACTOR SHALL MAINTAIN ALL PLANTED AREAS BY MEANS OF CONTINUOUS WATERING, PRUNING, RAISING TREE BALLS WHICH SETTLE BELOW GRADE, FERTILIZING, APPLICATION OF SPRAYS WHICH ARE NECESSARY TO KEEP THE PLANTINGS FREE OF INSECTS AND DISEASES, WEEDING, AND/OR OTHER OPERATIONS NECESSARY FOR PROPER CARE AND UPKEEP. THE LANDSCAPE CONTRACTOR SHALL MAINTAIN ALL PLANTINGS AS SPECIFIED ABOVE FOR A PERIOD OF NINETY (90) DAYS. ALL PLANTER BEDS TO BE AMENDED WITH SOIL PREPARATION PER SPECIFICATIONS. NO DEVIATIONS ARE ALLOWED.
- II. ALL PLANTING SHALL BE IRRIGATED WITH LOW VOLUME SPRAY HEADS, BUBBLERS AND/OR DRIP EMITTERS CONNECTED TO AUTOMATIC REMOTE CONTROL VALVES AND AND TIED INTO AN AUTOMATIC IRRIGATION CONTROLLER.

PRELIMINARY PLANTING PLAN

Crick-Gig-1

Atlanta Georgia, 30349-2998

Revisions:

Mark Date By

Mark Date By

Mark Date By

aal



o: 949.489.5623 f: 858.810.0335

STORE
CHICK-FIL-A
FSU #04107
COORS BLVD.

COORS BLVD NW & ST. JOSEPHS DR NW ALBUQUERQUE, NM 87120

SHEET TITLE


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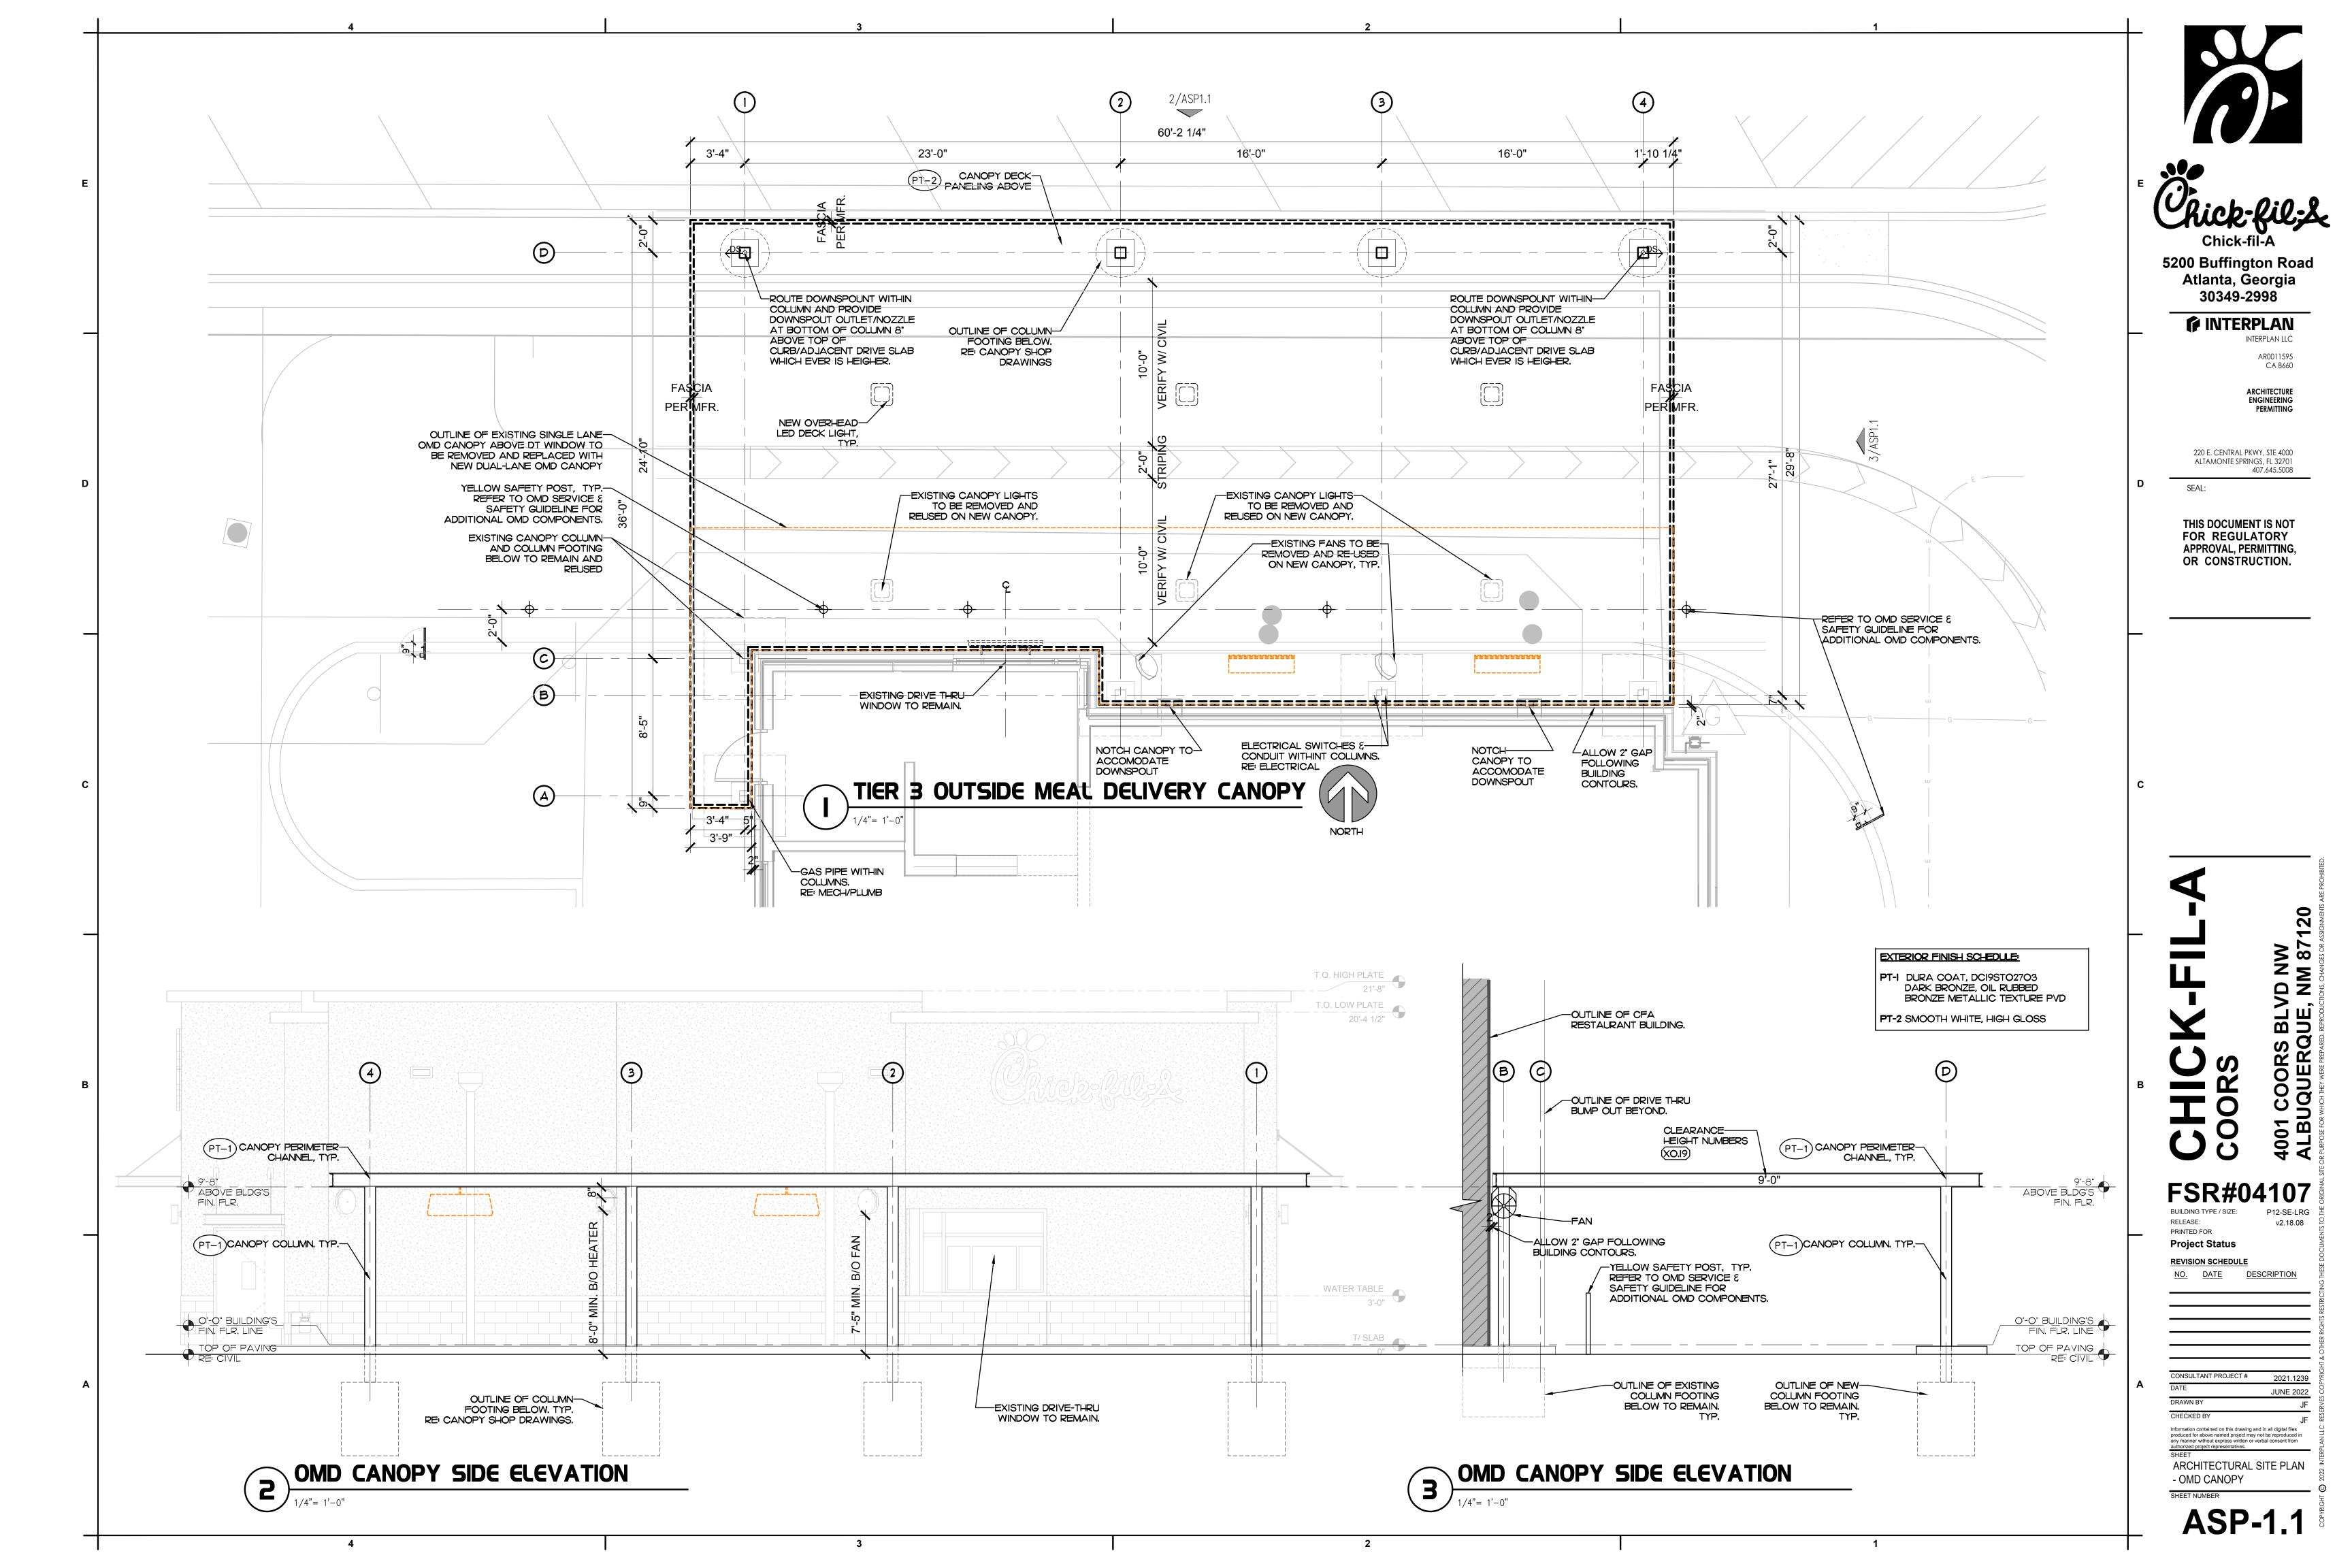
Drawn By

Job No. : <u>11274</u> Store : <u>04107</u> Date : <u>6/28/22</u>

Checked By: \_\_\_\_

PRELIMINARY PLANTING PLAN L-I.O



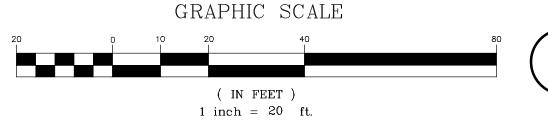



## City of Albuquerque

## Planning Department

## Development & Building Services Division

## DRAINAGE AND TRANSPORTATION INFORMATION SHEET (REV 10/2018)

Project Title: Building		g Permit #:H		lydrology File #:	
DRB#:	EPC#:		Work (	Order#:	
Legal Description:					
City Address:					
Applicant:			Contact		
Address:Phone#:					
Other Contact:					
Address:				_	
Phone#:					
TYPE OF DEVELOPMENT:	PLAT (# of lots)	RESIDENCE _	DRB SITE	ADMIN SITE	
IS THIS A RESUBMITTAL? Y					
<b>DEPARTMENT:</b> TRAFFIC/TI		HYDROLOG	Y/DRAINAGE		
Check all that Apply:  TYPE OF SUBMITTAL:  ENGINEER/ARCHITECT CERTIFICATION  PAD CERTIFICATION  CONCEPTUAL G & D PLAN  GRADING PLAN  DRAINAGE MASTER PLAN  DRAINAGE REPORT  FLOODPLAIN DEVELOPMENT PERMIT APPLIC  ELEVATION CERTIFICATE  CLOMR/LOMR  TRAFFIC CIRCULATION LAYOUT (TCL)  TRAFFIC IMPACT STUDY (TIS)  OTHER (SPECIFY)  PRE-DESIGN MEETING?		TYPE OF APPROVAL/ACCEPTANCE SOUGHT: BUILDING PERMIT APPROVAL CERTIFICATE OF OCCUPANCY PRELIMINARY PLAT APPROVAL SITE PLAN FOR SUB'D APPROVAL SITE PLAN FOR BLDG. PERMIT APPROVAL FINAL PLAT APPROVAL SIA/ RELEASE OF FINANCIAL GUARANTEE FOUNDATION PERMIT APPROVAL GRADING PERMIT APPROVAL SO-19 APPROVAL PAVING PERMIT APPROVAL GRADING/ PAD CERTIFICATION WORK ORDER APPROVAL CLOMR/LOMR FLOODPLAIN DEVELOPMENT PERMIT OTHER (SPECIFY)			

FEE PAID:\_\_\_