


ADMINISTRATIVE AMENDMENT				
FILE #:	PROJECT #:			
APPROVED BY	DATE			

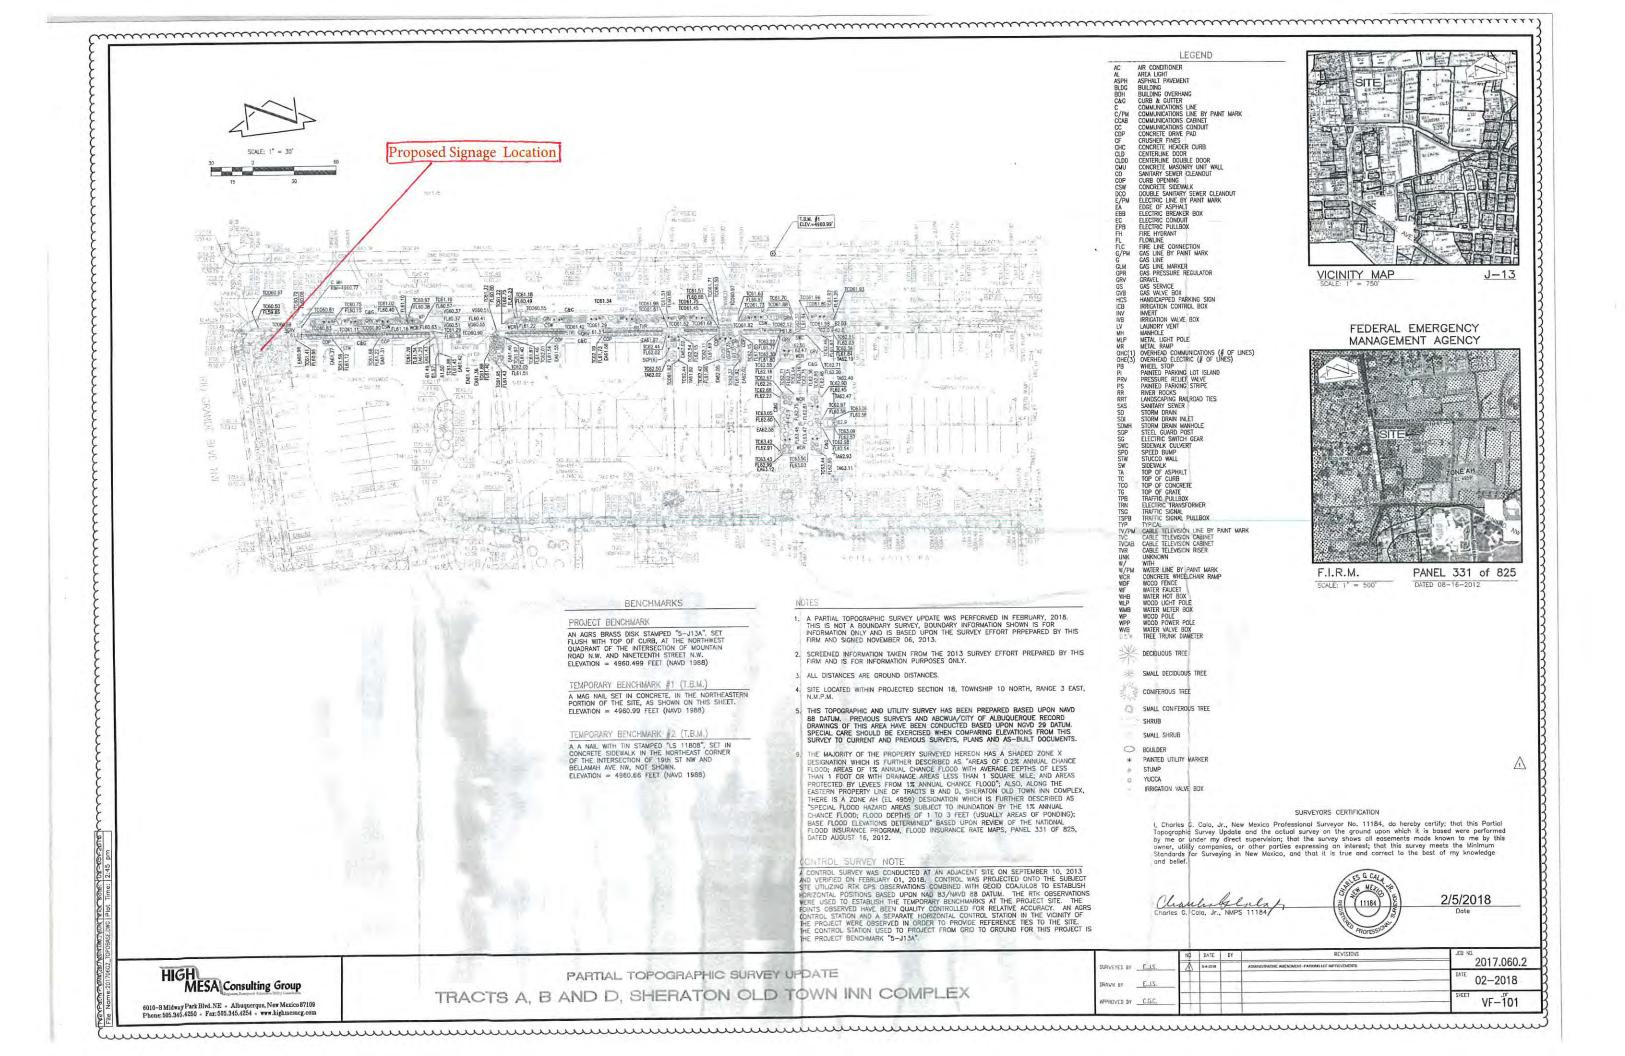


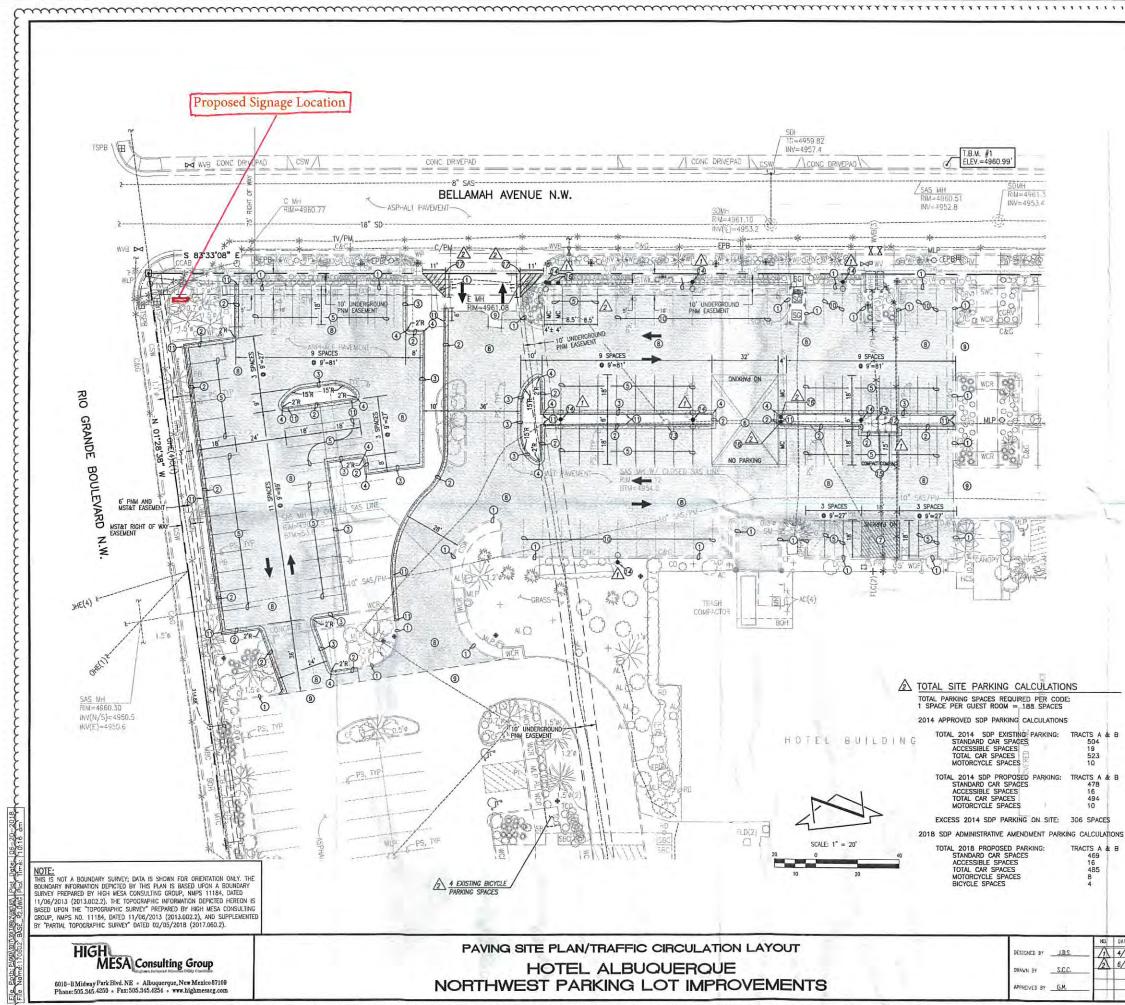


EGEN	UD.				
c	AIR CONDITIONER	TA	TOP OF ASPHA	IT	
200	AREA LIGHT ASPHALT PAVEMENT	TC	TOP OF CURB	RETE	
DG	BUILDING BUILDING OVERHANG	TG	TOP OF GRATE		
2G	CURB & GUTTER	TPB	TRAFFIC PULLE ELECTRIC TRAN	SFORMER	
PM	COMMUNICATIONS LINE COMMUNICATIONS LINE BY PAINT MARK	TSG TSPB	TRAFFIC SIGNAL	PULLBOX	
CAB	COMMUNICATIONS CABINET	TYP	TYPICAL		,
P	CONCRETE DRIVE PAD	TV/PM TVC	CABLE TELEVIS	Ion line by paint mari Ion cabinet Ion cabinet Ion riser	1
C	CRUSHER FINES CONCRETE HEADER CURB	TVCAB TVR	CABLE TELEVIS	ION CABINET	
DDD	CENTERLINE DOOR CENTERLINE DOUBLE DOOR CONCRETE MASONRY UNIT WALL SANITARY SEWER CLEANOUT	UNK	UNKNOWN		
IU	CONCRETE MASONRY UNIT WALL	W/PM WCR	WATER LINE BY	PAINT MARK	
		WDF	WOOD FENCE	ELCHAIR RAMP	
w	CONCRETE SIDEWALK DOUBLE SANITARY SEWER CLEANOUT	WF WHB	WATER FAUCET WATER HOT BO	NY.	
PM	ELECTRIC LINE BY PAINT MARK	WLP WMB	WOOD LIGHT P WATER METER	OLE	
B	CORRECTES IDEWALK CONCRETE SIDEWALK DOUBLE SANTRAY SEWER CLEANOUT ELECTRIC LINE BY PAINT MARK EDGE OF ASPHALT ELECTRIC BREAKER BOX ELECTRIC CONDUCT	WP	WOOD POLE		
8	ELECTRIC PULLBOX	WVB	WOOD POWER WATER VALVE I	BOX	
	FIRE HYDRANT FLOWLINE	0.5'ø	TREE TRUNK D	IAMETER	
PM	FIRE LINE CONNECTION GAS LINE BY PAINT MARK	1 Ale	DECIDUOUS TRI	EE	
M	GAS LINE GAS LINE MARKER	2/1			
R	GAS PRESSURE REGULATOR GRAVEL	業	SMALL DECIDUO	DUS TREE	
	GAS SERVICE	ANY S	CONIFEROUS T	RFF	
S	GAS VALVE BOX HANDICAPPED PARKING SIGN	THE	mood 11		
1	IRRIGATION CONTROL BOX	Sit	SMALL CONIFEF	ROUS TREE	
£	IRRIGATION VALVE BOX LAUNDRY VENT	\mathbb{C}	SHRUB		
£	MANHOLE METAL LIGHT POLE	0	SMALL SHRUB		
	METAL RAMP	0	BOULDER		
E(3)	OVERHEAD COMMUNICATIONS (# OF LINES) OVERHEAD ELECTRIC (# OF LINES)	*	PAINTED UTILIT	MARKER	
	WHEEL STOP	*	STUMP		
N	PAINTED PARKING LOT ISLAND PRESSURE RELIEF VALVE PAINTED PARKING STRIPE	0	YUCCA	VE BOX	
T	RIVER ROCKS LANDSCAPING RAILROAD TIES		IRRIGATION VAL	UL DUA	
S	SANITARY SEWER STORM DRAIN	24.45	PROPOSED CO	NCRETE PAVING	
	STORM DRAIN INLET STORM DRAIN MANHOLE	100 - 100 - 200 - 200 - 200 - 200 - 200 - 200 - 200 - 200 - 200 - 200 - 200 - 200 - 200 - 200 - 200 - 200 - 200	-		
P	STEEL GUARD POST	32-10 C	PROPOSED ASI	PHALI PAVING	
VC	ELECTRIC SWITCH GEAR SIDEWALK CULVERT				
PD WW V	SPEED BUMP STUCCO WALL SIDEWALK				
2. Con 3. Con 4. Trai 5. Pain 5. Pain Stei	D NOTES TING CURB AND GUTTER TO REMAIN STRUCT 6" (STANDARD) CURB AND GUTTER STRUCT 6" (DEPRESSED) CURB AND GUTTER STITON BETWEEN STANDARD AND DEPRESS IT 4" WIDE WHITE PAVEMENT MARKING S WIT IT 4" WIDE YELLOW PAVEMENT MARKING 'X VCIL 'NO PARKING', MIN. 2 COATS	er per typical s ed curb and gu ih white traffic ' as shown with	ection, sheet (itter paint, minimum yellow traffic	2 - 103 2 Coats : Paint and	
2. CON 3. CON 4. TRAI 5. PAIN 5. PAIN 5. FAIN 5. STEI 7. PAIN AND 5. STEI 7. PAIN AND 7. PAIN 7. PAINO	TING CURB AND GUTTER TO REMAIN STRUCT 6" (STANDARD) CURB AND GUTTER STRUCT 6" (DEPRESSED) CURB AND GUTTER STRUCT 6" (DEPRESSED) CURB AND GUTTER STRUCT 6" (DEPRESSED) CURB AND GUTTER STRUCT 6" WITHE FAVEMENT MARKINGS WI TI 4" WIDE WHITE PAVEMENT MARKING 'X VCIL 'NO PARKING', MIN. 2 COATS TI 4" WIDE VELLOW PAVEMENT MARKING 'X VCIL 'NO PARKING', MINIUM 2 COATS STENCIL 'NO PARKING', MINIUM 2 COATS CULT, REMOVE / PULVERIZE EXISTING ASPH HALT PAVEMENT PER TYPICAL SECTION, SH I EXISTING SUBGRADE AND COMPACT TO SI TING ASPHALT PAVEMENT TO REMAIN (LIMI ANN 4" WHITE PAVEMENT MARKINGS TO MA TIC PAINT, MINIUM 2 COATS STRUCT 12" WIDE CURB OPENING PER TYF STING ELECTRICAL BOX TO REMAIN; REM STING LIGHT POLE TO BE REMOVED AND V LIGHT POLE, SEE ELECRICAL PLAN NCIL "COMPACT" WITH WHITE TRAFFIC P.	ER PER TYPICAL S ED CURB AND GU IH WHITE TRAFFIC ' AS SHOWN WITH NG @ 45 DEG, 2' 3 ALT PAVEMENT IN EET C-103. MIX I ERVE AS BASECOL TS TO BE VERIFIEL VTCH EXISTING STF PICAL SECTION, SH NOVE EXISTING BU D DISPOSED ANNT, MINIMUM 2	Section, Sheet (Titer Paint, Minimum Yellow Traffic C-C With Red Place; Replace Pulverized Asph Rese for New F O With Owner) Riping Alignment Heet C-103 Dullards	2-103 2 COATS 3 PAINT AND TRAFFIC PAINT 5 WITH 3" 44LT PAVEMENT AVEMENT.	
2. CON 5. CON 5. CON 5. TRAIN 5. PAIN STEIN 5. PAIN STEIN 7. PAIN AND 5. TRAIN AND 1. SAW ASP TRAIN 1. CON 1.	TING CURB AND GUTTER TO REMAIN STRUCT 6" (STANDARD) CURB AND GUTTER STRUCT 6" (DEPRESSED) CURB AND GUTTER STRUCT 6" (DEPRESSED) CURB AND GUTTER STRUCT 6" (DEPRESSED) CURB AND GUTTER STRUCT 6" WIDE WHITE PAVEMENT MARKINGS WIT IT 4" WIDE WHITE PAVEMENT MARKING 'X VCIL 'NO PARKING', MIN. 2 COATS STRUCT 10" WIDE CURB OPACT TO SI STRUCT 12" WIDE CURB OPANING PER TYP STING LLCTRICAL BOX TO REMAIN, REM STING LLCTRICAL BOX TO REMAIN, REM STING LIGHT POLE TO BE REMOVED AND V LIGHT POLE, SEE ELECTRICAL PLAN NCIL "COMPACT" WITH WHITE TRAFFIC P. MILT 4" SIGNAGE MAD SIGNAGE WILL NOT INTEL DSCAPING AND SIGNAGE WILL NOT INTEL	ER PER TYPICAL S ED CURB AND GU IH WHITE TRAFFIC ' AS SHOWN WITH AG 0 45 DEG, 2' S ALT PAVEMENT IN EET C-103. MIX I ERVE AS DASCOL STO BE VERIFIEL STO DISPOSED AINT, MINIMUM 2 ST, TYP.	SECTION, SHEET (TITER PAINT, MINIMUM YELLOW TRAFFIC C-C WITH RED PLACE; REPLACE PULVERZED ASPI PRSE FOR NEW F D WITH OWNER) RIPING ALIGNMENT HEET C-103 DLLARDS	2-103 2 Coats 2 Paint and Traffic Paint 3 With 3" Aut Pavement Avement, 3, With White Rements,	
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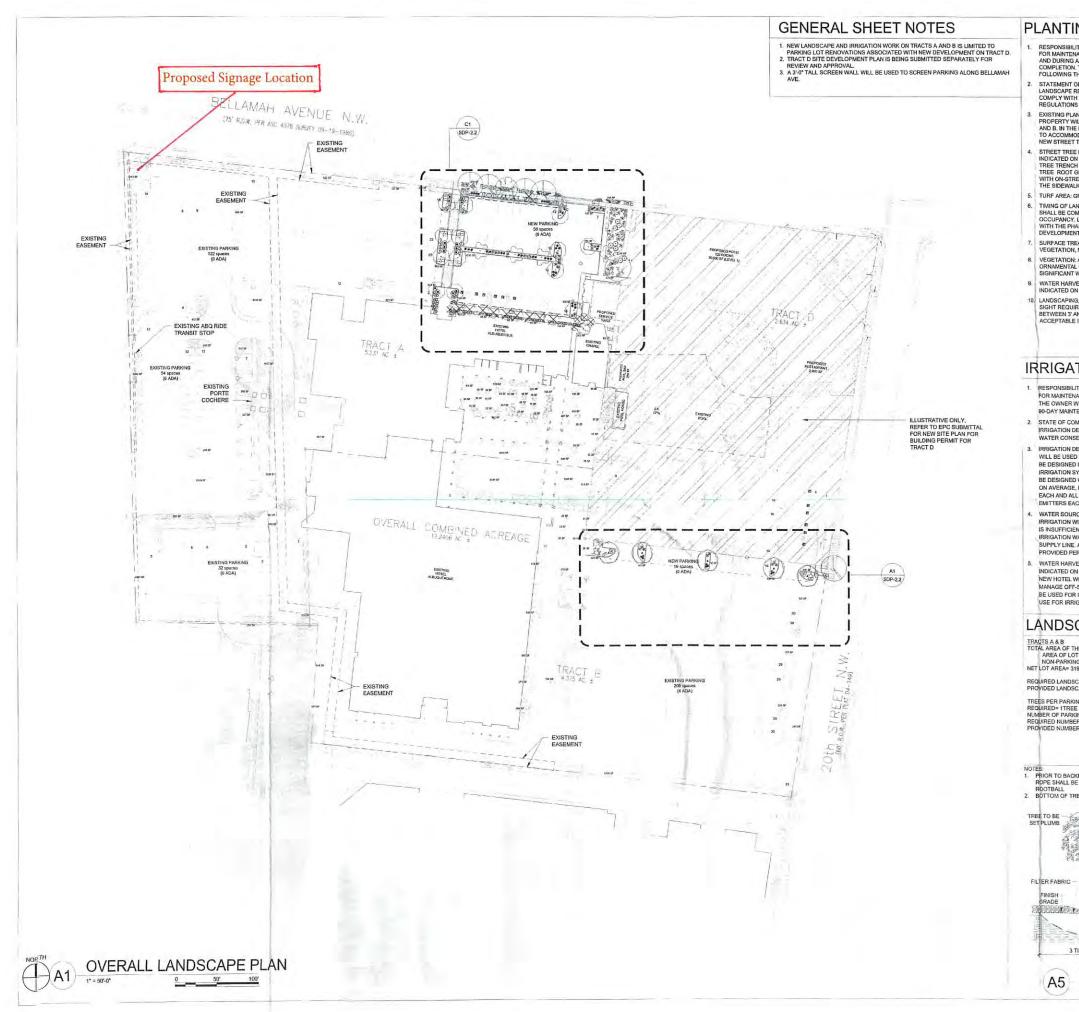


AC	ND			
AL	AIR CONDITION AREA LIGHT		0.5'\$	TREE TRUNK DIAMETER
ASPH BLDG	ASPHALT PAVE BUILDING		×	DECIDUOUS TREE
BOH C&G	BUILDING OVER	ER		
C C/PM CCAB	COMMUNICATIO	NS LINE	*	SMALL DECIDUOUS TREE
CC	COMMUNICATIO	NS LINE BY PAINT MARK NS CABINET NS CONDUIT	Mar Mar	CONIFEROUS TREE
CDP	CONCRETE DR	WE PAD	11/4	SMALL CONIFEROUS TREE
CHC	CRUSHER FINE CONCRETE HE	ADER CURB	Curry we	SHRUB
CLDD CMU	CENTERLINE D	OOR OUBLE DOOR SONRY UNIT WALL	0	SMALL SHRUB
CO	SANITARY SEW CURB OPENIN	ER CLEANOUT	0	
CSW	CONCRETE SIL	EWALK ARY SEWER CLEANOUT BY PAINT MARK	*	Boulder Painted Utility Marker
DCO E/PM EA	ELECTRIC LINE	BY PAINT MARK	*	STUMP
EBB	ELECTRIC BRE ELECTRIC CON ELECTRIC PUL	AKER BOX	•	YUCCA
EC EPB	ELECTRIC PUL	LBOX	**	IRRIGATION VALVE BOX
FH	FIRE HYDRANT		INV TA	INVERT TOP OF ASPHALT PAVEMENT
FLC G/PM	FIRE LINE COL GAS LINE BY	PAINT MARK	TC	TOP OF CURB
GLM	GAS LINE GAS LINE MAP GAS PRESSUR	KER	TG	TOP OF GRATE
GPR GRV	CRAVEL		+ 20.05	EXISTING SPOT ELEVATION
GS GVB	GAS SERVICE GAS VALVE BO	PARKING SIGN	9 14.00	PROPOSED SPOT ELEVATION
HCS ICB	IRRIGATION CC	PARKING SIGN INTROL BOX		EXISTING FLOWLINE PROPOSED FLOWLINE
INV	INVERT IRRIGATION VA	LVE BOX	-4920	EXISTING CONTOUR
LV	LAUNDRY VEN	T		PROPOSED CONTOUR
MLP	MANHOLE METAL LIGHT METAL RAMP	POLE	<	EXISTING DIRECTION OF FLOW
MR OHC(1)	OVERHEAD CO	MMUNICATIONS (# OF LINES ECTRIC (# OF LINES)	5) 4	PROPOSED DIRECTION OF FLOW
OHE(3) PB	WHEEL SIDE			- RIGHT OF WAY LINE
PI PRV	PAINTED PARK	CING LOT ISLAND		- PUBLIC EASEMENT LINE
PS RR RRT SAS	PAINTED PARE RIVER ROCKS LANDSCAPING	RAILROAD TIES	-‡	HIGH POINT / DIVIDE
SD SDI SDMH	SANITARY SEV STORM DRAIN STORM DRAIN STORM DRAIN	INLET MANHOLE		PROPOSED CONCRETE PAVING
SGP SG SWC	STEEL GUARD ELECTRIC SWI SIDEWALK CU	POST TCH GEAR		PROPOSED ASPHALT PAVING
SPD	SPEED BUMP STUCCO WALL			
SW	SIDEWALK			
TC TCO	TOP OF ASPH TOP OF CURI TOP OF CON TOP OF GRAT	3 CRETE		
TG	TOP OF GRAT	E		
TRN	TRAFFIC PULL ELECTRIC TRA TRAFFIC SIGN	NSFORMER		
TSG TSPB	TRAFFIC SIGN TRAFFIC SIGN TYPICAL	AL PULLBOX		
TYP TV/PM TVC	CABLE TELEV	SION LINE BY PAINT MARK		
TVCAB	CABLE TELEV	SION LINE BY PAINT MARK SION CABINET SION CABINET SION RISER		
TVR	UNKNOWN	SION RISER		
144 1	WITH WATER LINE	BY PAINT MARK		
W/PM	DOLLAR LINE	HEELCHAIR RAMP		
W/PM WCR WDF	CONCRETE W WOOD FENCE			
W/PM WCR WDF WF WHB	CONCRETE W WOOD FENCE WATER FAUCE	Т		
W/PM WCR WDF WF WHB WLP WMB	CONCRETE W WOOD FENCE	T BOX POLE		
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W/PM WCR WDF WHB WLP WMB WPP	CONCRETE W WOOD FENCE WATER FAUC WATER HOT I WOOD OLGHT WATER METER WOOD POWER WOOD POWER WATER VALVE	T POLE 2 BOX 2 POLE BOX 3 CALE: 1* = 20'	► 40	À
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W/PM WCR WDF WFW WHB WLP WHB WP WP WP WP WP WP WP WP WP T FLUSH	CONCRETE W WOOD FENCE WATER FAUC WATER FAUT WOOD DUGHT WOOD POWE WOOD POWE WOOD POWE WOOD POWE WATER VALVE	FILEST FLUSH	40 40	
W/PM WCR WDF WHB WLP WLP WLP WLP WLP WLP WLP WLP WLP WLP	CONCRETE W WOOD FENCE WATER FAUC WATER FAUT WOOD POLE WOOD POLE WOOD POLE WOOD POLE WATER VALVE	T POLE 2 BOX 2 POLE BOX 3 CALE: 1* = 20' 0 20	40 10	À
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W/PM WCR WDF WFB WHB WHP WHP WPP WPP WPP WPP WPP WPP WPP WPP	CONCRETE W WOOD FENCE WATER FAUCT WATER FAUCT WATER METER WOOD POWER WOOD POWER WOOD POWER WOOD POWER WATER VALVE	T POLE POLE BOX R POLE BOX SCALE: 1* = 20' 0 20 RRST FLUSH BYPASS 0 CF	40	A
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W/PM WCR WF WF WHB WP WP WP WP WP WP WP WP WP WP WP WP T FLUSH IERATED 50 CF 25 CF 20 CF 20 CF	CONCRETE W WOOD FENCE WATER FAUCT WATER FAUCT WATER METER WOOD POWER WOOD POWER WOOD POWER WOOD POWER WATER VALVE	T POLE POLE 8 BOX R POLE BOX SCALE: 1* = 20' 0 20 FIRST FLUSH BYPASS 0 CF 15 CF 30 CF 155 CF	40	06-22-2018
W/PM WCR WF WF WHB WP WP WP WP WP WP WP WP WP WP WP WP SC WP WP WP WP WP WP WP WP WP WP WP WP WP	CONCRETE W WOOD FENCE WATER FAUCT WATER FAUCT WATER METER WOOD POWE WOOD POWE WOOD POWE WOOD POWE WOOD POWE WATER VALVE	FIRST FLUSH BITASS 0 CF 15 CF 80 CF 15 CF 80 CF	40	06-22-2018
W/PM WCR WF WF WHB WP WP WP WP WP WP WP WP WP WP WP WP SC WP WP WP WP WP WP WP WP WP WP WP WP WP	CONCRETE W WOOD FENCE WATER FAUCT WATER FAUCT WATER METER WOOD POWER WOOD POWER WOOD POWER WOOD POWER WATER VALVE	T POLE POLE 8 BOX R POLE BOX SCALE: 1* = 20' 0 20 FIRST FLUSH BYPASS 0 CF 15 CF 30 CF 155 CF	40	06-22-2018 GRAENE MC4 3 - 24 WERDS -
W/PM WCR WF WF WHB WP WP WP WP WP WP WP WP WP WP WP WP T FLUSH IERATED 50 CF 25 CF 20 CF 20 CF	CONCRETE W WOOD FENCE WATER FAUCT WATER FAUCT WATER METER WOOD POWER WOOD POWER WOOD POWER WOOD POWER WATER VALVE	T POLE POLE 8 BOX R POLE BOX SCALE: 1* = 20' 0 20 FIRST FLUSH BYPASS 0 CF 15 CF 30 CF 155 CF	×	06-22-2018
W/PM WCR WF WF WHB WP WP WP WP WP WP WP WP WP WP WP WP T FLUSH IERATED 50 CF 25 CF 20 CF 20 CF	CONCRETE W WOOD FENCE WATER FAUCT WATER FAUCT WATER METER WOOD POWER WOOD POWER WOOD POWER WOOD POWER WATER VALVE	T POLE POLE 8 BOX R POLE BOX SCALE: 1* = 20' 0 20 FIRST FLUSH BYPASS 0 CF 15 CF 30 CF 155 CF	40 10	06-22-2018 GALEME 44:45 (3676)
W/PM WCR WF WF WHB WP WP WP WP WP WP WP WP WP WP WP WP T FLUSH IERATED 50 CF 25 CF 20 CF 20 CF	CONCRETE W WOOD FENCE WATER FAUCT WATER FAUCT WATER METER WOOD POWER WOOD POWER WOOD POWER WOOD POWER WATER VALVE	T POLE POLE 8 BOX R POLE BOX SCALE: 1* = 20' 0 20 FIRST FLUSH BYPASS 0 CF 15 CF 30 CF 155 CF	40	06-22-2018 (1) MEME 46-14 (3670) (3670) (1) MERCINE 46-14 (3670) (1) MERCINE 46-14 (1) MERC
W/PM WCR WF WF WHB WP WP WP WP WP WP WP WP WP WP WP WP SC WP WP WP WP WP WP WP WP WP WP WP WP WP	CONCRETE W WOOD FENCE WATER FAUCT WATER FAUCT WATER METER WOOD POWER WOOD POWER WOOD POWER WOOD POWER WATER VALVE	T POLE POLE 8 BOX R POLE BOX SCALE: 1* = 20' 0 20 FIRST FLUSH BYPASS 0 CF 15 CF 30 CF 155 CF	40	06-22-2018 GRIEBE MC 440 150 MELTON 150
W/PM WCR WDF WFB WLP WLP WLP WLP WLP WLP WLP WLP WLP WLP	CONCRETE W WOOD FENCE WATER FAUCT WATER FAUCT WATER METER WOOD POLE WOOD POLE WOOD POLE WOOD POLE WATER VALVE	T POLE POLE BOX R POLE BOX SCALE: 1" = 20' 0 20 FIRST FLUSH BYPASS 0 CF 15 CF 30 CF 155 CF 280 CF 280 CF		06-22-2018
W/PM WCR WDF WF WDF WF WF WF WDF WF WHB WP WP W	CONCRETE W WOOD FENCE WATER FAUC WATER FAUT WOOD DUGHT WOOD POLE WOOD POLE W	FIRST FLUSH BYPASS SCALE: 1" = 20' 0 20 FIRST FLUSH BYPASS 0 CF 15 CF 30 CF 155 CF 280 CF 155 CF 280 CF 55 CF 280 CF	WO COMPACT SPACE	06-22-2018 (1) (1) (1) (1) (1) (1) (1) (1) (1) (1)
W/PM WCR WDF WFB WLP WLP WLP WLP WLP WLP WLP WLP WLP WLP	CONCRETE W WOOD FENCE WATER FAUC WATER FAUT WOOD DUGHT WOOD POLE WOOD POLE W	T POLE POLE BOX R POLE BOX SCALE: 1" = 20' 0 20 FIRST FLUSH BYPASS 0 CF 15 CF 30 CF 155 CF 280 CF 280 CF	WO COMPACT SPACE	06-22-2018

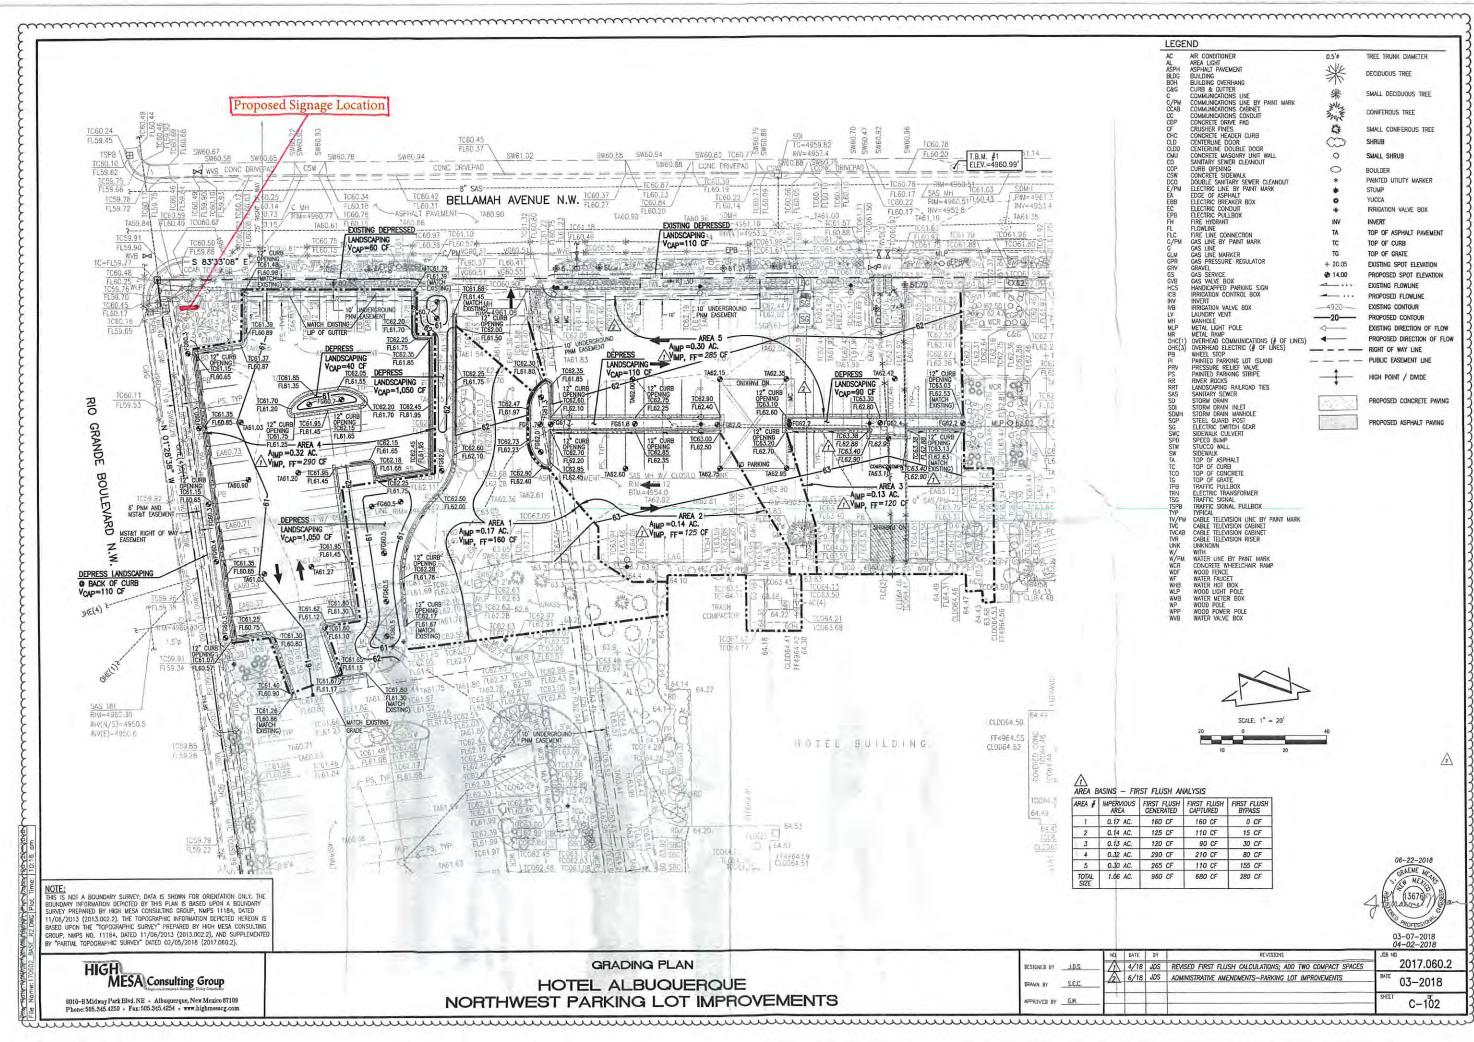

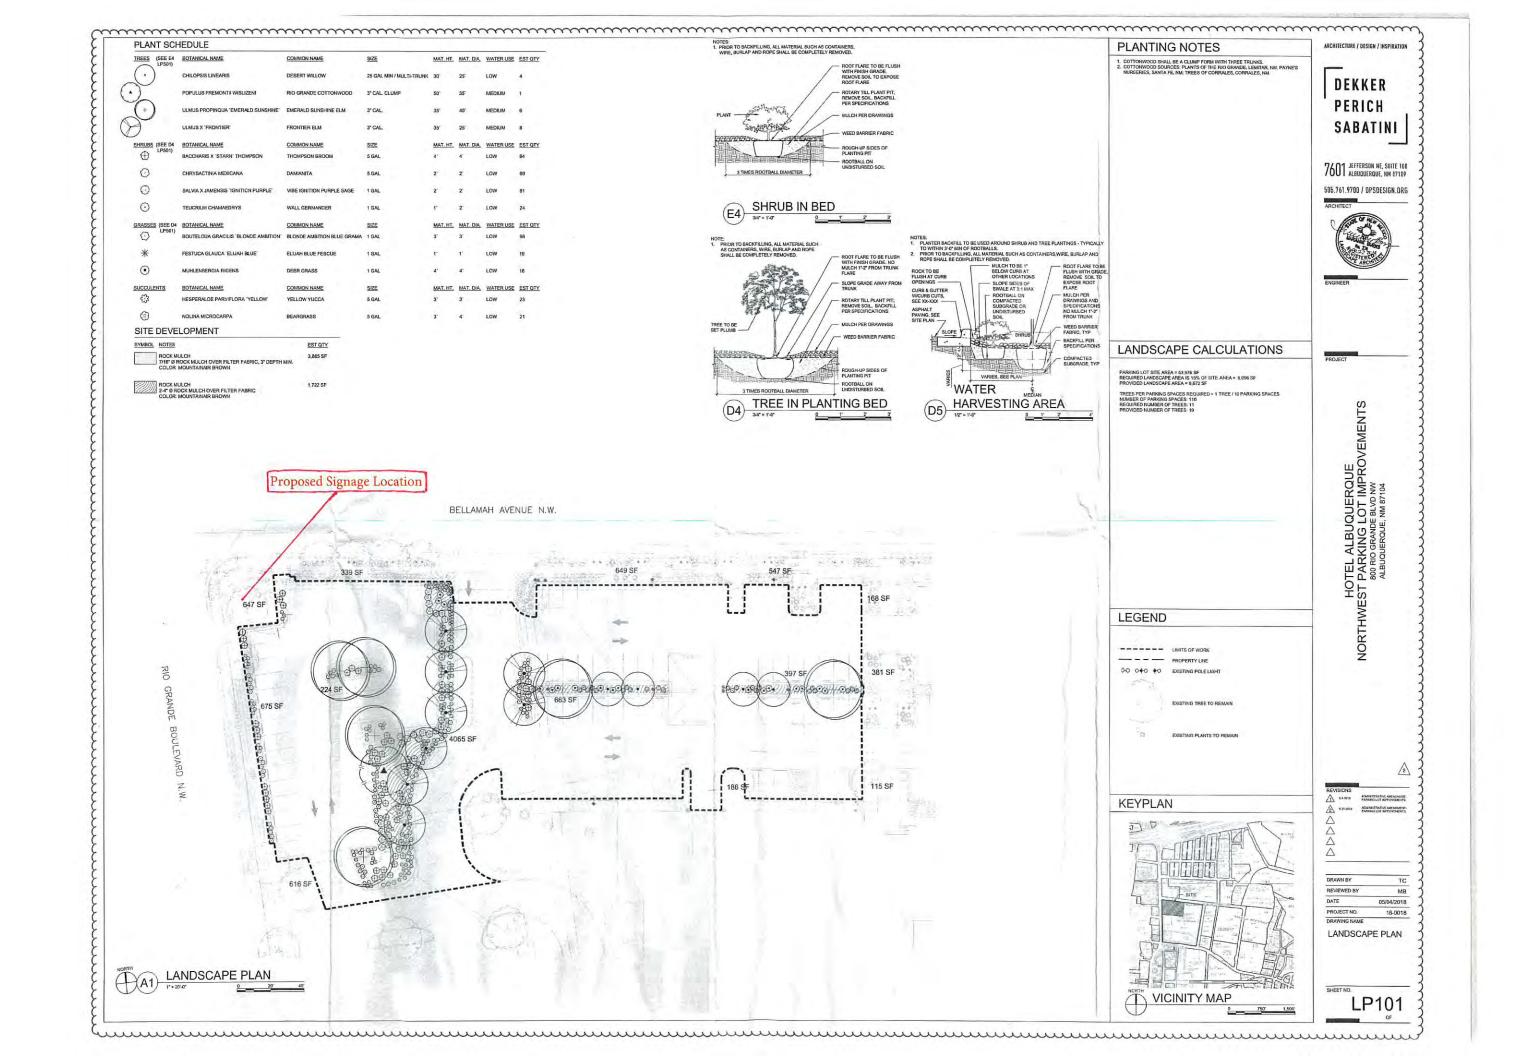

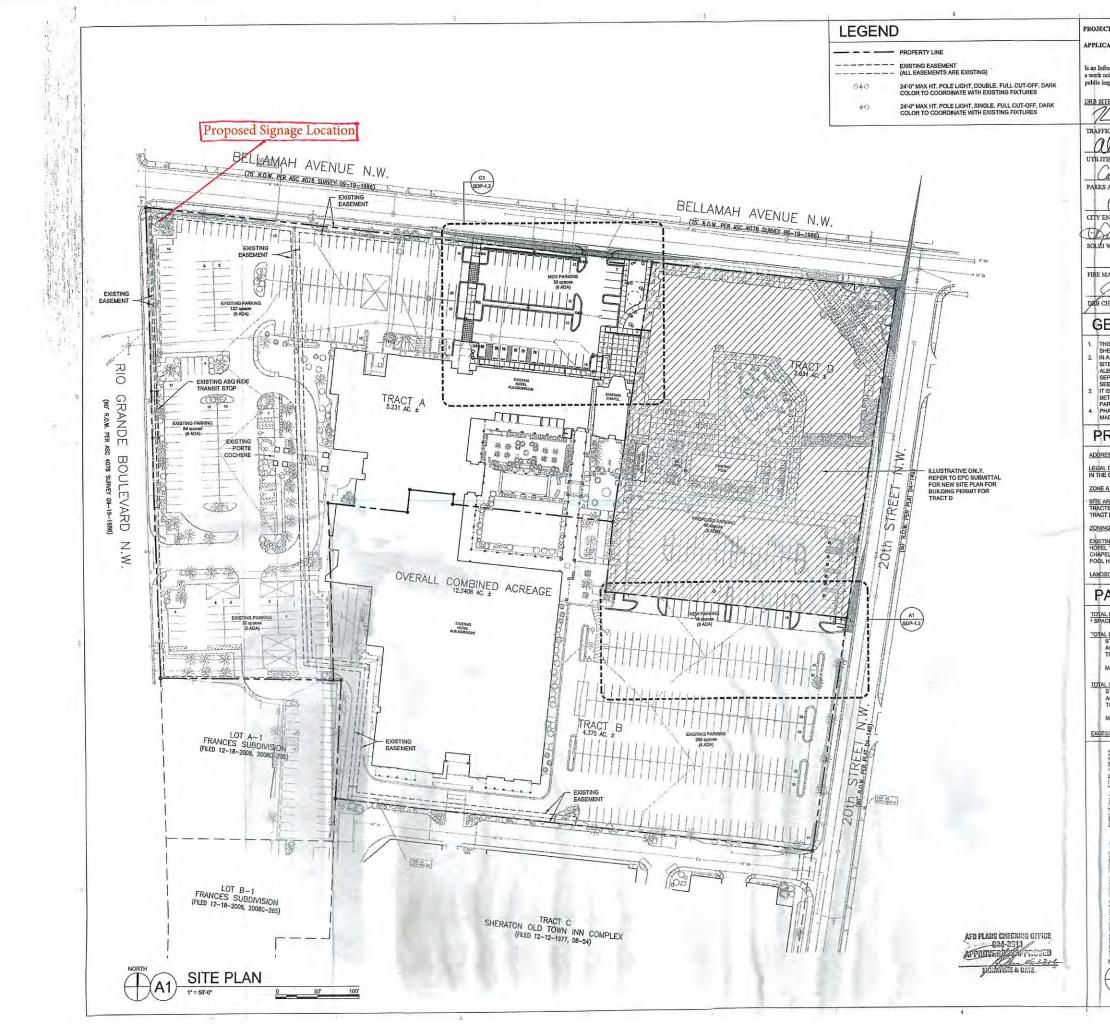	architecture
CT NUMBER: 1000318 CATION NUMBER: DRB Amendment to Existing Site Development Plan	interiors landscape
	planning
instructure List Required? (x) Yes () No If yes, then a set of approved DRC plans with order is required for any construction within Public Right-of-Way or for construction of uprovements.	DAL IAP engineering
IE DEVELOPMENT PLAN APPROVAL:	Dekker
1525 07-09-14	Perich
IC ENGINEER, TRANSPORTATION DIVISION DATE	a 1 1
Den Cate 07/09/14 TES DIVISION DATE	Sabatini
avel S. Dument 09-03-14	7601 Jefferson NE Suite 100
AND RECREATION DEPARTMENT DATE	Albuquerque, NM 87109 505 761-9700
Cinto a. clene 7-9-14	fax 761-4222
NGINEER DATE	dps@dpsdesign.org
WASTE MANAGEMENT DATE	ARCHITECT
	Gensler
AARSHALL DATE	H
HAIRPERSON, PLANNING DEPARTMENT DATE	
ENERAL SHEET NOTES	ENGINEER
HIS SUBMITTAL IS TO AMEND THE EXSITING SITE DEVELOPMENT PLAN FOR THE IERATON OLD TOWN INN COMPLEX (#1000318) A SEPARATE EPC SUBMITTAL TRACT D WILL BE REMOVED FROM THE OVERALL	AMENDMENT
TE DEVELOPMENT PLAN ASSOCIATED WITH THE EXISTING HOTEL BUQUERQUE. THE PRIMARY REASON FOR REMOVING TRACT D IS TO ESTABLISH EPARATE ZONING THAT IS MORE ALIGNED WITH THE NEW HOTEL OBJECTIVES.	TO EXISTING
2E SITE DEVELOPMENT PLAN FOR TRACT D FOR MORE INFORMATION. IS ANTICIPATED THAT THERE WILL BE A SHARED PARKING AGREEMENT TIWEEN THE EXISTING HOTEL (TRACTS A & B) AND TRACT D TO SUPPORT	SITE DEVELOPMENT PLAN
RKING DEMAND ON TRACT D, BEYOND WHAT IS PROVIDED ON THE TRACT. HASES OF DEVELOPMENT: THE MODIFICATIONS TO THE PARKING AREA WILL BE DADE IN ONE PHASE IN ASSOCIATION WITH DEVELOPMENT OF TRACT D.	
ROJECT DATA	PROJECT
ESS: 800 RIO GRANDE BLVD. NW, ALBUQUERQUE, NM 87104	
DESCRIPTION: TRACTS A, B, AND D OF SHERATON OLD TOWN INN COMPLEX,	
CITY OF ALBUQUERQUE, NEW MEXICO ATLAS PAGE: J-13	
NEA: TS A & B: 9.606 AC	
T D: 2.634 AC	φ≥S
IG: C-2 ING BUILDING FOOTPRINT:	vlbuquerque srande Blvd. NW jue, New Mexico
L TOWER / BALLROOM: 93,628 SF EL: 2,496 SF HOUSE: 624 SF	w Ne
SCAPING: REFER TO SHEET SDP-2.1 FOR LANDSCAPE PLAN	b Nee
ARKING CALCULATIONS	Alb
PARKING SPACES REQUIRED PER CODE:	Hotel Alt 800 Rio Gra Albuquerque
CE PER GUEST ROOM = 188 SPACES	Poo P
STANDARD CAR SPACES 504 0 ACCESSIBLE SPACES 19 0	7 24
TOTAL CAR SPACES 523 0 MOTORCYCLE SPACES 10 0	
L PROPOSED PARKING: TRACTS A & B TRACT D IS TO BE	DRB
STANDARD CAR SPACES 478 REMOVED FROM THIS ACCESSIBLE SPACES 16 SITE DEVELOPMENT TOTAL CAR SPACES 494 PLAN IN A SEPARATE	SUBMITTAL June 24, 2014
MOTORCYCLE SPACES 10	June 24, 2014
SS PARKING ON SITE: 306 SPACES	REVISIONS
The Alexander and the Alexander	6-24-14 Revised Per EPC Conditions 5-8-14
	Δ
15 martin State	$\overline{\Delta}$
	DRAWN BY CM
SITE SW STRUCT INTERNAL	REVIEWED BY MB / WG
	DATE 6.24.2014 PROJECT NO. 13-0020
THE ROTEVAN WE FILL	DRAWING NAME
	SITE PLAN
A A A A A A A A A A A A A A A A A A A	
A A HEALTH AND A A A A A A A A A A A A A A A A A A	
	SHEET NO.
	SHEET NO. SDP-1.1



PLANTING NOTES

RESPONSIBILITY FOR MAINTENANCE: THE CONTRACTOR WILL BE RESPONSIBLE FOR MAINTENANCE OF THE LANDSCAPE INSTALLATION DURING CONSTRUCTION AND DURING A 90 DAY-MAINTENANCE PERIOD FOLLOWING SUBSTANTIAL COMPLETION. THE OWNER WILL BE RESPONSIBLE FOR MAINTENANCE FOLLOWING THE 90-DAY MAINTENANCE PERIOD.

STATEMENT OF COMPLIANCE WITH CITY OF ALBUQUERQUE: GENERAL LANDSCAPE REGULATIONS SECTION 14-16-3-10: THE LANDSCAPE DESIGN WILL COMPLY WITH THE CITY OF ALBUQUERQUES GENERAL LANDSCAPING REGULATIONS APPLICABLE TO NON-RESIDENTIAL DEVELOPMENT.

EXISTING PLANT MATERIALS: THE PLANT MATERIAL ON THE MAJORITY OF THE ENDING FORT INTERNALS, THE FORT INCREMENT OF THE MODERT OF THE PROPERTY WILL NOT BE AFFECTED BY THE PROPOSED CHANGES TO TRACTS A AND B. IN THE NORTH PARKING LOT, A FEW TREES WILL NEED TO BE REMOVED TO ACCOMMODATE THE NEW DESIGN. THESE TREES WILL BE REPLACED BY NEW STREET TREES.

NEW SIRELINEES. STREET TREE PLAN: STREET TREES ARE PLANTED 25'ON CENTER OR LESS AS INDICATED ON THE PLANS. STREET TREES WILL BE PLANTED IN A CONTINUOUS TREE TREACH IN ORDER TO MAXIMIZE THE AMOUNT OF SPACE AVAILABLE FOR TREE ROOT GROWTH. STREET TREE PLACEMENT HAS BEEN COORDINATED WITH ON-STREET PARKING STREINEN IN ORDER TO ALLOW EASY ACCESS TO THE SIDEWALK AND TO PROTECT THE TREES.

5. TURF AREA: GRASS TURF AREAS ARE NOT INCLUDED IN THIS PLAN. TIMING OF LANDSCAPE INSTALLATION: INSTALLATION OF THE LANDSCAPING SHALL BE COMPLETE WITHIN 60 DAYS OF THE TRACT D BUILDING'S OCCUPANCY. LANDSCAPE IMPROVEMENTS WILL BE PHASED IN ASSOCIATION WITH THE PHASED SITE DEVELOPMENT INDICATED FOR THE TRACT D SITE DEVELOPMENT PLAN.

SURFACE TREATMENT: ALL LANDSCAPE AREAS SHALL BE COVERED WITH VEGETATION, MULCH OR SEED.

8. VEGETATION: A MINIMUM OF 40% OF INSTALLED SHRUBS, ACCENT PLANTS AND ORNAMENTAL GRASSES WILL BE EVERGREEN IN ORDER TO PROVIDE SIGNIFICANT WINTER INTEREST AND VISUAL IMPACT.

WATER HARVESTING: PASSIVE AND ACTIVE WATER HARVESTING ZONES ARE INDICATED ON THE PLANS. SEE IRRIGATION NOTES.

10. LANDSCAPING, FENCING, AND SIGNING WILL NOT INTERFERE WITH CLEAR SIGHT REQUIREMENTS. THEREFORE, SIGNS, WALLS, TREES, AND SHRUBBERY BETWEEN 3' AND B' (AS MEASURED FROM THE GUTTER PAN) WILL NOT BE ACCEPTABLE IN THIS AREA.

IRRIGATION NOTES

RESPONSIBILITY FOR MAINTENANCE: THE CONTRACTOR WILL BE RESPONSIBLE FOR MAINTENANCE OF THE IRRIGATION INSTALLATION DURING CONSTRUCTION. THE OWNER WILL BE RESPONSIBLE FOR MAINTENANCE FOLLOWING THE 90-DAY MAINTENANCE PERIOD.

2. STATE OF COMPLIANCE WITH WATER CONSERVATION REGULATIONS: THE IRRIGATION DESIGN SHALL COMPLY WITH THE CITY OF ALBUQUERQUE WASTE WATER CONSERVATION, LANDSCAPING AND WATER WASTE ORDINANCE.

IRRIGATION DESIGN DESCRIPTION: A FULLY AUTOMATED IRRIGATION SYSTEM INNERVION DEALER DESCRIPTION: A POLITIAN COMMENDIATION AND A DE LEM WILL DE USED OT IRRIGATE PLANTS IN THE PROJECT AREA. IRRIGATION MAY BE DESIGNED IN PART OR IN TOTAL AS AN EXTENSION OF THE EXISTING IRRIGATION SYSTEM FOR THE EXISTING HORE: THE IRRIGATION SYSTEM WILL BE DESIGNED WITH SEPARATE ZONES ACCORDING TO WATER REQUIREMENTS. ON AVERAGE, EACH TREE SHALL RECEIVE THREE (3) - TWO (2) GPH EMITTERS EACH AND ALL OTHER PLANT MATERIAL SHALL RECEIVE TWO (2) - ONE (1) GPH EMITTERS EACH.

WATER SOURCE AND PROTECTION: THE WATER SOURCE FOR PROJECT IRRIGATION WILL BE CITY WATER. IF THE EXISTING IRRIGATION SYSTEM DESIGN IS INSUFFICIENT TO ACCOMMODATE THE LANDSCAPING FOR THE NEW HOTEL, IRIIGATION WATER SUPPLY WILL BE PROVIDED OF OF THE HOTEL DOMESTIC SUPPLY LINE. A NEW BACKFLOW PREVENTER AND MASTER VALVE WILL BE PROVIDED PER COA STANDARD DETAIL 2701.

WATER HARVESTING: PASSIVE AND ACTIVE WATER HARVESTING ZONES ARE INDICATED ON THE ENLARGEMENT PLANS PLANS (SEE SHEET SDP-2.2), THE NEW HOTEL WILL DIRECT ROOF STORMWATER TO CISTERNS IN ORDER TO MANAGE OFF-SITE STORMWATER FLOWS. THE WATER IN THE CISTERNS WILL BE USED FOR IRRIGATION PURPOSES IN ORDER TO REDUCE POTABLE WATER USE FOR IRRIGATION.

LANDSCAPE CALCULATIONS

TRACTS A & B TOTAL AREA OF THE LOT (TRACT A & B)= 9.606 AC = 418,437 SF AREA OF LOT COVERED BY BUILDING= 96,748 SF NON-PARKING AREA WI NO LANDSCAPING AND MIN. 6' TALL SCREEN= 2,137 SF NET LOT AREA 319,652 SF

REQUIRED LANDSCAPE AREA (15% OF NET LOT AREA)= 47,933 SF PROVIDED LANDSCAPE AREA= 53,777 SF = 16,8%

TREES PER PARKING SPACES - IN RENOVATION AREA REQUIRED= 1TREE / 10 PARKING SPACES NUMBER OF PARKING = 59 REQUIRED NUMBER OF TREES= 6 TREES PROVIDED NUMBER OF TREES= 16 TREES

TIMES ROOTBALL DIA.

TREE

3/4" = 1'-0"

NOTES: 1. PRIOR TO BACKFILLING, ALL MATERIAL SUCH AS CONTAINERS, WIRE, BURLAP, AND ROPE SHALL BE REMOVED, WHILE STILL PROTECTING THE INTEGRITY OF THE 2. BOTTOM OF TREE PITS TO BE COMPACTED TO PREVENT SETTLING ROOT FLARE TO BE FLUSH W/ GRADE, REMOVE SOIL TO EXPOSE ROOT FLARE

> - TAB/CB/CB/CB/CB 1

SLOPE GRADE AWAY FROM TRUNK ROOTBALL ON UNDISTURBED SOIL, TAMP UNDER ROOTBALL AS NEEDED

REMOVE SOIL AND BACKFILL WITH A MIX OF NATIVE SOIL AND COMPOST

MULCH PER DRAWINGS, MAX, 1* DEPTH OVER ROOTBALL, WITH NO MULCH 1*-2* FROM TRUNK

UNDISTURBED SOIL

Perich Sabatini 7601 Jelferson NE Suite 100 Albuquerque, NM 87109 505761-9700 lax 761-4222 dps@dpsdesign.org ARCHITECT Gensler

Dekker

a rchite clure

interiors

landscape planning

engineering

GINEER



ROJEC

Hotel Albuquerque 800 Rio Grande Blvd. NW Albuquerque, New Mexico

DRB SUBMITTAL June 24, 2014

REVISIONS

1 6-24-14 Revised Per EPC Conditions 5-8-14

DRAWN BY CM REVIEWED BY MB/WG 6.24.2014

SDP-2.1


OF

13-0020

DRAWING NAM

LANDSCAPING PLAN

SHEET NO

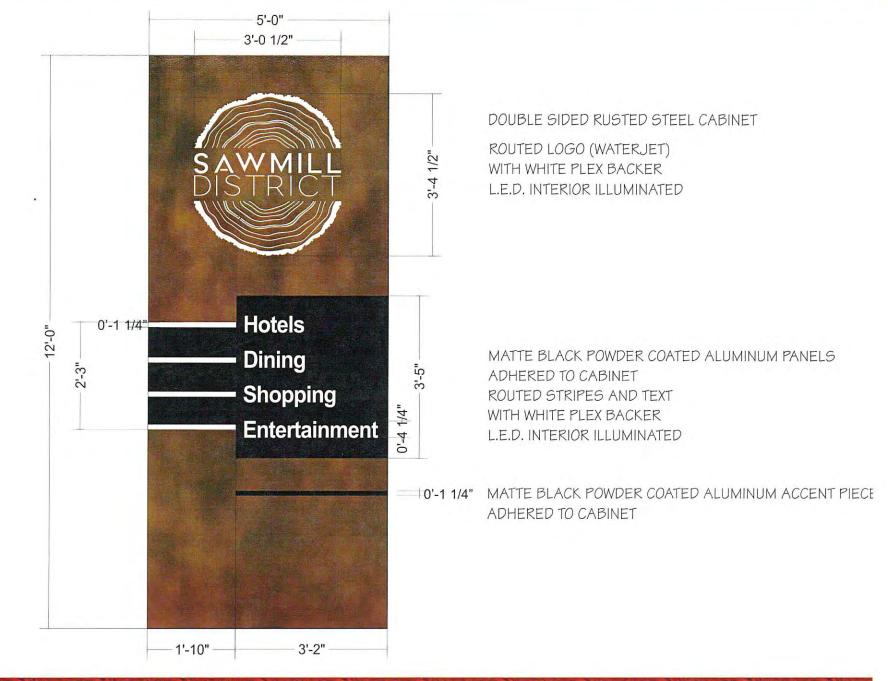

amah

SENTATIONAL ONLY. SEE MATERIAL SAMPLES FOR ACTUAL COLORS. D, INC. THESE PLANS ARE THE EXCLUSIVE PROPERTY OF SIGNART OF NEW MEXICO, INC., AND ARE THE S EMPLOYEES. THEY ARE SUBMITTED TO YOUR COMPANY FOR THE SOLE PURPOSE OF YOUR ASE THESE PLANS OR TO PURCHASE FROM SIGNART OF NEW MEXICO, INC. A SIGN MANUFACTURED ION OR EXHIBITTON OF THESE PLANS TO ANYONE OTHER THAN EMPLOYEES OF YOUR COMPANY OR SIGN SIMILAR TO THE ONE EMBODIED HEREIN IS EXPRESSILY FORBIDEN. IN THE EVENT THAT SUCH


ICO, INC. EXPECTS TO BE REIMBURSED \$900 IN COMPENSATION FOR THE TIME AND EFFORT ENTAILE NTENDED TO BE INSTALLED IN ACCORDANCE WITH THE REQUIREMENTS OF ARTICLE 600 OF TH R APPLICABLE LOCAL CODES. THIS INCLUES PROPER GROUNDING AND BONDING OF THE SIGN.



SCALE: 1/2"=1' SKETCH NO: 63866 5-20-22 SALES: MICAH APPROVAL:



District Entrance: (60"W x 144"H) Rio Grande & Bellamah

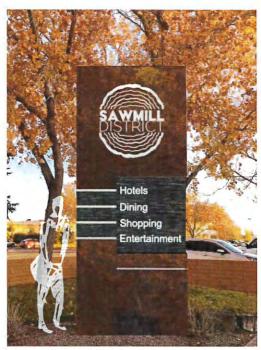

Rusted metal, wood, frosted acrylic lettering