
ADMINISTRATIVE AMENDMENT	
FILE #:	PROJECT #:
APPROVED BY	DATE

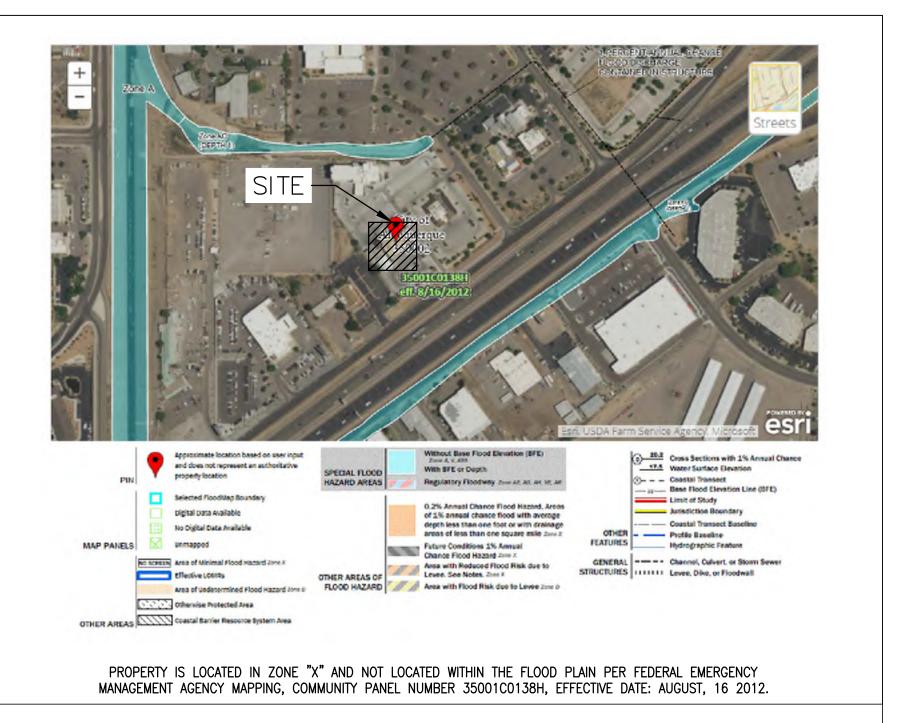

FLOOD INSURANCE RATE MAP N.T.S.

## SHEET INDEX:

C 0.0	COVER
C 1.0	DEMOLITION PLAN
SHEET 1	SITE PLAN FOR BUILDING PERMIT
C 2.0	SITE PLAN
C 2.2	FIRE PLAN
SHEET 2	CONCEPTUAL GRADING PLAN
C 3.0	GRADING AND DRAINAGE PLAN
SHEET 3	UTILITY PLAN
SHEET 5	SITE DETAILS
C 4.0	DETAIL SHEET

## ATTACHMENTS


	ALTA/NSPS
SHEET 4	OVERALL LANDSCAPE PLAN
L 1.0	LANDSCAPE PLAN
SHEET 6	EXTERIOR ELEVATIONS
A 2.1	EXTERIOR ELEVATIONS
SHEET 7	SIGNAGE

## SURVEYOR:

CSI-CARTESIAN SURVEYS INC. P.O. BOX 4414 RIO RANCHO, NM 87174 TEL: (505) 986-3050 PROJECT NO.: 190502B



# **4861 PAN AMERICAN FWY NE BERNALILLO COUNTY** ALBUQUERQUE, NM 87109 **ZONING: NR-BP**

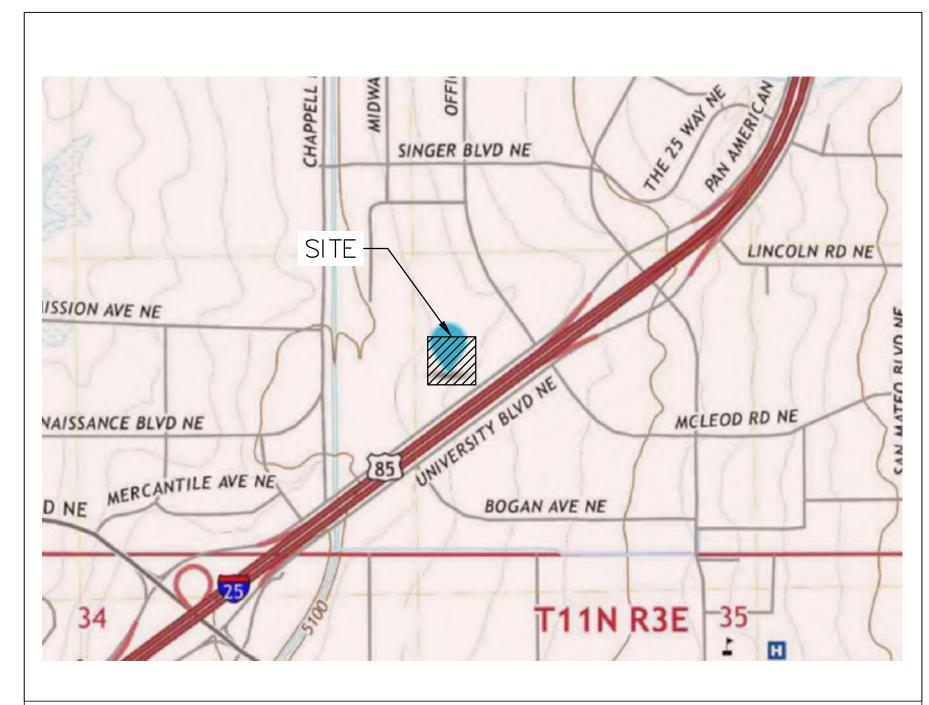

PROJECT LOCATION MAP

N.T.S.

# **DEVELOPER**:

TEXAS ROADHOUSE CONTACT: DUANE BANET 6040 DUTCHMANS LANE, SUITE 400 LOUISVILLE, KENTUCKY 40205 EMAIL: DUANE.BANET@TEXASROADHOUSE.COM

# **ENGINEER:**

CONTACT: JEFF RATH, P.E. 8600 W BRYN MAWR AVENUE, SUITE 800N CHICAGO, ILLINOIS 60631

TEL: (319) 329-1907 EMAIL: JRATH@GREENBERGFARROW.COM

PRELIMINARY PLANS	
(NAT FAD	
(NOT FOR	
CONSTRUCTION)	

\_\_\_\_\_ SHEET NUMBER **CO.0** 



COVER

SHEET TITLE

**PROJECT NUMBER** 20230442.5

NOT ISSUED FOR CONSTRUCTION





4861 PAN AMERICAN FWY NE Albuquerque, NM 87109

ALBUQUERQUE NEW MEXICO

**BUBBA'S 33** 


**PROJECT NAME** 

**QUALITY CONTROL** DRAWN BY

**PROFESSIONAL IN CHARGE** RYAN SCO **PROJECT MANAGER** 





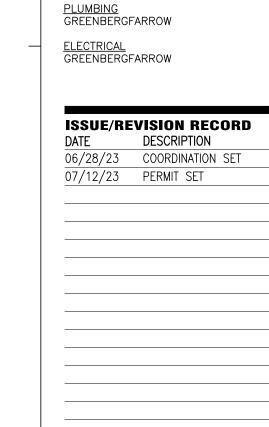

www.greenbergfarrow.com 8600 W Bryn Mawr Ave

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**PROJECT TEAM** <u>CIVIL</u> GREENBERGFARROW


STRUCTURAL GREENBERGFARROW

MECHANICAL GREENBERGFARROW

## GENERAL DEMOLITION NOTES:

- 1. CONTRACTOR SHALL OBTAIN ALL NECESSARY PERMITS PRIOR TO COMMENCEMENT OF CONSTRUCTION.
- 2. CONTRACTOR SHALL COORDINATE ALL DEMOLITION WORK WITH THE MUNICIPALITY AND OWNERS REPRESENTATIVE TO ENSURE PROTECTION AND MAINTENANCE OF EXISTING UTILITY SERVICES AND SITE FEATURES NOT NOTED FOR REMOVAL.
- 3. CONTRACTOR SHALL CONTACT STATE ONE CALL SYSTEM (811) AND/OR PRIVATE LOCATING SERVICE TO LOCATE ALL UNDERGROUND UTILITY LINES PRIOR TO STARTING ANY DEMOLITION AND/OR EXCAVATION. EXACT LOCATIONS OF ANY EXISTING ELECTRIC, GAS, TELEPHONE, ETC. LINES ARE UNKNOWN.
- 4. CONTRACTOR SHALL PERFORM ALL DEMOLITION WORK IN ACCORDANCE WITH ALL APPLICABLE FEDERAL, STATE, AND LOCAL REQUIREMENTS. 5. ALL EROSION AND SEDIMENTATION CONTROL MEASURES AND DEVICES SHALL BE INSTALLED
- AND FUNCTIONAL BEFORE THE SITE IS OTHERWISE DISTURBED. THEY SHALL BE KEPT OPERATIONAL AND MAINTAINED CONTINUOUSLY THROUGHOUT THE PERIOD OF LAND DISTURBANCE UNTIL PERMANENT SITE STABILIZATION IS ACHIEVED.
- 6. THE PURPOSE OF THIS DRAWING IS TO CONVEY THE OVERALL SCOPE OF DEMOLITION WORK AND IT IS NOT INTENDED TO COVER ALL DETAILS OR SPECIFICATIONS REQUIRED TO COMPLY WITH GENERALLY ACCEPTED DEMOLITION PRACTICES. CONTRACTOR SHALL THOROUGHLY FAMILIARIZE THEMSELVES WITH THE SITE, SCOPE OF WORK, AND ALL EXISTING CONDITIONS AT THE JOB SITE PRIOR TO BIDDING AND COMMENCING THE WORK. THE DEMOLITION CONTRACTOR SHALL BE SOLELY RESPONSIBLE FOR MEANS, METHODS, TECHNIQUES, OR PROCEDURES USED TO COMPLETE THE WORK IN ACCORDANCE WITH THE CONSTRUCTION DOCUMENTS AND IS LIABLE FOR THE SAFETY OF THE PUBLIC AND CONTRACTOR'S EMPLOYEES DURING THE COURSE OF THE PROJECT.
- . THE DEMOLITION PLAN IS INTENDED TO SHOW REMOVAL OF KNOWN SITE FEATURES AND UTILITIES AS SHOWN ON THIS PLAN SET. THERE MAY BE OTHER SITE FEATURES, UTILITIES, STRUCTURES, AND MISCELLANEOUS ITEMS BOTH BURIED AND ABOVE GROUND THAT ARE WITHIN THE LIMITS OF WORK THAT MAY REQUIRE REMOVAL FOR THE PROPOSED SITE IMPROVEMENTS BUT THAT ARE NOT SHOWN HEREON. THE CONTRACTOR IS RESPONSIBLE FOR THE REMOVAL OF SUCH ITEMS AT NO ADDITIONAL COST TO THE OWNER.
- 8. CONTRACTOR SHALL UTILIZE CARE WHEN WORKING NEAR EXISTING UTILITIES TO REMAIN. ANY DAMAGE TO EXISTING UTILITIES NOT NOTED TO BE REMOVED SHALL BE REPAIRED AT CONTRACTOR'S EXPENSE AND TO THE SATISFACTION OF THE OWNER AND/OR ENGINEER.
- . ALL EXISTING SANITARY SEWERS, STORM SEWERS, WATER MAINS OR IRRIGATION LINES AND APPURTENANCES NOTED FOR REMOVAL WITHIN THE AREA OF THE PROPOSED CONSTRUCTION SHALL BE REMOVED FROM THE SITE AND DISPOSED OF BY THE CONTRACTOR. ALL ABANDONED SEWER LINES SHALL BE PLUGGED AT BOTH ENDS WITH A MINIMUM OF TWO (2) FEET LONG NON-SHRINK CONCRETE MORTAR PLUGS.
- 10. VOIDS LEFT BY ANY ITEM REMOVED UNDER ANY PROPOSED BUILDINGS, PAVEMENTS, OR WALKS OR WITHIN 24" THEREOF SHALL BE BACKFILLED IN ACCORDANCE WITH THIS PLAN SFT
- 11. ALL EXISTING LANDSCAPING NOTED TO BE REMOVED SHALL BE REMOVED FROM THE SITE AND DISPOSED OF BY THE CONTRACTOR. 12. PRIOR TO REMOVAL OF ANY PORTION OF THE EXISTING IRRIGATION SYSTEM AFFECTED BY THE PROPOSED BUILDING ADDITION CONTRACTOR SHALL LOCATE AND CAP THE EXISTING IRRIGATION LINES AT THE PROJECT AREA LIMITS. THE REMAINDER OF THE EXISTING SYSTEM SHALL REMAIN OPERATIONAL AT ALL TIMES DURING CONSTRUCTION. IF FOR ANY REASON THE SYSTEM WILL NOT BE OPERATIONAL CONTRACTOR SHALL UTILIZE CARE TO
- ENSURE EXISTING PLANT MATERIAL IS ADEQUATELY WATERED DURING DRY PERIODS OR TIMES OF EXTENDED HEAT. 13. CONTRACTOR SHALL REPAIR AT HIS EXPENSE ANY DAMAGE TO EXISTING ASPHALT, CONCRETE, CURBS, SIDEWALKS, ETC. RESULTING FROM CONSTRUCTION TRAFFIC AND/OR OPERATIONS. REPAIRS SHALL BE MADE TO THE SATISFACTION OF THE OWNER AND/OR

## DEMOLITION HATCH LEGEND:

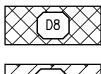


ENGINEER.


EXISTING SIDEWALK TO BE REMOVED




D14

EXISTING LANDSCAPING TO BE REMOVED

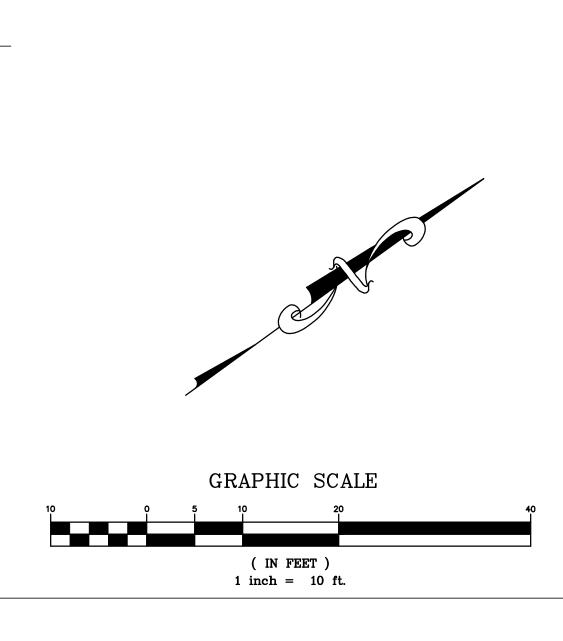

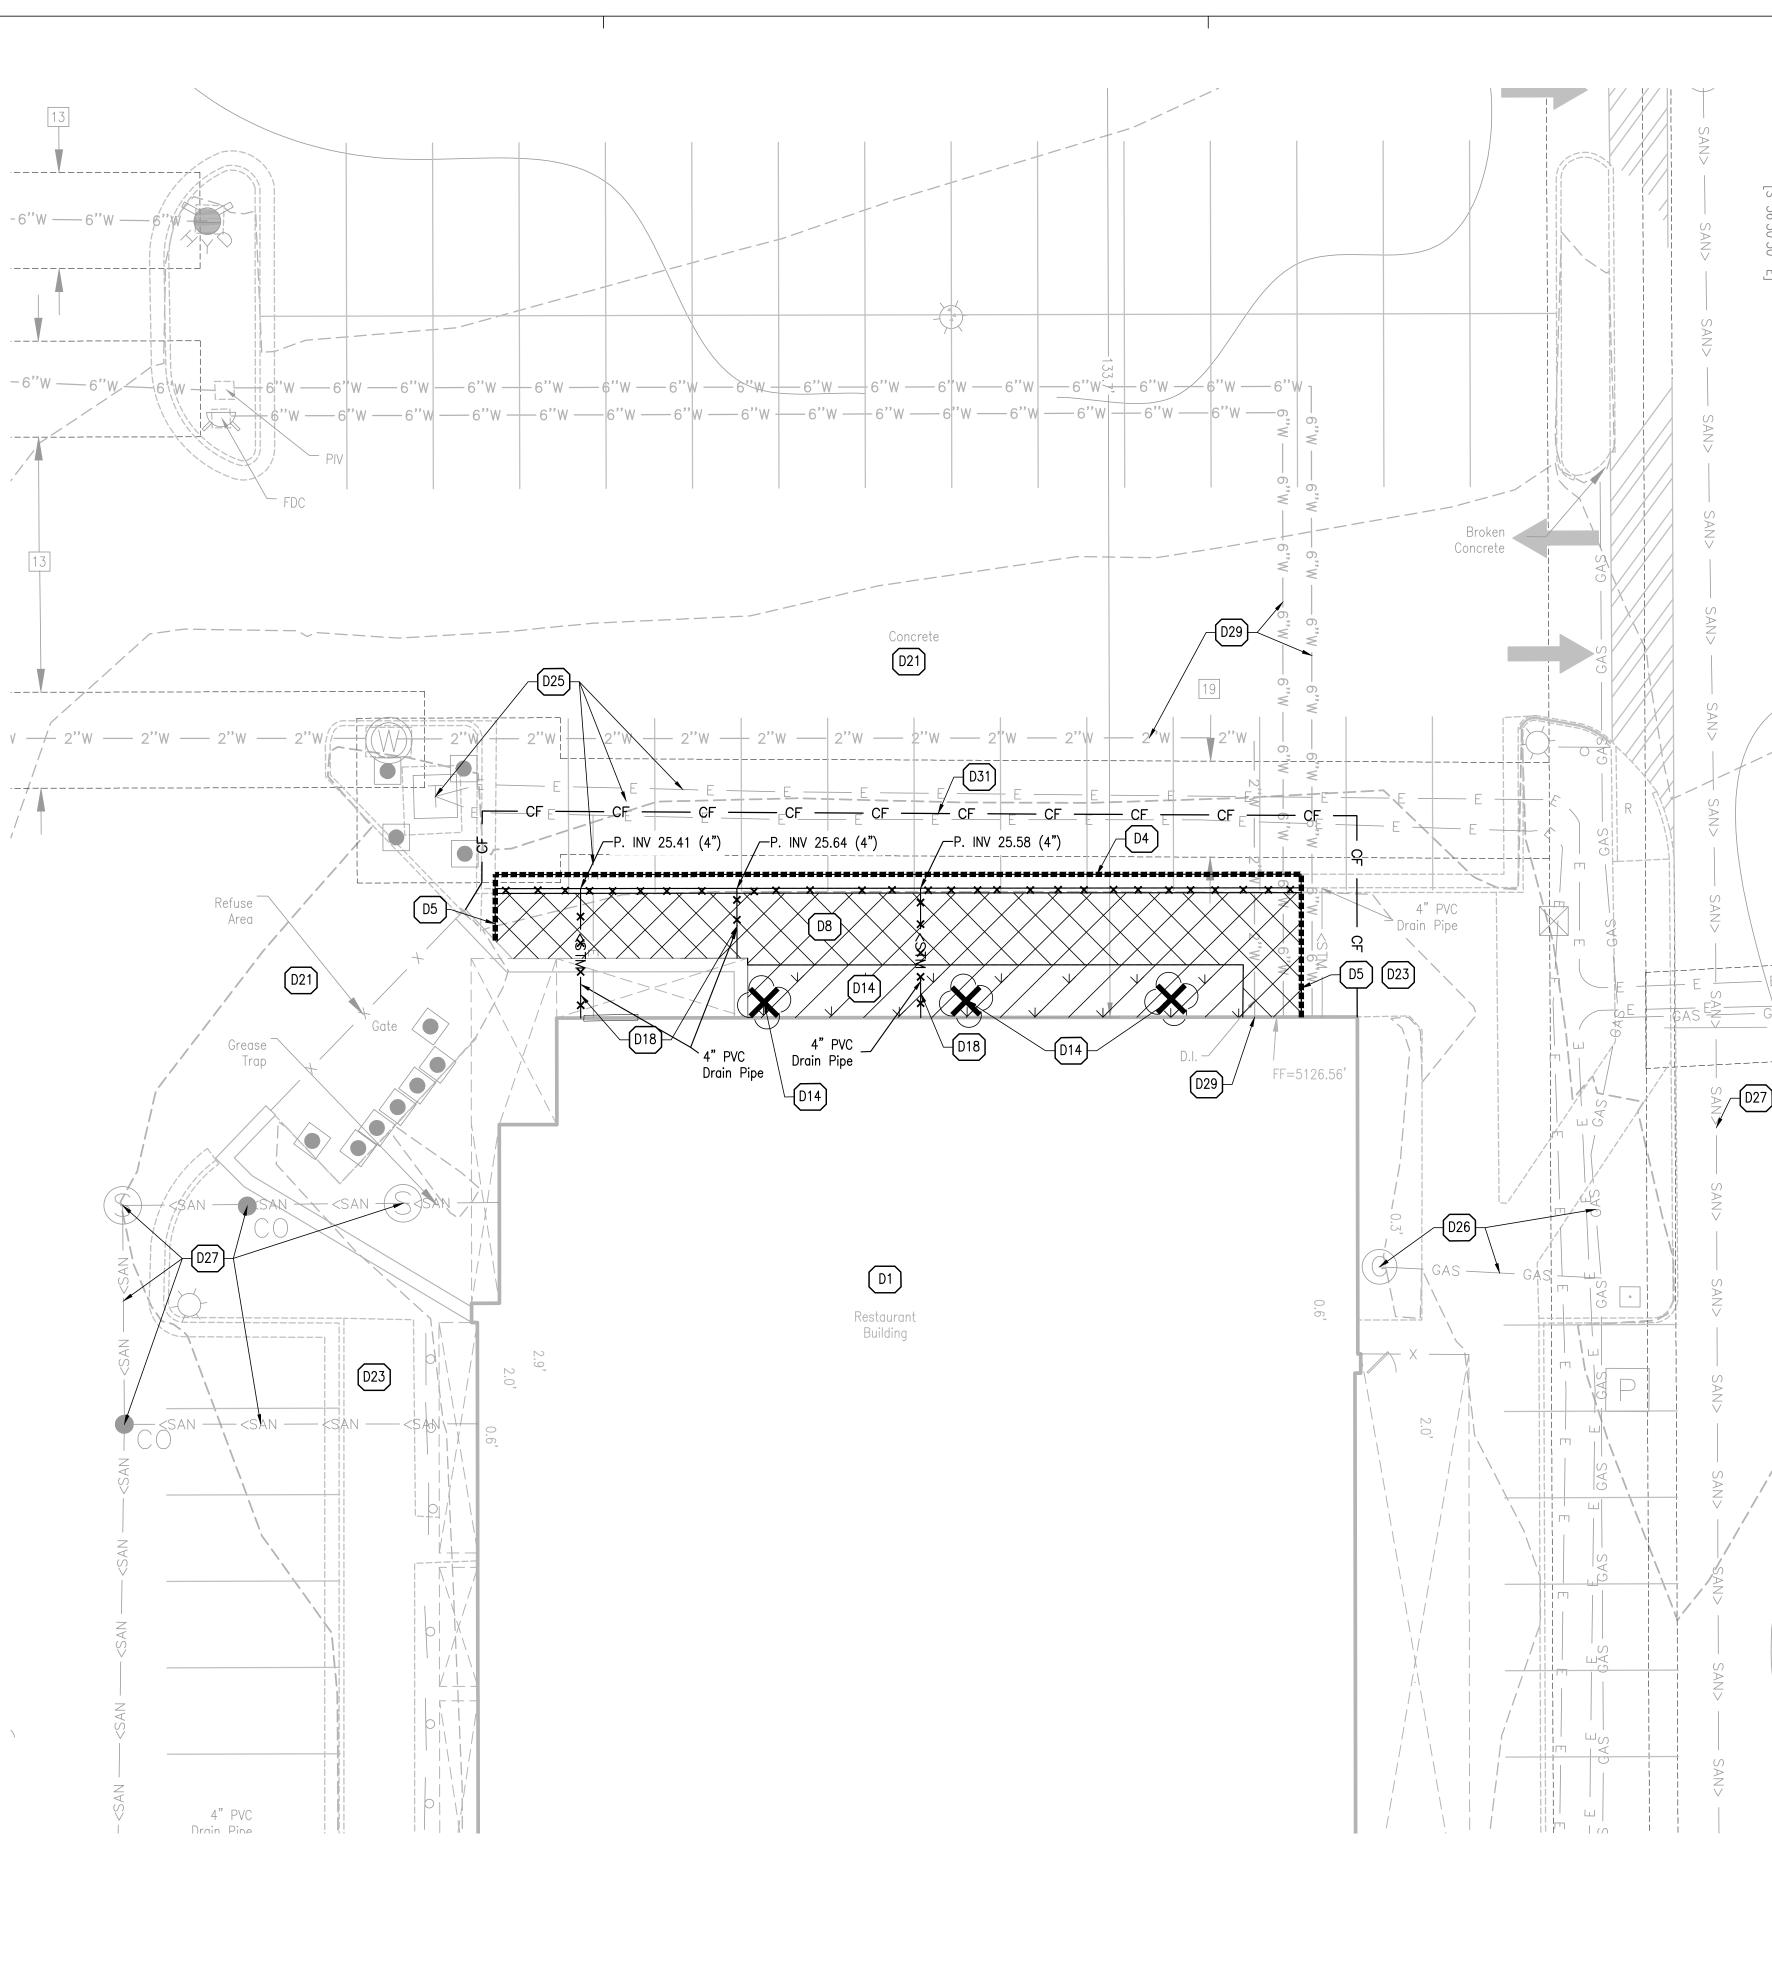

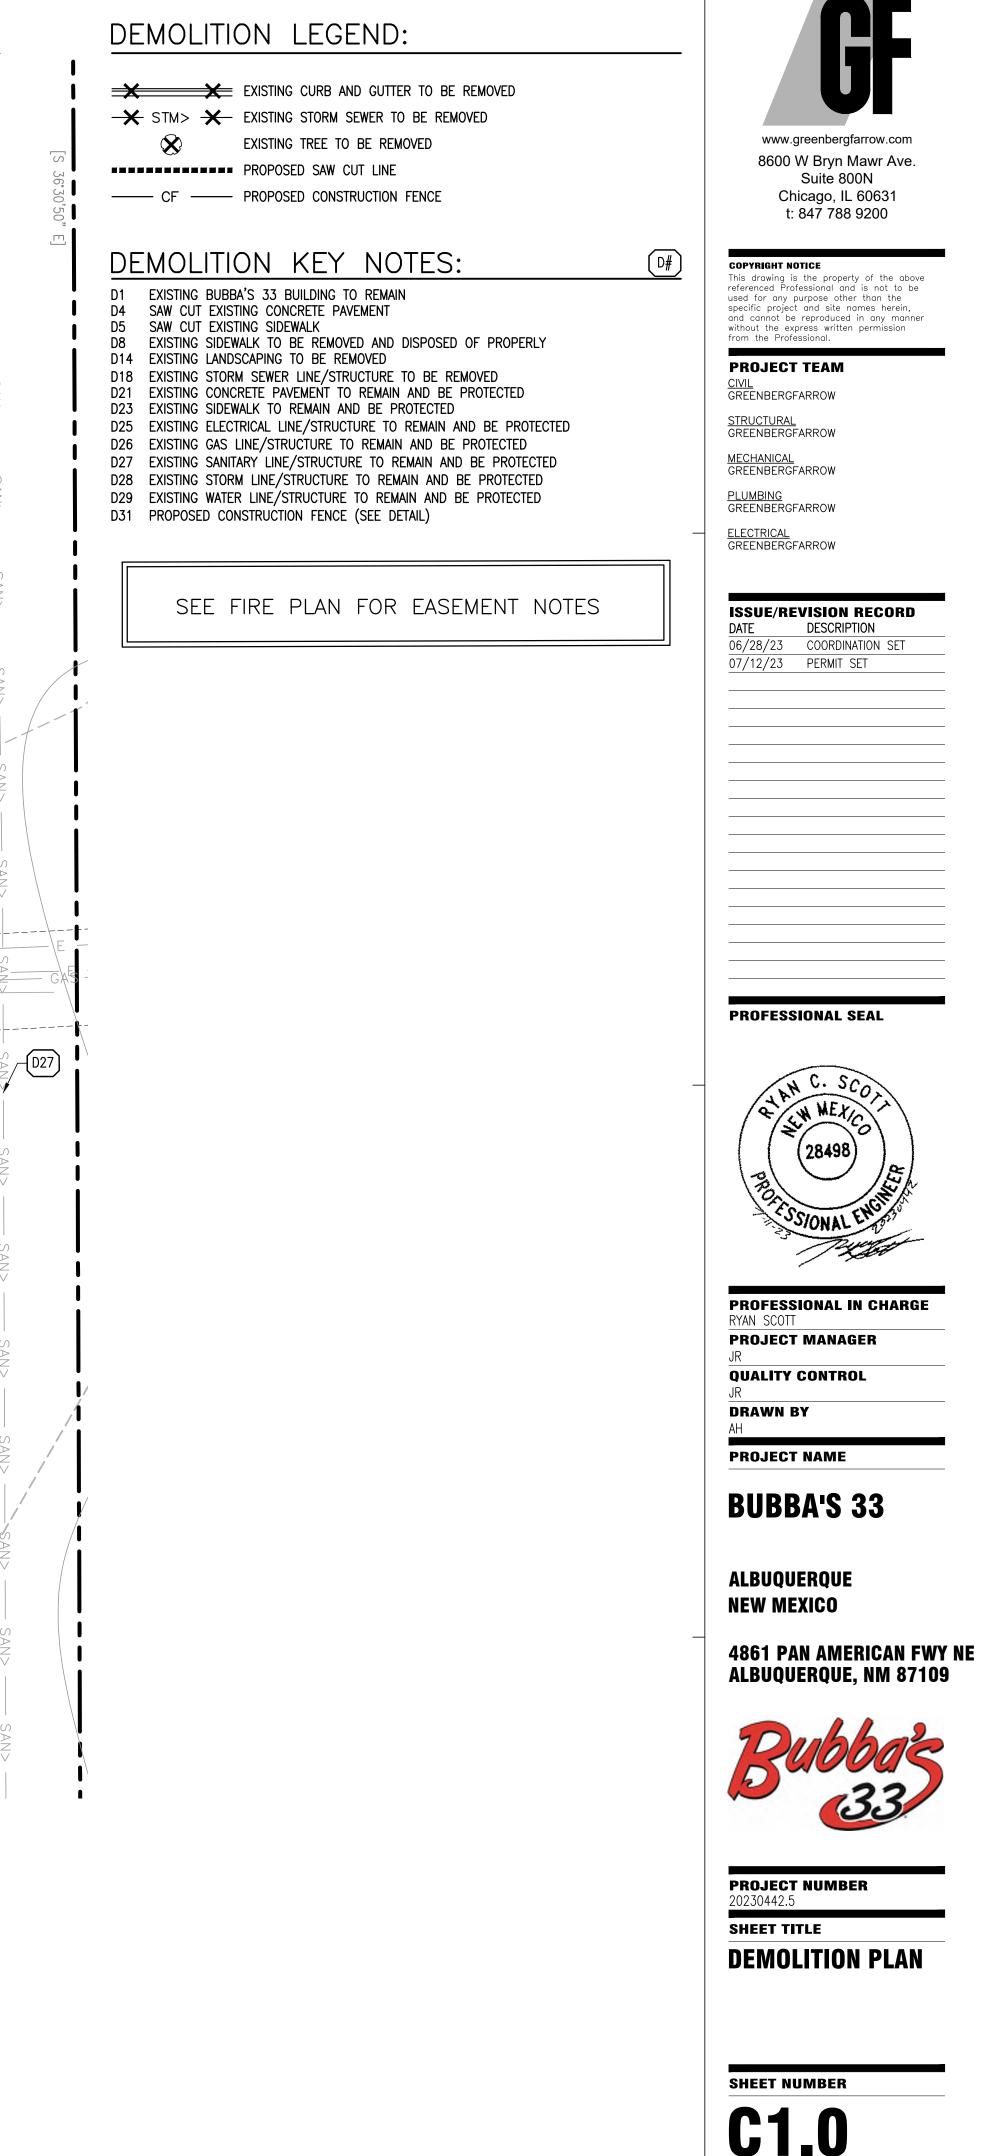

## GENERAL SITE AND UTILITY NOTES:

- 1. CONTRACTOR SHALL BE RESPONSIBLE FOR PROVIDING SAFE AND ADEQUATE WORKING CONDITIONS THROUGHOUT THE DURATION OF CONSTRUCTION OF THE PROPOSED SITE IMPROVEMENTS.
- 2. ALL CONSTRUCTION MATERIALS AND WORKMANSHIP SHALL BE IN ACCORDANCE WITH THE LATEST STATE AND LOCAL GOVERNMENT CONSTRUCTION STANDARDS AND SPECIFICATIONS.
- 3. ALL HANDICAP ACCESSIBLE SITE IMPROVEMENTS SHALL BE CONSTRUCTED IN ACCORDANCE
- WITH ALL FEDERAL, STATE AND LOCAL CODES AND REQUIREMENTS.
- 4. CONSTRUCTION SURVEY AND STAKEOUT SHALL BE THE RESPONSIBILITY OF THE CONTRACTOR.
- 5. IF DURING THE COURSE OF CONSTRUCTION THE CONTRACTOR FINDS ANY DISCREPANCIES OR CONFLICTS BETWEEN THE PROPOSED SITE IMPROVEMENTS INDICATED ON THE PLANS AND THE PHYSICAL CONDITIONS OF THE SITE, OR ANY ERRORS OR OMISSIONS WITHIN THE PLANS OR IN THE SITE LAYOUT AS PROVIDED BY THE ENGINEER. IT SHALL BE THE RESPONSIBILITY OF THE CONTRACTOR TO IMMEDIATELY NOTIFY THE ENGINEER. UNTIL AUTHORIZED TO PROCEED, ANY WORK PERFORMED BY THE CONTRACTOR AFTER SUCH A DISCOVERY WILL BE AT THE CONTRACTOR'S SOLE RISK AND EXPENSE.
- 6. CONTRACTOR SHALL COORDINATE ALL SITE IMPROVEMENTS WITH ARCHITECTURAL PLANS. ARCHITECTURAL PLANS SHALL BE USED FOR BUILDING STAKEOUT.
- 7. ALL PROPOSED GRADING, PAVEMENT, APRONS, CURBS, WALKS, ETC. SHALL MATCH EXISTING GRADES FLUSH.
- 8. ALL GRADING AND SITE PREPARATION WORK SHALL CONFORM WITH THE RECOMMENDATIONS AND SPECIFICATIONS CONTAINED IN THIS PLAN SET. 9. MAXIMUM CROSS SLOPES AND LONGITUDINAL SLOPES FOR ALL CONCRETE SIDEWALKS AND
- HANDICAP ACCESSIBLE ROUTES SHALL NOT EXCEED 2% AND 5%, RESPECTIVELY. 10. MAXIMUM SLOPES WITHIN THE HANDICAP ACCESSIBLE PARKING AREAS SHALL NOT EXCEED
- 2% IN ANY DIRECTION. 11. MAXIMUM GRADE DIFFERENCE BETWEEN PAVEMENT SURFACES AND ADJACENT CONCRETE SIDEWALKS FOR THE ACCESSIBLE ROUTE TO THE BUILDING SHALL NOT EXCEED 1/4" VERTICAL OR 1/2" WHEN BEVELED.
- 12. ALL HANDICAP ACCESSIBLE EXTERIOR DOORWAY LOCATIONS REQUIRE AN EXTERIOR LANDING THAT IS A MINIMUM OF FIVE (5) FEET IN LENGTH WITH A SLOPE NOT EXCEEDING 2% IN ANY DIRECTION.
- 13. CONTRACTOR SHALL ENSURE POSITIVE DRAINAGE TO EXISTING AND/OR PROPOSED STORM DRAINAGE STRUCTURES. AREAS OF SURFACE PONDING SHALL BE CORRECTED BY THE CONTRACTOR AT NO ADDITIONAL EXPENSE TO THE OWNER.
- 14. EXCAVATION SHORING SHALL BE DONE AS NECESSARY FOR THE PROTECTION OF THE WORK AND FOR THE SAFETY OF PERSONNEL. SHORING SHALL BE IN ACCORDANCE WITH ALL O.S.H.A AND LOCAL REGULATIONS.
- 15. ALL FIRE ACCESS LANES WITHIN THE PROJECT AREA SHALL REMAIN IN SERVICE, CLEAN OF DEBRIS, AND ACCESSIBLE FOR USE BY EMERGENCY VEHICLES AT ALL TIMES. 16. CONTRACTOR IS SPECIFICALLY CAUTIONED THAT THE LOCATION AND/OR ELEVATION OF
- EXISTING UTILITIES AS SHOWN ON THESE PLANS IS BASED ON RECORDS OF THE VARIOUS UTILITY COMPANIES AND, WHERE POSSIBLE, MEASUREMENTS TAKEN IN THE FIELD. THE INFORMATION IS NOT TO BE RELIED ON AS BEING EXACT OR COMPLETE. THE CONTRACTOR MUST CALL THE LOCAL UTILITY LOCATION CENTER AT LEAST FORTY-EIGHT (48) HOURS BEFORE ANY EXCAVATION TO REQUEST EXACT FIELD LOCATIONS OF THE UTILITIES. IT SHALL BE THE RESPONSIBILITY OF THE CONTRACTOR TO RELOCATE ALL EXISTING UTILITIES WHICH CONFLICT WITH THE PROPOSED SITE IMPROVEMENTS SHOWN ON THE PLANS.
- 17. CONTRACTOR SHALL UTILIZE CARE WHEN WORKING NEAR EXISTING UTILITIES TO REMAIN. ANY DAMAGE TO EXISTING UTILITIES NOT NOTED TO BE REMOVED SHALL BE REPAIRED AT THE CONTRACTOR'S EXPENSE AND TO THE SATISFACTION OF THE OWNER AND/OR ENGINEER.
- 18. CONTRACTOR SHALL RESTORE ALL DISTURBED AREAS OUTSIDE OF CONSTRUCTION LIMITS TO ORIGINAL CONDITION OR BETTER.

## PROPOSED HATCH LEGEND:

S15


PROPOSED CONCRETE SIDEWALK 5" PORTLAND CEMENT CONCRETE 4" AGGREGATE BASE


GRAPHIC SCALE

( IN FEET ) 1 inch = 10 ft.





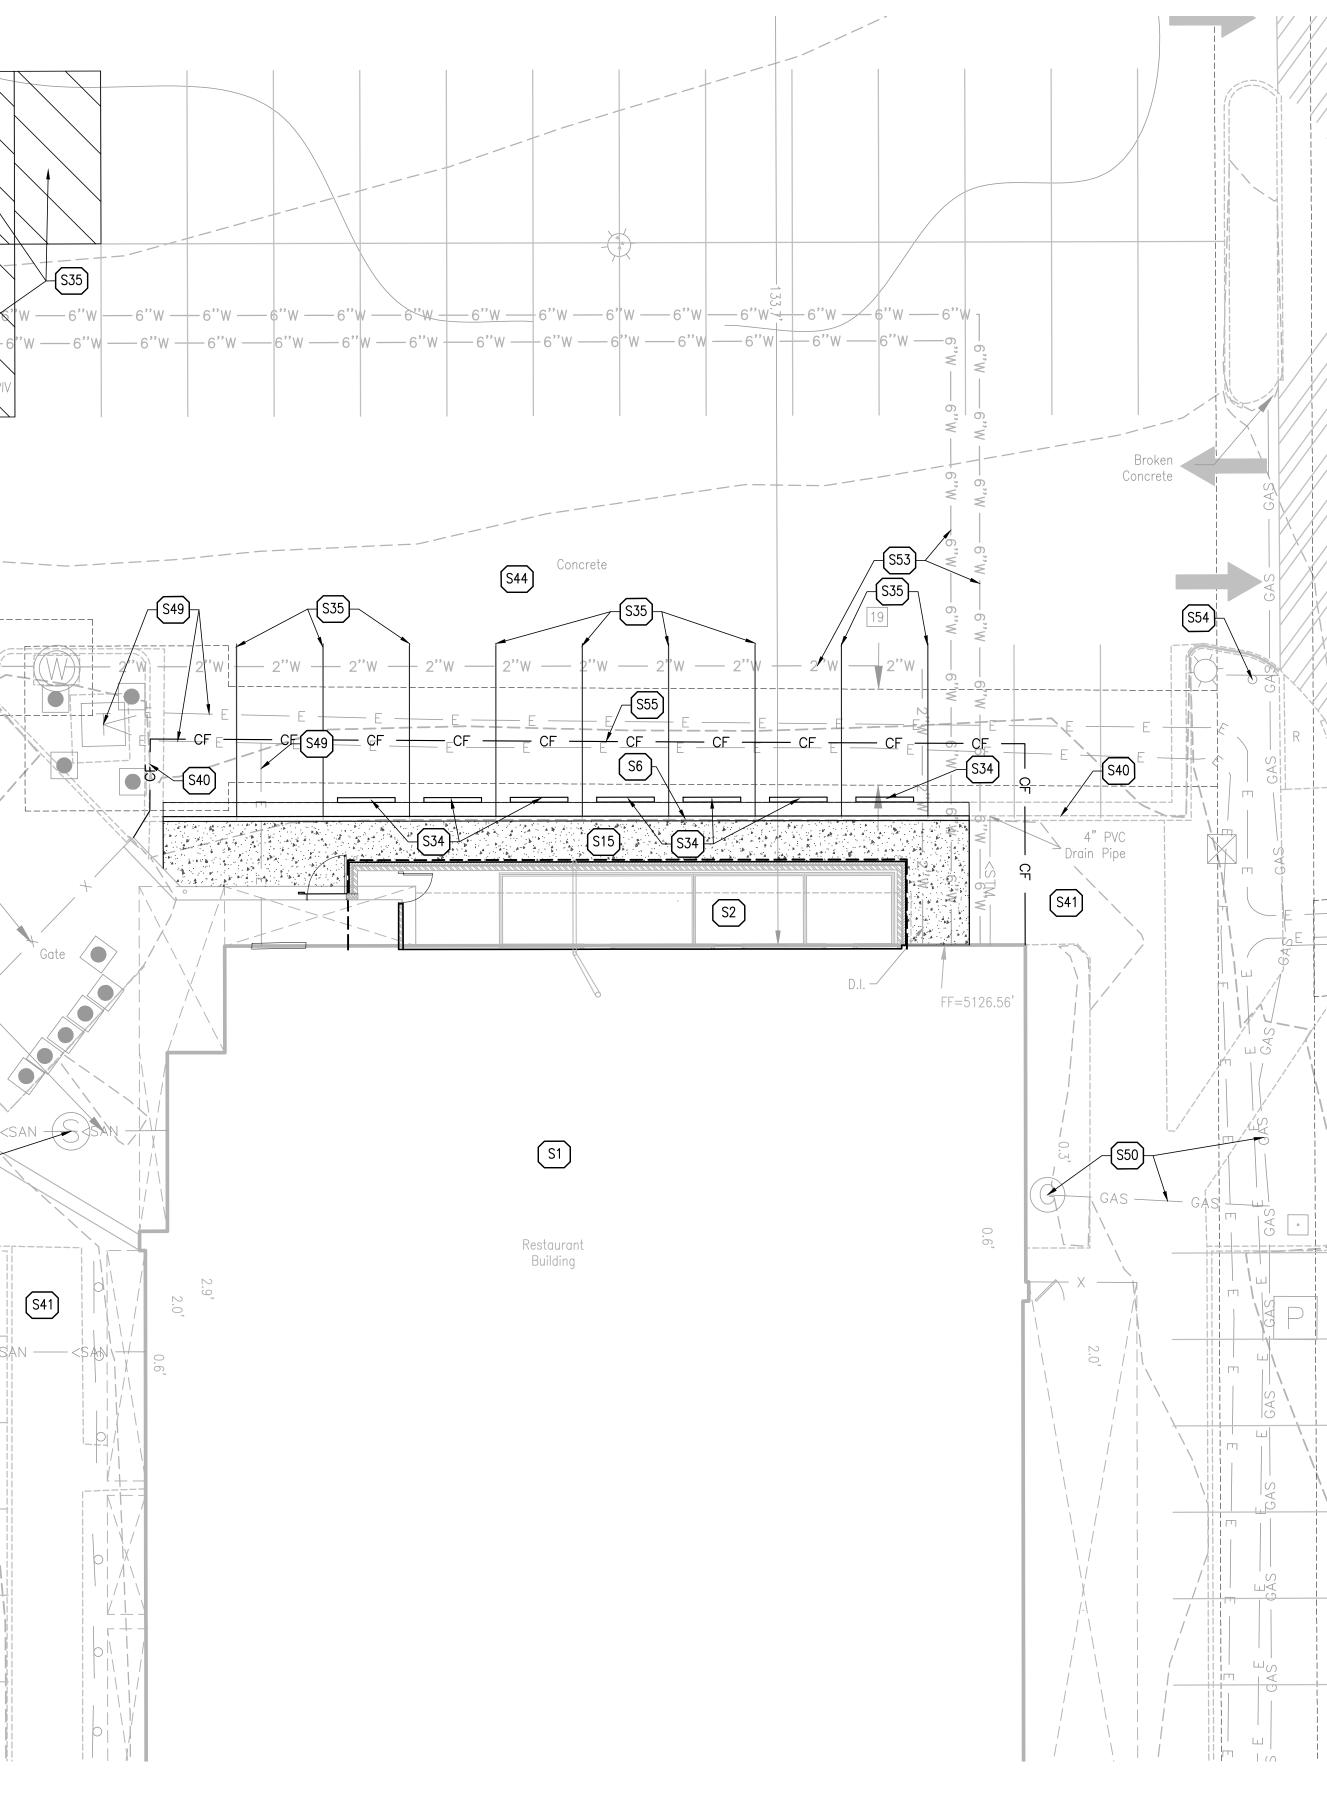

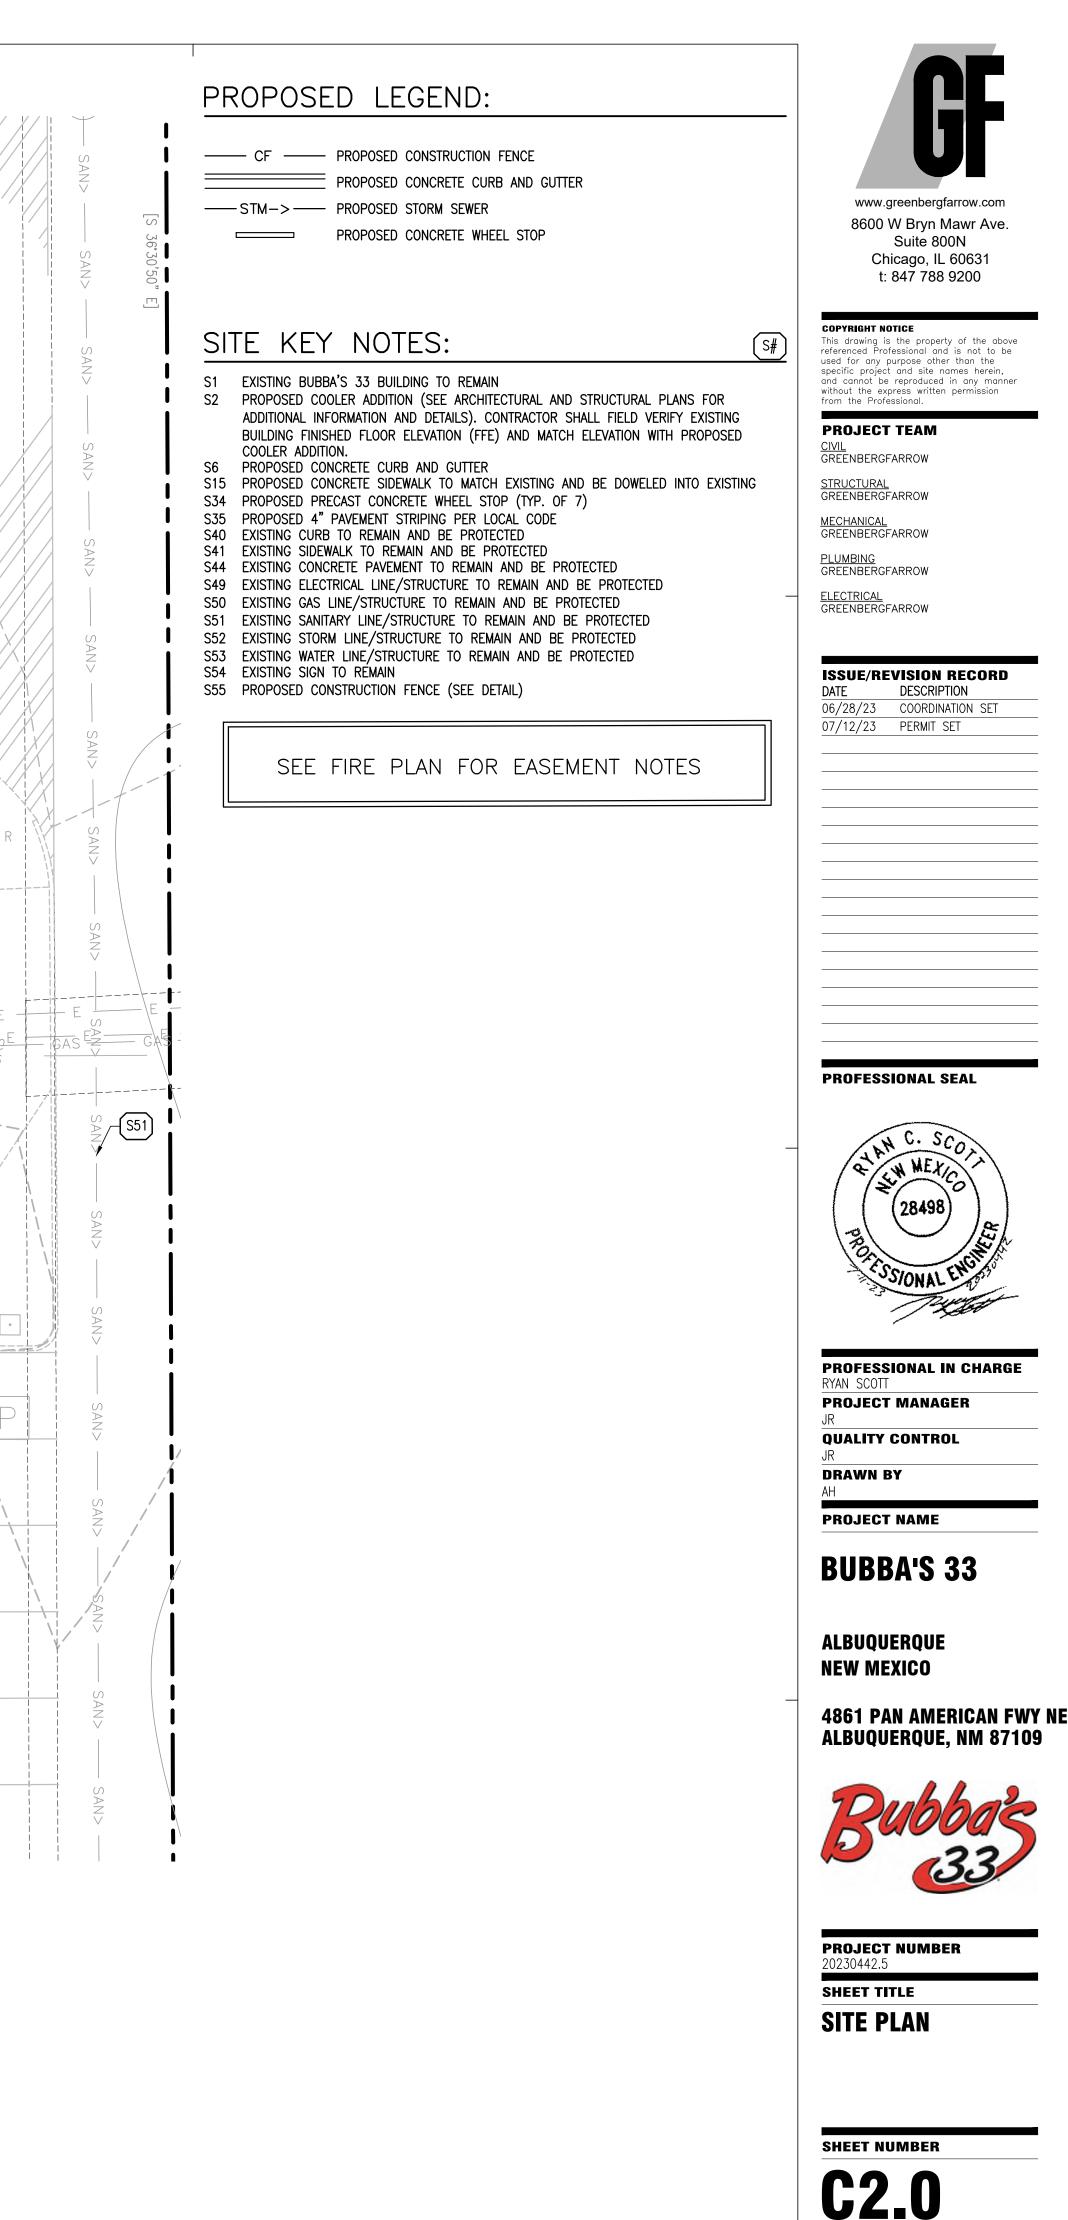

## CODE CRITERIA:

CONSTRUCTION TYPE: VB SQUARE FOOTAGE: 9,160 SF FIRE FLOW: 1,500 GPM NUMBER OF HYDRANTS REQUIRED: 1 750 FEET WITH SPRINKLERS HYDRANT SPACING REQUIRED: SPRINKLER SYSTEM: SPRINKLERED

## FIRE INFORMATION:

FIRE CASE#: BUBBA'S 33 BUILDING AREA: 9,160 SQ. FT. CONSTRUCTION TYPE: VB OCCUPANCY: A2 BUILDING HEIGHT:

27'-6" ADJACENT TO FRONT DOOR ON SE SIDE OF THE BUILDING (VERIFY KNOX BOX LOCATION:

FDC LOCATION: PIV LOCATION:

EXACT LOCATION) NW OF BUILDING (SEE PLAN) NW OF BUILDING (SEE PLAN) HYDRANT LOCATIONS: EXISTING NW OF BUBBA'S 33 RESTAURANT (SEE PLAN)

## SITE INFORMATION:

#### LEGAL DESCRIPTION TRACT: PARCEL ID: ZONING

A-1-C-1-A-2-A 101706107629520113 NR-BP (NON-RESIDENTIAL BUISINESS PARK)

GROSS BUILDING AREA (GBA): BUBBA'S 33 BUILDING AREA: BUBBA'S 22BUILDING ADDITION:

8,700 SQ. FT. <u>460 SQ. FT.</u> 9,160 SQ. FT. ±92,691 SQ. FT.  $\pm 2.128$  ACRES

0.99

GROSS F.A.R. (GBA/SITE AREA):

## ADDRESS:

TOTAL SITE AREA:

4861 PAN AMERICAN FREEWAY NE ALBUQUERQUE, NM 87109

## LEGAL DESCRIPTION:

TRACT "A-1-C-1-A-2-A", OF CRYER PROPERTY, A REPLAT OF TRACT A-1-C-1-A, A SUBDIVISION TO THE CITY OF ALBUQUERQUE, NEW MEXICO, AS THE SAME IS SHOWN AND DESIGNATED ON THE PLAT OF SAID SUBDIVISION, FILED IN THE OFFICE OF THE COUNTY CLERK OF BERNALILLO COUNTY, NEW MEXICO, ON JUNE 2, 2014, IN PLAT BOOK 2014C, PAGE 48.


## LEGEND:


EXISTING FIRE LANE PAINT ON CURB

PROPOSED FIRE LANE PAINT ON CURB PROPOSED FIRE LANE PAINT ON PAVEMENT PROPOSED FIRE LANE

FIRE ACCESS

---- PROPOSED ADA PATH OF TRAVEL

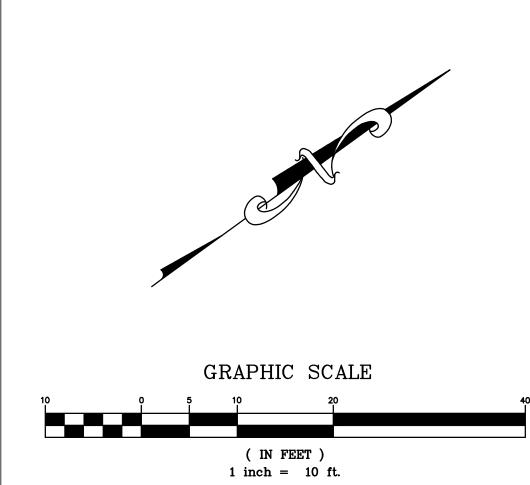

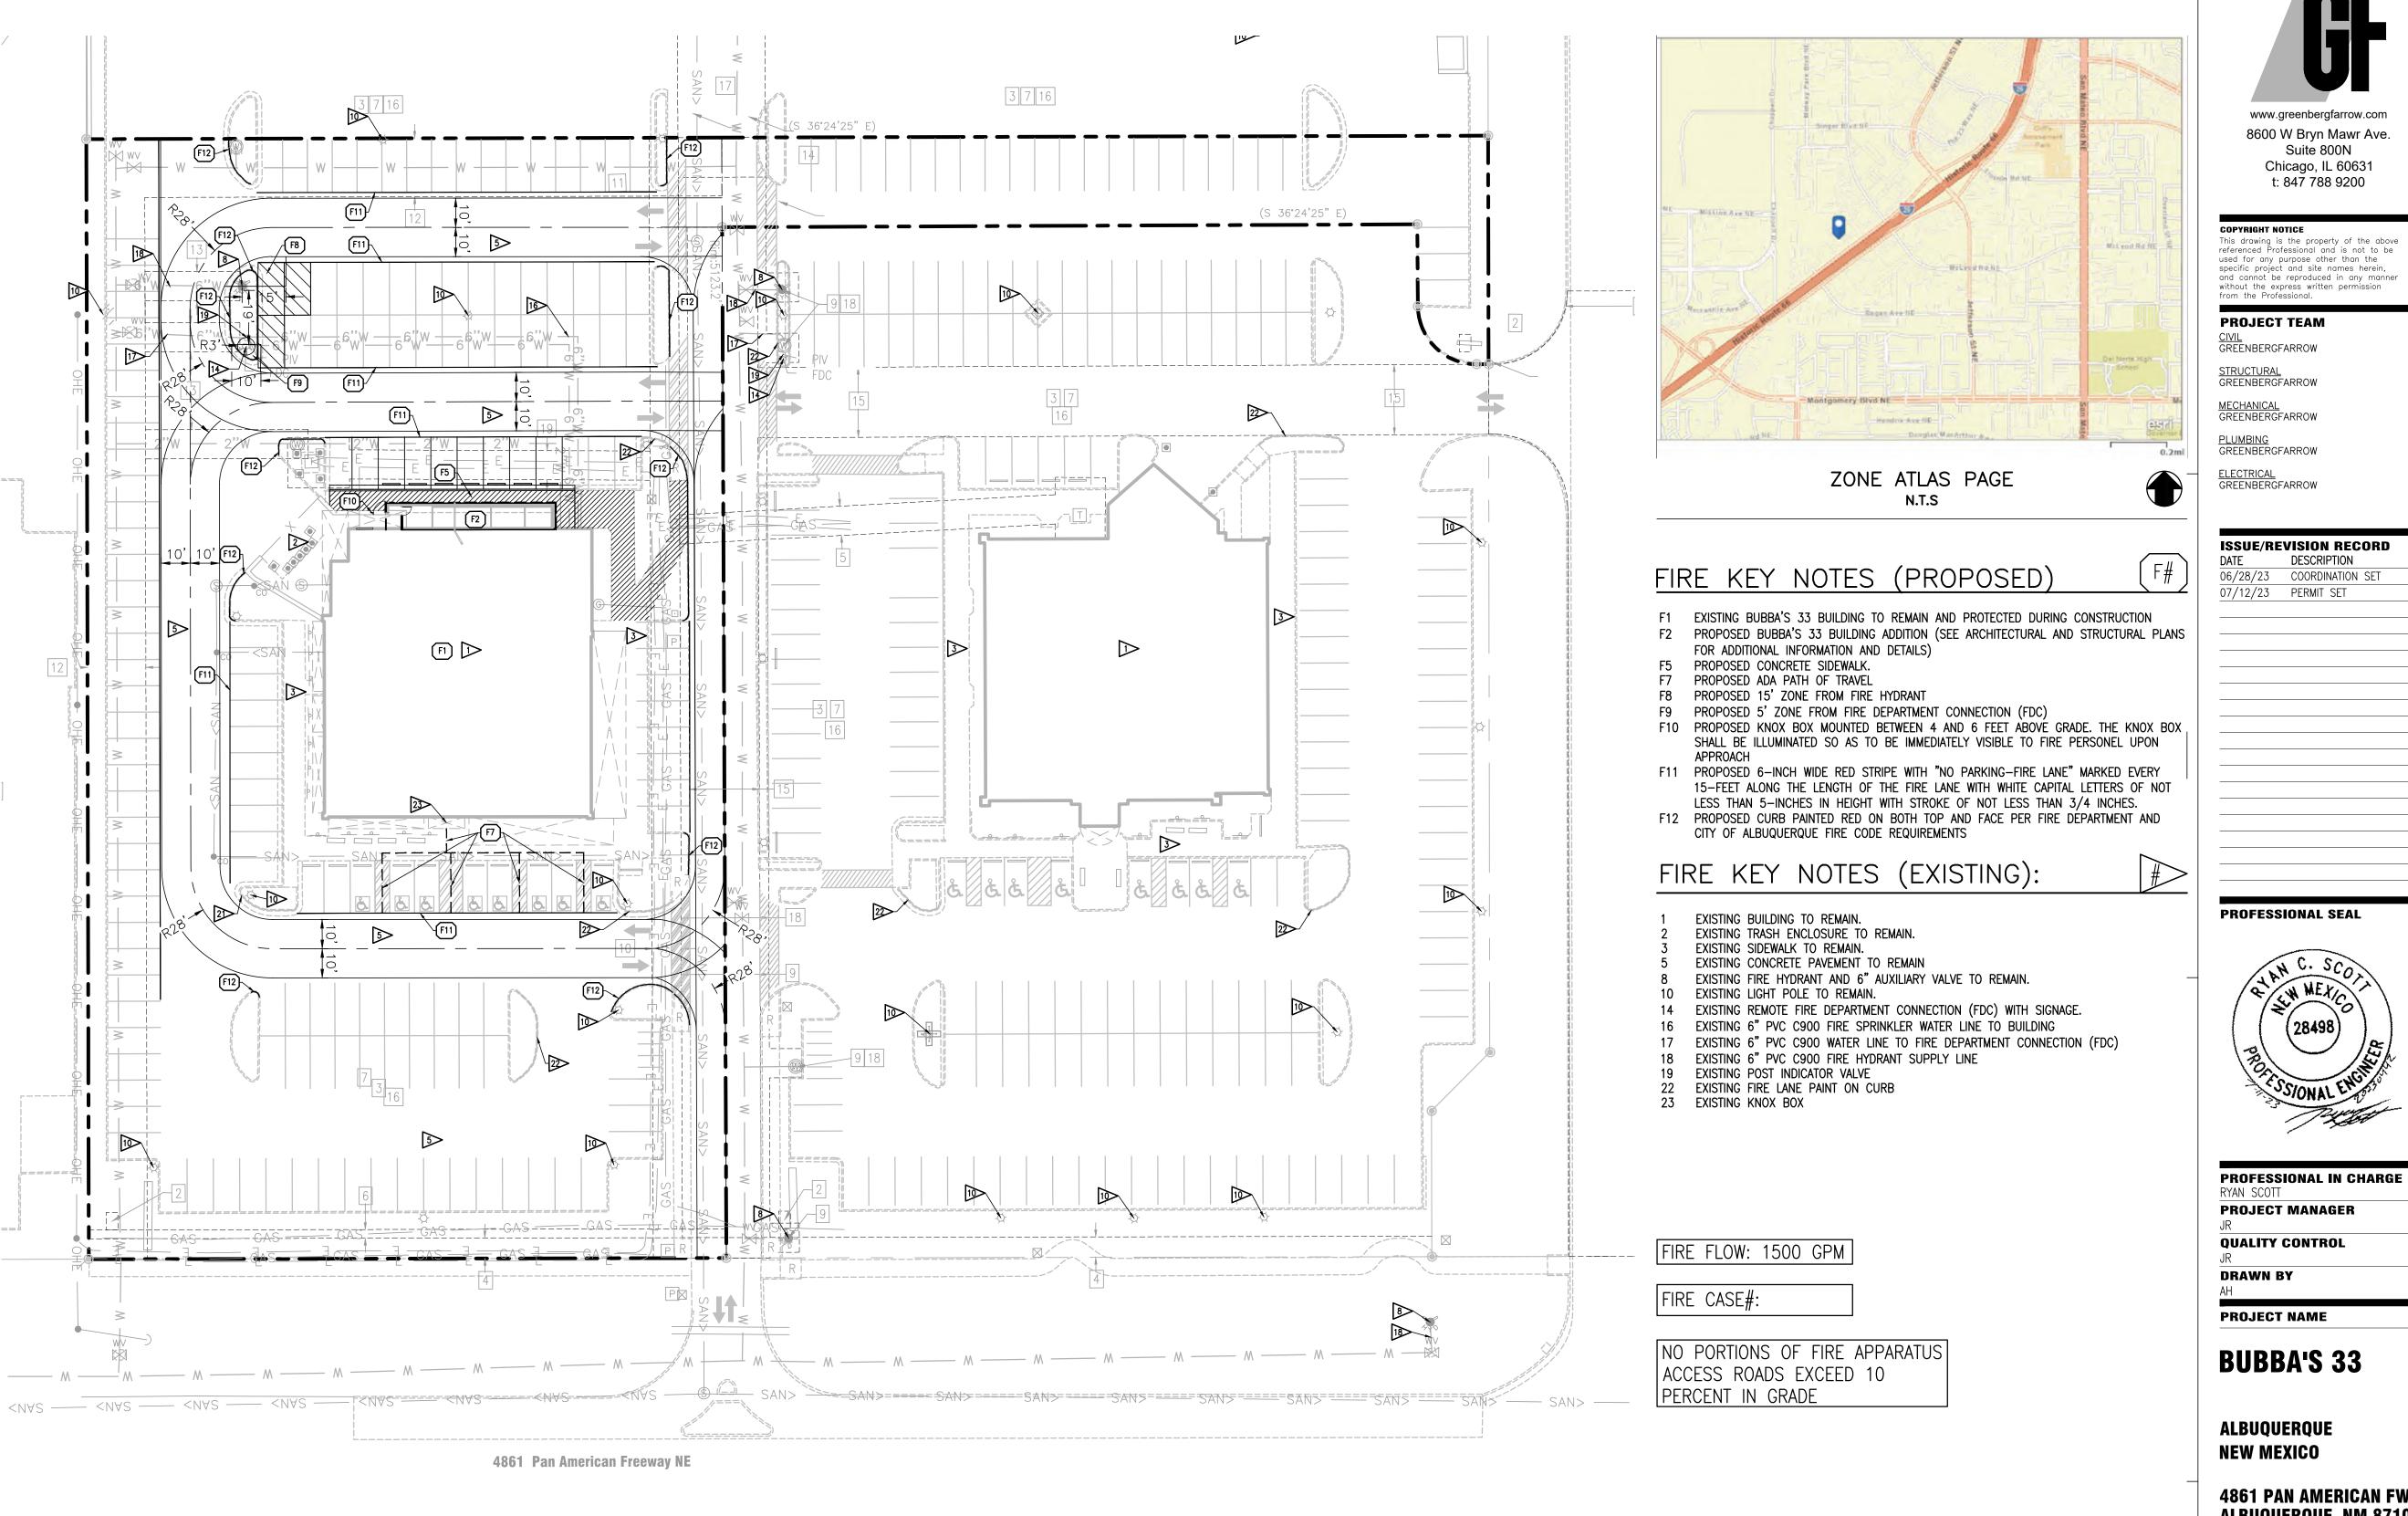

## EASEMENT NOTES:

1 EXISTING 40'X55' PRIVATE STORM WATER PRIVATE DRAINAGE EASEMENT (10/02/2013, DOC. NO. 201311

- 2 EXISTING 4'X6' SIGN EASEMENT
- (10/02/2013, DOC. NO. 2013110237)
- 3 EXISTING RECIPROCAL PRIVATE CROSS DRAINAGE AND PARKING EASEMENT (12/15/2010, 2010C-133) RECIPROCAL CROSS PARKING VACATED PER 13DRB-7 (PROJECT NO. 1008519) REFERENCED ON PLATS (02/24/2014, 2014C-8)(06/02/2014, 2014C-48)
- 4 EXISTING 7' P.U.E. (08/28/1979, BK. B16, PG. 186)
- 5 EXISTING PNM EASEMENT (02/24/2014, BK. 2014C, F
- 6 EXISTING 3' P.U.E. (02/24/2014, BK. 2014C, PG. 8)
- 7 EXISTING NON-EXCLUSIVE RECIPROCAL INGRESS/EGRESS EASEMENT (10/02/2013, DOC. NO. 2013110237)

**Interstate 25** 

10237)	8 EXISTING NON-EXCLUSIVE ACCESS EASEMENT (03/25/2013, DOC. NO. 2013032803)
	9 EXISTING PERMANENT 30' PUBLIC WATER AND SANITARY SEWER EASEMENT (09/18/2013, DOC. NO. 2013105160)
D	10 EXISTING 10' P.U.E. (02/24/2014, BK. 2014C, PG. 8)
70780	11 EXISTING 10' P.U.E. (06/02/2014, BK. 2014C, PG. 48)
	12 EXISTING 20' PUBLIC WATERLINE EASEMENT (06/02/2014, BK. 2014C, PG. 48)
PG. 8)	13 EXISTING 10' PUBLIC WATERLINE EASEMENT (06/02/2014, BK. 2014C, PG. 48)
ESS	14 EXISTING 30' PUBLIC WATER AND SANITARY SEWER EASEMENT (06/02/2014, BK. 2014C, PG. 48)

- 15 EXISTING 24' PROTECTED DRIVE (10/02/2013, DOC. NO. 2013110237)
- 16 EXISTING NON-EXCLUSIVE AND PERPETUAL EASEMENT FOR SURFACE DRAINAGE OF STORM WATER (10/02/2013, DOC. NO. 2013110237)
- 17 EXISTING 30'X46.50' PUBLIC WATER AND SANITARY SEWER EASEMENT (10/23/2014, DOC. NO. 2014084857)
- 18 EXISTING PERMANENT 30' PUBLIC WATER AND SANITARY SEWER EASEMENT (04/18/2013, DOC. NO. 2013043005)
- 19 EXISTING UNDERGROUND PNM EASEMENT (01/06/2016, DOC. NO. 2016001101)

**4861 PAN AMERICAN FWY NE** ALBUQUERQUE, NM 87109



**PROJECT NUMBER** 20230442.5

SHEET TITLE **FIRE PLAN** 

SHEET NUMBER





## GENERAL GRADING NOTES:


- 1. ALL GRADING AND SITE PREPARATION WORK SHALL CONFORM WITH THE RECOMMENDATIONS AND SPECIFICATIONS CONTAINED IN THIS PLAN SET
- CONTRACTOR SHALL CAREFULLY PRESERVE ALL SITE BENCHMARKS AND REFERENCE POINTS DURING CONSTRUCTION OPERATIONS.
- 3. CONTRACTOR IS SPECIFICALLY CAUTIONED THAT THE LOCATION AND/OR ELEVATION OF EXISTING UTILITIES AS SHOWN ON THESE PLANS IS BASED ON RECORDS OF THE VARIOUS UTILITY COMPANIES AND, WHERE POSSIBLE, MEASUREMENTS TAKEN IN THE FIELD. THE INFORMATION IS NOT TO BE RELIED ON AS BEING EXACT OR COMPLETE. THE CONTRACTOR MUST CALL THE LOCAL UTILITY LOCATION CENTER AT LEAST FORTY-EIGHT (48) HOURS BEFORE ANY EXCAVATION TO REQUEST EXACT FIELD LOCATIONS OF THE UTILITIES. IT SHALL BE THE RESPONSIBILITY OF THE CONTRACTOR TO RELOCATE ALL EXISTING UTILITIES WHICH CONFLICT WITH THE PROPOSED SITE IMPROVEMENTS SHOWN ON THE PLANS.
- 4. CONTRACTOR SHALL INSTALL APPROPRIATE TREE PROTECTION MEASURES PRIOR TO COMMENCEMENT OF SITE GRADING OPERATIONS. 5. ALL PROPOSED GRADING, PAVEMENT, APRONS, CURBS, WALKS, ETC. SHALL MATCH
- EXISTING GRADES FLUSH. 6. CONTRACTOR SHALL ENSURE POSITIVE DRAINAGE TO ALL STORM DRAINAGE STRUCTURES.
- AREAS OF SURFACE PONDING SHALL BE CORRECTED BY THE CONTRACTOR AT NO ADDITIONAL EXPENSE TO THE OWNER. 7. ALL EXISTING AND PROPOSED TOP OF FRAME ELEVATIONS FOR STORM, SANITARY, WATER AND OTHER UTILITY STRUCTURES SHALL BE ADJUSTED TO MEET FINISHED GRADE WITHIN
- THE PROJECT LIMITS. 8. CONTRACTOR SHALL UTILIZE CARE WHEN WORKING NEAR EXISTING UTILITIES TO REMAIN. ANY DAMAGE TO EXISTING UTILITIES NOT NOTED TO BE REMOVED SHALL BE REPAIRED AT THE CONTRACTOR'S EXPENSE AND TO THE SATISFACTION OF THE OWNER AND/OR
- ENGINEER. 9. CONTRACTOR SHALL REPAIR AT HIS EXPENSE ANY DAMAGE TO EXISTING ASPHALT, CONCRETE, CURBS, SIDEWALKS, ETC. RESULTING FROM CONSTRUCTION TRAFFIC AND/OR OPERATIONS. REPAIRS SHALL BE MADE TO THE SATISFACTION OF THE OWNER AND/OR ENGINEER.
- 10. CONTRACTOR SHALL RESTORE ALL DISTURBED AREAS OUTSIDE OF CONSTRUCTION LIMITS TO ORIGINAL CONDITION OR BETTER.
- 11. MAXIMUM CROSS SLOPES AND LONGITUDINAL SLOPES FOR ALL CONCRETE SIDEWALKS AND HANDICAP ACCESSIBLE ROUTES SHALL NOT EXCEED 2% AND 5%, RESPECTIVELY. 12. MAXIMUM SLOPES WITHIN THE HANDICAP ACCESSIBLE PARKING AREAS SHALL NOT
- EXCEED 2% IN ANY DIRECTION. 13. MAXIMUM GRADE DIFFERENCE BETWEEN PAVEMENT SURFACES AND ADJACENT CONCRETE SIDEWALKS FOR THE ACCESSIBLE ROUTE TO THE BUILDING SHALL NOT EXCEED 1/4"
- VERTICAL OR 1/2" WHEN BEVELED. 14. ALL HANDICAP ACCESSIBLE EXTERIOR DOORWAY LOCATIONS REQUIRE AN EXTERIOR LANDING THAT IS A MINIMUM OF FIVE (5) FEET IN LENGTH WITH A SLOPE NOT EXCEEDING 2% IN ANY DIRECTION.
- 15. EXCAVATION SHORING SHALL BE DONE AS NECESSARY FOR THE PROTECTION OF THE WORK AND FOR THE SAFETY OF PERSONNEL. SHORING SHALL BE IN ACCORDANCE WITH ALL O.S.H.A AND LOCAL REGULATIONS.
- 16. ALL STRUCTURE BENCH WALLS SHALL BE SHAPED AND FORMED FOR A CLEAN TRANSITION WITH PROPER HYDRAULICS TO ALLOW THE SMOOTH CONVEYANCE OF FLOWS THROUGH THE MANHOLE OR BOX INLET. THE BENCH WALL SHALL FORM A DEFINED CHANNEL, TO A MINIMUM HEIGHT OF 80-PERCENT OF THE INSIDE DIAMETER OF THE INLET AND OUTLET PIPES TO FORM A "U" SHAPED CHANNEL, CONSTRUCTED AT A MINIMUM %-INCH PER FOOT SLOPE TO THE MANHOLE WALL.
- 17. ALL STORM WATER INLETS AND CATCH BASIN CASTINGS SHALL HAVE THE WORDS "NO DUMPING, DRAINS TO STREAM", OR SIMILARLY APPROVED MESSAGE, CAST IN RAISED OR RECESSED LETTERS AT A MINIMUM OF 1" IN HEIGHT. IN ADDITION, A SYMBOL OF A FISH SHALL ALSO BE CAST WITH THE LETTERS.

## FLOOD NOTE:


PROPERTY IS LOCATED IN ZONE "X" AND NOT LOCATED WITHIN THE FLOOD PLAIN PER FEDERAL EMERGENCY MANAGEMENT AGENCY MAPPING, COMMUNITY PANEL NUMBER 35001C0138H, EFFECTIVE DATE: AUGUST, 16 2012.

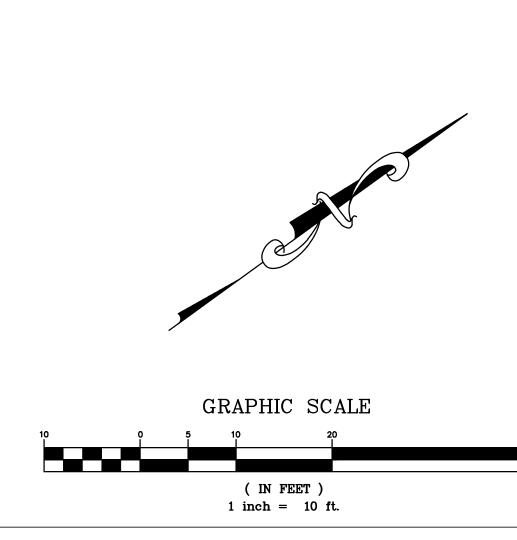

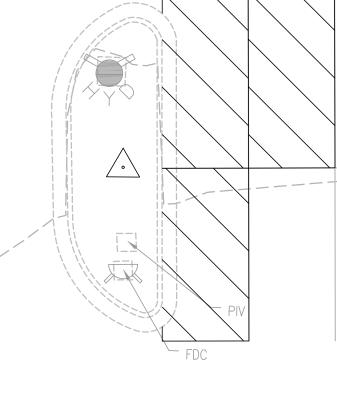

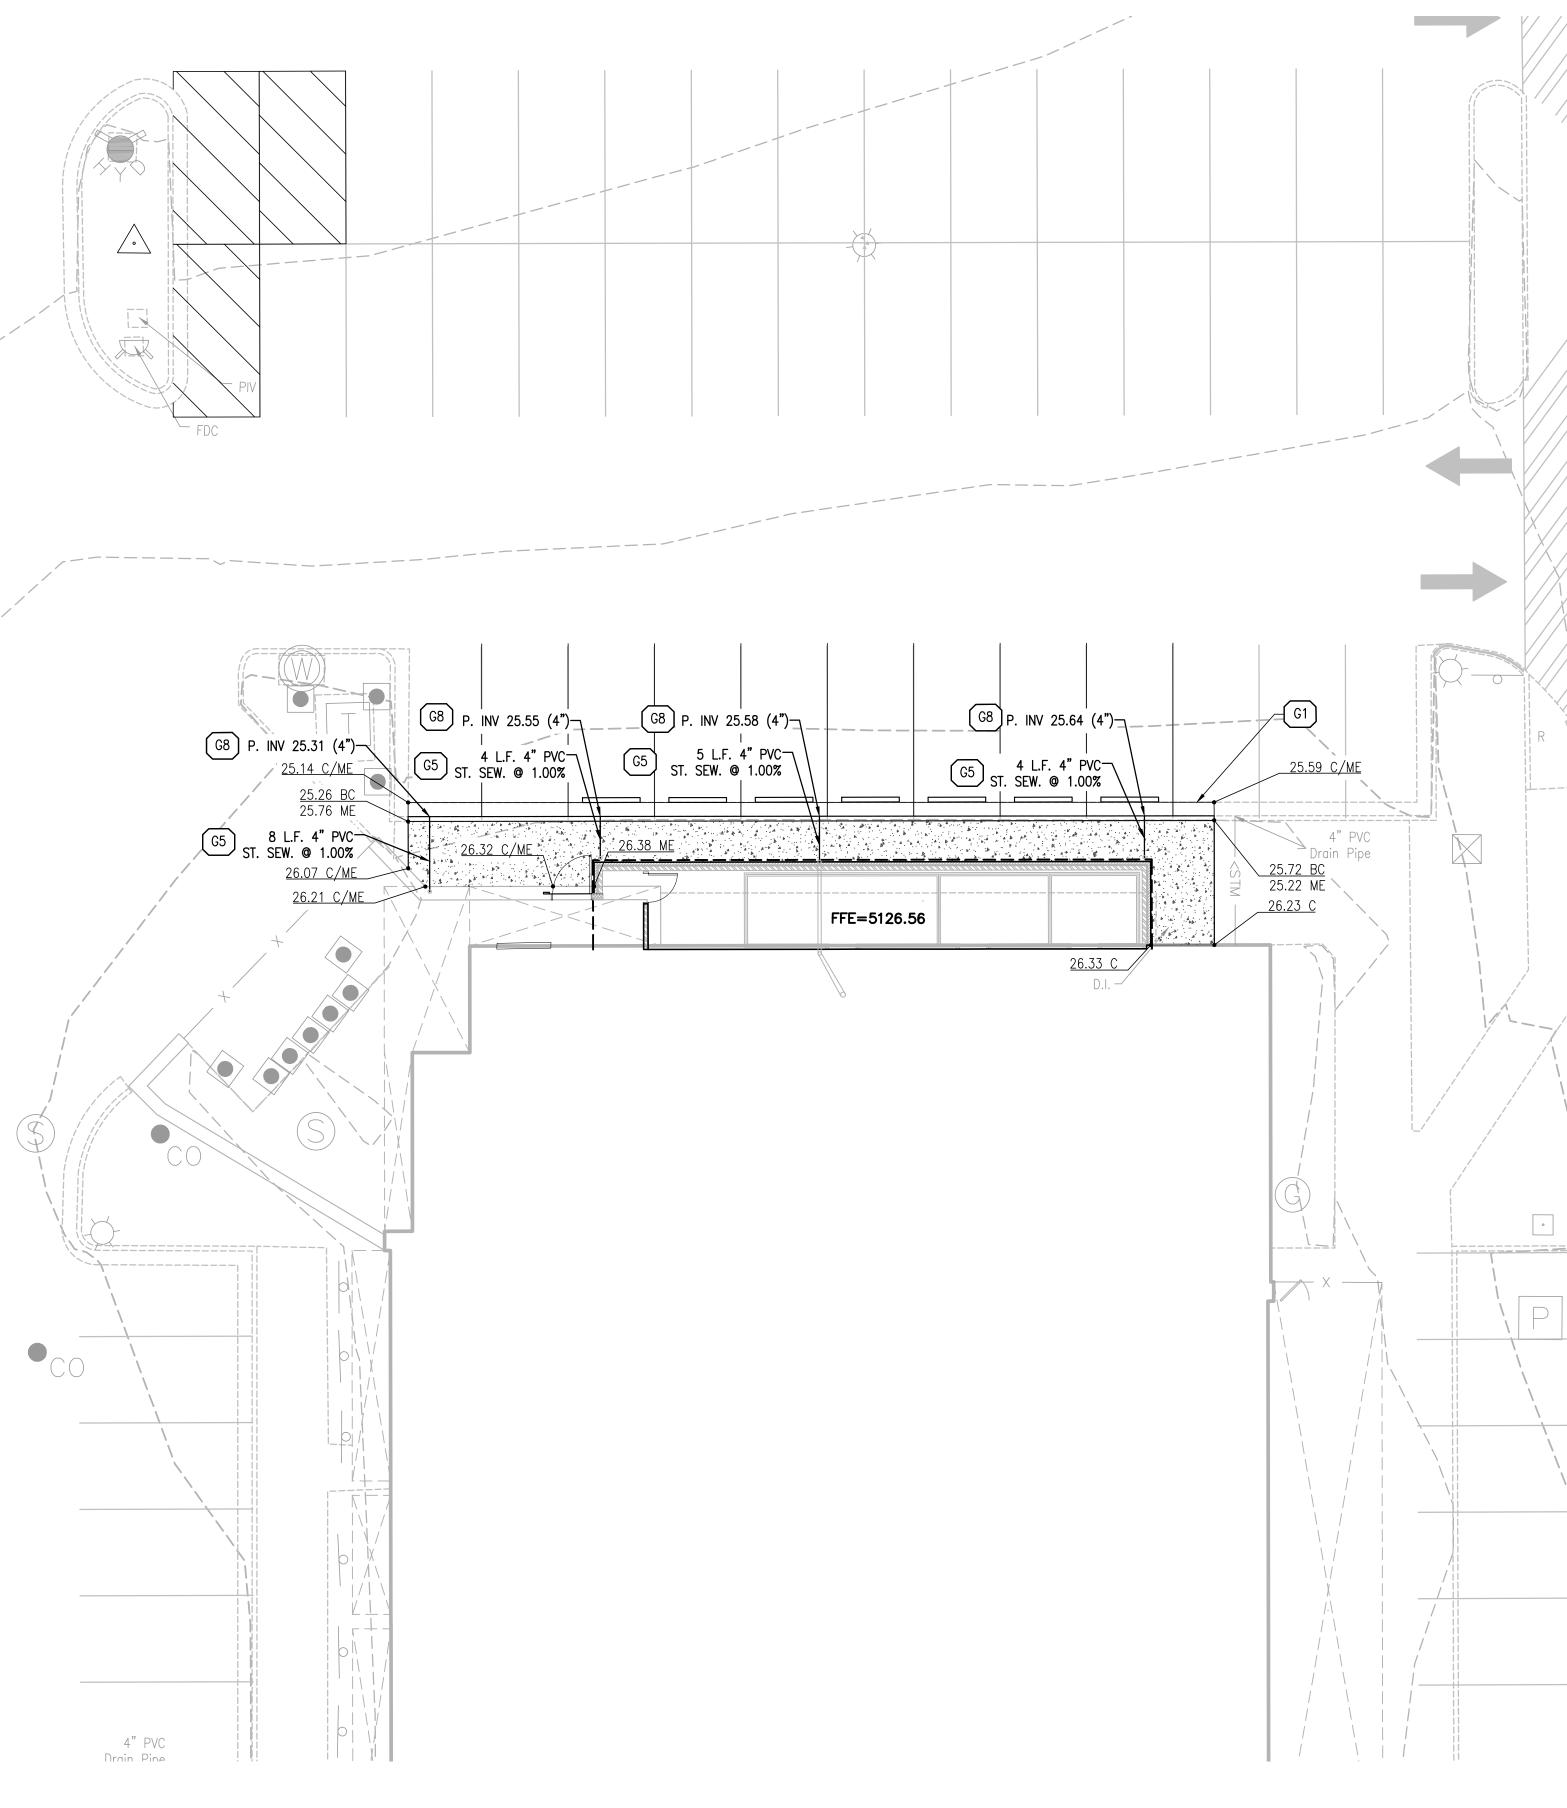

## PROPOSED LEGEND:

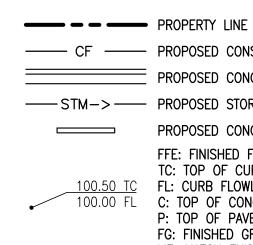

----- CF ----- PROPOSED CONSTRUCTION FENCE PROPOSED CONCRETE CURB AND GUTTER PROPOSED CONCRETE WHEEL STOP FFE: FINISHED FLOOR ELEVATION TC: TOP OF CURB ELEVATION FL: CURB FLOWLINE ELEVATION C: TOP OF CONCRETE ELEVATION P: TOP OF PAVEMENT ELEVATION FG: FINISHED GRADE ELEVATION ME: MATCH EXISTING

**BM # 00.00** SITE BENCH MARK (SEE SURVEY FOR ADDITIONAL INFORMATION)

## GRADING KEY NOTES:

- G1 FIELD VERIFY AND MATCH EXISTING ELEVATION AT PROJECT SCOPE OF WORK LIMITS (TYP.) G5 PROPOSED STORM SEWER LINE (TYP.)
- G8 PROPOSED BUILDING ROOF DRAIN OUTLET THROUGH SIDEWALK FACE (COORDINATE EXACT LOCATIONS WITH ARCHITECTURAL AND PLUMBING PLANS)



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#### **PROJECT TEAM**

<u>CIVIL</u> GREENBERGFARROW <u>STRUCTURAL</u> GREENBERGFARROW

MECHANICAL GREENBERGFARROW

G#

<u>PLUMBING</u> GREENBERGFARROW

ELECTRICAL GREENBERGFARROW

#### **ISSUE/REVISION RECORD** DESCRIPTION DATE



#### PROFESSIONAL SEAL



**PROFESSIONAL IN CHARGE** RYAN SCOTT **PROJECT MANAGER** 

**QUALITY CONTROL** 

DRAWN BY

**PROJECT NAME** 

## **BUBBA'S 33**

## ALBUQUERQUE

NEW MEXICO

ALBUQUERQUE, NM 87109

**4861 PAN AMERICAN FWY NE** 

**PROJECT NUMBER** 

**GRADING AND** 

SHEET NUMBER


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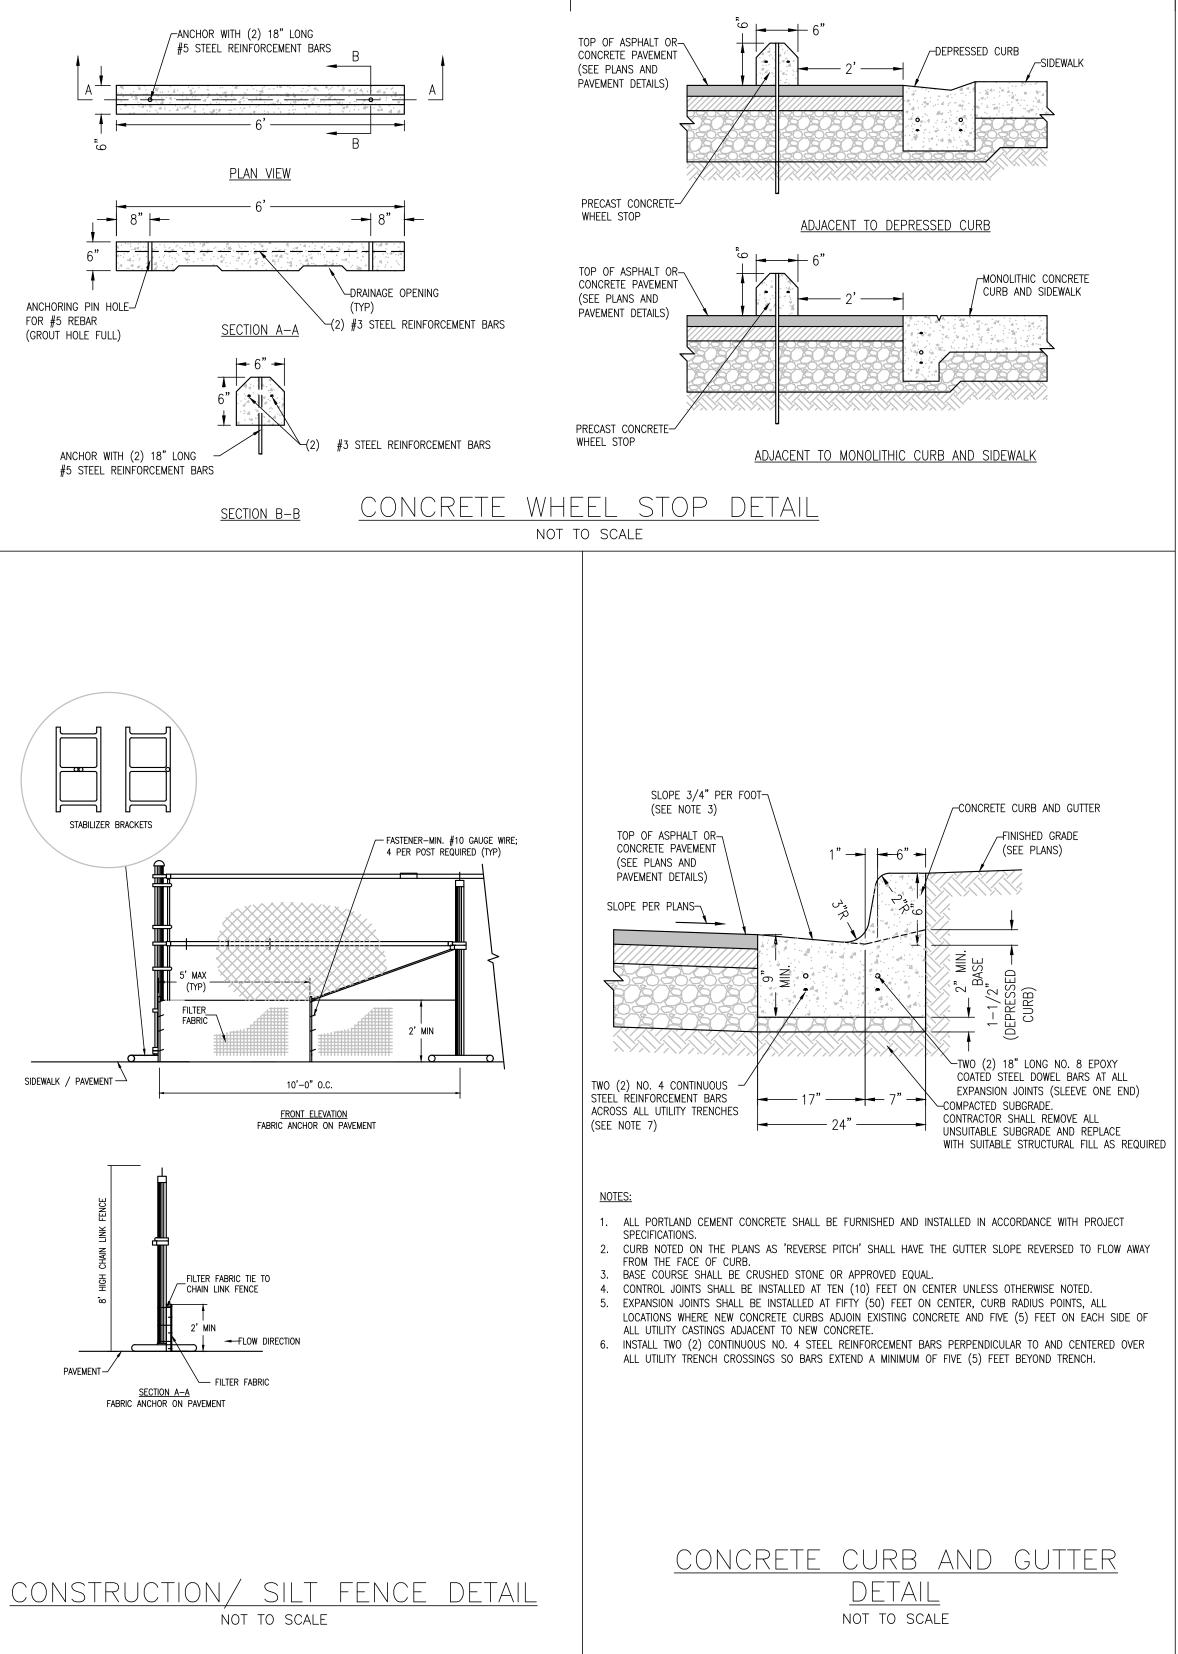
NOT ISSUED FOR CONSTRUCTION

DRAINAGE PLAN

20230442.5

SHEET TITLE



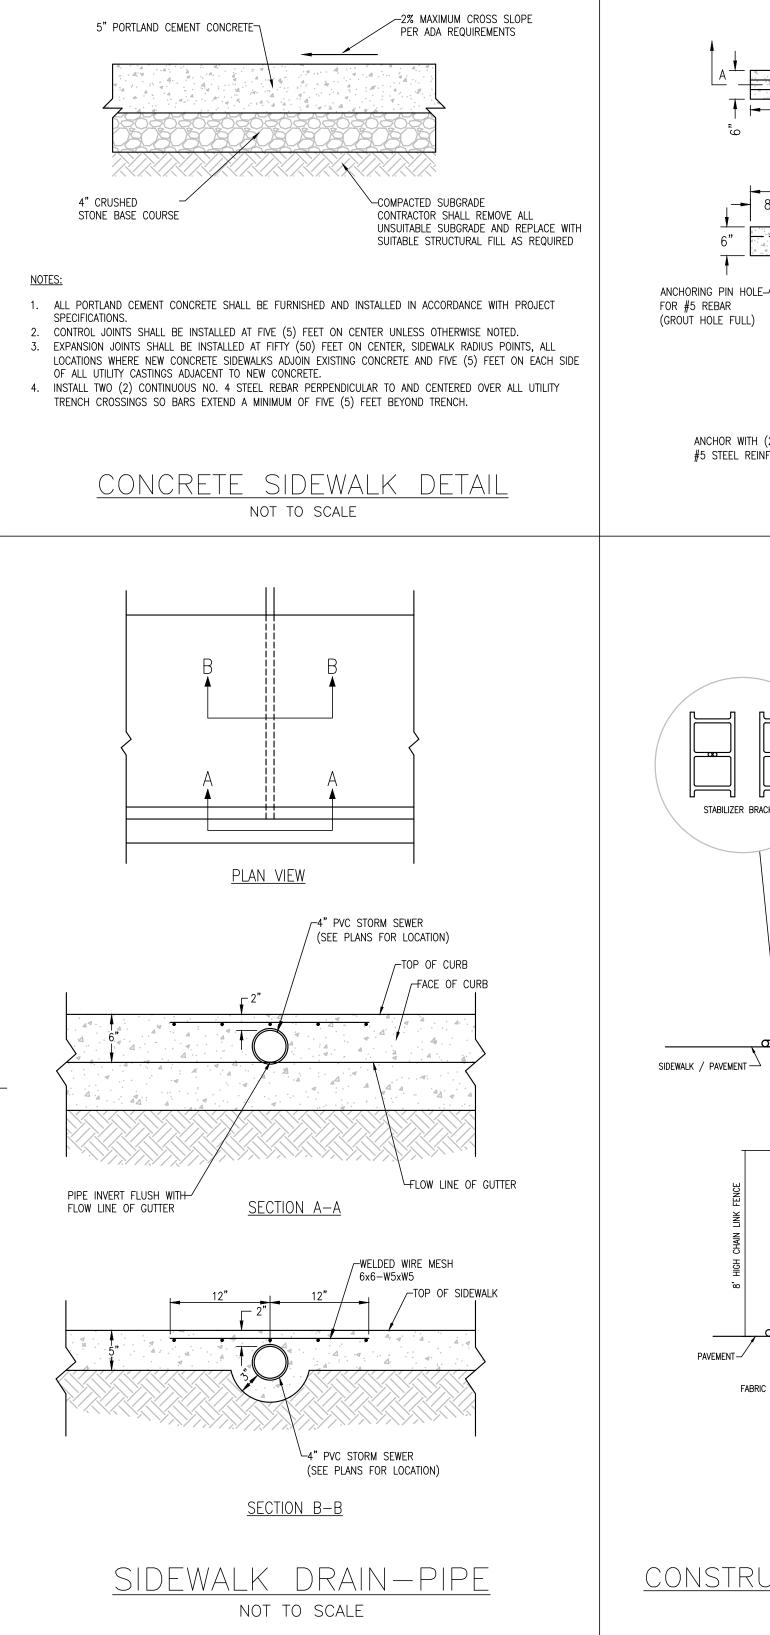



NOT ISSUED FOR CONSTRUCTION

**DETAIL SHEET** 

**PROJECT NUMBER** 20230442.5 SHEET TITLE



4861 PAN AMERICAN FWY NE ALBUQUERQUE, NM 87109

ALBUQUERQUE NEW MEXICO

## **BUBBA'S 33**

PROJECT NAME


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QUALITY CONTROL


**PROFESSIONAL IN CHARGE** 

RYAN SCOTT

PROJECT MANAGER

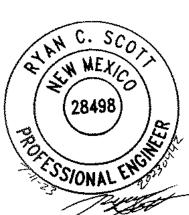

PROFESSIONAL SEAL

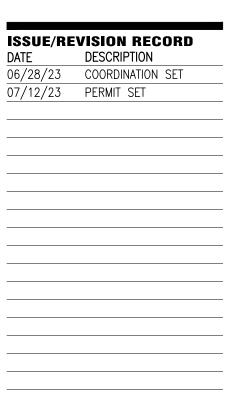

**PROJECT TEAM** <u>CIVIL</u> GREENBERGFARROW <u>STRUCTURAL</u> GREENBERGFARROW

<u>MECHANICAL</u> GREENBERGFARROW

<u>PLUMBING</u> GREENBERGFARROW

ELECTRICAL GREENBERGFARROW

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www.greenbergfarrow.com 8600 W Bryn Mawr Ave.


Suite 800N

Chicago, IL 60631

t: 847 788 9200



## FRONT ELEVATION (SOUTHEAST)

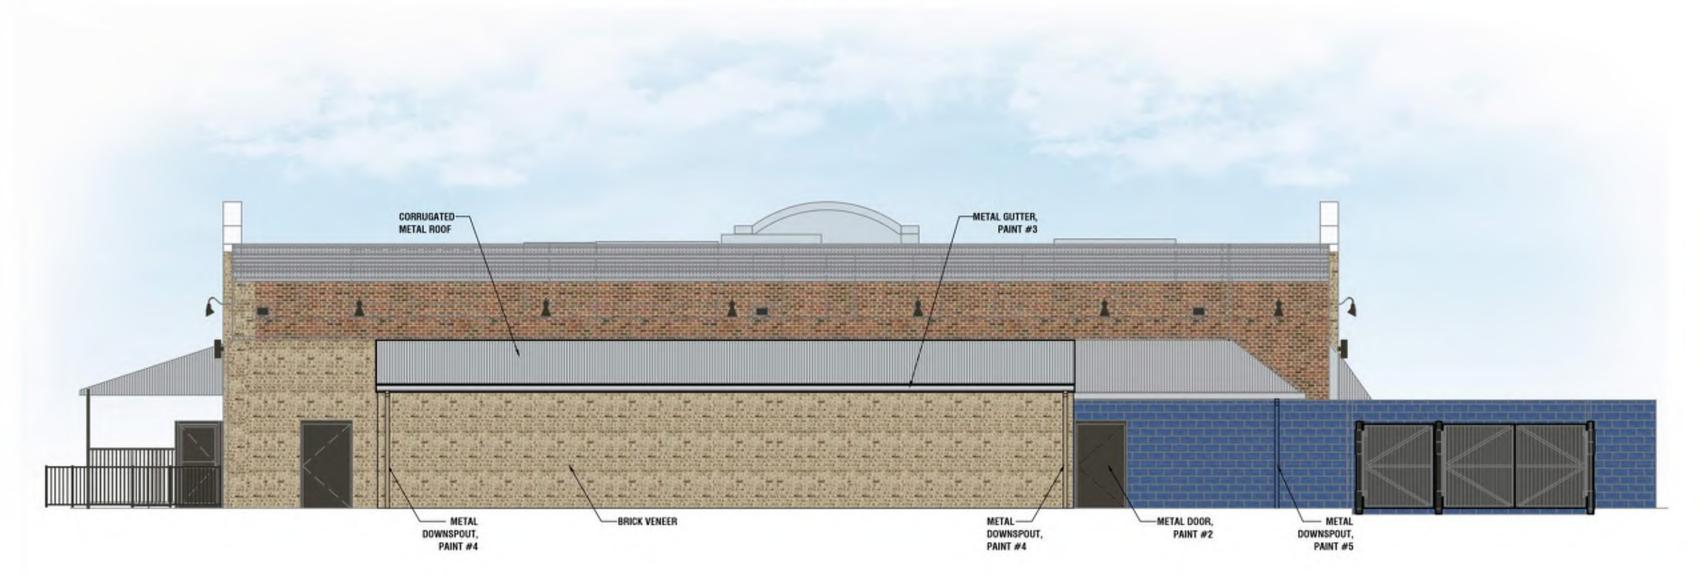

## REAR ELEVATION (NORTHWEST)



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PROJECT NAME





BUILDING ITEMS	DESCRIPTION
DISTRESSED BRICK	FACE BRICK REDLAND BRICK.
(TO MATCH EXISTING)	COLOR # 040 NANTUCKET GRAY
FASCIA TRIM (BLUE)	PAINT #1: PRESTAINED CEDAR HENRY POOR LUMBER 3200
(TO MATCH EXISTING)	REAGAN DRIVE LAFAYETTE, IN 47906
	CONTACT: DOUG MILLER
	WESTERN RED CEDAR WITH TWO COATS OF CABOT
	SEMI-GLOSS STAIN
	COLOR: NEWBURYPORT BLUE
METAL DOOR	PAINT #2: PAINT BLACK
(TO MATCH EXISTING)	
METAL ROOF	METAL SALES MANUFACTURING CORRUGATED METAL 26 GAUGE
(TO MATCH EXISTING)	COLOR: GALVALUME
	PHONE: 800-747-1206
GUTTERS	PAINT #3: PREFINISHED - 24 GAUGE TO MATCH GALVALUME.
(TO MATCH EXISTING)	
METAL DOWNSPOUTS	PAINT #4: 24 GAUGE TO MATCH ADJACENT WALL COLOR
(TO MATCH EXISTING)	
METAL DOWNSPOUTS	PAINT #5: 24 GAUGE TO MATCH ADJACENT WALL COLOR
(TO MATCH EXISTING)	and a state of the second state of the

**BUBBA'S 33 (COOLER ADDITION)** 

PROJECT ADDRESS 4861 PAN AMERICAN FWY, ALBUQUERQUE, NM 87109

20230442.5

PROJECT NUMBER

LEFT ELEVATION (SOUTHWEST)

## RIGHT ELEVATION (NORTHEAST)




SHEET NUMBER

A2.1

1 OF 1

SHEET TITLE EXTERIOR ELEVATIONS SCALE: 1/8" = 1'-0" LH 7,575 SF

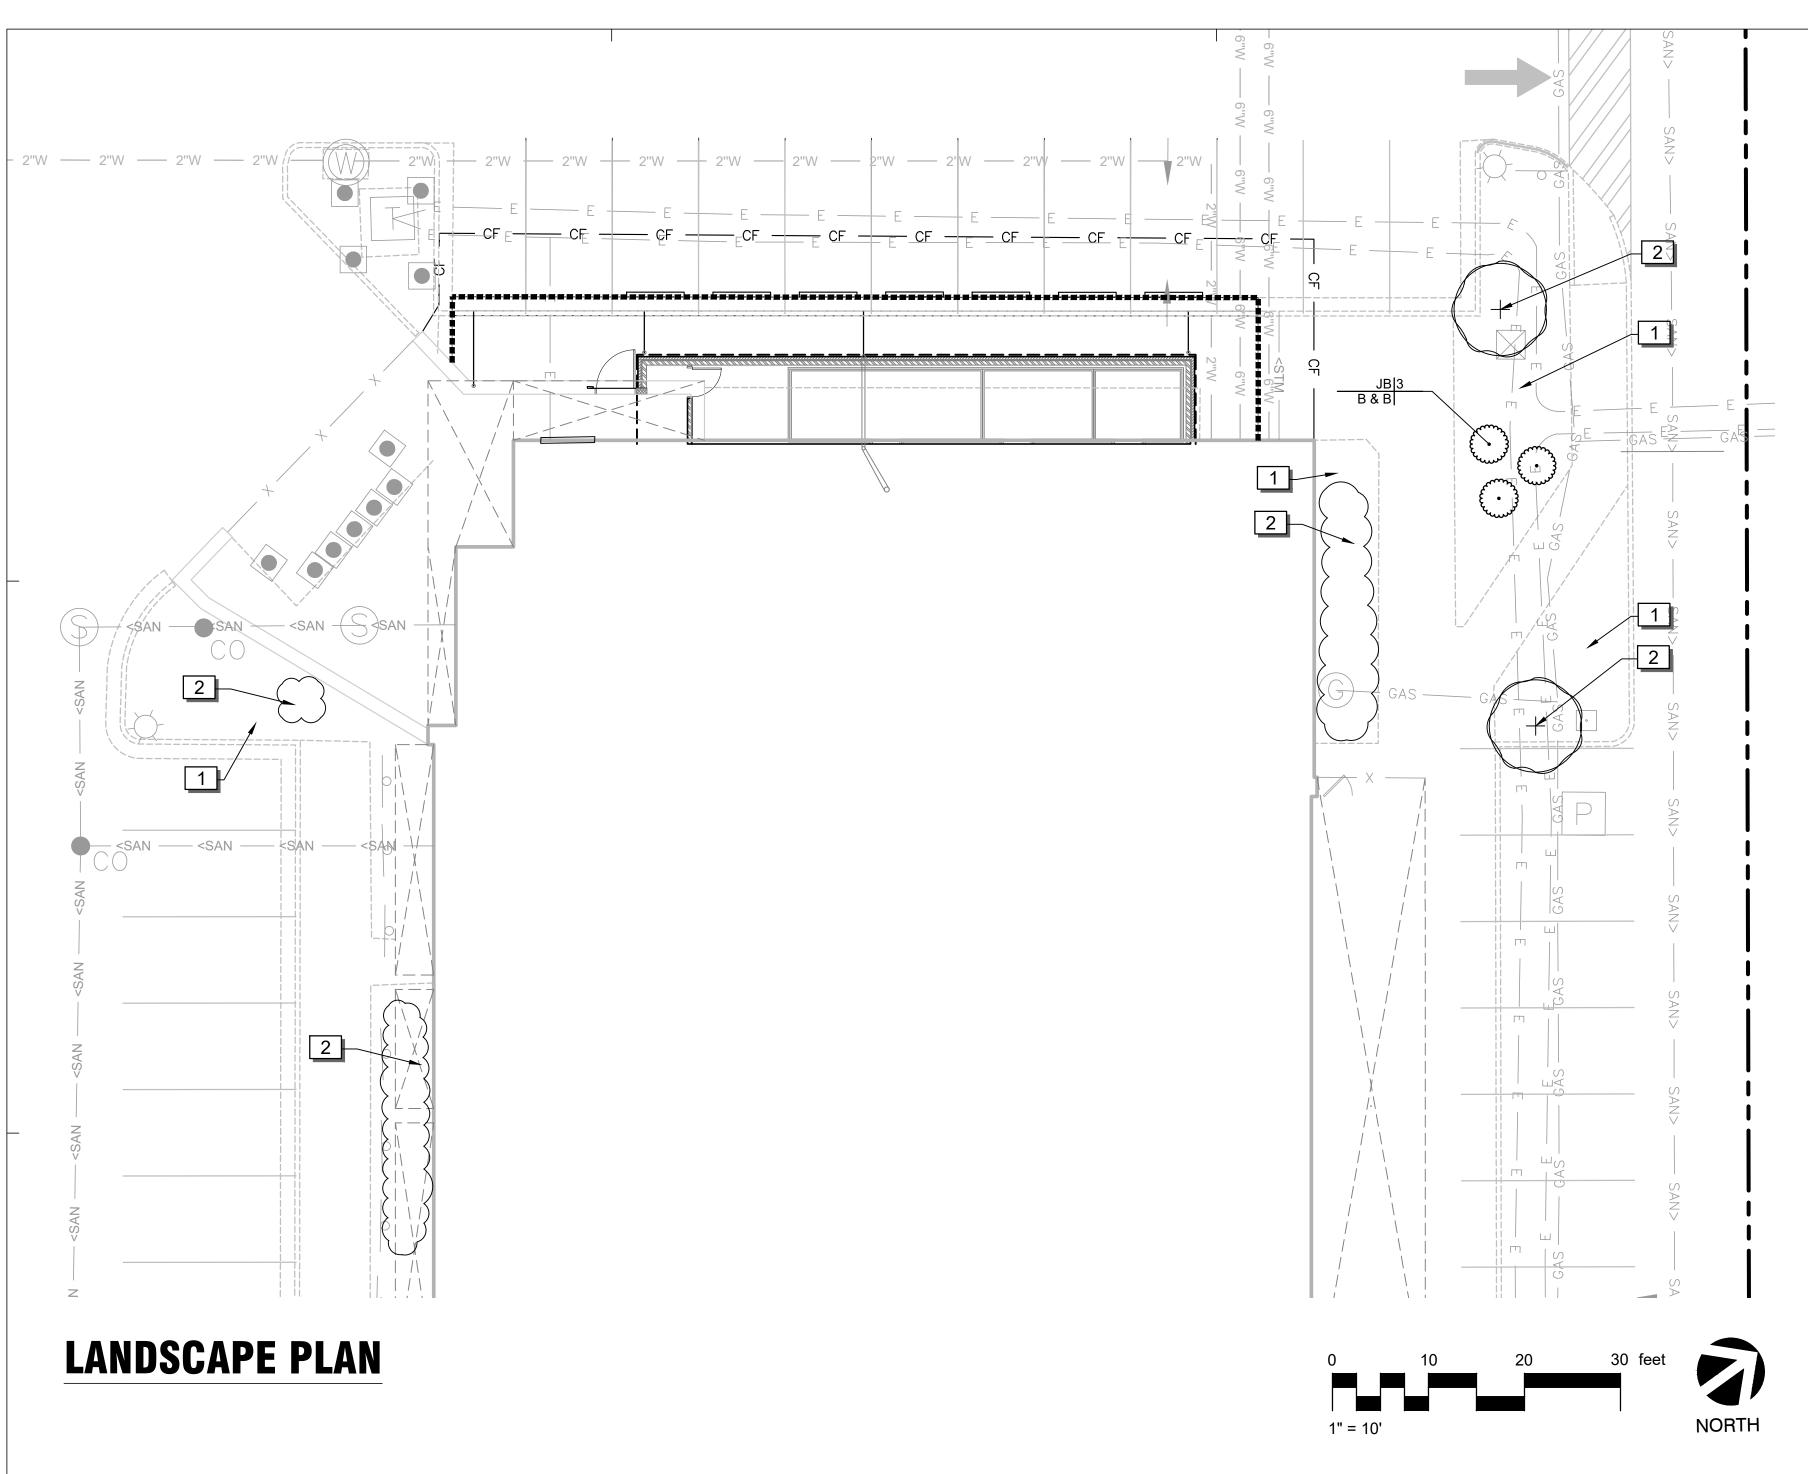

## **REFERENCE NOTES SCHEDULE**

SYMBOL	DESCRIPTION
1	RIVER ROCK MULCH
2	EXISTING LANDSCAF PRECAUTIONS TO PE NEW CONSTRUCTION MATERIAL IS TO BE F SPECIES OF MATERI

## PLANT SCHEDULE

SHRUBS	CODE	<u>QTY</u>	E
£	JB	3	,

## SHRUB HEIGHT MEASUREMENTS ARE TO BE AS MEASURED FROM TOP OF ROOTBALL (TYP.)

### GENERAL NOTES / STATEMENT OF COMPLIANCE:


- RIGHT-OF-WAY.
- ACCEPTABLE IN THIS AREA.

MAINTENANCE NOTES:

- OF ALL LANDSCAPE.
- MAINTENANCE.
- PART OF THIS PLAN.
- THE YEAR.

NOTES:

- 1. GRAPHIC SYMBOLS TAKE PRECEDENCE OVER WRITTEN QUANTITIES AND KEYS ON PLAN.
- 2. CONTRACTOR TO REPAIR AND REPLACE ANY LANDSCAPE MATERIAL OF THE LIMIT OF WORK OR OUTSIDE OF PROPERTY LINES
- 3. PRIOR TO DEMOLITION, CONTRACTOR IS TO CUT AND CAP EXISTING IRRIGATION IN AREA OF NEW CONSTRUCTION.
- 4. CONTRACTOR TO RESTORE IRRIGATION TO ALL NEW PLANTED AREA. INSTALL PER ALL FEDERAL, STATE AND LOCAL CODES.

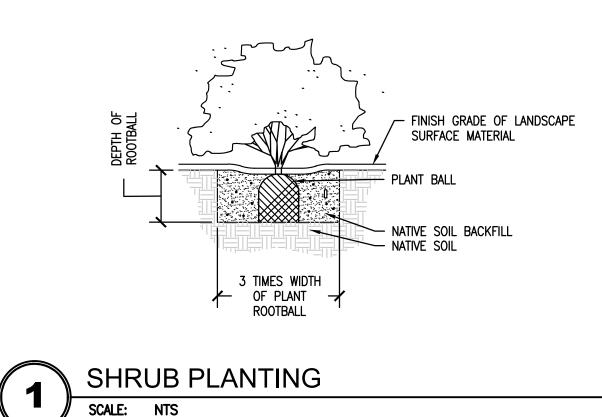

#### H TO REMAIN.

PE TO REMAIN. CONTRACTOR TO TAKE PROTECT EXISTING PLANTING FROM ON OPERATIONS. ANY DAMAGE OF REPLACED WITH LIKE, TYPE, SIZE AND RIAL.

**BOTANICAL NAME** 

COMMON NAME

SIZE <u>HEIGHT</u> JUNIPERUS CHINENSIS 'BLUE POINT' BLUE POINT JUNIPER B & B 7` HT. MIN.

1. THE SITE PLAN SHALL BE CONSISTENT WITH THE GENERAL LANDSCAPING REGULATIONS (Article 14-16-3-10) 2. THE PROPERTY OWNER IS RESPONSIBLE FOR ALL SIDEWALK AND LANDSCAPE MAINTENANCE IN THE ADJACENT PUBLIC

3. LANDSCAPING, FENCING AND SIGNING WILL NOT INTERFERE WITH CLEAR SIGHT REQUIREMENTS. THERFORE, SIGNS, WALLS, TREES, AND SHRUBBERY BETWEEN 3 AND 8 FEET TALL (MEASURED FROM THE GUTTER PAN) WILL NOT BE

1. THE OWNER, TENANT AND THEIR AGENT, IF ANY, SHALL BE JOINTLY AND SEVERALLY RESPONSIBLE FOR THE MAINTENANCE


2. THE LANDSCAPE SHALL BE MAINTAINED IN A NEAT AND ORDERLY MANNER AT ALL TIMES. THIS SHALL INCLUDE MOWING, EDGING, PRUNING, FERTILIZING, WATERING WEEDING AND OTHER SUCH ACTIVITIES COMMON TO LANDSCAPE

3. ALL LANDSCAPE AREAS SHALL BE KEPT FREE OF TRASH, LITTER, WEEDS AND OTHER SUCH MATERIAL OR PLANTS NOT

4. ALL PLANT MATERIAL SHALL BE MAINTAINED IN A HEALTHY GROWING CONDITION AS IS APPROPRIATE FOR THE SEASON OF

5. ALL PLANT MATERIAL WHICH DIES SHALL BE REPLACED WITH PLANT MATERIAL OF EQUAL OR BETTER VALUE.

DAMAGED DUE TO THIS CONSTRUCTION THAT IS LOCATED OUTSIDE

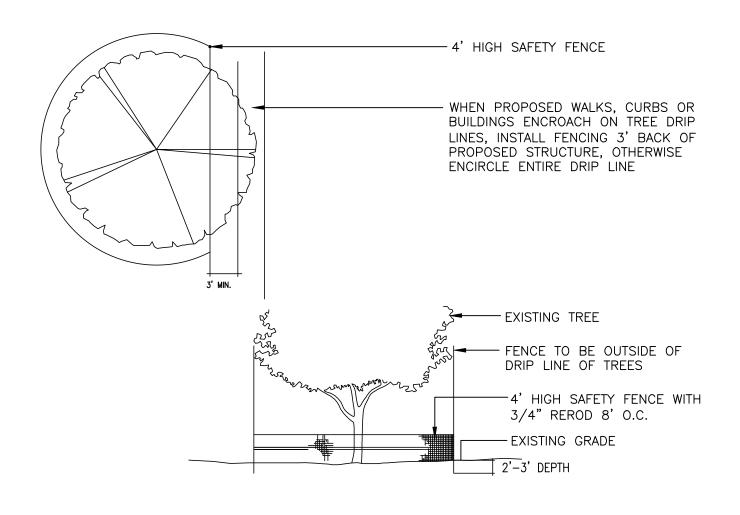

## TREE PROTECTION DETAIL

NOT TO SCALE

2

329343.67-Ø1



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PROJECT TEAM

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<u>PLUMBING</u> GREENBERGFARROW

<u>ELECTRICAL</u> GREENBERGFARROW

<b>ISSUE/RE</b>	VISION RECORD
DATE	DESCRIPTION
06/28/23	PERMIT SET
/	

#### **PROFESSIONAL SEAL**

## **PROFESSIONAL IN CHARGE**

**PROJECT MANAGER** 

QUALITY CONTROL

DRAWN BY

PROJECT NAME

## **BUBBA'S 33**

ALBUQUERQUE

**NEW MEXICO** 

**4861 PAN AMERICAN FWY NE** 

ALBUQUERQUE, NM 87109

PROJECT NUMBER 20230442.5 SHEET TITLE

LANDSCAPE PLAN

