

5. Open Space per table 2-4-5 including a 50% reduction for UC-MS-PT. Open space includes 9,616 sf of landscaping and 7,534 sf of sidewalk and patio space.

SEE SHEET SP-DRB-A.

2. Bicycle parking required, 3 spaces or 10% whichever is greater

3. Motorcycle parking required 1 space per 25 off street parking.

4. Accessible Parking is based on 2015NM Commercial Building Code, Table 1106.1 of Title 14, Chapter 7, Part 2.

ZONING MX-M

SEE SHEET SP-DRB-A.

SEE SHEET SP-DRB-A.

6. Un-assigned On Street Parking available along Silver Avenue SE and Jackson Street SE is 17 including 2 ADA Stalls.

Table 5-5-5: Bicycle Parking Requirements

Table 5-5-4: Motorcycle Parking Requirements

For Visibility, landscaping, fencing, and signs shall not interfere with clear sight requirements. Therefore, signs, walls, trees, and shrubs between 3 and 8 feet in height (as measured from the gutter pan) are not allowed in the clear sight triangle.

ZONING MX-M

WAIVER APPROVEDITO ALLOW

ALONG JACKSON STREET, SEE

EX PROPERTY LINE

NEW PROPERTY LINE

(50.00')

FOR 6' CONCRETE SIDEWALK

VA-2021-00217

{150.00'}

ALL WORK WITHIN THE RIGHT-OF-WAY TO BE CONSTRUCTED AT PART OF THE PUBLIC WORK ORDER.

EX PROPERTY LINE

PROPOSED

4 STORY BLDG.

NEW PROPERTY LINE

سانننساسا

27) SILVER AVENUE

60' RIGHT OF WAY

CENTRAL AVENUE

100' RIGHT OF WAY

FF=5255.36

18'

DEVIATION APPROVED WITH THIS SITE PLAN

ABOVE CONCRETE PATIO THAT IS UP TO 39"

AS REQUIRED BY GUARDRAIL DEFINED IN

INTERNATIONAL BUILDING CODE

SEE ENLARGED PLAN

ON SHEET C-102

FF=5255.36

EAST BOUND DRIVER PATH

SEE ENLARGED PLAN

ON SHEET C-102

ABOVE PUBLIC SIDEWALK AT THIS LOCATION

FF=5255.36

TO ALLOW FOR 3'-6' TALL PATIO RAILING

SITE PLAN GENERAL NOTES

- A. MINI SIGHT TRIANGLE (11' ON EACH SIDE STARTING AT BACK OF SIDEWALK AND THEN EXTENDING TO FLOW LINE OF CURB PER DEVELOPMENT PROCESS MANUAL FIGURE 7.4.94), FOR ILLUSTRATIVE PURPOSED ONLY.
- B. LANDSCAPING, SIGNAGE, WALLS, FENCES, TREES AND SHRUBBERY BETWEEN 3 FEET AND 8 FEET TALL (AS MEASURED FROM THE GUTTER PAN) ARE NOT ALLOWED WITHIN THE CLEAR SITE TRIANGLE. C. ALL PARCELS SURROUNDING THE PROJECT SITE ARE MX-M ZONING
- COMPACTOR. MAINTENANCE STAFF WILL MOVE REFUSE TO THE REFUSE HOLDING YARD, A MINIMUM OF (4) 2 CUBIC YARD ROLLING DUMPSTERS FOR TRASH WILL BE AVAILABLE. E. RECYCLE MATERIALS WILL BE COLLECTING IN ROLLING BINS ON EACH FLOOR OF THE BUILDING AND WILL BE MOVED OUT TO HOLDING YARD

D. REFUSE WILL BE COLLECTED INTERNALLY BY A TRASH CHUTE AND

- BY MAINTENANCE STAFF. F. SOLID WASTE WILL BE PROVIDED A PROXIMITY CARD AND KEY PAD ACCESS CODES TO ENSURE ACCESS FOR REFUSE COLLECTION. G. ACCESS SHALL BE PROVED TO ABCWUA AS NECESSARY FOR WATER
- METER VAULT FOR MAINTENANCE. H. ALL WORK WITHIN THE RIGHT-OF-WAY TO BE CONSTRUCTED AT PART OF THE PUBLIC WORK ORDER. CURB ACCESS RAMPS WITHIN THE PUBLIC RIGHT-OF-WAY WILL BE DETAILED AS PART OF PUBLIC WORK ORDER.
- VARIANCES TO BUILDING DESIGN STANDARDS IN THE NOB HILL/HILAND CPO-8 WERE APPROVED BY THE ZHE FOR THIS PROJECT UNDER PROJECT PR-2021-005535. SEE BUILDING ELEVATION SHEET FOR DETAILS.

SITE PLAN KEYED NOTES

- CONCRETE PAVEMENT PER DETAIL D3/C-501. . CONCRETE HEADER CURB, 6" TALL, PER DETAIL A5/C-501. 3. STANDARD CURB AND GUTTER PER DETAIL A5/C-501.
- 4. CONCRETE PAVEMENT STRIP 2' WIDE PER DETAIL D3/C-501. GRAVEL PAVEMENT PER DETAIL D4/C-501. . CONCRETE CURB ACCESS RAMP PER DETAIL A1/C-501 AND TYPE C
- PARALLEL CURB ACCESS RAMP PER COA STANDARD DWG 2443, TO BE DETAILED IN PWO PLANS.
- . DETECTABLE WARNING SURFACE PER DETAIL A3/C-501. 8. CONCRETE SIDEWALK PER DETAIL B4/C-501. ADA RESERVED PARKING STALL PER DETAIL A1/C-502.
- 10. ADA RESERVED PARKING SIGN MOUNTED PER DETAIL C3/C-502 AND D2/C-502.
- 11. ADA VAN ACCESSIBLE RESERVED SIGN MOUNTED PER DETAIL
- C3/C-502 AND D2/C-502 12. RESERVED PARKING SYMBOL PER DETAIL E3/C-502.
- 13. CONCRETE PARKING BLOCK PER DETAIL E4/C-502. 14. 24' SLIDING VEHICLE GATE PER DETAIL A5/C-504 WITH LIFT MASTER
- PROFESSIONAL MODEL SL3000101U HEAVY DUTY SLIDING GATE OPERATOR WITH 1-HP MOTOR ON 18"x34"x24" CONCRETE FOUNDATION. INSTALL PER MANUFACTURER RECOMMENDATIONS. 15. BICYCLE RACK PER DETAIL E5/C-502.
- ASPHALT PAVEMENT PER DETAIL E2/C-501. 17. PAINT CURB RED WITH 6" TALL LETTERS READING "NO PARKING
- FIRE LANE". 18. FIRE DEPARTMENT KNOX BOX.
- 19. SIDEWALK CULVERT PER DETAIL B3/C-501.
- 20. MOTORCYCLE PARKING STALL WITH SIGNAGE AND PAVEMENT MARKINGS.
- 21. CONCRETE STAIR PER B4/C-502 AND HANDRAILS PER DETAILS
- 22. CONCRETE CUT OFF WALL TO SEPARATE ASPHALT FROM GRAVEL PARKING, PER DETAIL A5/C-501.
- 23. 4" WIDE WHITE PARKING STRIPE.
- 24. CONTINENTAL CROSS WALK STRIPING.
- 25. REFUSE ENCLOSURE PER DETAIL A3/C-502. 26. FIRE RISER ROOM, SEE ARCHITECTURAL AND MECHANICAL PLANS. 27. LANDSCAPED AREA.
- 28. CONCRETE STOOP PER DETAIL C3/C-501. 29. CONCRETE SPLASH BLOCK PER DETAIL D6/C-501 AND CONCRETE RUNDOWN PER DETAIL D5/C-501.
- 30. 6' TALL PERIMETER FENCE PER DETAIL A5/C-504. 31. 6' TALL PERIMETER FENCE PERSONNEL GATE PER DETAIL A4/C-504. 32. 4' TALL PERIMETER FENCE PER DETAIL A5/C-504.
- 33. 4' TALL PERIMETER FENCE PERSONNEL GATE PER DETAIL A4/C-504. 35. REFUSE ENCLOSER GATE PER DETAIL D5/C-504. 36. ENCLOSURE GATE PER DETAIL A2/C-504.

37. CONCRETE VALLEY GUTTER PER DETAIL E1/O 50 38. LIGHT POLE PER ELECTRICAL SHEET ES 101. 39. 6" STEEL BOLLARD PER DETAIL E1/C-501.

- 40. PAINT CURB YELLOW WHERE HEIGHT IS BETWEEN $\frac{1}{4}$ " AND 6" TALL. 41. STORM WATER RETENTION POND, SEE GRADING PLANS.
- 42. TURN DOWN EDGE SIDEWALK PER DETAIL E3/C-501. 43. NATURAL GAS METER OR REGULATOR SEE UTILITY PLANS. 44. WATER METER VAULT. SEE UTILITY PLAN.
- 45. ELECTRICAL TRANSFORMER, SEE SHEET ES-101. 46. ELECTRICAL METER PACK. SEE ELECTRICAL PLANS.
- ADDITIONAL INFORMATION. 48. LOOP DETECTOR FOR AUTOMATIC GATE OPERATORS. SEE
- ELECTRICAL PLANS FOR DETAILS. 49. PATIO RAILING PER DETAIL C5/C-501 50. CONCRETE RAMP AND HANDRAILS PER DETAIL A2/C-502.
- 51. DOG WASTE STATION. SEE LANDSCAPING PLANS.
- 53. DOG PARK SURROUNDED BY 4' TALL FENCE PER DETAIL A5/C-504. 54. SKATE BOARD PARK AREA SURROUNDED BY 4' TALL FENCE PER DETAIL A5/C-504.
- 55. LOW SEAT WALL. SEE LANDSCAPING PLANS. 56. CONCRETE SIDEWALK TO BE FLUSH WITH ASPHALT. PROVIDE 3' LONG CURB TRANSITION FROM 6" TALL TO FLUSH ON EACH SIDE.
- 57. CONCRETE CURB ACCESS RAMP DETAIL A PAIRED PARALLEL CURB ACCESS RAMP WITH A COMMON LANDING PER COA STANDARD
- DWG 2445, TO BE DETAILED IN PWO PLANS..
- RAMP PER COA STANDARD DWG 2443. 59. CONCRETE CURB ACCESS RAMP DETAIL B CORNER ACCESS RAMP
- PER COA STANDARD DWG 2441, TO BE DETAILED IN PWO PLANS. 60. 24" THERMOPLASTIC WHITE STOP BAR STRIPING. 61. CONCRETE CURB ACCESS RAMP TYPE A PARALLEL CURB ACCESS
- RAMP PER COA STANDARD DWG 2443 62. CONCRETE CURB ACCESS RAMP SIMILAR TO COA STANDARD DWG
- 2443 DETAIL B MODIFIED TO HAVE SLOPING WING INSTEAD OF HEADER CURB, TO BE DETAILED IN PWO PLANS.



A5 ZONE ATLAS PAGE K-17-Z




Is an Infrastrure List Required? (X) Yes () No If yes, then a set of approved DRC plans with a work order is required for any construction within Public Right-of-Way of for construction of public improvements.

DDD SITE DEVELOPMENT DI ANI APPROVAL.

Jeanne Wolfenbarger	Sep 28, 2021
Traffic Engineering, Transportation Division	Date
Blaine Carter	Sep 28, 2021
ABCWUA (Sep 10, 1011 1011 1011)	Date
Chart Smerfeld	Sep 29, 2021
Parks and Recreation Department	Date
Einest armijo	Sep 28, 2021
City Engineer/Hydrology	Date
Charles Maestas	Sep 29, 202
Code Enforcement	Date
* Environmental Health Department (conditional)	Date
Herman Gallegos	08-31-21
Solid Waste Management	Date
The sale	Oct 8, 2021

STAMP

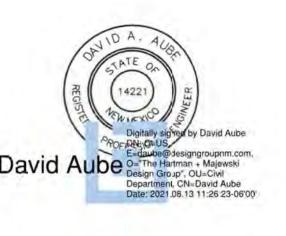

DESIGN GROUP

Architects • Engineers • Interior Design

Planners • Urban Designers • LEED®

120 Vassar Dr SE Suite 100 Albuquerque New Mexico 87106

T 505 242 6880 • F 505 242 6881

CONSULTANT

PROJECT NAME

HILAND PLAZA

5000 CENTRAL AVENUE NE ALBUQUERQUE, NM 87108

PR-2021-005390 PROJECT NUMBER: SI-2021-00832 - SITE PLAN Application Number:

TABLE OF CONTENTS:

ENLARGED SITE PLAN

LANDSCAPING PLAN

SITE GRADING PLAN

SITE UTILITY PLAN

PROJECT LOCATION: CENTRAL AVENUE SE AND JACKSON STREET SE

LEGAL DESCRIPTIONS: LOTS NUMBERED ONE (1) THROUGH TWENTY-TWO

(34) OF THE VALLEY VIEW ADDITION TO THE CITY

OF ALBUQUERQUE, NEW MEXICO, AS THE SAME IS

SHOWN AND DELINEATED ON THE MAP OF SAID

ADDITION, FILED IN THE OFFICE OF THE COUNTY

CLERK OF BERNALILLO COUNTY, NEW MEXICO, ON

MULTI FAMILY RESIDENTIAL, WITH 92 UNITS AND

TWO COMMERCIAL SPACES (APROX. 2,000 SF

(22), INCLUSIVE, IN BLOCK NUMBERED THIRTY-FOUR

ELEVATIONS

CIVIL DETAILS

CIVIL DETAILS

CIVIL DETAILS

CIVIL DETAILS

SP-DRB: SITE PLAN - DRB

C-102:

LP-101:

C-201:

C-301:

A-201:

C-501:

C-502:

C-503:

C-504:

SEPTEMBER 2, 1911.

ZONE ATLAS PAGES:


EXISTING ZONING:

PROPOSED USES:

K-17-Z

CONTAINING 1.59 ACRES

MX-M MIXED USE MEDIUM DENSITY

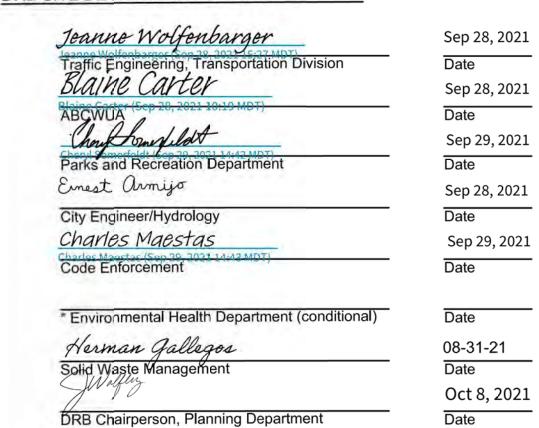


REVISIONS NO. DATE DESCRIPTION Copyright: Design Group August 5, 2021 2574 SHEET TITLE

SHEET NUMBER

SP-DRB



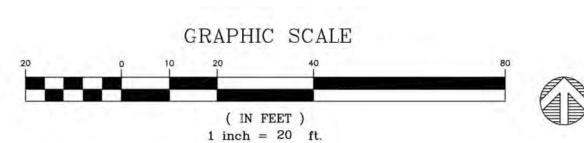

ZONING MX-M

NEW PROPERTY LINE

MINOR AMENDMENT - ON STREET PARLKOING SPACES RELOCATED FROM JACKSON ST. TO THE PROPERTY, ENTRY GATES SHIFTED NORTH TO ACCOMMODATE RELOCATED ACCESSIBLE PARKING.

WEST BOUND DRIVER PATH

5. Open Space per table 2-4-5 including a 50% reduction for UC-MS-PT. Open space includes 9,616 sf of landscaping and 7,534 sf of sidewalk and patio space.

6. Un-assigned On Street Parking available along Silver Avenue SE and Jackson Street SE is 17 including 2 ADA Stalls.

ZONING MX-M

WEST BOUND DRIVER PATH

100' RIGHT OF WAY

FF=5255.36

On-Site Open Open Electric Number of Req'd Parking Space Space Bicycle Bicycle Vehicle Parking Space/Unit Type Units GSF per unit Parking Provided Reg'd Provided Reg'd Provided MC Reg'd Provided Reg'd Provided Leasing Office 1 Office 2000 8 SPACES PROVIDED 1 Office/Retail 2000 Commercial 68 Residential 1 bdr, 1 ba 533 14 Residential 2 bdr, 2 ba 795 1995 3 bdr, 2 ba 10 Residential 52 62 11395 17,150 sf 6 12 8 6VAN 8VAN 4 1. Parking required 1 space per DU, with 50% reduction for UC-MS-PT Table 5-5-1: Off-street Parking Requirements 2. Bicycle parking required, 3 spaces or 10% whichever is greater Table 5-5-5: Bicycle Parking Requirements 3. Motorcycle parking required 1 space per 25 off street parking. Table 5-5-4: Motorcycle Parking Requirements 4. Accessible Parking is based on 2015NM Commercial Building Code, Table 1106.1 of Title 14, Chapter 7, Part 2.

For Visibility, landscaping, fencing, and signs shall not interfere with clear sight requirements. Therefore, signs, walls, trees, and shrubs between 3 and 8 feet in height (as measured from the gutter pan) are not allowed in the clear sight triangle.

ZONING MX-M

WAIVER APPROVED TO ALLOW

ALONG JACKSON STREET, SEE

NEW PROPERTY LINE

FOR 6' CONCRETE SIDEWALK

VA-2021-00217

FF=5255.36

EAST BOUND DRIVER PATH

ALL WORK WITHIN THE RIGHT-OF-WAY TO BE CONSTRUCTED AT PART OF THE PUBLIC WORK ORDER.

CENTRAL AVENUE

PROPOSED 1

4 STORY BLDG.

ZONING MX-M

FF=5255.36

NEW PROPERTY LINE

SKATEBOARD

60' RIGHT OF WAY

SITE PLAN GENERAL NOTES

- A. MINI SIGHT TRIANGLE (11' ON EACH SIDE STARTING AT BACK OF SIDEWALK AND THEN EXTENDING TO FLOW LINE OF CURB PER DEVELOPMENT PROCESS MANUAL FIGURE 7.4.94), FOR ILLUSTRATIVE
- B. LANDSCAPING, SIGNAGE, WALLS, FENCES, TREES AND SHRUBBERY BETWEEN 3 FEET AND 8 FEET TALL (AS MEASURED FROM THE GUTTER PAN) ARE NOT ALLOWED WITHIN THE CLEAR SITE TRIANGLE.

 \sim

- C. ALL PARCELS SURROUNDING THE PROJECT SITE ARE MX-M ZONING. REFUSE WILL BE COLLECTED INTERNALLY BY A TRASH CHUTE AND COMPACTOR. MAINTENANCE STAFF WILL MOVE REFUSE TO THE REFUSE HOLDING YARD, A MINIMUM OF (4) 2 CUBIC YARD ROLLING DUMPSTERS FOR TRASH WILL BE AVAILABLE.
- E. RECYCLE MATERIALS WILL BE COLLECTING IN ROLLING BINS ON EACH FLOOR OF THE BUILDING AND WILL BE MOVED OUT TO HOLDING YARD
- F. SOLID WASTE WILL BE PROVIDED A PROXIMITY CARD AND KEY PAD ACCESS CODES TO ENSURE ACCESS FOR REFUSE COLLECTION. G. ACCESS SHALL BE PROVED TO ABCWUA AS NECESSARY FOR WATER
- METER VAULT FOR MAINTENANCE. H. ALL WORK WITHIN THE RIGHT-OF-WAY TO BE CONSTRUCTED AT PART
- OF THE PUBLIC WORK ORDER. I. CURB ACCESS RAMPS WITHIN THE PUBLIC RIGHT-OF-WAY WILL BE
- DETAILED AS PART OF PUBLIC WORK ORDER. J. VARIANCES TO BUILDING DESIGN STANDARDS IN THE NOB HILL/HILAND CPO-8 WERE APPROVED BY THE ZHE FOR THIS PROJECT
- UNDER PROJECT PR-2021-005535. SEE BUILDING ELEVATION SHEET FOR DETAILS.

SITE PLAN KEYED NOTES

BY MAINTENANCE STAFF.

- CONCRETE PAVEMENT PER DETAIL D3/C-501. 2. CONCRETE HEADER CURB, 6" TALL, PER DETAIL A5/C-501. 3. STANDARD CURB AND GUTTER PER DETAIL A5/C-501.
- 4. CONCRETE PAVEMENT STRIP 2' WIDE PER DETAIL D3/C-501.
- GRAVEL PAVEMENT PER DETAIL D4/C-501. . CONCRETE CURB ACCESS RAMP PER DETAIL A1/C-501 AND TYPE C PARALLEL CURB ACCESS RAMP PER COA STANDARD DWG 2443, TO
- BE DETAILED IN PWO PLANS. 7. DETECTABLE WARNING SURFACE PER DETAIL A3/C-501.
- 8. CONCRETE SIDEWALK PER DETAIL B4/C-501. 9. ADA RESERVED PARKING STALL PER DETAIL A1/C-502.
- 10. ADA RESERVED PARKING SIGN MOUNTED PER DETAIL C3/C-502 AND D2/C-502.
- 11. ADA VAN ACCESSIBLE RESERVED SIGN MOUNTED PER DETAIL C3/C-502 AND D2/C-502.
- 12. RESERVED PARKING SYMBOL PER DETAIL E3/C-502. 13. CONCRETE PARKING BLOCK PER DETAIL E4/C-502.
- 14. 24' SLIDING VEHICLE GATE PER DETAIL A5/C-504 WITH LIFT MASTER PROFESSIONAL MODEL SL3000101U HEAVY DUTY SLIDING GATE OPERATOR WITH 1-HP MOTOR ON 18"x34"x24" CONCRETE
- FOUNDATION. INSTALL PER MANUFACTURER RECOMMENDATIONS. 15. BICYCLE RACK PER DETAIL E5/C-502.
- 16. ASPHALT PAVEMENT PER DETAIL E2/C-501. 17. PAINT CURB RED WITH 6" TALL LETTERS READING "NO PARKING
- FIRE LANE". 18. FIRE DEPARTMENT KNOX BOX.
- 19. SIDEWALK CULVERT PER DETAIL B3/C-501.
- 20. MOTORCYCLE PARKING STALL WITH SIGNAGE AND PAVEMENT 21. CONCRETE STAIR PER B4/C-502 AND HANDRAILS PER DETAILS
- 22. CONCRETE CUT OFF WALL TO SEPARATE ASPHALT FROM GRAVEL
- PARKING, PER DETAIL A5/C-501.
- 23. 4" WIDE WHITE PARKING STRIPE. 24. CONTINENTAL CROSS WALK STRIPING.
- 25. REFUSE ENCLOSURE PER DETAIL A3/C-502. 26. FIRE RISER ROOM, SEE ARCHITECTURAL AND MECHANICAL PLANS.
- 27. LANDSCAPED AREA. 28. CONCRETE STOOP PER DETAIL C3/C-501. 29. CONCRETE SPLASH BLOCK PER DETAIL D6/C-501 AND CONCRETE
- RUNDOWN PER DETAIL D5/C-501. 30. 6' TALL PERIMETER FENCE PER DETAIL A5/C-504.
- 31. 6' TALL PERIMETER FENCE PERSONNEL GATE PER DETAIL A4/C-504. 32. 4' TALL PERIMETER FENCE PER DETAIL A5/C-504.

33. 4' TALL PERIMETER FENCE PERSONNEL GATE PER DETAIL A4/C-504.


- 34. NOT USED 35. REFUSE ENCLOSER GATE PER DETAIL D5/C-504.
- 36. ENCLOSURE GATE PER DETAIL A2/C-504. 37. NOT USED

DETAIL A5/C-504.

- 38. NOT USED 39. 6" STEEL BOLLARD PER DETAIL E1/C-501.
- 40. PAINT CURB YELLOW WHERE HEIGHT IS BETWEEN $\frac{1}{4}$ " AND 6" TALL. 41. STORM WATER RETENTION POND, SEE GRADING PLANS. 42. TURN DOWN EDGE SIDEWALK PER DETAIL E3/C-501.
- 43. NATURAL GAS METER OR REGULATOR SEE UTILITY PLANS. 44. WATER METER VAULT. SEE UTILITY PLAN.
- 45. ELECTRICAL TRANSFORMER, SEE SHEET ES-101. 46. ELECTRICAL METER PACK. SEE ELECTRICAL PLANS. 47. NOT USED
- 48. LOOP DETECTOR FOR AUTOMATIC GATE OPERATORS. SEE ELECTRICAL PLANS FOR DETAILS.
- 49. PATIO RAILING PER DETAIL C5/C-501.
- 50. CONCRETE RAMP AND HANDRAILS PER DETAIL A2/C-502. 51. DOG WASTE STATION. SEE LANDSCAPING PLANS.

DWG 2445, TO BE DETAILED IN PWO PLANS..

- 53. DOG PARK SURROUNDED BY 4' TALL FENCE PER DETAIL A5/C-504. 54. SKATE BOARD PARK AREA SURROUNDED BY 4' TALL FENCE PER
- 55. LOW SEAT WALL. SEE LANDSCAPING PLANS. 56. CONCRETE SIDEWALK TO BE FLUSH WITH ASPHALT. PROVIDE 3'
- LONG CURB TRANSITION FROM 6" TALL TO FLUSH ON EACH SIDE. 57. CONCRETE CURB ACCESS RAMP DETAIL A PAIRED PARALLEL CURB ACCESS RAMP WITH A COMMON LANDING PER COA STANDARD
- 59. CONCRETE CURB ACCESS RAMP DETAIL B CORNER ACCESS RAMP
- PER COA STANDARD DWG 2441, TO BE DETAILED IN PWO PLANS. 60. 24" THERMOPLASTIC WHITE STOP BAR STRIPING. 61. CONCRETE CURB ACCESS RAMP TYPE A PARALLEL CURB ACCESS
- RAMP PER COA STANDARD DWG 2443 62. CONCRETE CURB ACCESS RAMP SIMILAR TO COA STANDARD DWG 2443 DETAIL B MODIFIED TO HAVE SLOPING WING INSTEAD OF
- HEADER CURB, TO BE DETAILED IN PWO PLANS.
- 63. PROVIDE 12" TURNDOWN ON SIDEWALK. 64. 2' WIDE CONCRETE RUNDOWN PER DETAIL D5/C-501.
- 65. TURNED DOWN SIDEWALK AT PLAYGROUND PER DETAIL C4/C-502. 66. SEE LANDSCAPING PLANS FOR DETAILS OF THIS AREA.

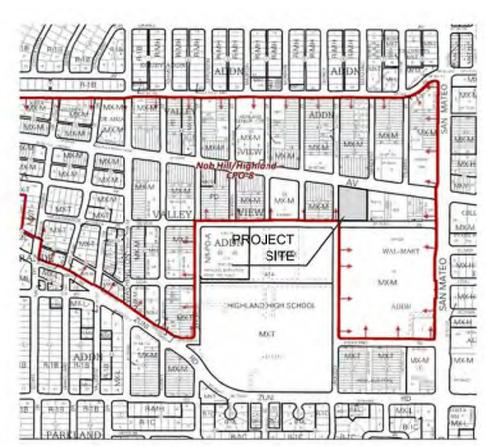

A5 ZONE ATLAS PAGE K-17-Z



TABLE OF CONTENTS:

SP-DRB: SITE PLAN - DRB **ENLARGED SITE PLAN** LP-101: LANDSCAPING PLAN C-201: SITE GRADING PLAN C-301: SITE UTILITY PLAN A-201: **ELEVATIONS** C-501: CIVIL DETAILS

C-502: CIVIL DETAILS C-503: CIVIL DETAILS C-504: CIVIL DETAILS

PROJECT LOCATION:
CENTRAL AVENUE SE AND JACKSON STREET SE


<u>LEGAL DESCRIPTIONS:</u>
LOTS NUMBERED ONE (1) THROUGH TWENTY-TWO (22), INCLUSIVE, IN BLOCK NUMBERED THIRTY-FOUR (34) OF THE VALLEY VIEW ADDITION TO THE CITY OF ALBUQUERQUE, NEW MEXICO, AS THE SAME IS SHOWN AND DELINEATED ON THE MAP OF SAID ADDITION, FILED IN THE OFFICE OF THE COUNTY CLERK OF BERNALILLO COUNTY, NEW MEXICO, ON SEPTEMBER 2, 1911.

CONTAINING 1.59 ACRES

ZONE ATLAS PAGES: K-17-Z

EXISTING ZONING: MX-M MIXED USE MEDIUM DENSITY

PROPOSED USES: MULTI FAMILY RESIDENTIAL, WITH 92 UNITS AND TWO COMMERCIAL SPACES (APROX. 2,000 SF

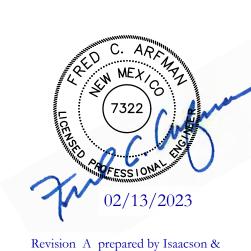

SITE PLAN KEYED NO

- 67. PAINTED ONE-WAY ARROW.
- 68. GATE MOUNTED SIGN: "NO EXIT" 69. GATE MOUNTED SIGN: "ENTRY ONLY. NO EXIT"
- 70. GATE MOUNTED SIGN: "NO ENTRY" 71. GATE MOUNTED SIGN: "EXIT ONLY. NO ENTRY."
- 72. NOT USED 73. NOT USED 74. SIGN: ELECTRIC VEHICLE CHARGING STATION

75. ELECTRONIC GATE 'FOB' PEDESTAL 76. FUTURE ELECTRIC VEHICLE (EV) PEDESTALS WITH BOLLARDS

PR-2021-005390 PROJECT NUMBER:

SI-2021-00832 - SITE PLAN Application Number:

Is an Infrastrure List Required? (X) Yes () No If yes, then a set of approved DRC plans with a work order is required for any construction within Public Right-of-Way of for construction of public improvements.

DRB SITE DEVELOPMENT PLAN APPROVAL:

ORB Chairperson, Planning Department

Jeanne Wolfenbarger	Sep 28, 202
Traffic Engineering, Transportation Division	Date
Blaine Carter	Sep 28, 202
ABCWUA Sep 28, 2021 10:10 MBT)	Date
Charge brown feld A	Sep 29, 202
Chond Somorfoldt (Sop 29, 2021 14:42 MDT) Parks and Recreation Department	Date
Ernest Armijo	Sep 28, 202
City Engineer/Hydrology	Date
Charles Maestas	Sep 29, 202
Charles Maestas (Sep 29, 2021 14:43 MDT) Code Enforcement	Date
Environmental Health Department (conditional)	Date
Herman Gallegos	08-31-21
Solid Waste Management	Date
Maying	Oct 8, 202

PERMIT SET PROJECT NAME HILAND PLAZA

DESIGN GROUP

Architects • Engineers • Interior Design Planners • Urban Designers • LEED®


120 Vassar Dr SE Suite 100 Albuquerque New Mexico 87106

T 505 242 6880 • F 505 242 6881

CONSULTANT

STAMP

5000 CENTRAL AVENUE NE ALBUQUERQUE, NM 87108

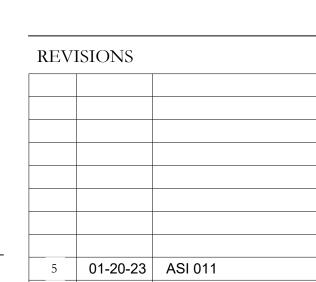

Copyright: Design Group

Checked by December 6, 2022 IA 2511

NO. DATE DESCRIPTION

SHEET TITLE


SITE PLAN

SHEET NUMBER

SP-DRB-A






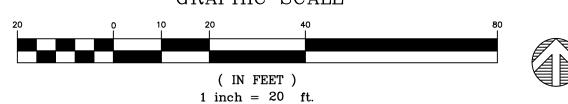

SILVER AVENUE

ZONING MX-M

EX PROPERTY LINE

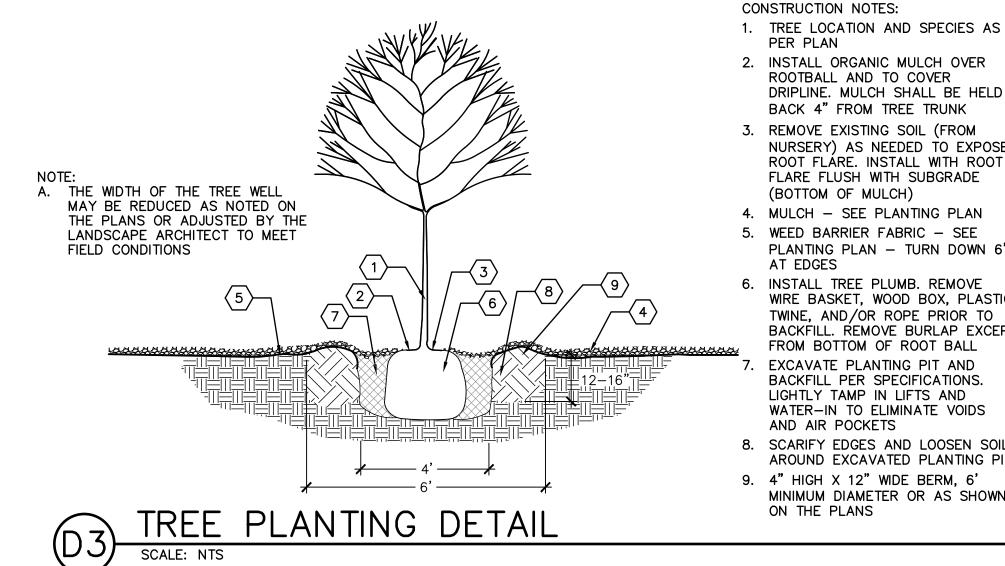

ROOTBALL AND TO COVER DRIPLINE. MULCH SHALL BE HELD BACK 4" FROM TREE TRUNK 3. REMOVE EXISTING SOIL (FROM NURSERY) AS NEEDED TO EXPOSE ROOT FLÁRE. INSTALL WITH ROOT FLARE FLUSH WITH SUBGRADE (BOTTOM OF MULCH) 4. MULCH - SEE PLANTING PLAN WEED BARRIER FABRIC - SEE PLANTING PLAN - TURN DOWN 6" AT EDGES

. INSTALL TREE PLUMB. REMOVE WIRE BASKET, WOOD BOX, PLASTIC, TWINE, AND/OR ROPE PRIOR TO BACKFILL. REMOVE BURLAP EXCEPT FROM BOTTOM OF ROOT BALL EXCAVATE PLANTING PIT AND BACKFILL PER SPECIFICATIONS LIGHTLY TAMP IN LIFTS AND

AND AIR POCKETS 8. SCARIFY EDGES AND LOOSEN SOIL AROUND EXCAVATED PLANTING PIT 9. 4" HIGH X 12" WIDE BERM, 6' MINIMUM DIAMETER OR AS SHOWN ON THE PLANS

BOTANICAL NAME

STYPHNOLOBIUM JAPONICUM 'HALKA'

ULMUS PARVIFOLIA 'EMER II'

PISTACHIA CHINENSIS

CHILOPSIS LINEARIS

VITEX AGNUS-CASTUS

FORESTIERA NEOMEXICANA

CHAMAEBATIARIA MILLEFOLIUM CARYOPTERIS X CLANDONENSIS RHUS AROMATICA 'GRO-LOW'

PRUNUS BESSEYI 'PAWNEE BUTTES'

HESPERALOE PARVIFLORA 'PERPA'

HESPERALOE PARVIFLORA

NEPETA FAASSENII

ROSA 'NEARLY WILD'

PENSTEMON PINIFOLIUS

CANADA RED CHOKECHERRY PRUNUS X VIRGINIANA 'CANADA RED'

PLANT LEGEND

<u>TREES</u>

COMMON NAME

LACEBARK ELM

DESERT WILLOW

CHASTE TREE

FERNBUSH

RED YUCCA

CATMINT

NEW MEXICO OLIVE

GRO-LOW SUMAC

SHRUBS/GROUNDCOVERS/GRASSES/PERENNIALS

BREAKLIGHTS RED YUCCA

HILAND PLAZA.

XERIC PLANT LIST.


GOLDEN TORCH GOLDENROD SOLIDAGO SP.

COMPLIANCE WITH WATER CONSERVATION ORDINANCE:

1. NO SPRAY IRRIGATION IS PROPOSED.

CHINESE PISTACHE

JAPANESE PAGODA TREE

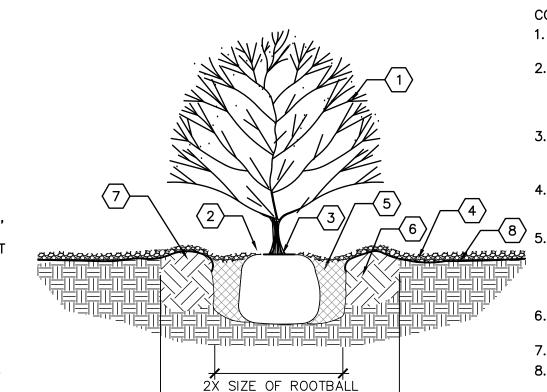

🖈 — 3X SIZE OF ROOTBALL — 🖈

INSTALLED SIZE

2" CAL., 10'-12' HT. B&B

2" CAL., 10'-12' HT. B&B

14 13 2" CAL., 10'-12' HT. 24"

16 10 { 2" CAL., 8'−10' HT.

4'-6' HT

4'-6' HT

MIN. 18" SPD

61 62 ⟨MIN. 12" HT.

19 21 \MIN. 6" SPD.

76 73 √MIN. 8" HT.

、15 21*)* 4'-6' HT.

SHRUB PLANTING DETAIL

REMARKS

MATURE SIZE

CONSTRUCTION NOTES: 1. SHRUB LOCATION AND SPECIES AS PER PLAN

2. MULCH SHALL BE FEATHERED TO A 2" DEPTH ON TOP OF ROOT BALL AND SHALL BE HELD BACK 2" FROM SHRUB STEM(S)

SHRUB BED UNLESS OTHERWISE

3. PLANT WITH TOP OF ROOT BALL FLUSH WITH SUBGRADE (BOTTOM OF MULCH) 4. 4" DEPTH MULCH THROUGHOUT

WATER DECIDUOUS/ COVERAGE

962 SF

707 SF

314 SF

314 SF

314 SF

USE EVERGREEN

M DECIDUOUS

M DECIDUOUS

M DECIDUOUS

DECIDUOUS

45' HT. X 35' SPD. M DECIDUOUS

15 GA, MULTI 15' HT. X 12' SPD. M DECIDUOUS

2' HT. X 2' SPD.

3' HT. X 5' SPD. L DECIDUOUS

1' HT. X 18" SPD. L EVERGREEN

2' HT. X 2' SPD. M DECIDUOUS 3 SF

L DECIDUOUS

L EVERGREEN

EXCAVATE PLANTING PIT AND BACKFILL PER SPECIFICATIONS. LIGHTLY TAMP IN LIFTS AND WATER-IN TO ELIMINATE VOIDS AND AIR POCKETS 6. SCARIFY EDGES AND LOOSEN SOIL AROUND EXCAVATED PLANTING PIT

7. 2" HIGH X 6" WIDE BERM 8. WEED BARRIER FABRIC - SEE IRRIGATION PLANTING PLAN - TURN DOWN 6" AT EDGES

CONSULTANT

LANDSCAPE ARCHITECTS 505 268 2266 mrwmla.com

THE HARTMAN + MAJEWSKI

DESIGN GROUP

Architects • Engineers • Interior Design

Planners • Urban Designers • LEED®

120 Vassar Dr SE Suite 100

Albuquerque New Mexico 87106

T 505 242 6880 • F 505 242 6881

STAMP



PERMIT SET PROJECT NAME

HILAND PLAZA

5000 CENTRAL AVENUE NE

ALBUQUERQUE, NM 87108

CITY LANDSCAPE ORDINANCE COMPLIANCE

LANDSCAPING RESPONSIBILITY FOR MAINTENANCE:

1. THE OWNER WILL BE RESPONSIBLE FOR ALL LANDSCAPE MAINTENANCE AT LANDSCAPE CALCULATION TABLE: TOTAL LOT AREA: 69,260 SF LESS TOTAL BUILDING AREA: 21,363 SF NET LOT AREA: 47,897 SF

REQUIRED LANDSCAPE AREA (15% OF NET LOT AREA):

2. PLANT SPECIES WILL BE LOW OR MEDIUM USE SPECIES PER THE ABCWNA'S 7,185 SF

PROVIDED-LANDSCAPE AREA: REQUIRED PLANTS: REQUIRED STREET TREES:

12 (296 LF ALONG JACKSON ST SE, TREES AVERAGE 25' O.C.) 11 (255 LF ALONG CENTRAL AVE SE, TREES AVERAGE 25' O.C.) 11 (254 LF ALONG SILVER AVE SE, TREES AVERAGE 25' O.C.)

3 GALLON

1 GALLON

STREET TREES PROVIDED: 14 ALONG JACKSON ST SE 11 ALONG CENTRAL AVE SE 11 ALONG SILVER AVE SE

NUMBER OF GROUND FLOOR* DWELLING UNITS: 14 *IN DT-UC-MS-PT AREAS, ONLY GROUND FLOOR DWELLING UNITS ARE USED TO CALCULATE THE REQUIRED TREES NUMBER OF TREES REQUIRED (AT LEAST ONE TREE PER GROUND FLOOR DWELLING UNITS): 14

REQUIRED PARKING LOT TREES AT ONE TREE PER TEN SPACES: 62 TOTAL SPACES

7 REQUIRED TREES PARKING LOT TREES PROVIDED: 13

REQUIRED PARKING LOT INTERIOR LANDSCAPE (15% OF PARKING LOT AREA): PROVIDED PARKING LOT INTERIOR LANDSCAPE:

3,037 SF (102.2% OF REQUIRED INTERIOR LANDSCAPE) REQUIRED COVERAGE (75% OF PROVIDED LANDSCAPE AREA): 7,456 SF 7,362 SF

PROVIDED COVERAGE: (9,937 SF 9,742 SF (137.8% 132.3%)OF REQUIRED COVERAGE) REQUIRED GROUND LEVEL VEGETATIVE COVERAGE (25% OF PROVIDED /LANDSCAPE-AREA)

2.489 SF 2.454 SF PROVIDED GROUND LEVEL PLANT COVERAGE: 12,890 SF 2,985 SF (120.2% 121.6% ØF REQUIRED GROUND LEVEL COVERAGE)

ENGINEERED WOOD FIBER MULCH PLAY AREA SURFACING

HATCH AND SYMBOL LEGEND GRAVEL MULCH CRUSHER FINES MULCH ORGANIC MULCH COBBLE MULCH SAND PLAY SURFACING → BIKE RACK O ROUND CONCRETE TABLE AND CHAIRS

CENTRAL AVENUE PROPERTY -LINE, TYP. 107 SF 1,375 SF 58 SF -FENCED I DOG RUN PROPERTY LINE, TYP. FENCED IN -SKATE 321 SF — 932 SF — 105 SF CLEAR SIGHT TRIANGLES - SEE COMPLIANCE WITH GENERAL COMPLIANCE WITH GENERAL

LANDSCAPING REQUIREMENTS NOTE 3.

LANDSCAPING REQUIREMENTS NOTE 3.

3. AN AUTOMATIC IRRIGATION SYSTEM WILL BE INSTALLED FOR ALL PLANT MATERIAL. THE SYSTEM WILL BE CONTROLLED BY AN AUTOMATIC CONTROLLER. PLANTS WILL BE IRRIGATED BY LOW WATER USE BUBBLERS. A REDUCED PRESSURE BACKFLOW PREVENTER WILL BE INSTALLED IN A HEATED ENCLOSURE TO PROTECT THE DOMESTIC WATER SUPPLY FROM CROSS-CONTAMINATION. COMPLIANCE WITH GENERAL LANDSCAPING REGULATIONS: 1. THIS PLAN PROVIDES VISUALLY ATTRACTIVE LANDSCAPE, A VISUALLY ATTRACTIVE STREETSCAPE, AND INTERSPERSED TREES IN LANDSCAPE AREAS TO PROVIDE SHADE AND REDUCE LARGE EXPANSES OF PAVEMENT. 2. GROUNDCOVER MULCH SHALL COMPRISE OF A COMBINATION OF CRUSHED GRAVEL (NOT TO EXCEED 75% OF TOTAL AREA) AND ORGANIC MULCH SUCH AS SHREDDED BARK, PECAN SHELLS, ETC. 3. VISIBILITY, LANDSCAPING FENCING, AND SIGNS SHALL NOT INTERFERE WITH CLEAR SIGHT REQUIREMENTS. THEREFORE, SIGNS, WALLS, TREES, AND SHRUBS BETWEEN 3 AND 8 FEET IN HEIGHT (AS MEASURED FROM THE GUTTER PAN) WILL NOT BE LOCATED IN THE CLEAR SIGHT TRIANGLE. 4. GROUND-MOUNTED EQUIPMENT SCREENING WILL BE DESIGNED TO ALLOW FOR ACCESS TO UTILITY FACILITIES. ALL SCREENING AND VEGETATION SURROUNDING GROUND-MOUNTED TRANSFORMERS AND UTILITY PADS ARE TO ALLOW 10 FEET OF CLEARANCE IN FRONT OF THE EQUIPMENT DOOR AND 5-6 FEET OF CLEARANCE ON THE REMAINING THREE SIDES FOR SAFE 2,972 SF OPERATION, MAINTENANCE, AND REPAIR PURPOSES. FEBRUARY 16, 2023 MINOR AMENDMENT LANDSCAPE PLAN CHANGES PER SITE PLAN

LANDSCAPE PLAN

SCALE: 1"=20'-0"

ADA PICNIC TABLE

SHEET NUMBER LP101

REVISIONS

/1\ | 01/12/2023 | ASI 011

Copyright: Design Group

SHEET TITLE

Checked by

NO. | DATE | DESCRIPTION

LANDSCAPE

PLAN

SEPTEMBER 20, 2021