


Index to Drawings

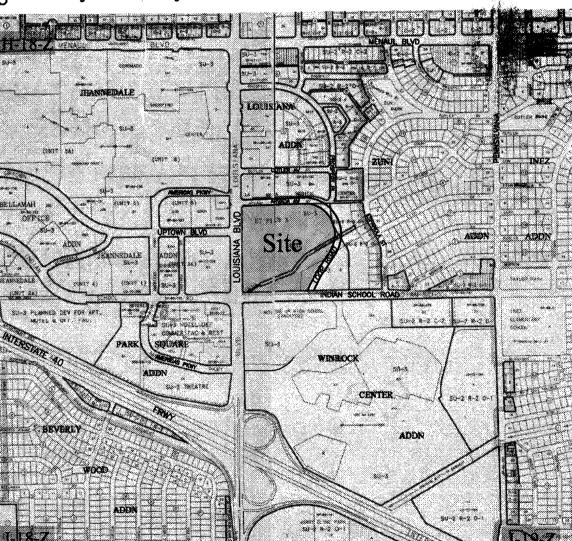



GENERAL NOTES KEYNOTES

- SEE SHEET A-120 FINISH SCHEDULE FOR SPECIFICATIONS, PROCUREMENT AND INSTALLATION RESPONSIBILITIES OF ALL STOREFRONT MATERIAL.
- SEE SHEET A-180 DOOR SCHEDULE FOR SIZES AND SPECIFICATION OF STOREFRONT DOORS.
- ARTWORK PROVIDED BY OWNER
- SEE STRUCTURAL DWGS FOR STOREFRONT FRAMING
- # KEYNOTE SYMBOL
- NEW SIGNAGE FURNISHED AND INSTALLED BY SIGN VENDOR. GC TO COORDINATE WITH SIGN VENDOR ALL ELECTRICAL AND STRUCTURAL REQUIREMENTS PRIOR TO INSTALLATION.
- INSTALL BLOCKING AS REQUIRED FOR SIGNAGE. SEE VENDOR SHOP DRAWINGS FOR ADDITIONAL INFORMATION JUNCTION BOX FOR STOREFRONT SIGNAGE CONCEALED ABOVE CEILING, SEE SHEET A-420
- STOREFRONT SECTIONS AND ELECTRICAL SHEET E-110 FOR ADDITIONAL INFORMATION EAS SENSORS RECESSED INTO SLAB, SEE ELECTRICAL DRAWINGS FOR MORE INFORMATION
- EAS CONTROLLER LOCATED BEHIND ACCESS PANEL AT STOREFRONT VOID, 100AC OUTLET REQUIRED FOR EAS CONTROLLER, SEE ELECTRICAL DWGS FOR MORE INFORMATION CONCRETE PLASTER FINISH APPLIED OVER CEMENTITIOUS BACKER BOARD OVER EXISTING
- A-120 FINISH SCHEDULE. PROVIDE U-V RESISTANT SEALER AT EXTERIOR LOCATIONS, GC TO PATCH, REPAIR AND/OR REPLACE EXISTING SHEATHING AS REQUIRED PRIOR TO NEW WALL FINISH APPLICATION AS APPLICABLE
- 3/8" FRY-REGLET REVEAL CONTROL JOINT AT CONCRETE PLASTER, MATCH CONCRETE COLOR. POWDER-COATED 3/4"W REVEAL, SEE A-400 SERIES DETAILS, COLOR: AS NOTED

SHEATHING PER DETAILS, UON, INSTALL PER MANUFACTURER'S INSTRUCTIONS, SEE SHEET

- POWDER-COATED BRAKE METAL 'L' AT REVEAL, SEE A-430 FOR MORE INFO, COLOR: AS NOTED 2 3/8" BACK-LIT CUSTOM PERFORATED METAL PANEL ASSEMBLY SECURED ON GC PROVIDED 7/8" HAT CHANNELS TO STOREFRONT WALL ASSEMBLY, GC TP RUN HAT CHANNELS IN PARALLEL TO LONG SIDE OF PANEL AND PROVIDE GAPS AS NEEDED TO ROUTE WIRING BETWEEN CHANNELS, GC TO COORDINATE POWER REQUIREMENTS AND ACCESS FOR REMOTE DRIVERS, FINAL PATTERN TO BE PROVIDED BY LLL FOR EACH LOCATION
- DASHED LINE INDICATES LOCATION OF LED STRIP LIGHTS INSIDE STOREFRONT PERFORATED PANEL, SEE SHEET A-150 RCP AND ELECTRICAL DRAWINGS FOR MORE INFORMATION
- INTERIOR WOOD VENEER PORTAL WITH FLUSH SOLID WOOD BASE AND SOLID WOOD FACE TRIMS AT STOREFRONT ENTRY. SEE SHEET A-120 FINISH SCHEDULE FOR SPEC AS NOTED INTERIOR WOOD VENEER EMBLEM WALL WITH FLUSH SOLID WOOD BASE AND METAL BASE
- PROVIDE DUPLEX OUTLET WITH WHITE COVERPLATE AT GWB SOFFIT WITHIN 18" OF TOP OF STOREFRONT WINDOW
- 🗟 PROVIDE DUPLEX OUTLET BRUSHED STAINLESS COVERPLATE AT WOOD PORTAL CEILING
- WITHIN 18" OF TOP OF STOREFRONT WINDOW 16 EXISTING COLUMN. LOCATION TO BE VERIFIED BY GC, ENSURE FIRE RATING IS MAINTAINED

- INTERIOR BRAKE METAL BASE, CORNER PIECES TO BE SHOP WELDED, AND SCRIBE IN FIELD, TYP INTERIOR GLAZING ASSEMBLY, SEE SHEET A-120 FINISH SCHEDULE FOR SPEC AS NOTED
- 1/8" MAX BUTT-JOINT. POLISH AND BEVEL ALL EXPOSED GLASS EDGES AND SEAMS, TYP. INTERIOR STOREFRONT GLAZING CHANNEL USE 1"x1" AT SILL AND 1" x 1 1/2" RECESSED INTO WOOD PORTAL AT HEAD, PROVIDE GRAY GASKETTING, NEOPRENE SETTING PADS, AND MATTE
- GRAY SILICONE SEALANT AS REQUIRED, FINISH BRUSHED STAINLESS STEEL INTERIOR SIDE-FOLDING GRILLE AND INTEGRATED LOCKING EGRESS DOOR, SEE SECTIONS A-420 INTERIOR OVERHEAD GRILLE WITH EQUIPMENT CONCEALED ABOVE PORTAL, SEE SECTIONS A-420, PROVIDE POWER FOR KEYED OPERATING SWITCH AND EMERGENCY RELEASE AT 48" AFF INTERIOR TEMPERED GLASS DOOR WITH BRUSHED STAINLESS STEEL PATCH FITTINGS, SEE
- | EXISTING EXTERIOR STOREFRONT DOOR TO REMAIN, GC TO POWDERCOAT EXTERIOR AND INTERIOR SIDES BLACK AS SCHEDULEDM SEE A-180 FOR DOOR AND HARDWARE SCHEDULE EXTERIOR STOREFRONT SYSTEM TO REMAIN, GC TO POWDER COAT EXTERIOR AND INTERIOR
- SIDES BLACK AS SCHEDULED EXTERIOR GLAZING ASSEMBLY TO REMAIN
- EXTERIOR CONTINUOUS FLASHING; COLOR AS NOTED TO MATCH ADJACENT FINISH 8 EXTERIOR PORCELAIN BASE OVER 3/8"THK MORTAR BED OVER 5/8" CEMENTITIOUS BACKER
- BOARD, MITER CORNERS IN FIELD. SEE A-120 FOR SPEC [29] EXTERIOR T&G SIDING AT STOREFRONT ENTRY WOOD PORTAL WITH FLUSH SOLID WOOD BASE AND SOLID WOOD FACE TRIMS, SEE SHEET A-120 FINISH SCHEDULE FOR SPEC AS NOTED
- 30 EXTERIOR AWNINGS BY AWNING VENDOR. GC. TO COORDINATE WITH VENDOR ALL ELECTRICAL AND STRUCTURAL REQUIREMENTS PRIOR TO INSTALLATION.

COATS OF TEXPREP PRIMER LET DRY; APPLY COLOR COAT.

EXISTING TRELLIS STRUCTURE, GC TO PAINT BLACK AS SCHEDULED 2 CONCRETE PLASTER FINISH APPLIED OVER EXISTING WALL FINISH; GC TO SCRAPE ALL HIGH POINTS, V-GROVE ALL CRACKS IN THE OLD BROWN COAT, CLEAN AND COVER WITH 4.5-OUNCE DETAIL FIBER MESH EMBEDDED IN ACRYLIC MODIFIED CEMENT, ORTEX OR EIFS BASECOAT; LEVEL ALL LOW POINTS WITH ACRYLIC MODIFIED CEMENT, ORTEX OR EIFS BASECOAT; EMBED A FULL 4.5-OUNCE EIFS FIBER MESH IN THE BASECOAT OVER THE WHOLE SURFACE; APPLY 2



1 Iululemon 1818 CORNWALL AVE. VANCOUVER, B.C., V6J1C7

> ABQ UPTOWN 2260 Q STREET, SPACE #02E

ALBUQUERQUE, NM 87110

| | kenneth**park**

ARCHITECT

MEP ENGINEER

STRUCTURAL ENGINEER

THESE DRAWINGS AND SPECIFICATIONS ARE THE PROPERTY AND COPYRIGHT OF ARCHITECT AND SHALL NOT BE USED ON ANY OTHER WORK EXCEPT BY WRITTEN AGREEMENT WITH ARCHITEC

LICENSED NAME, ARCHITECT

ARCHITECT: KENNETH PARK, AIA WAS PREPARED BY ME OR UNDER MY DIRECT SUPERVISION AND THAT I AM A DULY REGISTERED/LICENSED ARCHITECT UNDER THE LAWS OF THE STATE OF

ARCHITECTURAL REG. #2896 REGISTRATION EXPIRES: 12/31/2024

NEW MEXICO

BID/PERMIT SET

03/17/2023


△ DATE DESCRIPTION 01/23/2023 DD SET 02/24/2023 CD SET

03/17/2023 BID/PERMIT SET


DRAWING INFORMATION PROJECT #: 22-111 CHECKED BY: SL DRAWN BY: KY

(EXTERIOR) STOREFRONT PLANS AND ELEVATIONS

STOREFRONT RENDERING SHOWN FOR REFERENCE ONLY

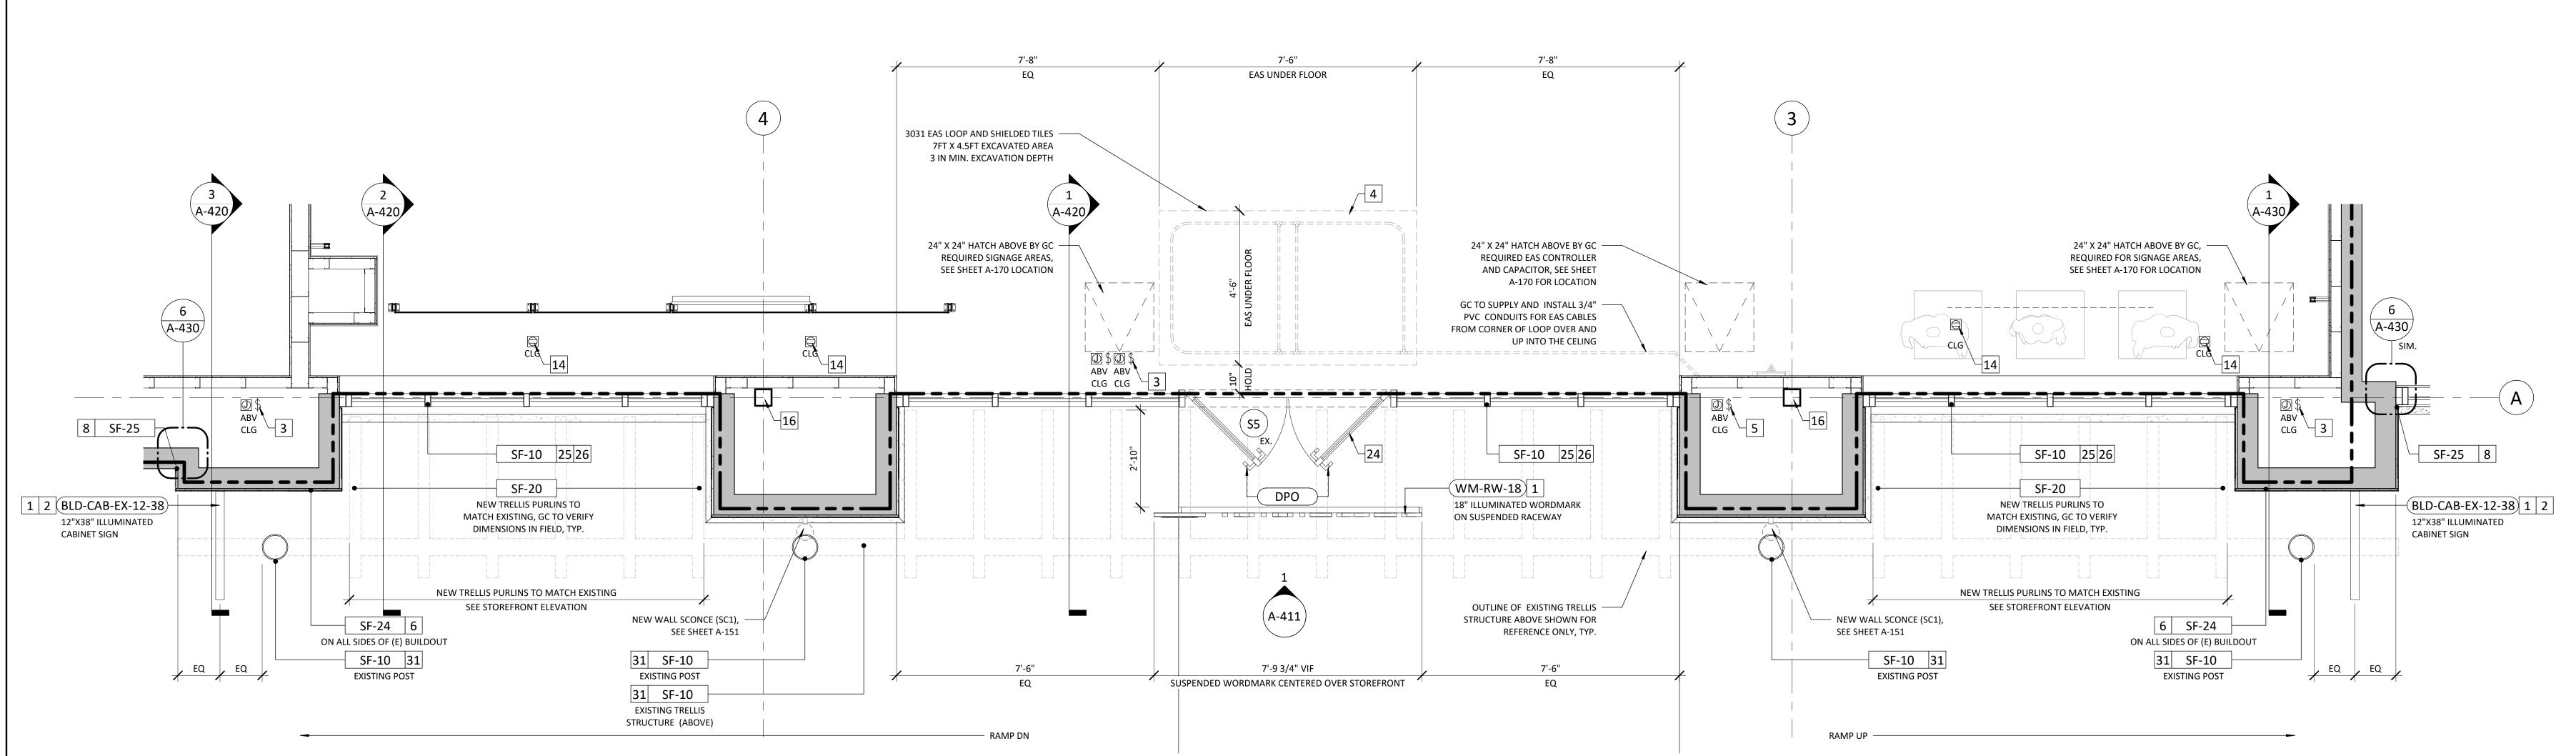


SCALE: 1/2" = 1'-0"

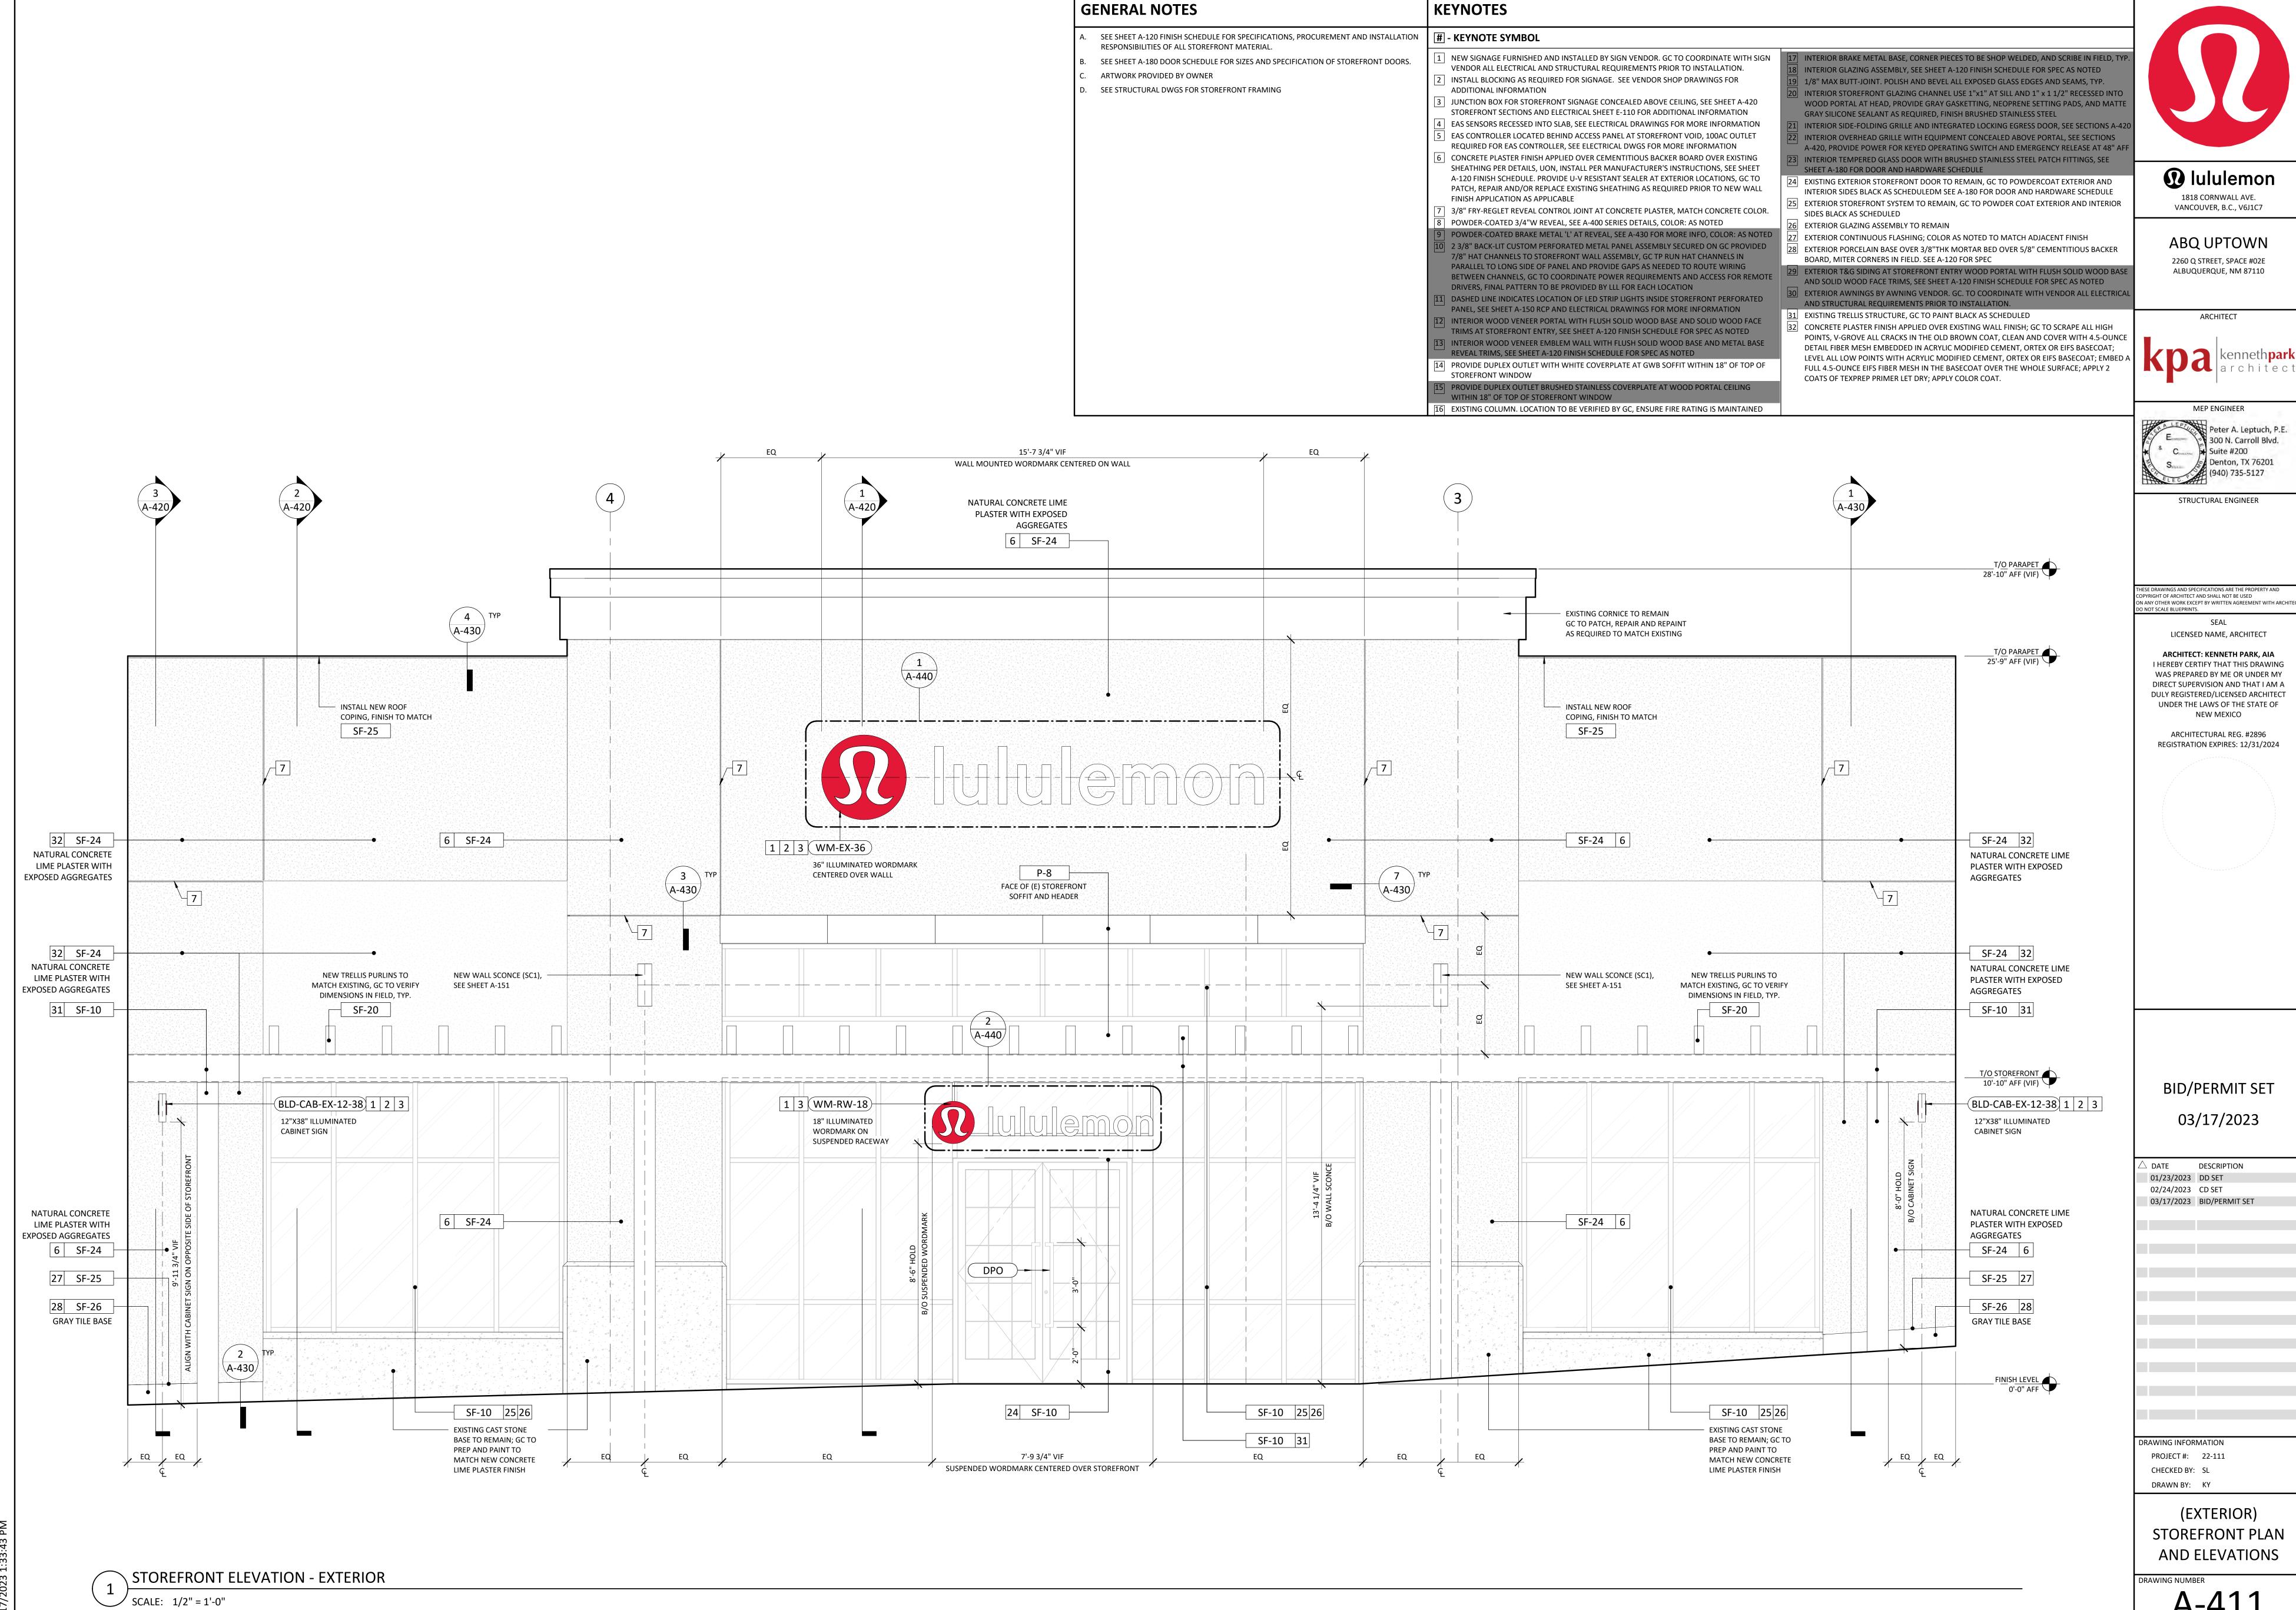

🔼 🕽 |kenneth**park**

A-411

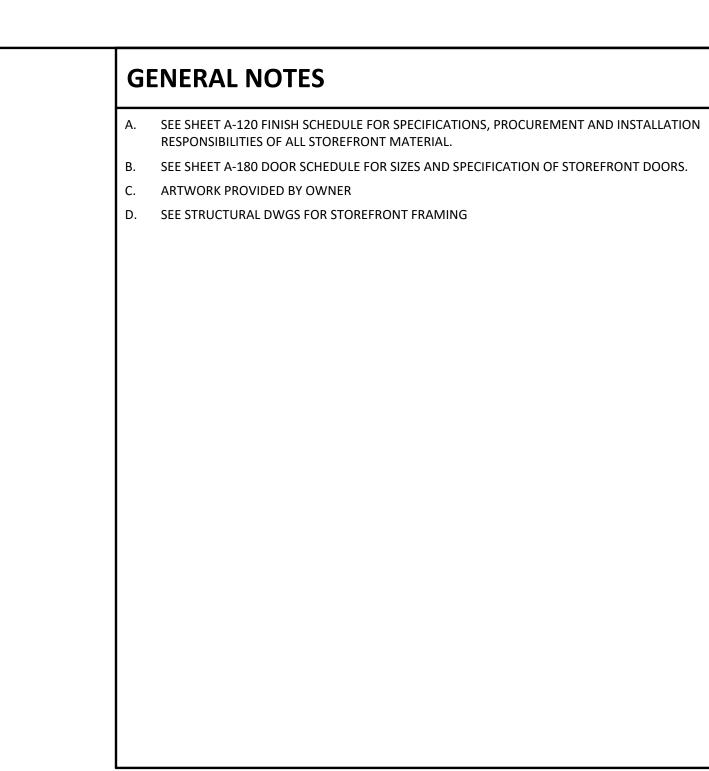

KEYNOTES

- KEYNOTE SYMBOL NEW SIGNAGE FURNISHED AND INSTALLED BY SIGN VENDOR. GC TO COORDINATE WITH SIGN

VENDOR ALL ELECTRICAL AND STRUCTURAL REQUIREMENTS PRIOR TO INSTALLATION. INSTALL BLOCKING AS REQUIRED FOR SIGNAGE. SEE VENDOR SHOP DRAWINGS FOR ADDITIONAL INFORMATION

JUNCTION BOX FOR STOREFRONT SIGNAGE CONCEALED ABOVE CEILING, SEE SHEET A-420 STOREFRONT SECTIONS AND ELECTRICAL SHEET E-110 FOR ADDITIONAL INFORMATION EAS SENSORS RECESSED INTO SLAB, SEE ELECTRICAL DRAWINGS FOR MORE INFORMATION

EAS CONTROLLER LOCATED BEHIND ACCESS PANEL AT STOREFRONT VOID, 100AC OUTLET REQUIRED FOR EAS CONTROLLER, SEE ELECTRICAL DWGS FOR MORE INFORMATION CONCRETE PLASTER FINISH APPLIED OVER CEMENTITIOUS BACKER BOARD OVER EXISTING SHEATHING PER DETAILS, UON, INSTALL PER MANUFACTURER'S INSTRUCTIONS, SEE SHEET A-120 FINISH SCHEDULE. PROVIDE U-V RESISTANT SEALER AT EXTERIOR LOCATIONS, GC TO PATCH, REPAIR AND/OR REPLACE EXISTING SHEATHING AS REQUIRED PRIOR TO NEW WALL

FINISH APPLICATION AS APPLICABLE 3/8" FRY-REGLET REVEAL CONTROL JOINT AT CONCRETE PLASTER, MATCH CONCRETE COLOR.

POWDER-COATED 3/4"W REVEAL, SEE A-400 SERIES DETAILS, COLOR: AS NOTED POWDER-COATED BRAKE METAL 'L' AT REVEAL, SEE A-430 FOR MORE INFO, COLOR: AS NOTED 2 3/8" BACK-LIT CUSTOM PERFORATED METAL PANEL ASSEMBLY SECURED ON GC PROVIDED 7/8" HAT CHANNELS TO STOREFRONT WALL ASSEMBLY, GC TP RUN HAT CHANNELS IN PARALLEL TO LONG SIDE OF PANEL AND PROVIDE GAPS AS NEEDED TO ROUTE WIRING BETWEEN CHANNELS, GC TO COORDINATE POWER REQUIREMENTS AND ACCESS FOR REMOTE DRIVERS, FINAL PATTERN TO BE PROVIDED BY LLL FOR EACH LOCATION DASHED LINE INDICATES LOCATION OF LED STRIP LIGHTS INSIDE STOREFRONT PERFORATED PANEL, SEE SHEET A-150 RCP AND ELECTRICAL DRAWINGS FOR MORE INFORMATION

2 INTERIOR WOOD VENEER PORTAL WITH FLUSH SOLID WOOD BASE AND SOLID WOOD FACE

TRIMS AT STOREFRONT ENTRY, SEE SHEET A-120 FINISH SCHEDULE FOR SPEC AS NOTED

3 INTERIOR WOOD VENEER EMBLEM WALL WITH FLUSH SOLID WOOD BASE AND METAL BASE REVEAL TRIMS, SEE SHEET A-120 FINISH SCHEDULE FOR SPEC AS NOTED 14 PROVIDE DUPLEX OUTLET WITH WHITE COVERPLATE AT GWB SOFFIT WITHIN 18" OF TOP OF STOREFRONT WINDOW 5 PROVIDE DUPLEX OUTLET BRUSHED STAINLESS COVERPLATE AT WOOD PORTAL CEILING

16 EXISTING COLUMN. LOCATION TO BE VERIFIED BY GC. ENSURE FIRE RATING IS MAINTAINED

WITHIN 18" OF TOP OF STOREFRONT WINDOW

NOT USED INTERIOR BRAKE METAL BASE, CORNER PIECES TO BE SHOP WELDED, AND SCRIBE IN FIELD, TYP INTERIOR GLAZING ASSEMBLY, SEE SHEET A-120 FINISH SCHEDULE FOR SPEC AS NOTED 1/8" MAX BUTT-JOINT. POLISH AND BEVEL ALL EXPOSED GLASS EDGES AND SEAMS, TYP. INTERIOR STOREFRONT GLAZING CHANNEL USE 1"x1" AT SILL AND 1" x 1 1/2" RECESSED INTO GRAY SILICONE SEALANT AS REQUIRED, FINISH BRUSHED STAINLESS STEEL

WOOD PORTAL AT HEAD, PROVIDE GRAY GASKETTING, NEOPRENE SETTING PADS, AND MATTE INTERIOR SIDE-FOLDING GRILLE AND INTEGRATED LOCKING EGRESS DOOR, SEE SECTIONS A-420 INTERIOR OVERHEAD GRILLE WITH EQUIPMENT CONCEALED ABOVE PORTAL, SEE SECTIONS A-420, PROVIDE POWER FOR KEYED OPERATING SWITCH AND EMERGENCY RELEASE AT 48" AFF INTERIOR TEMPERED GLASS DOOR WITH BRUSHED STAINLESS STEEL PATCH FITTINGS, SEE

SHEET A-180 FOR DOOR AND HARDWARE SCHEDULE | EXISTING EXTERIOR STOREFRONT DOOR TO REMAIN, GC TO POWDERCOAT EXTERIOR AND INTERIOR SIDES BLACK AS SCHEDULEDM SEE A-180 FOR DOOR AND HARDWARE SCHEDULE EXTERIOR STOREFRONT SYSTEM TO REMAIN, GC TO POWDER COAT EXTERIOR AND INTERIOR SIDES BLACK AS SCHEDULED

EXTERIOR GLAZING ASSEMBLY TO REMAIN

EXTERIOR CONTINUOUS FLASHING; COLOR AS NOTED TO MATCH ADJACENT FINISH 28 EXTERIOR PORCELAIN BASE OVER 3/8"THK MORTAR BED OVER 5/8" CEMENTITIOUS BACKER BOARD, MITER CORNERS IN FIELD. SEE A-120 FOR SPEC

29 EXTERIOR T&G SIDING AT STOREFRONT ENTRY WOOD PORTAL WITH FLUSH SOLID WOOD BASE AND SOLID WOOD FACE TRIMS, SEE SHEET A-120 FINISH SCHEDULE FOR SPEC AS NOTED

30 EXTERIOR AWNINGS BY AWNING VENDOR. GC. TO COORDINATE WITH VENDOR ALL ELECTRICA AND STRUCTURAL REQUIREMENTS PRIOR TO INSTALLATION.

COATS OF TEXPREP PRIMER LET DRY; APPLY COLOR COAT.

31 EXISTING TRELLIS STRUCTURE, GC TO PAINT BLACK AS SCHEDULED 2 CONCRETE PLASTER FINISH APPLIED OVER EXISTING WALL FINISH; GC TO SCRAPE ALL HIGH POINTS, V-GROVE ALL CRACKS IN THE OLD BROWN COAT, CLEAN AND COVER WITH 4.5-OUNCE DETAIL FIBER MESH EMBEDDED IN ACRYLIC MODIFIED CEMENT, ORTEX OR EIFS BASECOAT; LEVEL ALL LOW POINTS WITH ACRYLIC MODIFIED CEMENT, ORTEX OR EIFS BASECOAT; EMBED A FULL 4.5-OUNCE EIFS FIBER MESH IN THE BASECOAT OVER THE WHOLE SURFACE; APPLY 2

- EXISTING CORNICE TO REMAIN

REQUIRED, PAINT SPEC TBD

 EXISTING EXTERIOR WALL TO REMAIN, VERIFY CONSTRUCTION

ASSEMBLY IN FIELD , TYP.

U/S DECK 27'-3" AFF (VIF)

GC TO PATCH, REPAIR AND REPAINT AS

1 Iululemon 1818 CORNWALL AVE. VANCOUVER, B.C., V6J1C7

> **ABQ UPTOWN** 2260 Q STREET, SPACE #02E

ALBUQUERQUE, NM 87110

ARCHITECT

🛕 🔼 |kenneth**park**

MEP ENGINEER

STRUCTURAL ENGINEER

HESE DRAWINGS AND SPECIFICATIONS ARE THE PROPERTY AND ON ANY OTHER WORK EXCEPT BY WRITTEN AGREEMENT WITH ARCHITE

LICENSED NAME, ARCHITECT

ARCHITECT: KENNETH PARK, AIA I HEREBY CERTIFY THAT THIS DRAWING WAS PREPARED BY ME OR UNDER MY DIRECT SUPERVISION AND THAT I AM A DULY REGISTERED/LICENSED ARCHITECT UNDER THE LAWS OF THE STATE OF NEW MEXICO

ARCHITECTURAL REG. #2896 REGISTRATION EXPIRES: 12/31/2024

BID/PERMIT SET

03/17/2023

△ DATE DESCRIPTION 01/23/2023 DD SET 02/24/2023 CD SET


03/17/2023 BID/PERMIT SET


DRAWING INFORMATION PROJECT #: 22-111 CHECKED BY: SL

DRAWN BY: KY

STOREFRONT SECTIONS

DRAWING NUMBER A-420

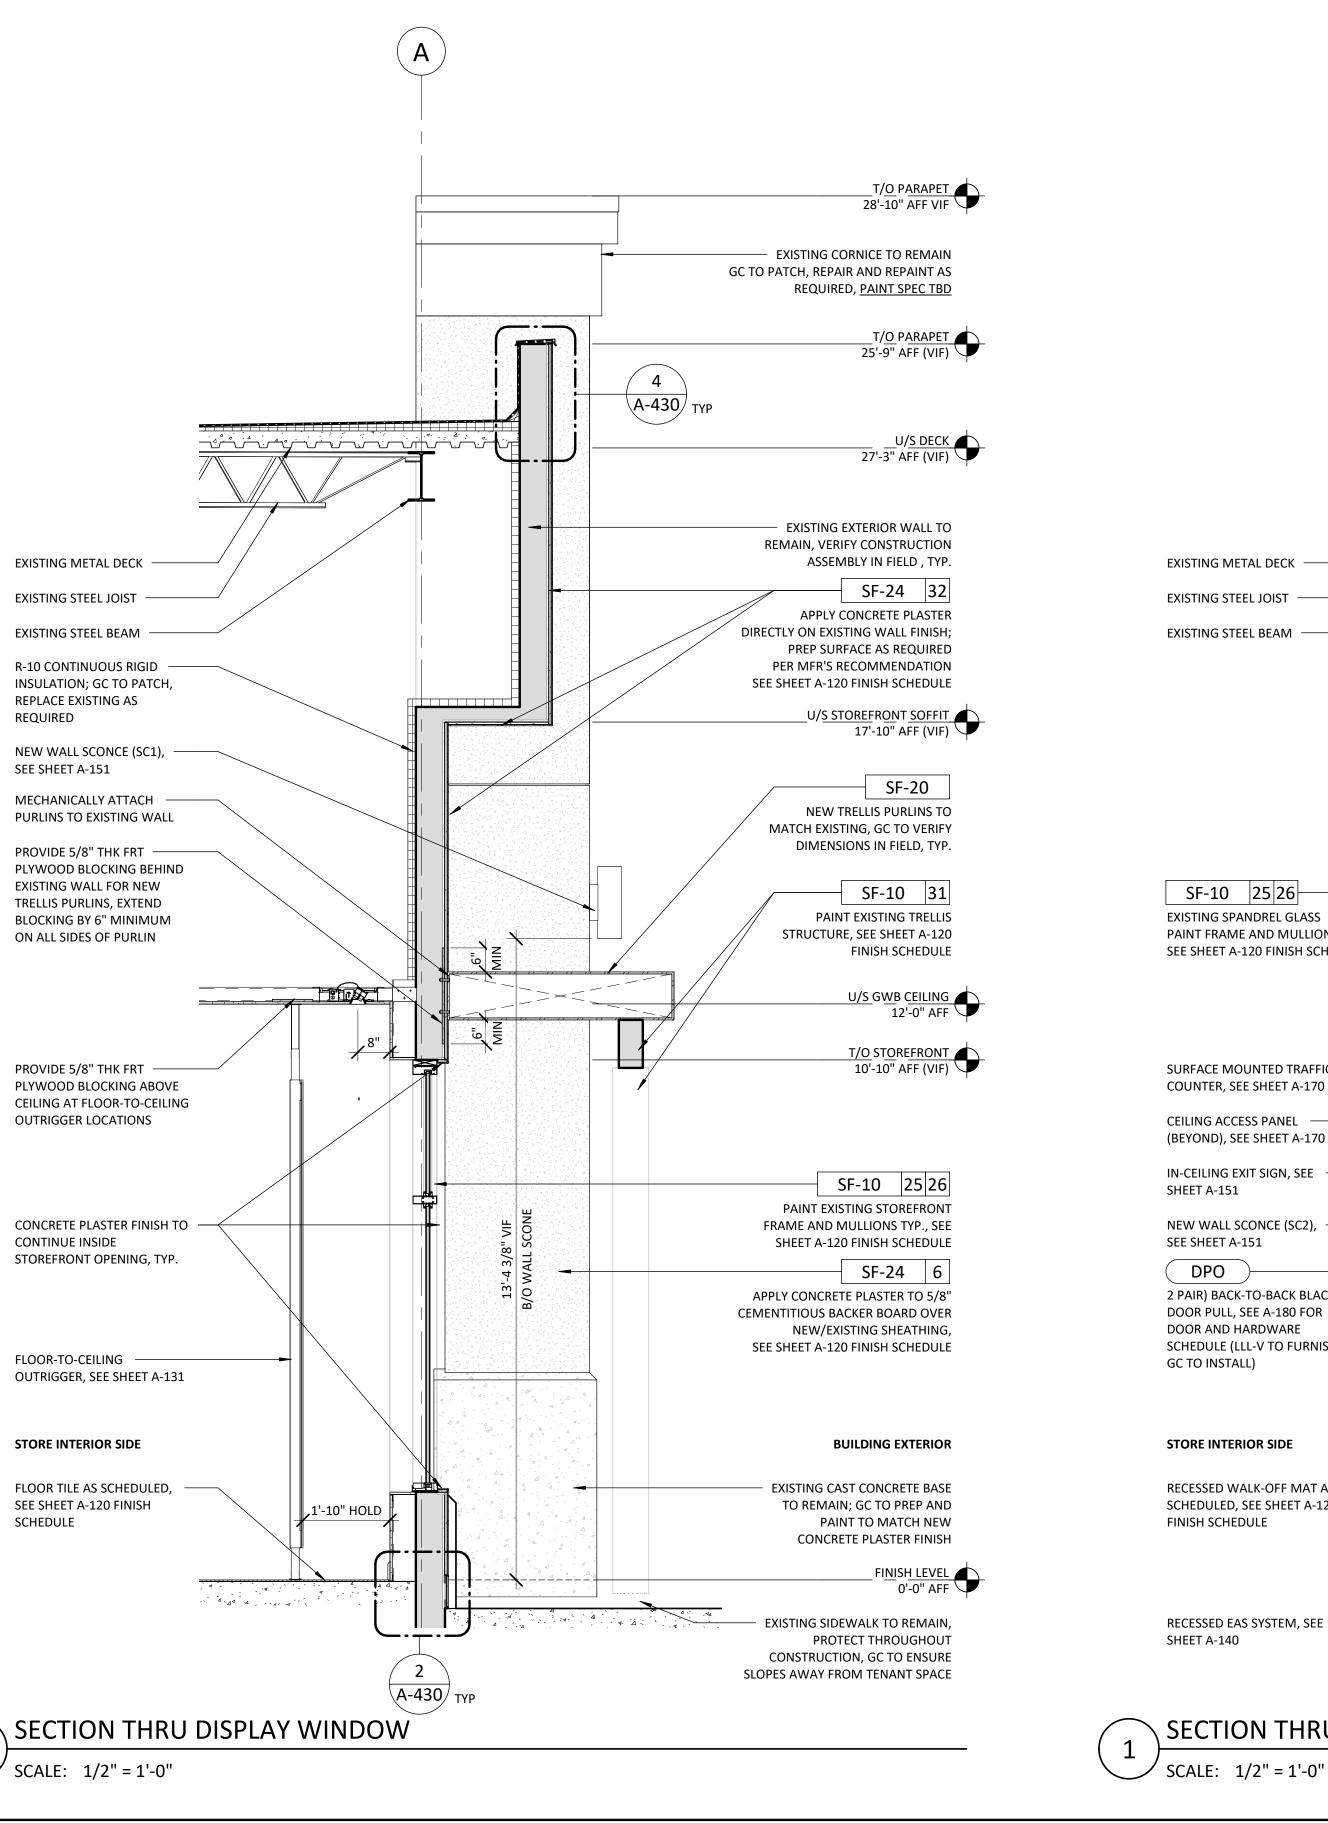

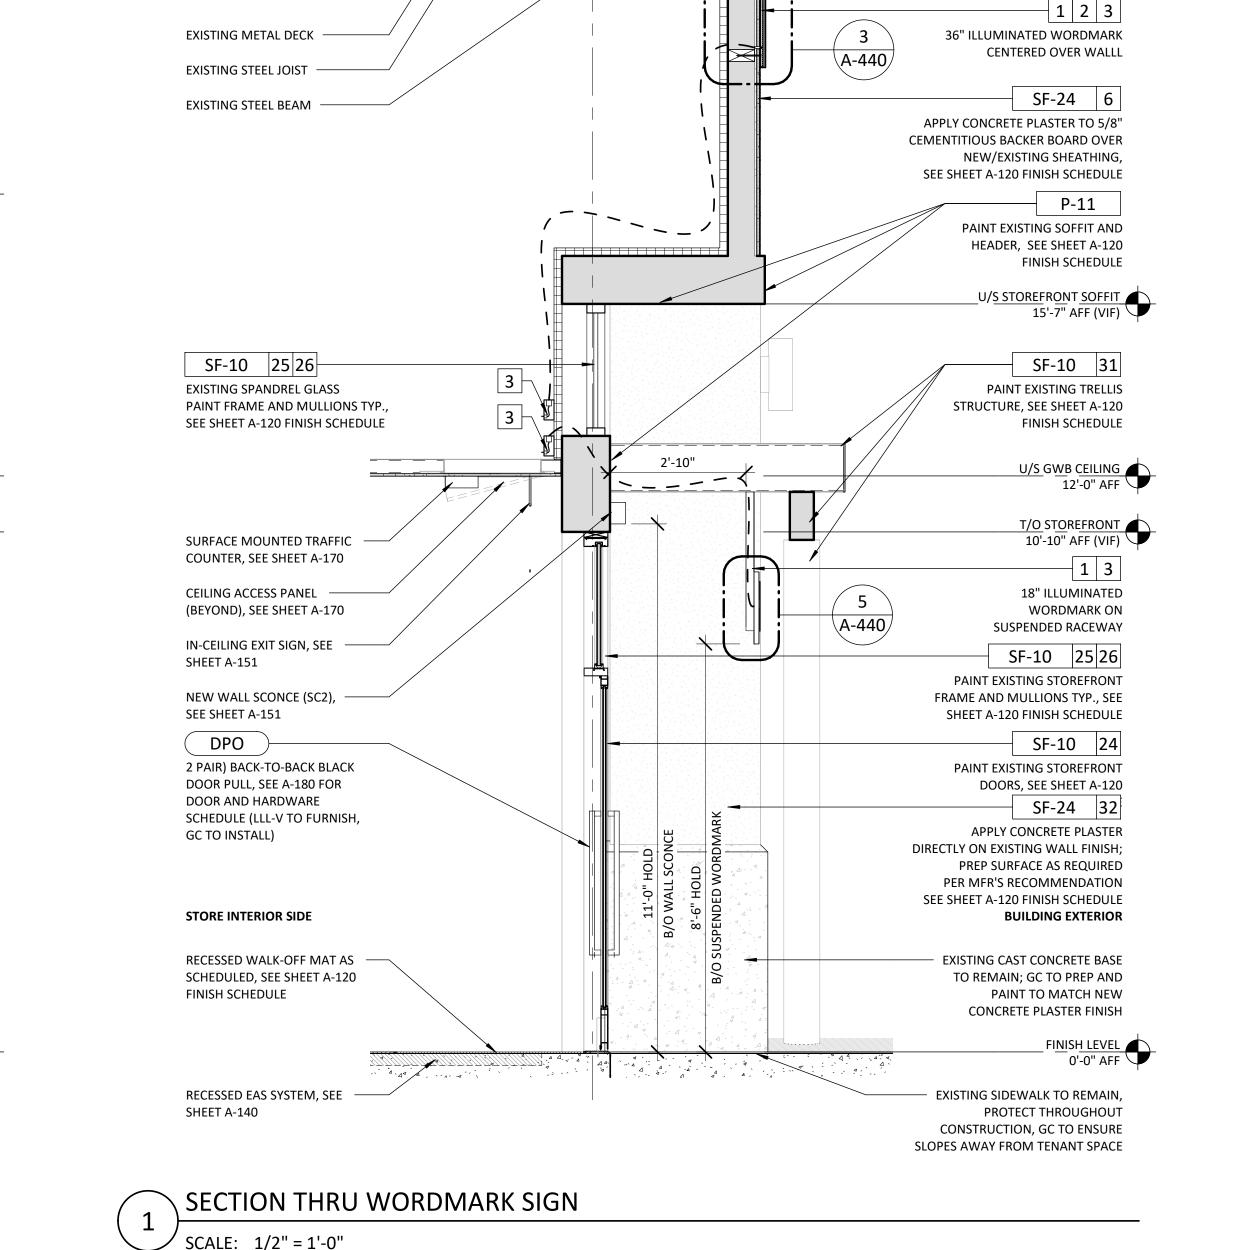

A-440

·—·—·—·~

T/O PARAPET
25'-9" AFF (VIF)

_____U/S DECK 27'-3" AFF (VIF)

EXISTING EXTERIOR WALL TO

ASSEMBLY IN FIELD , TYP.

APPLY CONCRETE PLASTER

NEW TRELLIS PURLINS TO

DIMENSIONS IN FIELD, TYP.

MATCH EXISTING, GC TO VERIFY

PREP SURFACE AS REQUIRED

PER MFR'S RECOMMENDATION

SEE SHEET A-120 FINISH SCHEDULE

DIRECTLY ON EXISTING WALL FINISH;

SF-24 32

SF-20

SF-10 31

FINISH SCHEDULE

T/O STOREFRONT
10'-10" AFF (VIF)

U/S ACT CEILING 10'-0" AFF

1 2 3

TOWARDS STORE

SF-24 6

BUILDING EXTERIOR

SF-25 27

SF-26 28

FINISH LEVEL 0'-0" AFF

12"X38" ILLUMINATED CABINET

SIGN, YOGO AND WORDMARK ON

SIDE FACING AWAY FROM STORE;

APPLY CONCRETE PLASTER TO 5/8"

SEE SHEET A-120 FINISH SCHEDULE

NEW/EXISTING SHEATHING,

CEMENTITIOUS BACKER BOARD OVER

YOGO ONLY ON SIDE FACING

PAINT EXISTING TRELLIS

STRUCTURE, SEE SHEET A-120

REMAIN, VERIFY CONSTRUCTION

SECTION THRU CABINET SIGN

EXISTING METAL DECK -

EXISTING STEEL JOIST -

EXISTING STEEL BEAM -

R-10 CONTINUOUS RIGID

REPLACE EXISTING AS

REQUIRED

INSULATION; GC TO PATCH,

ACT CEILING AS SCHEDULED,


SEE SHEET A-160

STORE INTERIOR SIDE

FLOOR TILE AS SCHEDULED,

SEE SHEET A-120 FINISH


SCHEDULE

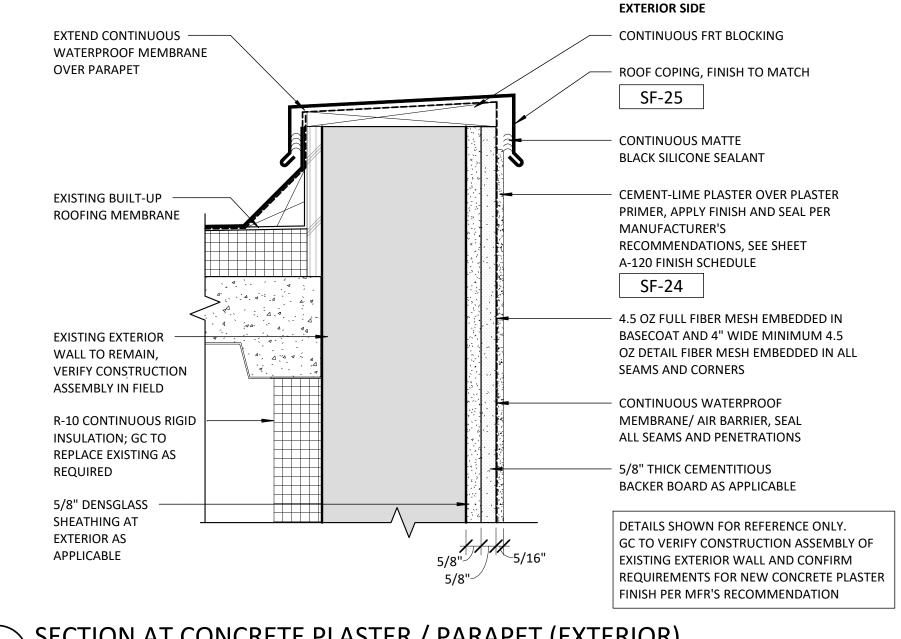

SECTION AT CONCRETE PLASTER / PARAPET (EXTERIOR)

5/8"\ 4.5 OZ FULL FIBER MESH EMBEDDED IN BASECOAT AND 4" WIDE MINIMUM 4.5 OZ DETAIL FIBER MESH EMBEDDED IN ALL SEAMS AND CORNERS R-10 CONTINUOUS RIGID INSULATION; GC TO REPLACE EXISTING AS - 5/8" THICK CEMENTITIOUS REQUIRED BACKER BOARD AS APPLICABLE CONCRETE PLASTER FINISH, SEE SHEET FRY REGLET VENEER A-120 FINISH SCHEDULE PLASTER REVEAL VPR SF-24 375-375, COLOR TO MATCH ADJACENT PLASTER FINISH **EXTERIOR SIDE** EXISTING EXTERIOR WALL TO REMAIN, VERIFY CONSTRUCTION ASSEMBLY FRT WOOD SHIM REMOVABLE FORMWORK 5/8" DENSGLASS STRIP, SEE PLASTER SHEATHING AT EXTERIOR SPECIFICATIONS FOR AS APPLICABLE MORE INFORMATION ABOUT INSTALLATION CONTINUOUS WATERPROOF MEMBRANE/ AIR BARRIER, SEAL ALL SEAMS AND PENETRATIONS DETAILS SHOWN FOR REFERENCE ONLY. GC TO VERIFY CONSTRUCTION ASSEMBLY OF EXISTING EXTERIOR WALL AND CONFIRM ARE MICRORADIUSED REQUIREMENTS FOR NEW CONCRETE PLASTER FINISH PER MFR'S RECOMMENDATION

\ SECTION AT CONCRETE PLASTER HORIZONTAL SEAM (EXTERIOR)

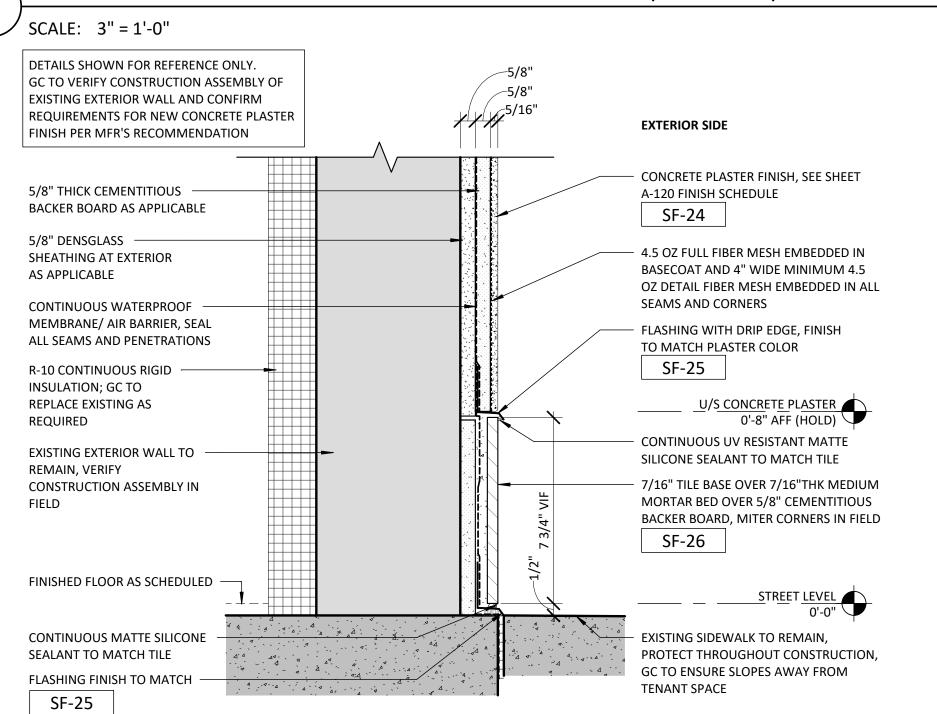

SECTION AT CONCRETE PLASTER / CONCRETE CURB (EXTERIOR) / SCALE: 3" = 1'-0"

T/O PARAPET
25'-9" AFF (VIF) _____U/S DECK 27'-3" AFF (VIF) - EXISTING EXTERIOR WALL TO REMAIN, VERIFY CONSTRUCTION ASSEMBLY IN FIELD , TYP. SF-24 32 APPLY CONCRETE PLASTER R-10 CONTINUOUS RIGID DIRECTLY ON EXISTING WALL FINISH; INSULATION; GC TO PATCH, PREP SURFACE AS REQUIRED REPLACE EXISTING AS PER MFR'S RECOMMENDATION REQUIRED SEE SHEET A-120 FINISH SCHEDULE SF-10 31 PAINT EXISTING TRELLIS STRUCTURE, SEE SHEET A-120 FINISH SCHEDULE T/O STOREFRONT
10'-10" AFF (VIF) U/S ACT CEILING 10'-0" AFF CEILING ACCESS PANEL, SEE SHEET A-170 -----1 2 3 12"X38" ILLUMINATED CABINET SIGN, YOGO AND WORDMARK ON SIDE FACING AWAY FROM STORE; YOGO ONLY ON SIDE FACING **TOWARDS STORE** SF-24 6 APPLY CONCRETE PLASTER TO 5/8" CEMENTITIOUS BACKER BOARD OVER NEW/EXISTING SHEATHING, SEE SHEET A-120 FINISH SCHEDULE STORE INTERIOR SIDE **BUILDING EXTERIOR** SF-25 27 FLOOR TILE AS SCHEDULED, SEE SHEET A-120 FINISH SF-26 28 SCHEDULE FINISH LEVEL 0'-0" AFF

A-430 _{TYP}

444

SECTION THRU CABINET SIGN


SCALE: 1/2" = 1'-0"

1 Iululemon 1818 CORNWALL AVE. VANCOUVER, B.C., V6J1C7

ABQ UPTOWN 2260 Q STREET, SPACE #02E ALBUQUERQUE, NM 87110

ARCHITECT



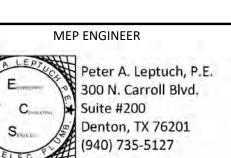

STRUCTURAL ENGINEER

THESE DRAWINGS AND SPECIFICATIONS ARE THE PROPERTY AND COPYRIGHT OF ARCHITECT AND SHALL NOT BE USED ON ANY OTHER WORK EXCEPT BY WRITTEN AGREEMENT WITH ARCHITEC

LICENSED NAME, ARCHITECT

ARCHITECT: KENNETH PARK, AIA I HEREBY CERTIFY THAT THIS DRAWING WAS PREPARED BY ME OR UNDER MY DIRECT SUPERVISION AND THAT I AM A DULY REGISTERED/LICENSED ARCHITECT UNDER THE LAWS OF THE STATE OF NEW MEXICO

ARCHITECTURAL REG. #2896 REGISTRATION EXPIRES: 12/31/2024

BID/PERMIT SET

03/17/2023

△ DATE DESCRIPTION

01/23/2023 DD SET 02/24/2023 CD SET 03/17/2023 BID/PERMIT SET

DRAWING INFORMATION PROJECT #: 22-111 CHECKED BY: SL

DRAWN BY: KY

EXISTING SIDEWALK TO REMAIN,

CONSTRUCTION, GC TO ENSURE


SLOPES AWAY FROM TENANT SPACE

PROTECT THROUGHOUT

STOREFRONT

SECTIONS AND DETAILS

A-430

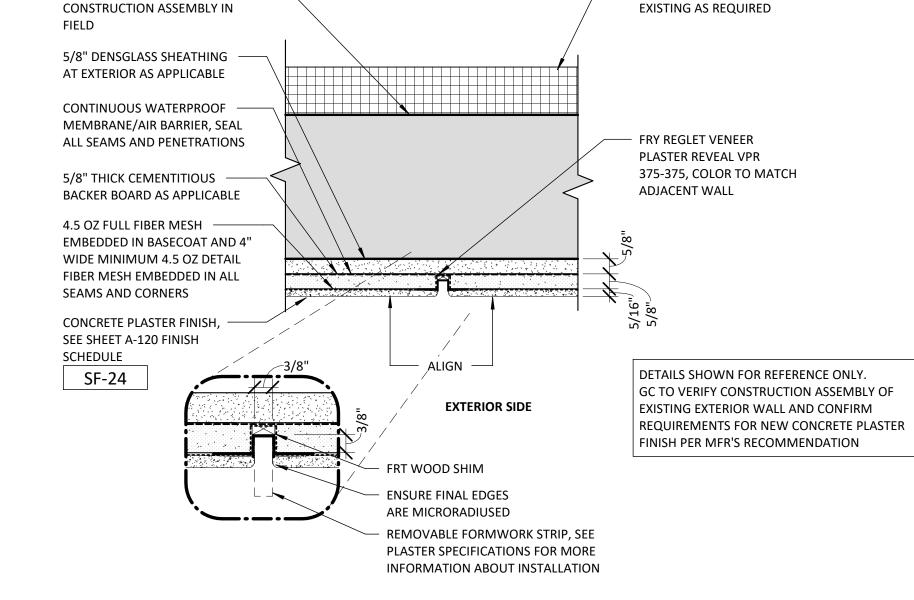


R-10 CONTINUOUS RIGID

INSULATION; GC TO REPLACE



EXISTING EXTERIOR WALL TO ——

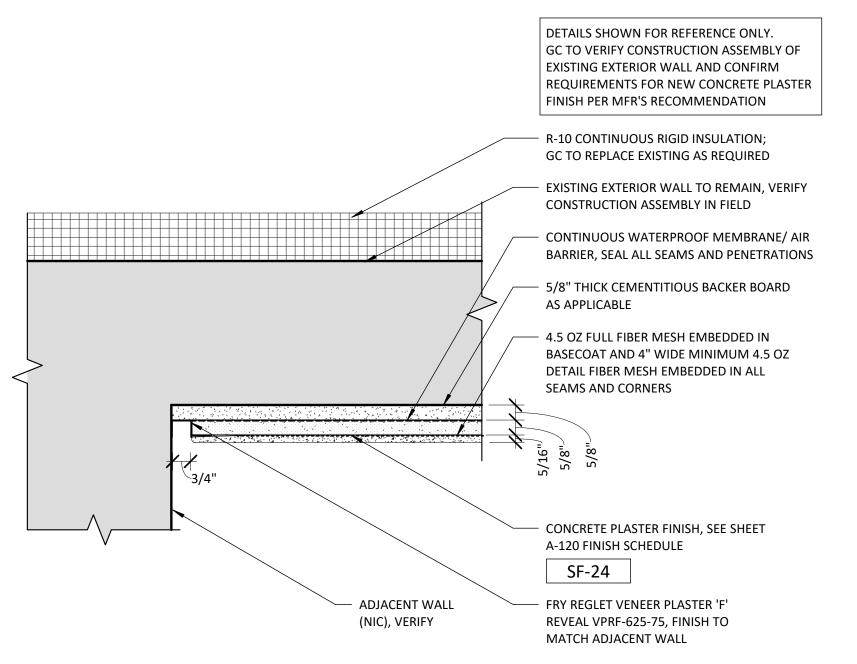

→ PLAN AT CONCRETE PLASTER / NEUTRAL PIER (EXTERIOR)

SCALE: 3" = 1'-0"