



electrify america

LECTRIFY AMERICA, LI 2003 EDMUND HALLEY

SUITE 200 RESTON, VA 2019


2022 KIMLEY-HORN A

ASSOCIATES, INC.

SUITE 1500 DENVER, CO 80237

303-288-2300

PROJECT NUMBER: NM240036 INSTALLATION OF ELECTRIC VEHICLES CHARGING EQUIPMENT KROGER SMITHS 443 320 YALE BLVD SE, ALBUQUERQUE, NM 87106

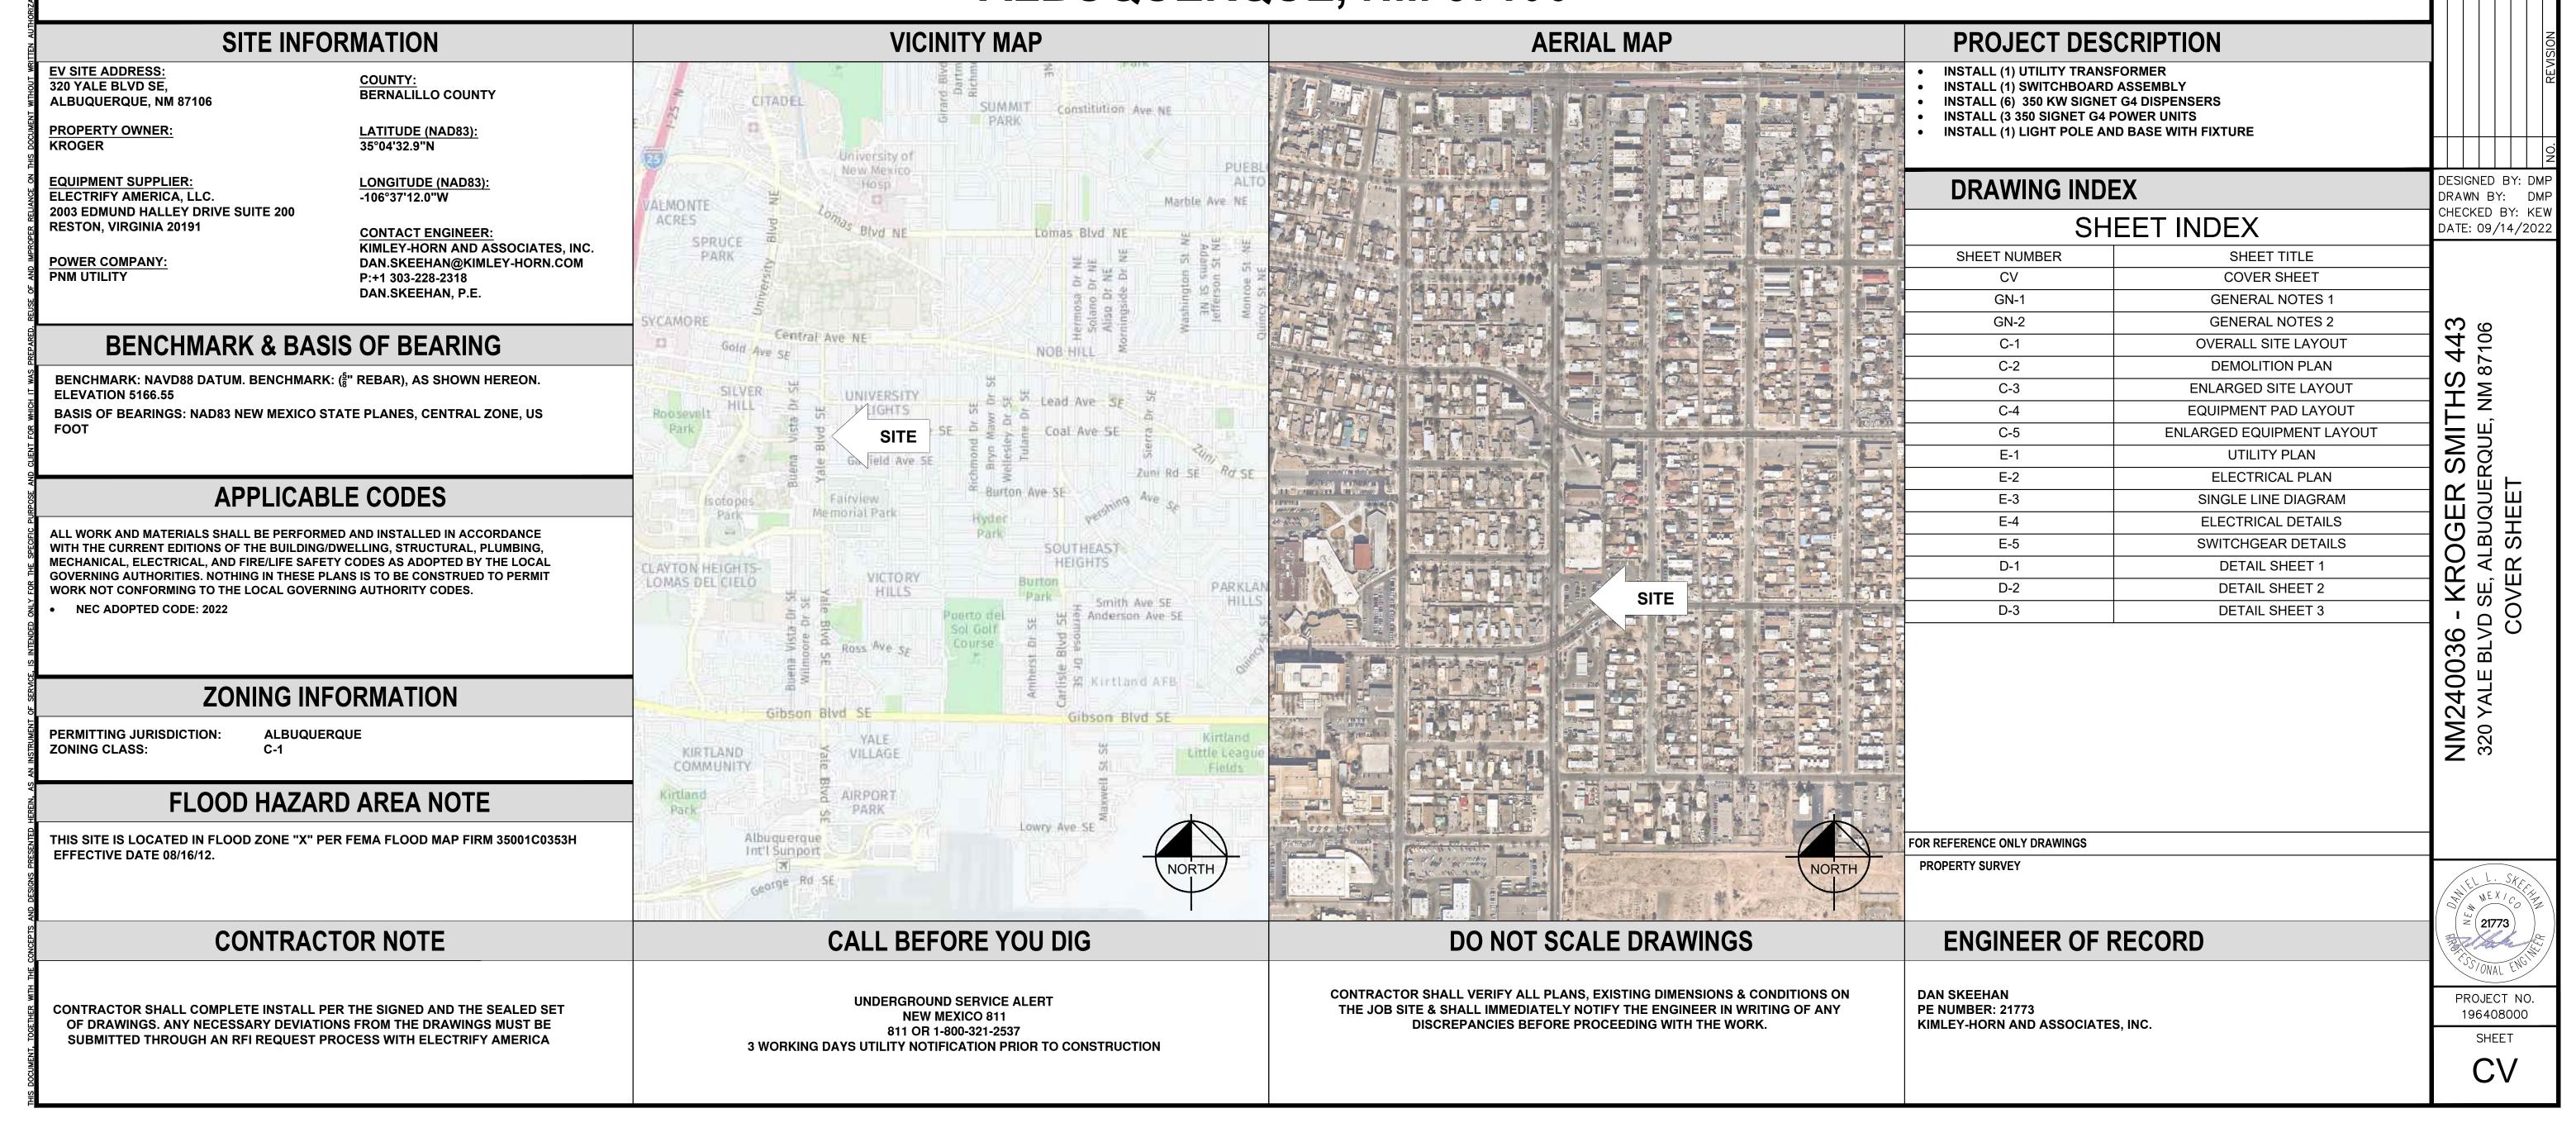

GENERAL CONSTRUCTION NOTES

- FOR THE PURPOSE OF CONSTRUCTION DRAWINGS, THE FOLLOWING DEFINITIONS SHALL APPLY GENERAL CONTRACTOR: POWERHOUSE CONSTRUCTION **OWNER: ELECTRIFY AMERICA**
- ALL SITE WORK SHALL BE COMPLETED AS INDICATED ON THE DRAWINGS.
- ALL MATERIALS FURNISHED AND INSTALLED SHALL BE IN STRICT ACCORDANCE WITH ALL APPLICABLE CODES, REGULATIONS, AND ORDINANCES. GENERAL CONTRACTOR SHALL ISSUE ALL APPROPRIATE NOTICES AND COMPLY WITH ALL LAWS, ORDINANCES, RULES, REGULATIONS, AND LAWFUL ORDERS OF ANY PUBLIC **AUTHORITY REGARDING THE PERFORMANCE OF WORK.**
- ALL WORK CARRIED OUT SHALL COMPLY WITH ALL APPLICABLE MUNICIPAL AND UTILITY COMPANY SPECIFICATIONS AND LOCAL JURISDICTIONAL CODES, ORDINANCES, AND APPLICABLE REGULATIONS.
- PLANS ARE NOT TO BE SCALED. THESE PLANS ARE INTENDED TO BE A DIAGRAMMATIC OUTLINE ONLY UNLESS OTHERWISE NOTED. DIMENSIONS SHOWN ARE TO FINISH SURFACES UNLESS OTHERWISE NOTED. SPACING BETWEEN EQUIPMENT IS THE MINIMUM REQUIRED CLEARANCE. THEREFORE, IT IS CRITICAL TO FIELD VERIFY DIMENSIONS, SHOULD THERE BE ANY QUESTIONS REGARDING THE CONTRACT DOCUMENTS, THE CONTRACTOR SHALL BE RESPONSIBLE FOR OBTAINING A CLARIFICATION FROM THE ENGINEER PRIOR TO PROCEEDING WITH THE WORK. DETAILS ARE INTENDED TO SHOW DESIGN INTENT. MODIFICATIONS MAY BE REQUIRED TO SUIT JOB DIMENSIONS OR CONDITIONS AND SUCH MODIFICATIONS SHALL BE INCLUDED AS PART OF WORK AND PREPARED BY THE ENGINEER PRIOR TO PROCEEDING WITH WORK.
- WORK PREVIOUSLY COMPLETED IS REPRESENTED BY LIGHT SHADED LINES AND NOTES. THE SCOPE OF WORK FOR THIS PROJECT IS REPRESENTED BY DARK SHADED LINES AND NOTES. CONTRACTOR SHALL NOTIFY THE GENERAL CONTRACTOR OF ANY EXISTING CONDITIONS THAT DEVIATE FROM THE DRAWINGS PRIOR TO BEGINNING CONSTRUCTION.
- THE CONTRACTOR SHALL PROVIDE WRITTEN NOTICE TO THE CONSTRUCTION MANAGER 48 HOURS PRIOR TO COMMENCEMENT OF WORK.
- THE CONTRACTOR SHALL CONTACT UTILITY LOCATING SERVICES PRIOR TO THE START OF CONSTRUCTION.
- THE GENERAL CONTRACTOR SHALL MAINTAIN IN GOOD CONDITION ONE COMPLETE SET OF PLANS WITH ALL REVISIONS, ADDENDA, AND CHANGE ORDERS ON THE PREMISES AT ALL TIMES.
- THE CONTRACTOR SHALL PROVIDE PORTABLE FIRE EXTINGUISHERS WITH A RATING OF NOT LESS THAN 2-A:10-B:C AND SHALL BE WITHIN 25 FEET OF TRAVEL DISTANCE TO ALL PORTIONS OF WHERE THE WORK IS BEING COMPLETED DURING CONSTRUCTION
- 10. ALL EXISTING ACTIVE SEWER, WATER, GAS, ELECTRIC, AND OTHER UTILITIES SHALL BE PROTECTED AT ALL TIMES. AND WHERE REQUIRED FOR THE PROPER EXECUTION OF THE WORK. SHALL BE RELOCATED AS DIRECTED BY THE ENGINEER. EXTREME CAUTION SHOULD BE USED BY THE CONTRACTOR WHEN EXCAVATING OR DRILLING PIERS AROUND OR NEAR UTILITIES. THE CONTRACTOR SHALL PROVIDE SAFETY TRAINING FOR THE WORKING CREW. THIS SHALL INCLUDE BUT NOT BE LIMITED TO A) FALL PROTECTION, B) CONFINED SPACE, C) ELECTRICAL SAFETY, AND D) TRENCHING & EXCAVATION.
- 11. ALL EXISTING INACTIVE SEWER, WATER, GAS, ELECTRIC, AND OTHER UTILITIES, WHICH INTERFERE WITH THE EXECUTION OF THE WORK, SHALL BE REMOVED, CAPPED, PLUGGED OR OTHERWISE DISCONNECTED AT POINTS WHICH WILL NOT INTERFERE WITH THE EXECUTION OF THE WORK, AS DIRECTED BY THE ENGINEER. AND SUBJECT TO THE APPROVAL OF THE OWNER AND/OR LOCAL UTILITIES.
- 12. THE AREAS OF THE OWNER'S PROPERTY DISTURBED BY THE WORK AND NOT COVERED BY THE EQUIPMENT OR DRIVEWAY. SHALL BE GRADED TO A UNIFORM SLOPE. AND STABILIZED TO PREVENT EROSION.
- 13. CONTRACTOR SHALL MINIMIZE DISTURBANCE TO THE EXISTING SITE DURING CONSTRUCTION. EROSION CONTROL MEASURES, IF REQUIRED DURING CONSTRUCTION, SHALL BE IN CONFORMANCE WITH THE FEDERAL AND LOCAL JURISDICTION FOR EROSION AND SEDIMENT CONTROL.
- 14. NO FILL OR EMBANKMENT MATERIAL SHALL BE PLACED ON FROZEN GROUND. FROZEN MATERIALS, SNOW OR ICE SHALL NOT BE PLACED IN ANY FILL OR EMBANKMENT.
- 15. THE SUBGRADE SHALL BE BROUGHT TO A SMOOTH UNIFORM GRADE AND COMPACTED TO 95 PERCENT STANDARD PROCTOR DENSITY UNDER PAVEMENT AND STRUCTURES AND 80 PERCENT STANDARD PROCTOR DENSITY IN OPEN SPACE. ALL TRENCHES IN PUBLIC RIGHT OF WAY SHALL BE BACKFILLED WITH FLOWABLE FILL OR OTHER MATERIAL PRE-APPROVED BY THE LOCAL JURISDICTION.
- 16. ALL BROCHURES, OPERATING AND MAINTENANCE MANUALS, CATALOGS, SHOP DRAWINGS, AND OTHER DOCUMENTS SHALL BE TURNED OVER TO THE GENERAL CONTRACTOR AT COMPLETION OF CONSTRUCTION AND PRIOR TO PAYMENT.
- 17. THE CONTRACTOR SHALL SUBMIT A COMPLETE SET OF AS-BUILT REDLINES TO THE GENERAL CONTRACTOR UPON COMPLETION OF PROJECT AND PRIOR TO FINAL PAYMENT.
- 18. INFORMATION SHOWN ON THESE DRAWINGS WAS OBTAINED FROM SITE VISITS AND/OR DRAWINGS PROVIDED BY THE SITE OWNER. CONTRACTORS SHALL NOTIFY THE ENGINEER OF ANY DISCREPANCIES PRIOR TO ORDERING MATERIAL OR PROCEEDING WITH CONSTRUCTION.

ELECTRICAL NOTES

- 1. ANY/ALL CONSTRUCTION SHALL BE IN ACCORDANCE WITH DRAWINGS AND ANY/ALL APPLICABLE SPECIFICATIONS. IF ANY PROBLEMS ARE ENCOUNTERED BY COMPLYING WITH THESE REQUIREMENTS, CONTRACTOR SHALL NOTIFY 'CONSTRUCTION MANAGER' AS SOON AS POSSIBLE, AFTER THE DISCOVERY OF THE PROBLEMS, AND SHALL NOT PROCEED WITH THAT PORTION OF WORK, UNTIL THE 'CONSTRUCTION MANAGER' HAS DIRECTED THE CORRECTIVE ACTIONS TO BE TAKEN
- ALL WORK SHALL BE PERFORMED IN ACCORDANCE WITH THE LATEST ADOPTED EDITION OF THE NEC AND ALL CODES AND LOCAL ORDINANCES OF THE LOCAL POWER COMPANIES HAVING JURISDICTION AND SHALL **INCLUDE BUT NOT BE LIMITED TO:**
- **UL UNDERWRITERS LABORATORIES**
- **NEC NATIONAL ELECTRICAL CODE 2022**
- **NEMA NATIONAL ELECTRICAL MANUFACTURERS ASSOC.**
- OSHA OCCUPATIONAL SAFETY AND HEALTH ACT
- SBC STANDARD BUILDING CODE
- NFPA NATIONAL FIRE PROTECTION ASSOCIATION
- DO NOT SCALE ELECTRICAL DRAWINGS, REFER TO SITE PLANS AND ELEVATIONS FOR EXACT LOCATIONS OF ALL EQUIPMENT, BUT CONFIRM WITH 'CONSTRUCTION MANAGER' ANY SIZES AND LOCATIONS WHEN NEEDED.
- 5. EXISTING SERVICES: THE CONTRACTOR SHALL NOT INTERRUPT EXISTING SERVICES WITHOUT WRITTEN PERMISSION OF THE OWNER.
- 6. THE CONTRACTOR SHALL PAY FOR ANY/ALL PERMITS, FEES, INSPECTIONS AND TESTING. THE CONTRACTOR IS TO OBTAIN PERMITS AND APPROVED SUBMITTALS PRIOR TO THE WORK BEGINNING OR ORDERING THE **EQUIPMENT.**
- 7. THE CONTRACTOR SHALL CONFIRM WITH LOCAL UTILITY COMPANY ANY/ALL REQUIREMENTS SUCH AS THE: LUG SIZE RESTRICTIONS, CONDUIT ENTRY, SIZE OF TRANSFORMERS, SCHEDULED DOWNTIME FOR THE OWNERS' CONFIRMATION, ETC. ANY/ALL CONFLICTS SHALL BE BROUGHT TO THE ATTENTION OF THE CONSTRUCTION MANAGER, PRIOR TO BEGINNING ANY WORK.
- 8. CONDUCTORS: CONTRACTOR SHALL USE 98% CONDUCTIVITY COPPER OR ALUMINUM WITH TYPE (THWN-2) INSULATION, 600 VOLT, COLOR CODED UNLESS SPECIFIED DIFFERENTLY ON DRAWINGS
- 9. ALL (THWN-2) WIRING INSTALLATIONS TO FOLLOW MANUFACTURER'S INSTRUCTIONS AND RECOMMENDATIONS.
- 10. OUTLET BOXES SHALL BE PRESSED STEEL IN DRY LOCATIONS, CAST ALLOY WITH THREADED HUBS IN WET/DAMP LOCATIONS AND SPECIAL ENCLOSURES FOR OTHER CLASSIFIED AREAS.
- 11. ALL WORK SHALL BE PERFORMED BY A LICENSED ELECTRICAL CONTRACTOR IN A FIRST CLASS, WORKMANLIKE MANNER. THE COMPLETED SYSTEM SHALL BE FULLY OPERATIONAL AND SUBJECT TO REGULATORY INSPECTION AND APPROVAL BY CONSTRUCTION MANAGER
- 12. MATERIALS, PRODUCTS AND EQUIPMENT, INCLUDING ALL COMPONENTS THEREOF, SHALL BE NEW AND SHALL APPEAR ON THE LIST OF U.L. APPROVED ITEMS AND SHALL MEET OR EXCEED THE REQUIREMENTS OF THE NEC, **NEMA AND IEEE.**
- 13. CONTRACTOR SHALL SUBMIT SHOP DRAWINGS OR MANUFACTURERS CATALOG INFORMATION OF ANY/ALL LIGHTING FIXTURES, SWITCHES AND ALL OTHER ELECTRICAL ITEMS FOR APPROVAL BY THE CONSTRUCTION MANAGER PRIOR TO INSTALLATION.
- 14. THE ELECTRICAL CONTRACTOR SHALL LABEL ALL PANELS WITH ONLY TYPEWRITTEN DIRECTORIES.
- 15. DISCONNECT SWITCHES SHALL BE H.P. RATED HEAVY-DUTY, QUICK-MAKE AND QUICK-BREAK ENCLOSURES, AS REQUIRED BY EXPOSURE TYPE.
- 16. ALL CONNECTIONS EXCEPT THE EV CHARGE CABLE TERMINATION IN THE CHARGE POST SHALL BE MADE WITH A PROTECTIVE COATING OF AN ANTI-OXIDE COMPOUND SUCH AS "NOALOX" BY IDEAL INDUSTRIAL INC., COAT ALL WIRE SURFACES BEFORE CONNECTING. EXPOSED ALUMINUM & COPPER SURFACES, INCLUDING GROUND BARS, SHALL BE TREATED - NO SUBSTITUTIONS.
- 17. ALL EXTERIOR AND INTERIOR ABOVE GROUND CONDUIT SHALL BE RIGID UNLESS SPECIFIED OTHERWISE. ALL BURIED CONDUITS SHALL BE SCH 40 PVC UNLESS SPECIFIED OTHERWISE.
- 18. RACEWAYS: CONDUIT SHALL BE SCHEDULE 40 PVC, MEETING OR EXCEEDING NEMA TC2 1990. THE CONTRACTOR SHALL PLUG AND CAP EACH END OF SPARE AND EMPTY CONDUITS AND PROVIDE TWO SEPARATE PULL STRINGS - 200 LBS TEST POLYETHYLENE CORD. ALL CONDUIT BENDS SHALL BE A MINIMUM OF 3 FT. RADIUS. RGS CONDUITS WHEN SPECIFIED, SHALL MEET UL-6 FOR GALVANIZED STEEL. ALL FITTINGS SHALL BE SUITABLE FOR USE WITH THREADED RIGID CONDUIT. COAT ALL THREADS WITH 'BRITE ZINC' OR 'GOLD GALV'.
- 19. SUPPORT OF ALL ELECTRICAL WORK SHALL BE AS REQUIRED BY NEC.
- 20. CONNECTORS FOR POWER CONDUCTORS: CONTRACTOR SHALL USE PRESSURE TYPE INSULATED TWIST-ON CONNECTORS FOR NO. 10 AWG AND SMALLER. USE SOLDERLESS MECHANICAL TERMINAL LUGS FOR NO. 8 AWG AND LARGER.
- 21. THE CONTRACTOR SHALL PLACE TWO LENGTHS OF WARNING TAPE AT A DEPTH OF 12" BELOW GROUND AND DIRECTLY ABOVE ELECTRICAL SERVICE CONDUITS. CAUTION TAPE TO READ "CAUTION BURIED ELECTRIC".
- 22. WHEN DIRECTIONAL BORING IS REQUIRED, CONTRACTOR SHALL INSTALL A LOOSE TONING WIRE WITHIN INSTALLED CONDUIT TO ALLOW FOR IDENTIFICATION OF UNDERGROUND CONDUITS.
- 23. ALL BOLTS SHALL BE STAINLESS STEEL.

GENERAL SITE WORK NOTES

PART 1 - GENERAL

CLEARING, GRUBBING, STRIPPING, EROSION CONTROL, SURVEY, LAYOUT, SUBGRADE PREPARATION AND FINISH GRADING AS REQUIRED TO COMPLETE THE PROPOSED WORK SHOWN IN THESE PLANS. 1. REFERENCES:

- A. NMDOT (STATE DEPARTMENT OF TRANSPORTATION STANDARD SPECIFICATIONS FOR HIGHWAY CONSTRUCTION-CURRENT EDITION).
- B. ASTM (AMERICAN SOCIETY FOR TESTING AND MATERIALS).
- C. OSHA (OCCUPATION SAFETY AND HEALTH ADMINISTRATION).

2. INSPECTION AND TESTING:

A. GENERAL CONTRACTOR SHALL PERFORM ALL WORK IN CONFORMANCE WITH THE PLANS AND SPECIFICATIONS. PERFORM INSPECTIONS BEFORE CONCEALING WORK WITH FOLLOW-ON **ACTIVITIES (BACKFILL, CONCRETE POUR, ETC).**

3. SITE MAINTENANCE AND PROTECTION:

- A. PROVIDE ALL NECESSARY JOB SITE MAINTENANCE FROM COMMENCEMENT OF WORK UNTIL COMPLETION OF THE CONTRACT.
- B. AVOID DAMAGE TO THE SITE AND TO EXISTING FACILITIES, STRUCTURES, TREES, AND SHRUBS DESIGNATED TO REMAIN. TAKE PROTECTIVE MEASURES TO PREVENT EXISTING FACILITIES THAT ARE NOT DESIGNATED FOR REMOVAL FROM BEING DAMAGED BY THE WORK.
- C. KEEP SITE FREE OF ALL PONDING WATER.
- D. PROVIDE EROSION CONTROL MEASURES IN ACCORDANCE WITH STATE DOT, LOCAL PERMITTING AGENCY AND EPA REQUIREMENTS.
- E. PROVIDE AND MAINTAIN ALL TEMPORARY FENCING, BARRICADES, WARNING SIGNALS AND SIMILAR DEVICES NECESSARY TO PROTECT AGAINST THEFT FROM PROPERTY DURING THE ENTIRE PERIOD OF CONSTRUCTION. REMOVE ALL SUCH DEVICES UPON COMPLETION OF THE WORK.
- F. EXISTING UTILITIES: DO NOT INTERRUPT EXISTING UTILITIES SERVING FACILITIES OCCUPIED BY CHECKED BY: KEW THE OWNER OR OTHERS, EXCEPT WHEN PERMITTED IN WRITING BY THE CONSTRUCTION MANAGER AND THEN ONLY AFTER ACCEPTABLE TEMPORARY UTILITY SERVICES HAVE BEEN PROVIDED.
- G. PROVIDE A MINIMUM 48-HOUR NOTICE TO THE CONSTRUCTION MANAGER AND RECEIVE WRITTEN NOTICE TO PROCEED BEFORE INTERRUPTING ANY UTILITY SERVICE.
- H. SOD PLANTED IN THE FALL MUST ESTABLISH ITS ROOTS BEFORE THE FIRST WINTER FROST DETERMINE WHEN THE FIRST FROST USUALLY OCCURS. AND PLANT THE SOD NO LATER THAN ONE MONTH BEFORE THE FIRST FROST. IF THE CONSTRUCTION IS FINISHED LATER THAN ONE MONTH BEFORE THE FIRST FROST, USE STRAW UNTIL SOD CAN BE INSTALLED.

PART 2 - PRODUCTS

- 1. SUITABLE MATERIAL SUITABLE MATERIAL ARE USED FOR GRADING AND BACKFILL. SUITABLE MATERIALS ARE ON SITE SOILS REMOVED FROM EXCAVATIONS THAT EXCLUDE FROZEN SOIL. ROOTS OR ORGANIC MATERIAL, DEBRIS, TRASH, REFUSE, OR PARTICLES SIZE GREATER THAN 3-INCH. SUITABLE SOILS HAVE MOISTURE CONTENTS THAT ALLOW THEM TO BE COMPACTED TO THE SAME DENSITY AS THE NATIVE SOILS.
- 2. UNSUITABLE MATERIAL SOILS THAT ARE FROZEN, CONTAIN ROOTS OR ORGANIC MATERIAL, DEBRIS, TRASH, REFUSE, OR PARTICLES SIZES GREATER THAN 3-INCH. SOILS THAT ARE TOO WET OR TOO DRY TO BE COMPACTED TO THE SAME DENSITY AS THE NATIVE SOILS ARE UNSUITABLE.
- 3. GRANULAR BACKFILL SHALL MEET THE FOLLOWING GRADATION

SIEVE SIZE	TOTAL PERCENT PASSING		
1 1/2 INCH (37.5 MM)	100		
NO. 4 (4.75 MM)	30 TO 60		
NO 200 (0.075 MM)	3 TO 15		

- 4. GRANULAR BEDDING WELL-GRADED SAND MEETING THE GRADATION REQUIREMENT OF **ASTM C 33 FINE AGGREGATE.**
- 5. CONTROLLED LOW STRENGTH MATERIAL (CLSM)— A SELF LEVELING AND SELF COMPACTING CEMENTITIOUS MATERIAL COMPOSED OF SAND, COARSE AGGREGATE, CEMENT, FLY ASH, WATER AND ADMIXTURES. CLSM SHALL BE EXCAVATABLE AND SHALL HAVE A DESIGNED UNCONFINED **COMPRESSIVE STRENGTH OF BETWEEN 50 TO 100 PSI.**
- 6. BACKFILL PRODUCTS MEETING THE REQUIREMENTS OF SUITABLE MATERIAL, GRANULAR BEDDING, GRANULAR BACKFILL OR CLSM.
- 7. TOPSOIL SOIL WITH AN ORGANIC CONTENT SUFFICIENT TO ALLOW VEGETATIVE GROWTH.



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GENERAL SITE WORK NOTES CONT.

PART 3 - EXECUTION

1. GENERAL:

- A. BEFORE STARTING GENERAL SITE PREPARATION ACTIVITIES, INSTALL EROSION AND SEDIMENT CONTROL MEASURES. THE WORK AREA SHALL BE CONSTRUCTED AND MAINTAINED IN SUCH CONDITION THAT IN THE EVENT OF RAIN THE SITE WILL BE DRAINED AT ALL TIMES.
- B. BEFORE ALL SURVEY, LAYOUT, STAKING, AND MARKING, ESTABLISH AND MAINTAIN ALL LINES, GRADES, ELEVATIONS AND BENCHMARKS NEEDED FOR EXECUTION OF THE WORK. CONDUCT UTILITY LOCATE IN ACCORDANCE WITH THE ONE-CALL NOTIFICATION
- C. CLEAR AND GRUB THE AREA WITHIN THE LIMITS OF THE SITE. REMOVE TREES, BRUSH, STUMPS, RUBBISH AND OTHER DEBRIS AND VEGETATION RESTING ON OR PROTRUDING THROUGH THE SURFACE OF THE SITE AREA TO BE CLEARED.
- D. REMOVE THE FOLLOWING MATERIALS TO A DEPTH OF NO LESS THAN 12 INCHES BELOW THE ORIGINAL GROUND SURFACE: ROOTS, STUMPS, AND OTHER DEBRIS, BRUSH, AND REFUSE EMBEDDED IN OR PROTRUDING THROUGH THE GROUND SURFACE, RAKE, DISK OR PLOW THE AREA TO A DEPTH OF NO LESS THAN 6 INCHES, AND REMOVE TO A DEPTH OF 12 INCHES ALL ROOTS AND OTHER DEBRIS THEREBY EXPOSED.
- E. REMOVE TOPSOIL MATERIAL COMPLETELY FROM THE SURFACE UNTIL THE SOIL NO LONGER MEETS THE DEFINITION OF TOPSOIL. AVOID MIXING TOPSOIL WITH SUBSOIL OR OTHER UNDESIRABLE MATERIALS. SUFFICIENT TOPSOIL MAY BE STOCKPILED ON SITE FOR USE DURING FINAL SITE GRADING.
- F. EXCEPT WHERE EXCAVATION TO GREATER DEPTH IS INDICATED, FILL DEPRESSIONS RESULTING FROM CLEARING, GRUBBING AND DEMOLITION WORK COMPLETELY WITH SUITABLE MATERIAL.
- G. REMOVE FROM THE SITE AND DISPOSE IN AN AUTHORIZED LANDFILL ALL DEBRIS RESULTING FROM CLEARING AND GRUBBING OPERATIONS. BURNING WILL NOT BE PERMITTED.
- H. PRIOR TO EXCAVATING, THOROUGHLY EXAMINE THE AREA TO BE EXCAVATED AND/OR TRENCHED TO VERIFY THE LOCATIONS OF FEATURES INDICATED ON THE DRAWINGS AND TO ASCERTAIN THE EXISTENCE AND LOCATION OF ANY STRUCTURE, UNDERGROUND STRUCTURE, OR OTHER ITEM NOT SHOWN THAT MIGHT INTERFERE WITH THE PROPOSED CONSTRUCTION. NOTIFY THE CONSTRUCTION MANAGER OF ANY OBSTRUCTIONS THAT WILL PREVENT ACCOMPLISHMENT OF THE WORK AS INDICATED ON THE DRAWINGS.
- SEPARATE AND STOCK PILE ALL EXCAVATED MATERIALS SUITABLE FOR BACKFILL. ALL EXCESS EXCAVATED AND UNSUITABLE MATERIALS SHALL BE DISPOSED OF OFF-SITE IN A LEGAL MANNER.
- J. DURING EXCAVATION, THE CONTRACTOR SHALL PROVIDE SHORING, SHEETING, AND BRACING AS REQUIRED TO PREVENT CAVING OR SLOUGHING OF EXCAVATION.

2. BACKFILL

- A. AS SOON AS PRACTICAL, AFTER COMPLETING CONSTRUCTION OF THE RELATED STRUCTURE, INCLUDING EXPIRATION OF THE SPECIFIED MINIMUM CURING PERIOD FOR CAST-IN-PLACE CONCRETE, BACKFILL THE EXCAVATION WITH APPROVED MATERIAL TO RESTORE THE REQUIRED FINISHED GRADE.
- B. PRIOR TO PLACING BACKFILL AROUND STRUCTURES, ALL FORMS SHALL BE REMOVED AND THE EXCAVATION CLEANED OF ALL TRASH, DEBRIS, AND UNSUITABLE MATERIALS.
- C. DO NOT PLACE FROZEN MATERIAL IN AS BACKFILL.
- D. PLACE BACKFILL MATERIAL OR SELECT GRANULAR BACKFILL MATERIAL WHEN REQUIRED IN UNIFORM HORIZONTAL LAYERS OF NO GREATER THAN 8-INCHES LOOSE THICKNESS AND COMPACT TO THE SAME DENSITY AS NATIVE SOIL. WHERE HAND OPERATED COMPACTORS ARE USED, THE FILL MATERIAL SHALL BE PLACED IN LIFTS NOT TO EXCEED 4 INCHES IN LOOSE DEPTH AND COMPACTED.
- E. WHENEVER TESTING INDICATES THAT THE CONTRACTOR HAS NOT OBTAINED THE SPECIFIED DENSITY,
 THE SUCCEEDING LAYER SHALL NOT BE PLACED UNTIL THE REQUIREMENTS ARE MET UNLESS
 OTHERWISE AUTHORIZED BY THE CONSTRUCTION MANAGER. THE CONTRACTOR SHALL TAKE WHATEVER
 APPROPRIATE ACTION IS NECESSARY, SUCH AS DRYING, ADDING WATER, OR INCREASING THE
 COMPACTIVE EFFORT TO MEET THE COMPACTION REQUIREMENTS.

3. TRENCH EXCAVATION:

- A. UTILITY TRENCHES SHALL BE EXCAVATED TO THE LINES AND GRADES SHOWN ON THE DRAWINGS OR AS DIRECTED BY THE GENERAL CONTRACTOR. PROVIDE SHORING, SHEETING AND BRACING AS REQUIRED TO PREVENT CAVING OR SLOUGHING OF THE TRENCH WALLS.
- B. EXTEND THE TRENCH WIDTH A MINIMUM OF 6 INCHES BEYOND THE OUTSIDE EDGE OF THE OUTERMOST CONDUIT.
- C. WHEN SOFT YIELDING, OR OTHERWISE UNSTABLE SOIL CONDITIONS ARE ENCOUNTERED, EXCAVATE THE REQUIRED TRENCH TO A DEPTH OF NO LESS THAN 12 INCHES BELOW THE REQUIRED ELEVATION, THEN BACKFILL WITH 12" OF GRANULAR BEDDING MATERIAL.

4. TRENCH BACKFILL:

- A. PROVIDE GRANULAR BEDDING MATERIAL OR FLOWABLE FILL IN ACCORDANCE WITH THE DRAWINGS AND THE UTILITY REQUIREMENTS.
- B. NOTIFY THE GENERAL CONTRACTOR 24 HOURS IN ADVANCE OF BACKFILLING.
- C. CONDUCT UTILITY CHECK TESTS BEFORE BACKFILLING. BACKFILL AND COMPACT TRENCH BEFORE

GENERAL SITE WORK NOTES CONT.

ACCEPTANCE TESTING.

- D. PLACE GRANULAR TRENCH BACKFILL UNIFORMLY ON BOTH SIDES OF THE CONDUITS IN 6-INCH UNCOMPACTED LIFTS UNTIL 12 INCHES OVER THE CONDUITS. SOLIDLY RAM AND TAMP BACKFILL INTO SPACE AROUND CONDUITS.
- E. PROTECT CONDUIT FROM LATERAL MOVEMENT, IMPACT DAMAGE, OR UNBALANCED LOADING.
- F. ABOVE THE CONDUIT EMBEDMENT ZONE, PLACE AND COMPACT SATISFACTORY BACKFILL MATERIAL IN 8-INCH MAXIMUM LOOSE THICKNESS LIFTS TO RESTORE THE REQUIRED FINISHED SURFACE GRADE.
- G. COMPACT FINAL TRENCH BACKFILL TO A DENSITY EQUAL TO OR GREATER THAN THAT OF THE EXISTING UNDISTURBED MATERIAL IMMEDIATELY ADJACENT TO THE TRENCH.

5. FINISH GRADING:

- A. PERFORM ALL GRADING TO PROVIDE POSITIVE DRAINAGE AWAY FROM STRUCTURES AND SMOOTH, EVEN SURFACE DRAINAGE OF THE ENTIRE AREA WITHIN THE LIMITS OF CONSTRUCTION. GRADING SHALL BE COMPATIBLE WITH ALL SURROUNDING TOPOGRAPHY AND STRUCTURES.
- B. UTILIZE SATISFACTORY FILL MATERIAL RESULTING FROM THE EXCAVATION WORK IN THE CONSTRUCTION OF FILLS, EMBANKMENTS AND FOR REPLACEMENT OF REMOVED UNSUITABLE MATERIALS.
- C. REPAIR ALL ACCESS ROADS AND SURROUNDING AREAS USED DURING THE COURSE OF THIS WORK TO THEIR ORIGINAL CONDITION.

6. ASPHALT PAVING ROAD:

- A. CONTRACTOR RESPONSIBLE FOR RE-STRIPING AND APPLYING SEALCOATING, UNLESS OTHERWISE
- . NMDOT STANDARD SPECIFICATION, CURRENT EDITION.

7. STAGING:

- A. WORK / STAGING AREA TO BE CONFIRMED AT PRE-CONSTRUCTION SITE MEETING AND SURROUNDED BY TEMPORARY FENCE (SEE DETAIL BELOW) DURING CONSTRUCTION.
- B. POSSIBLE LOCATION FOR TEMPORARY DRIVE AISLE CLOSURE DURING CONSTRUCTION.
- C. CONTRACTOR TO PROVIDE TEMPORARY SIGNS TO DIRECT TRAFFIC FLOW.
- D. SHORT TERM FENCING TO BE PROVIDED OUTSIDE OF TEMPORARY FENCE FOR ANY OPEN TRENCHES LEFT OVER NIGHT OR UNATTENDED.
- E. TEMPORARY FENCE SHALL BE CLOSED AND LOCKED AT ALL TIMES. IF GATE MUST BE OPEN FOR MOVING EQUIPMENT OR MATERIALS, A SPOTTER SHALL BE PROVIDED TO TO PREVENT UNAUTHORIZED ENTRY.
- NO EQUIPMENT OR MATERIALS SHALL BE STORED OUTSIDE THE TEMPORARY FENCE FOR ANY AMOUNT OF TIME.

STRUCTURAL STEEL NOTES

STRUCTURAL STEEL SHALL CONFORM TO THE FOLLOWING REQUIREMENTS, UNLESS NOTED OTHERWISE: WIDE FLANGE SHAPE: A992, 50KSI

ANGLE AND CHANNEL SHAPE: ASTM A36, 36 KSI PLATE: ASTM A36, 36KSI PIPE: ASTM A53 GRADE B. 35 KSI

HSS: ASTM A500 GRADE B, 46KSI

- 2. HIGH-STRENGTH BOLTS SHALL CONFORM TO ASTM A325: ONE HIGH-STRENGTH BOLT ASSEMBLY SHALL CONSIST OF A HEAVY HEX STRUCTURAL BOLT, A HEAVY NUT, A HARDENED WASHER CONFORMING TO ASTM F436. THE HARDENED WASHER SHALL BE INSTALLED AGAINST ELEMENT TURNED IN TIGHTENING. UNLESS NOTED OTHERWISE ON THE DRAWINGS, ALL CONNECTIONS SHALL BE BEARING TYPE CONNECTIONS.
- 3. WELDING ELECTRODES SHALL COMPLY WITH AWS D1.1 USING A5.1 OR A5.5 E70XX AND SHALL BE COMPATIBLE WITH THE WELDING PROCESS SELECTED. WELDERS SHALL BE QUALIFIED AS PRESCRIBED IN AWS D1.1.
- 4. UNLESS NOTED OTHERWISE ON THE DRAWING, ALL ANCHOR BOLTS SHALL CONFORM TO ASTM F1554 WITH HEAVY HEXAGONAL NUT.
- 5. FABRICATE ITEMS OF STRUCTURAL STEEL IN ACCORDANCE WITH AISC SPECIFICATION.
- . ALL EXPOSED STRUCTURAL STEEL AND BOLTS SHALL BE HOT DIP GALVANIZED PER ASTM A123.
- 7. SUBMIT FABRICATION AND ERECTION DRAWINGS SHOWING ALL DETAILS, CONNECTIONS, MATERIAL DESIGNATIONS, AND TOP STEEL ELEVATIONS FOR APPROVAL. THE SHOP DRAWINGS WILL BE REVIEWED FOR GENERAL CONFORMANCE TO THE CONTRACT DRAWINGS. SUCH APPROVAL SHALL NOT RELIEVE THE FABRICATOR/CONTRACTOR OF THE RESPONSIBILITY FOR EITHER THE ACCURACY OF THE DETAILED DIMENSIONS IN THE SHOP AND ERECTION DRAWINGS OR THE GENERAL FIT-UP OF PARTS THAT ARE TO BE ASSEMBLED IN THE FIELD.
- . PRIMER SHALL BE RED OXIDE-CHROMATE PRIME COMPLYING WITH STEEL STRUCTURES PAINTING COUNCIL (SSPC) PAINT SPECIFICATION NUMBER 11

ANCHORAGE INSTALLATION NOTES

- 1. DRILLING THROUGH EXISTING SLAB REBAR DURING POST-INSTALLED ANCHOR BOLTS INSTALLATION IS NOT PERMITTED.
- 2. POST-INSTALLED ANCHOR BOLT INSTALLATION SHALL BE PERFORMED BY PERSONNEL TRAINED TO INSTALL THE SYSTEM PER THE MANUFACTURER'S PRINTED INSTALLATION INSTRUCTIONS (MPII), AS INCLUDED IN THE ANCHOR PACKAGING.
- 3. EXPANSION AND ADHESIVE ANCHORS SHALL BE INSTALLED PER THE MANUFACTURER'S INSTRUCTIONS USING STANDARD EMBEDMENTS AND EDGE DISTANCES UNLESS NOTED OTHERWISE ON THE DRAWINGS.

REINFORCED CONCRETE NOTES

- CONCRETE SHALL ATTAIN A MINIMUM COMPRESSIVE STRENGTH OF 5000 PSI IN 28 DAYS UNLESS
 OTHERWISE NOTED CONTINUOUS INSPECTION IS NOT REQUIRED. SLUMP: 4" MIN / 6" MAX.
 i. AIR ENTRAINMENT: 4 1/2% 7% BY VOLUME
- 2. REINFORCEMENT SHALL BE A NEW BILLET STEEL DEFORMED BARS CONFORMING TO ASTM SPECIFICATION A615 GRADE 60, MAXIMUM COARSE AGGREGATE SIZE SHALL BE 3/4".
- 3. REINFORCEMENT SHALL COMPLY WITH THE LATEST EDITION OF ACI 318 FOR MINIMUM CLEARANCES AND CONCRETE COVER.
- 4. ALL EMBEDDED ITEMS SHALL BE SECURELY HELD IN POSITION PRIOR TO PLACEMENT OF CONCRETE. ALL CONCRETE SHALL BE READY-MIXED IN ACCORDANCE WITH ASTM C94.
- 5. MAINTAIN TEMPERATURE OF CAST IN PLACE CONCRETE BETWEEN 50 DEGREES AND 90 DEGREES FAHRENHEIT.
- 6. DO NOT USE RETEMPERED CONCRETE, OR ADD WATER TO READY-MIX CONCRETE AT THE JOB SITE
- 7. WELDED WIRE FABRIC SHALL CONFORM TO ASTM A185.7.
- 8. EXCEPT AS DETAILED OR AUTHORIZED, MAKE BARS CONTINUOUS AROUND CORNERS WHERE PERMITTED, SPLICES MADE BY CONTACT LAPS SHALL BE CLASS "B" TENSION LAPS UNLESS NOTED OTHERWISE.
- 9. DETAIL BARS IN ACCORDANCE WITH "ACI DETAILING MANUAL", PUBLICATION SP-66 AND "BUILDING CODE REQUIREMENTS FOR REINFORCED CONCRETE", ACI 318.
- 10. PROVIDE ACCESSORIES NECESSARY TO PROPERLY SUPPORT REINFORCING.
- 11. EXPANSION JOINTS SHALL BE CONSTRUCTED AT LOCATIONS WHERE THE CONCRETE PAD ABUTS CONCRETE CURBS, DRIVEWAYS, AND SIMILAR STRUCTURES, AND AS SHOWN ON APPROVED PLANS.

 EXPANSION JOINTS SHALL BE FORMED WITH ONE-HALF INCH PRE-FABRICATED NON-EXTRUDING FILLER AND SHALL EXTEND THE FULL DEPTH OF THE SLAB.

GROUNDING NOTES

- 1. COAT ALL SURFACES WITH AN ANTI-OXIDANT COMPOUND BEFORE MATING.
- 2. FOR GROUND BOND TO STEEL ONLY: INSERT A CADMIUM FLAT WASHER BETWEEN LUG AND STEEL,
 COAT ALL SURFACES WITH AN ANTI-OXIDANT COMPOUND BEFORE MATING.
- 3. ENSURE THE WIRE INSULATION TERMINATION IS WITHIN 1/8" OF THE BARREL (NO SHINERS).
- 4. ALL BELOW GRADE BONDS TO BE EXOTHERMIC WELDS OR IRREVERSIBLE COMPRESSION-TYPE CONNECTIONS LISTED FOR USE IN THE APPLICATION WHICH THEY ARE INSTALLED.
- 5. ALL HARDWARE SHALL BE STAINLESS STEEL 3/8" DIAMETER OR LARGER. ALL HARDWARE 18-8 STAINLESS STEEL INCLUDING LOCK WASHERS, COAT ALL SURFACES WITH AN ANTI-OXIDANT COMPOUND BEFORE MATING.
- 6. 2014 NEC 250.121 EXCEPTION: A WIRE-TYPE EQUIPMENT GROUNDING CONDUCTOR INSTALLED IN COMPLIANCE WITH 250.6(A) AND THE APPLICABLE REQUIREMENTS FOR BOTH THE EQUIPMENT GROUNDING CONDUCTOR AND THE GROUNDING ELECTRODE CONDUCTOR IN PARTS II, III, AND VI OF THIS ARTICLE SHALL BE PERMITTED TO SERVE AS BOTH AN EQUIPMENT GROUNDING CONDUCTOR AND A GROUNDING ELECTRODE CONDUCTOR.

FIBER OPTIC NOTES

USE CABLE WITH THE FOLLOWING MINIMUM PROPERTIES:

- 1. HIGH TENSILE STRENGTH >150 LB
- 2. TIGHT BUFFERED
- 3. INDOOR / OUTDOOR UV AND MOISTURE RESISTANT "RISER" CABLE
- 4. CONNECTOR TYPE: ST-ST
- 5. FIBER TYPE: MULTI-MODE 6-FIBER (3 PAIR) 62.5UM. 6 CONNECTORS ON BOTH ENDS.
- 6. JACKET: INDOOR/OUTDOOR RISER, BLACK
- 7. BREAKOUT: SIDE A: INNER END 24 INCHES WITH 2MM FURCATION
- 7.A. SIDE B: OUTER END 24 INCHES 2MM FURCATION STAGGERED EVERY 1"
- WITH PULLING EYE ON SIDE B (OUTER END) AND SPOOL REEL



Kimley»Horn

REVISION BY DATE APE

DESIGNED BY: DMF
DRAWN BY: DMF
CHECKED BY: KEW

DESIGNED BY: DM
DRAWN BY: DM
CHECKED BY: KEV
DATE: 09/14/202

NM240036 - KROGER SMITHS 443
320 YALE BLVD SE, ALBUQUERQUE, NM 87106
GENERAL NOTES 2

21773
21773

PROJECT NO. 196408000

GN-2

SHEET

LEGEND

WORKING/STAGING AREA


DRIVE AISLE CLOSURE

TEMPORARY DRIVE AISLE

UTILITY LINE TO BE BORED (OUTSIDE OF WORKING/STAGING AREA)

UTILITY LINE TO BE TRENCHED (OUTSIDE OF WORKING/STAGING AREA)



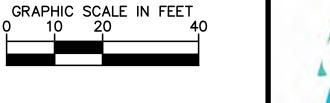



ELECTRIFY AMERICA, LL 2003 EDMUND HALLEY DRIVE SUITE 200 RESTON, VA 20191

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4582 S. ULSTER STREET SUITE 1500 DENVER, CO 80237 303-288-2300

APPR.	DATE APPR.	ЬA	REVISION	NO.


DESIGNED BY: DMF DRAWN BY: DMF CHECKED BY: KEW DATE: 09/14/2022


NM240036 - KROGER SMITHS 443 320 YALE BLVD SE, ALBUQUERQUE, NM 87106 OVERALL SITE LAYOUT





PROJECT NO. 196408000 SHEET


C-1

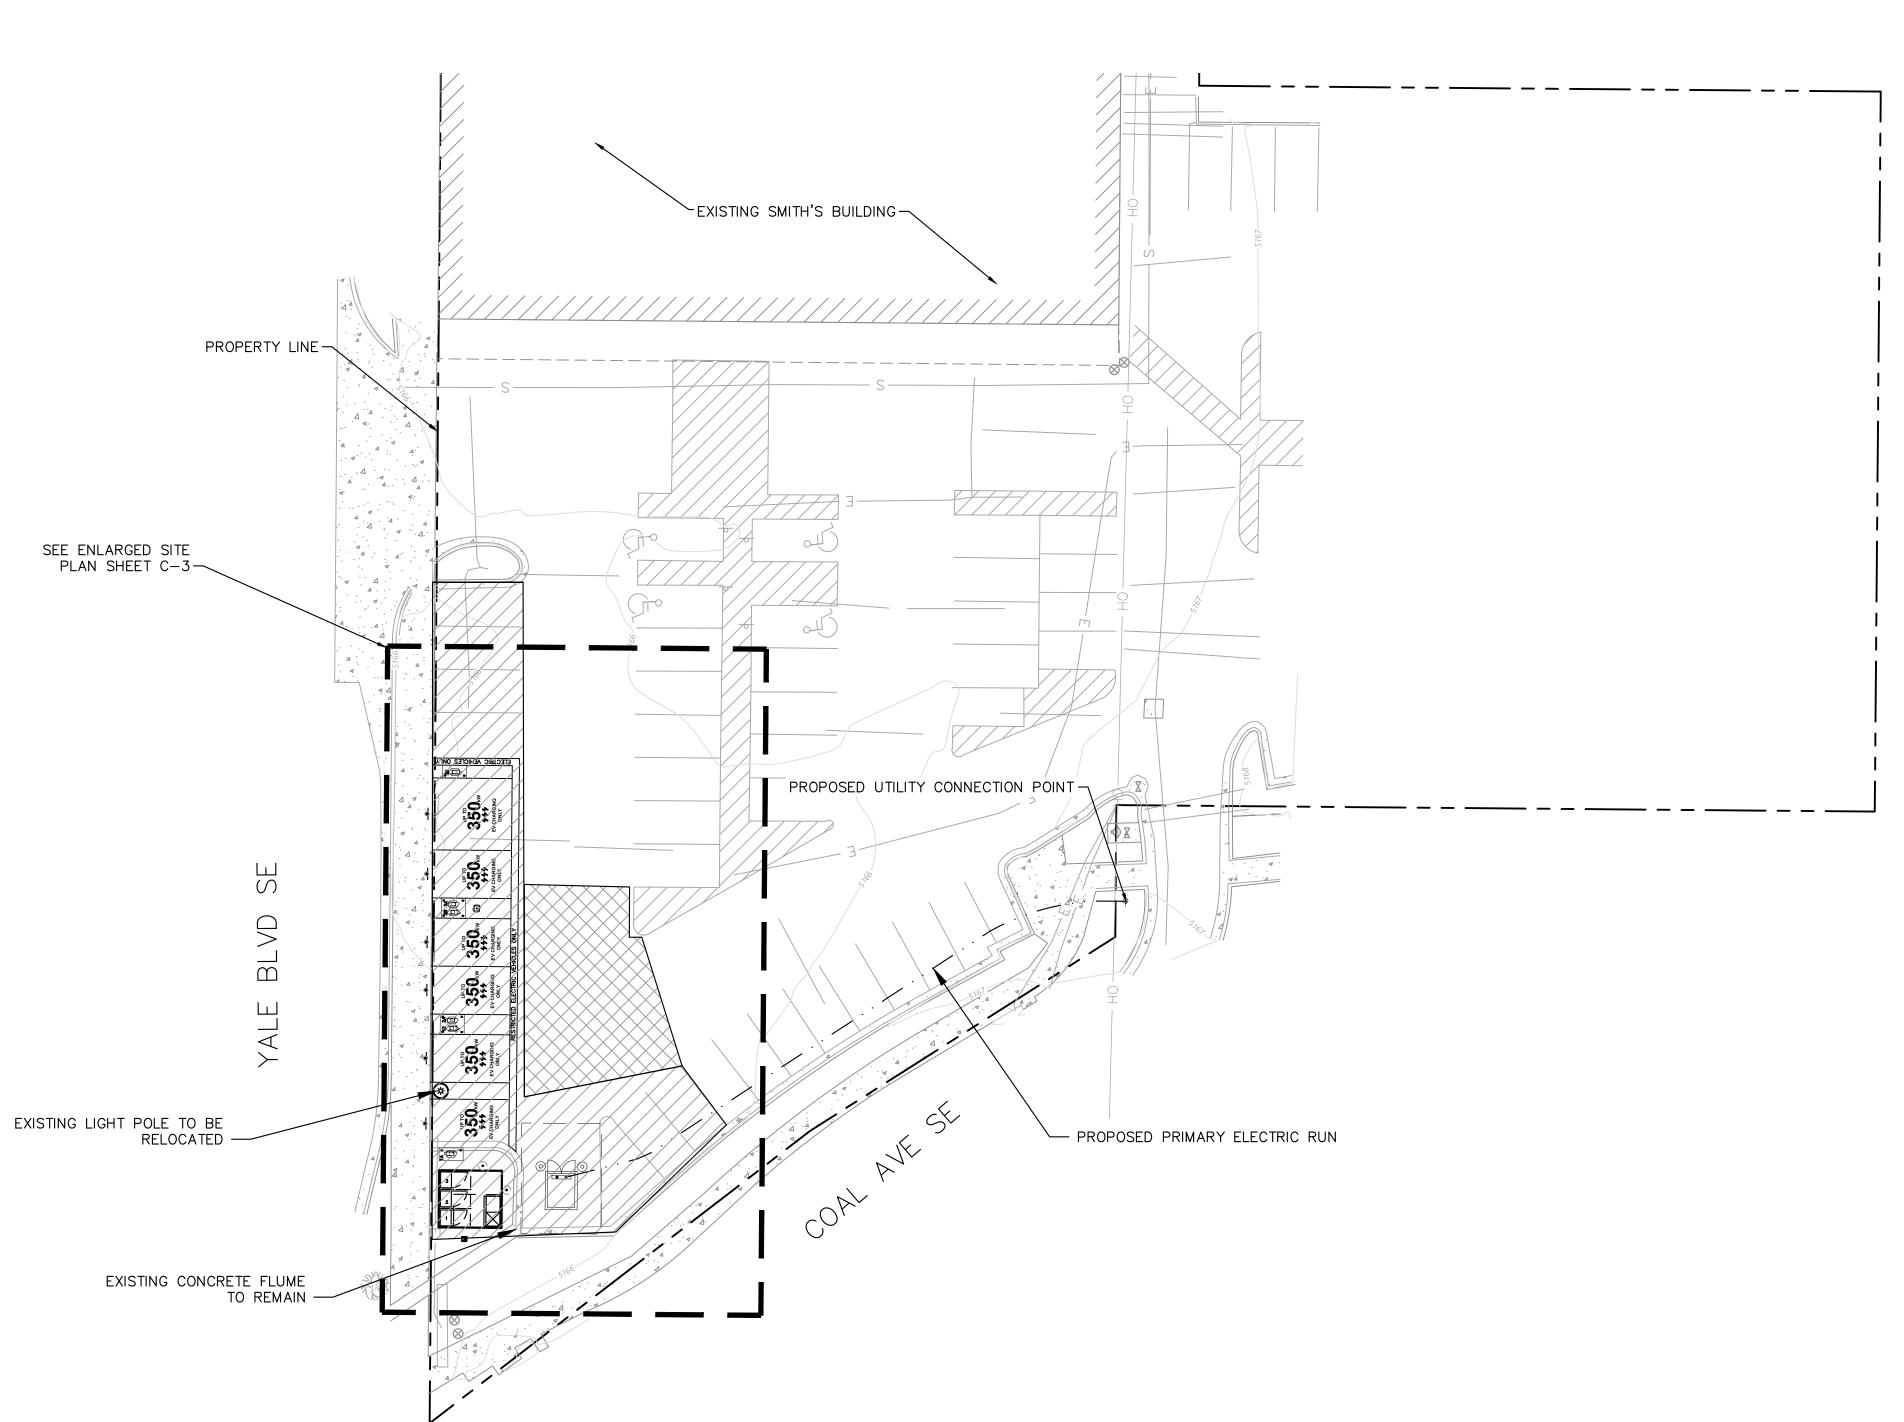


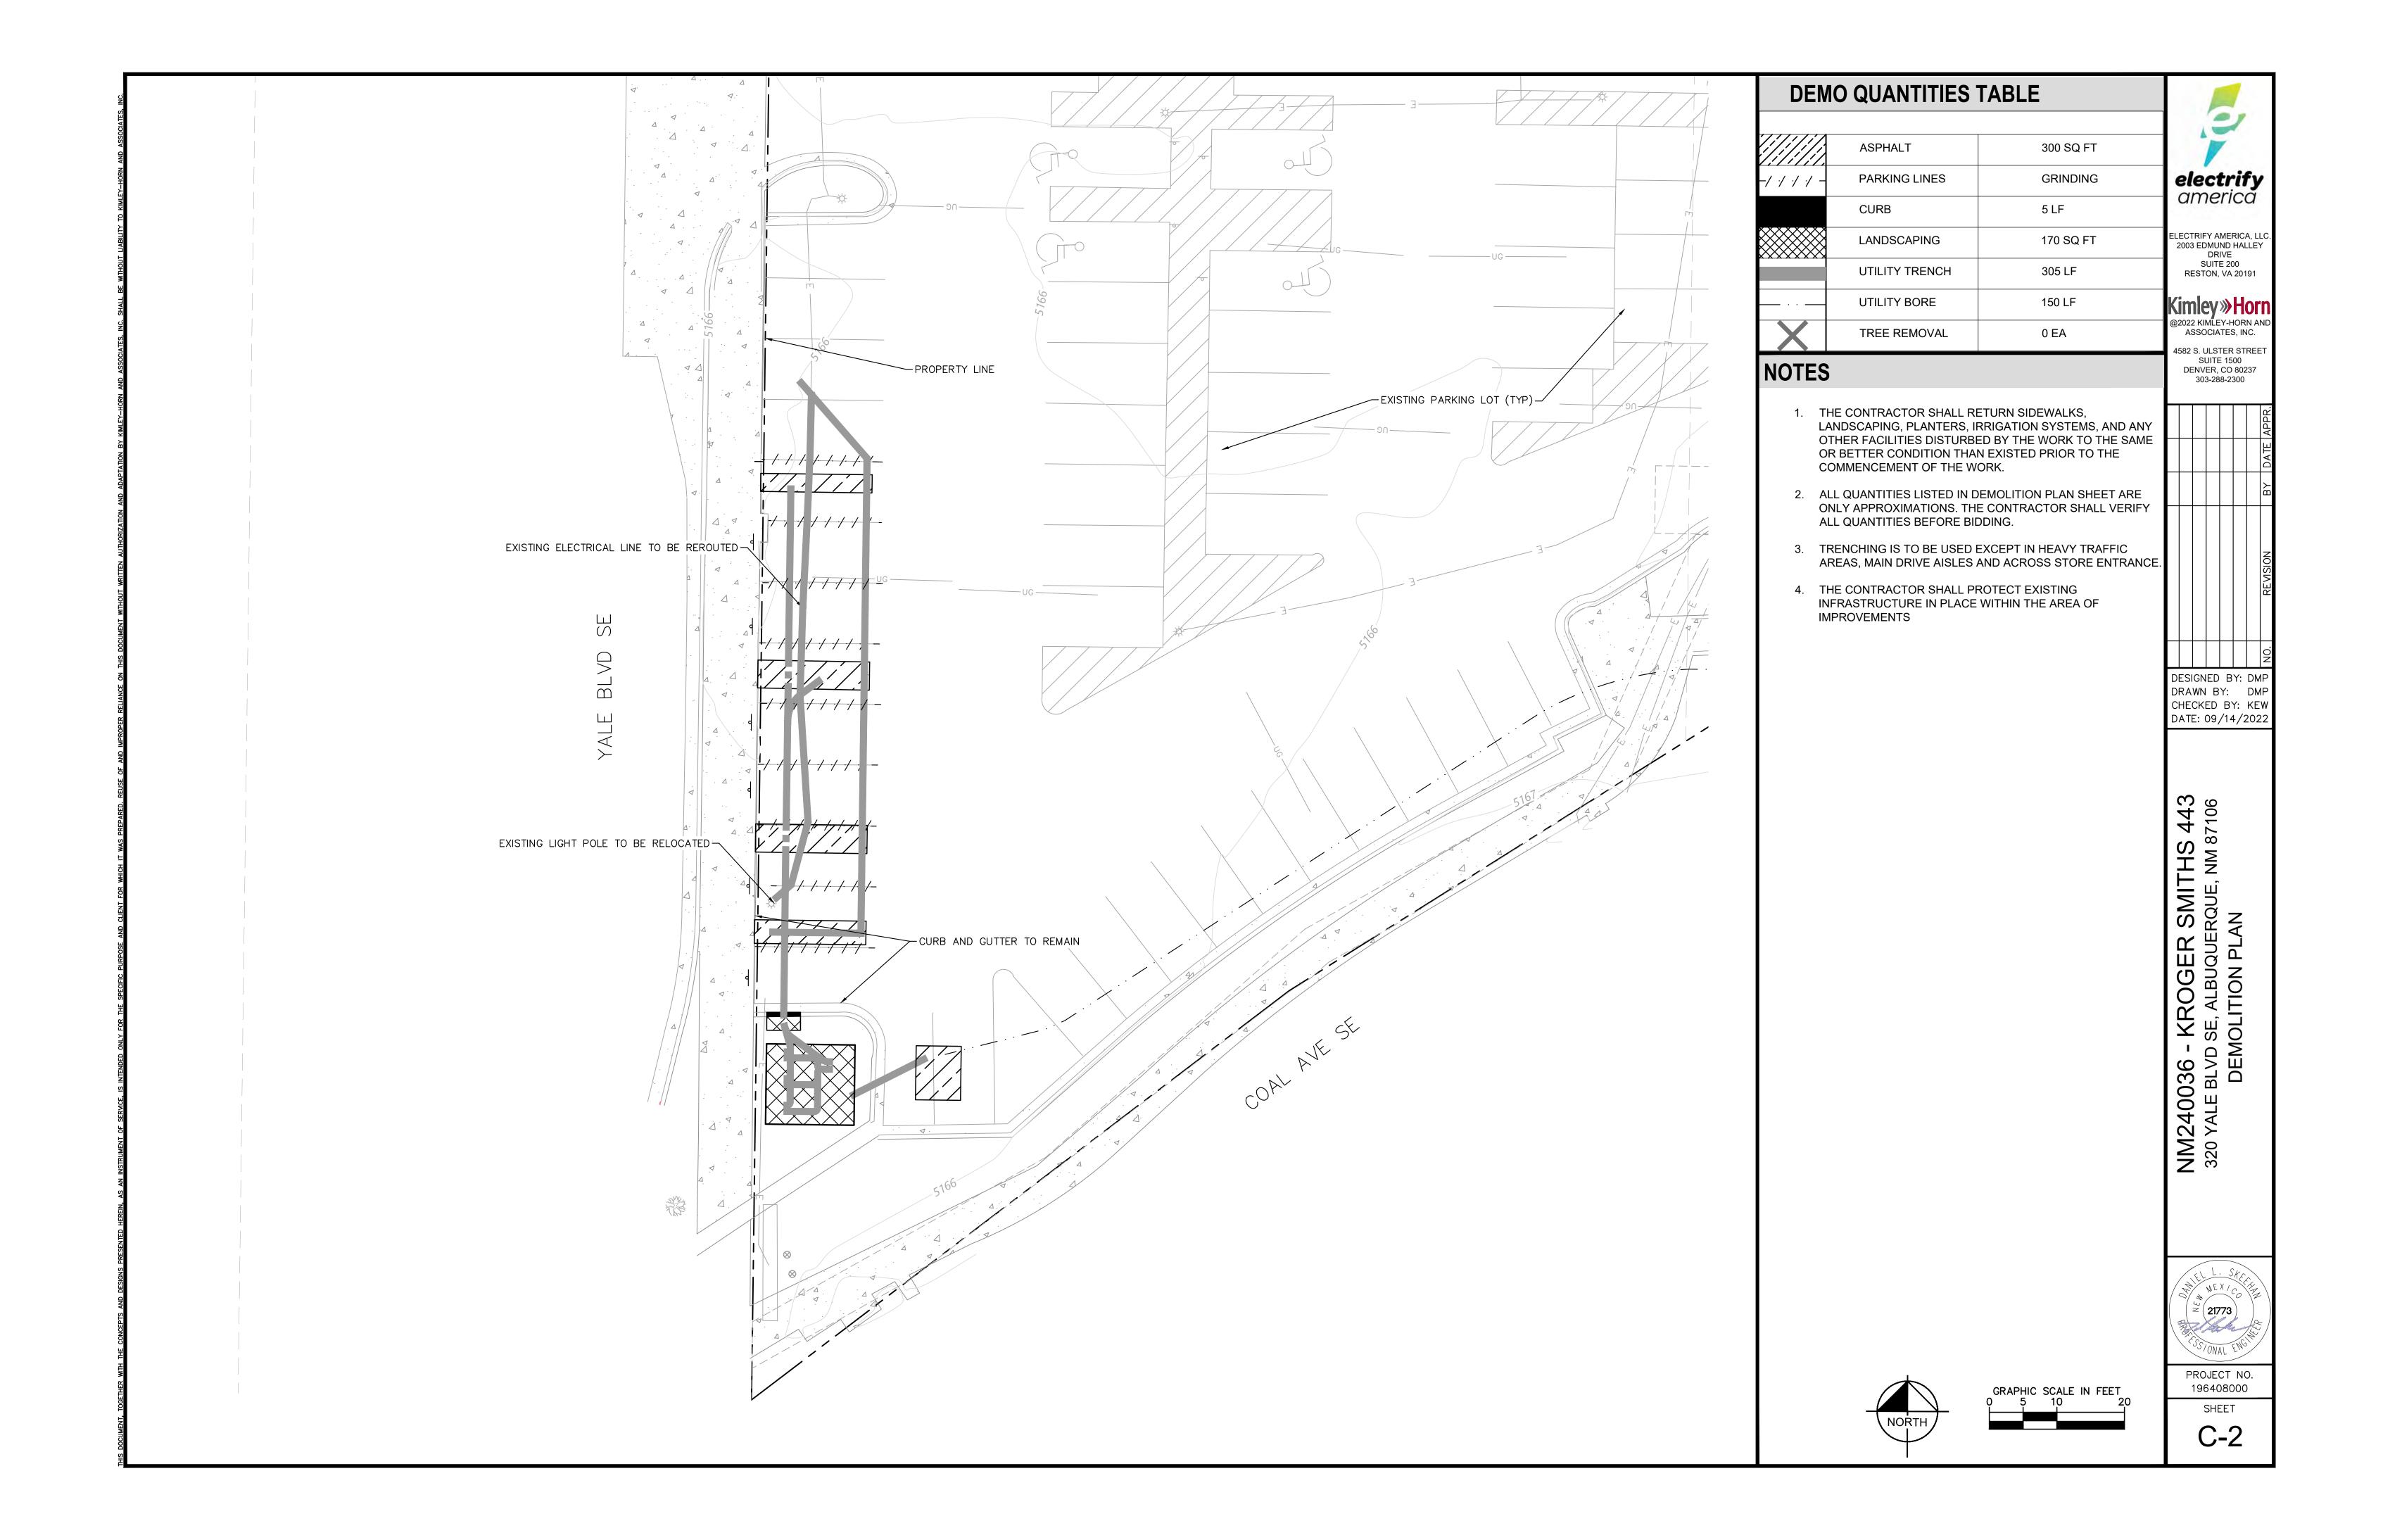


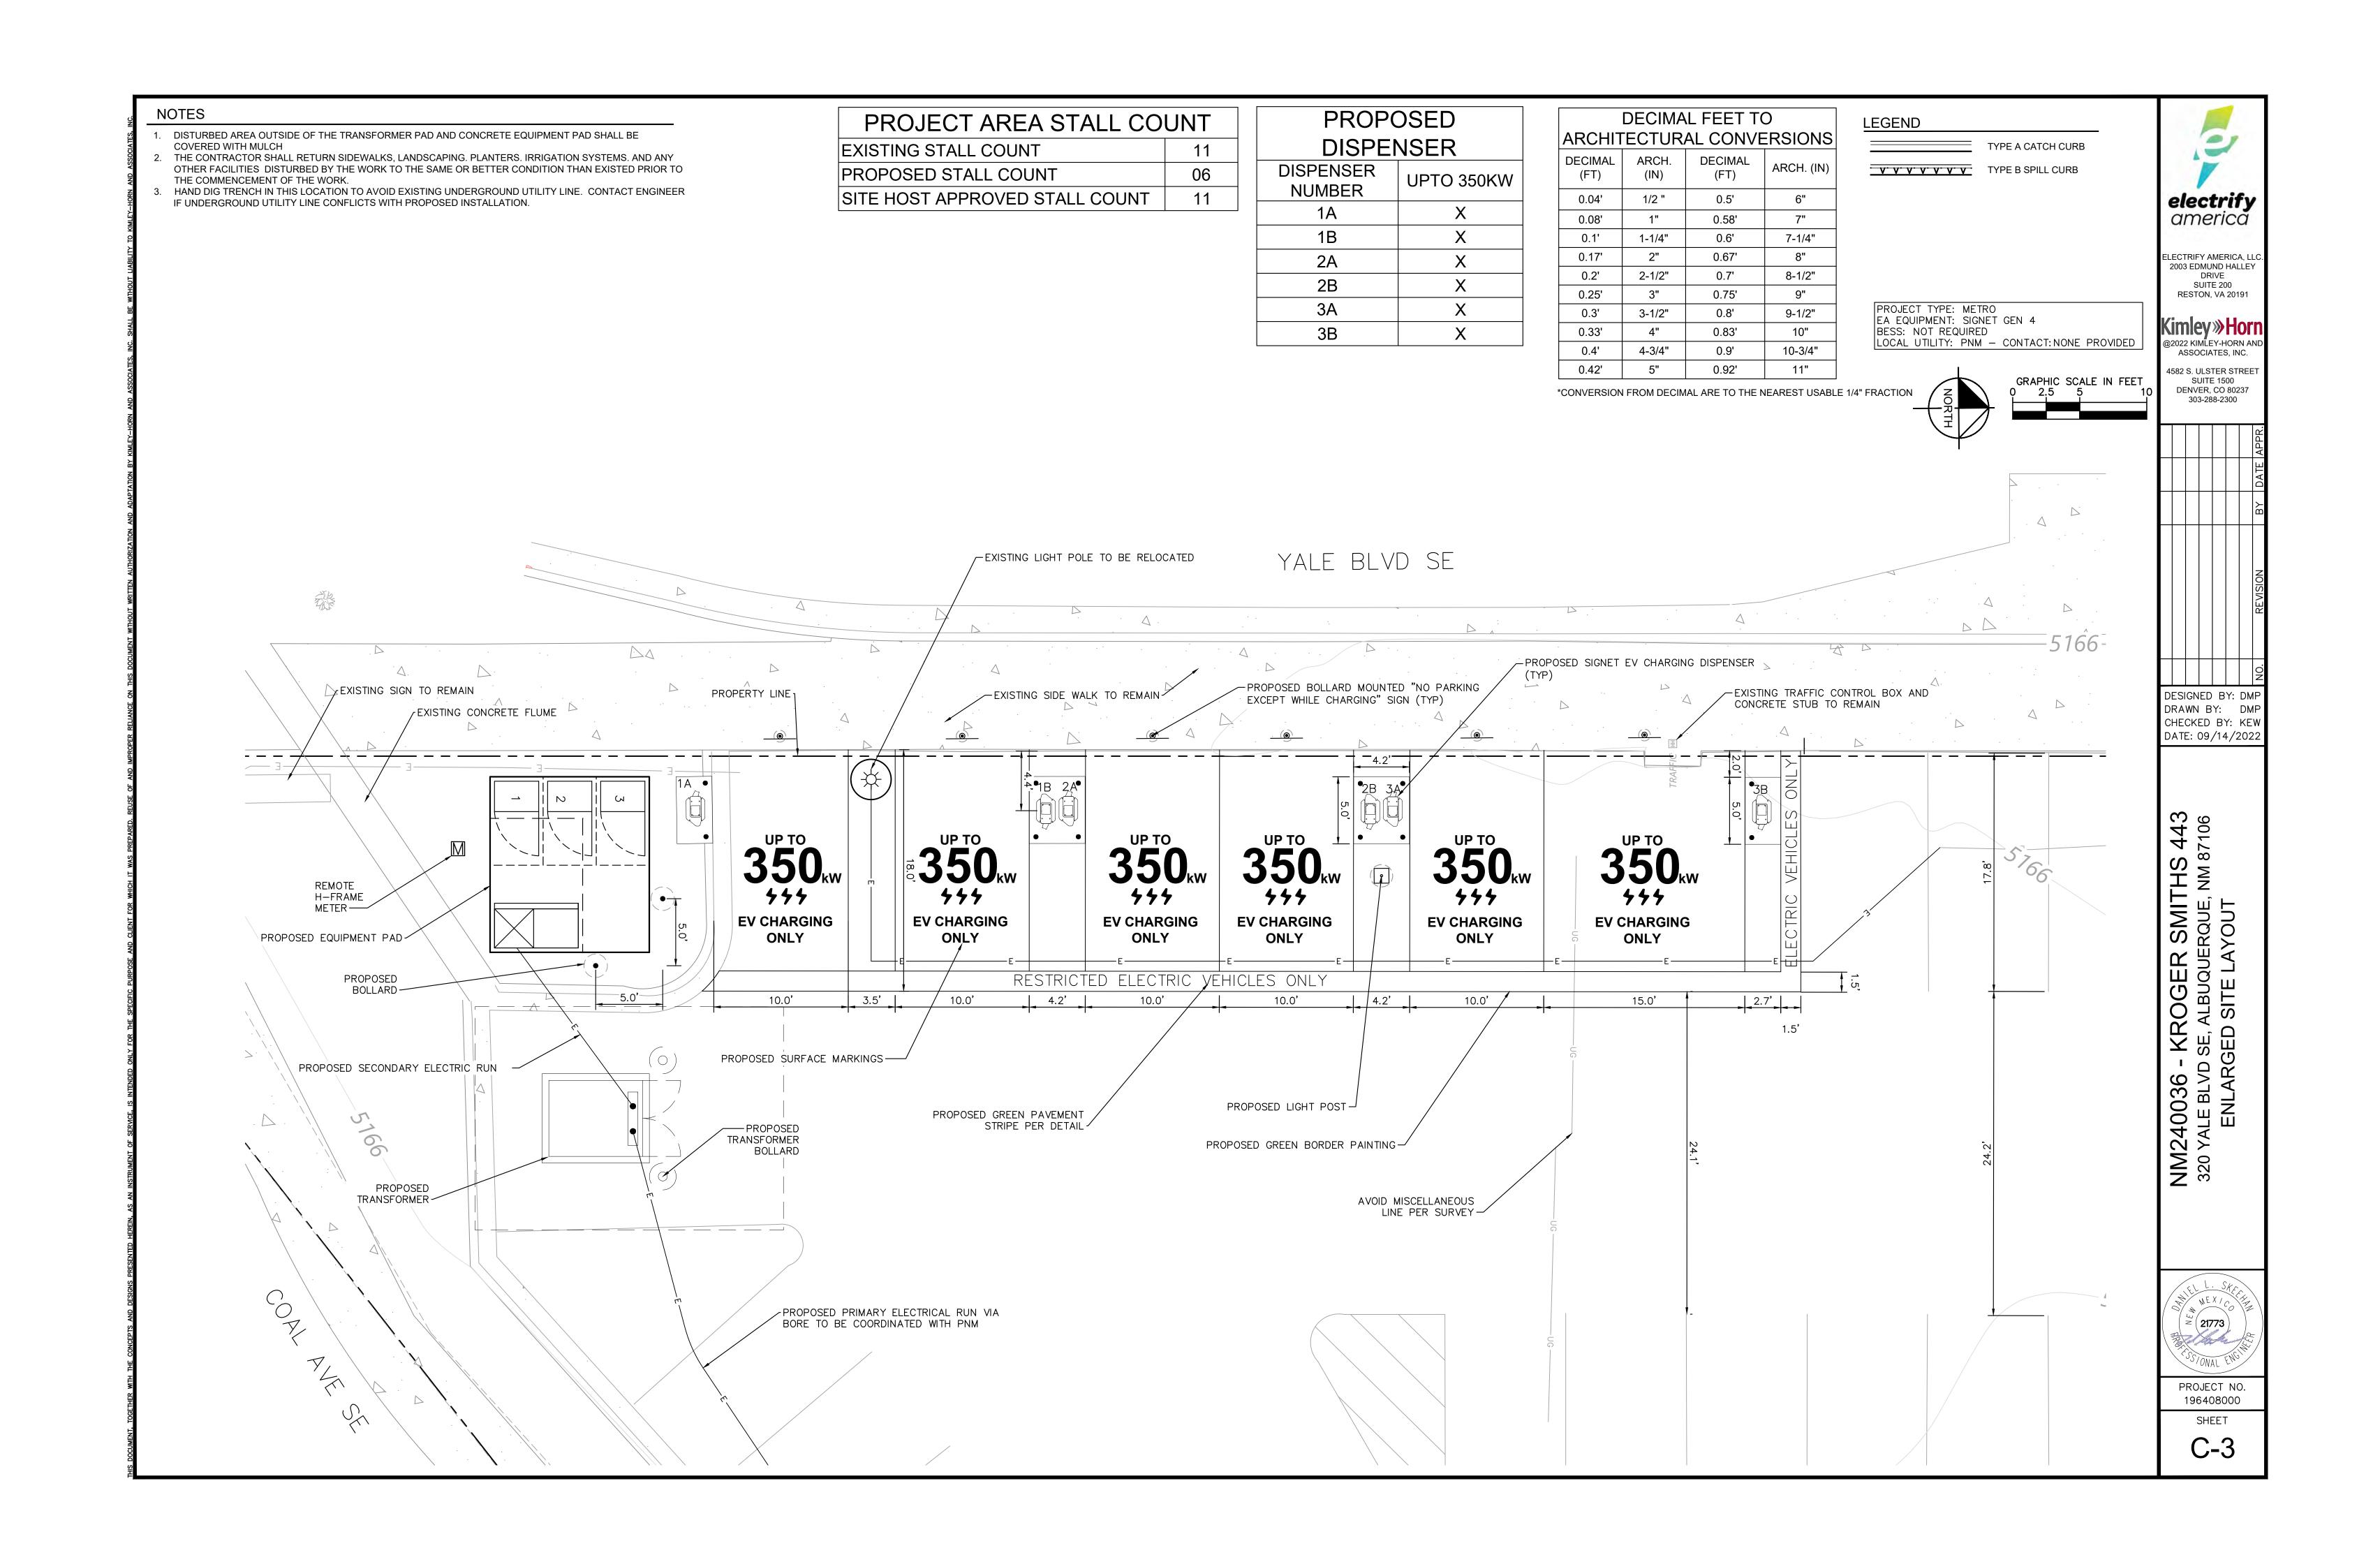

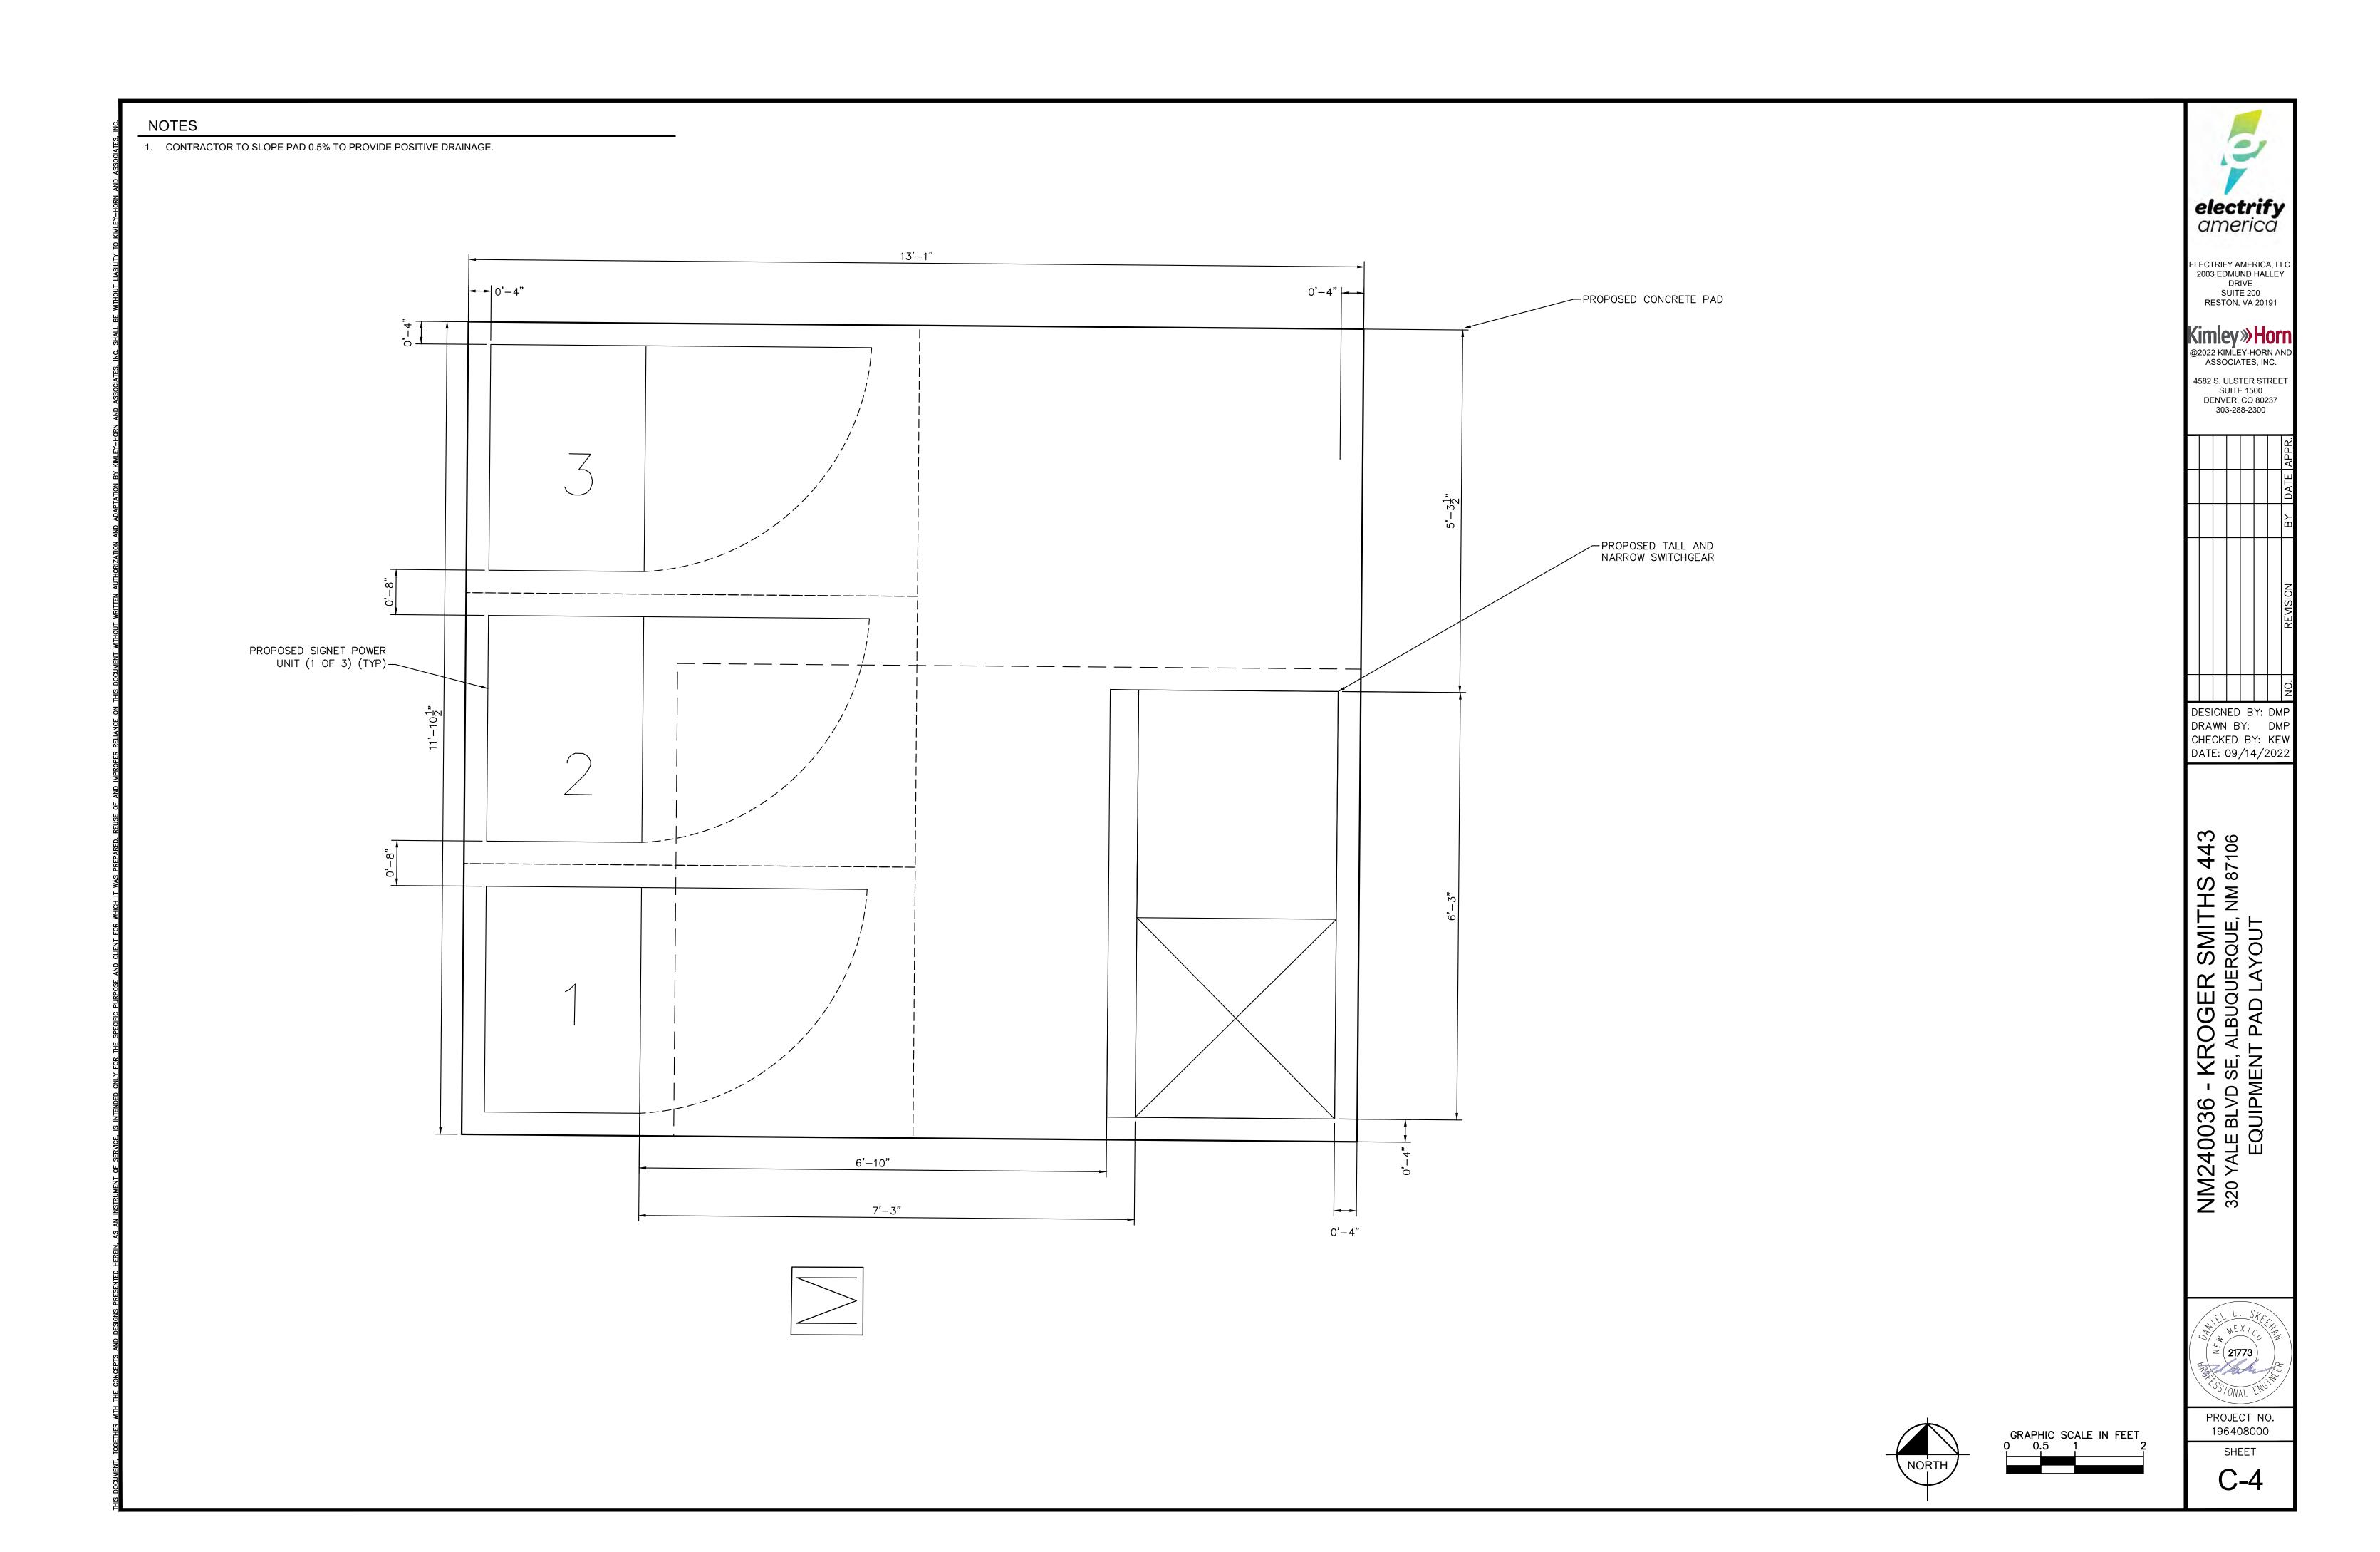

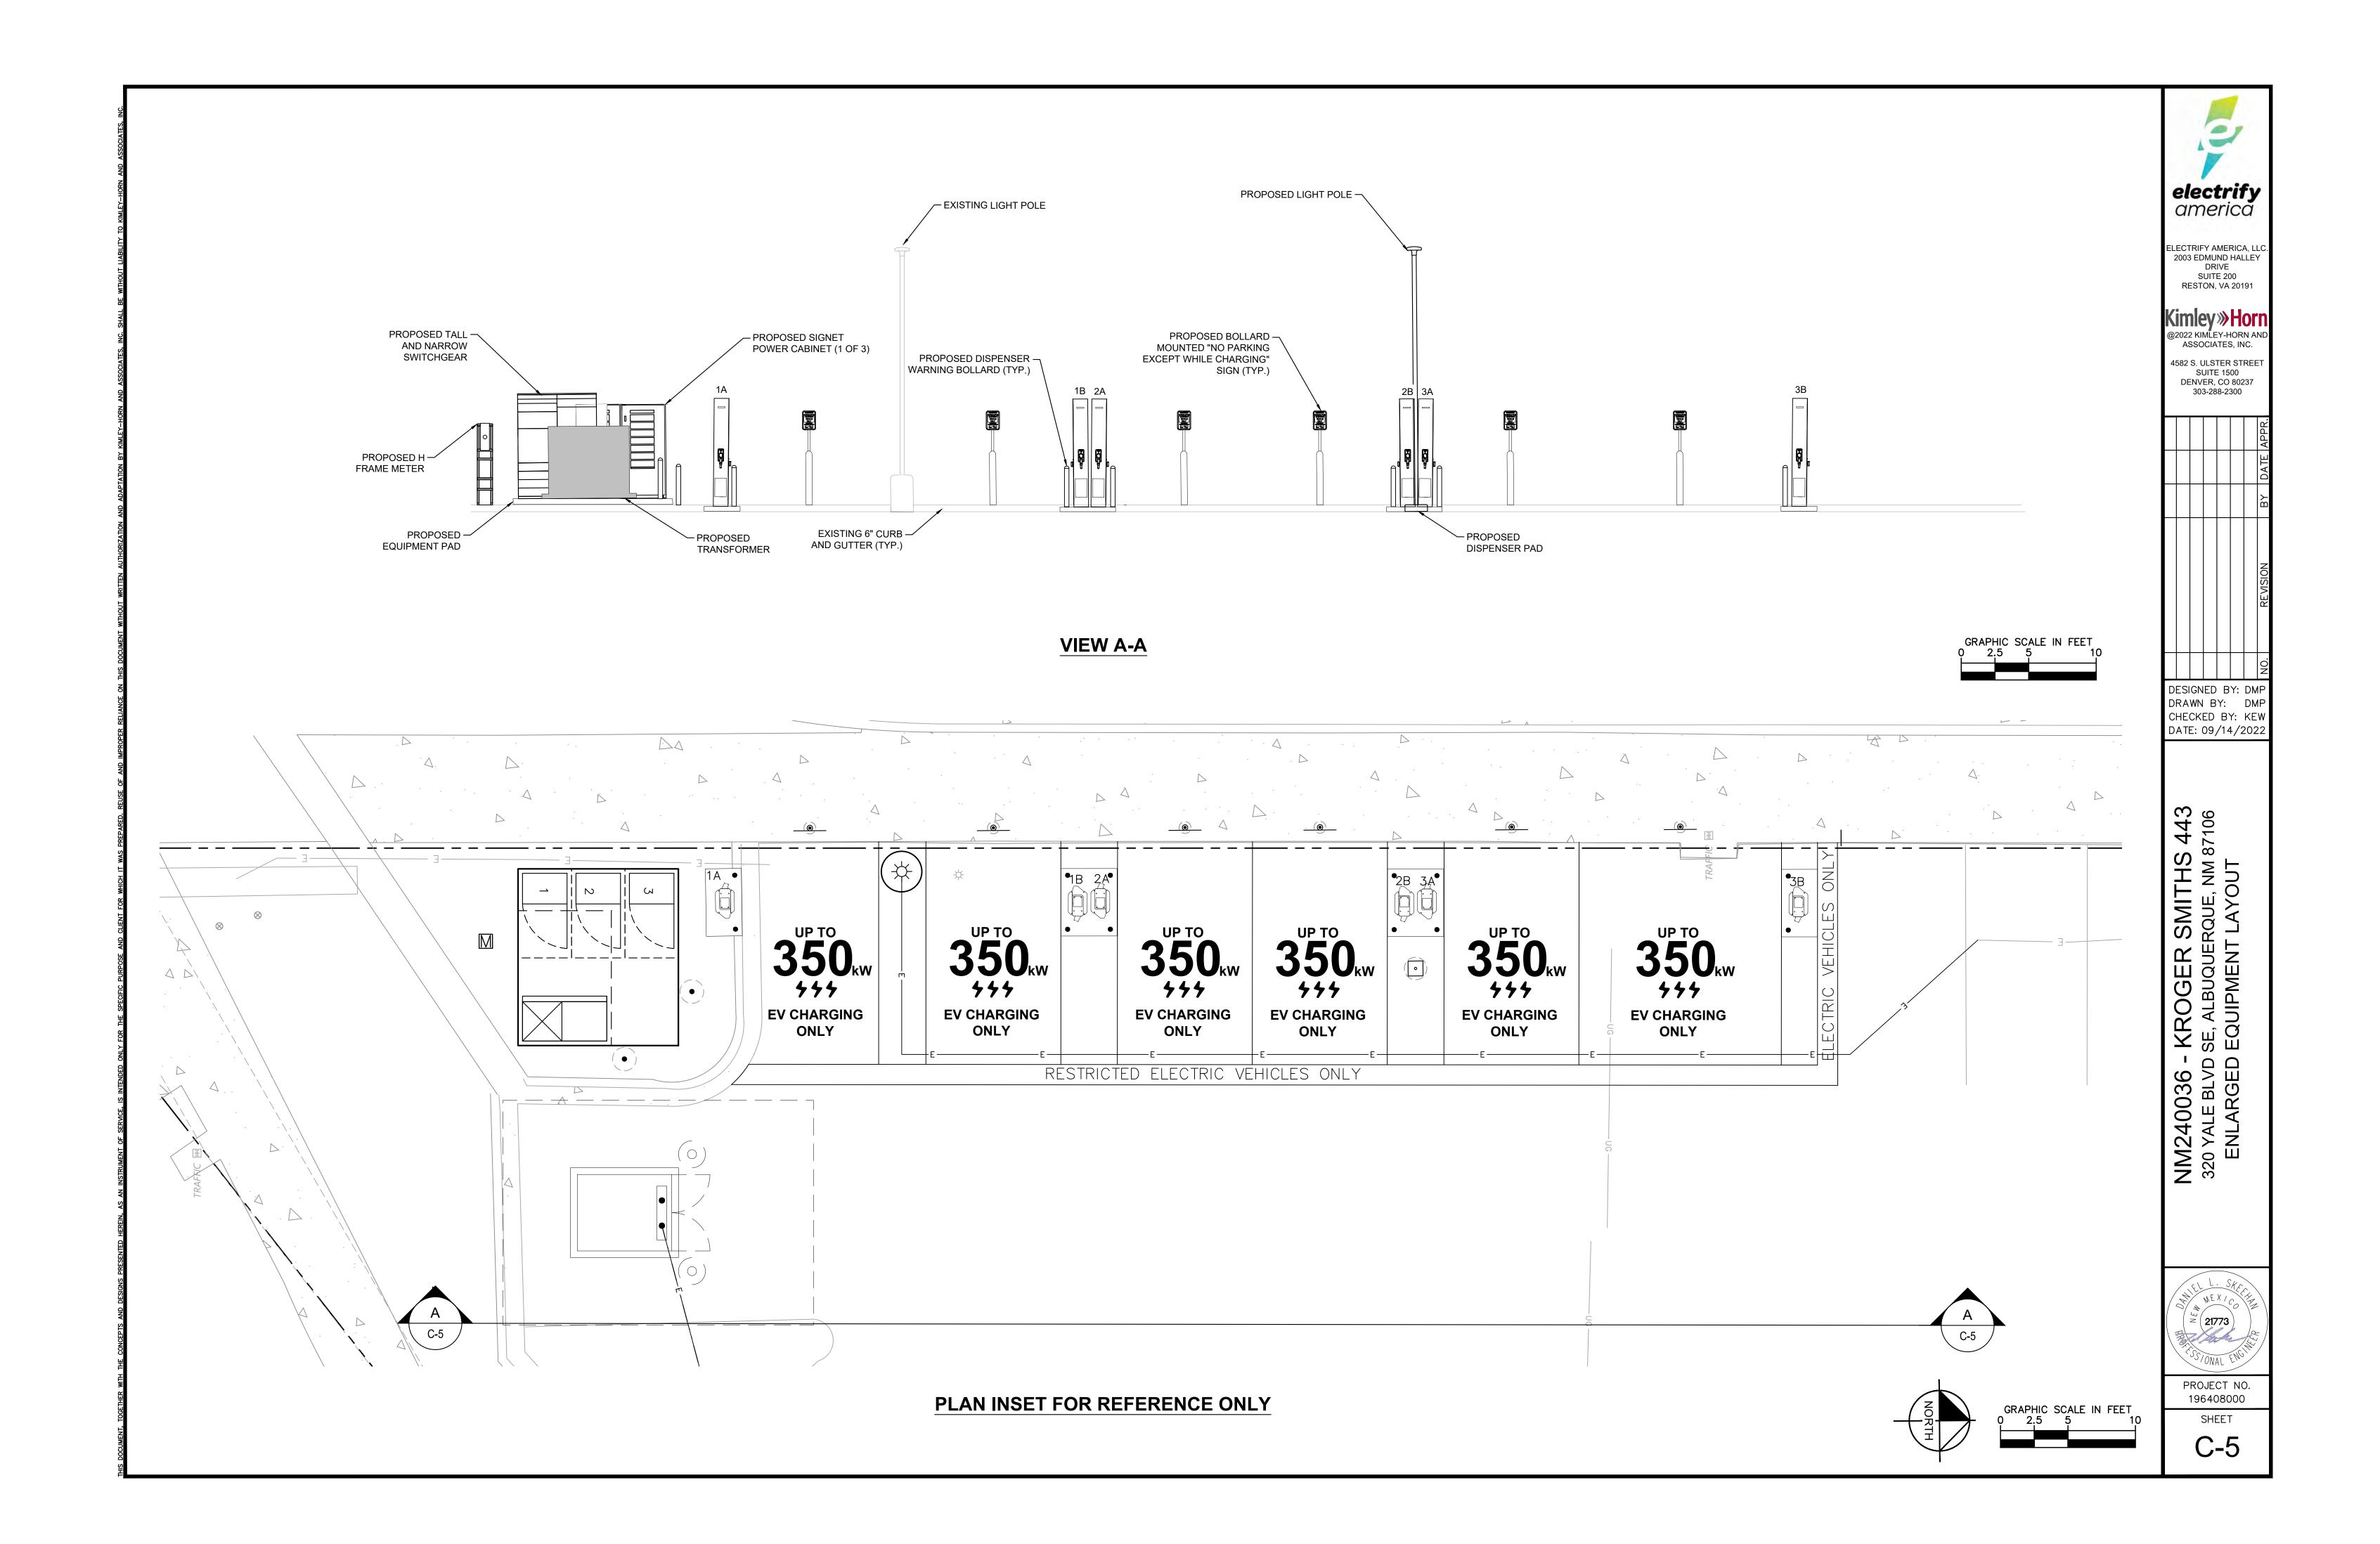

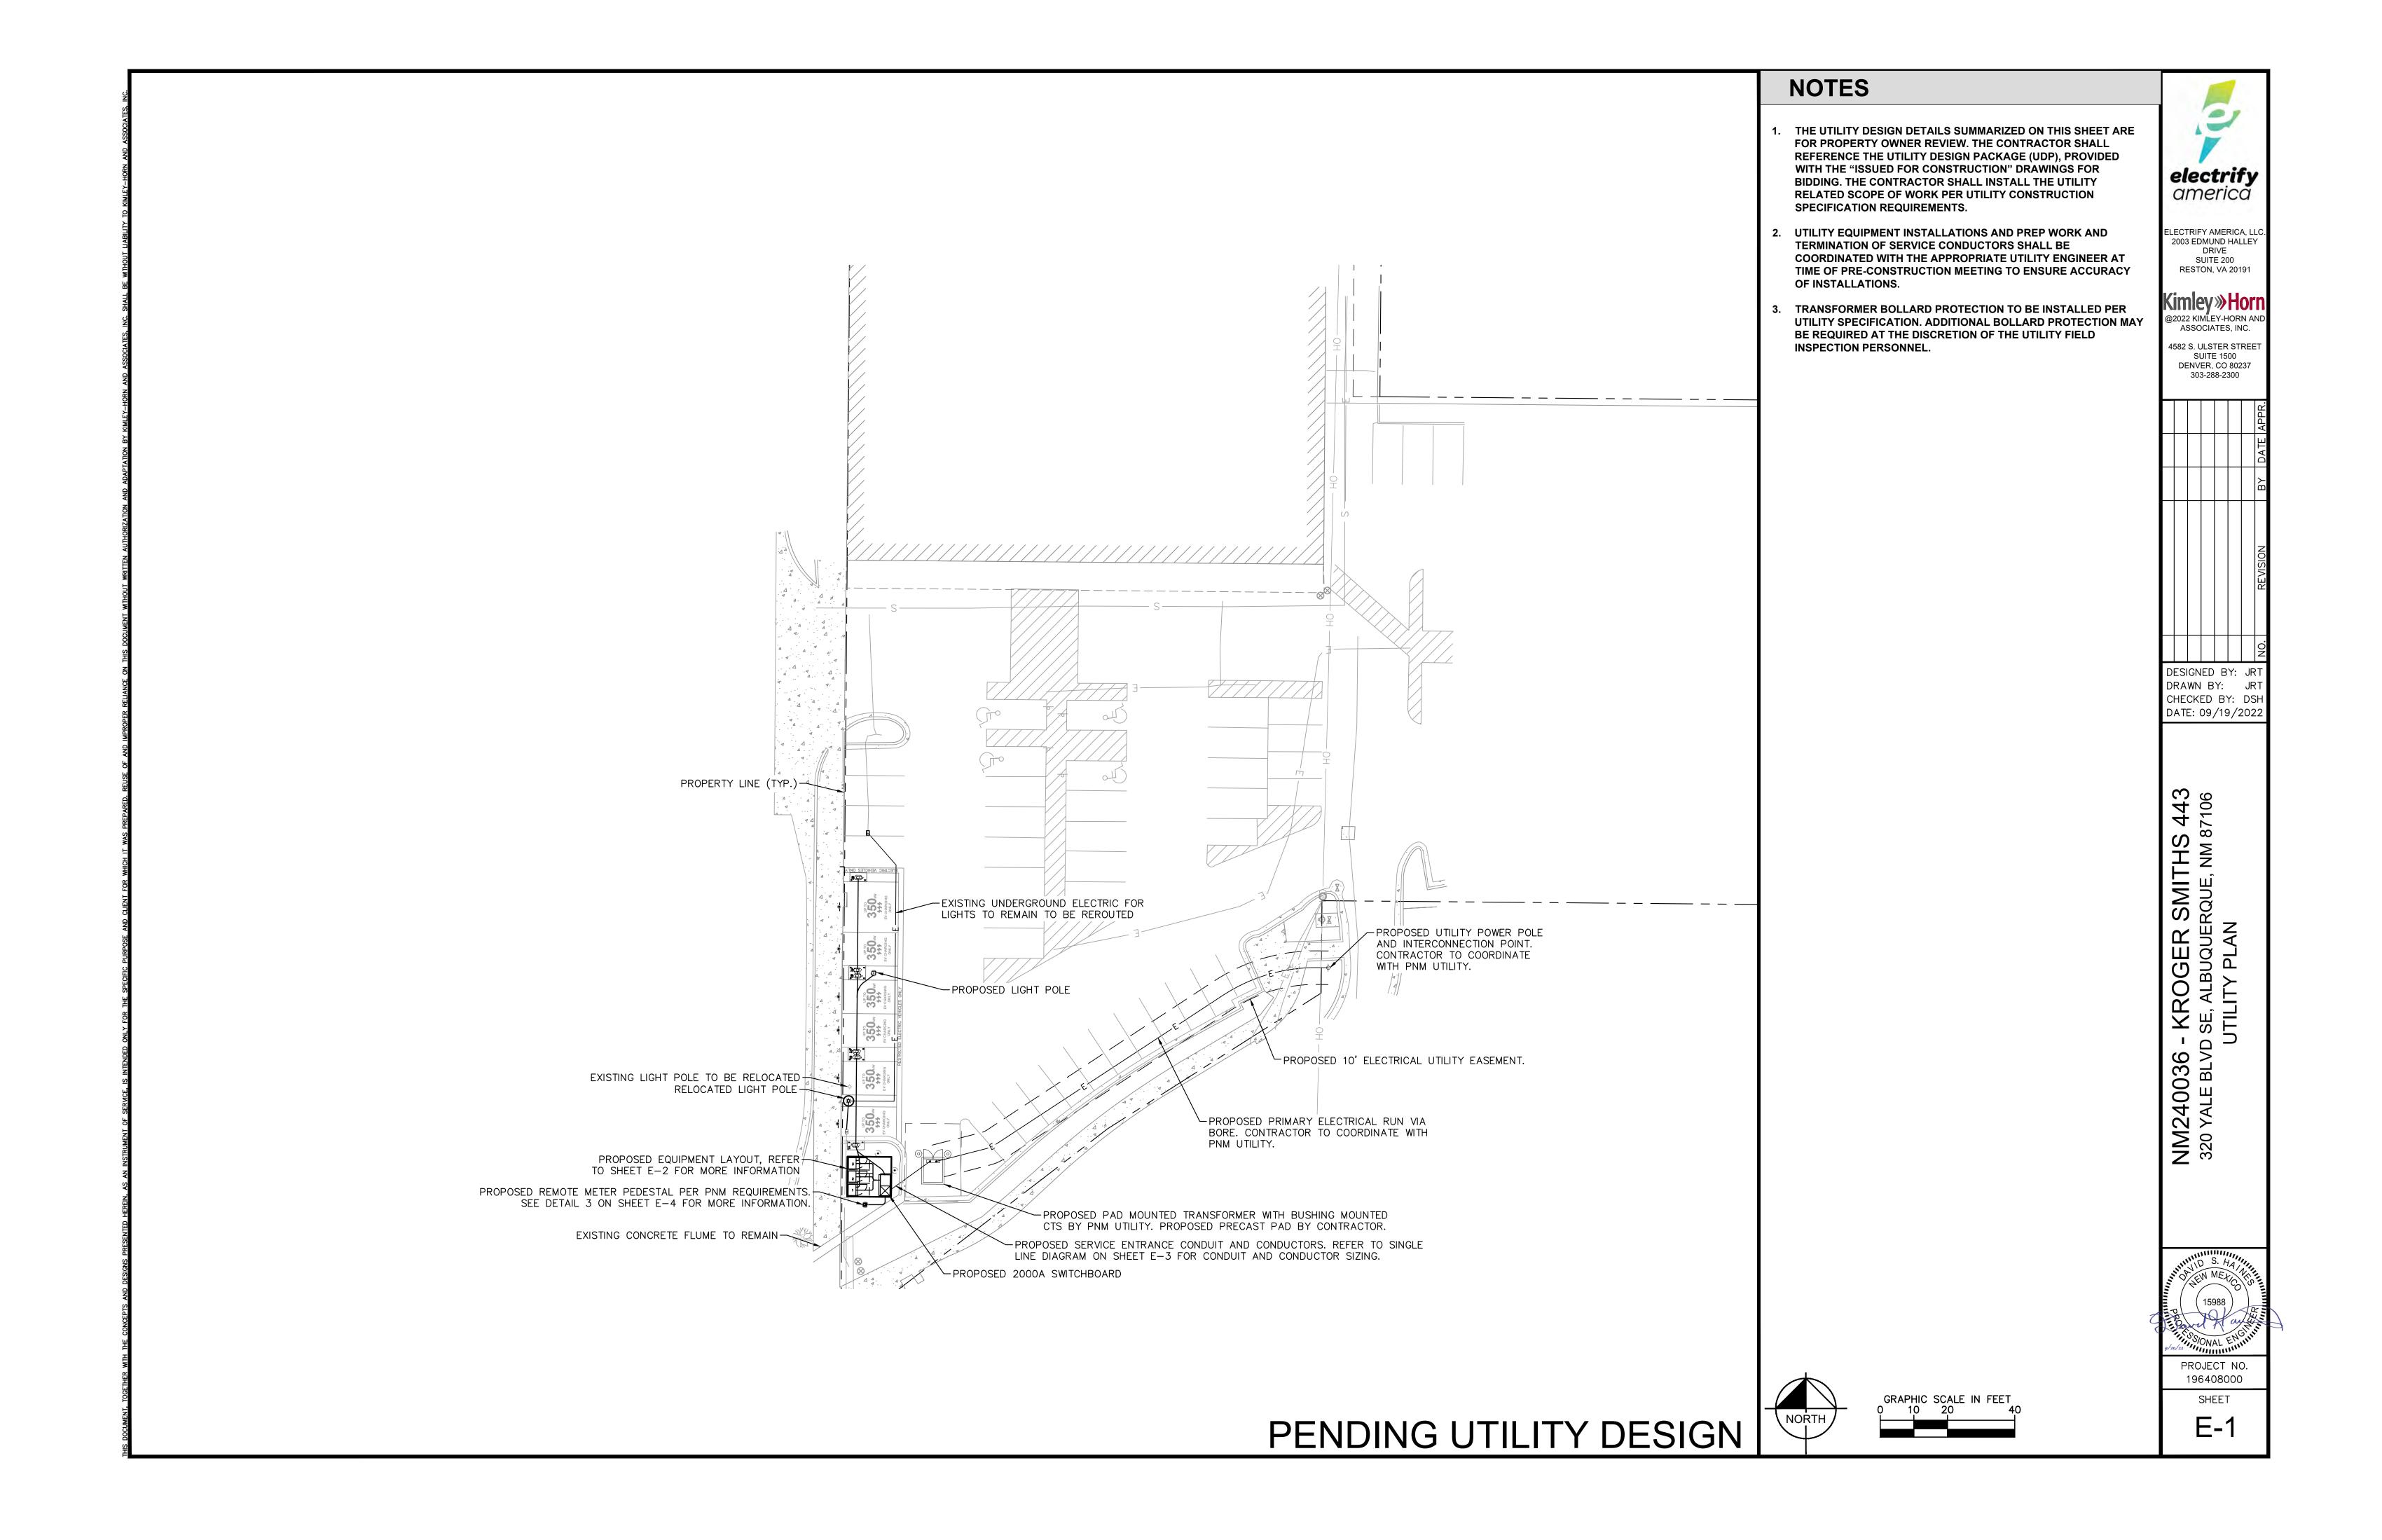

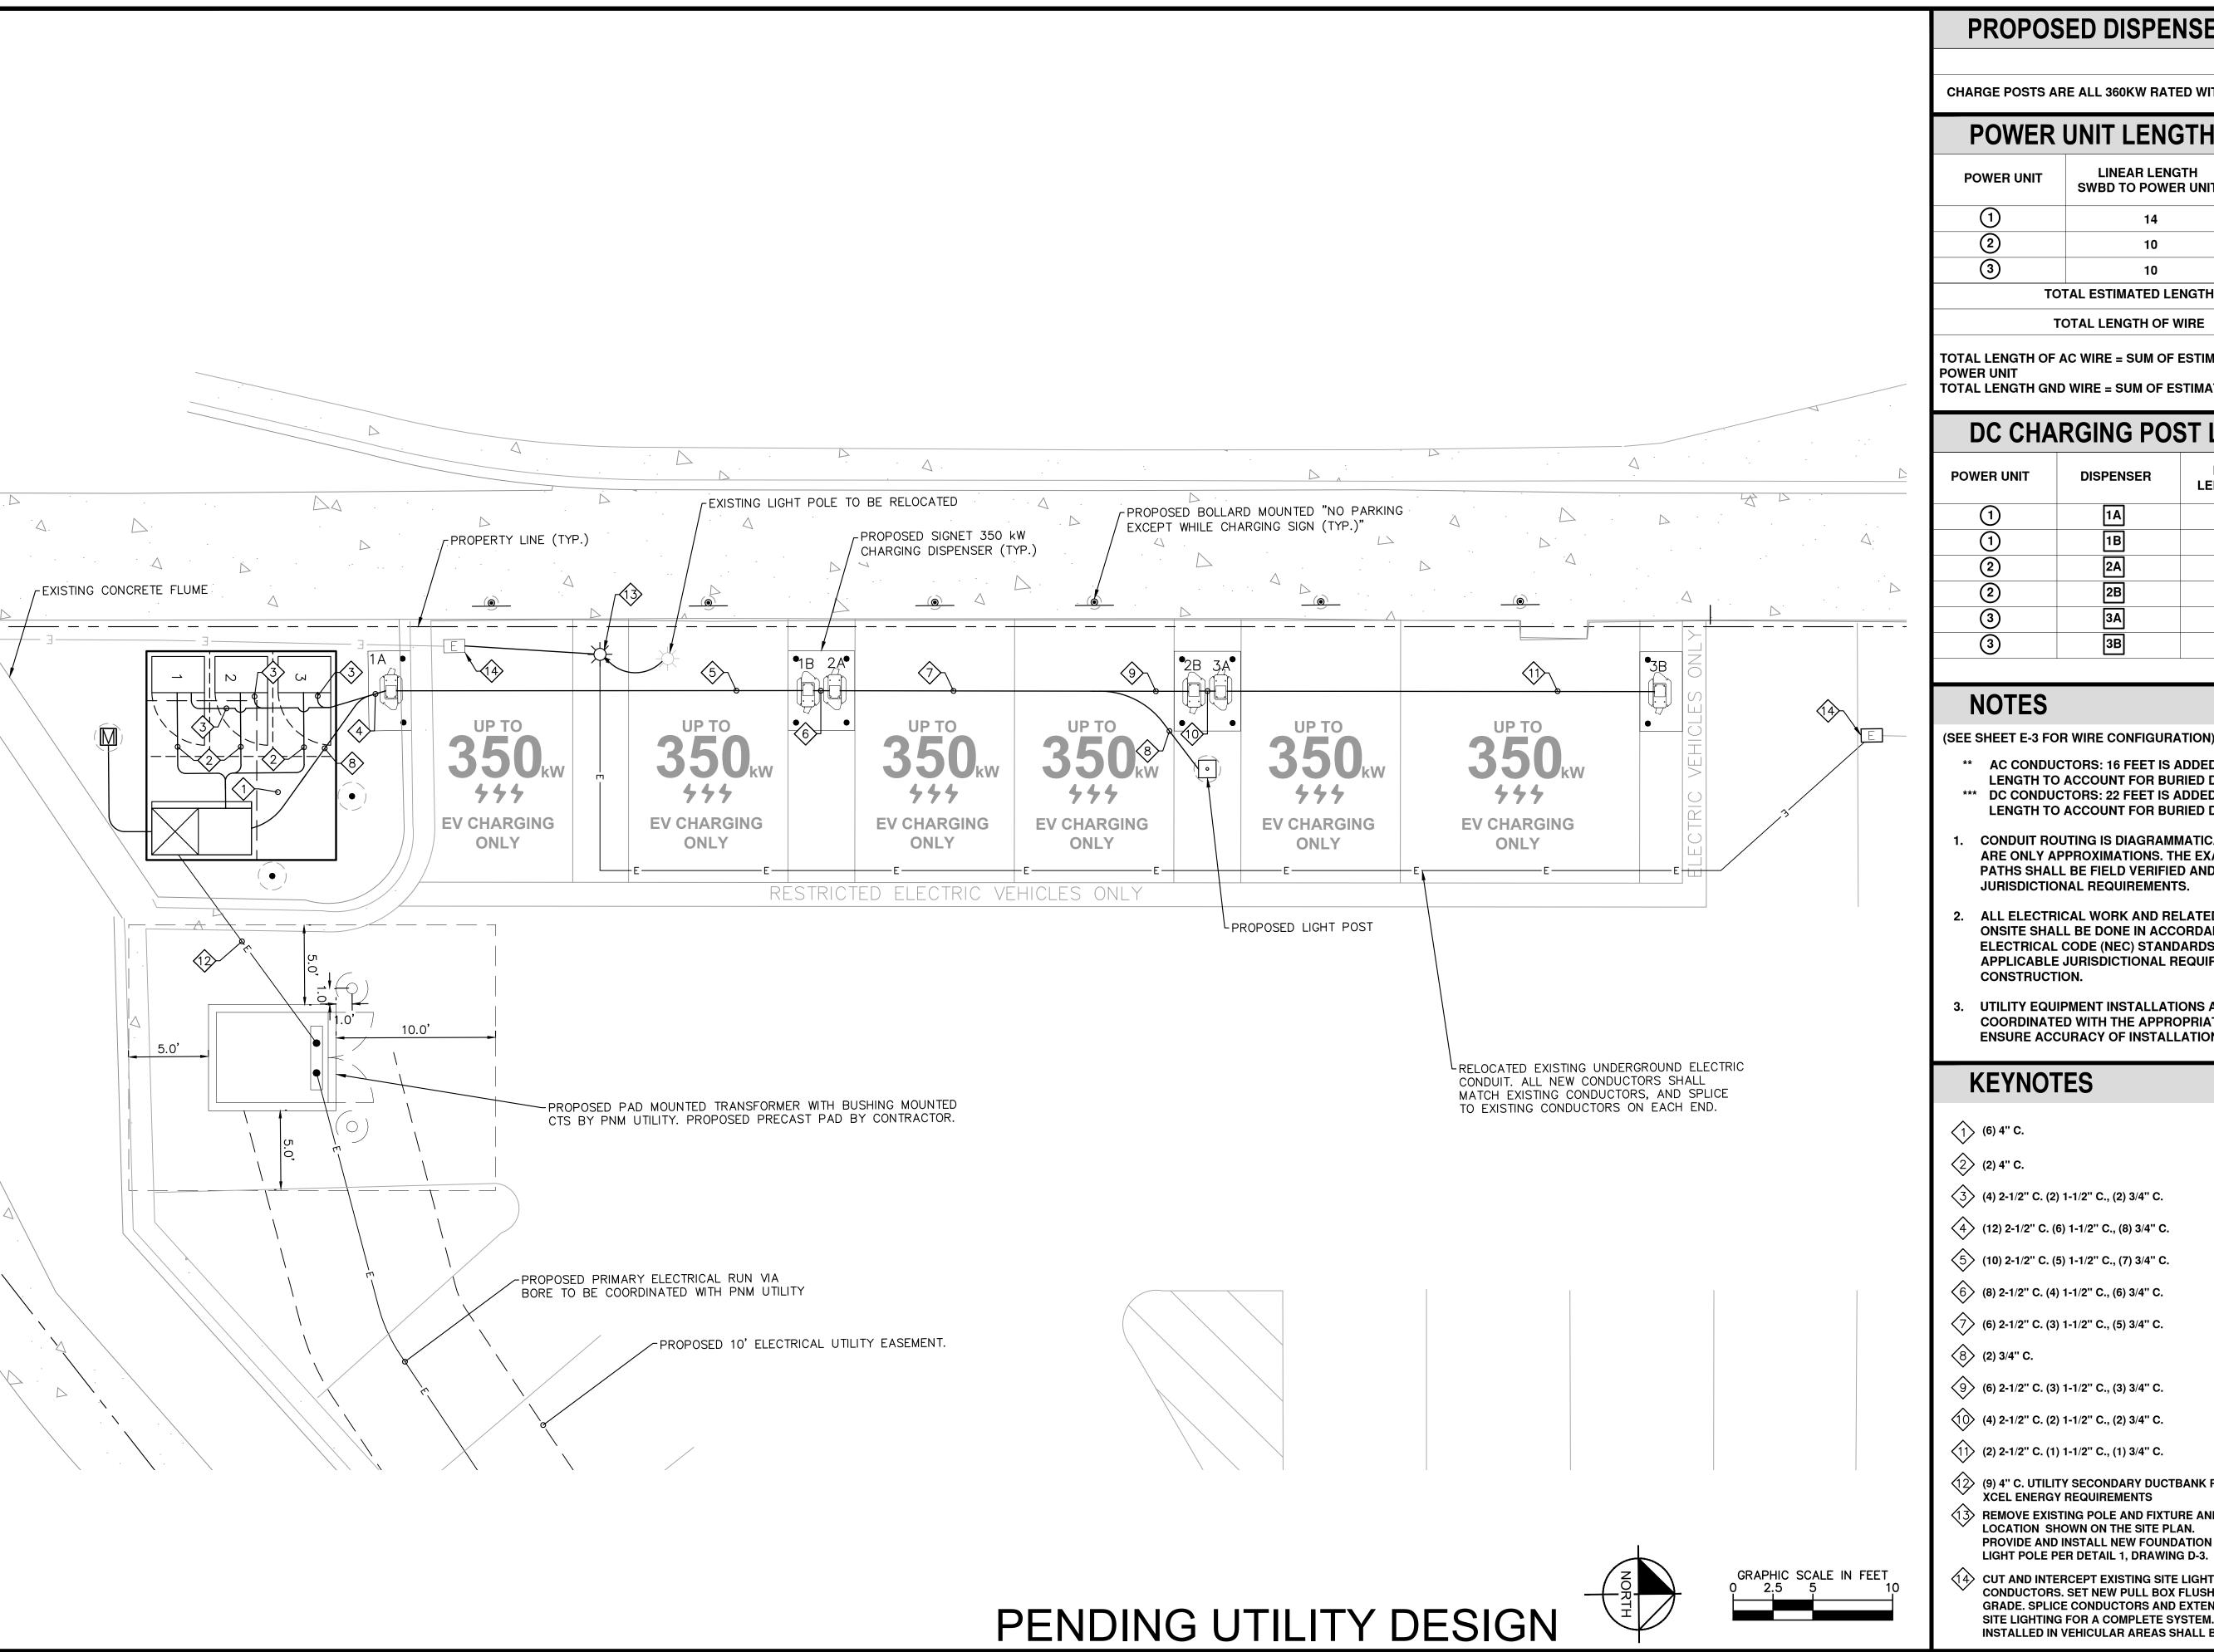

PROPOSED DISPENSERS

CHARGE POSTS ARE ALL 360KW RATED WITH CCS CABLES

POWER UNIT LENGTHS ** ESTIMATED LINEAR LENGTH **SWBD TO POWER UNIT** LENGTH (FT) TOTAL ESTIMATED LENGTH TOTAL LENGTH OF WIRE

TOTAL LENGTH OF AC WIRE = SUM OF ESTIMATED LENGTH x 4 WIRES PER

SUITE 200 RESTON, VA 20191
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4582 S. ULSTER STREET

@ F

electrify americă

LECTRIFY AMERICA, LI 2003 EDMUND HALLEY

SUITE 1500

DENVER, CO 80237 303-288-2300

DESIGNED BY: JR

DRAWN BY: JR CHECKED BY: DSH

DATE: 09/19/2022

- KROGER SMITHS 4 SE, ALBUQUERQUE, NM 87 ECTRICAL PLAN

1240036 - PO YALE BLVD S

NM 320

TOTAL LENGTH GND WIRE = SUM OF ESTIMATED LENGTHS

DC CHA		+	+			
POWER UNIT	DISPENSER	LINEAR LENGTH (FT)	*** ESTIMATED LENGTH (FT)			
1	1A	15	37		\perp	4
1	1B	39	61			
2	2A	37	59			
2	2B	57	79			
3	3A	35	57			
3	3B	60	82			

NOTES

(SEE SHEET E-3 FOR WIRE CONFIGURATION)

- ** AC CONDUCTORS: 16 FEET IS ADDED TO HORIZONTAL RUN LENGTH TO ACCOUNT FOR BURIED DEPTH *** DC CONDUCTORS: 22 FEET IS ADDED TO HORIZONTAL RUN LENGTH TO ACCOUNT FOR BURIED DEPTH
- CONDUIT ROUTING IS DIAGRAMMATICALLY SHOWN ON PLANS AND ARE ONLY APPROXIMATIONS. THE EXACT LOCATION AND ROUTING PATHS SHALL BE FIELD VERIFIED AND INSTALLED PER JURISDICTIONAL REQUIREMENTS.
- 2. ALL ELECTRICAL WORK AND RELATED ACTIVITIES PERFORMED ONSITE SHALL BE DONE IN ACCORDANCE WITH NATIONAL ELECTRICAL CODE (NEC) STANDARDS BEING ENFORCED BY ALL APPLICABLE JURISDICTIONAL REQUIREMENTS AT TIME OF
- UTILITY EQUIPMENT INSTALLATIONS AND PREP WORK SHALL BE COORDINATED WITH THE APPROPRIATE UTILITY ENGINEER TO **ENSURE ACCURACY OF INSTALLATIONS.**

KEYNOTES

(6) 4" C.

(2) 4" C.

(4) 2-1/2" C. (2) 1-1/2" C., (2) 3/4" C.

(12) 2-1/2" C. (6) 1-1/2" C., (8) 3/4" C.

(5) (10) 2-1/2" C. (5) 1-1/2" C., (7) 3/4" C.

6 (8) 2-1/2" C. (4) 1-1/2" C., (6) 3/4" C. (6) 2-1/2" C. (3) 1-1/2" C., (5) 3/4" C.

8 (2) 3/4" C.

(6) 2-1/2" C. (3) 1-1/2" C., (3) 3/4" C.

(4) 2-1/2" C. (2) 1-1/2" C., (2) 3/4" C.

(1) (2) 2-1/2" C. (1) 1-1/2" C., (1) 3/4" C.

(9) 4" C. UTILITY SECONDARY DUCTBANK PER XCEL ENERGY REQUIREMENTS


REMOVE EXISTING POLE AND FIXTURE AND RELOCATE TO LOCATION SHOWN ON THE SITE PLAN. PROVIDE AND INSTALL NEW FOUNDATION FOR RELOCATED

4 CUT AND INTERCEPT EXISTING SITE LIGHTING CONDUIT AND CONDUCTORS. SET NEW PULL BOX FLUSH WITH FINAL GRADE. SPLICE CONDUCTORS AND EXTEND TO EXISTING SITE LIGHTING FOR A COMPLETE SYSTEM. ALL PULL BOXES INSTALLED IN VEHICULAR AREAS SHALL BE TRAFFIC RATED.



196408000 SHEET

E-2

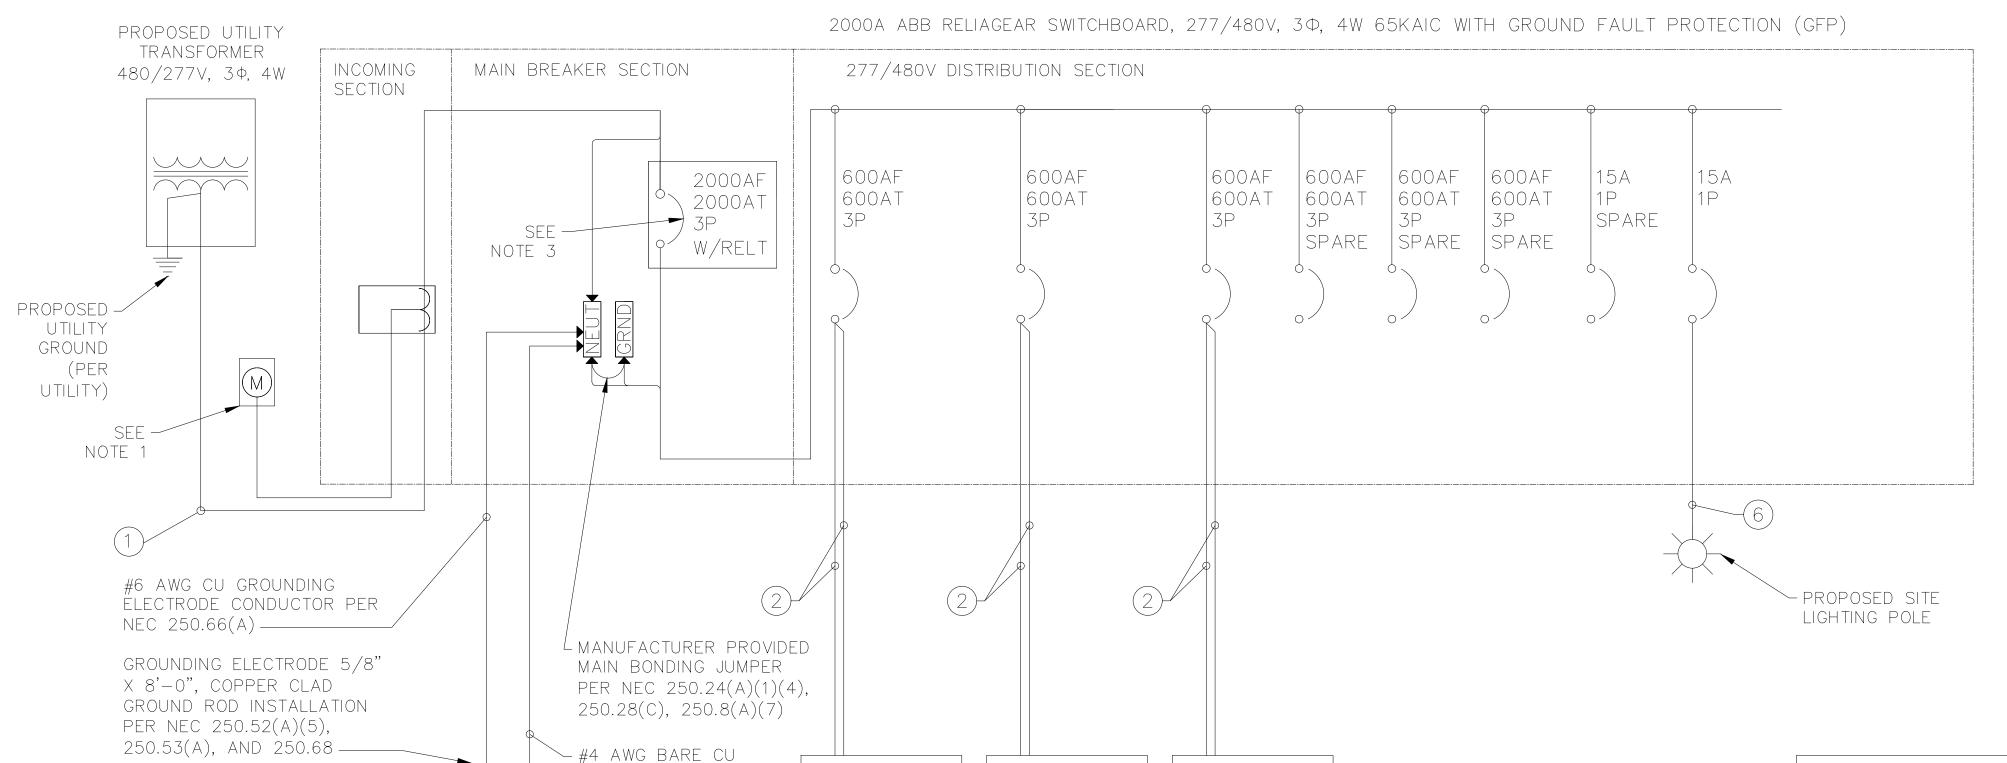

350KW

POWER

UNIT

350KW

DISPENSER

350KW

DISPENSER

DISPENSER

DISPENSER

350KW

POWER

UNIT

#3

SWITCHBOAF	RD NOTES			
LUG QUANTITY AND SIZE	6 SETS OF 600MCM			
ORIENTATION	RIGHT-TO-LEFT			
AMPACITY	2000 AMPS			
TYPE	TALL AND NARROW			

CONDUIT AND WIRING SCHEDULE							
TAG #	FROM	ТО	CONFIGURATION				
1	UTILITY TRANSFORMER	PROPOSED SWITCHBOARD	(3) 600 MCM AL + (1) 600 MCM AL NEUT + IN EACH OF (6) 4" CONDUITS + (3) SPARE 4" CONDUITS				
2	PROPOSED SWITCHBOARD	PROPOSED POWER UNIT (EV CHARGER)	(4) 500 MCM AL + (1) #1 AWG CU EGC IN (1) 4" CONDUIT				
3	PROPOSED POWER UNIT (EV CHARGER)	PROPOSED DC DISPENSER (POST) DC POWER (POS + NEG)	(2) 350 MCM AL 1KV + (1) #2 AWG CU EGC IN (1) 2-1/2" CONDUIT				
4	PROPOSED POWER UNIT (EV CHARGER)	PROPOSED DC DISPENSER (POST) AUXILIARY 480V POWER	(3) #10 AWG CU + (1) #10 AWG CU EGC IN (1) 3/4" CONDUIT				
5	PROPOSED POWER UNIT (EV CHARGER)	PROPOSED DC DISPENSER (POST) COMMUNICATION	(1) FIBER OPTIC CABLE, MM 62.5/125 W/ ST CONNECTORS + (1) #16 AWG TSP + (1) CAT6 CABLE IN (1) 1-1/2" CONDUIT				
6	PROPOSED SWITCHBOARD	PROPOSED SITE LIGHT POLE	(2) #10 AWG CU + (1) #10 AWG CU GND IN (1) 3/4" CONDUIT + (1) 3/4" CONDUIT SPARE				

			••	SWIT	CHB	DARD)"			
VOLTAGE: 277/480			PANE	L BUS:	2000	AMPS				
PHASE, WIRES: 3Ø, 4W SCCR (AMPS): 60,000 PER DI SOURCE: UTILITY TRANS				MAIN:	2000	BREAK	ŒR			
DESCRIPTION	KVA	СВ	CKT	Α	В	С	CKT	СВ	KVA	DESCRIPTION
SITE LIGHTING	0.05	15/1	1	466					129	
	129				931		2	600/3	129	POWER UNIT #
POWER UNIT #1	129	600/3	3			931			129	
	129			931					129	
	0				466		4	600/3	129	POWER UNIT #
SPARE	0	600/3	5			466			129	
	0			0	_			222/2	0	
0D 4 DE	0	000/0	_		0		6	600/3	0	SPARE
SPARE	0	600/3	7			0		45/4	0	CDADI
	0	<u> </u>		0	1207.1	1207.1	8	15/1	0	SPARE
			IOIALS	1397.3	1397.1	1397.1	IAIVIPS			
LOAD CALCULATIONS:	SL	IBTOTAL	_ (KVA):	1161						
MANUFACTURER INST	ALLED RECEP	TACLES	KVA):	0.72						
		TOTAL	_ (KVA):	1162	@ 480\	/, 3Ø =	1398.1 <i>A</i>	MPS		

NOTES

CONCRETE ENCASED

ELECTRODE PER NEC

250.52(A)(3)(1) OR (2)—

- 1. PROPOSED CTS/PTS SHALL BE LOCATED AS APPROVED BY THE UTILITY. PROVIDE REMOTE METERING AS REQUIRED.
- 2. WHEN REQUIRED BY AHJ, A THIRD PARTY SHALL PROVIDE AN ARC FLASH HAZARD ANALYSIS AND DEVICE COORDINATION FOR THE ELECTRICAL EQUIPMENT INSIDE THE FENCED YARD.

GROUNDING ELECTRODE

CONDUCTOR PER NEC

250.66(B)

350KW

POWER

UNIT

DISPENSER

DISPENSER

- 3. MAIN BREAKER IS 100% RATED AND IS EQUIPPED WITH REDUCED ENERGY LET THROUGH (RELT) MAINTENANCE SWITCH WITH LOCAL STATUS INDICATION.
- 4. ALL EV CHARGING EQUIPMENT, POWER UNITS AND DISPENSERS, ARE UL 2202 LISTED AND 65KAIC WITHSTAND RATED.
- 5. WHEN REQUIRED BY THE AHJ, CONTRACTOR SHALL PROVIDE LABEL AT MAIN SERVICE DISCONNECT INDICATING NOMINAL VOLTAGE, AVAILABLE FAULT CURRENT, BREAKER CLEARING TIME, AND DATE OF BREAKER TESTING.
- 6. SWITCHGEAR IS EQUIPPED WITH MANUFACTURER INSTALLED WITH UP TO THREE (3) INTEGRAL CONVENIENCE OUTLETS.
- 7. MAIN BREAKER AND SWITCHGEAR ASSEMBLY SHALL BE 100% RATED. LOAD CALCULATIONS FOR THE SERVICE ARE PERFORMED IN COMPLIANCE WITH NEC 2020 230.42(A)(1), EXCEPTION NO.2.

LOAD			
LOAD DESCRIPTION	KVA	QTY	TOTAL KVA
350KW POWER UNIT	387.00	3	1,161.00
SITE LIGHTING	0.05	1	0.05
RECEPTACLE	0.18	3	0.72
	TOTAL	1,161.77	
	AMPS (480	1,398A	



PENDING UTILITY DESIGN



ELECTRIFY AMERICA, LLC 2003 EDMUND HALLEY DRIVE SUITE 200 RESTON, VA 20191

Kimley » Horr @2022 KIMLEY-HORN AND ASSOCIATES, INC. 4582 S. ULSTER STREET

SUITE 1500


DENVER, CO 80237

303-288-2300

REVISION BY DATE APPR.

DESIGNED BY: JRT
DRAWN BY: JRT
CHECKED BY: DSH
DATE: 09/19/2022


NM240036 - KROGER SMITHS 443 320 YALE BLVD SE, ALBUQUERQUE, NM 87106 SINGLE LINE DIAGRAM

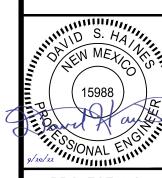



PROJECT NO. 196408000


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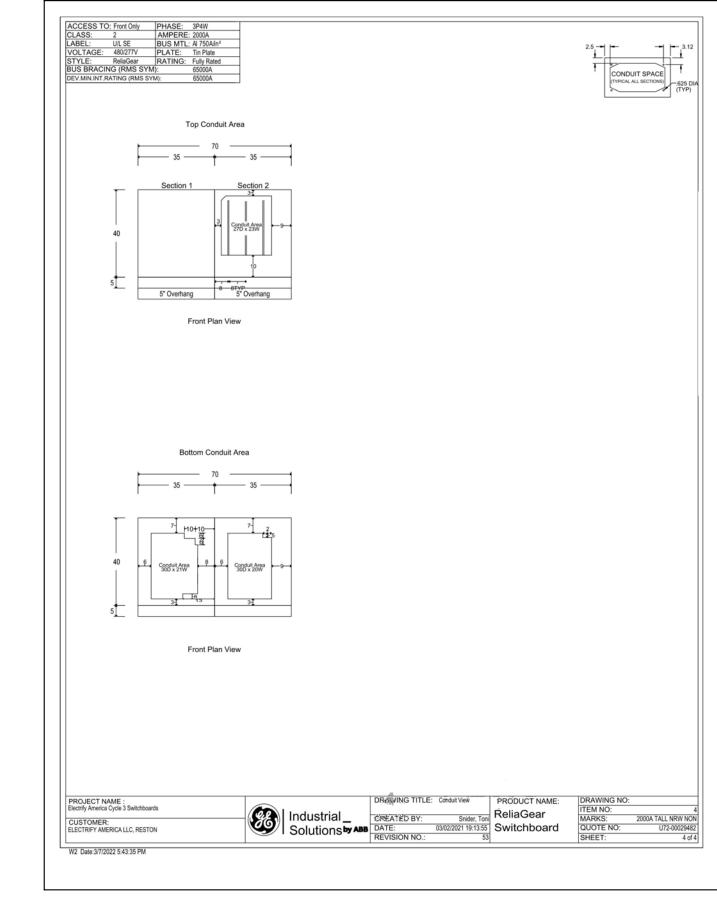
E-3



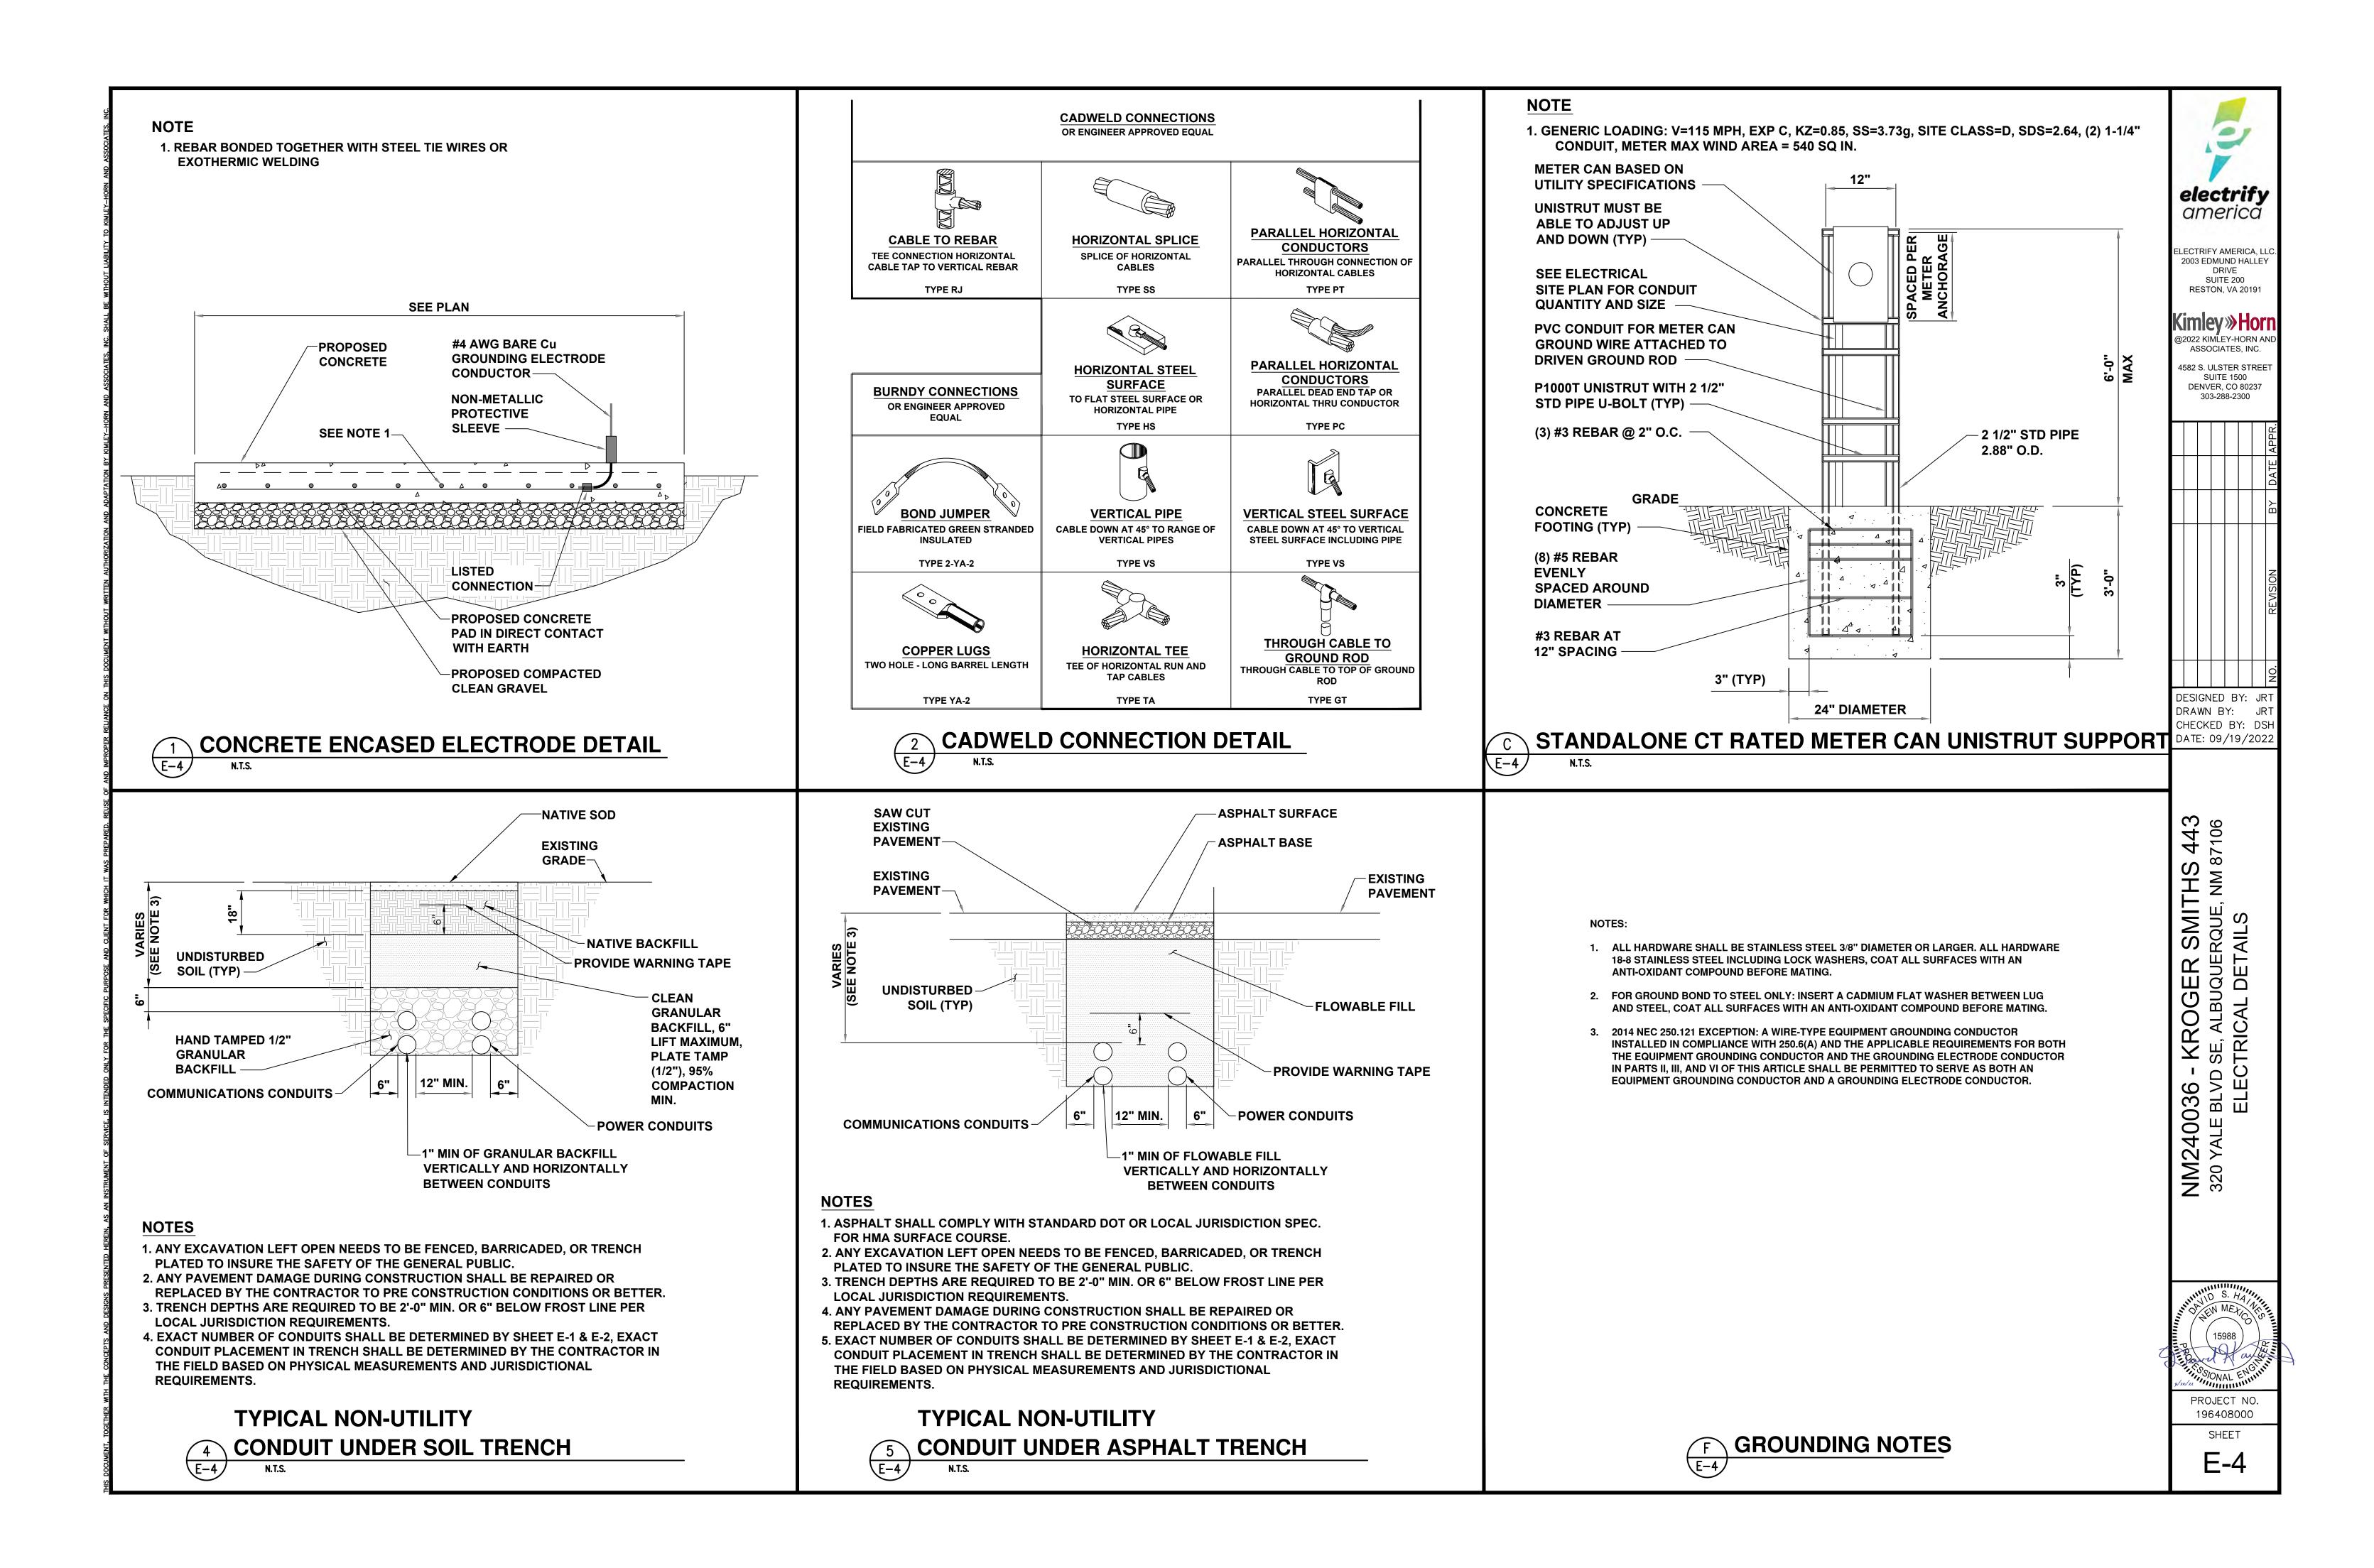

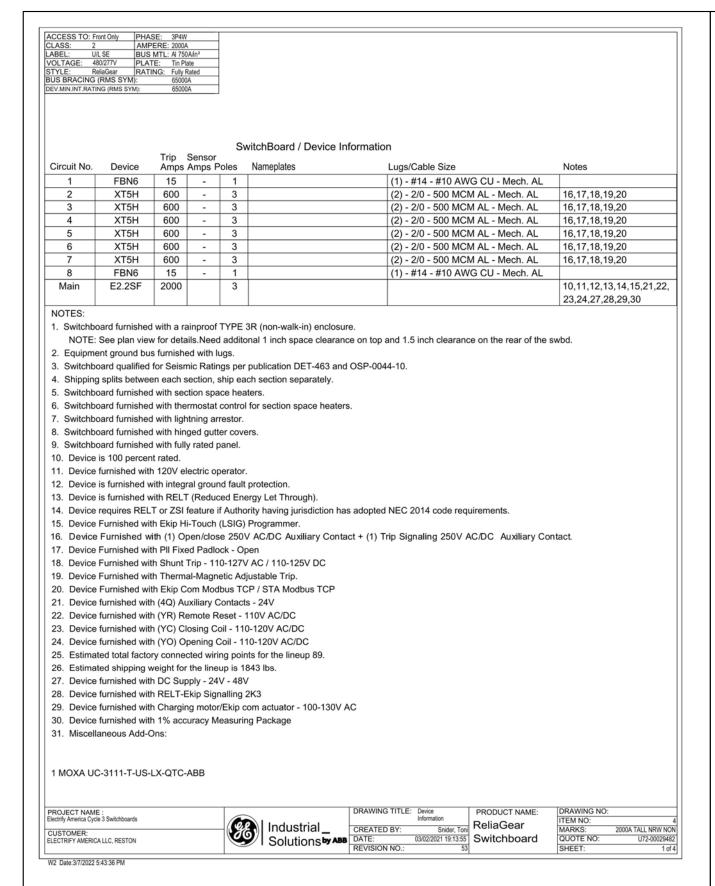

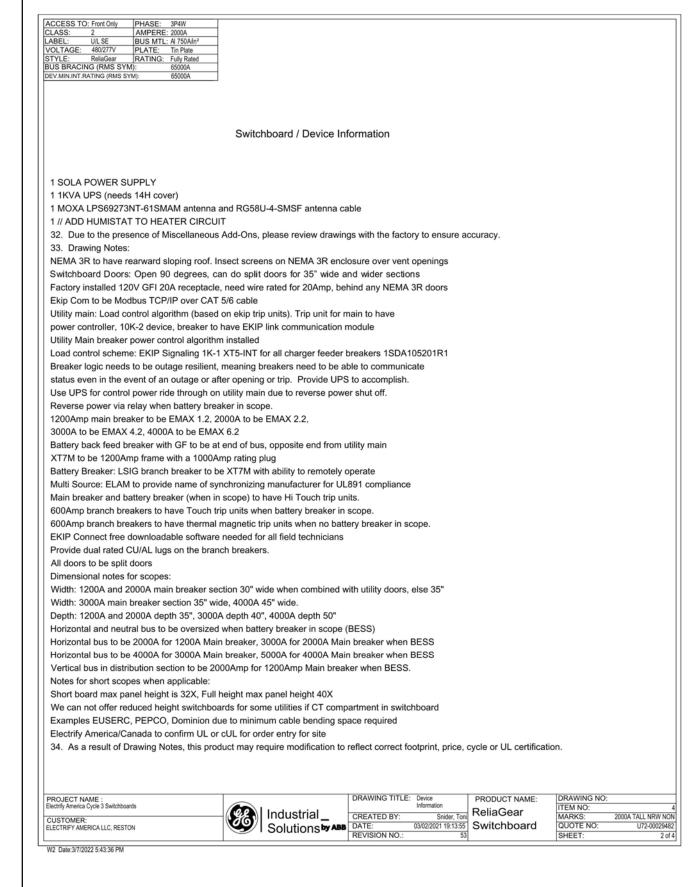

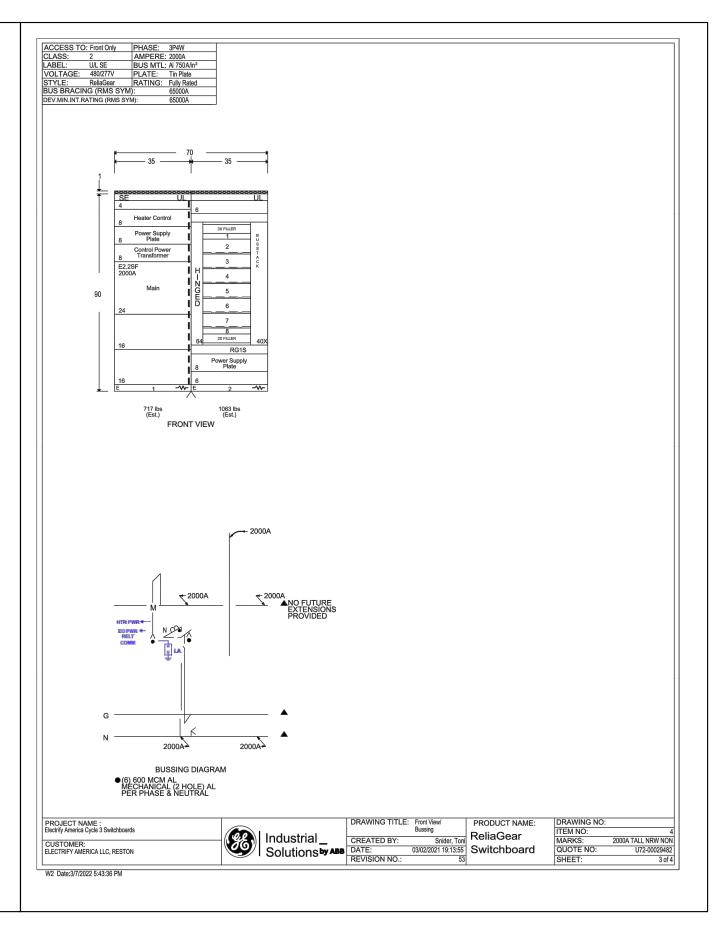

FOR REFERENCE ONLY

electrify america


ELECTRIFY AMERICA, LLC. 2003 EDMUND HALLEY DRIVE SUITE 200 RESTON, VA 20191

Kimley » Horn @2022 KIMLEY-HORN AND ASSOCIATES, INC. 4582 S. ULSTER STREET

SUITE 1500

DENVER, CO 80237

303-288-2300

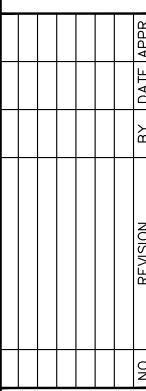


DESIGNED BY: JRT
DRAWN BY: JRT
CHECKED BY: DSH
DATE: 09/19/2022

NM240036 - KROGER SMITHS 443 320 YALE BLVD SE, ALBUQUERQUE, NM 87106 SWITCHGEAR DETAILS

> PROJECT NO. 196408000 SHEET

E-5

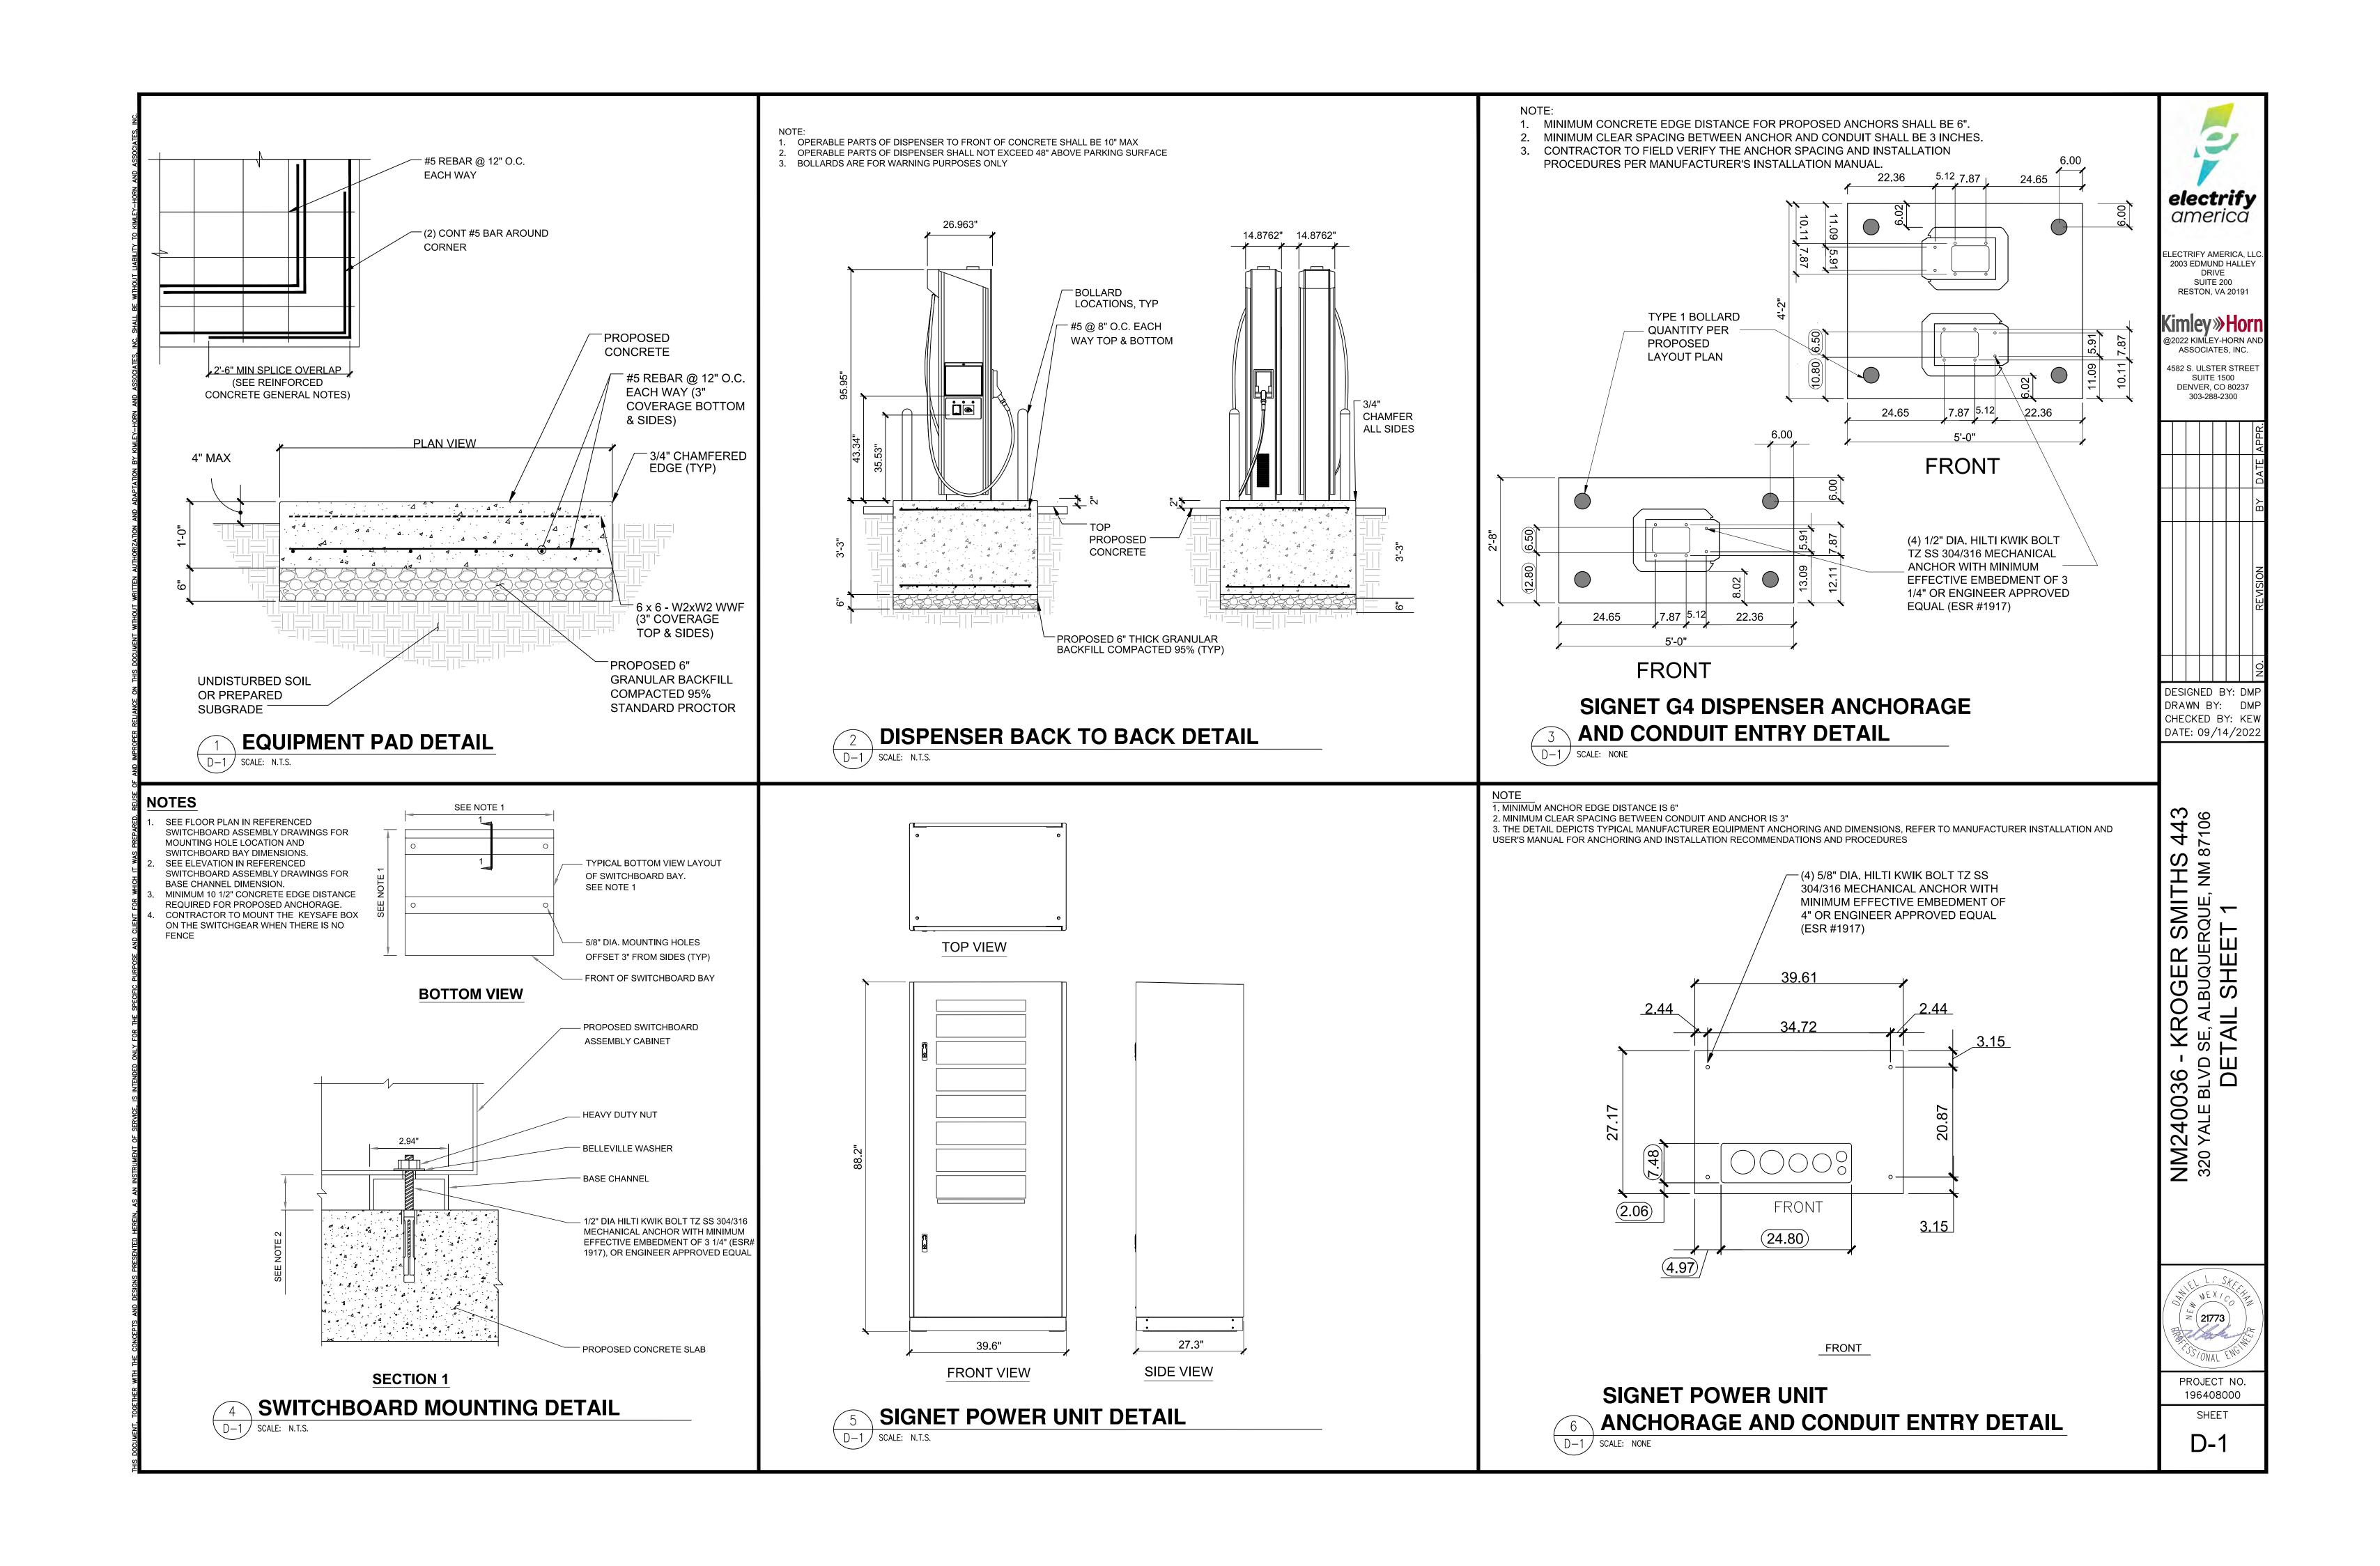

STAINLESS STEEL SLIP -COVER. PART #CSS4000 (PROVIDED BY OTHERS) 3" SCHEDULE 80 STEEL PIPE -FILLED WITH CONCRETE M0.39" x 0.59" SCREW (TYP OF 3) -—FACE OF CURB — EXISTING ASPHALT PROPOSED DISPENSER -FOUNDATION SCREW M0.39"x0.59"


- 1. BOTTOM OF STENCIL TO BE PLACED AT THE LEADING EDGE OF THE PROPOSED PARKING STALL
- 2. STENCIL TO FIT WITHIN DIMENSIONS SHOWN 3. PAVEMENT MARKING TO BE PAINTED WHITE

PAINT SPECIFICATIONS

1. PAINT SHALL BE WATERBORNE OR SOLVENT BORNE, COLORS AS SHOWN OR SPECIFIED HEREIN. PAVEMENT MARKING PAINTS SHALL COMPLY WITH APPLICABLE STATE AND LOCAL LAWS ENACTED TO ENSURE COMPLIANCE WITH FEDERAL CLEAN AIR STANDARDS. PAINT MATERIALS SHALL CONFORM TO THE RESTRICTIONS OF THE LOCAL AIR POLLUTION CONTROL DISTRICT.

WATERBORNE PAINT: PAINTS SHALL CONFORM TO FS TT-P-1952. . SOLVENT BORNE PAINT: PAINT SHALL CONFORM TO FS A-A-2886 OR AASHTO M248. PAINT SHALL BE NON-BLEEDING, QUICK-DRYING, AND PETROLEUM BASE PAINT SUITABLE FOR TRAFFIC-BEARING SURFACE AND BE MIXED IN

ACCORDANCE WITH MANUFACTURER'S INSTRUCTIONS BEFORE APPLICATION . . CONTRACTOR TO BLOCK OF STALLS AFTER PAINTING TO ALLOW PAINT TO DRY PROPERLY WITHOUT ANY CONSTRUCTION ACTIVITIES OR PUBLIC ACCESSING THE AREA WHILE PAINT IS DRYING

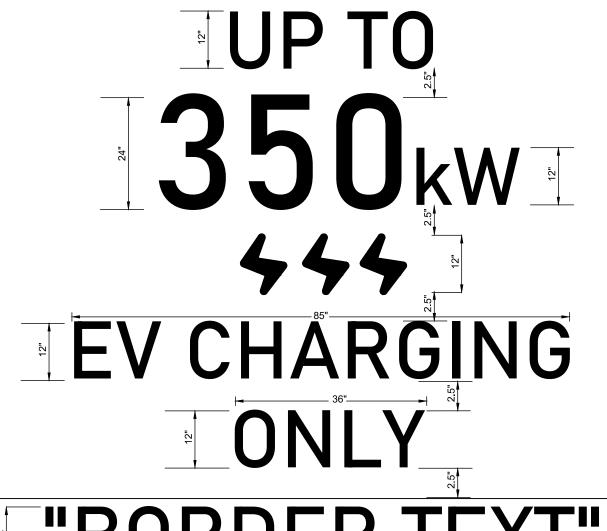

"BORDER TEXT"

1. BORDER PAINTED GREEN (RGB: 135, 204, 151) (HEX:#87CC97)(CMYK: 53/0/51/0) (PMS: 346 C)

2. PAVEMENT MARKINGS TO BE 12" WHITE LETTERS INSIDE BORDER TO STATE "RESTRICTED ELECTRIC VEHICLES


ONLY" ON BOTTOM AND "ELECTRIC VEHICLES ONLY" ON SIDES 3. ** BOTTOM BORDER TO BE 18" IN WIDTH AND SIDE BORDER TO BE 16"

EV PAVEMENT MARKING DETAIL

D-2 SCALE: N.T.S.

NOTES

- 1. BOTTOM OF LOWEST SIGN SHALL BE INSTALLED 66" ABOVE GRADE.
- 2. TO CONFORM WITH MUTCD SIGNS R-113, R-111-L AND R-111-R. 3. SIGNS ARE TO HAVE A WHITE RETROREFLECTIVE BACKGROUND
- WITH RED RETROREFLECTIVE LETTERS, ARROW, AND BORDER 4. SIGNS ARE TO HAVE BLUE RETROREFLECTIVE "EV SYMBOL" PER
- CDOT R7-113r CO SIGN

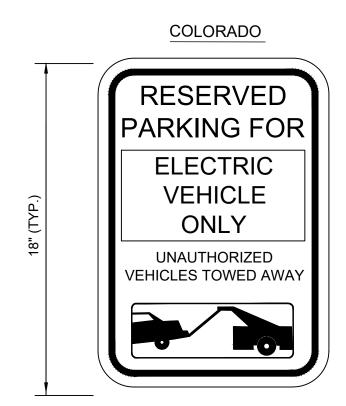

NO PARKING SIGN

CONTRACTOR TO SELECT CONCRETE FOOTING OR BOLT DOWN BASED ON EXISTING CONDITIONS.

DISPENSER BOLLARD (TYPE 1)

SEE SHEET C-3 FOR PLACEMENT. BOTTOM OF LOWEST SIGN TO BE INSTALLED 66" ABOVE GRADE.

1. BOLLARD IS FOR WARNING PURPOSES ONLY.

OVER TOP OF STEEL PIPE TO STABILIZE SLIP COVER.


BOLLARD DETAIL FOR BOLLARDS AROUND ELECTRIFY AMERICA EQUIPMENT.

CONTRACTOR TO PROVIDE (2) 6' LONG, 1/2" THICK FOAM STRIPS CROSSED


- 4. ADDITIONAL PARKING SIGNS TO BE INSTALLED 2" ABOVE TOP OF PREVIOUS SIGN.
- 5. SIGN, SIGN POST, AND SIGN FASTENERS TO BE PROVIDED BY CONTRACTOR. CONTRACTOR TO PROVIDE SIGN POST FASTENERS IF REQUIRED AND PAINTED TO MATCH.
- 6. IF PAINT FINISH IS DAMAGED DURING INSTALLATION, CONTRACTOR SHALL REPAINT AS REQUIRED.
- 7. CONTRACTOR SHALL COORDINATE WITH CITY WHEN SPECIAL JURISDICTIONAL/CITY REQUESTS ARE NECESSARY FOR ANY SIGN POST INSTALLATION, I.E. POST MATERIAL, PAINT COLORS, HARDWARE, ETC. CONTRACTOR IS RESPONSIBLE FOR ENSURING CITY APPROVES ALL MATERIALS PRIOR TO CONSTRUCTION

BOLT DOWN BASE PLATE NOTES

- . CONTRACTOR TO PROVIDE AND INSTALL SIGN POST, BASE PLATE ASSEMBLY, EXPANSION ANCHORS, AND 1/2" DIA A307
- 2. BASE PLATE ASSEMBLY TO BE HOT DIPPED GALVANIZED. PAINT TO MATCH SIGN POST.
- 3. PROVIDE 1/4" DIA. DRAIN HOLE TO PREVENT WATER FROM COLLECTING IN HSS.

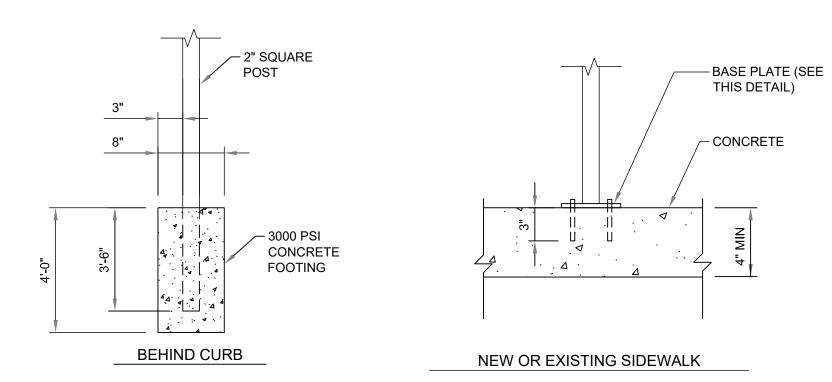

SIGN POST INSTALLATION DETAIL

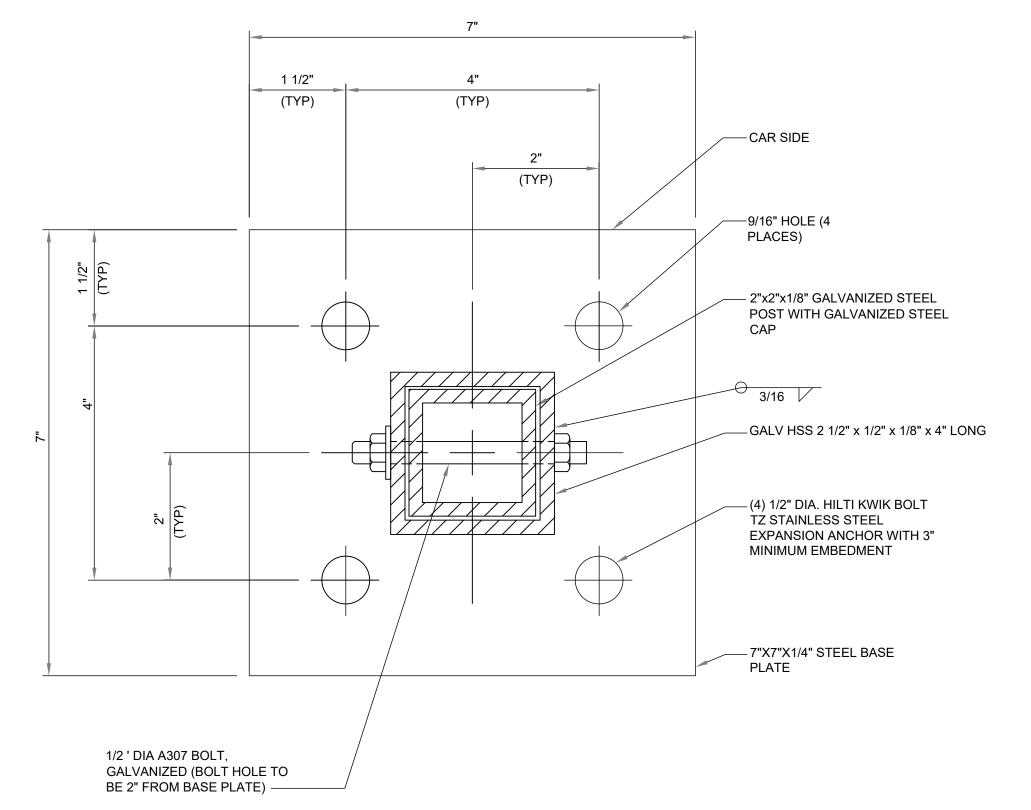

BASE PLATE DETAIL -DETAIL 1

01 electrify america

> LECTRIFY AMERICA, L 2003 EDMUND HALLEY SUITE 200 RESTON, VA 20191

D2022 KIMLEY-HORN AN

ASSOCIATES, INC. 1582 S. ULSTER STREE SUITE 1500 DENVER, CO 80237 303-288-2300

DESIGNED BY: DMF DRAWN BY: DMF CHECKED BY: KEW DATE: 09/14/2022


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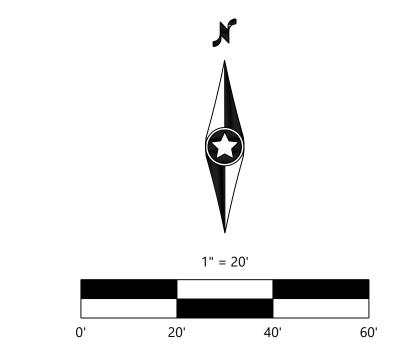
40036 ALE BLVI $\langle \mathcal{A} \rangle$

> = (**21773**) STONAL EN

> > PROJECT NO. 196408000 SHEET

D-2



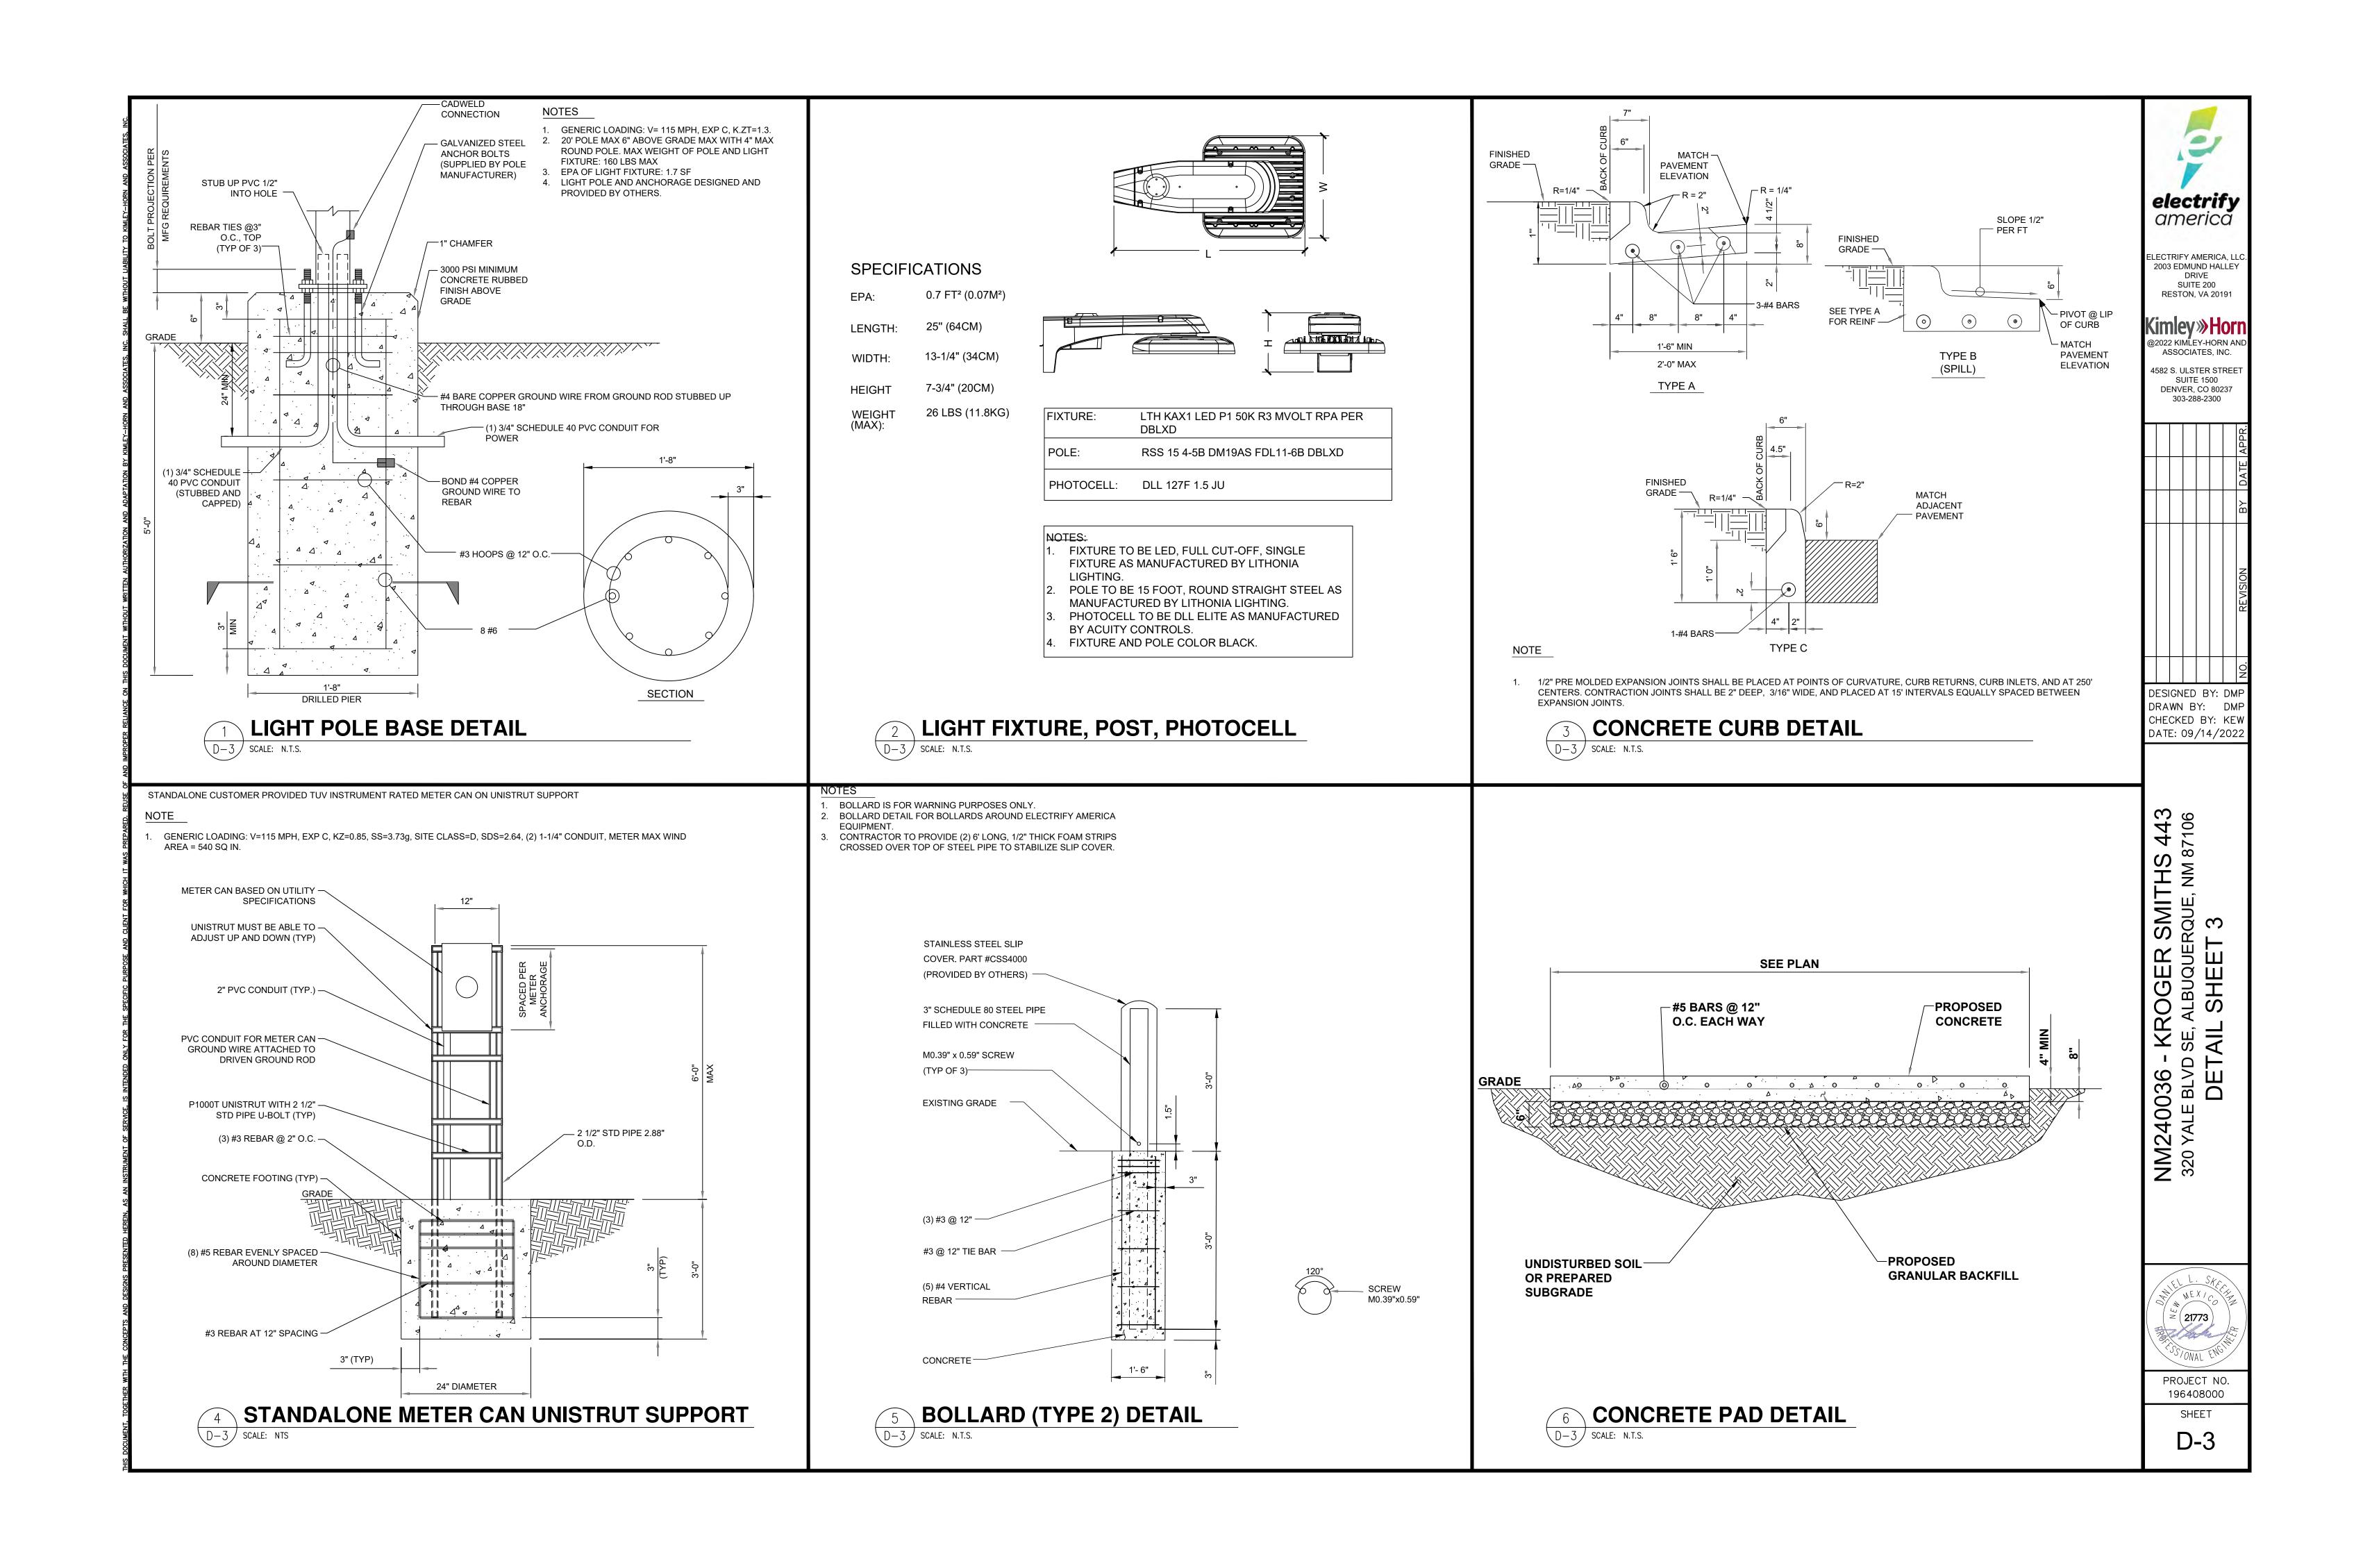

REPORT ORD-692326-G8W8Y9

LEGAL DESCRIPTIONS PER TITLE

Tract W-D of the Summary Plat (Formerly Lots 6 thru 15 in Block 3, vacated portion of Alley and of Highland Avenue and portion of Lots 1 and 2 in Block 4), UNIVERSITY HEIGHTS ADDITION, Albuquerque, New Mexico, as the same is shown and designated on the recorded plat of said addition, filed in the office of the County Clerk of Bernalillo County, New Mexico, on May 23, 1978.

LEGAL DESCRIPTIONS PER TITLE **REPORT ORD-692327-Y5Q4X7**

The Easterly Eight (8) feet of vacated alley adjacent to Lot 16, Block 3, UNIVERSITY HEIGHTS ADDITION, as the same is shown and designated on the Map of said Addition, filed in the office of the County Clerk of Bernalillo County, New Mexico on February 7, 1916. Said alley vacated by Environmental Planning Commission Land Controls Board Resolution V-77-30, filed for record with the County Clerk of Bernalillo County, New Mexico on November 22, 1978 in Book Misc 652 page 829.

ITEMS OF RECORD PER TITLE **REPORT ORD-692326-G8W8Y9 AND ORD-692327-Y5Q4X7**

Grant of Easement 06/15/1983 Document No. 83 38655 (SHOWN ON SURVEY) Grant of Easement 06/15/1983 Document No. 83 38656 (SHOWN ON SURVEY) 3) Grant of Easement 07/29/1983 Document No. 83 50403 (SHOWN ON SURVEY)

SURVEYOR'S NOTES

1. This survey was prepared using First Corporate Solutions, Title Report Number ORD-692326-G8W8Y9 and ORD-692327-Y5Q4X7 having an effective date of November 18, 2021.

2. The underground utilities shown have been located from field survey information provided by MT Private Utility Locating Services, LLC. on 11/24/2021. The surveyor makes no guarantees that the underground utilities shown comprise all such utilities in the area, either in service or abandoned. The surveyor further does not warrant that the underground utilities shown are in the exact location indicated although he does certify that they are located as accurately as possible from information available. The surveyor has not physically located the underground utilities.

3. Subject property appears to be classified as (Zone X and AO), when scaled from Flood Insurance Rate Map Community- Panel

4. The subject property is zoned (MX-L, Mixed Use Low Intensity). No zoning information was provided by the client. For zoning code, contact the City of Albuquerque, NM Planning and Zoning Department.

5. Elevations are based of NAVD88 Datum. Benchmark: $(\frac{5}{8}"$ Rebar), as shown hereon. Elevation: 5166.55

6. This is a topographic survey. This is not a boundary survey and is only intended to depict those features or improvements shown. The property lines shown are approximate record lines only and are shown for graphical reference only per Warranty Deed 79 30635. The right of way of Yale Boulevard is shown per the plat of University Heights Addition.

7. Bearings shown are based upon NAD83 New Mexico State Planes, Central Zone, US Foot.

SURVEYOR'S STATEMENT

I hereby certify that this plan was prepared by me or under my direct supervision and that I am a duly licensed LAND SURVEYOR under the laws of the State of New Mexico.

DATE 12/14/2021 NM LICENSE NO. 18330, EXPIRATION 12/31/2022

I ECENID.

LEGEND:			
<u></u>	SANITARY MANHOLE	8	STEEL/WOOD POST
<u></u>	SEWER CLEANOUT	-o-	SIGN
(3)	STORM MANHOLE	~	FLAG POLE
	CATCH BASIN		CONIFEROUS TREE
	STORM INTERCEPTOR	卷	DECIDUOUS TREE
©	HYDRANT	4	CACTUS
X	GATE VALVE		PALM TREE
\boxtimes	WATER METER	FO	FIBER OPTIC PEDESTAL
~	FIRE DEPARTMENT CONNECTION	Ø	NATURAL GAS METER
-⊗-⊗-	DOUBLE DETECTOR CHECK VALVE		UNKNOWN MANHOLE
E	ELECTRIC BOX	M	MISCELLANEOUS METER
Œ	ELECTRIC METER	М	MISCELLANEOUS PEDESTAL
(ELECTRIC MANHOLE		BOUNDARY LINE
*	STREET LIGHT	——— GAS ———	GAS LINE
Ş	POWER POLE	——— РОН ———	POWER OVERHEAD
o	MAST ARM	——— PUG ———	POWER UNDERGROUND
o — — — — — — — — — — — — — — — — — — —	MAST ARM W/ LIGHT	——— SAN ———	SANITARY SEWER
8	TRAFFIC SIGNAL	STO	STORM SEWER
T	TELEPHONE BOX	——— WAT ———	WATERMAIN
	TELEPHONE MANHOLE		CURB & GUTTER
НН	HAND HOLE/JUNCTION BOX		CONCRETE SURFACE
TV	CABLE TV BOX		BITUMINOUS SURFACE
•	FOUND MONUMENT (SEE LABEL)		CONCRETE PAVER SURFAC

VICINITY MAP



CHECKED: HORIZONTAL SCALE:

PREPARED FOR: **REVISIONS: Electrify America, LLC** 2003 Edmund Halley Drive Reston, VA 20191

Westwood

(952) 937-5150 12701 Whitewater Drive, Suite #300 (952) 937-5822 Minnetonka, MN 55343 (888) 937-5150 **westwoodps.com**

PID: 101605702612731206 OWNER: SIMBANA NINA & GRIFFITHS ELLEN JEAN & JOSE SIMBANA

PID: 101605702612231205

SIDEWALK EASEMENT PER -, ~

DOC. NO. 83 38655

OWNER: ARNOT GAIL A &

ESTRADA MARTIN J

UNIVERSITY HEIGHTS ADDITION

BLOCK 3

- MISCELLANEOUS LINE

- WATERLINE

UTILITY EASEMENT

- RIM=5167.07

- 1/2" REBAR /

ELEV=5166.55

INV=5158.57 N/S 6 PVC

PID: 101605701011931217 OWNER: SMITHS FOOD KING PROPS INC

- BUILDING CANOPY

·/----------

FIRE HYDRANT EASEMENT -

PER DOC. NO. 83 38656 /

C/O NICKEL & CO LLC

SUMMARY PLAT, TRACT WD, UNIVERSITY HEIGHTS ADDITION

EXISTING BUILDING

- MISCELLANEOUS LINE

LOT 16

SITE 240036 SMITHS 443 320 YALE BLVD SE ALBUQUERQUE, NM

Topographic Survey

A PORTION OF TRACT W-D OF THE SUMMARY PLAT, UNIVERSITY HEIGHTS ADDITION, CITY OF ALBUQUERQUE, BERNALILLO COUNTY, NM

SHEET NUMBER:

PROJECT NUMBER: 0034170.AX DATE: 12/14/2021

OF