



4. Windows facing west shall use heat mitigation features.

for every 30 feet of facade length.

transparent windows and/or doors.

requirements in 1 or 2 above.

5. The façade shall have at least one element that is recessed or projected from the façade by at least 6 inches and that is 2 feet in width

8. Balcony massing, material, or color shall vary to create visual interest. Solid balconies shall not obscure the street-level view of required

7. Art, such as murals or sculpture, that is privately-owned or coordinated through the City Public Arts Program, may count toward

6. Each street-facing façade shall be designed with more than one building finish material or color.

OPUS THE OPUS GROUP

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DESIGN ARCHITECT

PROJECT

TRANSPORT MF

PROJECT ADDRESS

Albuquerque, NM

PROJECT NUMBER 32176000

ISSUE RECORD

2024-07-08
PROJECT MANAGER

DRAWN BY
TG
CHECKED BY

REGISTRATION

SHEET TITLE

Conceptual Exterior Elevations - Buildings A1 and A2

SHEET NUMBER

15



(1a) CLADDING STUCCO TAN (1b) CLADDING STUCCO BROWN (2) CLADDING STUCCO BLUE (3) ART APPLIQUE (4) BRONZE RESIDENTIAL WINDOWS AND DOORS (5) BRONZE METAL RAILING (6) BRONZE COLORED LINTEL ELEMENT (7) BRONZE STOREFRONT WINDOW SYSTEM (8) BRONZE VIGA ELEMENT (9) BLUE METAL CANOPY (10) BROWN COPING TO MATCH STUCCO (11) BRONZE COPING (12) BRONZE METAL CANOPY SCUPPERS AND DOWNSPOUTS TO MATCH ADJACENT MATERIAL

2. The ground floor of each street-facing façade shall contain a minimum of 20 percent of its surfaces in transparent windows and/or doors.

**MATERIAL KEY** 

5. The façade shall have at least one element that is recessed or projected from the façade by at least 6 inches and that is 2 feet in width

6. Each street-facing façade shall be designed with more than one building finish material or color.
7. Art, such as murals or sculpture, that is privately-owned or coordinated through the City Public Arts Program, may count toward

8. Balcony massing, material, or color shall vary to create visual interest. Solid balconies shall not obscure the street-level view of required



BUILDING B - EAST ELEVATION



BUILDING B - WEST ELEVATION

1" = 10'-0"

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**ISSUE RECORD** 


2024-07-08 PROJECT MANAGER

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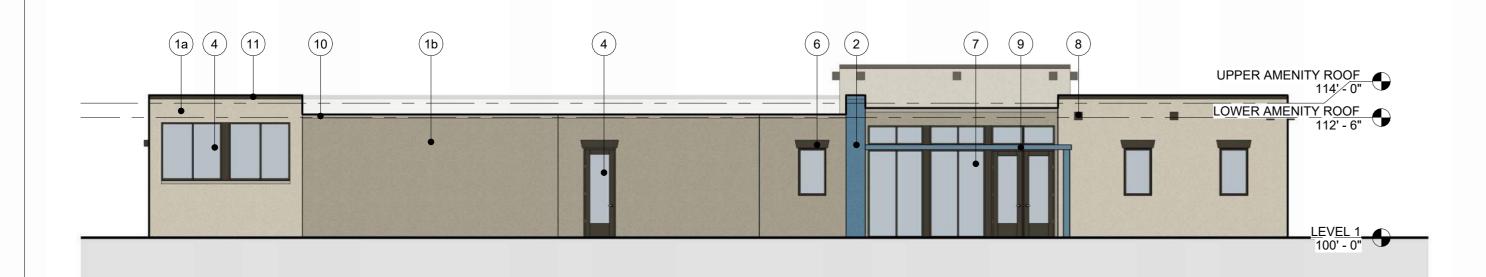
REGISTRATION

**Conceptual Exterior** Elevations - Buildings B1 and B2


SHEET NUMBER

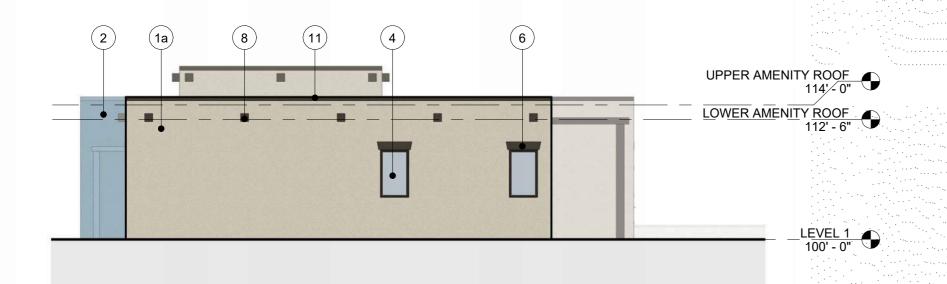

## AMENITY BUILDING - NORTH ELEVATION



## AMENITY BUILDING - EAST ELEVATION 2 AMEN 1" = 10'-0"

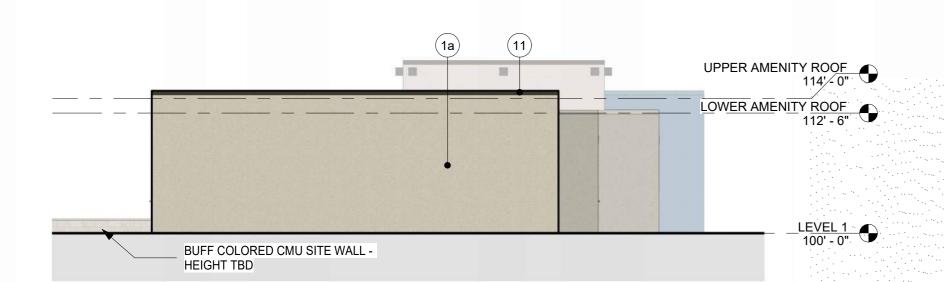

## 3 AMENITY BUILDING - SOUTH ELEVATION




## AMENITY BUILDING - WEST ELEVATION

- 1. Building Entrances All Exterior doors to have weather stripping and sweep. 2. The ground floor of each street-facing façade shall contain a minimum of 20 percent of its surfaces in transparent windows and/or doors. 3. Windows on the upper floors shall be recessed or projected not less than 2 inches and/or shall be surrounded by a window casing or
- frame not less than 2 inches wide. 4. Windows facing west shall use heat mitigation features.
- 5. The façade shall have at least one element that is recessed or projected from the façade by at least 6 inches and that is 2 feet in width for every 30 feet of facade length.
- 6. Each street-facing façade shall be designed with more than one building finish material or color.7. Art, such as murals or sculpture, that is privately-owned or coordinated through the City Public Arts Program, may count toward


8. Balcony massing, material, or color shall vary to create visual interest. Solid balconies shall not obscure the street-level view of required transparent windows and/or doors.




AMENITY BUILDING - NORTH ELEVATION 2

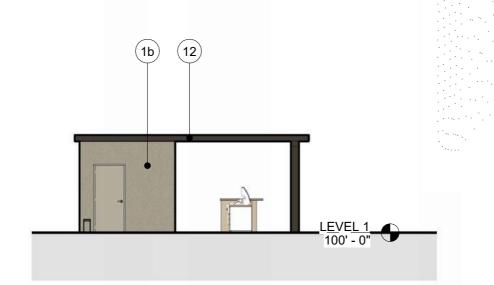

AMENITY BUILDING - EAST ELEVATION 2

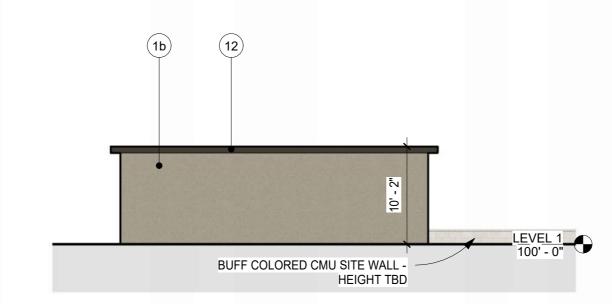

7 AMENITY BUILDING - SOUTH ELEVATION 2

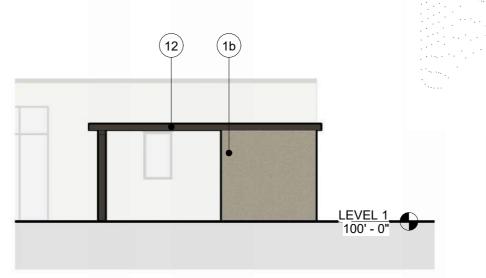

AMENITY BUILDING - WEST ELEVATION 2



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DESIGN ARCHITECT

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**ISSUE RECORD** 

2024-07-08 PROJECT MANAGER

REGISTRATION

Conceptual Exterior **Elevations - Amenity** Building

SHEET NUMBER

DRAWN BY TG **MATERIAL KEY** CHECKED BY (1a) CLADDING STUCCO TAN

- (1b) CLADDING STUCCO BROWN
- (2) CLADDING STUCCO BLUE
- (3) ART APPLIQUE
- (5) BRONZE METAL RAILING
- (6) BRONZE COLORED LINTEL ELEMENT
- (7) BRONZE STOREFRONT WINDOW SYSTEM

(4) BRONZE RESIDENTIAL WINDOWS AND DOORS

- (8) BRONZE VIGA ELEMENT
- (9) BLUE METAL CANOPY
- (10) BROWN COPING TO MATCH STUCCO
- (11) BRONZE COPING
- (12) BRONZE METAL CANOPY

ADJACENT MATERIAL

SCUPPERS AND DOWNSPOUTS TO MATCH