


ADMINISTRATIVE AMENDMENT

FILE #: _____ PROJECT #: _____

APPROVED BY

DATE

11/15/2023 8:06 AM

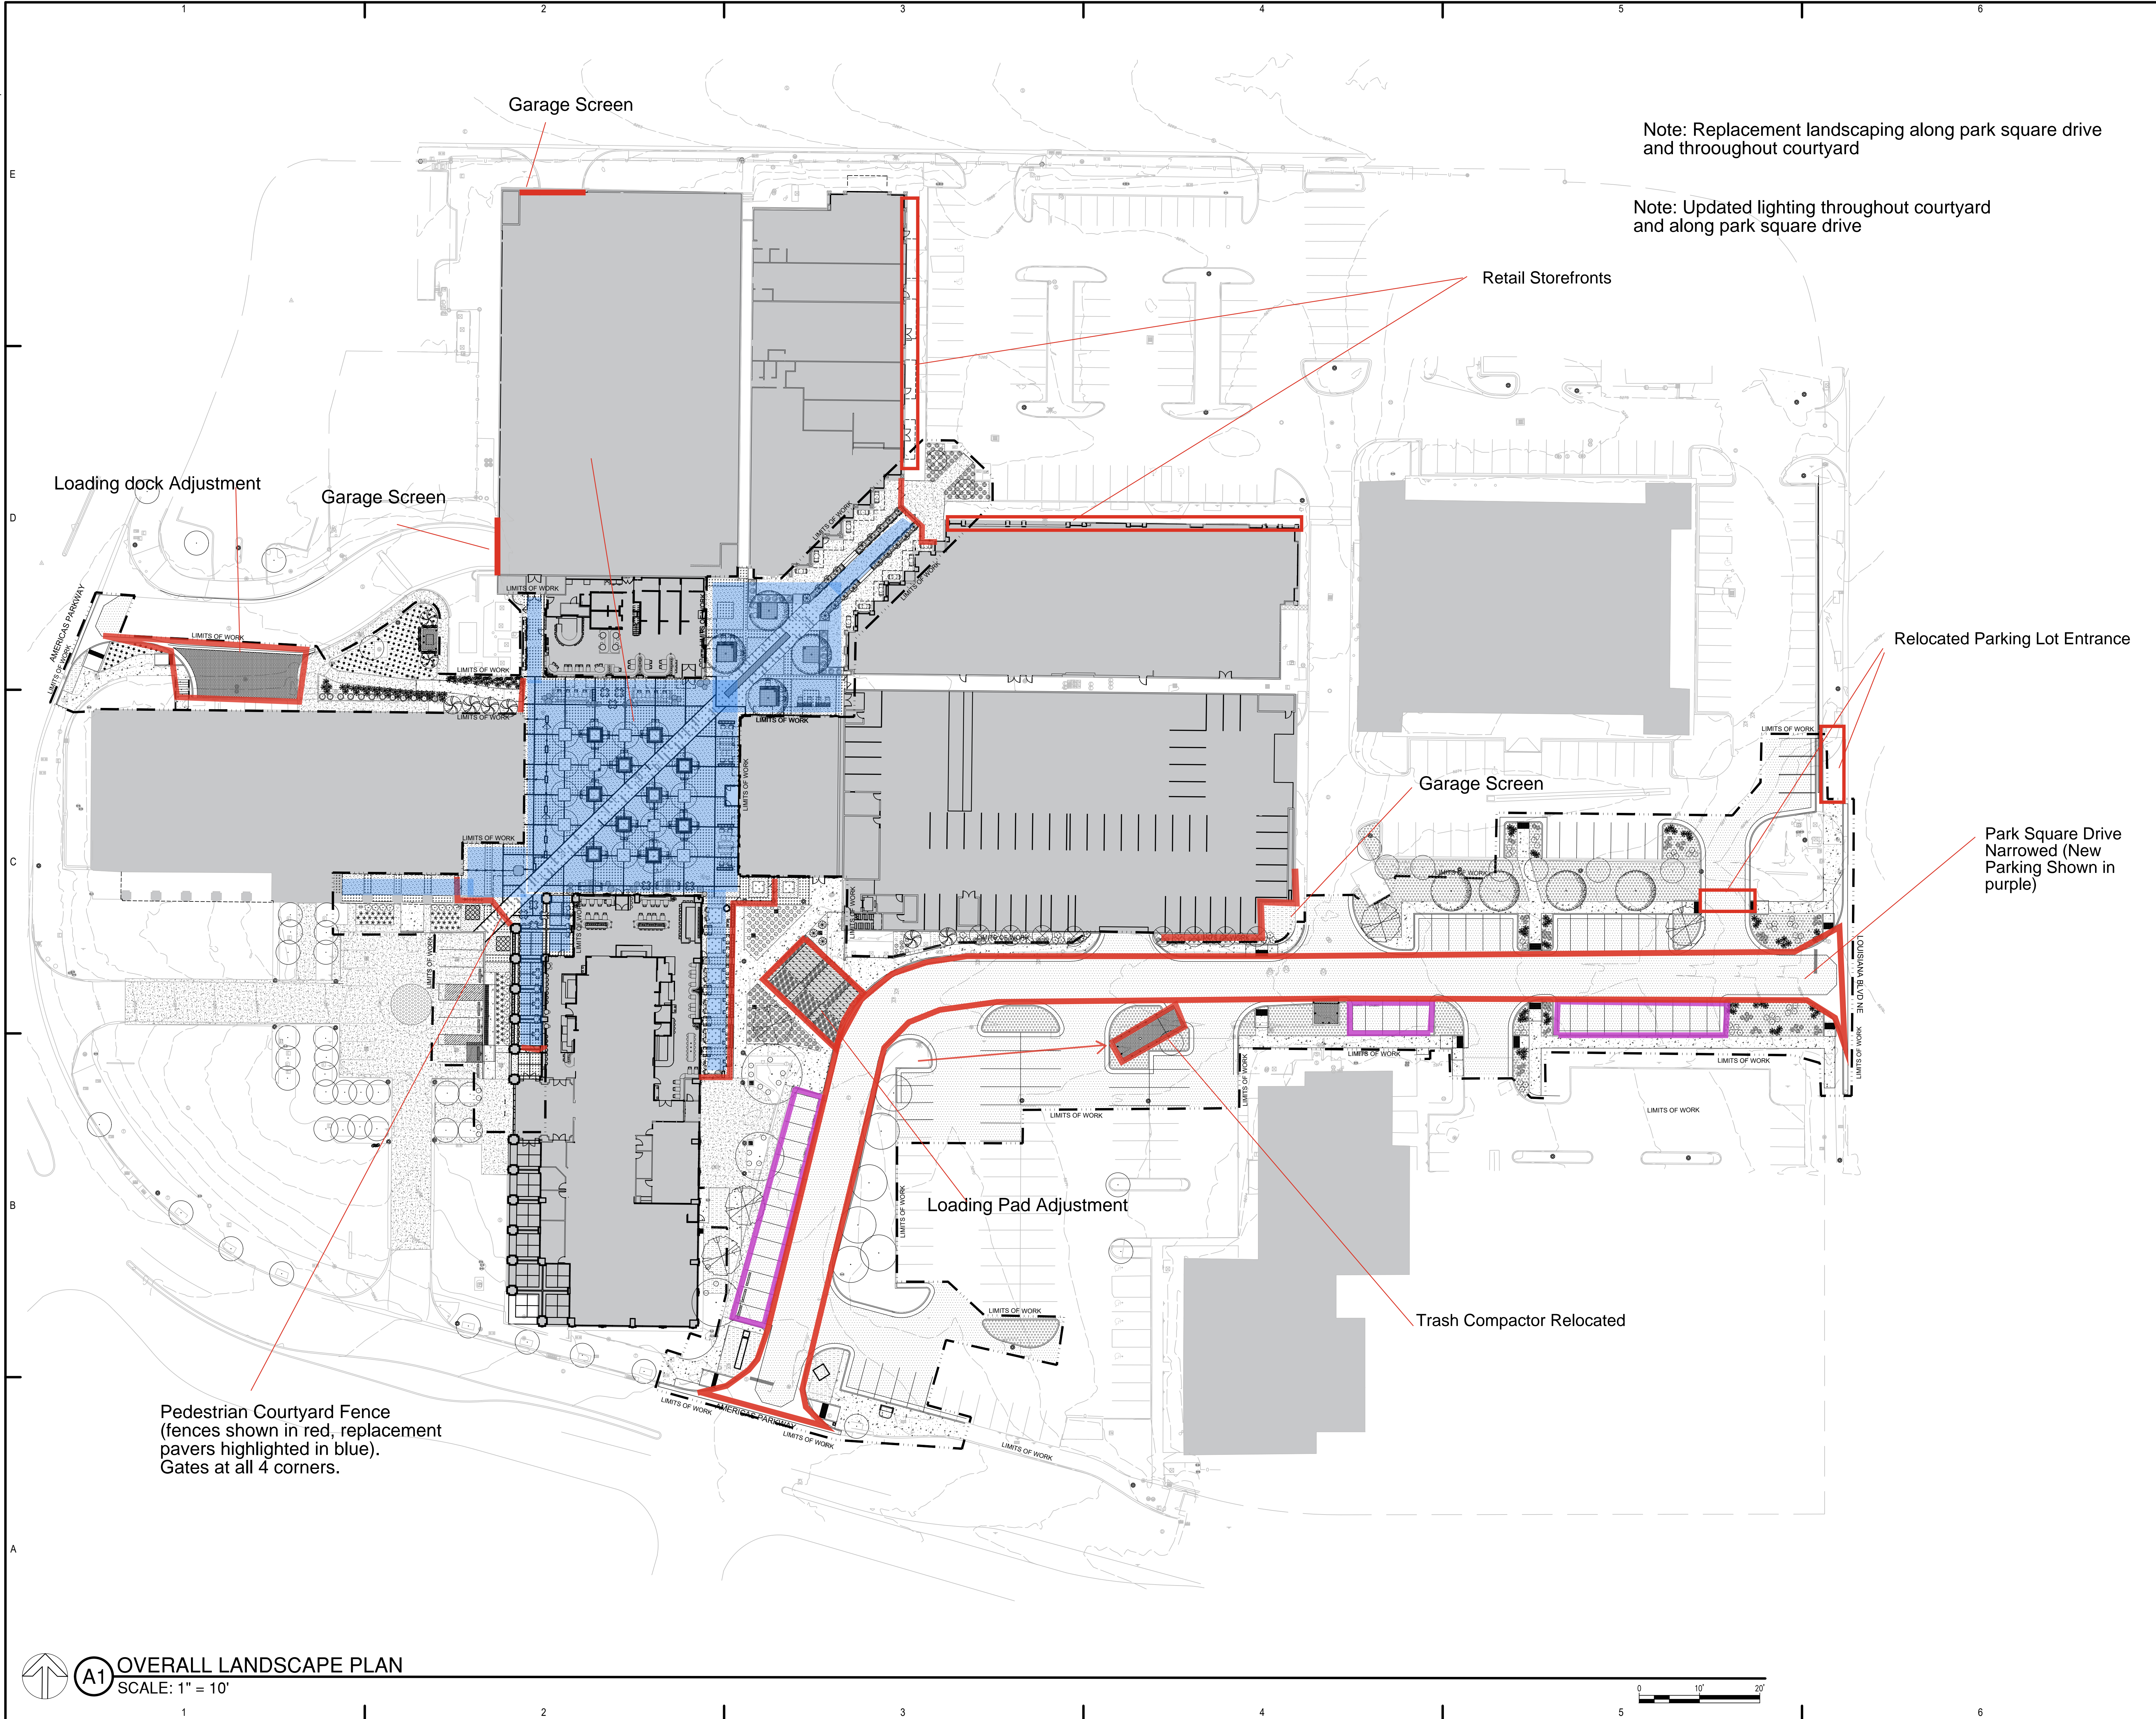

A1 OVERALL LANDSCAPE PLAN
SCALE: 1" = 10'

fbt architects

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CONSULTANTS

LANDSCAPE ARCHITECT


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CIVIL ENGINEER

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LIGHTING

AE Design
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LANDSCAPE ARCHITECT

**Park Square Plaza
Renovation**

6565 AMERICAS PKWY
ALBUQUERQUE, NM 87110

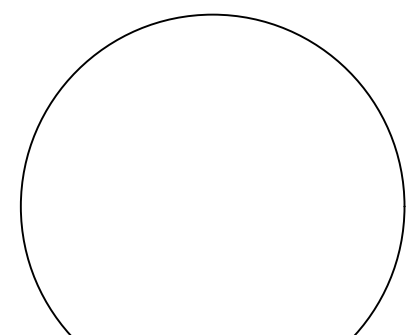NOVEMBER 2023

| MARK | DATE | DESCRIPTION |
|------|------|-------------|
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| ISSUE: | FOR PRICING |
| DATE: | NOVEMBER 10, 2023 |
| PROJECT NO: | |
| DRAWN BY: | TW/WM |
| CHECKED BY: | WM |

SHEET TITLE

OVERALL LANDSCAPE
PLAN

L-100

Park Square Plaza Renovation



PARK SQUARE PLAZA

EXTERIOR IMPROVEMENTS

ADMINISTRATIVE AMENDMENT SET

APRIL 2024

DRAWING INDEX:

SITE ARCHITECTURAL

| | |
|---------|-----------------------------|
| GS-000 | COVER SHEET |
| L-100 | OVERALL LANDSCAPE PLAN |
| TC-501 | TRAFFIC CIRCULATION DETAILS |
| TOL-101 | TRAFFIC CIRCULATION LAYOUT |
| LD-101 | SITE DEMOLITION PLAN |
| LD-102 | SITE DEMOLITION PLAN |
| LD-103 | SITE DEMOLITION PLAN |
| LD-104 | SITE DEMOLITION PLAN |
| LD-105 | SITE DEMOLITION PLAN |
| LS-101 | CONSTRUCTION PLAN |
| LS-102 | CONSTRUCTION PLAN |
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| LS-105 | CONSTRUCTION PLAN |
| LS-501 | CONSTRUCTION DETAILS |
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| LK-101 | DIMENSION PLAN |
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CIVIL

| | |
|-------|------------------------------------|
| C-200 | OVERALL DRAINAGE PLAN |
| C-201 | DRAINAGE PLAN - EXISTING CONDITION |
| C-202 | DRAINAGE PLAN - PROPOSED CONDITION |
| C-300 | OVERALL GRADING PLAN |
| C-301 | GRADING PLAN |
| C-302 | GRADING PLAN |
| C-303 | GRADING PLAN |
| C-304 | GRADING PLAN |
| C-305 | GRADING PLAN |

LANDSCAPE

| | |
|--------|--------------------|
| LI-101 | IRRIGATION PLAN |
| LI-102 | IRRIGATION PLAN |
| LI-103 | IRRIGATION PLAN |
| LI-104 | IRRIGATION PLAN |
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| LI-501 | IRRIGATION DETAILS |
| LP-101 | PLANTING PLAN |
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| LP-105 | PLANTING PLAN |
| LP-501 | PLANTING DETAILS |

SITE LIGHTING

| | |
|--------|-----------------------------|
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| LE-100 | OVERALL LIGHTING PLAN |
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| LE-102 | LIGHTING PLAN |
| LE-103 | LIGHTING PLAN |
| LE-104 | LIGHTING PLAN |
| LE-105 | LIGHTING PLAN |
| LE-401 | LIGHTING DETAILS |
| LE-800 | LIGHTING SCHEDULES |
| LE-801 | LIGHTING CONTROLS SCHEDULES |

SITE ELECTRICAL

| | |
|--------|---|
| E-001 | ELECTRICAL GENERAL NOTES SYMBOL LEGEND |
| ES-101 | OVERALL SITE LIGHTING PLAN |
| ES-103 | SITE LIGHTING PLAN - CENTRAL PLAZA & RETAIL CORRIDOR |
| ES-104 | SITE LIGHTING PLAN - EAST PLAZA |
| ES-105 | SITE LIGHTING PLAN - SOUTH PARKING LOT |
| ES-106 | SITE LIGHTING PLAN - EAST PARKING LOT |
| ES-102 | SITE LIGHTING PLAN - WEST PLAZA |
| E-501 | NORTH HALL EXISTING POWER RISER DIAGRAM & PANEL SCHEDULES |
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ARCHITECTURAL

| | |
|--------|------------------------------|
| AS-201 | BUILDING ELEVATIONS |
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| AS-203 | BUILDING ELEVATIONS |
| AS-204 | BUILDING ELEVATIONS |
| AS-205 | BUILDING ELEVATIONS |
| AS-206 | BUILDING ELEVATIONS |
| AS-310 | TRELLIS PLANS AND ELEVATIONS |
| AS-311 | WALL SECTIONS |

OWNER

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Albuquerque, NM 87107
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VICINITY MAP

6501 Americas Pkwy Albuquerque, NM 87110

fbt | architects


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Park Square Plaza Renovation

4/25/2024 1:15 PM



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LANDSCAPE ARCHITECT

Park Square Plaza
Renovation

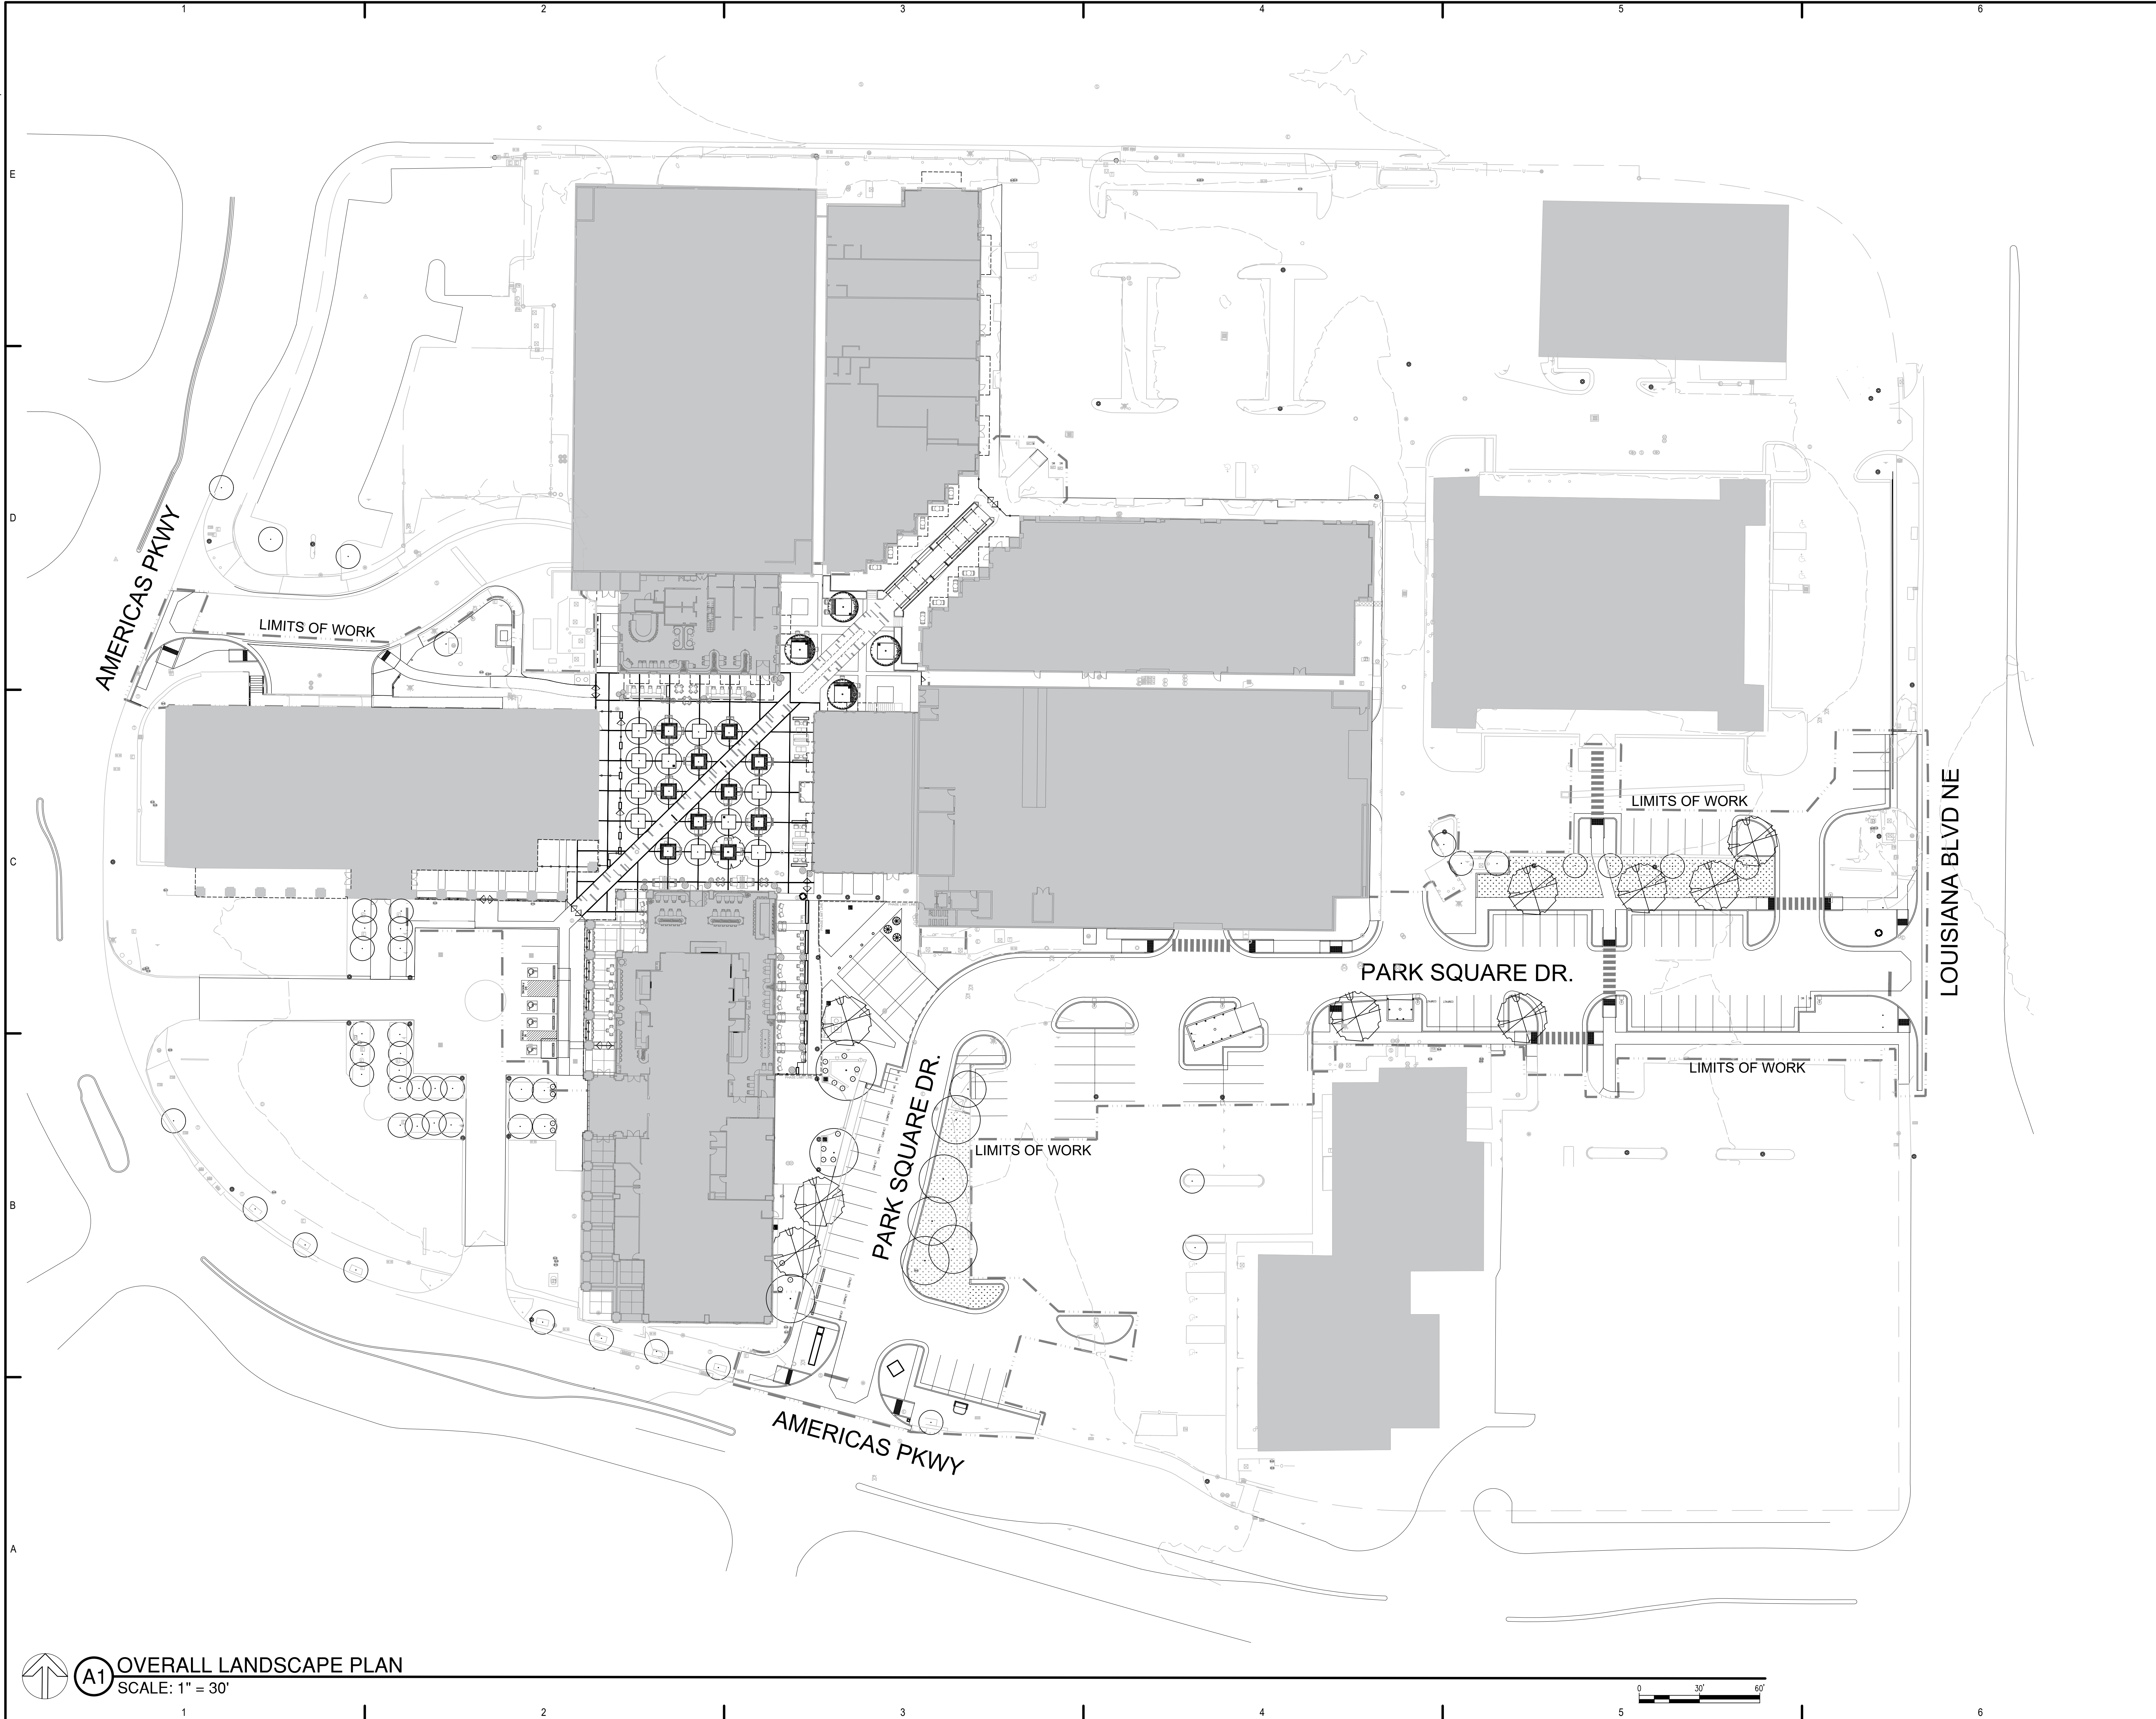6565 AMERICAS PKWY
ALBUQUERQUE, NM 87110

APRIL 2024

| MARK | DATE | DESCRIPTION |
|------|------|-------------|
|------|------|-------------|

| | |
|-------------|------------------------|
| ISSUE: | CONSTRUCTION DOCUMENTS |
| DATE: | APRIL 22, 2024 |
| PROJECT NO: | |
| DRAWN BY: | TW/WM |
| CHECKED BY: | WM |

SHEET TITLE

OVERALL LANDSCAPE
PLAN

L-100


GENERAL NOTES

- A. ALL BROKEN OR CRACKED SIDEWALK MUST BE REPLACED WITH SIDEWALK CONSTRUCTED PER CABQ STD. DWG 2430.

CONSTRUCTION KEYED NOTES

- PROPOSED CONCRETE CURB AND GUTTER PER CABQ STANDARD DWG 2415A.
- PROPOSED SIDEWALK PER COA STD. DWG. 2430. ALL BROKEN OR CRACKED SIDEWALK MUST BE REPLACED WITH SIDEWALK AND CURB & GUTTER PER CABQ STD. DWGS. 2415 AND 2430.
- PROPOSED CONCRETE VALLEY GUTTER PER COA STD. DWG. 2420.
- EXISTING STREET LIGHT TO REMAIN.
- EXISTING TREE TO REMAIN.
- EXISTING CURB RAMP TO REMAIN.
- PROPOSED PERPENDICULAR CURB ACCESS RAMP WITH TRUNCATED DOME DETECTABLE WARNING PAD PER COA STD. DWG. 2442.
- PROPOSED PARALLEL CURB ACCESS RAMP WITH TRUNCATED DOME DETECTABLE WARNING PAD PER COA STD. DWG. 2443.
- PROPOSED PAINTED PARKING LOT STRIPING 4" IN WIDTH TO BE PAINTED WITH TRAFFIC-RATED LATEX PAINT.
- PROPOSED PAINTED PARKING LOT MARKINGS TO BE PAINTED WITH TRAFFIC-RATED LATEX PAINT.
- RE-STRIPE PAVEMENT MARKINGS AND REPLACE SIGNAGE AT EXISTING ADA-PARKING PER DETAILS A1/TC-501, A3/TC-501, A5/TC-501, AND C3/TC-501.
- PROPOSED ADA-PARKING PER DETAILS A1/TC-501, A3/TC-501, A5/TC-501, AND C3/TC-501.
- NEW MOTORCYCLE PARKING SIGN PER DETAIL D5/TC-501.
- NEW STAINLESS STEEL CANE-DETECTABLE TOFINO BIKE RACK AS AVAILABLE FROM SPORTWORKS (425)483-7000. OR APPROVED EQUAL. SURFACE MOUNT TO EXISTING CONCRETE PER MANUFACTURER'S INSTRUCTIONS WITH MANUFACTURER'S INCLUDED CONCRETE WEDGE ANCHORS. INSTALL PER DETAIL D3/TC-501 AND ACCORDING TO DIMENSIONAL STANDARDS OUTLINED IN COA DPM FIGURE 7.4.115.
- PEDESTRIAN ACCESSIBLE ROUTE PER COA IDO §14-16-5-3(D) AND COA DPM.
- CONSTRUCT TRANSIT SHELTER PER COA STD. DWG. 2535.05.
- EXISTING DUMPSTER ENCLOSURE TO REMAIN.
- PROPOSED DUMPSTER ENCLOSURE.
- EXISTING TRASH COMPACTOR ENCLOSURE TO REMAIN.
- PROPOSED TRASH COMPACTOR ENCLOSURE.
- PROPOSED MONUMENT SIGN.
- PROPOSED BOLLARD.
- PROPOSED CROSSWALK STRIPING.

VICINITY MAP

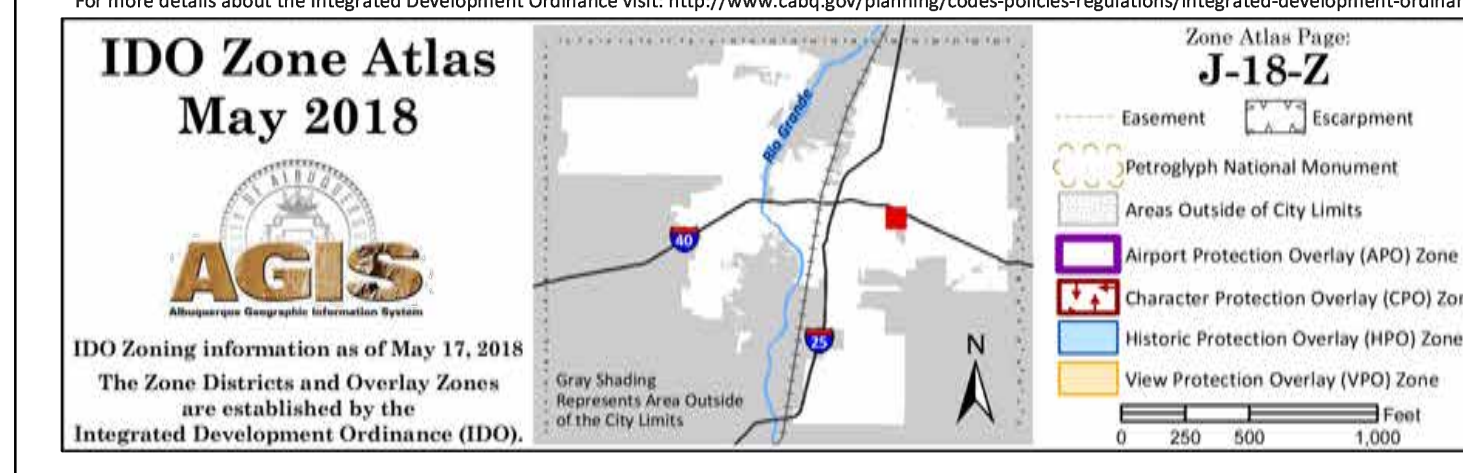

EXECUTIVE SUMMARY

- PROPERTY DESCRIPTIONS:**
- One Park Square, UPC: 101805845149911620
Address: 6501 Indian School Rd. NE, Albuquerque, NM 87110
Legal Description: LTR 1-B-1 REPL. OF TRS 1-A-1, 1-B-1, 1-C-1, 1-D-1A, 1-E-1A, 1-F, 1-G & 1-H-1 PARK SQUARE ADDN CONT 84,763 SQ FT
 - Two Park Square, UPC: 101805847048511619
Address: 6551 Americas Parkway NE, Albuquerque, NM 87110
Legal Description: TRACT 1-C-1A PARK SQUARE ADDN PLAT OF TRS 1-C-1A, 1-E-1A-1, 1-G-1 & 1-H-1A PARK SQUARE ADDN CONT 80,649 SQ FT M/L
UPC: 101805849051011621
 - 6588 Indian School Rd. NE, Albuquerque, NM 87110
Legal Description: TR 1-A-1 REPL. OF TRS 1-A-1, 1-B-1, 1-C-1, 1-D-1A, 1-E-1A, 1-F, 1-G & 1-H-1 PARK SQUARE ADDN CONT 91,409 SQ FT

PROPOSED DEVELOPMENT SIZE:
The project site will encompass approximately 4.0 acres.

- PLANNING HISTORY:**
- Master Plans
6501 America's Parkway: Administrative Amendment (Nextel) 2-2450 Project #: 1001163; 12280000; 00449
6551 America's Parkway: Z-78-122-1
 - Site Plans
Unknown
 - Sector Plans
Uptown Sector Development Plan - Repealed
IDO Uptown Urban Center and Uptown Small Area

PROPOSED DEVELOPMENT DESCRIPTION:
The Park Square Plaza Renovation will provide outdoor seating for visitors of restaurants located within the One Park Square and Two Park Square buildings. The design improves connectivity from Louisiana Blvd and Albuquerque Uptown to the plaza.

TRAFFIC CIRCULATION CONCEPT:
The design narrows the width of access driveways within the NE corner in order to slow down cars in the parking lots. Additional parking will support the expected increase of visitors to Park Square Plaza.

IMPACT ON ADJACENT SITES:
The project will not impact adjacent sites.

REQUIRED OFF-STREET PARKING
The site is zoned SU-3 with primary uses of restaurants, offices, and general retail. Restaurant use requires 8 spaces per 1000 SF Gross Floor Area (GFA), offices require 3 spaces per 1000 SF GFA, and general retail requires 1 space per 225 SF GFA. See table.

| OFF-STREET PARKING CALCULATIONS | | | |
|--|--|--------|------------------|
| Type of Use | Per IDO 14-16-5-5(C) TABLE 5-5-1 | GFA | Required Parking |
| Office | 4 spaces per 1000 GFA for buildings more than 100,000 SF | 334632 | 1339 |
| Restaurant | 8 spaces per 1000 GFA | 18950 | 152 |
| Bank | 3 spaces per 1000 GFA | 1000 | 3 |
| General Retail | 1 space per 225 GFA | 12953 | 58 |
| Total Required Parking Spaces | | | 1551 |
| Reduce 30% For Premium Transit (<15m Wait) Within 1/2 mile | | | |
| Total Required Parking Spaces With 30% Reduction | | | 992 |
| Reduce 5% For Transit Shelter | | | |
| Total Required Parking Spaces With 35% Reduction | | | 915 |
| Existing Car (Non-ADA) Parking Spaces (Structures) | | | |
| Existing Car Parking Spaces (Surface) | | | 137 |
| Total Provided Car Parking Spaces | | | 968 |
| Required ADA Accessible Parking Spaces (2%) | | | |
| Provided ADA Accessible Parking Spaces | | | 31 |
| Required ADA Van Accessible Parking Spaces (1%) | | | |
| Provided ADA Van Accessible Parking Spaces | | | 6 |
| Required Bicycle Spaces per COA DPM Standards (10%) | | | |
| Provided Bicycle Spaces Designed per COA DPM Standards | | | 22 |
| Required Secured Bicycle Spaces (20%) | | | |
| Provided Secured Bicycle Spaces | | | 0 |
| Required Motorcycle Spaces | | | |
| Required Motorcycle Spaces | | | 8 |
| Existing Motorcycle Spaces | | | |
| New Motorcycle Spaces | | | 3 |
| Provided Motorcycle Spaces | | | 8 |
| Required Electrical Vehicle Parking Spaces | | | |
| Provided Electrical Vehicle Parking Spaces | | | 0 |

HATCH LEGEND

- EXISTING CONCRETE TO REMAIN.
- 4" THICK CONCRETE PAVEMENT.
- PEDESTRIAN-RATED CONCRETE PAVERS.
- VEHICLE-RATED CONCRETE OR PAVERS.
- PROPOSED NEW AND RENOVATED ASPHALT PAVEMENT.

LINE TYPE LEGEND

- PROPERTY LINE
- EASEMENT
- LIMITS OF WORK
- 3' HIGH ORNAMENTAL FENCE.
- PEDESTRIAN ACCESS ROUTE.

TRAFFIC CIRCULATION LAYOUT APPROVED

Ernest Umeyor 5/16/2024
Signed Date

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Park Square Plaza Renovation

6565 AMERICAS PKWY
ALBUQUERQUE, NM 87110

MAY 2024


MARK DATE DESCRIPTION

ISSUE: TRAFFIC CIRCULATION LAYOUT PLAN
DATE: MAY 10, 2024
PROJECT NO:
DRAWN BY: TW/WM
CHECKED BY: WM

SHEET TITLE

TRAFFIC CIRCULATION LAYOUT PLAN

TC-101

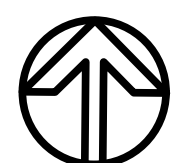


PARK SQUARE PLAZA TRAFFIC CIRCULATION LAYOUT PLAN

SCALE: 1" = 40'


0 40' 80'

Park Square Plaza Renovation

5/13/2024 8:19 AM

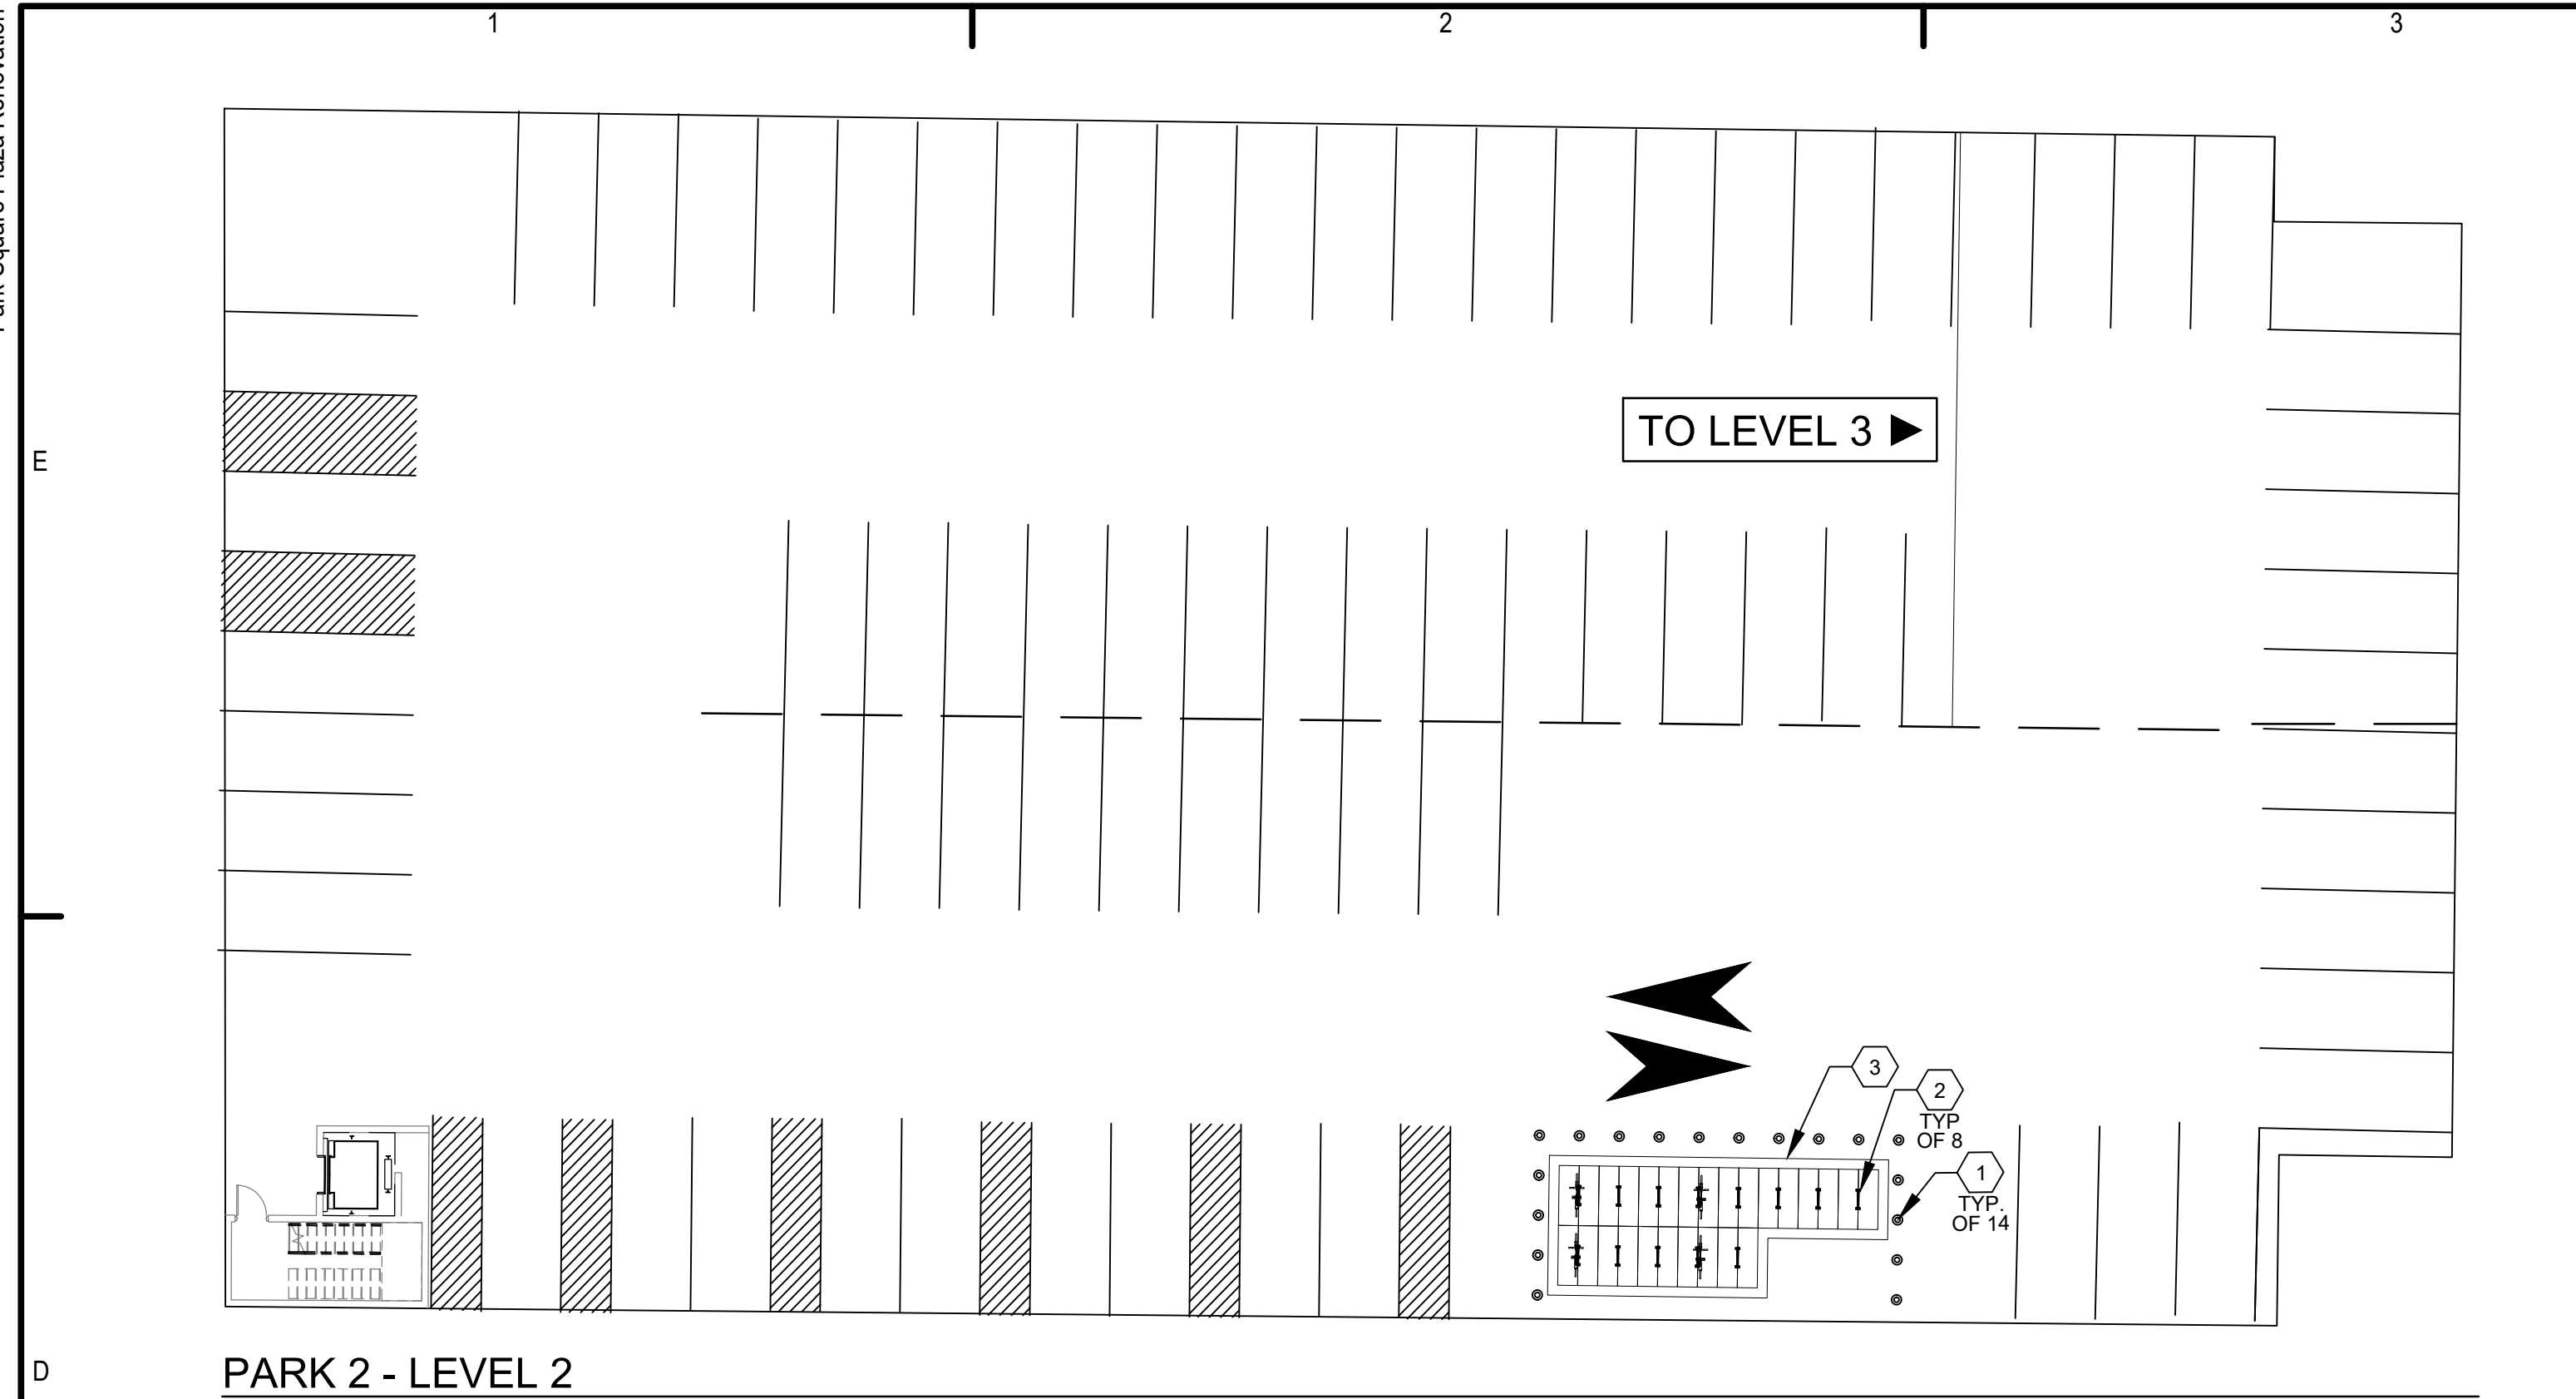

PARK 2 - LEVEL 2

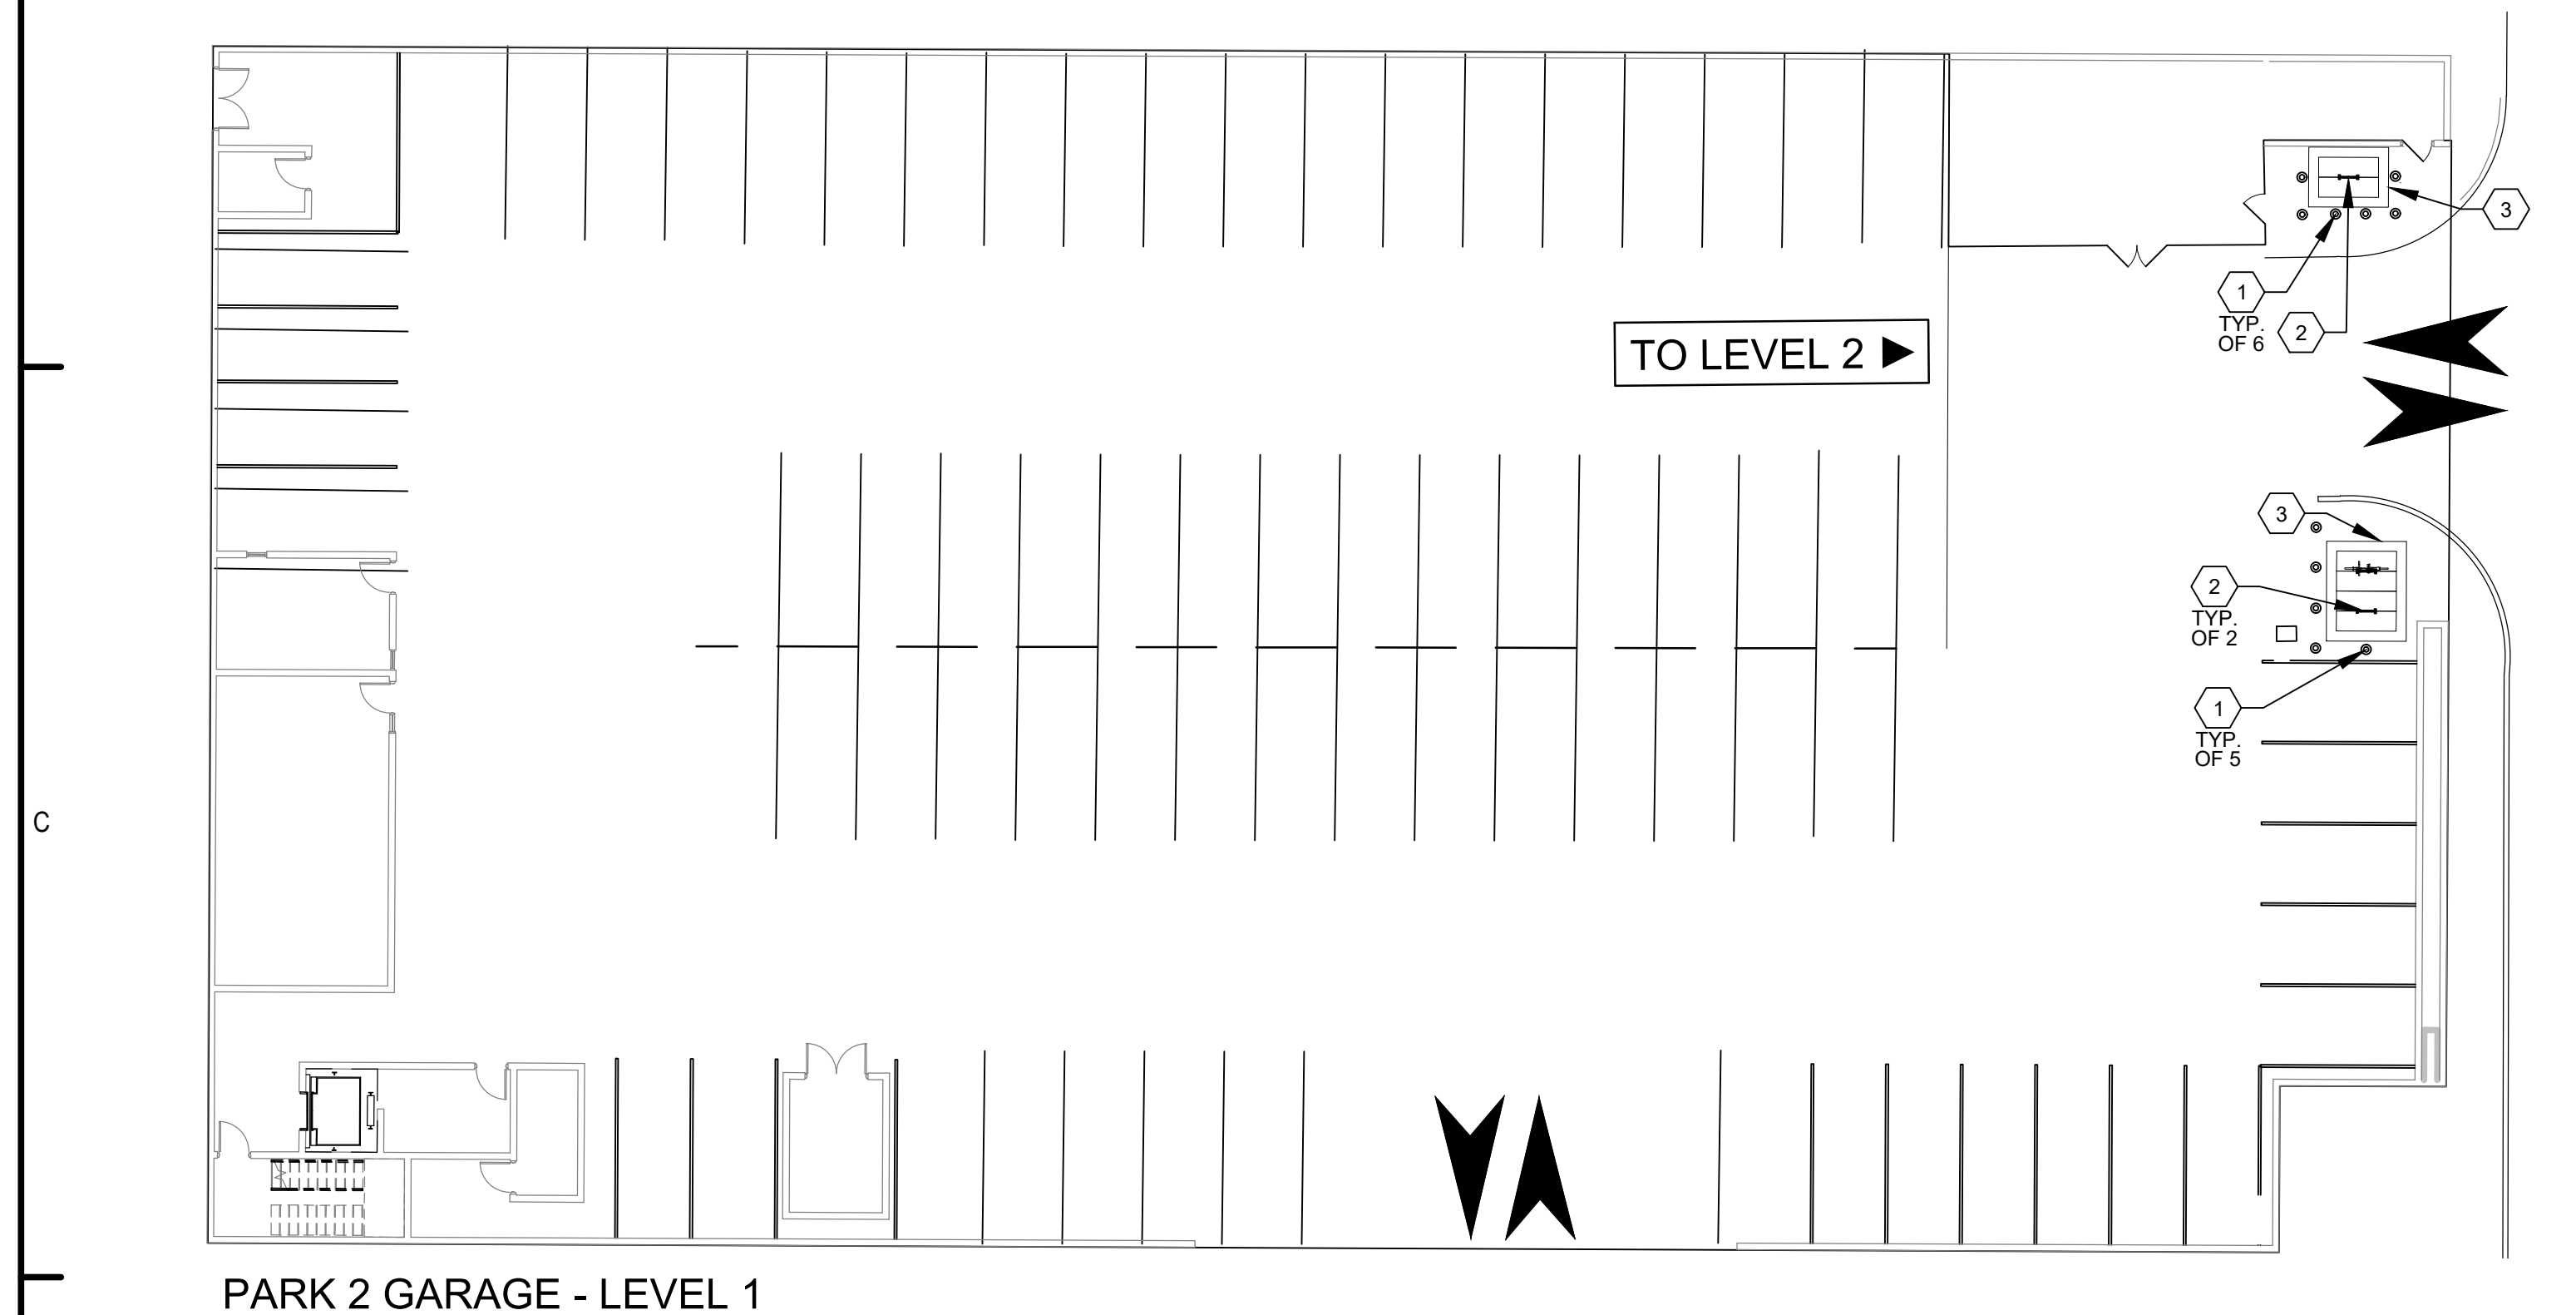

PARK 2 GARAGE - LEVEL 1

GENERAL NOTES


- BICYCLE PARKING SHALL BE PER CITY OF ALBUQUERQUE DEVELOPMENT PROCESS MANUAL (DPM) SECTION 7.4(K)(2).
- REMOVE EXISTING RACKS AND BOLLARDS AS NECESSARY TO INSTALL BICYCLE PARKING LAYOUT.

KEYED NOTES

- FURNISH AND INSTALL BOLLARD.
- FURNISH AND INSTALL BICYCLE RACK, MODEL 291 BY DUMOR, AS AVAILABLE FROM EXERPLAY (855) 281-0151, OR APPROVED EQUAL, ANCHOR TO CONCRETE PAD PER DETAIL C4 THIS SHEET OR PER MANUFACTURER'S INSTRUCTIONS.
- PER (DPM) SECTION 7.4(K)(2), EACH BICYCLE PARKING SPACE SHALL BE A MINIMUM OF 2'-0" X 6'-0" WITH A MINIMUM 1'-0" CLEAR ZONE AROUND THE ENTIRE STALL.

B1 BICYCLE PARKING ENLARGEMENT

SCALE: 1/16" = 1'-0"

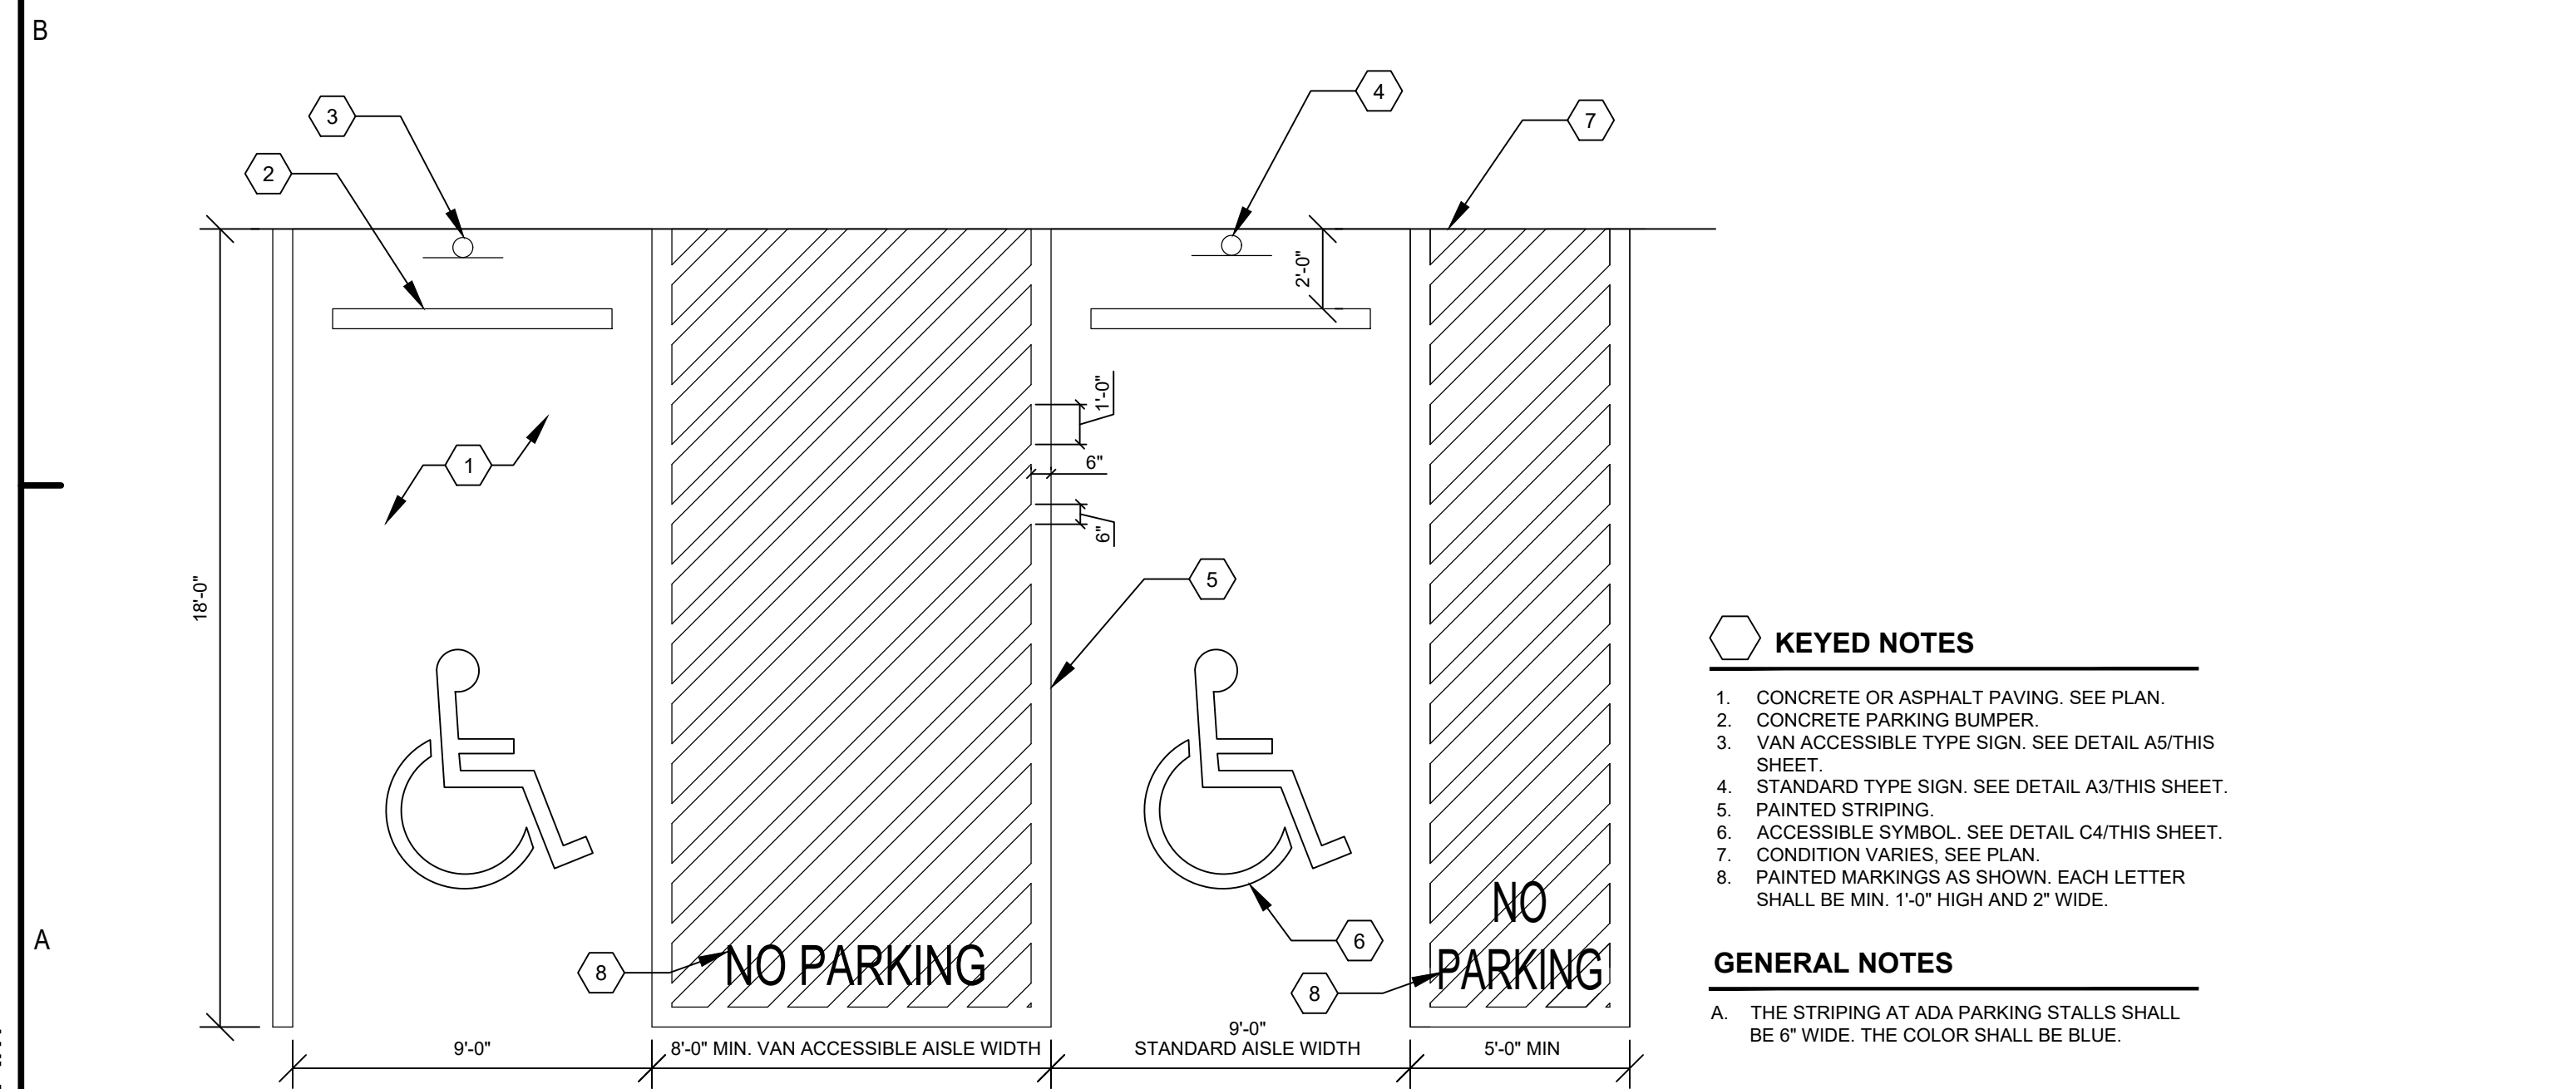

KEYED NOTES



- CONCRETE OR ASPHALT PAVING. SEE PLAN.
- CONCRETE PARKING BUMPER.
- VAN ACCESSIBLE TYPE SIGN. SEE DETAIL A5 THIS SHEET.
- STANDARD TYPE SIGN. SEE DETAIL A3 THIS SHEET.
- PAINTED STRIPING.
- ACCESSIBLE SYMBOL. SEE DETAIL C4 THIS SHEET.
- CONDITION VARIES. SEE PLAN.
- PAINTED MARKINGS AS SHOWN. EACH LETTER SHALL BE MIN. 1'-0" HIGH AND 2" WIDE.

GENERAL NOTES

- THE STRIPING AT ADA PARKING STALLS SHALL BE 6" WIDE. THE COLOR SHALL BE BLUE.

A1 STRIPING DETAIL FOR ACCESSIBLE PARKING

SCALE: 1/4" = 1'-0"

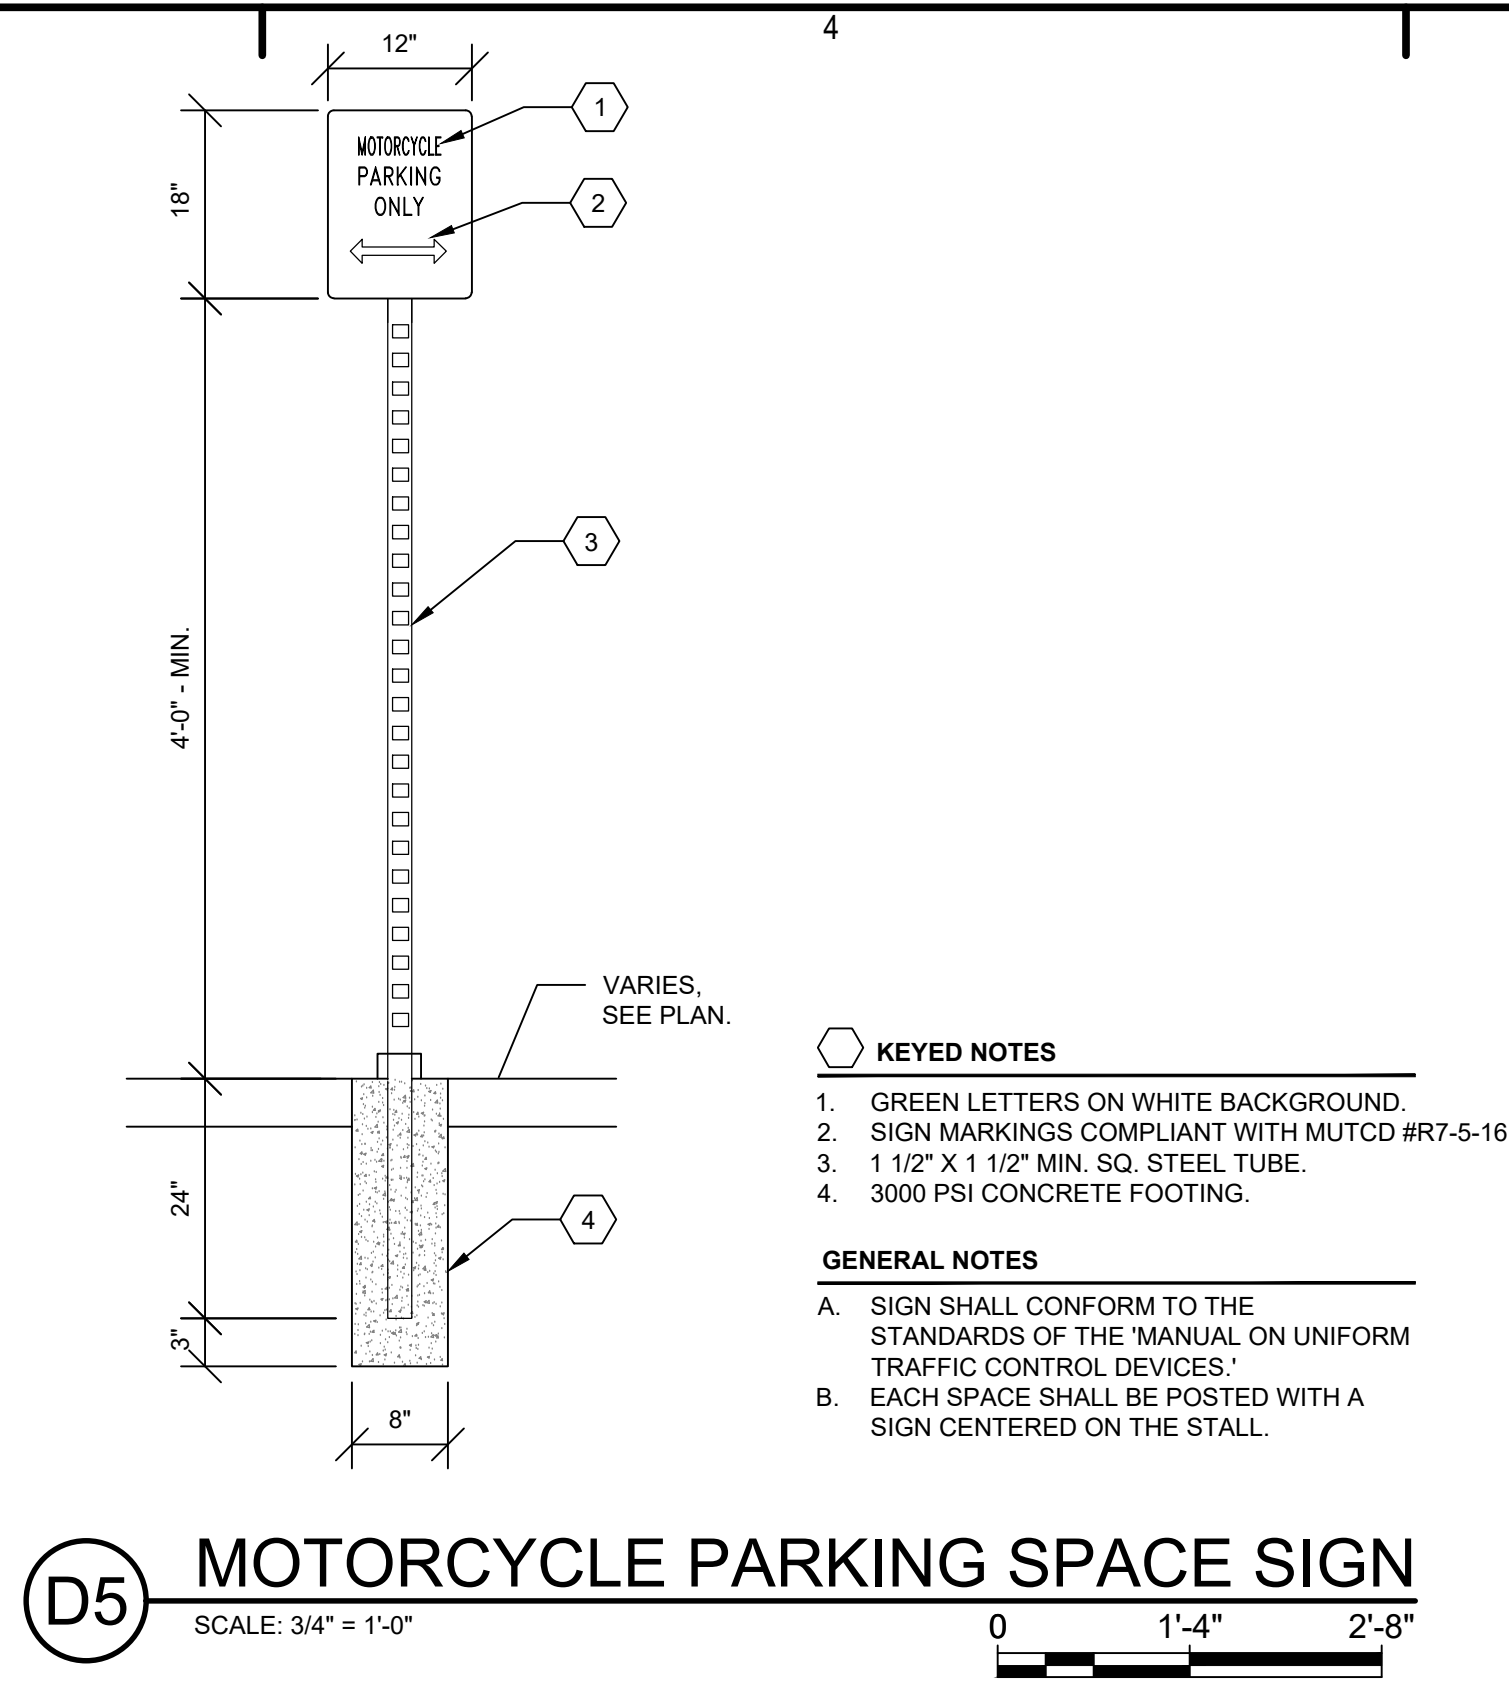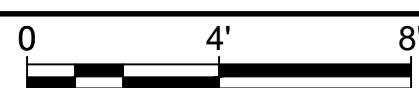


SCALE: 3/4" = 1'-0"

KEYED NOTES

- GREEN LETTERS ON WHITE BACKGROUND.
- SIGN MARKINGS COMPLIANT WITH MUTCD #R7-5-16.
- 1 1/2" X 1 1/2" MIN. SQ. STEEL TUBE.
- 3000 PSI CONCRETE FOOTING.

GENERAL NOTES

- SIGN SHALL CONFORM TO THE STANDARDS OF THE "MANUAL ON UNIFORM TRAFFIC CONTROL DEVICES."
- EACH SPACE SHALL BE POSTED WITH A SIGN CENTERED ON THE STALL.


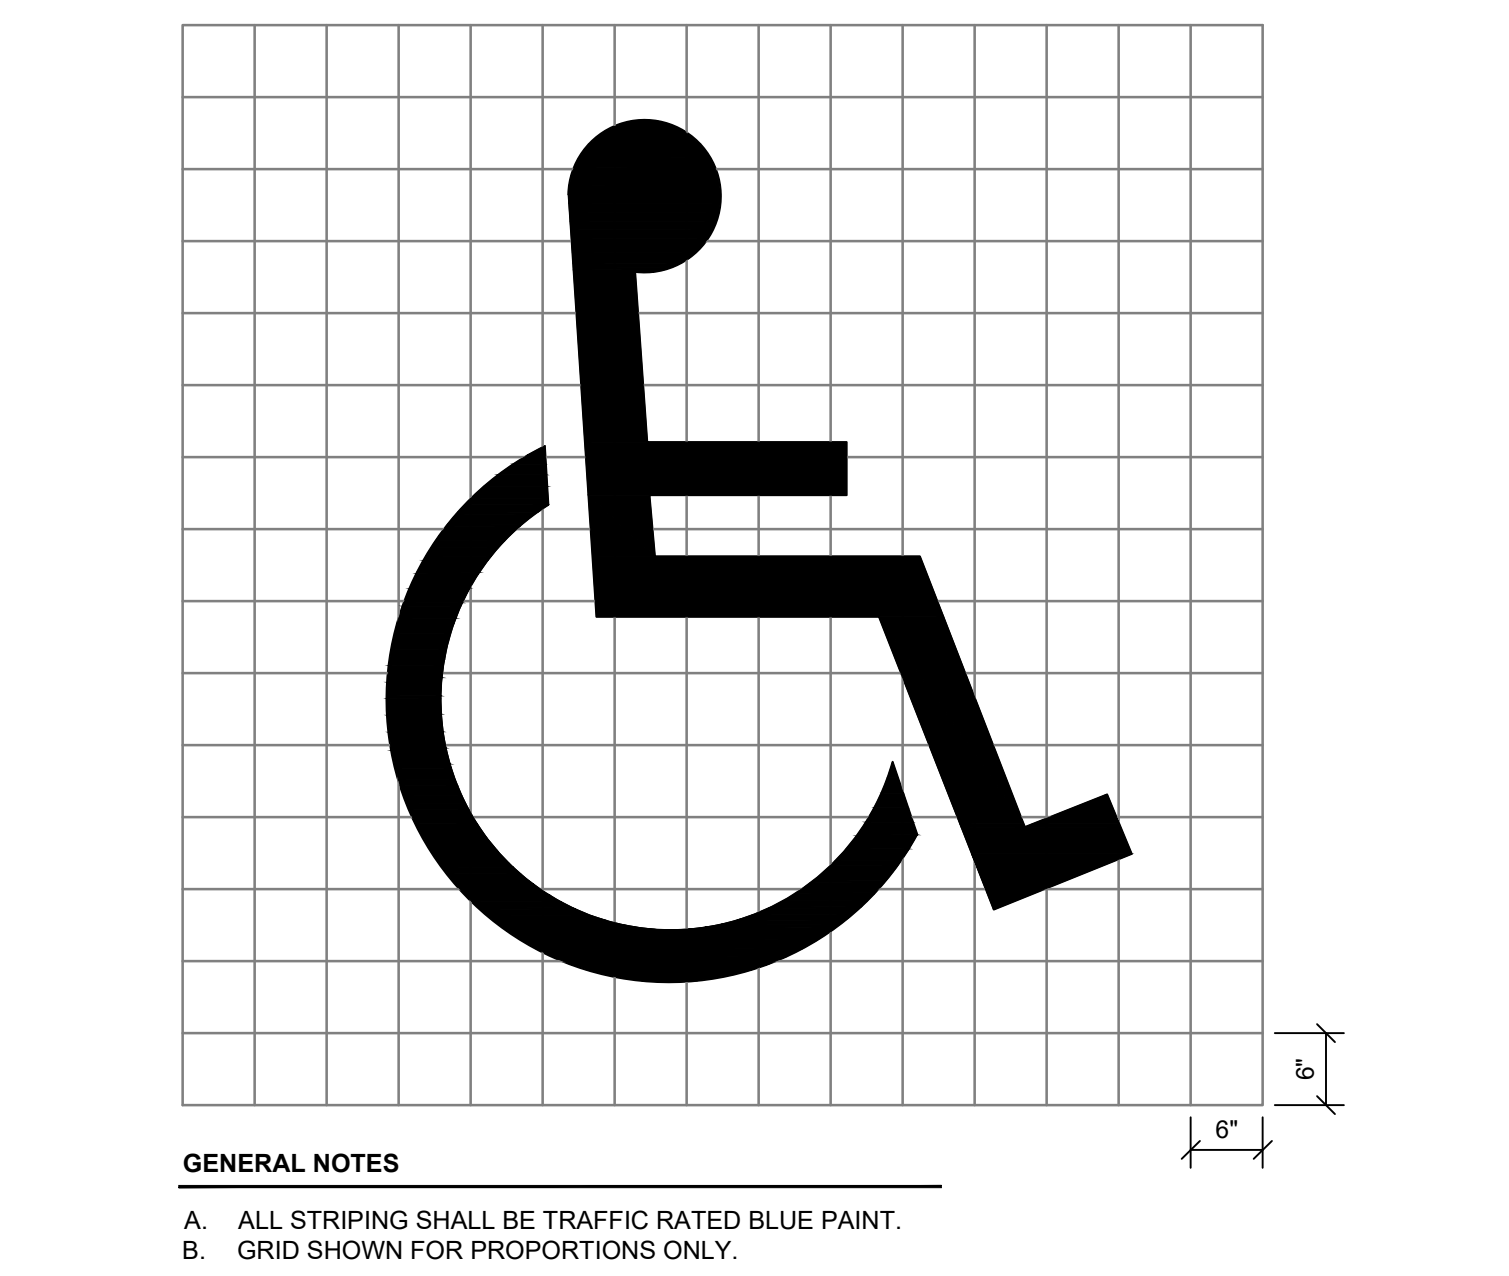


SCALE: 3/4" = 1'-0"

- ALL STRIPING SHALL BE TRAFFIC RATED BLUE PAINT.
- GRID SHOWN FOR PROPORTIONS ONLY.

C4 ACCESSIBLE PARKING SYMBOL STRIPING

SCALE: 3/4" = 1'-0"

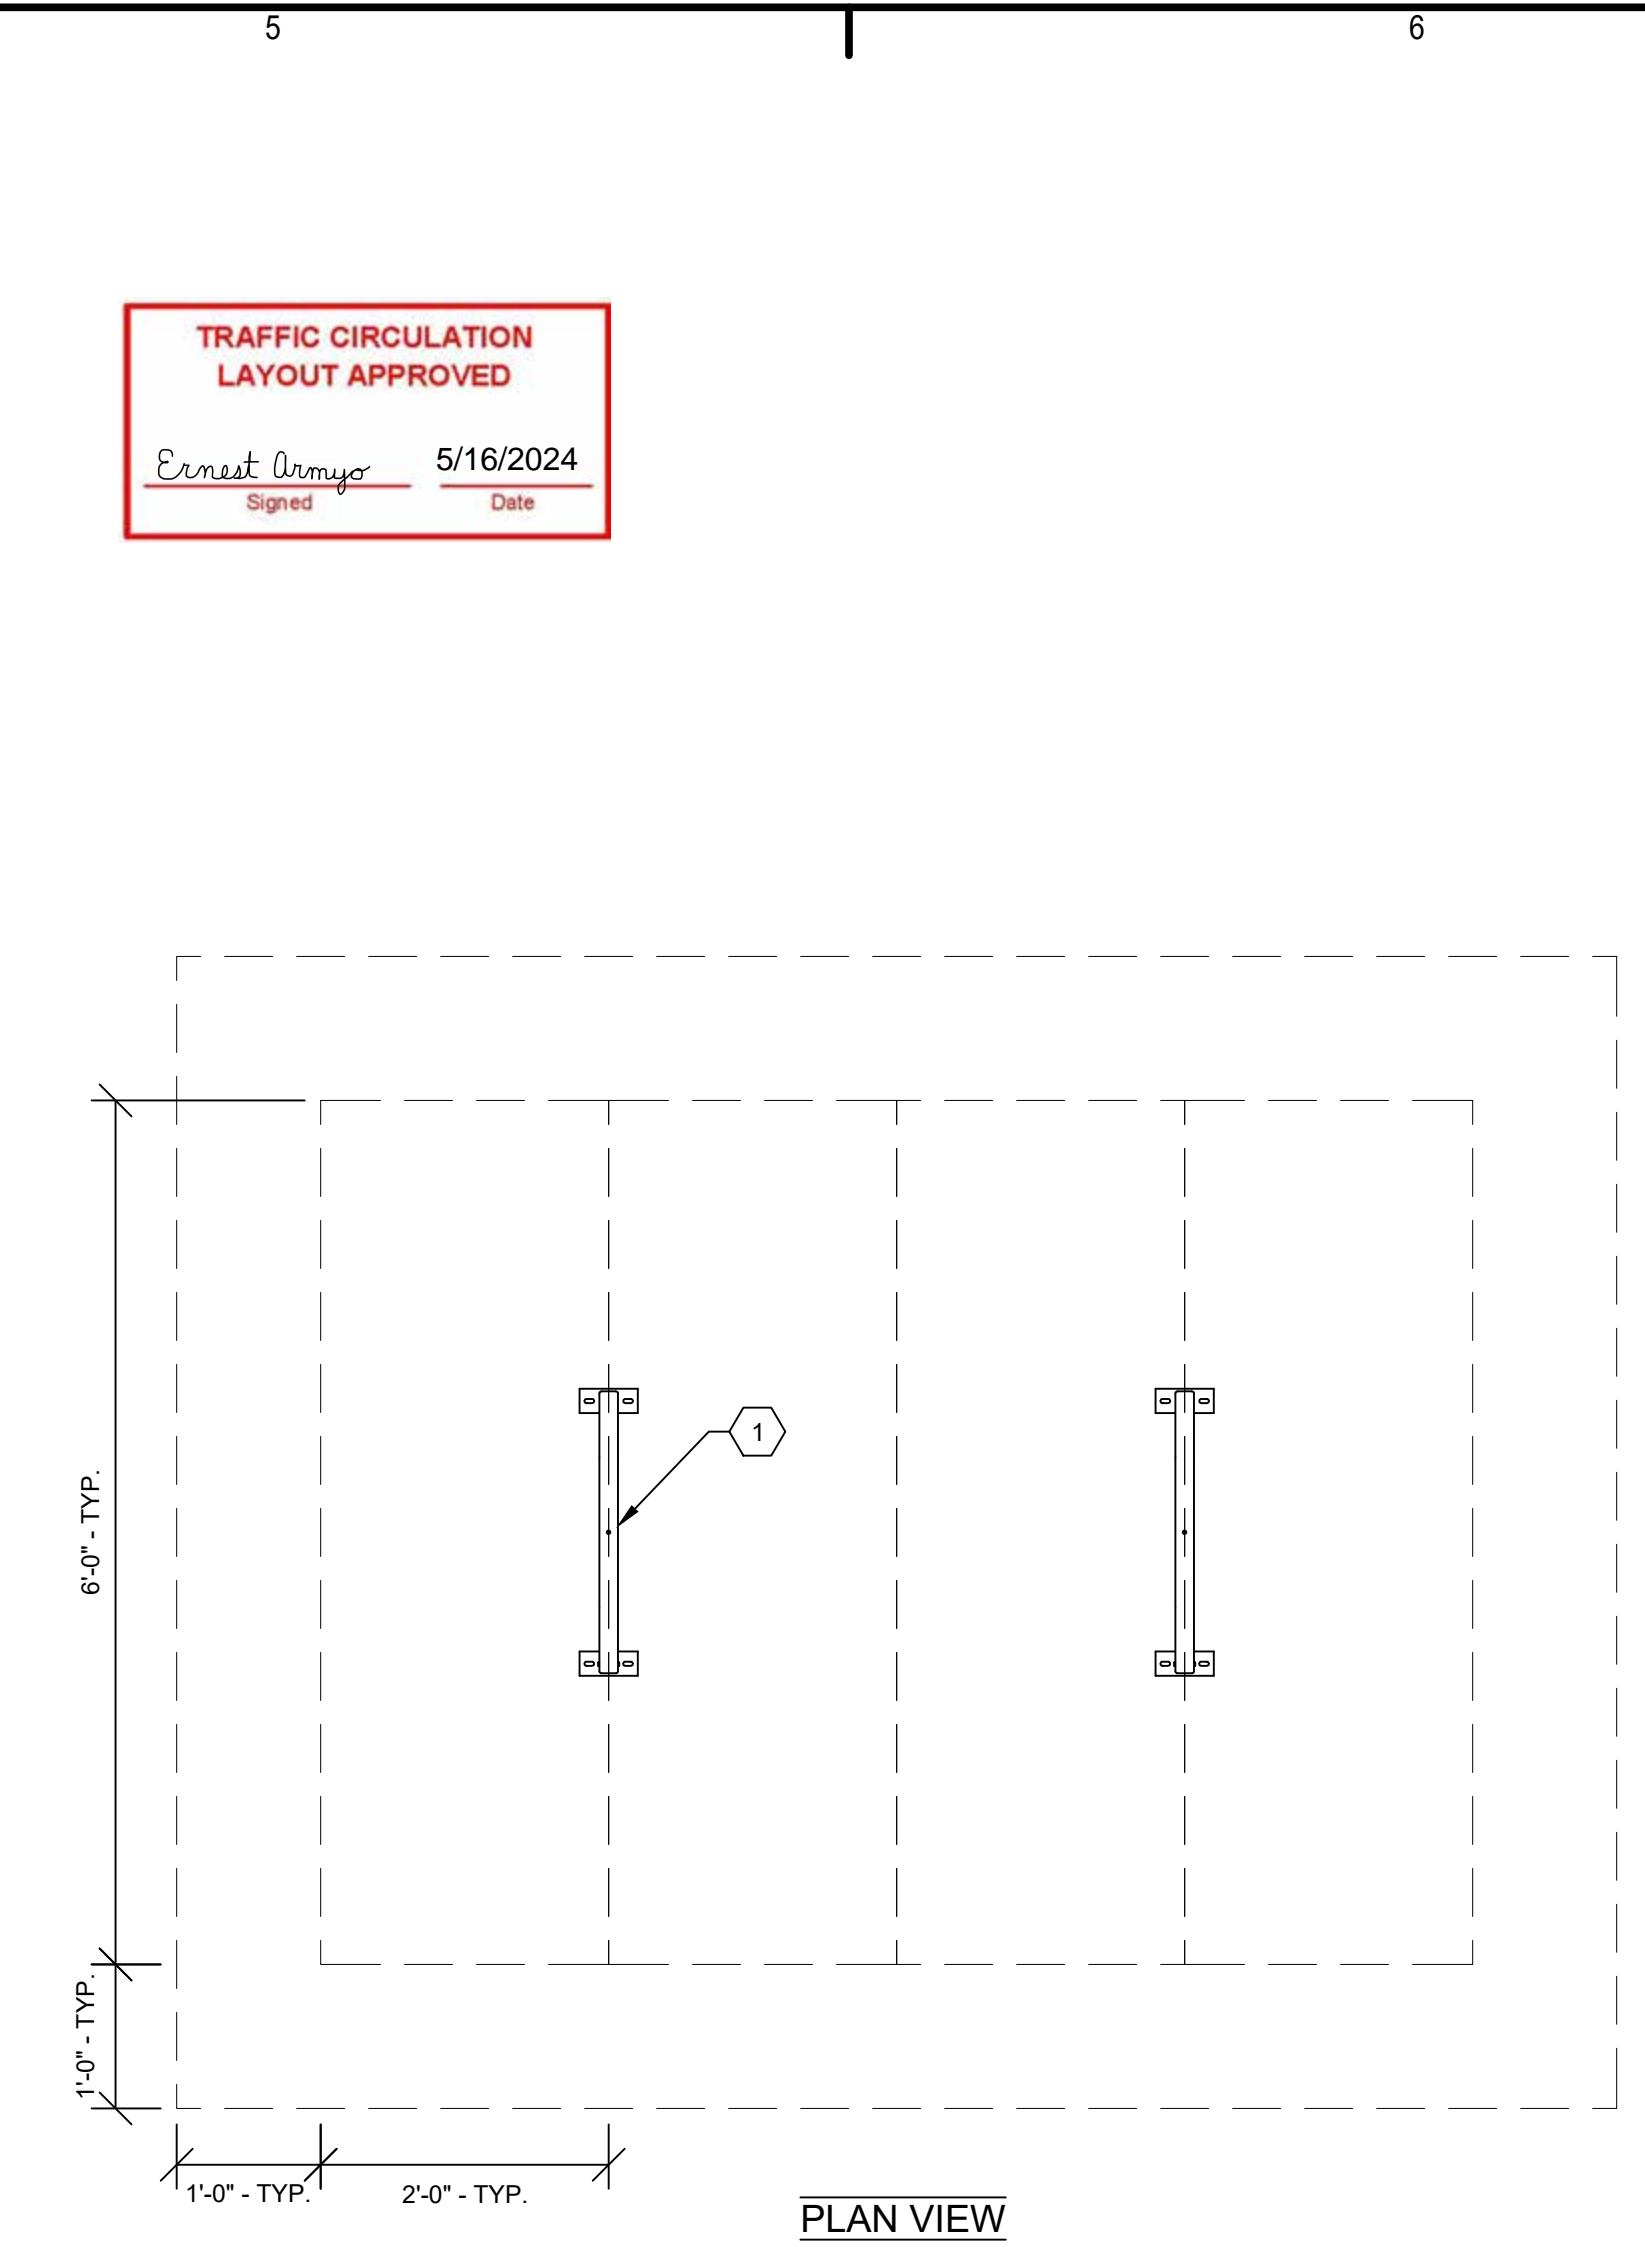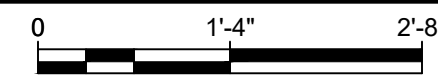

SCALE: 3/4" = 1'-0"

KEYED NOTES



- BIKE RACK, DERO DOWNTOWN, OR APPROVED EQUAL.
- 6" DIA. STEEL PLATE, 3/8" THICKNESS, SECURED WITH TAMPER PROOF ANCHORS.
- FINISH GRADE: 3000 PSI CONCRETE WITH BROOM FINISH, MIN. SEE PLAN.
- 95% COMPACTED SUBGRADE.

GENERAL NOTES

- ALL STEEL MEMBERS SHALL BE POWDER COATED, COLOR: AS APPROVED BY OWNER.
- MOUNTING HARDWARE SHALL BE PER MANUFACTURER'S INSTRUCTIONS AS APPROVED BY OWNER.
- SEE COA DPM FIGURE 7.4.115 FOR PLACEMENT REQUIREMENTS.

C5 BIKE RACK

SCALE: 3/4" = 1'-0"

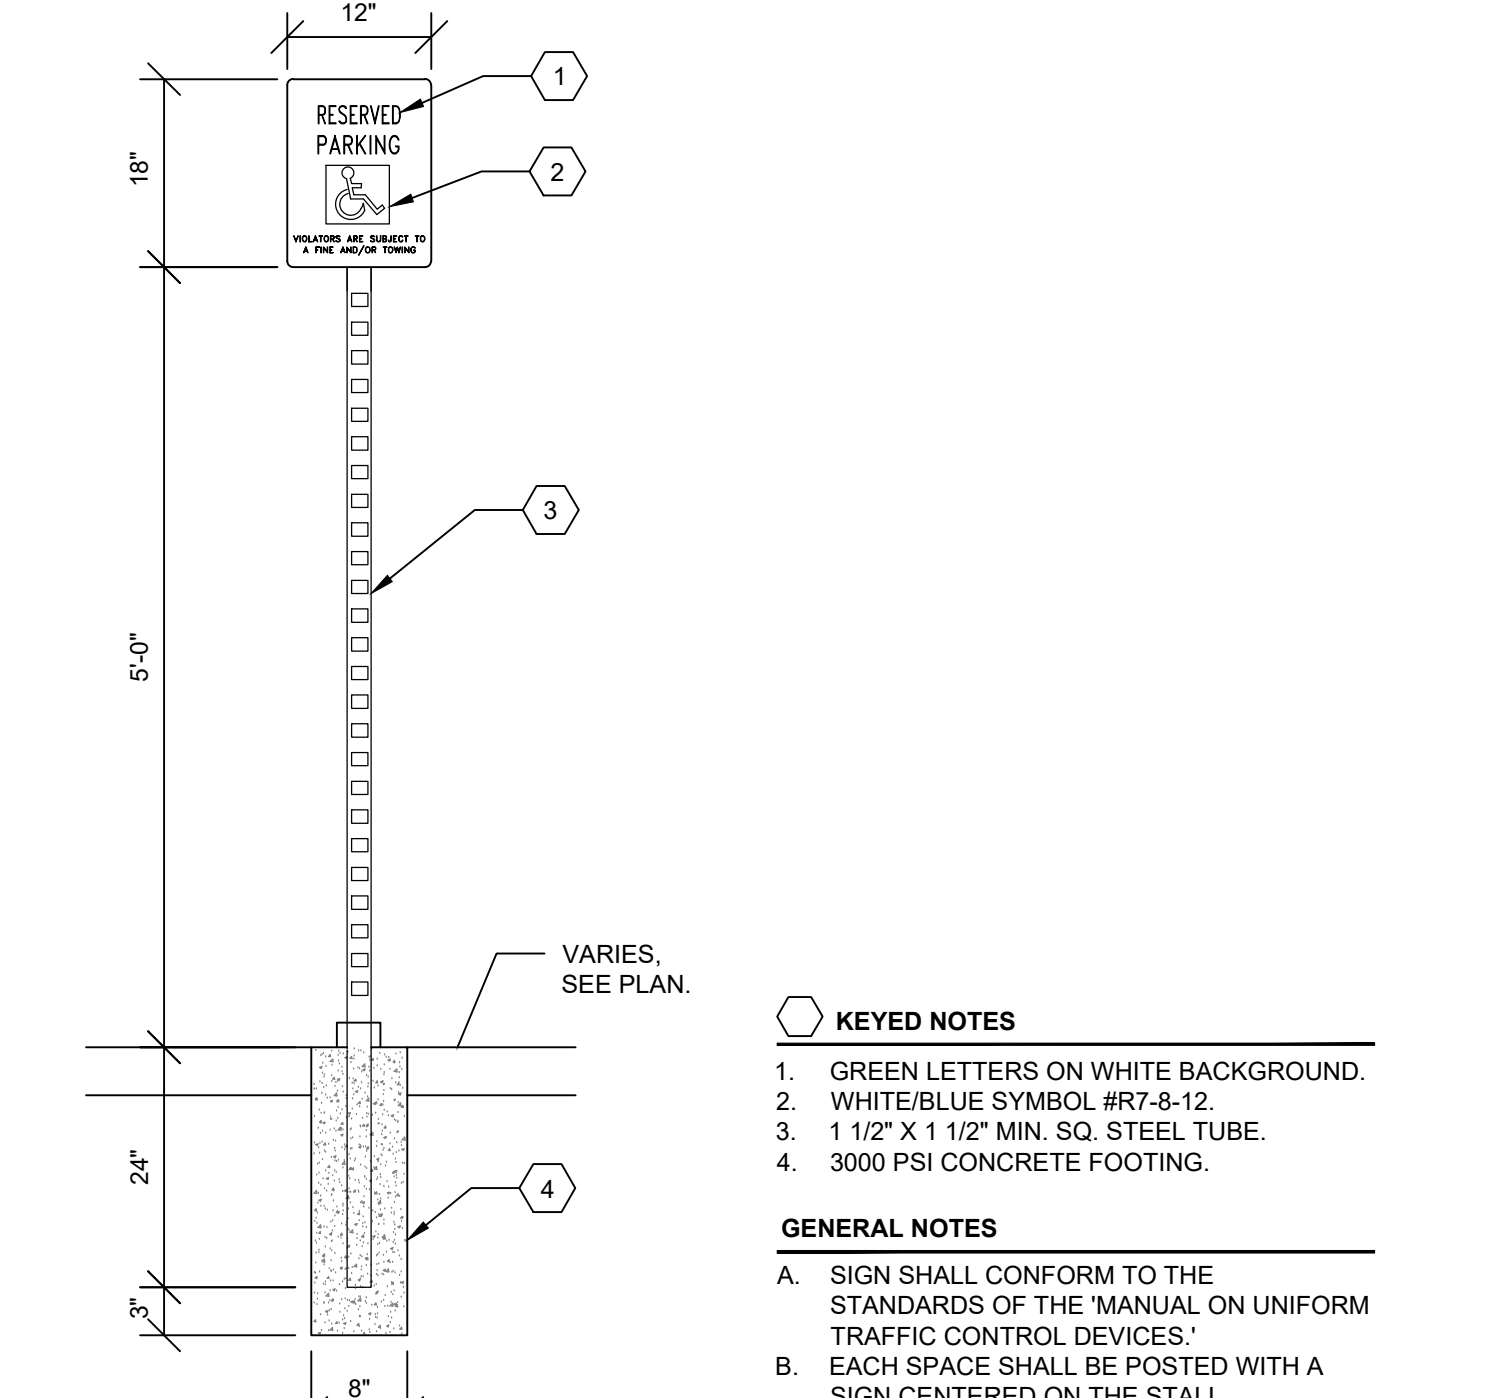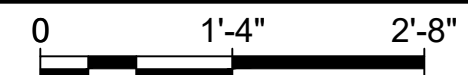

SCALE: 3/4" = 1'-0"

KEYED NOTES



- GREEN LETTERS ON WHITE BACKGROUND.
- WHITE/BLUE SYMBOL #R7-8-12.
- 1 1/2" X 1 1/2" MIN. SQ. STEEL TUBE.
- 3000 PSI CONCRETE FOOTING.

GENERAL NOTES

- SIGN SHALL CONFORM TO THE STANDARDS OF THE "MANUAL ON UNIFORM TRAFFIC CONTROL DEVICES."
- EACH SPACE SHALL BE POSTED WITH A SIGN CENTERED ON THE STALL.

A4 ACCESSIBLE PARKING SPACE SIGN

SCALE: 3/4" = 1'-0"

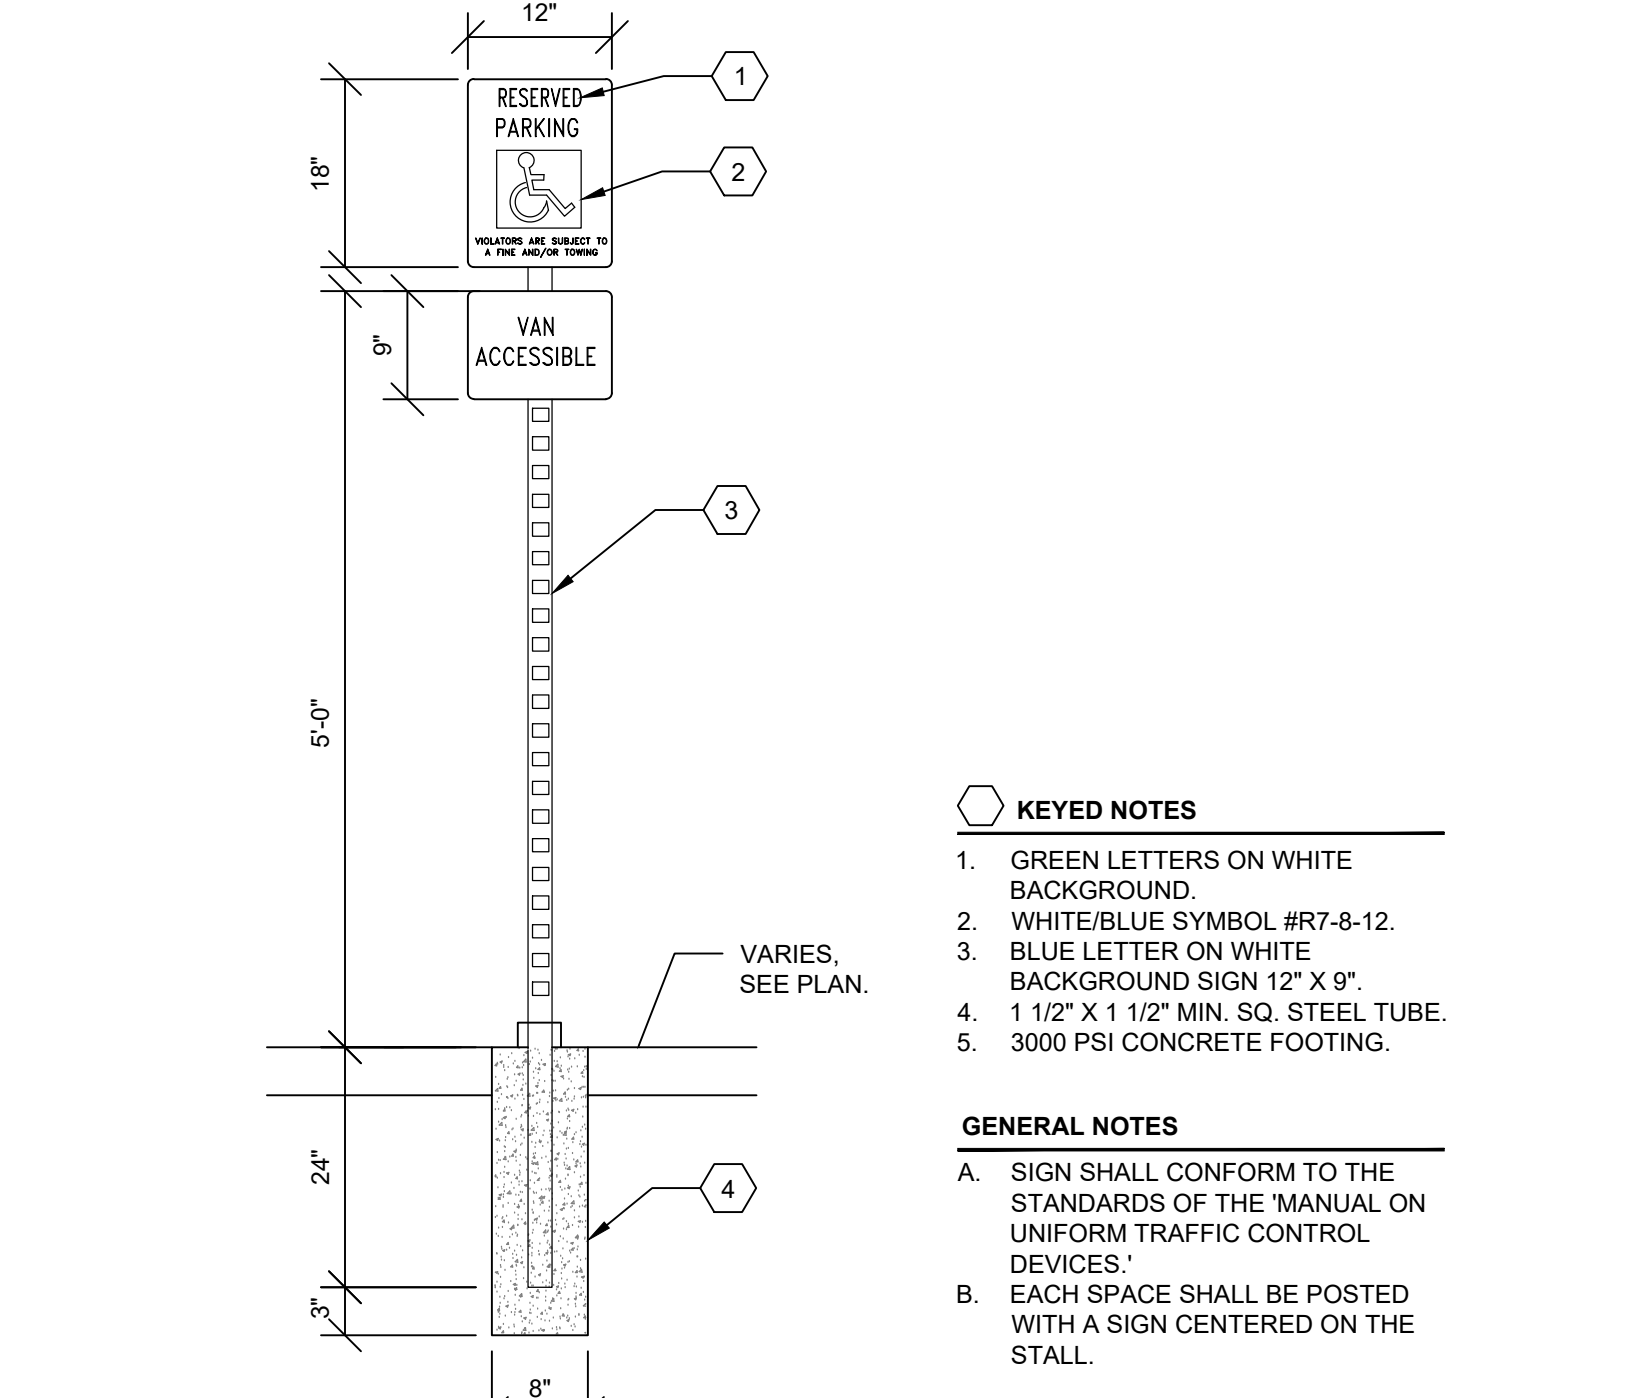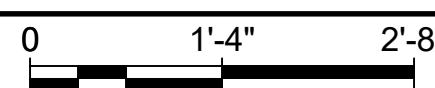

SCALE: 3/4" = 1'-0"

KEYED NOTES


- GREEN LETTERS ON WHITE BACKGROUND.
- WHITE/BLUE SYMBOL #R7-8-12.
- BLUE LETTER ON WHITE BACKGROUND SIGN 12" X 9".
- 1 1/2" X 1 1/2" MIN. SQ. STEEL TUBE.
- 3000 PSI CONCRETE FOOTING.

GENERAL NOTES

- SIGN SHALL CONFORM TO THE STANDARDS OF THE "MANUAL ON UNIFORM TRAFFIC CONTROL DEVICES."
- EACH SPACE SHALL BE POSTED WITH A SIGN CENTERED ON THE STALL.

A5 ACCESSIBLE PARKING SPACE SIGN

SCALE: 3/4" = 1'-0"

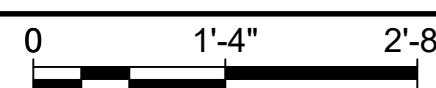

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Park Square Plaza
Renovation

6565 AMERICAS PKWY
ALBUQUERQUE, NM 87110

APRIL 2024

MARK DATE DESCRIPTION


ISSUE: CONSTRUCTION DOCUMENTS
DATE: APRIL 22, 2024
PROJECT NO:
DRAWN BY: TW/MM
CHECKED BY: WM

SHEET TITLE

TRAFFIC CIRCULATION
DETAILS

TC-501

Park Square Plaza Renovation

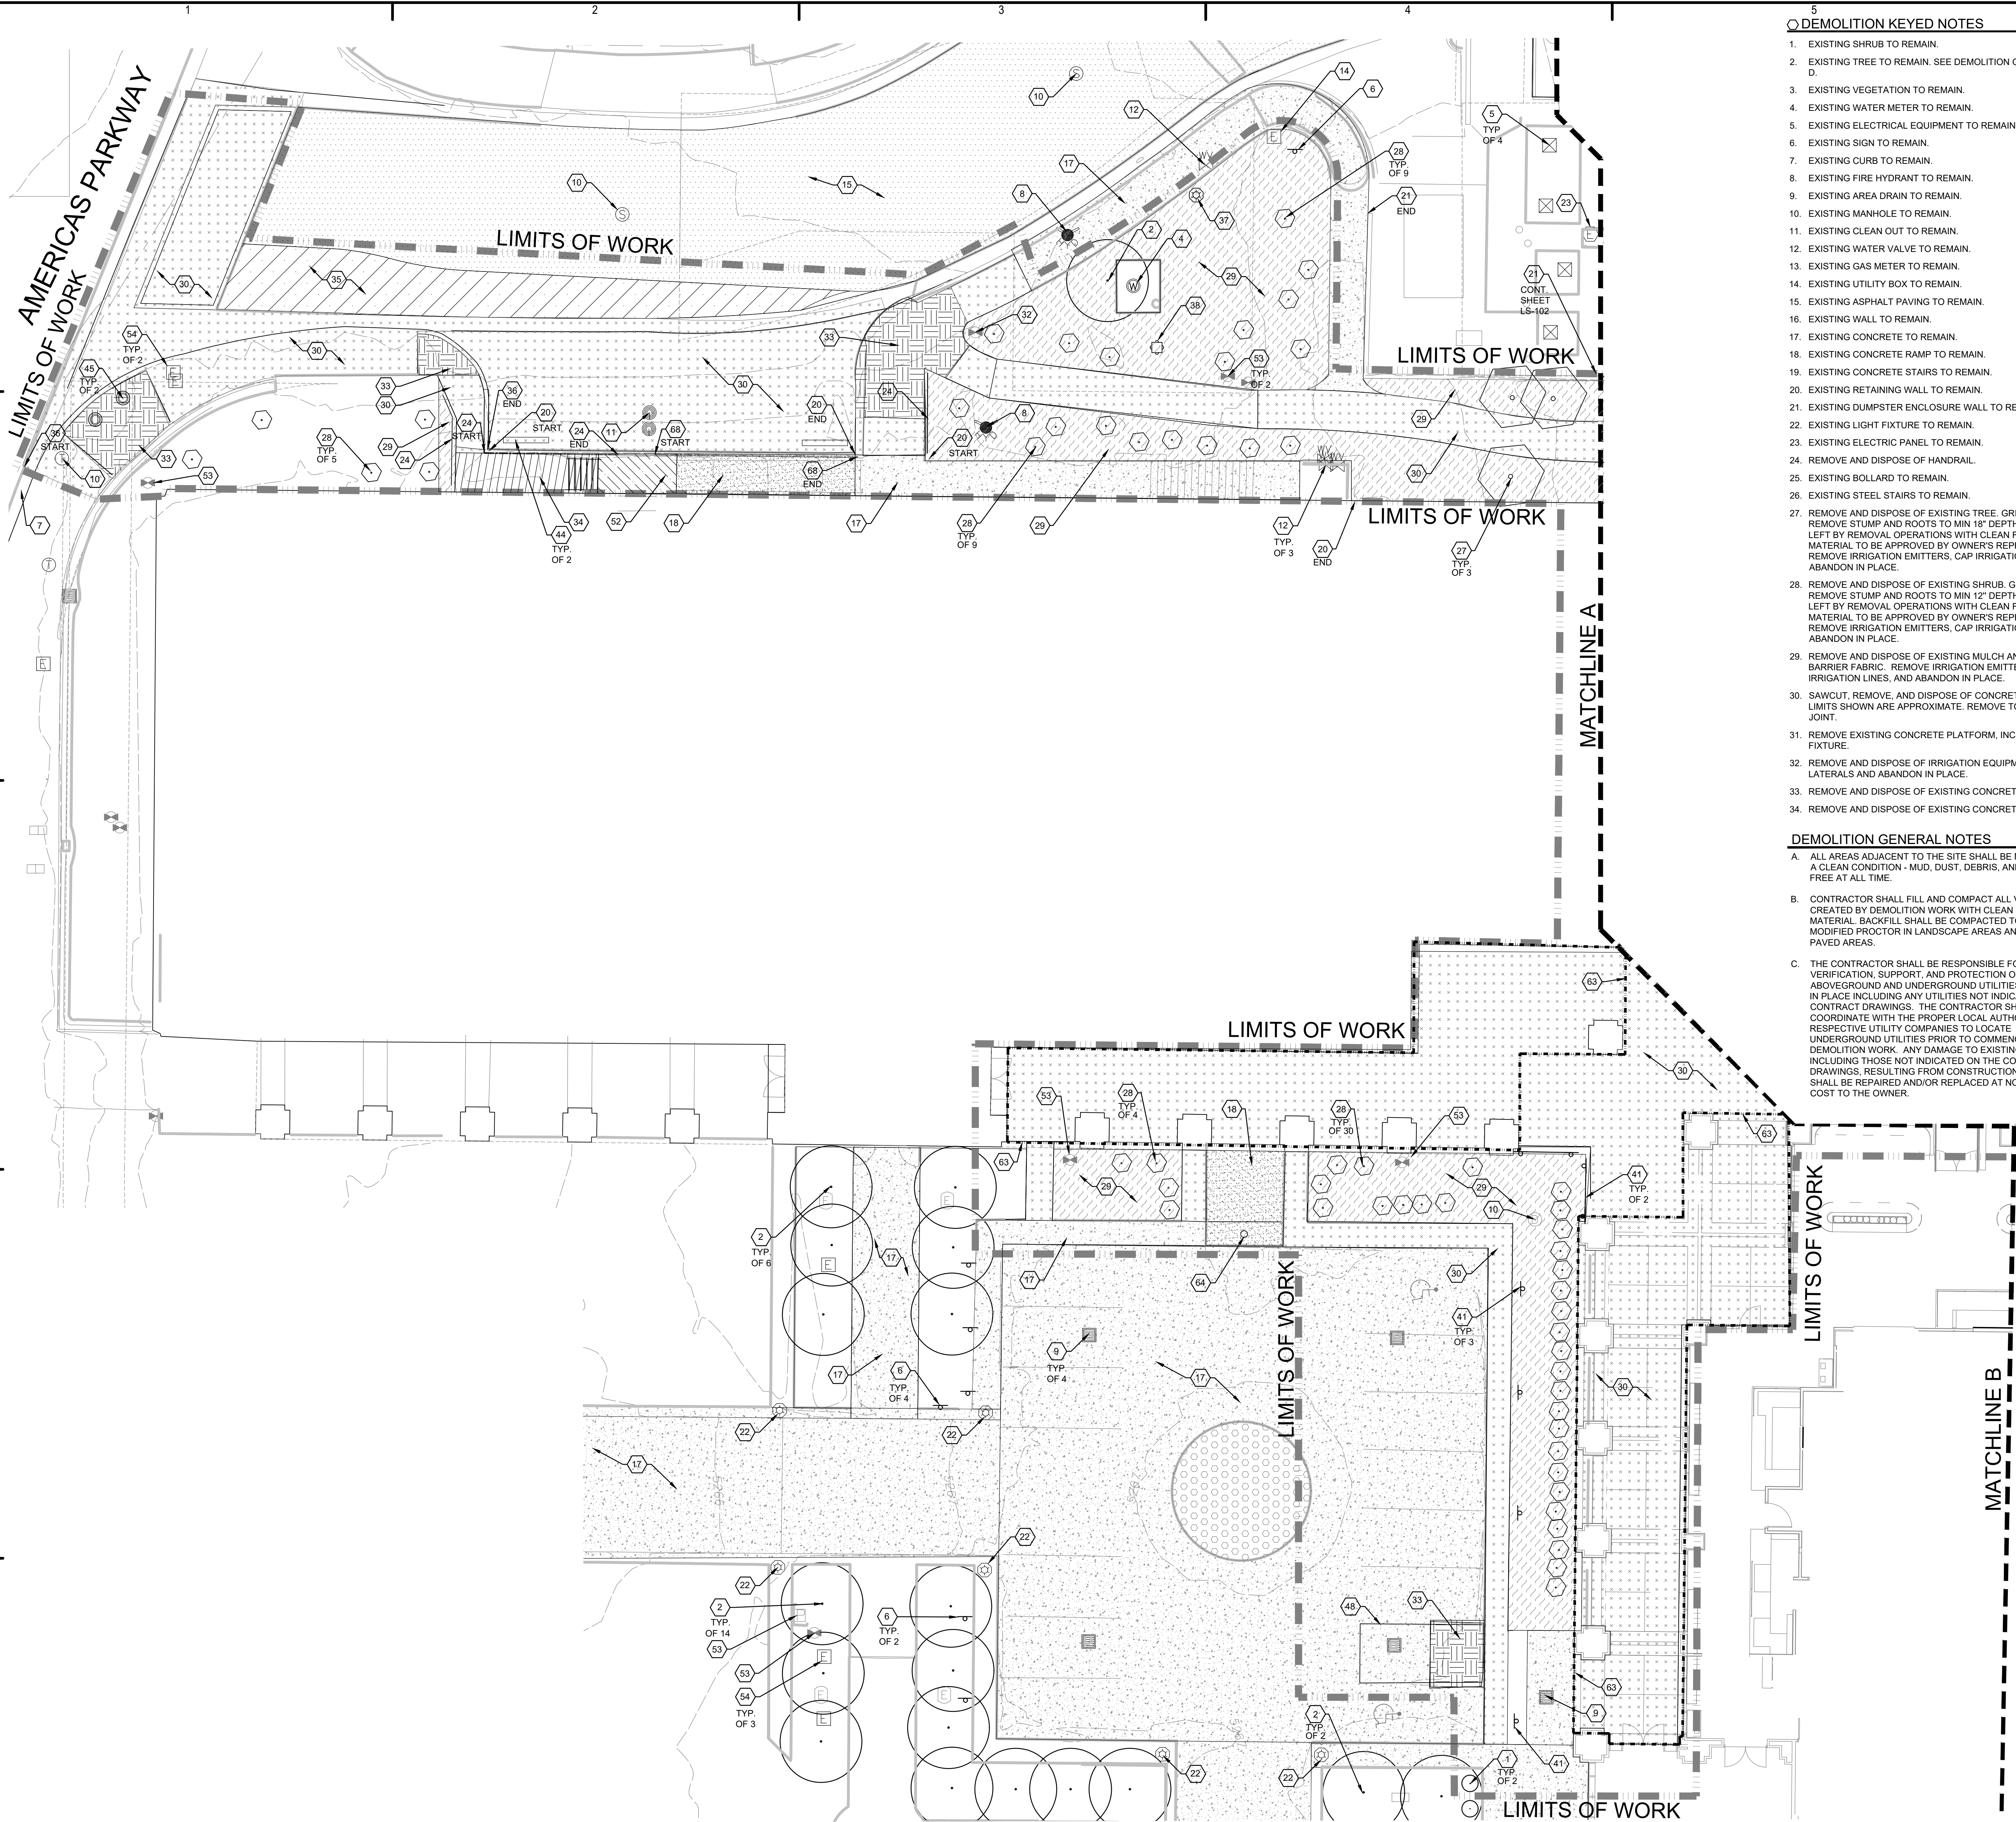

DEMOLITION KEYED NOTES

- EXISTING SHRUB TO REMAIN.
- EXISTING TREE TO REMAIN. SEE DEMOLITION GENERAL NOTE D.
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DEMOLITION GENERAL NOTES

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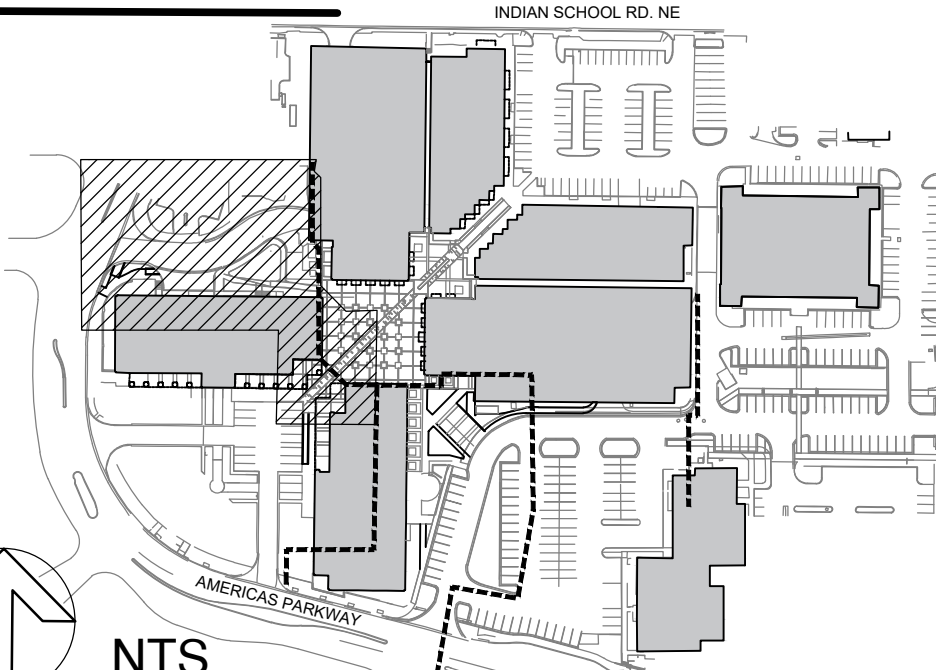
DEMOLITION HATCH LEGEND

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- EXISTING CONCRETE LANDING TO REMAIN. SEE KEYED NOTE 52.
- EXISTING TURFGRASS TO REMAIN. SEE KEYED NOTE 61.

DEMOLITION LINETYPE LEGEND

- LIMITS OF WORK.
- LIMITS OF PHASE 1 WORK.
- LIMITS OF DEDUCTIVE ALTERNATE 1. SEE KEYED NOTE 63.
- REMOVE PARKING LOT STRIPING. SEE KEYED NOTE 48.

KEY MAP



NTS

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P 505.883.5200 WEB: www.fbtarch.com

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LANDSCAPE ARCHITECT

Park Square Plaza Renovation

6565 AMERICAS PKWY
ALBUQUERQUE, NM 87110

APRIL 2024

MARK DATE DESCRIPTION

ISSUE: CONSTRUCTION DOCUMENTS

DATE: APRIL 22, 2024

PROJECT NO:


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CHECKED BY: WM

SHEET TITLE

DEMOLITION PLAN

LD-101

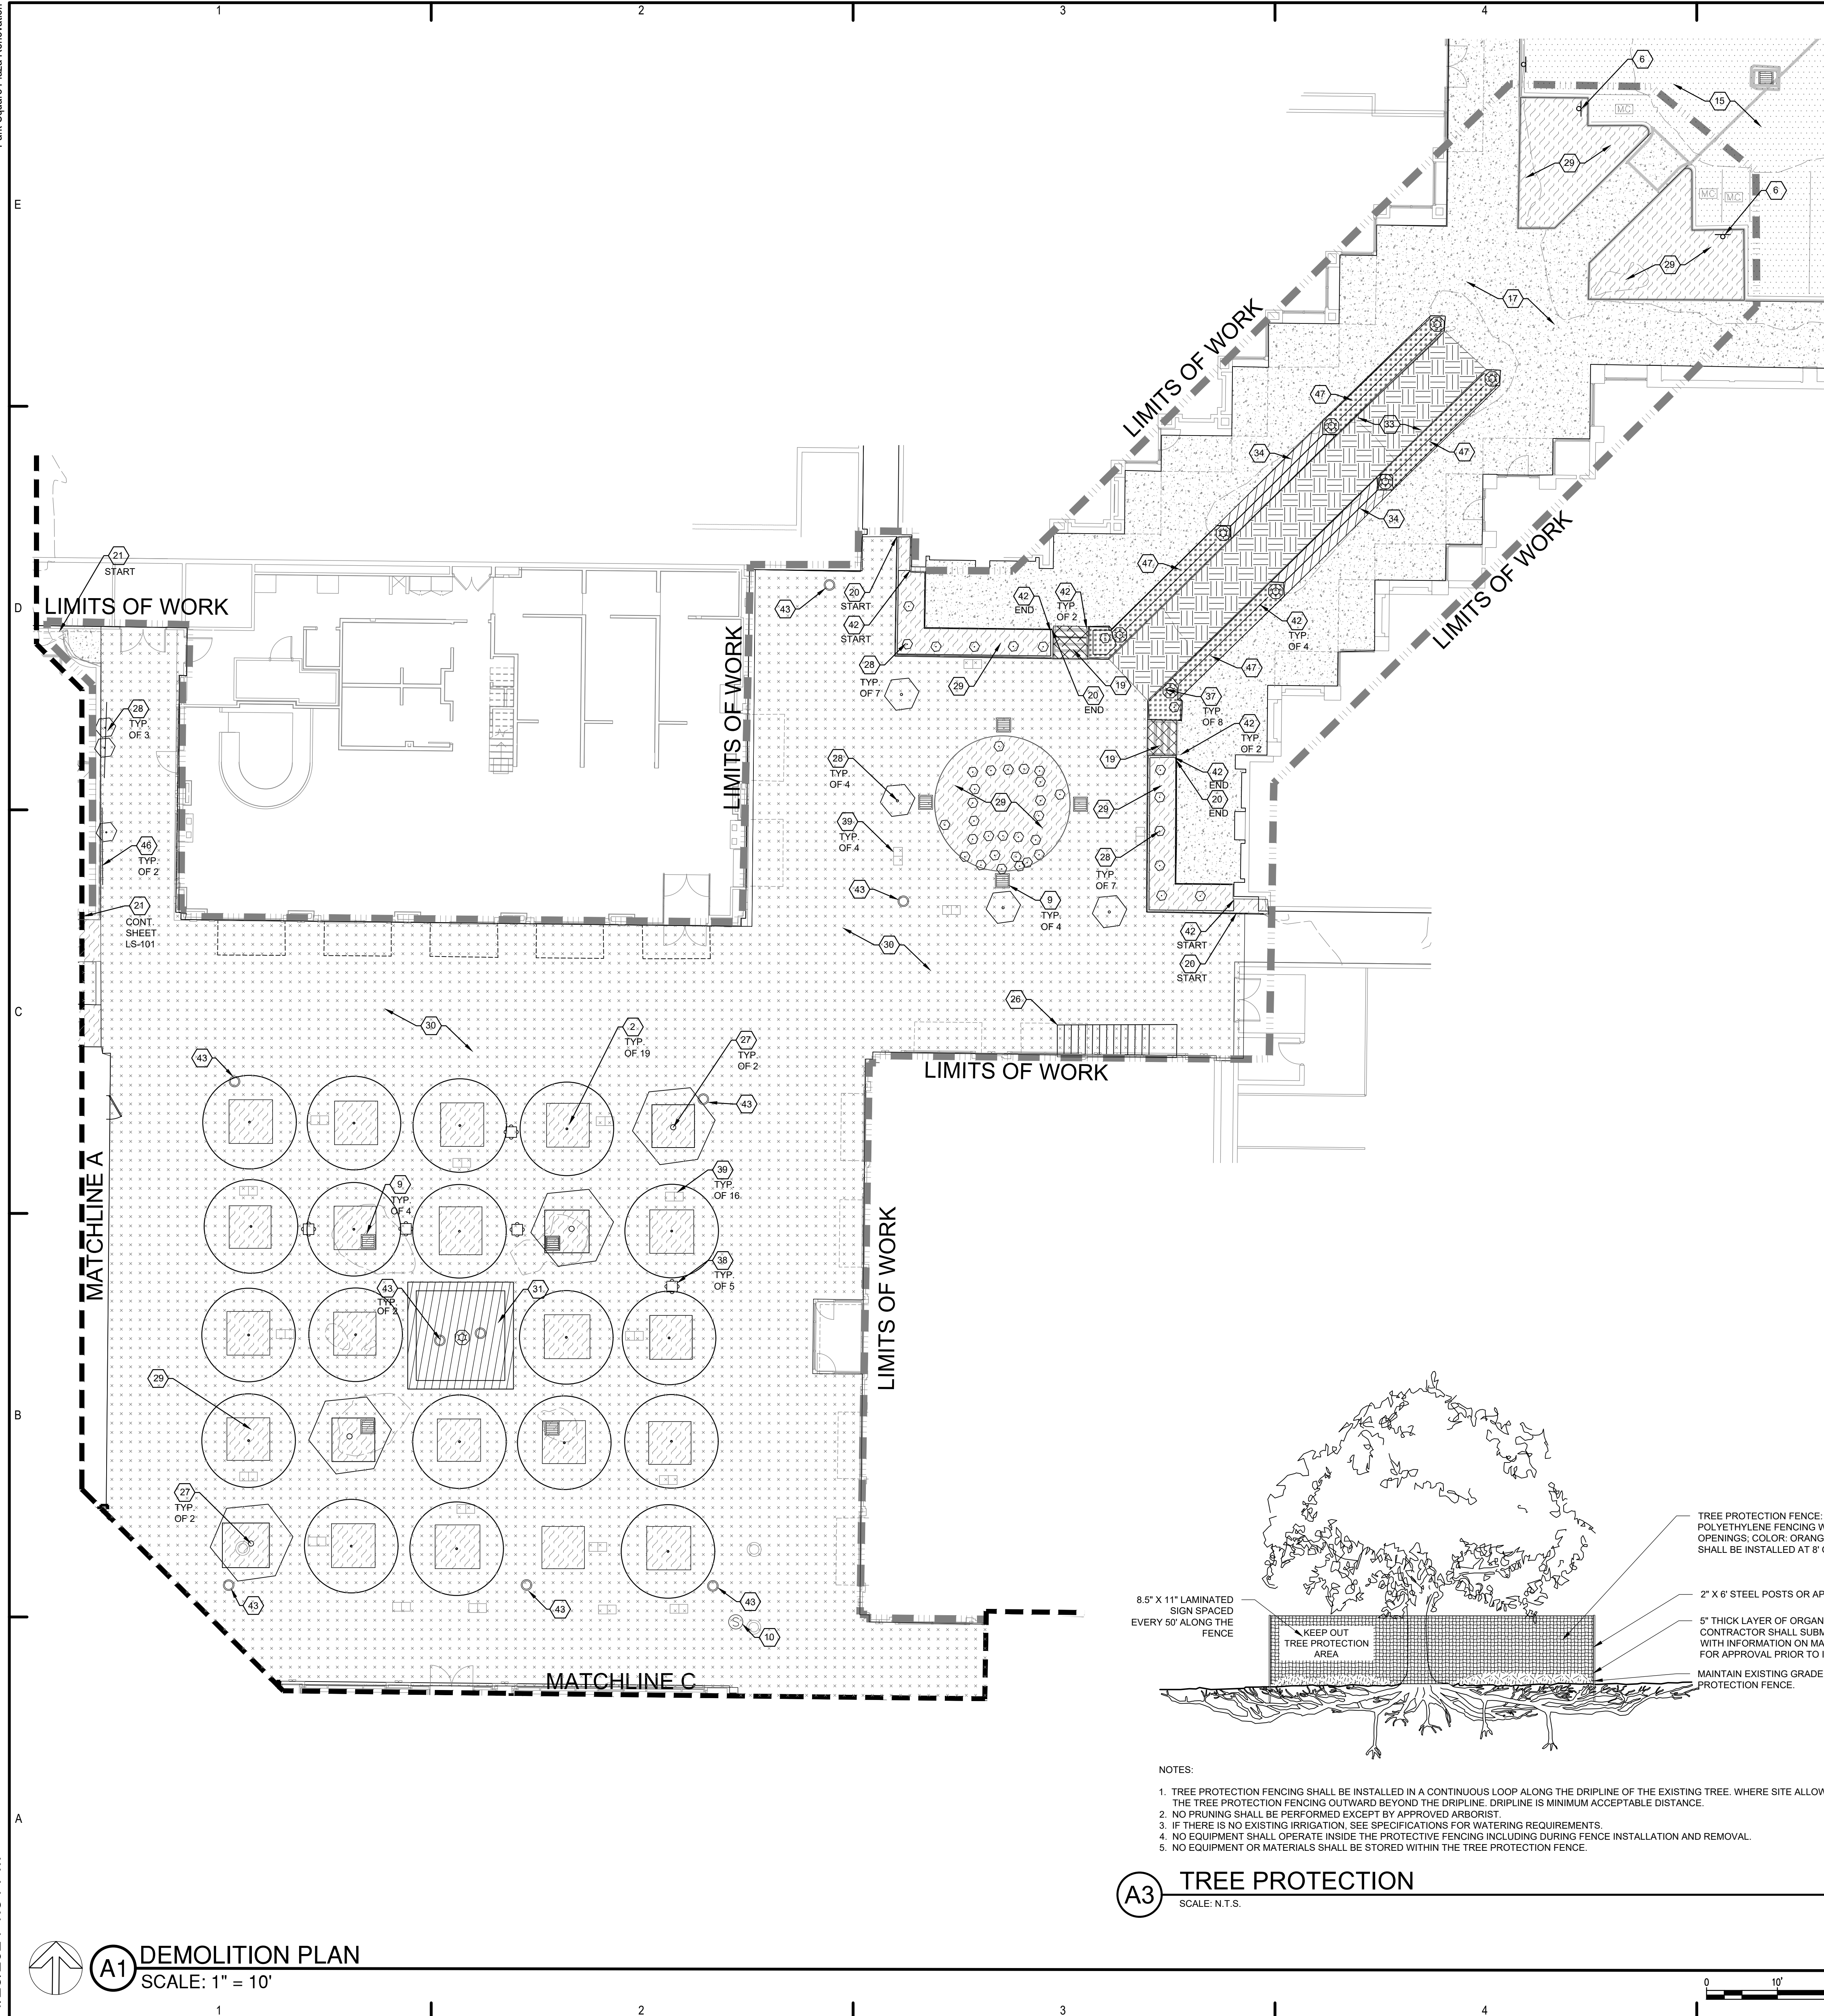

DEMOLITION KEYED NOTES

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- EXISTING VEGETATION TO REMAIN.
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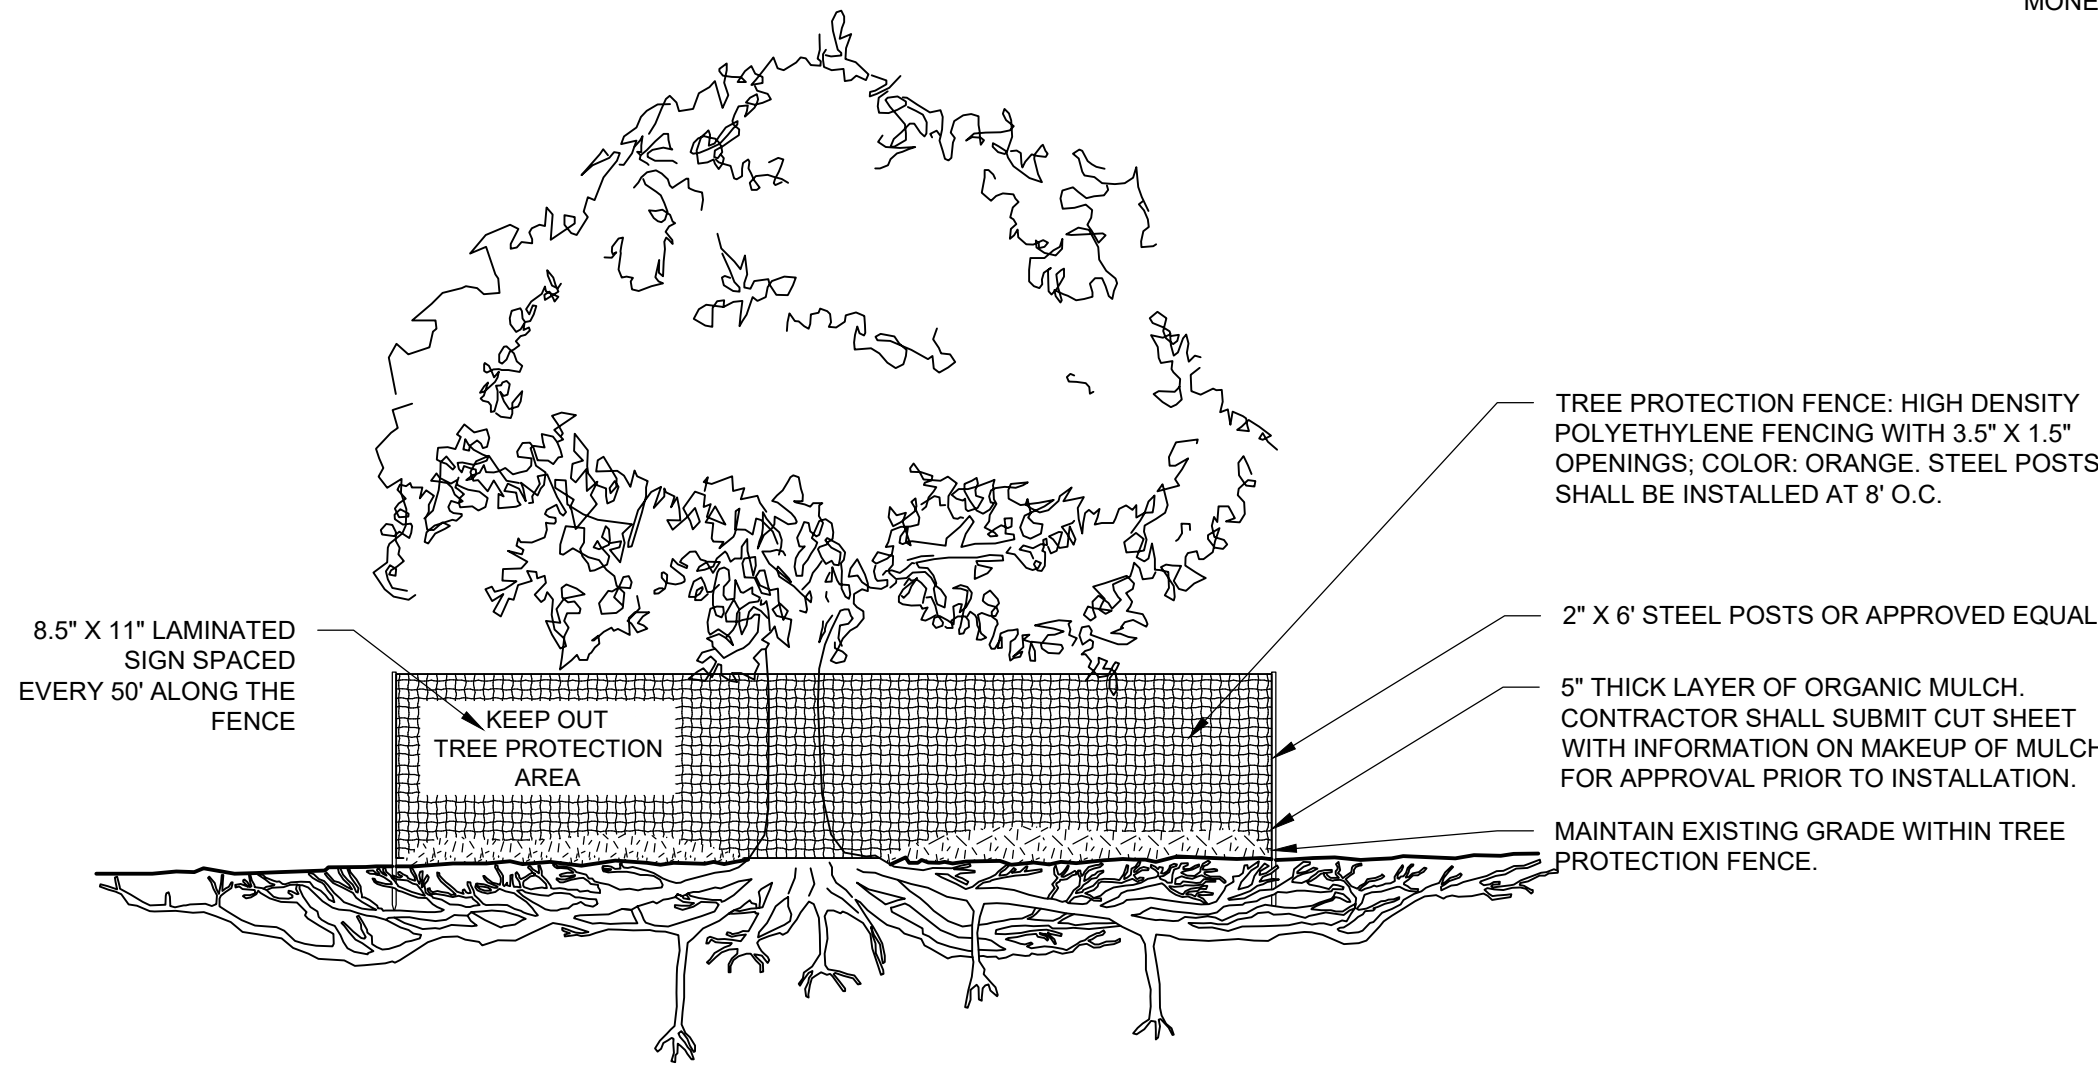
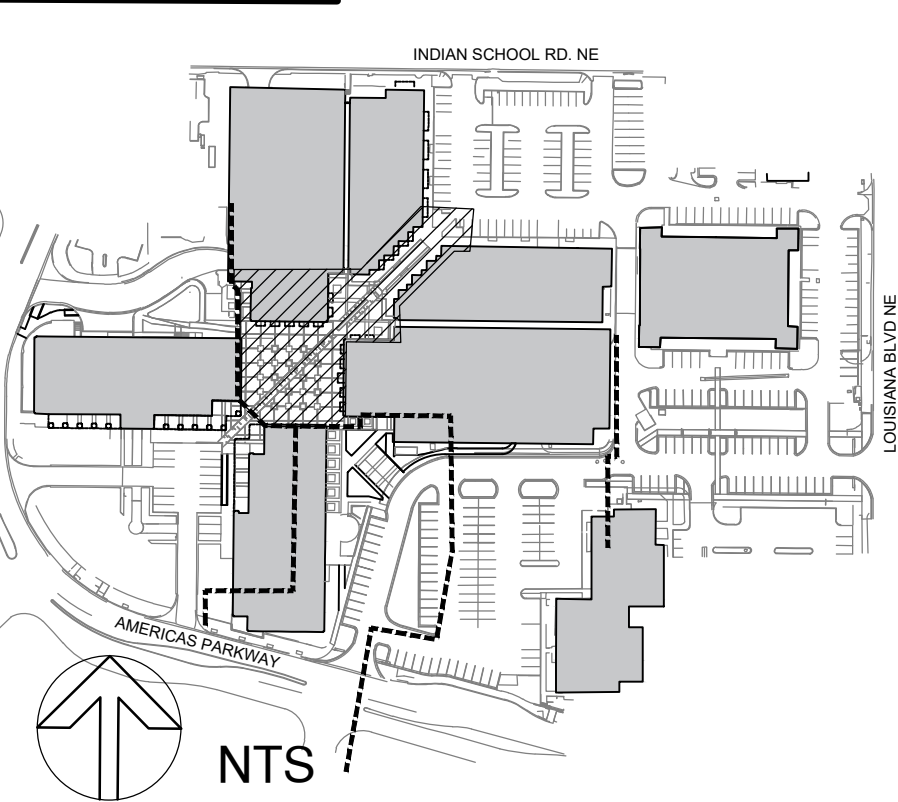
DEMOLITION HATCH LEGEND

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DEMOLITION LINETYPE LEGEND

| | |
|--|---|
| | LIMITS OF WORK. |
| | LIMITS OF PHASE 1 WORK. |
| | LIMITS OF DEDUCTIVE ALTERNATE 1. SEE KEYED NOTE 63. |
| | REMOVE PARKING LOT STRIPING. SEE KEYED NOTE 48. |

KEY MAP



NOTES:

- TREE PROTECTION FENCING SHALL BE INSTALLED IN A CONTINUOUS LOOP ALONG THE DRIPLINE OF THE EXISTING TREE. WHERE SITE ALLOWS, EXTEND THE TREE PROTECTION FENCING OUTWARD BEYOND THE DRIPLINE. DRIPLINE IS MINIMUM ACCEPTABLE DISTANCE.
- NO PRUNING SHALL BE PERFORMED EXCEPT BY APPROVED ARBORIST.
- IF THERE IS NO EXISTING IRRIGATION, SEE SPECIFICATIONS FOR WATERING REQUIREMENTS.
- NO EQUIPMENT SHALL OPERATE INSIDE THE PROTECTIVE FENCING INCLUDING DURING FENCE INSTALLATION AND REMOVAL.
- NO EQUIPMENT OR MATERIALS SHALL BE STORED WITHIN THE TREE PROTECTION FENCE.

A3 TREE PROTECTION
SCALE: N.T.S.

A1 DEMOLITION PLAN
SCALE: 1" = 10'

CONSULTANTS

LANDSCAPE ARCHITECT
Groundwork Studio
6501 Americas Pkwy NE, Ste. 350
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CIVIL ENGINEER

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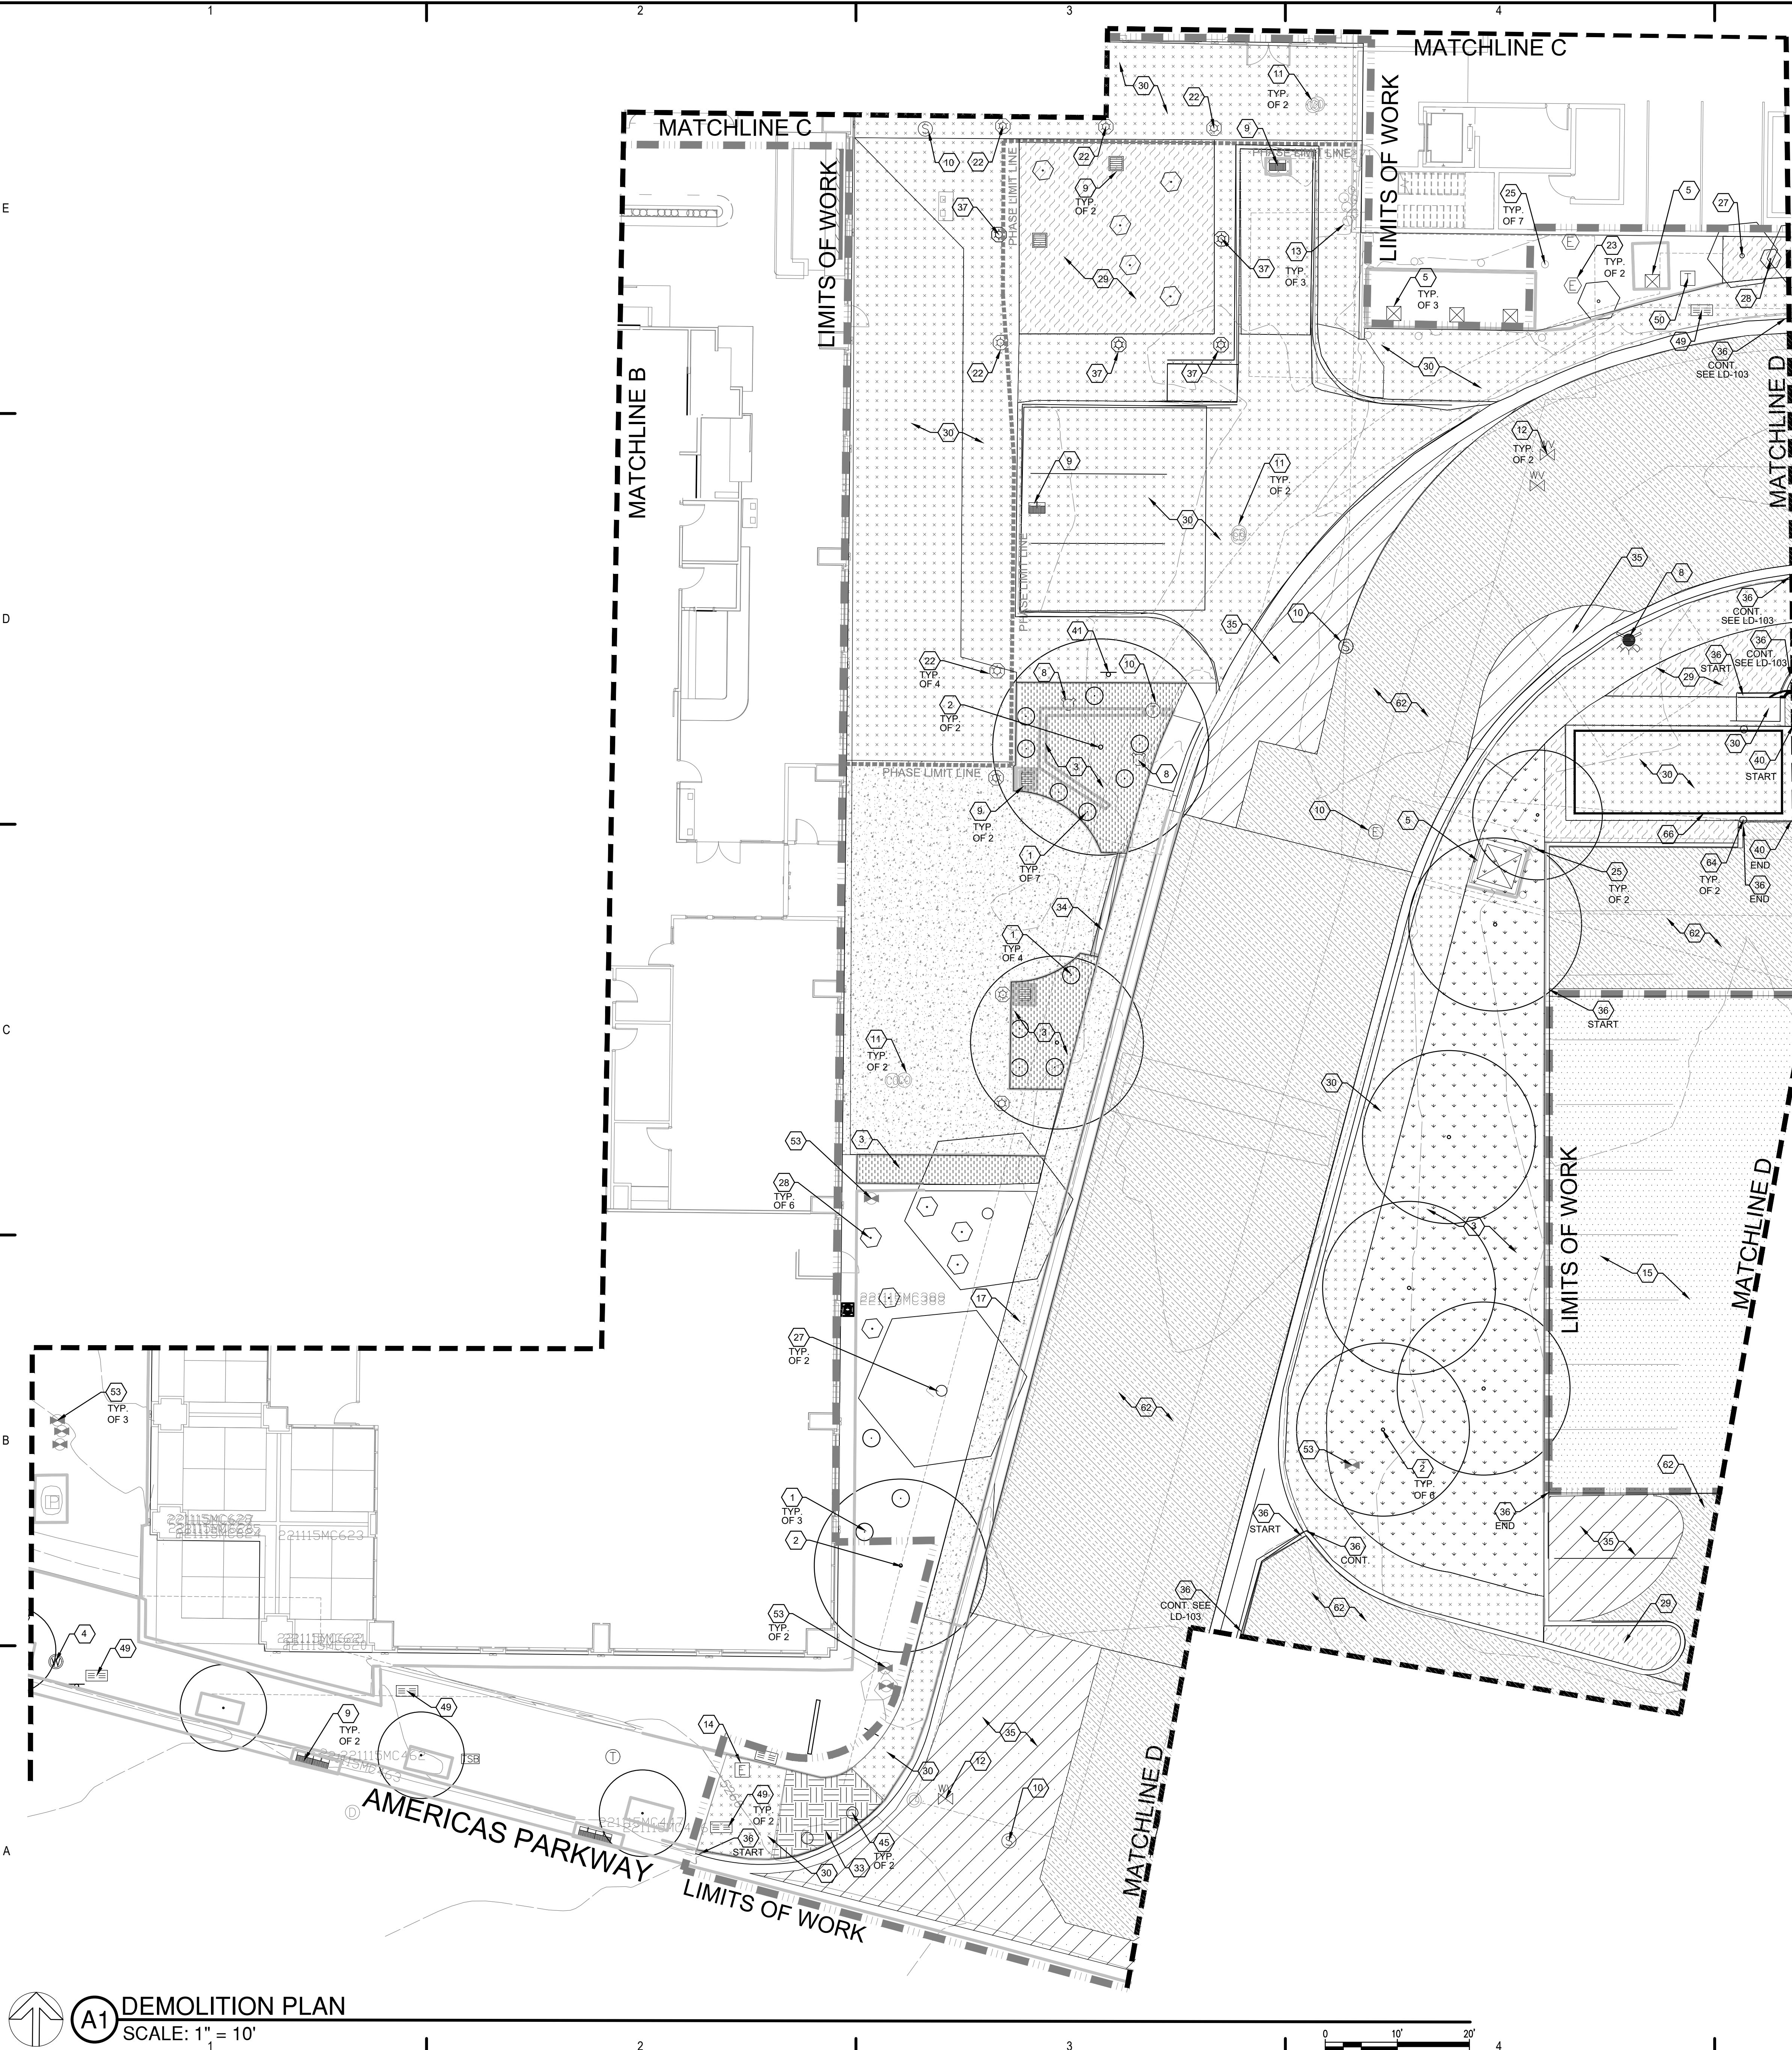
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| PROJECT NO: | |
| DRAWN BY: | TW/WM |
| CHECKED BY: | WM |

SHEET TITLE

DEMOLITION PLAN



DEMOLITION KEYED NOTES

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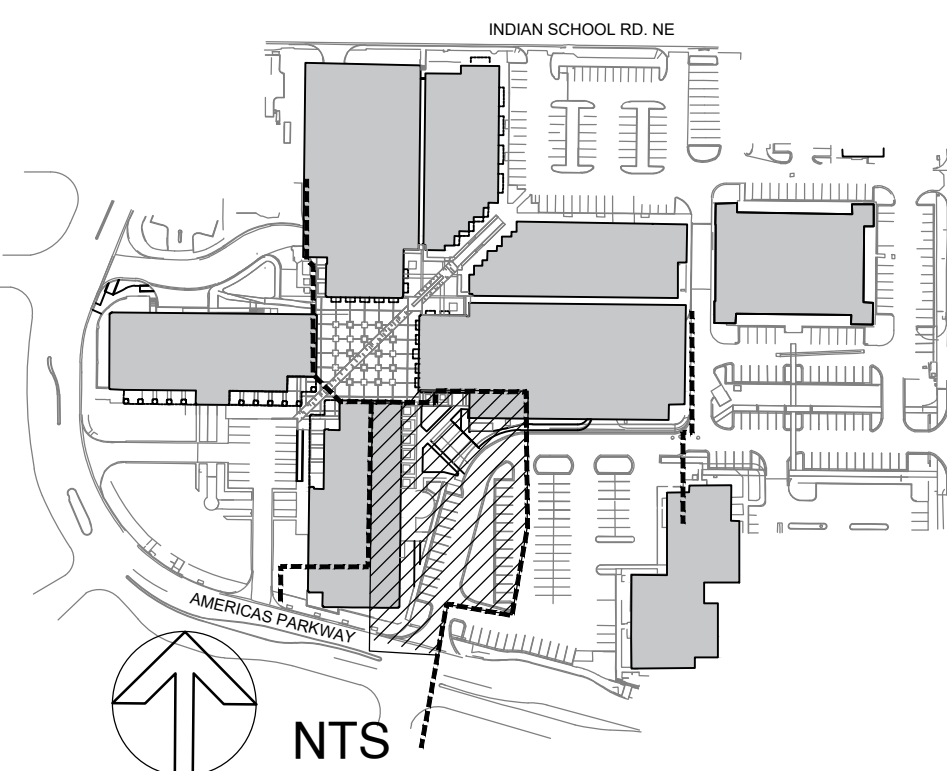
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KEY MAP



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ALBUQUERQUE, NM 87110

APRIL 2024


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ISSUE: CONSTRUCTION DOCUMENTS
DATE: APRIL 22, 2024
PROJECT NO:
DRAWN BY: TW/WM
CHECKED BY: WM

SHEET TITLE

DEMOLITION PLAN

LD-103

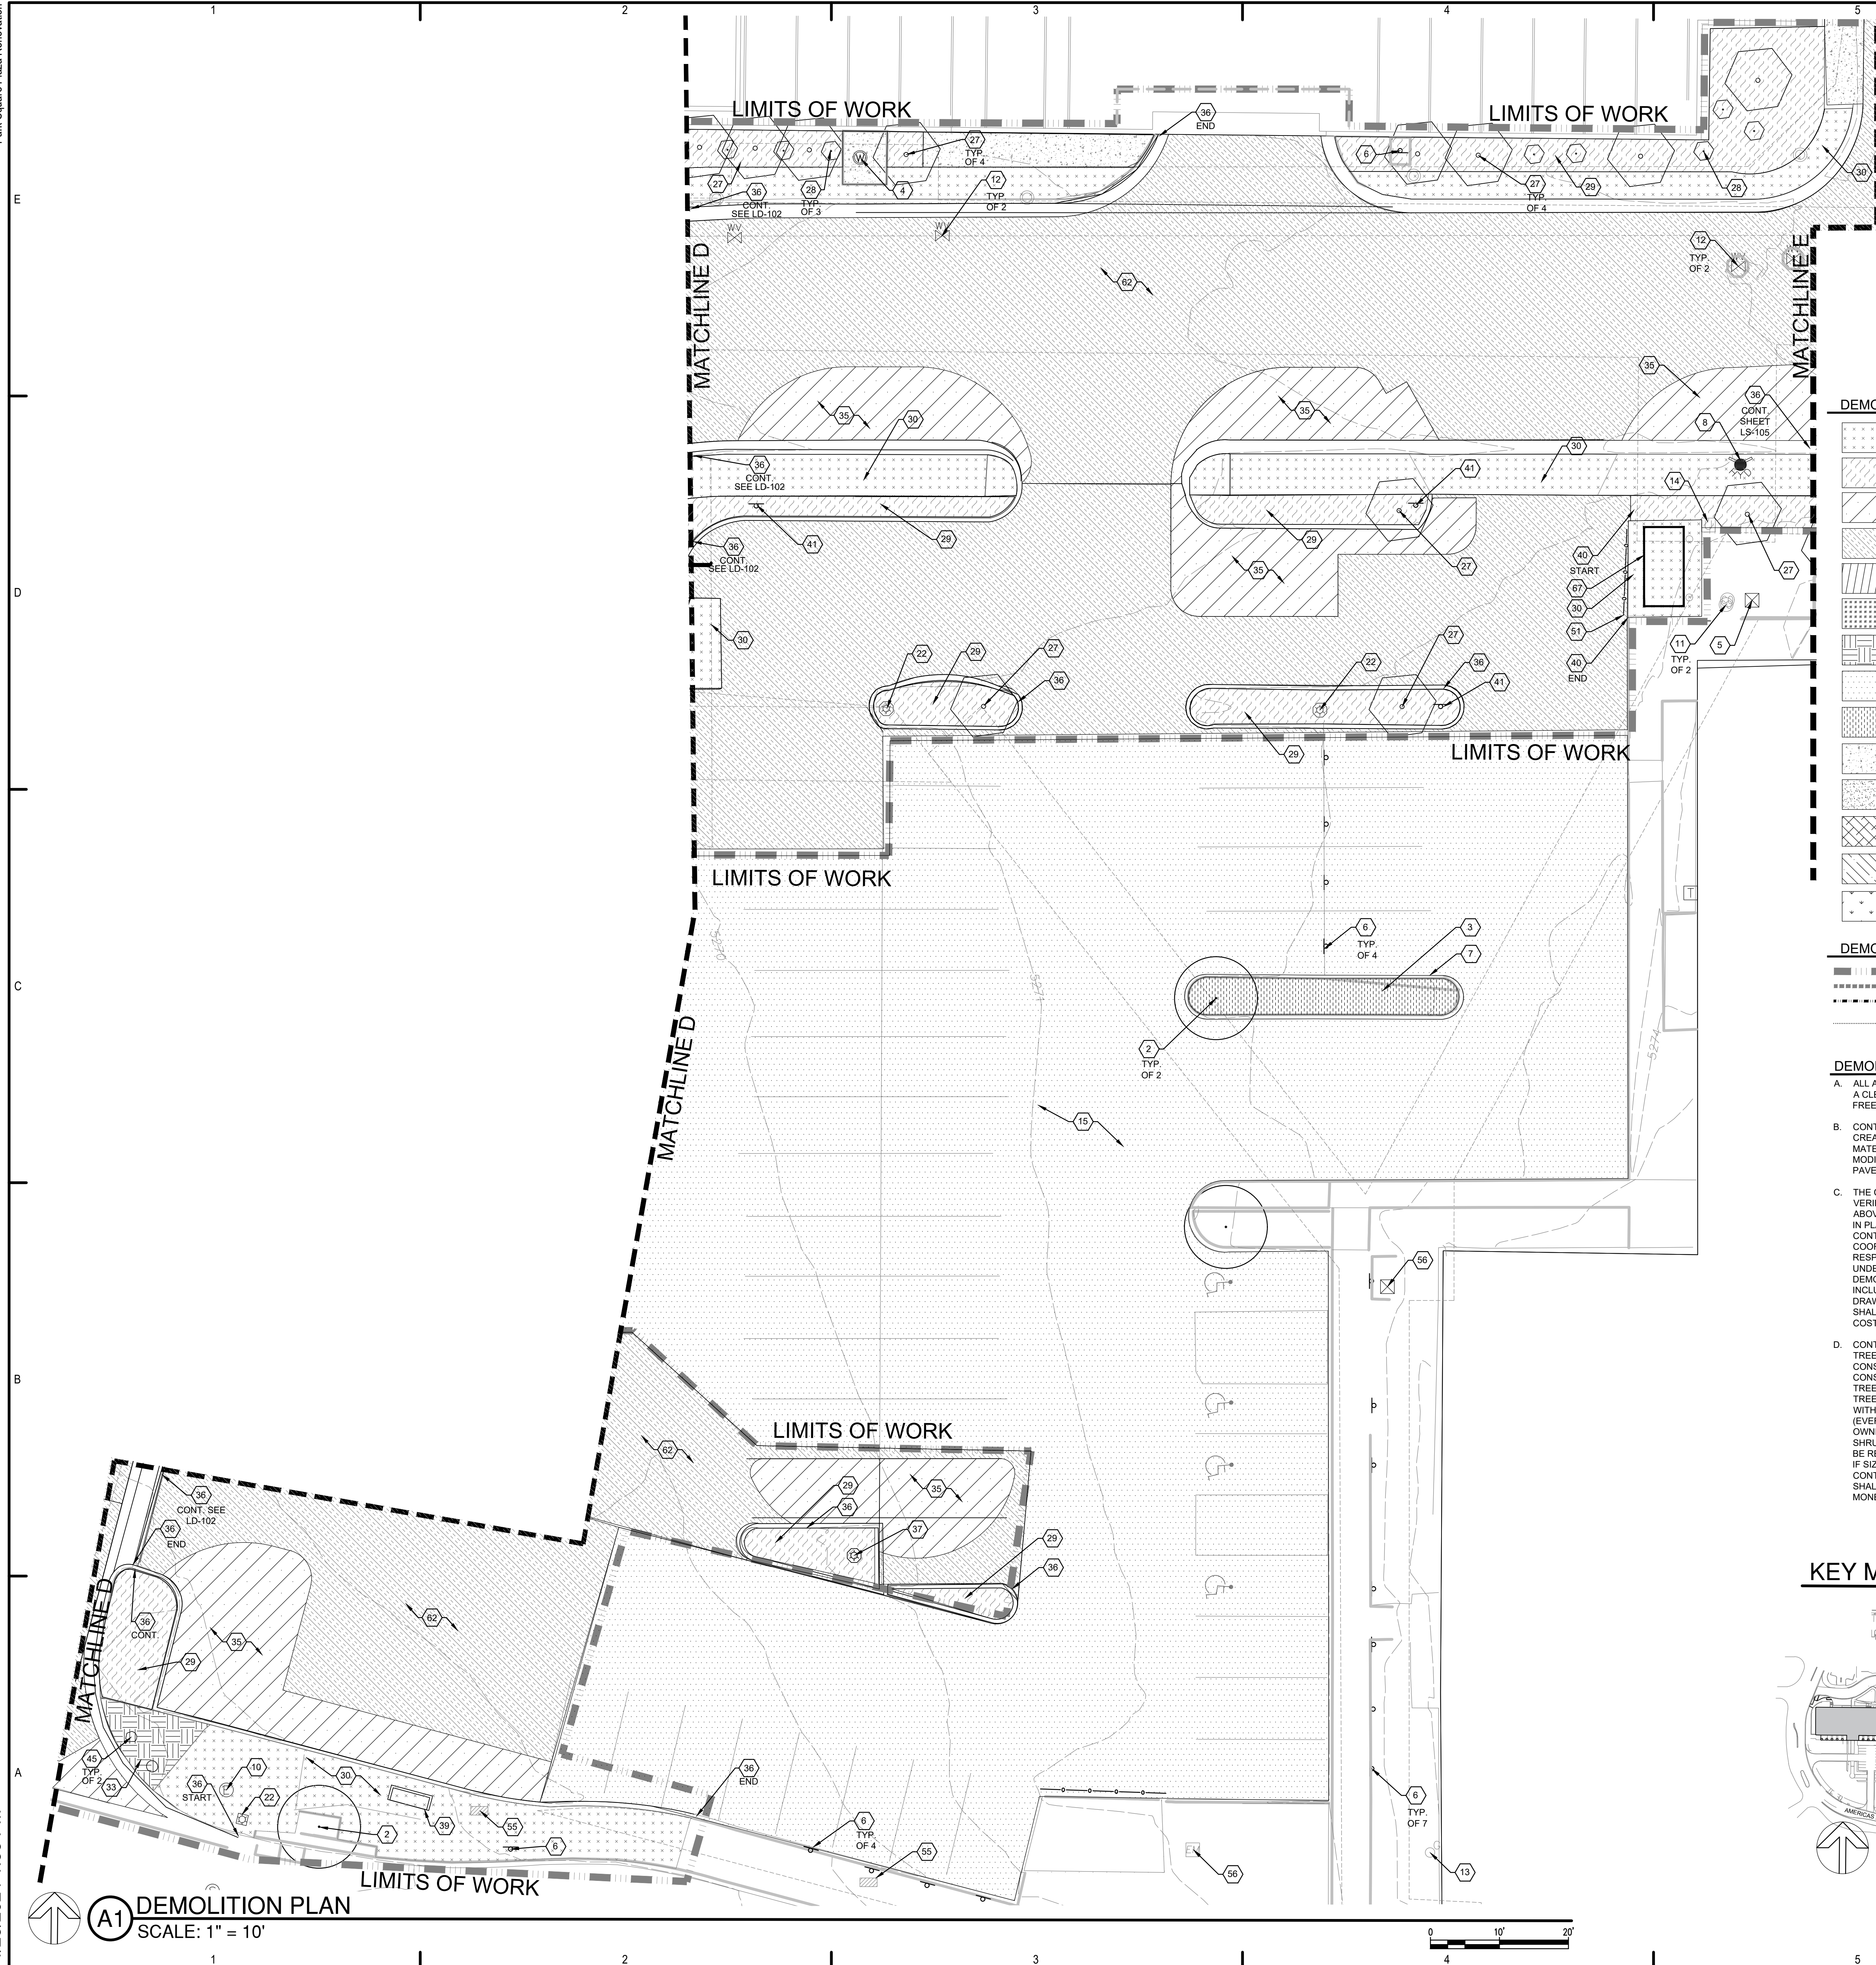

DEMOLITION HATCH LEGEND

- REMOVE EXISTING CONCRETE PAVEMENT. SEE KEYED NOTE 30.
- REMOVE EXISTING MULCH AND FABRIC. SEE KEYED NOTE 29.
- REMOVE EXISTING ASPHALT. SEE KEYED NOTE 35.
- RESURFACE EXISTING ASPHALT. SEE KEYED NOTE 62.
- REMOVE EXISTING CONCRETE STAIRS. SEE KEYED NOTE 34.
- REMOVE EXISTING RETAINING WALL. SEE KEYED NOTE 47.
- REMOVE EXISTING CONCRETE RAMP. SEE KEYED NOTE 33.
- EXISTING ASPHALT PAVEMENT TO REMAIN. SEE KEYED NOTE 15.
- EXISTING VEGETATION TO REMAIN. SEE KEYED NOTE 3.
- EXISTING CONCRETE WALK TO REMAIN. SEE KEYED NOTE 17.
- EXISTING CONCRETE RAMP TO REMAIN. SEE KEYED NOTE 18.
- EXISTING CONCRETE STAIRS TO REMAIN. SEE KEYED NOTE 19.
- EXISTING CONCRETE LANDING TO REMAIN. SEE KEYED NOTE 52.
- EXISTING TURFGRASS TO REMAIN. SEE KEYED NOTE 61.


DEMOLITION LINETYPE LEGEND

- LIMITS OF WORK.
- LIMITS OF PHASE 1 WORK.
- LIMITS OF DEDUCTIVE ALTERNATE 1. SEE KEYED NOTE 63.
- REMOVE PARKING LOT STRIPING. SEE KEYED NOTE 48.

DEMOLITION GENERAL NOTES

- A. ALL AREAS ADJACENT TO THE SITE SHALL BE MAINTAINED IN A CLEAN CONDITION - MUD, DUST, DEBRIS, AND GRAFFITI FREE AT ALL TIME.
- B. CONTRACTOR SHALL FILL AND COMPACT ALL VOIDS CREATED BY DEMOLITION WORK WITH CLEAN BACKFILL MATERIAL. BACKFILL SHALL BE COMPACTED TO 85% MODIFIED PROCTOR IN LANDSCAPE AREAS AND 95% IN PAVED AREAS.
- C. THE CONTRACTOR SHALL BE RESPONSIBLE FOR LOCATION VERIFICATION, SUPPORT, AND PROTECTION OF ALL ABOVEGROUND AND UNDERGROUND UTILITIES TO REMAIN IN PLACE INCLUDING ANY UTILITIES NOT INDICATED ON CONTRACT DRAWINGS. THE CONTRACTOR SHALL COORDINATE WITH THE PROPER LOCAL AUTHORITIES OR RESPECTIVE UTILITY COMPANIES TO LOCATE UNDERGROUND UTILITIES PRIOR TO COMMENCING THE DEMOLITION WORK. ANY DAMAGE TO EXISTING UTILITIES, INCLUDING THOSE NOT INDICATED ON THE CONTRACT DRAWINGS, RESULTING FROM CONSTRUCTION OPERATIONS SHALL BE REPAIRED AND/OR REPLACED AT NO ADDITIONAL COST TO THE OWNER.
- D. CONTRACTOR SHALL PRESERVE AND PROTECT EXISTING TREES DESIGNATED AS TO REMAIN FROM DAMAGE BY CONSTRUCTION OPERATIONS. ANY TREE DAMAGED BY CONSTRUCTION OPERATIONS SHALL BE REPLACED WITH A TREE OF THE SAME SPECIES AND SIZE. IF SIZE OF EXISTING TREE IS NOT AVAILABLE CONTRACTOR SHALL REPLACE WITH A 2" CAL. TREE (DECIDUOUS) OF 6" HT. TREE (EVERGREEN) AND SHALL PROVIDE A CREDIT TO THE OWNER FOR THE MONETARY DIFFERENCE IN VALUE. SEE DETAIL A3/LD-102.

KEY MAP

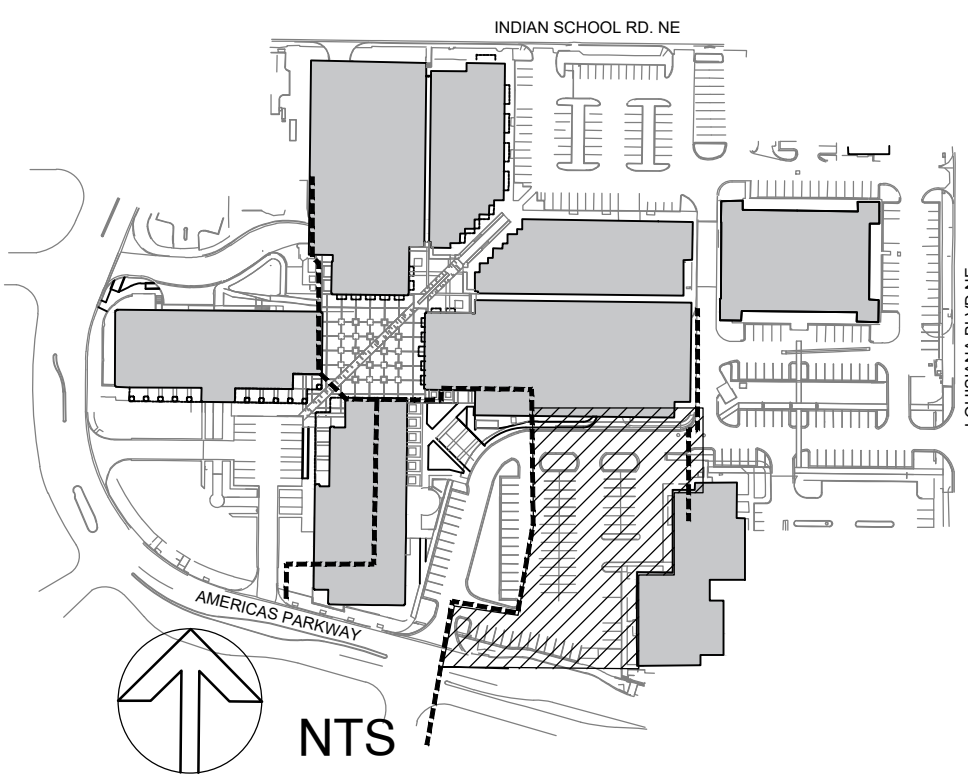

DEMOLITION KEYED NOTES

- EXISTING SHRUB TO REMAIN.
- EXISTING TREE TO REMAIN. SEE DEMOLITION GENERAL NOTE D.
- EXISTING VEGETATION TO REMAIN.
- EXISTING WATER METER TO REMAIN.
- EXISTING ELECTRICAL EQUIPMENT TO REMAIN.
- EXISTING SIGN TO REMAIN.
- EXISTING CURB TO REMAIN.
- EXISTING FIRE HYDRANT TO REMAIN.
- EXISTING AREA DRAIN TO REMAIN.
- EXISTING MANHOLE TO REMAIN.
- EXISTING CLEAN OUT TO REMAIN.
- EXISTING WATER VALVE TO REMAIN.
- EXISTING GAS METER TO REMAIN.
- EXISTING UTILITY BOX TO REMAIN.
- EXISTING ASPHALT PAVING TO REMAIN.
- EXISTING WALL TO REMAIN.
- EXISTING CONCRETE TO REMAIN.
- EXISTING CONCRETE RAMP TO REMAIN.
- EXISTING CONCRETE STAIRS TO REMAIN.
- EXISTING RETAINING WALL TO REMAIN.
- EXISTING DUMPSTER ENCLOSURE WALL TO REMAIN.
- EXISTING LIGHT FIXTURE TO REMAIN.
- EXISTING ELECTRIC PANEL TO REMAIN.
- REMOVE AND DISPOSE OF HANDRAIL.
- EXISTING BOLLARD TO REMAIN.
- EXISTING STEEL STAIRS TO REMAIN.
- REMOVE AND DISPOSE OF EXISTING TREE. GRIND AND REMOVE STUMP AND ROOTS TO MIN 18" DEPTH. BACKFILL VOID LEFT BY REMOVAL OPERATIONS WITH CLEAN FILL. FILL MATERIAL TO BE APPROVED BY OWNER'S REPRESENTATIVE. REMOVE IRRIGATION EMITTERS, CAP IRRIGATION LINES, AND ABANDON IN PLACE.
- REMOVE AND DISPOSE OF EXISTING SHRUB. GRIND AND REMOVE STUMP AND ROOTS TO MIN 12" DEPTH. BACKFILL VOID LEFT BY REMOVAL OPERATIONS WITH CLEAN FILL. FILL MATERIAL TO BE APPROVED BY OWNER'S REPRESENTATIVE. REMOVE IRRIGATION EMITTERS, CAP IRRIGATION LINES, AND ABANDON IN PLACE.
- REMOVE AND DISPOSE OF EXISTING MULCH AND WEED BARRIER FABRIC. REMOVE IRRIGATION EMITTERS, CAP IRRIGATION LINES, AND ABANDON IN PLACE.
- SAWCUT, REMOVE, AND DISPOSE OF CONCRETE PAVEMENT. LIMITS SHOWN ARE APPROXIMATE. REMOVE TO NEAREST JOINT.
- REMOVE EXISTING CONCRETE PLATFORM, INCLUDING LIGHT FIXTURE.
- REMOVE AND DISPOSE OF IRRIGATION EQUIPMENT. CAP LATERALS AND ABANDON IN PLACE.
- REMOVE AND DISPOSE OF EXISTING CONCRETE RAMP.
- REMOVE AND DISPOSE OF EXISTING CONCRETE STAIRS.
- SAWCUT, REMOVE, AND DISPOSE OF EXISTING ASPHALT PAVEMENT. LIMITS SHOWN ARE APPROXIMATE.
- SAWCUT, REMOVE, AND DISPOSE OF EXISTING CURB AND GUTTER. LIMITS SHOWN ARE APPROXIMATE. REMOVE TO NEAREST JOINT.
- REMOVE AND DISPOSE OF EXISTING LIGHT FIXTURE INCLUDING PEDESTAL.
- REMOVE AND DISPOSE OF EXISTING CONCRETE TABLE AND CHAIRS.
- REMOVE AND DISPOSE OF EXISTING CONCRETE BENCH.
- REMOVE AND DISPOSE OF EXISTING DUMPSTER ENCLOSURE.
- REMOVE AND DISPOSE OF SIGN, INCLUDING FOOTING.
- REMOVE AND DISPOSE OF EXISTING STEEL RAILING.
- REMOVE AND DISPOSE OF EXISTING TRASH RECEPTACLE.
- REMOVE AND DISPOSE OF EXISTING PARKING BUMPER.
- REMOVE AND DISPOSE OF EXISTING CONCRETE BOLLARD, INCLUDING FOOTING.
- REMOVE AND DISPOSE OF EXISTING STEEL TRELLIS.
- REMOVE AND DISPOSE OF EXISTING CONCRETE RETAINING WALL, INCLUDING FOOTING.
- REMOVE PAVEMENT STRIPING.
- EXISTING PULLBOX TO REMAIN.
- EXISTING TELEPHONE PEDESTAL TO REMAIN.
- REMOVE AND DISPOSE OF CHAIN LINK FENCE.
- EXISTING CONCRETE LANDING TO REMAIN.
- EXISTING IRRIGATION EQUIPMENT TO REMAIN.
- EXISTING TRAFFIC SIGNAL BOX TO REMAIN.
- EXISTING STREET LIGHT BOX TO REMAIN.
- EXISTING ELECTRIC METER TO REMAIN.
- EXISTING POWER POLE TO REMAIN.
- EXISTING WALL HYDRANT TO REMAIN.
- EXISTING ELECTRIC BOX TO REMAIN.
- EXISTING POST-INDICATOR VALVE TO REMAIN.
- EXISTING TURFGRASS TO REMAIN. CONTRACTOR SHALL PROTECT-IN-PLACE AND REPLACE ANY GRASS DAMAGED DURING CONSTRUCTION. SEE IRRIGATION PLANS.
- REMOVE EXISTING MONUMENT SIGN, INCLUDING FOOTING. BACKFILL VOID LEFT BY REMOVAL OPERATIONS WITH CLEAN FILL. FILL MATERIAL TO BE APPROVED BY OWNER'S REPRESENTATIVE.
- REMOVE AND STOCKPILE EXISTING COMPACTOR FOR REINSTALLATION. STOCKPILE LOCATION TO BE APPROVED BY OWNER.
- REMOVE AND STOCKPILE EXISTING DUMPSTER. STOCKPILE LOCATION TO BE APPROVED BY OWNER.
- EXISTING GUARD RAIL TO REMAIN.

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STATE OF NEW MEXICO
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REGISTERED PROFESSIONAL LANDSCAPE ARCHITECT
04/25/2024
LANDSCAPE ARCHITECT

Park Square Plaza Renovation

6565 AMERICAS PKWY
ALBUQUERQUE, NM 87110

APRIL 2024

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ISSUE: CONSTRUCTION DOCUMENTS

DATE: APRIL 22, 2024

PROJECT NO: TW/WM

DRAWN BY: WM

CHECKED BY: WM

SHEET TITLE

DEMOLITION PLAN

LD-104

Park Square Plaza Renovation

DEMOLITION KEYED NOTES

- EXISTING SHRUB TO REMAIN.
- EXISTING TREE TO REMAIN. SEE DEMOLITION GENERAL NOTE D.
- EXISTING VEGETATION TO REMAIN.
- EXISTING WATER METER TO REMAIN.
- EXISTING ELECTRICAL EQUIPMENT TO REMAIN.
- EXISTING SIGN TO REMAIN.
- EXISTING CURB TO REMAIN.
- EXISTING FIRE HYDRANT TO REMAIN.
- EXISTING AREA DRAIN TO REMAIN.
- EXISTING MANHOLE TO REMAIN.
- EXISTING CLEAN OUT TO REMAIN.
- EXISTING WATER VALVE TO REMAIN.
- EXISTING GAS METER TO REMAIN.
- EXISTING UTILITY BOX TO REMAIN.
- EXISTING ASPHALT PAVING TO REMAIN.
- EXISTING WALL TO REMAIN.
- EXISTING CONCRETE TO REMAIN.
- EXISTING CONCRETE RAMP TO REMAIN.
- EXISTING CONCRETE STAIRS TO REMAIN.
- EXISTING RETAINING WALL TO REMAIN.

- EXISTING DUMPSTER ENCLOSURE WALL TO REMAIN.
- EXISTING LIGHT FIXTURE TO REMAIN.
- EXISTING ELECTRIC PANEL TO REMAIN.
- REMOVE AND DISPOSE OF HANDRAIL.
- EXISTING BOLLARD TO REMAIN.
- EXISTING STEEL STAIRS TO REMAIN.
- REMOVE AND DISPOSE OF EXISTING TREE. GRIND AND REMOVE STUMP AND ROOTS TO MIN 18" DEPTH. BACKFILL VOID LEFT BY REMOVAL OPERATIONS WITH CLEAN FILL. FILL MATERIAL TO BE APPROVED BY OWNER'S REPRESENTATIVE. REMOVE IRRIGATION EMITTERS, CAP IRRIGATION LINES, AND ABANDON IN PLACE.
- REMOVE AND DISPOSE OF EXISTING SHRUB. GRIND AND REMOVE STUMP AND ROOTS TO MIN 12" DEPTH. BACKFILL VOID LEFT BY REMOVAL OPERATIONS WITH CLEAN FILL. FILL MATERIAL TO BE APPROVED BY OWNER'S REPRESENTATIVE. REMOVE IRRIGATION EMITTERS, CAP IRRIGATION LINES, AND ABANDON IN PLACE.
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- SAWCUT, REMOVE, AND DISPOSE OF CONCRETE PAVEMENT. LIMITS SHOWN ARE APPROXIMATE. REMOVE TO NEAREST JOINT.
- REMOVE EXISTING CONCRETE PLATFORM, INCLUDING LIGHT FIXTURE.

- REMOVE AND DISPOSE OF IRRIGATION EQUIPMENT. CAP LATERALS AND ABANDON IN PLACE.
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- REMOVE AND DISPOSE OF SIGN, INCLUDING FOOTING.
- REMOVE AND DISPOSE OF EXISTING STEEL RAILING.
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- REMOVE AND DISPOSE OF EXISTING PARKING BUMPER.
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- REMOVE AND DISPOSE OF EXISTING STEEL TRELLIS.
- REMOVE AND DISPOSE OF EXISTING CONCRETE RETAINING WALL, INCLUDING FOOTING.

- REMOVE PAVEMENT STRIPING.
- EXISTING PULLBOX TO REMAIN.
- EXISTING TELEPHONE PEDESTAL TO REMAIN.
- REMOVE AND DISPOSE OF CHAIN LINK FENCE.
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- EXISTING TURFGRASS TO REMAIN. CONTRACTOR SHALL PROTECT-IN-PLACE AND REPLACE ANY GRASS DAMAGED DURING CONSTRUCTION. SEE IRRIGATION PLANS.
- RESURFACE AND RESEAL EXISTING ASPHALT. SEE CONSTRUCTION PLANS.
- DEDUCTIVE ALTERNATE 1: EXISTING CONCRETE TO REMAIN.
- REMOVE AND DISPOSE OF EXISTING STEEL BOLLARD, INCLUDING FOOTING.

- REMOVE EXISTING MONUMENT SIGN, INCLUDING FOOTING. BACKFILL VOID LEFT BY REMOVAL OPERATIONS WITH CLEAN FILL. FILL MATERIAL TO BE APPROVED BY OWNER'S REPRESENTATIVE.
- REMOVE AND STOCKPILE EXISTING COMPACTOR FOR REINSTALLATION. STOCKPILE LOCATION TO BE APPROVED BY OWNER.
- REMOVE AND STOCKPILE EXISTING DUMPSTER. STOCKPILE LOCATION TO BE APPROVED BY OWNER.
- EXISTING GUARD RAIL TO REMAIN.

DEMOLITION HATCH LEGEND

- REMOVE EXISTING CONCRETE PAVEMENT. SEE KEYED NOTE 30.
- REMOVE EXISTING MULCH AND FABRIC. SEE KEYED NOTE 29.
- REMOVE EXISTING ASPHALT. SEE KEYED NOTE 55.
- RESURFACE EXISTING ASPHALT. SEE KEYED NOTE 62.
- REMOVE EXISTING CONCRETE STAIRS. SEE KEYED NOTE 34.
- REMOVE EXISTING RETAINING WALL. SEE KEYED NOTE 47.
- REMOVE EXISTING CONCRETE RAMP. SEE KEYED NOTE 53.
- EXISTING ASPHALT PAVEMENT TO REMAIN. SEE KEYED NOTE 15.
- EXISTING VEGETATION TO REMAIN. SEE KEYED NOTE 3.
- EXISTING CONCRETE WALK TO REMAIN. SEE KEYED NOTE 17.
- EXISTING CONCRETE RAMP TO REMAIN. SEE KEYED NOTE 18.
- EXISTING CONCRETE STAIRS TO REMAIN. SEE KEYED NOTE 19.
- EXISTING CONCRETE LANDING TO REMAIN. SEE KEYED NOTE 52.
- EXISTING TURFGRASS TO REMAIN. SEE KEYED NOTE 61.

DEMOLITION LINETYPE LEGEND

- LIMITS OF WORK.
- LIMITS OF PHASE 1 WORK.
- LIMITS OF DEDUCTIVE ALTERNATE 1. SEE KEYED NOTE 63.
- REMOVE PARKING LOT STRIPING. SEE KEYED NOTE 48.

DEMOLITION GENERAL NOTES

- ALL AREAS ADJACENT TO THE SITE SHALL BE MAINTAINED IN A CLEAN CONDITION - MUD, DUST, DEBRIS, AND GRAFFITI FREE AT ALL TIME.
- CONTRACTOR SHALL FILL AND COMPACT ALL VOIDS CREATED BY DEMOLITION WORK WITH CLEAN BACKFILL MATERIAL. BACKFILL SHALL BE COMPACTED TO 85% MODIFIED PROCTOR IN LANDSCAPE AREAS AND 95% IN PAVED AREAS.
- THE CONTRACTOR SHALL BE RESPONSIBLE FOR LOCATION VERIFICATION, SUPPORT, AND PROTECTION OF ALL ABOVEGROUND AND UNDERGROUND UTILITIES TO REMAIN IN PLACE INCLUDING ANY UTILITIES NOT INDICATED ON CONTRACT DRAWINGS. THE CONTRACTOR SHALL COORDINATE WITH THE PROPER LOCAL AUTHORITIES OR RESPECTIVE UTILITY COMPANIES TO LOCATE UNDERGROUND UTILITIES PRIOR TO COMMENCING THE DEMOLITION WORK. ANY DAMAGE TO EXISTING UTILITIES, INCLUDING THOSE NOT INDICATED ON THE CONTRACT DRAWINGS, RESULTING FROM CONSTRUCTION OPERATIONS SHALL BE REPAIRED AND/OR REPLACED AT NO ADDITIONAL COST TO THE OWNER.
- CONTRACTOR SHALL PRESERVE AND PROTECT EXISTING TREES DESIGNATED AS TO REMAIN FROM DAMAGE BY CONSTRUCTION OPERATIONS. ANY TREE DAMAGED BY CONSTRUCTION OPERATIONS SHALL BE REPLACED WITH A TREE OF THE SAME SPECIES AND SIZE. IF SIZE OF EXISTING TREE IS NOT AVAILABLE CONTRACTOR SHALL REPLACE WITH A 2" CAL. TREE (DECIDUOUS) OF 8' HT. TREE (EVERGREEN) AND SHALL PROVIDE A CREDIT TO THE OWNER FOR THE MONETARY DIFFERENCE IN VALUE. ANY SHRUB DAMAGED BY CONSTRUCTION OPERATIONS SHALL BE REPLACED BY A SHRUB OF THE SAME SPECIES AND SIZE. IF SIZE OF EXISTING SHRUB IS NOT AVAILABLE CONTRACTOR SHALL REPLACE WITH A 5-GAL SHRUB AND SHALL PROVIDE A CREDIT TO THE OWNER FOR THE MONETARY DIFFERENCE IN VALUE. SEE DETAIL A3LD-102.

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LANDSCAPE ARCHITECT

Park Square Plaza Renovation

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APRIL 2024


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| CHECKED BY: | WM |

SHEET TITLE
DEMOLITION PLAN

LD-105

4/25/2024 1:22 PM

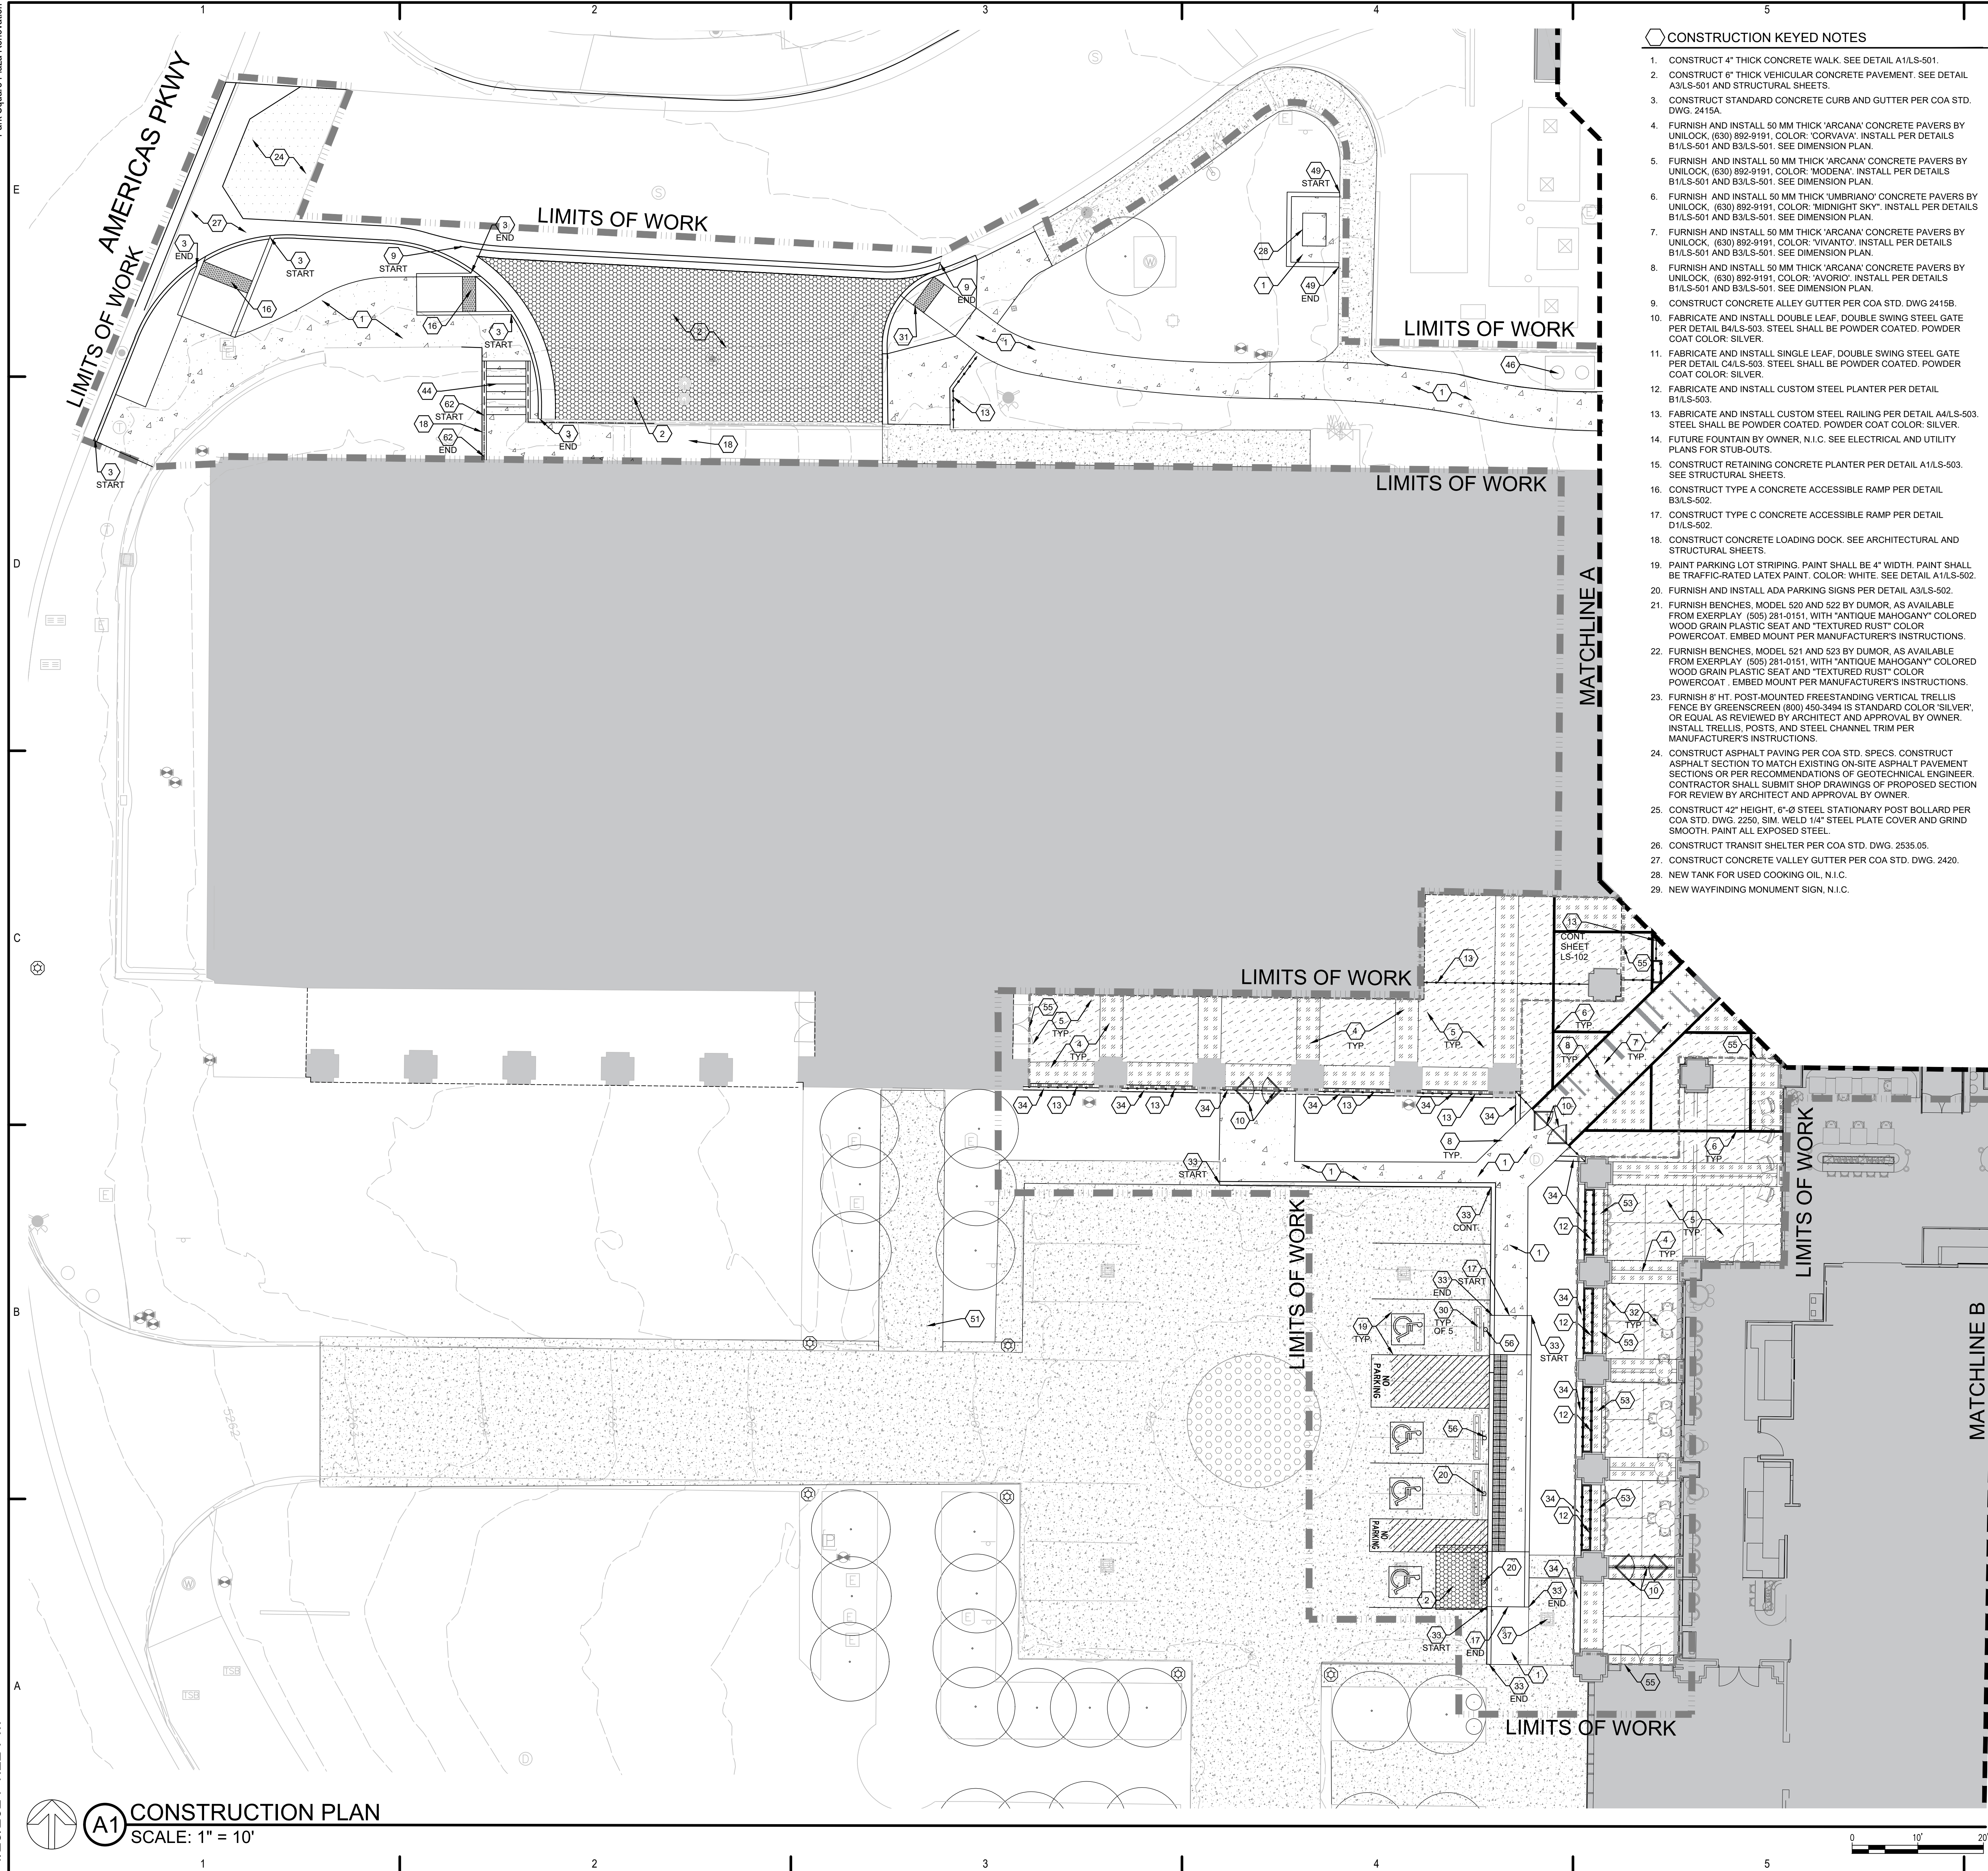

CONSTRUCTION KEYED NOTES

1. CONSTRUCT 4" THICK CONCRETE WALK. SEE DETAIL A1/LS-501.
2. CONSTRUCT 6" THICK VEHICULAR CONCRETE PAVEMENT. SEE DETAIL A3/LS-501 AND STRUCTURAL SHEETS.
3. CONSTRUCT STANDARD CONCRETE CURB AND GUTTER PER COA STD. DWG. 2415A.
4. FURNISH AND INSTALL 50 MM THICK 'ARCANA' CONCRETE PAVERS BY UNILOCK. (630) 892-9191, COLOR: 'CORVAYA'. INSTALL PER DETAILS B1/LS-501 AND B3/LS-501. SEE DIMENSION PLAN.
5. FURNISH AND INSTALL 50 MM THICK 'ARCANA' CONCRETE PAVERS BY UNILOCK. (630) 892-9191, COLOR: 'MODENA'. INSTALL PER DETAILS B1/LS-501 AND B3/LS-501. SEE DIMENSION PLAN.
6. FURNISH AND INSTALL 50 MM THICK 'UMBRIANO' CONCRETE PAVERS BY UNILOCK. (630) 892-9191, COLOR: 'MIDNIGHT SKY'. INSTALL PER DETAILS B1/LS-501 AND B3/LS-501. SEE DIMENSION PLAN.
7. FURNISH AND INSTALL 50 MM THICK 'ARCANA' CONCRETE PAVERS BY UNILOCK. (630) 892-9191, COLOR: 'VIVANTO'. INSTALL PER DETAILS B1/LS-501 AND B3/LS-501. SEE DIMENSION PLAN.
8. FURNISH AND INSTALL 50 MM THICK 'ARCANA' CONCRETE PAVERS BY UNILOCK. (630) 892-9191, COLOR: 'AVORIO'. INSTALL PER DETAILS B1/LS-501 AND B3/LS-501. SEE DIMENSION PLAN.
9. CONSTRUCT CONCRETE ALLEY GUTTER PER COA STD. DWG. 2415B.
10. FABRICATE AND INSTALL DOUBLE LEAF, DOUBLE SWING STEEL GATE PER DETAIL B4/LS-503. STEEL SHALL BE POWDER COATED. POWDER COAT COLOR: SILVER.
11. FABRICATE AND INSTALL SINGLE LEAF, DOUBLE SWING STEEL GATE PER DETAIL C4/LS-503. STEEL SHALL BE POWDER COATED. POWDER COAT COLOR: SILVER.
12. FABRICATE AND INSTALL CUSTOM STEEL PLANTER PER DETAIL B1/LS-503.
13. FABRICATE AND INSTALL CUSTOM STEEL RAILING PER DETAIL A4/LS-503. STEEL SHALL BE POWDER COATED. POWDER COAT COLOR: SILVER.
14. FUTURE FOUNTAIN BY OWNER, N.I.C. SEE ELECTRICAL AND UTILITY PLANS FOR STUB-OUTS.
15. CONSTRUCT RETAINING CONCRETE PLANTER PER DETAIL A1/LS-503. SEE STRUCTURAL SHEETS.
16. CONSTRUCT TYPE A CONCRETE ACCESSIBLE RAMP PER DETAIL B3/LS-502.
17. CONSTRUCT TYPE C CONCRETE ACCESSIBLE RAMP PER DETAIL D1/LS-502.
18. CONSTRUCT CONCRETE LOADING DOCK. SEE ARCHITECTURAL AND STRUCTURAL SHEETS.
19. PAINT PARKING LOT STRIPING. PAINT SHALL BE 4" WIDTH. PAINT SHALL BE TRAFFIC-RATED LATEX PAINT. COLOR: WHITE. SEE DETAIL A1/LS-502.
20. FURNISH AND INSTALL ADA PARKING SIGNS PER DETAIL A3/LS-502.
21. FURNISH BENCHES, MODEL 520 AND 522 BY DUMOR, AS AVAILABLE FROM EXERPLAY (505) 281-0151, WITH "ANTIQUE MAHOGANY" COLORED WOOD GRAIN PLASTIC SEAT AND "TEXTURED RUST" COLOR POWDERCOAT. EMBED MOUNT PER MANUFACTURER'S INSTRUCTIONS.
22. FURNISH BENCHES, MODEL 521 AND 523 BY DUMOR, AS AVAILABLE FROM EXERPLAY (505) 281-0151, WITH "ANTIQUE MAHOGANY" COLORED WOOD GRAIN PLASTIC SEAT AND "TEXTURED RUST" COLOR POWDERCOAT. EMBED MOUNT PER MANUFACTURER'S INSTRUCTIONS.
23. FURNISH 8' HT. POST-MOUNTED FREESTANDING VERTICAL TRELLIS FENCE BY GREENSCREEN (800) 450-3494 IS STANDARD COLOR 'SILVER', OR EQUAL AS REVIEWED BY ARCHITECT AND APPROVAL BY OWNER. INSTALL TRELLIS, POSTS, AND STEEL CHANNEL TRIM PER MANUFACTURER'S INSTRUCTIONS.
24. CONSTRUCT ASPHALT PAVING PER COA STD. SPECS. CONSTRUCT ASPHALT SECTION TO MATCH EXISTING ON-SITE ASPHALT PAVEMENT SECTIONS OR PER RECOMMENDATIONS OF GEOTECHNICAL ENGINEER. CONTRACTOR SHALL SUBMIT SHOP DRAWINGS OF PROPOSED SECTION FOR REVIEW BY ARCHITECT AND APPROVAL BY OWNER.
25. CONSTRUCT 42" HEIGHT, 6"-Ø STEEL STATIONARY POST BOLLARD PER COA STD. DWG. 2250, SIM. WELD 1/4" STEEL PLATE COVER AND GRIND SMOOTH PAINT ALL EXPOSED STEEL.
26. CONSTRUCT TRANSIT SHELTER PER COA STD. DWG. 2535.05.
27. CONSTRUCT CONCRETE VALLEY GUTTER PER COA STD. DWG. 2420.
28. NEW TANK FOR USED COOKING OIL, N.I.C.
29. NEW WAYFINDING MONUMENT SIGN, N.I.C.
30. FURNISH AND INSTALL CONCRETE PARKING BUMPER. SEE DETAIL B1/LS-502.
31. CONSTRUCT CORNER ACCESS RAMP PER COA STD. DWG. 2442A.
32. PLAZA FURNITURE, N.I.C.
33. CONSTRUCT 8" CONCRETE HEADER CURB PER DETAIL A5/LS-501.
34. CONSTRUCT 12" CONCRETE HEADER CURB AT COLONNADE PER DETAIL A5/LS-501, SIM.
35. FURNISH AND INSTALL 3 7/8 x 7 7/8 x 2 3/4" VEHICULAR CONCRETE PAVERS. PAVERS SHALL BE 'UMBRIANO' BY UNILOCK. (630) 892-9191, COLOR: 'TRENCH GRAY'. INSTALL PER COA STD. DWG. 2412.
36. FURNISH AND INSTALL 3 7/8 x 7 7/8 x 2 3/4" VEHICULAR CONCRETE PAVERS. PAVERS SHALL BE 'UMBRIANO' BY UNILOCK. (630) 892-9191, COLOR: 'WINTER MARVEL'. INSTALL PER COA STD. DWG. 2412.
37. FURNISH 8" SQUARE 'RAIN' PATTERN CATCH BASIN GRATE BY IRON AGE DESIGNS (877) 418-3568. INSTALL IN EXISTING CATCH BASIN.
38. FURNISH 12" SQUARE 'RAIN' PATTERN CATCH BASIN GRATE BY IRON AGE DESIGNS (877) 418-3568. INSTALL IN EXISTING CATCH BASIN. SEE CIVIL.
39. FURNISH 12" SQUARE 'RAIN' PATTERN CATCH BASIN GRATE BY IRON AGE DESIGNS (877) 418-3568. INSTALL IN EXISTING CATCH BASIN. SEE CIVIL.
40. FURNISH 24" SQUARE 'RAIN' PATTERN CATCH BASIN GRATE BY IRON AGE DESIGNS (877) 418-3568. INSTALL IN EXISTING CATCH BASIN. SEE CIVIL.
41. FURNISH 24" SQUARE 'RAIN' PATTERN CATCH BASIN GRATE BY IRON AGE DESIGNS (877) 418-3568. INSTALL IN IRON AGE CUSTOM FRAME PER MANUFACTURER'S INSTRUCTIONS. SEE CIVIL.
42. FURNISH 8" x 20" 'RAIN' PATTERN TRENCH GRATE BY IRON AGE DESIGNS (877) 418-3568. INSTALL IN NDS 8" PRO SERIES CHANNEL DRAIN. SEE CIVIL.
43. CONSTRUCT CMU DUMPSTER ENCLOSURE PER DETAIL D3/LS-502.
44. CONSTRUCT CONCRETE STEPS WITH HAND RAIL. SEE DETAIL D1/LS-501.
45. CONSTRUCT MOUNTABLE CURB PER COA STD. DWG. 2415B.
46. INTERCEPTOR AND CLEANOUTS. SEE SITE UTILITY PLANS.
47. CONSTRUCT 7 HT. STEEL BARRIER AND DOOR WITH PANIC HARDWARE. SEE ARCHITECTURAL PLANS.
48. CONSTRUCT STEEL ARBOR. SEE ARCHITECTURAL PLANS.
49. CONSTRUCT SITE MASONRY WALL PER DETAIL D5/LS-502.
50. CONSTRUCT STEEL RAILING AT NARROW OPENING PER DETAIL C1/LS-503.
51. CONSTRUCT NON-ACCESSIBLE RAMP PER DETAIL E4/LS-503.
52. RESURFACE AND SEAL ASPHALT PAVING PER COA STD. SPECS. CONTRACTOR SHALL SUBMIT SHOP DRAWINGS OF PROPOSED AREAS TO BE RESURFACED AND RESEALED FOR REVIEW BY ARCHITECT AND APPROVAL BY OWNER.
53. FURNISH AND INSTALL BAR HEIGHT TABLE, MODEL # UL5-110X17X42-3M4PF, IN POWDER COAT COLOR 'SILVER' AS AVAILABLE FROM SITESCAPES, (888) 331-9464, OR EQUAL APPROVED BY OWNER.
54. PLAZA PLANTER POT, N.I.C. SEE LIGHTING AND ELECTRICAL PLANS FOR LANDSCAPE LIGHTING. CONTRACTOR SHALL SUBMIT SHOP DRAWINGS OF PROPOSED WIRE ROUTING AND DRIVER INSTALLATION FOR ARCHITECT REVIEW AND OWNER APPROVAL. SEE PLANTING PLANS.
55. DEDUCTIVE ALTERNATE 1: OMIT PAVERS AT COVERED ARCADE. EXISTING CONCRETE TO REMAIN.
56. FURNISH AND INSTALL VAN-ACCESSIBLE ADA PARKING SIGNS PER DETAIL A3/LS-502.
57. DRAIN. SEE CIVIL.
58. CONSTRUCT CONCRETE-FILLED STEEL BOLLARD PER DETAIL B2/LS-502.
59. PAINT CROSSWALK STRIPING WITH TRAFFIC RATED PAINT.
60. CONSTRUCT CONCRETE MOWSTRIP PER CABO STD. DWG. 2726.
61. FURNISH AND INSTALL MOTORCYCLE PARKING SPACE SIGN. SEE DETAIL B5/LS-502.
62. CONSTRUCT GUARD RAIL. SEE DETAIL D5/LS-501.

CONSTRUCTION GENERAL NOTES

- A. CONTRACTOR SHALL PRESERVE AND PROTECT EXISTING WALKWAYS, STRUCTURES, AND UTILITIES TO REMAIN. THE CONTRACTOR SHALL BE RESPONSIBLE TO LOCATE AND SECURE ALL ABOVEGROUND AND UNDERGROUND UTILITIES. INSTALL, AND MAINTAIN ALL NECESSARY PROTECTION MEASURES. ANY DAMAGE TO EXISTING WALKWAYS, STRUCTURES, TREES, AND UTILITIES, EVEN THOSE NOT INDICATED ON THE CONTRACT RESULTING FROM CONSTRUCTION OPERATIONS SHALL BE REPAIRED AND/OR REPLACED AT NO ADDITIONAL COST TO THE OWNER.
- B. ALL AREAS ADJACENT TO THE SITE SHALL BE MAINTAINED IN A CLEAN CONDITION, MUD AND DUST FREE AT ALL TIMES.
- C. WHERE NEW CONCRETE PAVEMENT IS SHOWN ADJACENT TO EXISTING, CONTRACTOR SHALL PROVIDE NEW CONCRETE UP TO AND FLUSH WITH EXISTING EXPANSION JOINT. LIMITS SHOWN ARE APPROXIMATE. CONTRACTOR SHALL FIELD VERIFY.
- D. CONTRACTOR SHALL RESET LIDS/BOXES OF ANY EXISTING UTILITY TO REMAIN AS NEEDED SO THAT TOP OF LID IS FLUSH WITH TOP OF ADJACENT SURFACE.


CONSTRUCTION HATCH LEGEND

- 4" THICK CONCRETE PAVEMENT. SEE KEYED NOTE 1.
- 6" THICK CONCRETE PAVEMENT. SEE KEYED NOTE 2.
- CONCRETE PAVERS. SEE KEYED NOTE 4.
- CONCRETE PAVERS. SEE KEYED NOTE 5.
- CONCRETE PAVERS. SEE KEYED NOTE 6.
- CONCRETE PAVERS. SEE KEYED NOTE 7.
- CONCRETE PAVERS. SEE KEYED NOTE 8.
- ASPHALT PAVEMENT. SEE KEYED NOTE 24.
- VEHICULAR CONCRETE PAVERS. SEE KEYED NOTE 35.
- VEHICULAR CONCRETE PAVERS. SEE KEYED NOTE 36.
- RESURFACE AND RESEAL ASPHALT. SEE KEYED NOTE 52.

CONSTRUCTION LINETYPE LEGEND

- STEEL ENCLOSURE RAILING, KEYED NOTE 13.
- STEEL HAND RAIL.
- GUARD RAIL. SEE KEYED NOTE 62.
- TRELLIS. SEE KEYED NOTE 23.
- LIMITS OF DEDUCTIVE ALTERNATE 1. SEE KEYED NOTE 55.
- LIMITS OF WORK.
- LIMITS OF PHASE 1 WORK.

KEY MAP

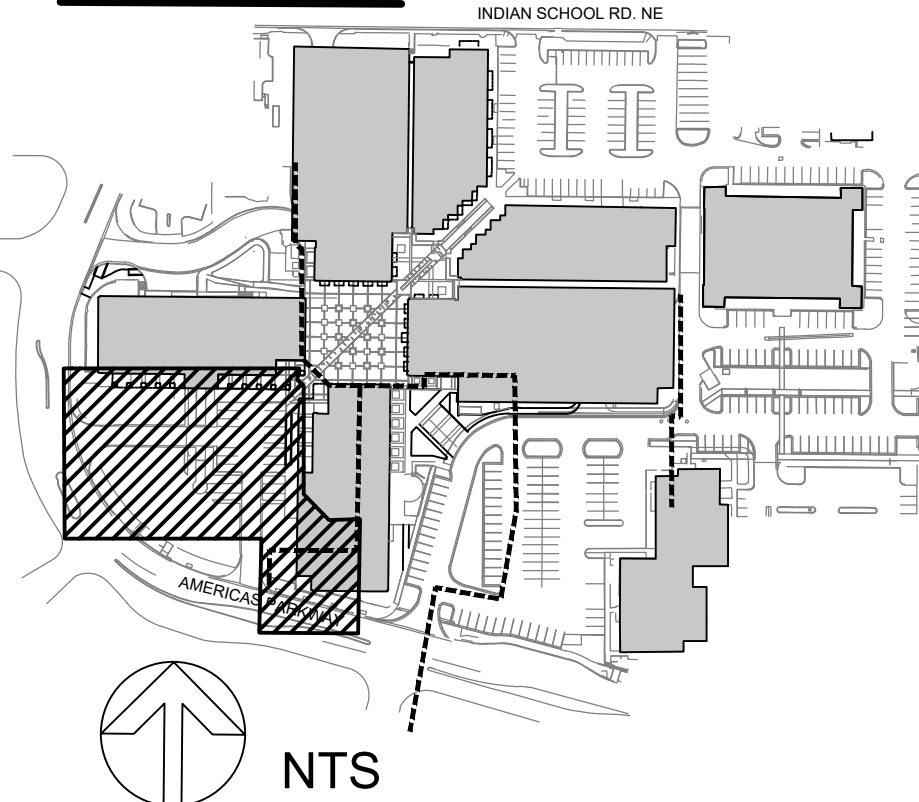

fbt architects

6501 Americas Pkwy NE, Ste. 300
Albuquerque, NM 87110
P 505.883.5200 WEB: www.fbtarch.com

CONSULTANTS

LANDSCAPE ARCHITECT

Groundwork Studio
6501 Americas Pkwy NE, Ste. 350
Albuquerque, NM 87110
p. 505.212.9126

CIVIL ENGINEER

NVS
6501 Americas Pkwy NE, Ste. 400
Albuquerque, NM 87110
p. 505.830.8753

LIGHTING

AE Design

1900 Wazee Street #205
Denver, CO 80202
p. 303.296.3034



LANDSCAPE ARCHITECT

Park Square Plaza Renovation

6565 AMERICAS PKWY
ALBUQUERQUE, NM 87110

APRIL 2024

MARK DATE DESCRIPTION


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DATE: APRIL 22, 2024
PROJECT NO:
DRAWN BY: TW/WM
CHECKED BY: WM

SHEET TITLE

CONSTRUCTION PLAN

LS-101

Park Square Plaza Renovation

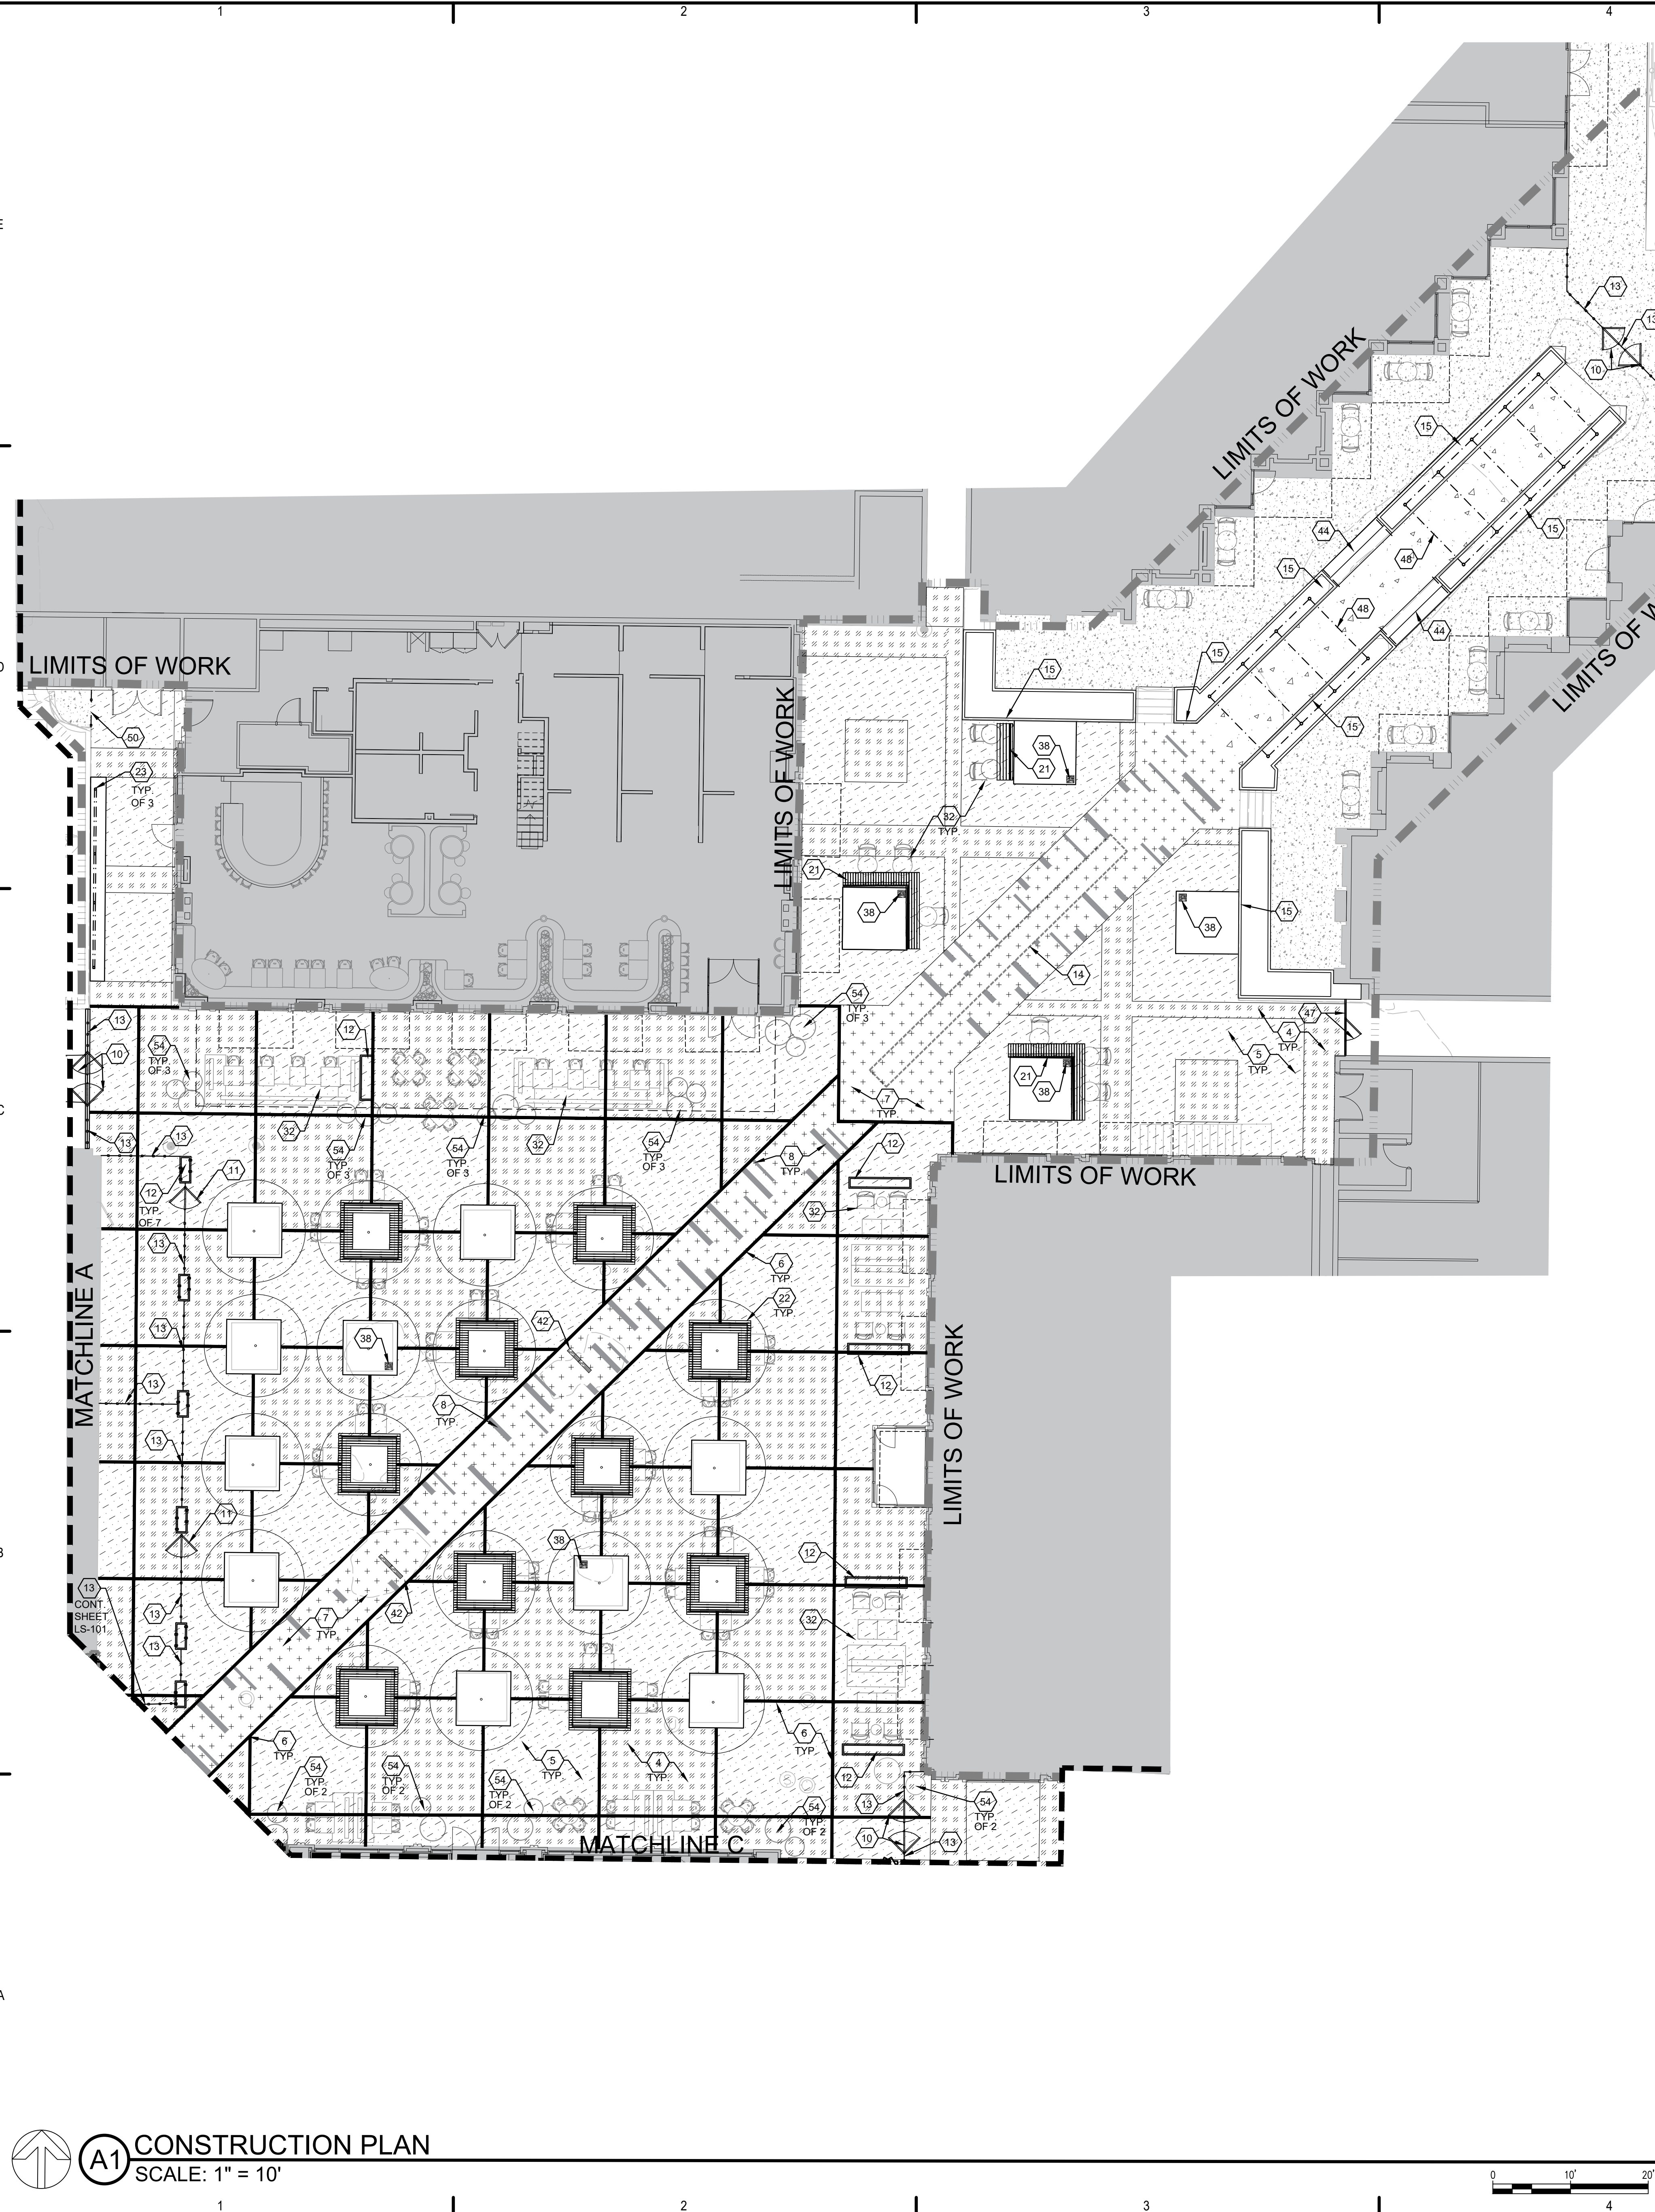

CONSULTANTS

LANDSCAPE ARCHITECT

Groundwork Studio
6501 Americas Pkwy NE, Ste. 350
Albuquerque, NM 87110
p_505.212.9126

CIVIL ENGINEER

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LIGHTING

AE Design
1900 Wazee Street #205
Denver, CO 80202
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LANDSCAPE ARCHITECT

Park Square Plaza
Renovation6565 AMERICAS PKWY
ALBUQUERQUE, NM 87110

APRIL 2024

MARK DATE DESCRIPTION

ISSUE: CONSTRUCTION DOCUMENTS
DATE: APRIL 22, 2024
PROJECT NO:
DRAWN BY: TW/WM
CHECKED BY: WM

SHEET TITLE

CONSTRUCTION PLAN

LS-102

CONSTRUCTION HATCH LEGEND

| | |
|--|--|
| | 4\"/> |
| | 6\"/> |
| | CONCRETE PAVERS. SEE KEYED NOTE 4. |
| | CONCRETE PAVERS. SEE KEYED NOTE 5. |
| | CONCRETE PAVERS. SEE KEYED NOTE 6. |
| | CONCRETE PAVERS. SEE KEYED NOTE 7. |
| | CONCRETE PAVERS. SEE KEYED NOTE 8. |
| | ASPHALT PAVEMENT. SEE KEYED NOTE 24. |
| | VEHICULAR CONCRETE PAVERS. SEE KEYED NOTE 35. |
| | VEHICULAR CONCRETE PAVERS. SEE KEYED NOTE 36. |
| | RESURFACE AND RESEAL ASPHALT. SEE KEYED NOTE 52. |

CONSTRUCTION LINETYPE LEGEND

| | |
|--|---|
| | STEEL ENCLOSURE RAILING, KEYED NOTE 13. |
| | STEEL HAND RAIL. |
| | GUARD RAIL. SEE KEYED NOTE 62. |
| | TRELLIS. SEE KEYED NOTE 23. |
| | LIMITS OF DEDUCTIVE ALTERNATE 1. SEE KEYED NOTE 55. |
| | LIMITS OF WORK. |
| | LIMITS OF PHASE 1 WORK. |



CONSTRUCTION KEYED NOTES

- CONSTRUCT 4\"/>
- CONSTRUCT 6\"/>
- CONSTRUCT STANDARD CONCRETE CURB AND GUTTER PER COA STD. DWG. 2415A.
- FURNISH AND INSTALL 50 MM THICK 'ARCA' CONCRETE PAVERS BY UNILOCK, (630) 892-9191, COLOR: 'CORVAIA'. INSTALL PER DETAILS B1/L.S-501 AND B3/L.S-501. SEE DIMENSION PLAN.
- FURNISH AND INSTALL 50 MM THICK 'ARCA' CONCRETE PAVERS BY UNILOCK, (630) 892-9191, COLOR: 'MODENA'. INSTALL PER DETAILS B1/L.S-501 AND B3/L.S-501. SEE DIMENSION PLAN.
- FURNISH AND INSTALL 50 MM THICK 'UMBRIANO' CONCRETE PAVERS BY UNILOCK, (630) 892-9191, COLOR: 'MIDNIGHT SKY'. INSTALL PER DETAILS B1/L.S-501 AND B3/L.S-501. SEE DIMENSION PLAN.
- FURNISH AND INSTALL 50 MM THICK 'ARCA' CONCRETE PAVERS BY UNILOCK, (630) 892-9191, COLOR: 'VIVANTO'. INSTALL PER DETAILS B1/L.S-501 AND B3/L.S-501. SEE DIMENSION PLAN.
- FURNISH AND INSTALL 50 MM THICK 'ARCA' CONCRETE PAVERS BY UNILOCK, (630) 892-9191, COLOR: 'AVORIO'. INSTALL PER DETAILS B1/L.S-501 AND B3/L.S-501. SEE DIMENSION PLAN.
- CONSTRUCT CONCRETE ALLEY GUTTER PER COA STD. DWG. 2415B.
- FABRICATE AND INSTALL DOUBLE LEAF, DOUBLE SWING STEEL GATE PER DETAIL B4/L.S-503. STEEL SHALL BE POWDER COATED. POWDER COAT COLOR: SILVER.
- FABRICATE AND INSTALL SINGLE LEAF, DOUBLE SWING STEEL GATE PER DETAIL B4/L.S-503. STEEL SHALL BE POWDER COATED. POWDER COAT COLOR: SILVER.
- FABRICATE AND INSTALL CUSTOM STEEL PLANTER PER DETAIL B1/L.S-503.
- FABRICATE AND INSTALL CUSTOM STEEL RAILING PER DETAIL A4/L.S-503. STEEL SHALL BE POWDER COATED. POWDER COAT COLOR: SILVER.
- FUTURE FOUNTAIN BY OWNER, N.I.C. SEE ELECTRICAL AND UTILITY PLANS FOR STUB-OUTS.
- CONSTRUCT RETAINING CONCRETE PLANTER PER DETAIL A1/L.S-503. SEE STRUCTURAL SHEETS.
- CONSTRUCT TYPE C CONCRETE ACCESSIBLE RAMP PER DETAIL D1/L.S-502.
- CONSTRUCT CONCRETE LOADING DOCK. SEE ARCHITECTURAL AND STRUCTURAL SHEETS.
- PAINT PARKING LOT STRIPING. PAINT SHALL BE 4\"/>
- FURNISH AND INSTALL ADA PARKING SIGNS PER DETAIL A3/L.S-502.
- FURNISH BENCHES, MODEL 520 AND 522 BY DUMOR, AS AVAILABLE FROM EXERPLAY, (505) 281-0151, WITH 'ANTIQUE MAHOGANY' COLORED WOOD GRAIN PLASTIC SEAT AND 'TEXTURED RUST' COLOR POWDERCOAT. EMBED MOUNT PER MANUFACTURER'S INSTRUCTIONS.
- FURNISH BENCHES, MODEL 521 AND 523 BY DUMOR, AS AVAILABLE FROM EXERPLAY, (505) 281-0151, WITH 'ANTIQUE MAHOGANY' COLORED WOOD GRAIN PLASTIC SEAT AND 'TEXTURED RUST' COLOR POWDERCOAT. EMBED MOUNT PER MANUFACTURER'S INSTRUCTIONS.
- FURNISH 8\"/>
- CONSTRUCT ASPHALT PAVING PER COA STD. SPECS. CONSTRUCT ASPHALT SECTION TO MATCH EXISTING ON-SITE ASPHALT PAVEMENT SECTIONS OR PER RECOMMENDATIONS OF GEOTECHNICAL ENGINEER. CONTRACTOR SHALL SUBMIT SHOP DRAWINGS OF PROPOSED SECTION FOR REVIEW BY ARCHITECT AND APPROVAL BY OWNER.
- CONSTRUCT 42\"/>
- CONSTRUCT TRANSIT SHELTER PER COA STD. DWG. 2535.05.
- CONSTRUCT CONCRETE VALLEY GUTTER PER COA STD. DWG. 2420.
- NEW TANK FOR USED COOKING OIL, N.I.C.
- NEW WAYFINDING MONUMENT SIGN, N.I.C.
- FURNISH AND INSTALL CONCRETE PARKING BUMPER. SEE DETAIL B1/L.S-502.
- CONSTRUCT CORNER ACCESS RAMP PER COA STD. DWG. 2442A.
- PLAZA FURNITURE, N.I.C.
- CONSTRUCT 8\"/>
- CONSTRUCT 12\"/>
- FURNISH AND INSTALL 3 7/8 x 7 7/8 x 2 3/4\"/>
- FURNISH AND INSTALL 3 7/8 x 7 7/8 x 2 3/4\"/>
- FURNISH 8\"/>
- FURNISH 12\"/>
- FURNISH 12\"/>
- FURNISH 24\"/>
- FURNISH 24\"/>
- FURNISH 8\"/>
- CONSTRUCT CMU DUMPSTER ENCLOSURE PER DETAIL D3/L.S-502.
- CONSTRUCT CONCRETE STEPS WITH HAND RAIL. SEE DETAIL D1/L.S-501.
- CONSTRUCT MOUNTABLE CURB PER COA STD. DWG. 2415B.
- INTERCEPTOR AND CLEANOUTS. SEE SITE UTILITY PLANS.
- CONSTRUCT 7\"/>
- CONSTRUCT STEEL ARBOR, SEE ARCHITECTURAL PLANS.
- CONSTRUCT SITE MASONRY WALL PER DETAIL D5/L.S-502.
- CONSTRUCT STEEL RAILING AT NARROW OPENING PER DETAIL C1/L.S-503.
- CONSTRUCT NON-ACCESSIBLE RAMP PER DETAIL E4/L.S-503.
- RESURFACE AND SEAL ASPHALT PAVING PER COA STD. SPECS. CONTRACTOR SHALL SUBMIT SHOP DRAWINGS OF PROPOSED AREAS TO BE RESURFACED AND RESEALED FOR REVIEW BY ARCHITECT AND APPROVAL BY OWNER.
- FURNISH AND INSTALL BAR HEIGHT TABLE, MODEL # UL6-119X17X42-SM-PF, IN POWDER COAT COLOR 'SILVER' AS AVAILABLE FROM SITESCAPES, (888) 331-9464, OR EQUAL APPROVED BY OWNER.
- PLAZA PLANTER POT, N.I.C. SEE LIGHTING AND ELECTRICAL PLANS FOR LANDSCAPE LIGHTING. CONTRACTOR SHALL SUBMIT SHOP DRAWINGS OF PROPOSED WIRE ROUTING AND DRIVER INSTALLATION FOR ARCHITECT REVIEW AND DRIVER APPROVAL. SEE PLANTING PLANS.
- DEDUCTIVE ALTERNATE 1: OMIT PAVERS AT COVERED ARCADE. EXISTING CONCRETE TO REMAIN.
- FURNISH AND INSTALL VAN-ACCESSIBLE ADA PARKING SIGNS PER DETAIL A3/L.S-502.
- DRAIN. SEE CIVIL.
- CONSTRUCT CONCRETE-FILLED STEEL BOLLARD PER DETAIL B2/L.S-502.
- PAINT CROSSWALK STRIPING WITH TRAFFIC RATED PAINT.
- CONSTRUCT CONCRETE MOWSTRIP PER CABQ STD. DWG. 2726.
- FURNISH AND INSTALL MOTORCYCLE PARKING SPACE SIGN. SEE DETAIL B5/L.S-502.
- CONSTRUCT GUARD RAIL. SEE DETAIL D5/L.S-501.


CONSTRUCTION GENERAL NOTES

- CONTRACTOR SHALL PRESERVE AND PROTECT EXISTING WALKWAYS, STRUCTURES, AND UTILITIES TO REMAIN. THE CONTRACTOR SHALL BE RESPONSIBLE TO LOCATE AND SECURE ALL ABOVEGROUND AND UNDERGROUND UTILITIES, INSTALL AND MAINTAIN ALL NECESSARY PROTECTION MEASURES, ANY DAMAGE TO EXISTING WALKWAYS, STRUCTURES, TREES, AND UTILITIES, EVEN THOSE NOT INDICATED ON THE CONTRACT RESULTING FROM CONSTRUCTION OPERATIONS SHALL BE REPAIRED AND/OR REPLACED AT NO ADDITIONAL COST TO THE OWNER.
- ALL AREAS ADJACENT TO THE SITE SHALL BE MAINTAINED IN A CLEAN CONDITION, MUD AND DUST FREE AT ALL TIMES.
- WHERE NEW CONCRETE PAVEMENT IS SHOWN ADJACENT TO EXISTING, CONTRACTOR SHALL PROVIDE NEW CONCRETE UP TO AND FLUSH WITH EXISTING EXPANSION JOINT. LIMITS SHOWN ARE APPROXIMATE. CONTRACTOR SHALL FIELD VERIFY.
- CONTRACTOR SHALL RESET LIDS/BOXES OF ANY EXISTING UTILITY TO REMAIN AS NEEDED SO THAT TOP OF LID IS FLUSH WITH TOP OF ADJACENT SURFACE.

KEY MAP

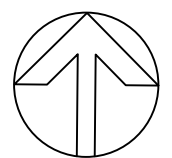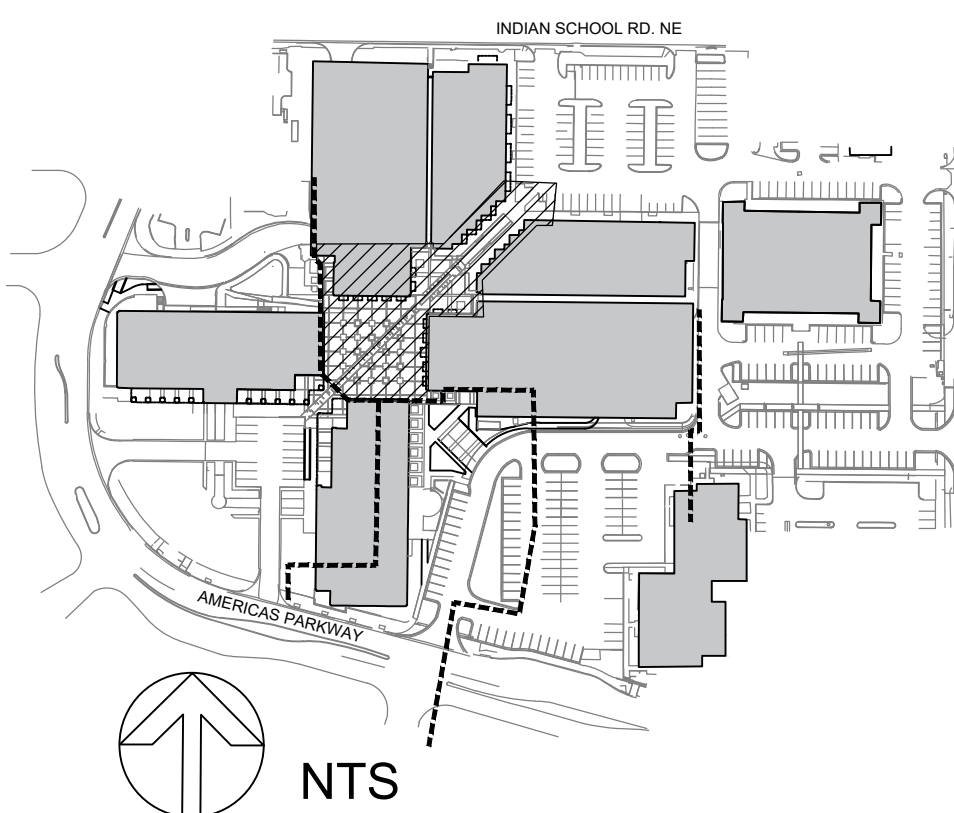




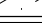
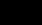


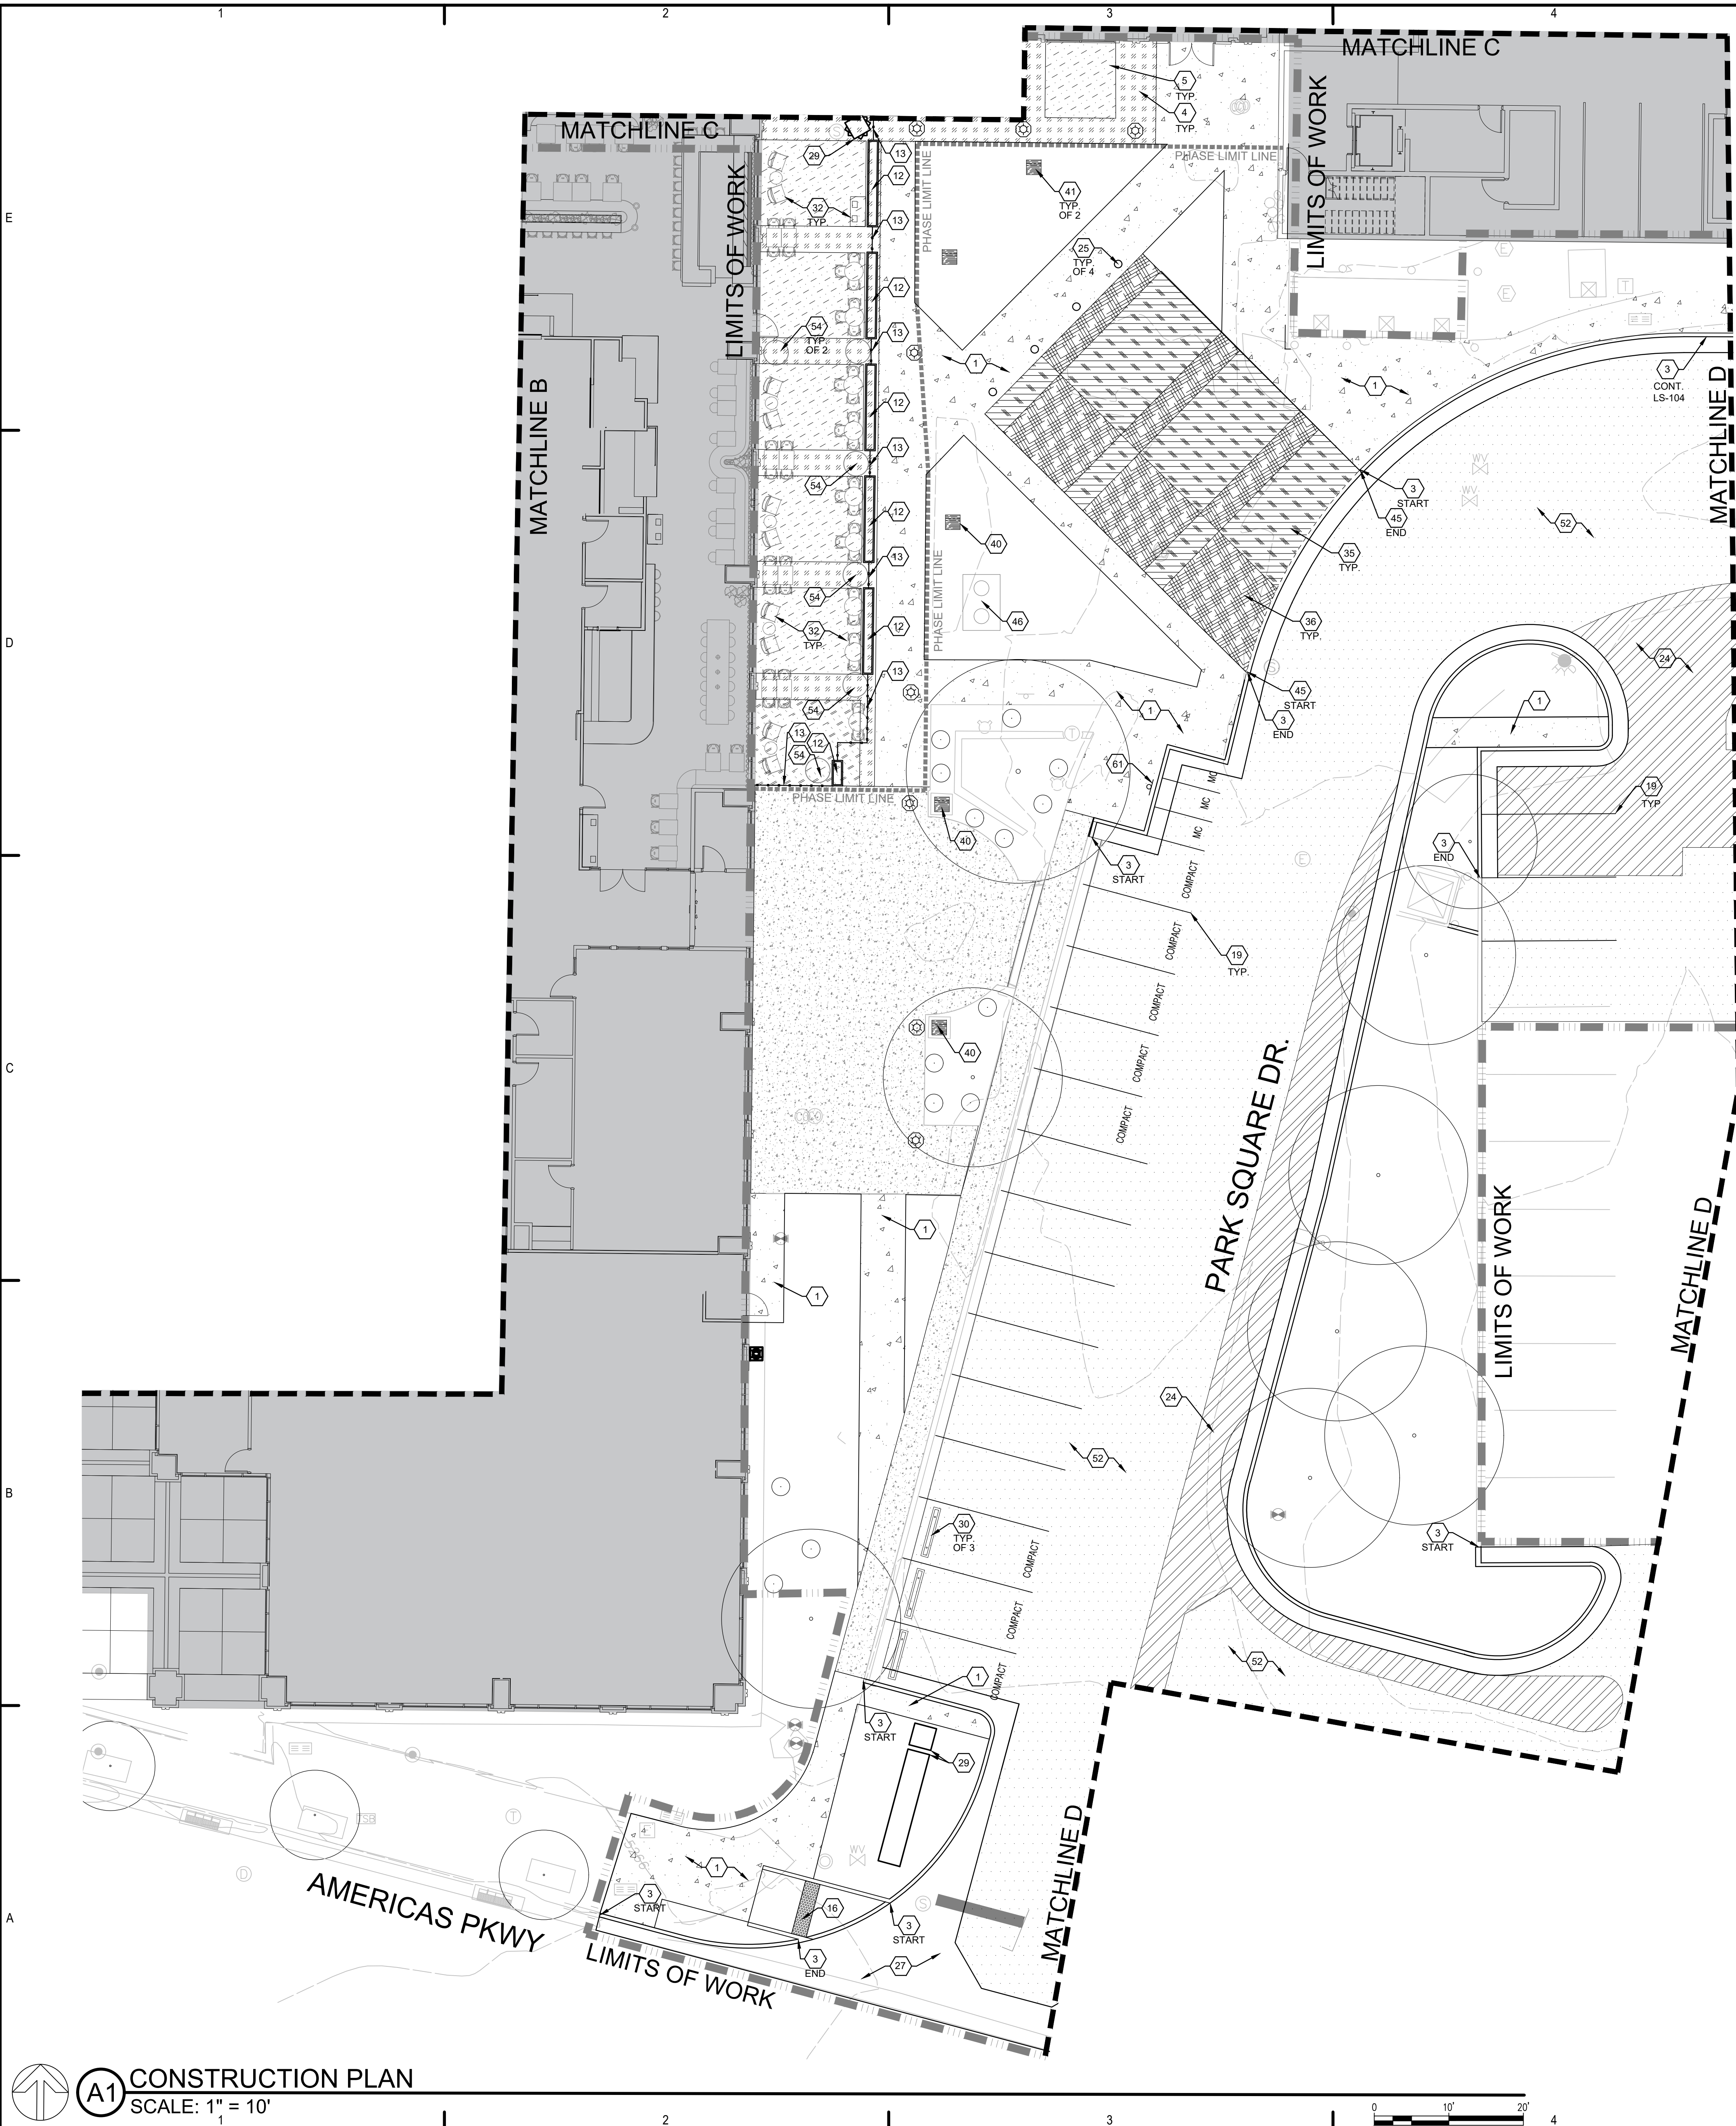

A1 CONSTRUCTION PLAN
SCALE: 1" = 10'




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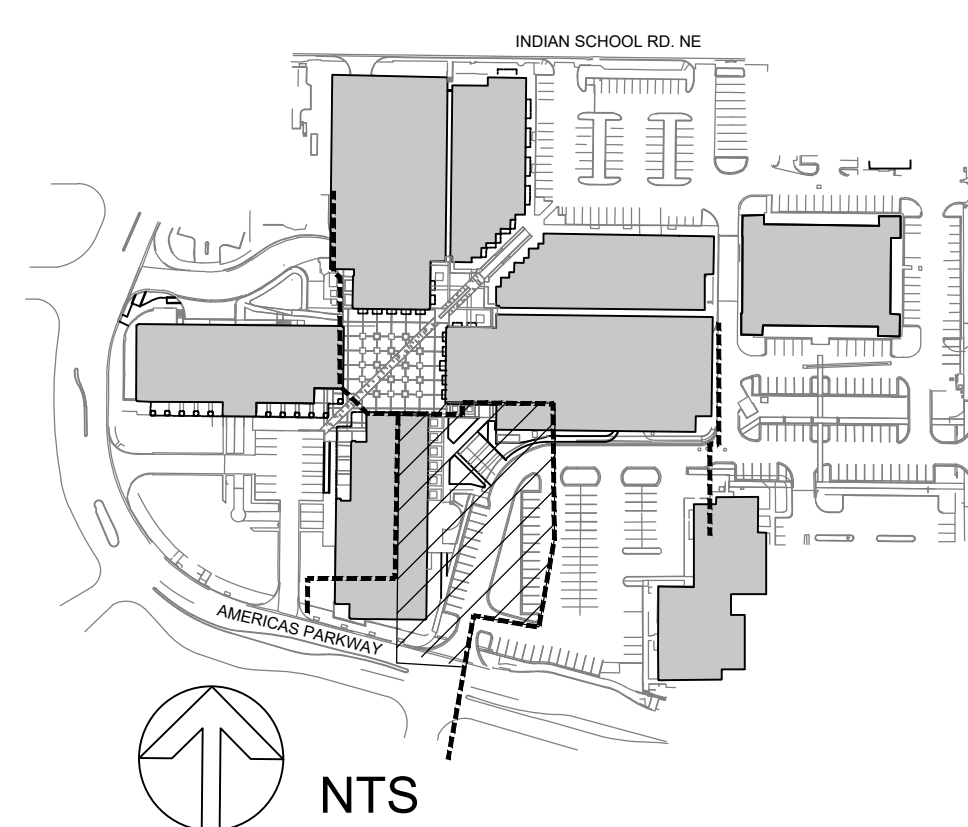


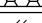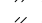1. CONSTRUCT 4" THICK CONCRETE WALK. SEE DETAIL A1/L5-501.
 2. CONSTRUCT 6" THICK VEHICULAR CONCRETE PAVEMENT. SEE DETAIL A3/L5-501 AND STRUCTURAL SHEETS.
 3. CONSTRUCT STANDARD CONCRETE CURB AND GUTTER PER COA STD. DWG. 2415A.
 4. FURNISH AND INSTALL 50 MM THICK 'ARCANIA' CONCRETE PAVERS BY UNILOCK. (630) 892-9191. COLOR: 'CORVAYA'. INSTALL PER DETAILS B1/L5-501 AND B3/L5-501. SEE DIMENSION PLAN.
 5. FURNISH AND INSTALL 50 MM THICK 'ARCANIA' CONCRETE PAVERS BY UNILOCK. (630) 892-9191. COLOR: 'MODENA'. INSTALL PER DETAILS B1/L5-501 AND B3/L5-501. SEE DIMENSION PLAN.
 6. FURNISH AND INSTALL 50 MM THICK 'UMBRIANO' CONCRETE PAVERS BY UNILOCK. (630) 892-9191. COLOR: 'MIDNIGHT SKY'. INSTALL PER DETAILS B1/L5-501 AND B3/L5-501. SEE DIMENSION PLAN.
 7. FURNISH AND INSTALL 'RANKA' CONCRETE PAVERS BY UNILOCK. (630) 892-9191. COLOR: 'VIVANTO'. INSTALL PER DETAILS B1/L5-501 AND B3/L5-501. SEE DIMENSION PLAN.
 8. FURNISH AND INSTALL 50 MM THICK CONCRETE PAVERS BY UNILOCK. (630) 892-9191. COLOR: 'NORIO'. INSTALL PER DETAILS B1/L5-501 AND B3/L5-501. SEE DIMENSION PLAN.
 9. CONSTRUCT CONCRETE ALLIGER GUTTER PER COA STD. DWG. 2415B.
 10. FABRICATE AND INSTALL DOUBLE LEAF, DOUBLE SWING STEEL GATE PER DETAIL B4/L5-503. STEEL SHALL BE POWDER COATED. POWDER COAT COLOR: SILVER.
 11. FABRICATE AND INSTALL SINGLE LEAF, DOUBLE SWING STEEL GATE PER DETAIL C4/L5-503. STEEL SHALL BE POWDER COATED. POWDER COAT COLOR: SILVER.
 12. FABRICATE AND INSTALL CUSTOM STEEL PLANTER PER DETAIL B1/L5-503.
 13. FABRICATE AND INSTALL CUSTOM STEEL RAILING PER DETAIL A4/L5-503. STEEL SHALL BE POWDER COATED. POWDER COAT COLOR: SILVER.
 14. FUTURE FOUNTAIN BY OWNER, N.I.C. SEE ELECTRICAL AND UTILITY PLANS FOR STUB-OUTS.
 15. CONSTRUCT RETAINING CONCRETE PLANTER PER DETAIL A1/L5-503. SEE STRUCTURAL SHEETS.
 16. CONSTRUCT TYPE A CONCRETE ACCESSIBLE RAMP PER DETAIL B3/L5-502.
 17. CONSTRUCT TYPE C CONCRETE ACCESSIBLE RAMP PER DETAIL D1/L5-502.
 18. CONSTRUCT CONCRETE LOADING DOCK. SEE ARCHITECTURAL AND STRUCTURAL SHEETS.
 19. PAINT PARKING LOT STRIPING. PAINT SHALL BE 4" WIDTH. PAINT SHALL BE TRAFFIC-RATED LATEX PAINT. COLOR: WHITE. SEE DETAIL A1/L5-502.
 20. FURNISH AND INSTALL ADA PARKING SIGNS PER DETAIL A3/L5-502.
 21. FURNISH BENCHES, MODEL 520 AND 522 BY DUMOR, AS AVAILABLE FROM EXERPLY. (503) 281-0151. WITH 'ANTIQUE MAHOAGNY' COLORED WOOD GRAIN PLATING AND 'TEXTURED RUST' COLOR. POWERCOAT. EMBED MOUNT PER MANUFACTURER'S INSTRUCTIONS.
 22. FURNISH BENCHES, MODEL 521 AND 523 BY DUMOR, AS AVAILABLE FROM EXERPLY. (503) 281-0151. WITH 'ANTIQUE MAHOAGNY' COLORED WOOD GRAIN PLATING AND 'TEXTURED RUST' COLOR. POWERCOAT. EMBED MOUNT PER MANUFACTURER'S INSTRUCTIONS.
 23. FURNISH 8" HT. POST-MOUNTED FREESTANDING VERTICAL TRELLIS FENCE BY GRENSCHNEIDER (800) 450-3489 IS STANDARD COLOR 'SILVER'. OR EQUIVALENT AS REVIEWED BY ARCHITECT AND APPROVAL BY OWNER. INSTALL TRELLIS, POSTS, AND STEEL CHANNEL TRIM PER MANUFACTURER'S INSTRUCTIONS.
 24. CONSTRUCT ASPHALT PAVING PER COA STD. SPECS. CONSTRUCT ASPHALT SECTION TO MATCH EXISTING ON-SITE ASPHALT PAVEMENT. CONDITIONS OR PER RECOMMENDATIONS OF GEOTECHNICAL ENGINEER. CONTRACTOR SHALL SUBMIT SHOP DRAWINGS OF PROPOSED SECTION FOR REVIEW BY ARCHITECT AND APPROVAL BY OWNER.
 25. CONSTRUCT 42" HEIGHT, 6" X 6" STEEL STATIONARY POST BOLLARD PER COA STD. DWG. 2259. 5M WELD 1/4" STEEL PLATE COVER AND GRIND SMOOTH. PAINT ALL EXPOSED STEEL.
 26. CONSTRUCT TRANSIT SHELTER PER COA STD. DWG. 2535.05.
 27. CONSTRUCT CONCRETE VALLEY GUTTER PER COA STD. DWG. 2420.
 28. NEW WAYFINDING MONUMENT SIGN, N.I.C.
 29. FURNISH AND INSTALL CONCRETE PARKING BUMPER. SEE DETAIL B1/L5-502.
 30. CONSTRUCT CORNER ACCESS RAMP PER COA STD. DWG. 2442A.
 31. PLAZA FURNITURE, N.I.C.
 32. CONSTRUCT 8" CONCRETE HEADER CURB PER DETAIL A5/L5-501.
 33. CONSTRUCT 12" CONCRETE HEADER CURB AT COLONNADE PER DETAIL A5/L5-501, 3M.
 34. FURNISH AND INSTALL 3 7/8 x 7 7/8 x 2 3/4" VEHICULAR CONCRETE PAVERS. PAVERS SHALL BE 'UMBRIANO' BY UNILOCK. (630) 892-9191. COLOR: 'FRENCH GRAY'. INSTALL PER COA STD. DWG. 2412.
 35. FURNISH AND INSTALL 3 7/8 x 7 7/8 x 2 3/4" VEHICULAR CONCRETE PAVERS. PAVERS SHALL BE 'CORVAYA' BY UNILOCK. (630) 892-9191. COLOR: 'WINTER MARVEL'. INSTALL PER COA STD. DWG. 2412.
 36. FURNISH 8" SQUARE 'RAIN' PATTERN CAST BASIN GRATE BY IRON AGE DESIGNS (877) 418-3568. INSTALL IN EXISTING CAST BASIN.
 37. FURNISH 12" SQUARE 'RAIN' PATTERN CAST BASIN GRATE BY IRON AGE DESIGNS (877) 418-3568. INSTALL IN EXISTING CAST BASIN. SEE CIVIL.
 38. FURNISH 12" SQUARE 'RAIN' PATTERN CAST BASIN GRATE BY IRON AGE DESIGNS (877) 418-3568. INSTALL IN NDS 1200 SERIES CAST BASIN. SEE CIVIL.
 39. FURNISH 24" SQUARE 'RAIN' PATTERN CAST BASIN GRATE BY IRON AGE DESIGNS (877) 418-3568. INSTALL IN EXISTING CAST BASIN. SEE CIVIL.
 40. FURNISH 24" SQUARE 'RAIN' PATTERN CAST BASIN GRATE BY IRON AGE DESIGNS (877) 418-3568. INSTALL IN IRON AGE CUSTOM FRAME PER MANUFACTURER'S INSTRUCTIONS. SEE CIVIL.
 41. FURNISH 8" X 20" 'RAIN' PATTERN TRENCH GRATE BY IRON AGE DESIGNS (877) 418-3568. INSTALL IN NDS 8" PRO SERIES CHANNEL DRAIN. SEE CIVIL.
 42. CONSTRUCT CUMI DUMSTER ENCLOSURE PER DETAIL D3/L5-502.
 43. CONSTRUCT CONCRETE STEPS WITH HAND RAIL. SEE DETAIL D1/L5-501.
 44. CONSTRUCT MOUNTABLE CURB PER COA STD. DWG. 2415B.
 45. INTERCEPTOR AND CLEANOUTS. SEE SITE UTILITY PLANS.
 46. CONSTRUCT 7" HT. STEEL BARRIER AND DOOR WITH PANIC HARDWARE. SEE ARCHITECTURAL PLANS.
 47. CONSTRUCT STEEL ARBOR. SEE ARCHITECTURAL PLANS.
 48. CONSTRUCT SITE MASONRY WALL PER DETAIL D5/L5-502.
 49. CONSTRUCT STEEL RAILING AT NARROW OPENING PER DETAIL C1/L5-501.
 50. CONSTRUCT NON-ACCESSIBLE RAMP PER DETAIL E4/L5-503.
 51. RESURFACE AND SEAL ASPHALT PAVING PER COA STD. SPECS. CONTRACTOR SHALL SUBMIT SHOP DRAWINGS OF PROPOSED AREAS TO BE RESURFACED AND RESEALED FOR REVIEW BY ARCHITECT AND APPROVAL BY OWNER.
 52. FURNISH AND INSTALL BAR HEIGHT TABLE, MODEL 4 UL6-119X17242-M2-SP, IN POWDER COAT COLOR 'SILVER' AS AVAILABLE FROM SITESCAPES, (888) 331-9464 OR EQUAL APPROVED BY OWNER.
 53. PLAZA PLANTER POT, N.I.C. SEE LIGHTING AND ELECTRICAL PLANS FOR LANDSCAPE LIGHTING. CONTRACTOR SHALL SUBMIT SHOP DRAWINGS OF PROPOSED WIRING, LIGHTING AND DRAINAGE. ALL SHALL BE FOR ARCHITECT REVIEW AND OWNER APPROVAL. SEE PLANTING PLANS.
 54. DEDUCTIVE ALTERNATE 1: OMIT PAVERS AT COVERED ARCADE. EXISTING CONCRETE TO REMAIN.
 55. FURNISH AND INSTALL VAN-ACCESSIBLE ADA PARKING SIGNS PER DETAIL A3/L5-502.
 56. DRAIN, SEE CIVIL.
 57. CONSTRUCT CONCRETE-FILLED STEEL BOLLARD PER DETAIL B2/L5-502.
 58. PAINT CROSSWALK STRIPING WITH TRAFFIC RATED PAINT.
 59. CONSTRUCT CONCRETE MOWSTRIP PER CABQ STD. DWG. 2726.
 60. FURNISH AND INSTALL MOTORCYCLE PARKING SPACE SIGN. SEE DETAIL B5/L5-502.
 61. CONSTRUCT GUARD RAIL. SEE DETAIL D5/L5-501.

- A. CONTRACTOR SHALL PRESERVE AND PROTECT EXISTING WALKWAYS, STRUCTURES, AND UTILITIES TO REMAIN. THE CONTRACTOR SHALL BE RESPONSIBLE TO MAINTAIN AND SECURE ALL ABOVEGROUND AND UNDERGROUND UTILITIES TO REMAIN, AND MAINTAIN ALL NECESSARY PROTECTION MEASURES, ANY DAMAGE TO EXISTING WALKWAYS, STRUCTURES, TREES, AND UTILITIES, EXCEPT NOT INCLUDING ANY DAMAGE TO UTILITIES RESULTING FROM CONSTRUCTION OPERATIONS SHALL BE REPAIRED AND/OR REPLACED AT NO ADDITIONAL COST TO THE OWNER.
- B. ALL AREAS ADJACENT TO THE SITE SHALL BE MAINTAINED IN A CLEAN CONDITION, MUD AND DEBRIS SHALL NOT BE ALLOWED TO EXIST.
- C. WHERE NEW CONCRETE PAVEMENT IS SHOWN ADJACENT TO EXISTING CONTRACTOR SHALL PROVIDE NEW CONCRETE UP TO AND FLUSH WITH EXISTING EXPANSION JOINT. LIMITS SHOWN ARE APPROXIMATE. CONTRACTOR SHALL FIELD VERIFY.
- D. CONTRACTOR SHALL RESET LID/BOXES OF ANY EXISTING UTILITY LID/BOXES AS NECESSARY SO THAT TOP OF LID IS FLUSH WITH TOP OF ADJACENT SURFACE.

- | | |
|---|--|
|  | 4" THICK CONCRETE PAVEMENT. SEE KEYED NOTE 1. |
|  | 6" THICK CONCRETE PAVEMENT. SEE KEYED NOTE 2. |
|  | CONCRETE PAVERS. SEE KEYED NOTE 4. |
|  | CONCRETE PAVERS. SEE KEYED NOTE 5. |
|  | CONCRETE PAVERS. SEE KEYED NOTE 6. |
|  | CONCRETE PAVERS. SEE KEYED NOTE 7. |
|  | CONCRETE PAVERS. SEE KEYED NOTE 8. |
|  | ASPHALT PAVEMENT. SEE KEYED NOTE 24. |
|  | VEHICULAR CONCRETE PAVERS. SEE KEYED NOTE 35. |
|  | RESIDENTIAL CONCRETE PAVERS. SEE KEYED NOTE 36. |
|  | RESURFACE AND RESEAL ASPHALT. SEE KEYED NOTE 52. |

- STEEL ENCLOSURE RAILING, KEYED NOTE 13.
 STEEL HAND RAIL.
 GUARD RAIL. SEE KEYED NOTE 62.
 TRELLIS. SEE KEYED NOTE 23.
 LIMITS OF DEDUCTIVE ALTERNATE 1. SEE KEYED NOTE 55.
 LIMITS OF WORK.
 LIMITS OF PHASE 1 WORK.



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LANDSCAPE ARCHITECT

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APRIL 2024


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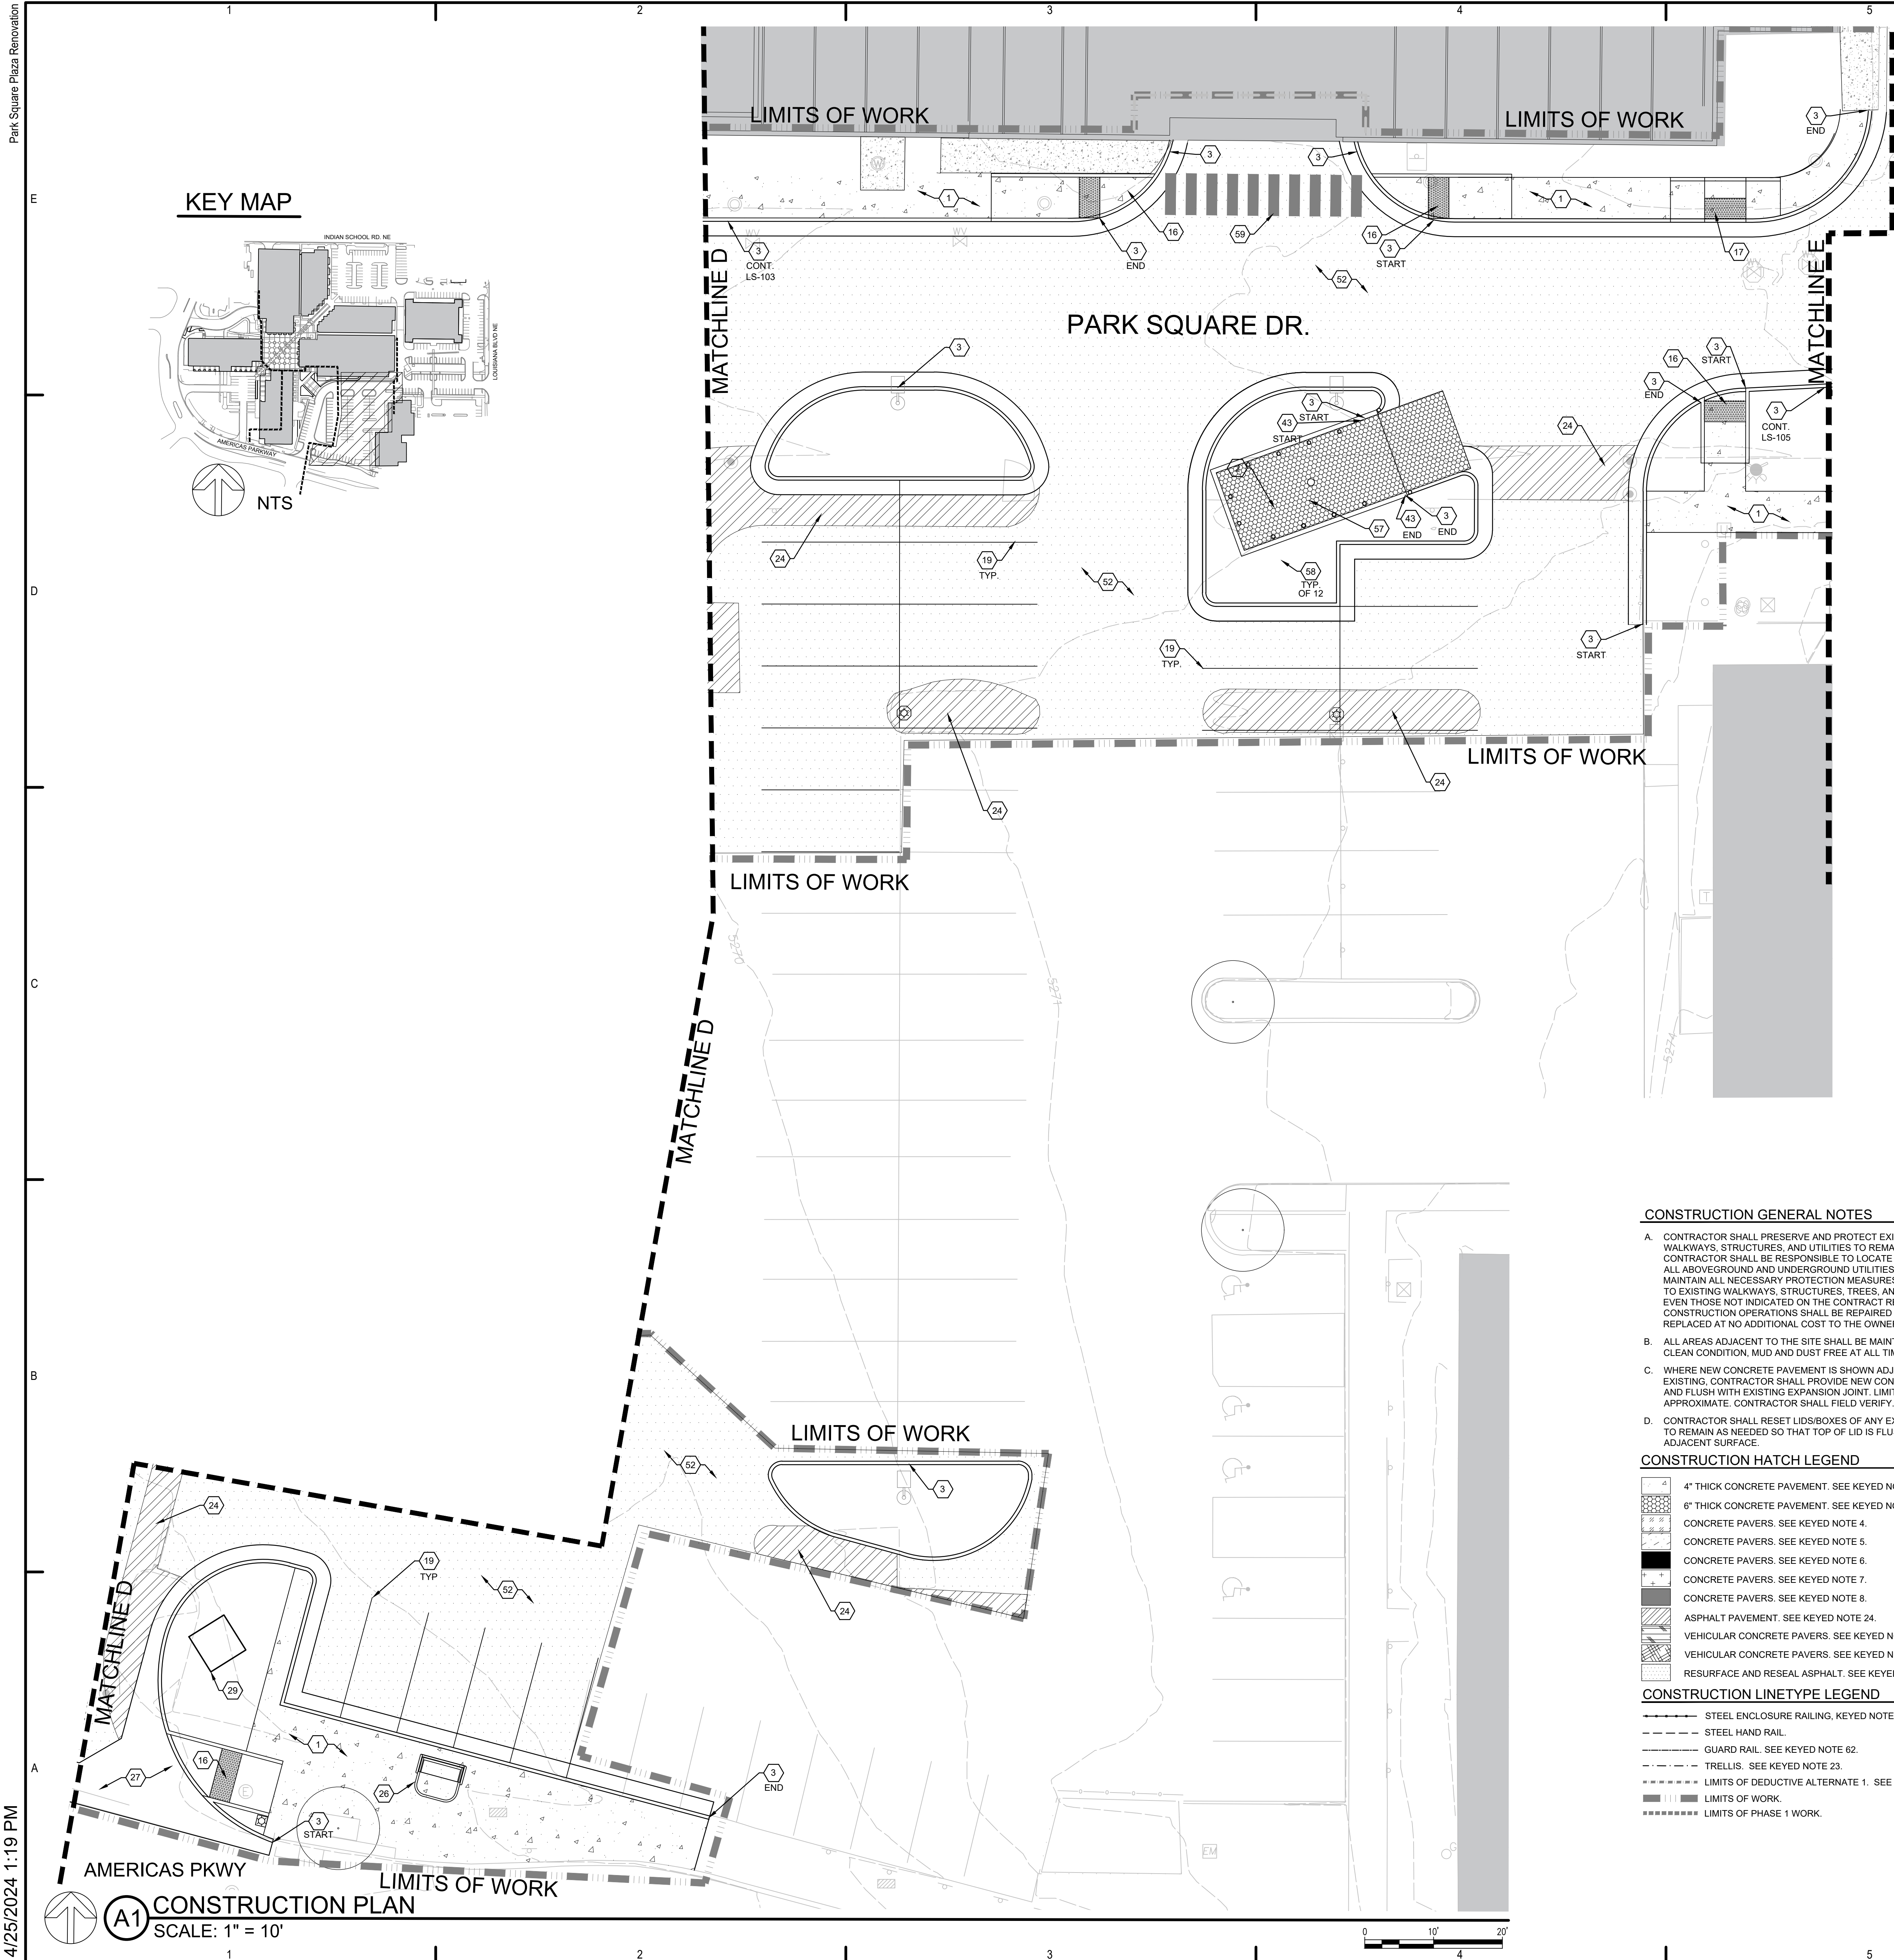
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LS-103

KEY MAP



PARK SQUARE DR.

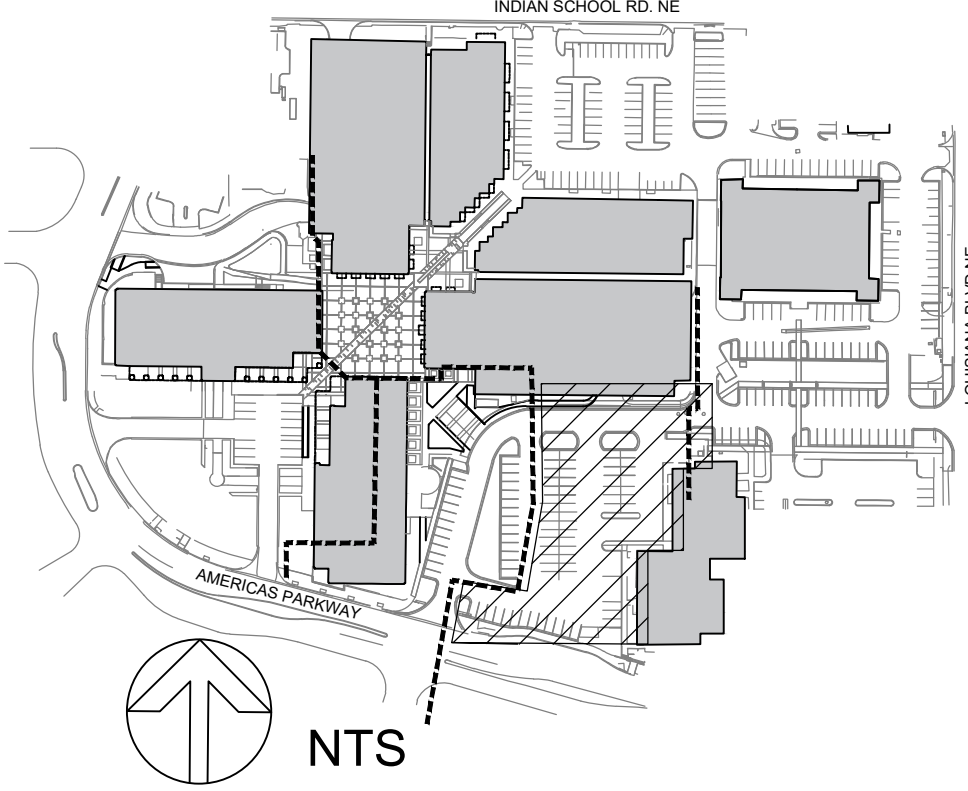

CONSTRUCTION GENERAL NOTES

- A. CONTRACTOR SHALL PRESERVE AND PROTECT EXISTING WALKWAYS, STRUCTURES, AND UTILITIES TO REMAIN. THE CONTRACTOR SHALL BE RESPONSIBLE TO LOCATE AND SECURE ALL ABOVEGROUND AND UNDERGROUND UTILITIES. INSTALL, AND MAINTAIN ALL NECESSARY PROTECTION MEASURES. ANY DAMAGE TO EXISTING WALKWAYS, STRUCTURES, TREES, AND UTILITIES, EVEN THOSE NOT INDICATED ON THE CONTRACT RESULTING FROM CONSTRUCTION OPERATIONS SHALL BE REPAIRED AND/OR REPLACED AT NO ADDITIONAL COST TO THE OWNER.
- B. ALL AREAS ADJACENT TO THE SITE SHALL BE MAINTAINED IN A CLEAN CONDITION. MUD AND DUST FREE AT ALL TIMES.
- C. WHERE NEW CONCRETE PAVEMENT IS SHOWN ADJACENT TO EXISTING, CONTRACTOR SHALL PROVIDE NEW CONCRETE UP TO AND FLUSH WITH EXISTING EXPANSION JOINT. LIMITS SHOWN ARE APPROXIMATE. CONTRACTOR SHALL FIELD VERIFY.
- D. CONTRACTOR SHALL RESET LIDS/BOXES OF ANY EXISTING UTILITY TO REMAIN AS NEEDED SO THAT TOP OF LID IS FLUSH WITH TOP OF ADJACENT SURFACE.

CONSTRUCTION HATCH LEGEND

- 4" THICK CONCRETE PAVEMENT. SEE KEYED NOTE 1.
- 6" THICK CONCRETE PAVEMENT. SEE KEYED NOTE 2.
- CONCRETE PAVERS. SEE KEYED NOTE 4.
- CONCRETE PAVERS. SEE KEYED NOTE 5.
- CONCRETE PAVERS. SEE KEYED NOTE 6.
- CONCRETE PAVERS. SEE KEYED NOTE 7.
- CONCRETE PAVERS. SEE KEYED NOTE 8.
- ASPHALT PAVEMENT. SEE KEYED NOTE 24.
- VEHICULAR CONCRETE PAVERS. SEE KEYED NOTE 35.
- VEHICULAR CONCRETE PAVERS. SEE KEYED NOTE 36.
- RESURFACE AND RESEAL ASPHALT. SEE KEYED NOTE 52.

CONSTRUCTION LINETYPE LEGEND

- STEEL ENCLOSURE RAILING, KEYED NOTE 13.
- STEEL HAND RAIL.
- GUARD RAIL. SEE KEYED NOTE 62.
- TRELLIS. SEE KEYED NOTE 23.
- LIMITS OF DEDUCTIVE ALTERNATE 1. SEE KEYED NOTE 55.
- LIMITS OF WORK.
- LIMITS OF PHASE 1 WORK.

CONSTRUCTION KEYED NOTES

- CONSTRUCT 4" THICK CONCRETE WALK. SEE DETAIL A1/LS-501.
- CONSTRUCT 6" THICK VEHICULAR CONCRETE PAVEMENT. SEE DETAIL A3/LS-501 AND STRUCTURAL SHEETS.
- CONSTRUCT STANDARD CONCRETE CURB AND GUTTER PER COA STD. DWG. 2415A.
- FURNISH AND INSTALL 50 MM THICK 'ARCANA' CONCRETE PAVERS BY UNILOCK, (630) 892-9191, COLOR: 'CORVAVA'. INSTALL PER DETAILS B1/LS-501 AND B3/LS-501. SEE DIMENSION PLAN.
- FURNISH AND INSTALL 50 MM THICK 'ARCANA' CONCRETE PAVERS BY UNILOCK, (630) 892-9191, COLOR: 'MODERNA'. INSTALL PER DETAILS B1/LS-501 AND B3/LS-501. SEE DIMENSION PLAN.
- FURNISH AND INSTALL 50 MM THICK 'UMBRIANO' CONCRETE PAVERS BY UNILOCK, (630) 892-9191, COLOR: 'MIDNIGHT SKY'. INSTALL PER DETAILS B1/LS-501 AND B3/LS-501. SEE DIMENSION PLAN.
- FURNISH AND INSTALL 50 MM THICK 'ARCANA' CONCRETE PAVERS BY UNILOCK, (630) 892-9191, COLOR: 'VIVANTO'. INSTALL PER DETAILS B1/LS-501 AND B3/LS-501. SEE DIMENSION PLAN.
- FURNISH AND INSTALL 50 MM THICK 'ARCANA' CONCRETE PAVERS BY UNILOCK, (630) 892-9191, COLOR: 'AVORIO'. INSTALL PER DETAILS B1/LS-501 AND B3/LS-501. SEE DIMENSION PLAN.
- CONSTRUCT CONCRETE ALLEY GUTTER PER COA STD. DWG 2415B.
- FABRICATE AND INSTALL DOUBLE LEAF, DOUBLE SWING STEEL GATE PER DETAIL B4/LS-503. STEEL SHALL BE POWDER COATED. POWDER COAT COLOR: SILVER.
- FABRICATE AND INSTALL SINGLE LEAF, DOUBLE SWING STEEL GATE PER DETAIL C4/LS-503. STEEL SHALL BE POWDER COATED. POWDER COAT COLOR: SILVER.
- FABRICATE AND INSTALL CUSTOM STEEL PLANTER PER DETAIL B1/LS-503.
- FABRICATE AND INSTALL CUSTOM STEEL RAILING PER DETAIL A4/LS-503. STEEL SHALL BE POWDER COATED. POWDER COAT COLOR: SILVER.
- FUTURE FOUNTAIN BY OWNER, N.I.C. SEE ELECTRICAL AND UTILITY PLANS FOR STUB-OUTS.
- CONSTRUCT RETAINING CONCRETE PLANTER PER DETAIL A1/LS-503. SEE STRUCTURAL SHEETS.
- CONSTRUCT TYPE A CONCRETE ACCESSIBLE RAMP PER DETAIL B3/LS-502.
- CONSTRUCT TYPE C CONCRETE ACCESSIBLE RAMP PER DETAIL D1/LS-502.
- CONSTRUCT CONCRETE LOADING DOCK. SEE ARCHITECTURAL AND STRUCTURAL SHEETS.
- PAINT PARKING LOT STRIPING. PAINT SHALL BE 4" WIDTH. PAINT SHALL BE TRAFFIC RATED LATEX PAINT. COLOR: WHITE. SEE DETAIL A1/LS-502.
- FURNISH AND INSTALL ADA PARKING SIGNS PER DETAIL A3/LS-502.
- FURNISH BENCHES, MODEL 520 AND 522 BY DUMOR, AS AVAILABLE FROM EXERPLAY (505) 281-0151, WITH 'ANTIQUE MAHOGANY' COLORED WOOD GRAIN PLASTIC SEAT AND 'TEXTURED RUST' COLOR POWERCOAT. EMBED MOUNT PER MANUFACTURER'S INSTRUCTIONS.
- FURNISH BENCHES, MODEL 521 AND 523 BY DUMOR, AS AVAILABLE FROM EXERPLAY (505) 281-0151, WITH 'ANTIQUE MAHOGANY' COLORED WOOD GRAIN PLASTIC SEAT AND 'TEXTURED RUST' COLOR POWERCOAT. EMBED MOUNT PER MANUFACTURER'S INSTRUCTIONS.
- FURNISH 8' HT. POST-MOUNTED FREESTANDING VERTICAL TRELLIS FENCE BY GREENSCREEN (888) 450-3434 IS STANDARD COLOR 'SILVER' OR EQUAL AS REVIEWED BY ARCHITECT AND APPROVAL BY OWNER. INSTALL TRELLIS, POSTS, AND STEEL CHANNEL TRIM PER MANUFACTURER'S INSTRUCTIONS.
- CONSTRUCT ASPHALT PAVING PER COA STD. SPECS. CONSTRUCT ASPHALT SECTION TO MATCH EXISTING ON-SITE ASPHALT PAVEMENT SECTIONS OR PER RECOMMENDATIONS OF GEOTECHNICAL ENGINEER. CONTRACTOR SHALL SUBMIT SHOP DRAWINGS OF PROPOSED SECTION FOR REVIEW BY ARCHITECT AND APPROVAL BY OWNER.
- CONSTRUCT 42" HEIGHT, 6"-Ø STEEL STATIONARY POST BOLLARD PER COA STD. DWG. 2250, SIM. WELD 1/4" STEEL PLATE COVER AND GRIND SMOOTH. PAINT ALL EXPOSED STEEL.
- CONSTRUCT TRANSIT SHELTER PER COA STD. DWG. 2535.05.
- CONSTRUCT CONCRETE ALLEY GUTTER PER COA STD. DWG. 2420.
- NEW TANK FOR USED COOKING OIL, N.I.C.
- NEW WAYFINDING MONUMENT SIGN, N.I.C.
- FURNISH AND INSTALL CONCRETE PARKING BUMPER. SEE DETAIL B1/LS-502.
- CONSTRUCT CORNER ACCESS RAMP PER COA STD. DWG 2442A.
- PLAZA FURNITURE, N.I.C.
- CONSTRUCT 8" CONCRETE HEADER CURB PER DETAIL A5/LS-501.
- CONSTRUCT 12" CONCRETE HEADER CURB AT COLONNADE PER DETAIL A5/LS-501, SIM.
- FURNISH AND INSTALL 3 7/8 x 7 7/8 x 2 3/4" VEHICULAR CONCRETE PAVERS. PAVERS SHALL BE 'UMBRIANO' BY UNILOCK, (630) 892-9191, COLOR: 'FRENCH GRAY'. INSTALL PER COA STD. DWG. 2412.
- FURNISH AND INSTALL 3 7/8 x 7 7/8 x 2 3/4" VEHICULAR CONCRETE PAVERS. PAVERS SHALL BE 'UMBRIANO' BY UNILOCK, (630) 892-9191, COLOR: 'WINTER MARVEL'. INSTALL PER COA STD. DWG. 2412.
- FURNISH 8" SQUARE 'RAIN' PATTERN CATCH BASIN GRATE BY IRON AGE DESIGNS (877) 418-3568. INSTALL IN EXISTING CATCH BASIN.
- FURNISH 12" SQUARE 'RAIN' PATTERN CATCH BASIN GRATE BY IRON AGE DESIGNS (877) 418-3568. INSTALL IN EXISTING CATCH BASIN. SEE CIVIL.
- FURNISH 12" SQUARE 'RAIN' PATTERN CATCH BASIN GRATE BY IRON AGE DESIGNS (877) 418-3568. INSTALL IN NDS 1200 SERIES CATCH BASIN. SEE CIVIL.
- FURNISH 24" SQUARE 'RAIN' PATTERN CATCH BASIN GRATE BY IRON AGE DESIGNS (877) 418-3568. INSTALL IN EXISTING CATCH BASIN. SEE CIVIL.
- FURNISH 24" SQUARE 'RAIN' PATTERN CATCH BASIN GRATE BY IRON AGE DESIGNS (877) 418-3568. INSTALL IN IRON AGE CUSTOM FRAME PER MANUFACTURER'S INSTRUCTIONS. SEE CIVIL.
- FURNISH 8" x 20" 'RAIN' PATTERN TRENCH GRATE BY IRON AGE DESIGNS (877) 418-3568. INSTALL IN NDS 6" PRO SERIES CHANNEL DRAIN. SEE CIVIL.
- CONSTRUCT CMU DUMPSTER ENCLOSURE PER DETAIL D3/LS-502.
- CONSTRUCT CONCRETE STEPS WITH HAND RAIL. SEE DETAIL D1/LS-501.
- CONSTRUCT MOUNTABLE CURB PER COA STD. DWG. 2415B.
- INTERCEPTOR AND CLEANOUTS. SEE SITE UTILITY PLANS.
- CONSTRUCT 7' HT. STEEL BARRIER AND DOOR WITH PANIC HARDWARE. SEE ARCHITECTURAL PLANS.
- CONSTRUCT STEEL ARBOR. SEE ARCHITECTURAL PLANS.
- CONSTRUCT SITE MASONRY WALL PER DETAIL D5/LS-502.
- CONSTRUCT STEEL RAILING AT NARROW OPENING PER DETAIL C1/LS-503.
- CONSTRUCT NON-ACCESSIBLE RAMP PER DETAIL E4/LS-503.
- RESURFACE AND SEAL ASPHALT PAVING PER COA STD. SPECS. CONTRACTOR SHALL SUBMIT SHOP DRAWINGS OF PROPOSED AREAS TO BE RESURFACED AND RESEALED FOR REVIEW BY ARCHITECT AND APPROVAL BY OWNER.
- FURNISH AND INSTALL BAR HEIGHT TABLE, MODEL # UL-6119X17X42-3M-PF, IN POWDER COAT COLOR 'SILVER' AS AVAILABLE FROM SITESCAPES, (888) 331-9464 OR EQUAL APPROVED BY OWNER.
- PLAZA PLANTER POT, N.I.C. SEE LIGHTING AND ELECTRICAL PLANS FOR LANDSCAPE LIGHTING. CONTRACTOR SHALL SUBMIT SHOP DRAWINGS OF PROPOSED WIRE ROUTING AND DRIVER INSTALLATION FOR ARCHITECT REVIEW AND OWNER APPROVAL. SEE PLANTING PLANS.
- DEDUCTIVE ALTERNATE 1: OMIT PAVERS AT COVERED ARCADE. EXISTING CONCRETE TO REMAIN.
- FURNISH AND INSTALL VAN-ACCESSIBLE ADA PARKING SIGNS PER DETAIL A3/LS-502.
- DRAIN. SEE CIVIL.
- CONSTRUCT CONCRETE-FILLED STEEL BOLLARD PER DETAIL B2/LS-502.
- PAINT CROSSWALK STRIPING WITH TRAFFIC RATED PAINT.
- CONSTRUCT CONCRETE MOWSTRIP PER CABO STD. DWG. 2726.
- FURNISH AND INSTALL MOTORCYCLE PARKING SPACE SIGN. SEE DETAIL B5/LS-502.
- CONSTRUCT GUARD RAIL. SEE DETAIL D5/LS-501.

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LANDSCAPE ARCHITECT

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APRIL 2024

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| DRAWN BY: | TW/WM |
| CHECKED BY: | WM |


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CONSTRUCTION PLAN

LS-104

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KEY MAP



CONSTRUCTION GENERAL NOTES

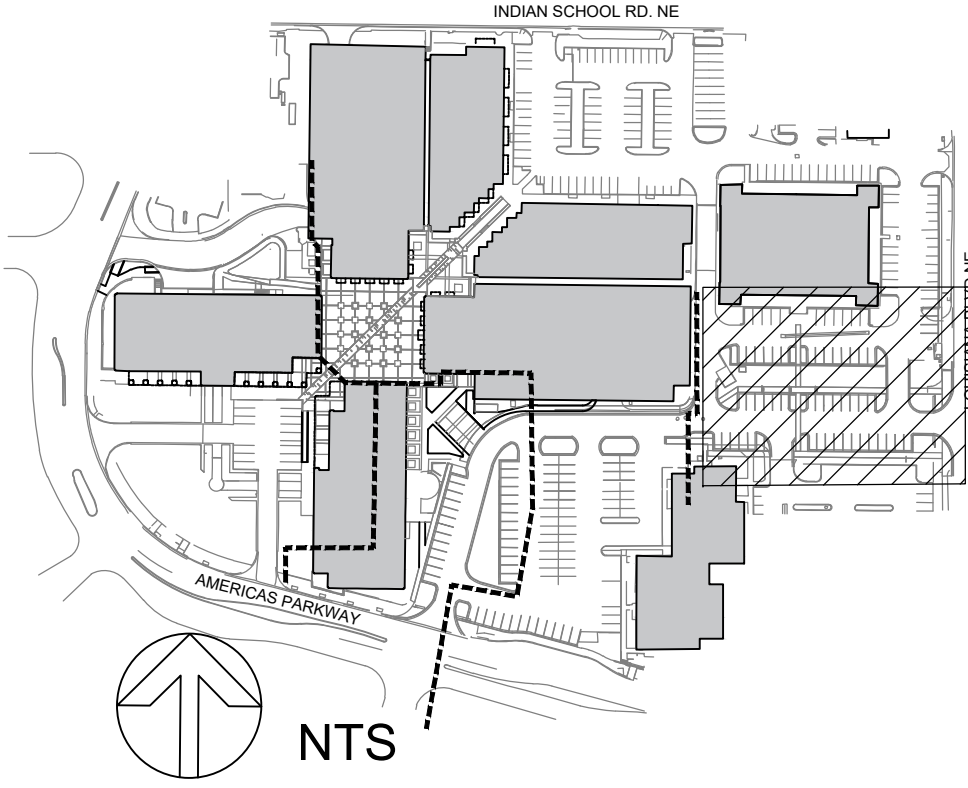- CONTRACTOR SHALL PRESERVE AND PROTECT EXISTING WALKWAYS, STRUCTURES, AND UTILITIES TO REMAIN. THE CONTRACTOR SHALL BE RESPONSIBLE TO LOCATE AND SECURE ALL ABOVEGROUND AND UNDERGROUND UTILITIES, INSTALL, AND MAINTAIN ALL NECESSARY PROTECTION MEASURES. ANY DAMAGE TO EXISTING WALKWAYS, STRUCTURES, TREES, AND UTILITIES, EVEN THOSE NOT INDICATED ON THE CONTRACT RESULTING FROM CONSTRUCTION OPERATIONS SHALL BE REPAIRED AND/OR REPLACED AT NO ADDITIONAL COST TO THE OWNER.
- ALL AREAS ADJACENT TO THE SITE SHALL BE MAINTAINED IN A CLEAN CONDITION, MUD AND DUST FREE AT ALL TIMES.
- WHERE NEW CONCRETE PAVEMENT IS SHOWN ADJACENT TO EXISTING, CONTRACTOR SHALL PROVIDE NEW CONCRETE UP TO AND FLUSH WITH EXISTING EXPANSION JOINT. LIMITS SHOWN ARE APPROXIMATE. CONTRACTOR SHALL FIELD VERIFY.
- CONTRACTOR SHALL RESET LIDS/BOXES OF ANY EXISTING UTILITY TO REMAIN AS NEEDED SO THAT TOP OF LID IS FLUSH WITH TOP OF ADJACENT SURFACE.

CONSTRUCTION HATCH LEGEND

- 4" THICK CONCRETE PAVEMENT. SEE KEYED NOTE 1.
- 6" THICK CONCRETE PAVEMENT. SEE KEYED NOTE 2.
- CONCRETE PAVERS. SEE KEYED NOTE 4.
- CONCRETE PAVERS. SEE KEYED NOTE 5.
- CONCRETE PAVERS. SEE KEYED NOTE 6.
- CONCRETE PAVERS. SEE KEYED NOTE 7.
- CONCRETE PAVERS. SEE KEYED NOTE 8.
- ASPHALT PAVEMENT. SEE KEYED NOTE 24.
- VEHICULAR CONCRETE PAVERS. SEE KEYED NOTE 35.
- VEHICULAR CONCRETE PAVERS. SEE KEYED NOTE 36.
- RESURFACE AND RESEAL ASPHALT. SEE KEYED NOTE 52.

CONSTRUCTION LINETYPE LEGEND

- STEEL ENCLOSURE RAILING, KEYED NOTE 13.
- STEEL HAND RAIL.
- GUARD RAIL. SEE KEYED NOTE 62.
- TRELLIS. SEE KEYED NOTE 23.
- LIMITS OF DEDUCTIVE ALTERNATE 1. SEE KEYED NOTE 55.
- LIMITS OF WORK.
- LIMITS OF PHASE 1 WORK.

CONSTRUCTION KEYED NOTES

- CONSTRUCT 4" THICK CONCRETE WALK. SEE KEYED NOTE 1.
- CONSTRUCT 6" THICK VEHICULAR CONCRETE PAVEMENT. SEE DETAIL A3/L5-501 AND STRUCTURAL SHEETS.
- CONSTRUCT STANDARD CONCRETE CURB AND GUTTER PER COA STD. DWG. 2415A.
- FURNISH AND INSTALL 50 MM THICK 'ARCANA' CONCRETE PAVERS BY UNILOCK, (630) 892-9191, COLOR: 'CORVANA'. INSTALL PER DETAILS B1/L5-501 AND B3/L5-501. SEE DIMENSION PLAN.
- FURNISH AND INSTALL 50 MM THICK 'ARCANA' CONCRETE PAVERS BY UNILOCK, (630) 892-9191, COLOR: 'MOENA'. INSTALL PER DETAILS B1/L5-501 AND B3/L5-501. SEE DIMENSION PLAN.
- FURNISH AND INSTALL 50 MM THICK 'UMBRIANO' CONCRETE PAVERS BY UNILOCK, (630) 892-9191, COLOR: 'MIDNIGHT SKY'. INSTALL PER DETAILS B1/L5-501 AND B3/L5-501. SEE DIMENSION PLAN.
- FURNISH AND INSTALL 50 MM THICK 'ARCANA' CONCRETE PAVERS BY UNILOCK, (630) 892-9191, COLOR: 'VIVANTO'. INSTALL PER DETAILS B1/L5-501 AND B3/L5-501. SEE DIMENSION PLAN.
- FURNISH AND INSTALL 50 MM THICK 'ARCANA' CONCRETE PAVERS BY UNILOCK, (630) 892-9191, COLOR: 'AVORIO'. INSTALL PER DETAILS B1/L5-501 AND B3/L5-501. SEE DIMENSION PLAN.
- CONSTRUCT CONCRETE ALLEY GUTTER PER COA STD. DWG. 2415B.
- FABRICATE AND INSTALL DOUBLE LEAF, DOUBLE SWING STEEL GATE PER DETAIL B4/L5-503. STEEL SHALL BE POWDER COATED. POWDER COAT COLOR: SILVER.
- FABRICATE AND INSTALL SINGLE LEAF, DOUBLE SWING STEEL GATE PER DETAIL C4/L5-503. STEEL SHALL BE POWDER COATED. POWDER COAT COLOR: SILVER.
- FABRICATE AND INSTALL CUSTOM STEEL PLANTER PER DETAIL B1/L5-503.
- FABRICATE AND INSTALL CUSTOM STEEL RAILING PER DETAIL A4/L5-503. STEEL SHALL BE POWDER COATED. POWDER COAT COLOR: SILVER.
- FUTURE FOUNTAIN BY OWNER, N.I.C. SEE ELECTRICAL AND UTILITY PLANS FOR STUD-OUTS.
- CONSTRUCT RETAINING CONCRETE PLANTER PER DETAIL A1/L5-503. SEE STRUCTURAL SHEETS.
- CONSTRUCT TYPE A CONCRETE ACCESSIBLE RAMP PER DETAIL B3/L5-502.
- CONSTRUCT TYPE C CONCRETE ACCESSIBLE RAMP PER DETAIL D1/L5-502.
- CONSTRUCT CONCRETE LOADING DOCK. SEE ARCHITECTURAL AND STRUCTURAL SHEETS.
- PAINT PARKING LOT STRIPING. PAINT SHALL BE 4" WIDTH. PAINT SHALL BE TRAFFIC-RATED LATEX PAINT. COLOR: WHITE. SEE DETAIL A1/L5-502.
- FURNISH AND INSTALL ADA PARKING SIGNS PER DETAIL A3/L5-502.
- FURNISH BENCHES, MODEL 520 AND 522 BY DUMOR, AS AVAILABLE FROM EXERPLAY (505) 281-0151, WITH 'ANTIQUE MAHOGANY' COLORED WOOD GRAIN PLASTIC SEAT AND 'TEXTURED RUST' COLOR POWDERCOAT. EMBED MOUNT PER MANUFACTURER'S INSTRUCTIONS.
- FURNISH BENCHES, MODEL 521 AND 523 BY DUMOR, AS AVAILABLE FROM EXERPLAY (505) 281-0151, WITH 'ANTIQUE MAHOGANY' COLORED WOOD GRAIN PLASTIC SEAT AND 'TEXTURED RUST' COLOR POWDERCOAT. EMBED MOUNT PER MANUFACTURER'S INSTRUCTIONS.
- FURNISH 8' HT. POST-MOUNTED FREESTANDING VERTICAL TRELLIS FENCE BY GREENSCREEN (800) 450-3494 IS STANDARD COLOR 'SILVER', OR EQUAL AS REVIEWED BY ARCHITECT AND APPROVAL BY OWNER. INSTALL TRELLIS, POSTS, AND STEEL CHANNEL TRIM PER MANUFACTURER'S INSTRUCTIONS.
- CONSTRUCT ASPHALT PAVING PER COA STD. SPECS. CONSTRUCT ASPHALT SECTION TO MATCH EXISTING ON-SITE ASPHALT PAVEMENT SECTIONS OR PER RECOMMENDATIONS OF GEOTECHNICAL ENGINEER. CONTRACTOR SHALL SUBMIT SHOP DRAWINGS OF PROPOSED SECTION FOR REVIEW BY ARCHITECT AND APPROVAL BY OWNER.
- CONSTRUCT 42" HEIGHT, 8"-Ø STEEL STATIONARY POST BOLLARD PER COA STD. DWG. 2250. SIM. WELD 1/4" STEEL PLATE COVER AND GRIND SMOOTH. PAINT ALL EXPOSED STEEL.
- CONSTRUCT TRANSIT SHELTER PER COA STD. DWG. 2535.05.
- CONSTRUCT CONCRETE VALLEY GUTTER PER COA STD. DWG. 2420.
- NEW TANK FOR USED COOKING OIL, N.I.C.
- NEW WAYFINDING MONUMENT SIGN, N.I.C.
- FURNISH AND INSTALL CONCRETE PARKING BUMPER. SEE DETAIL B1/L5-502.
- CONSTRUCT CORNER ACCESS RAMP PER COA STD. DWG. 2442A.
- PLAZA FURNITURE, N.I.C.
- CONSTRUCT 8" CONCRETE HEADER CURB PER DETAIL A5/L5-501.
- CONSTRUCT 12" CONCRETE HEADER CURB AT COLONNADE PER DETAIL A5/L5-501. SIM.
- FURNISH AND INSTALL 3 7/8 x 7 7/8 x 2 3/4" VEHICULAR CONCRETE PAVERS. PAVERS SHALL BE 'UMBRIANO' BY UNILOCK, (630) 892-9191, COLOR: 'FRENCH GRAY'. INSTALL PER COA STD. DWG. 2412.
- FURNISH AND INSTALL 3 7/8 x 7 7/8 x 2 3/4" VEHICULAR CONCRETE PAVERS. PAVERS SHALL BE 'UMBRIANO' BY UNILOCK, (630) 892-9191, COLOR: 'WINTER MARVEL'. INSTALL PER COA STD. DWG. 2412.
- FURNISH 8" SQUARE 'RAIN' PATTERN CATCH BASIN GRATE BY IRON AGE DESIGNS (877) 418-3568. INSTALL IN EXISTING CATCH BASIN.
- FURNISH 12" SQUARE 'RAIN' PATTERN CATCH BASIN GRATE BY IRON AGE DESIGNS (877) 418-3568. INSTALL IN EXISTING CATCH BASIN. SEE CIVIL.
- FURNISH 12" SQUARE 'RAIN' PATTERN CATCH BASIN GRATE BY IRON AGE DESIGNS (877) 418-3568. INSTALL IN NDS 1200 SERIES CATCH BASIN. SEE CIVIL.
- FURNISH 24" SQUARE 'RAIN' PATTERN CATCH BASIN GRATE BY IRON AGE DESIGNS (877) 418-3568. INSTALL IN EXISTING CATCH BASIN. SEE CIVIL.
- FURNISH 24" SQUARE 'RAIN' PATTERN CATCH BASIN GRATE BY IRON AGE DESIGNS (877) 418-3568. INSTALL IN IRON AGE CUSTOM FRAME PER MANUFACTURER'S INSTRUCTIONS. SEE CIVIL.
- FURNISH 8" x 20" 'RAIN' PATTERN TRENCH GRATE BY IRON AGE DESIGNS (877) 418-3568. INSTALL IN NDS 8" PRO SERIES CHANNEL DRAIN. SEE CIVIL.
- CONSTRUCT CMU DUMPSTER ENCLOSURE PER DETAIL D3/L5-502.
- CONSTRUCT CONCRETE STEPS WITH HAND RAIL. SEE DETAIL D1/L5-501.
- CONSTRUCT MOUNTABLE CURB PER COA STD. DWG. 2415B.
- INTERCEPTOR AND CLEANOUTS, SEE SITE UTILITY PLANS.
- CONSTRUCT 7' HT. STEEL BARRIER AND DOOR WITH PANIC HARDWARE. SEE ARCHITECTURAL PLANS.
- CONSTRUCT STEEL ARBOR, SEE ARCHITECTURAL PLANS.
- CONSTRUCT SITE MASONRY WALL PER DETAIL D5/L5-502.
- CONSTRUCT STEEL RAILING AT NARROW OPENING PER DETAIL C1/L5-503.
- CONSTRUCT NON-ACCESSIBLE RAMP PER DETAIL E4/L5-503.
- RESURFACE AND SEAL ASPHALT PAVING PER COA STD. SPECS. CONTRACTOR SHALL SUBMIT SHOP DRAWINGS OF PROPOSED AREAS TO BE RESURFACED AND RESEALED FOR REVIEW BY ARCHITECT AND APPROVAL BY OWNER.
- FURNISH AND INSTALL BAR HEIGHT TABLE, MODEL # ULB-19X17X42-SM-PF, IN POWDER COAT COLOR 'SILVER' AS AVAILABLE FROM SITESCAPES, (888) 351-0464 OR EQUAL, APPROVED BY OWNER.
- PLAZA PLANTER POT, N.I.C. SEE LIGHTING AND ELECTRICAL PLANS FOR LANDSCAPE LIGHTING. CONTRACTOR SHALL SUBMIT SHOP DRAWINGS OF PROPOSED WIRE ROUTING AND DRIVER INSTALLATION FOR ARCHITECT REVIEW AND OWNER APPROVAL. SEE PLANTING PLANS.
- DEDUCTIVE ALTERNATE 1: OMIT PAVERS AT COVERED ARCADE. EXISTING CONCRETE TO REMAIN.
- FURNISH AND INSTALL VAN-ACCESSIBLE ADA PARKING SIGNS PER DETAIL A3/L5-502.
- DRAIN. SEE CIVIL.
- CONSTRUCT CONCRETE-FILLED STEEL BOLLARD PER DETAIL B2/L5-502.
- PAINT CROSSWALK STRIPING WITH TRAFFIC RATED PAINT.
- CONSTRUCT CONCRETE MOWSTRIP PER CABO STD. DWG. 2726.
- FURNISH AND INSTALL MOTORCYCLE PARKING SPACE SIGN. SEE DETAIL B5/L5-502.
- CONSTRUCT GUARD RAIL. SEE DETAIL D5/L5-501.

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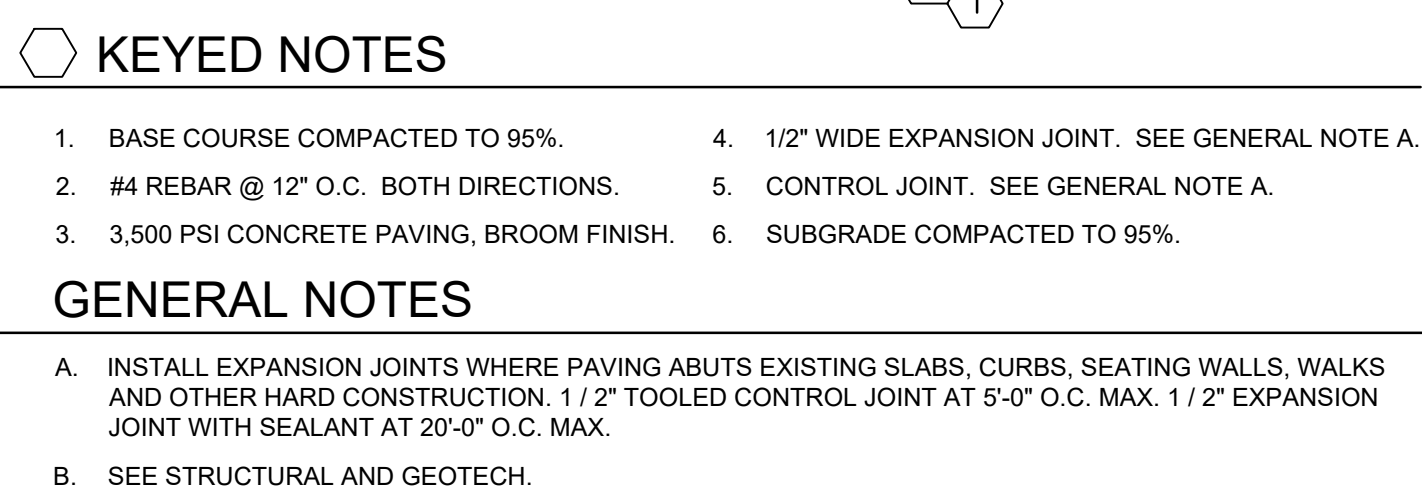
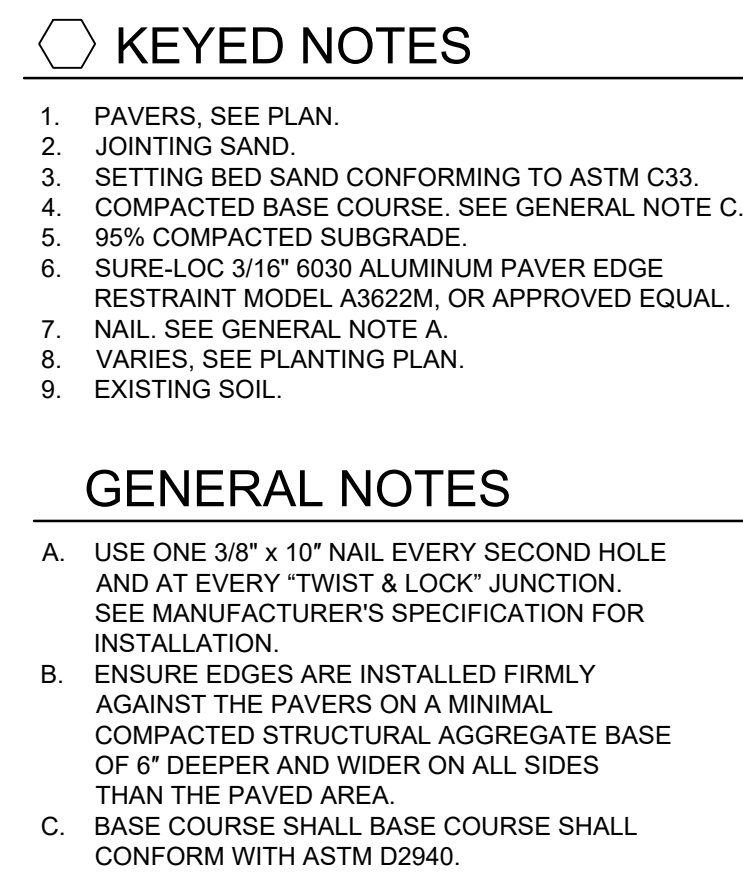
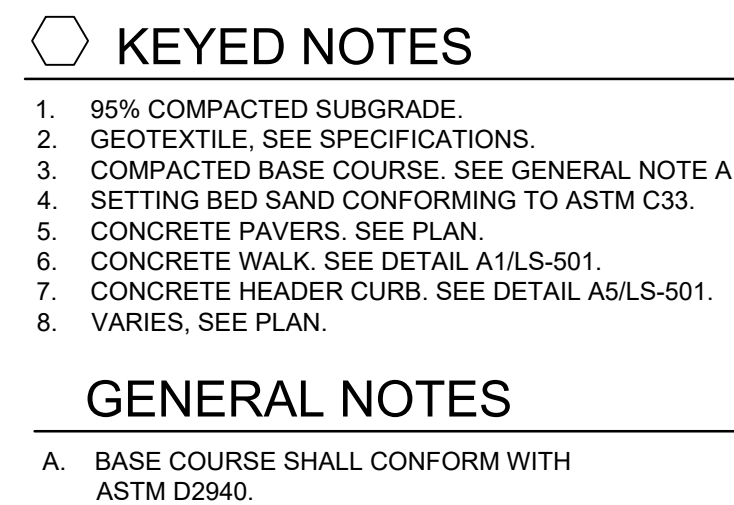
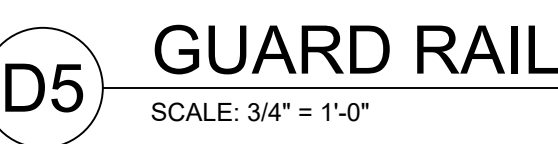
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CONSTRUCTION PLAN

LS-105

Park Square Plaza Renovation



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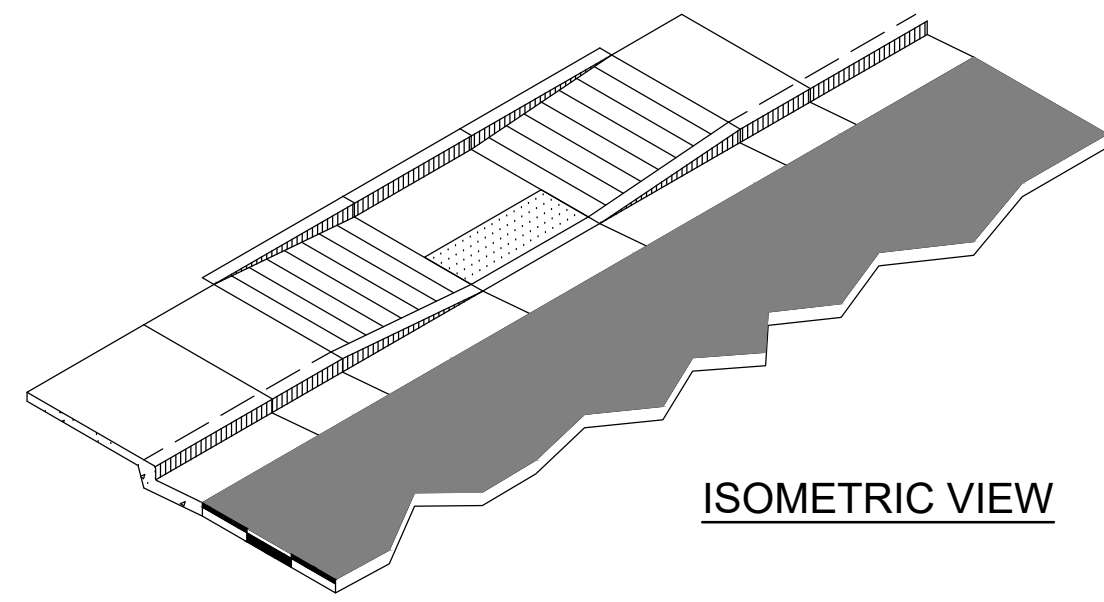
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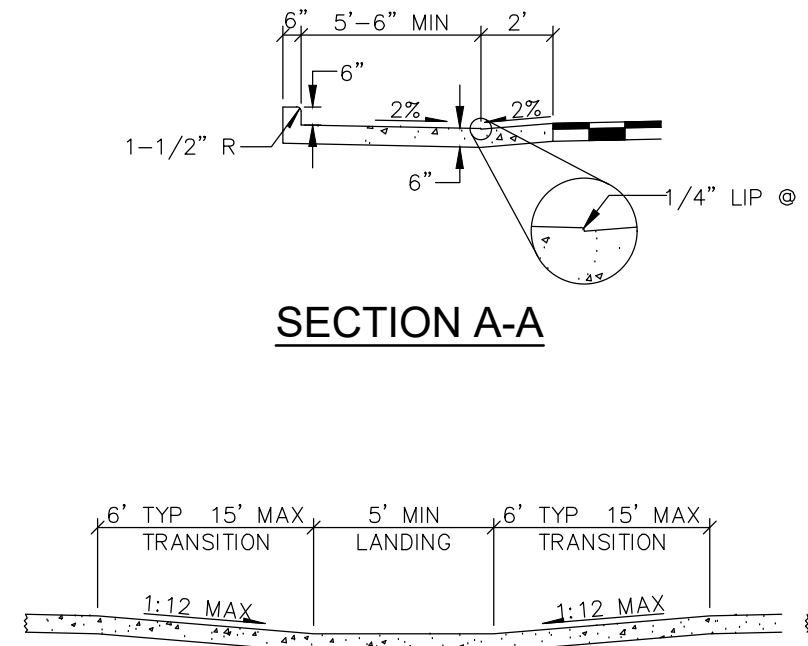
CONSTRUCTION DETAILS

LS-501






GENERAL NOTES

1. AVOID PLACING DRAINAGE STRUCTURES, TRAFFIC SIGNAL EQUIPMENT, JUNCTION BOXES OR OTHER OBSTRUCTIONS IN FRONT OF RAMP ACCESS AREAS.
2. RAMP SLOPES SHALL NOT BE STEEPER THAN 2%. THE TRANSITIONS SHALL HAVE A MAXIMUM SLOPE OF 1:12.
3. DETECTABLE WARNINGS SHALL BE UNLOCK ADA PAVES IN COLOR 'CHARCOL' OR APPROVED EQUAL. INSTALLATION SHALL BE DONE IN ACCORDANCE WITH MANUFACTURERS RECOMMENDATIONS.









SECTION B-B

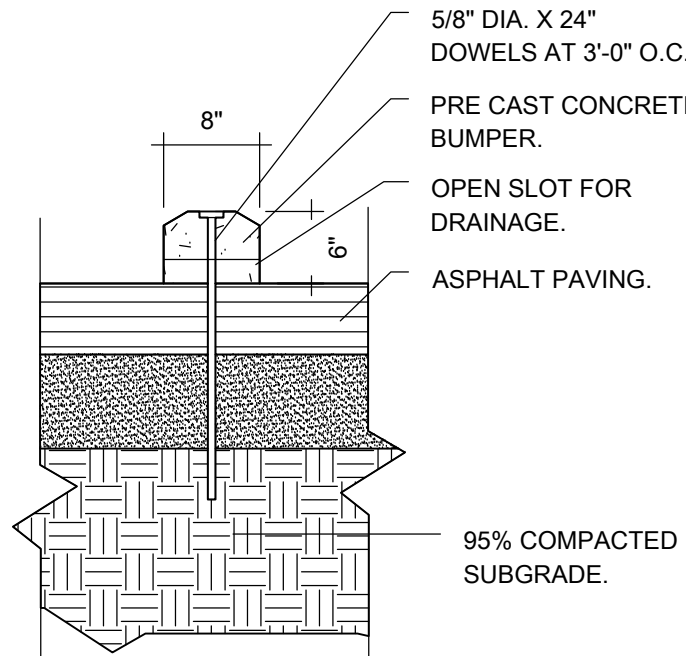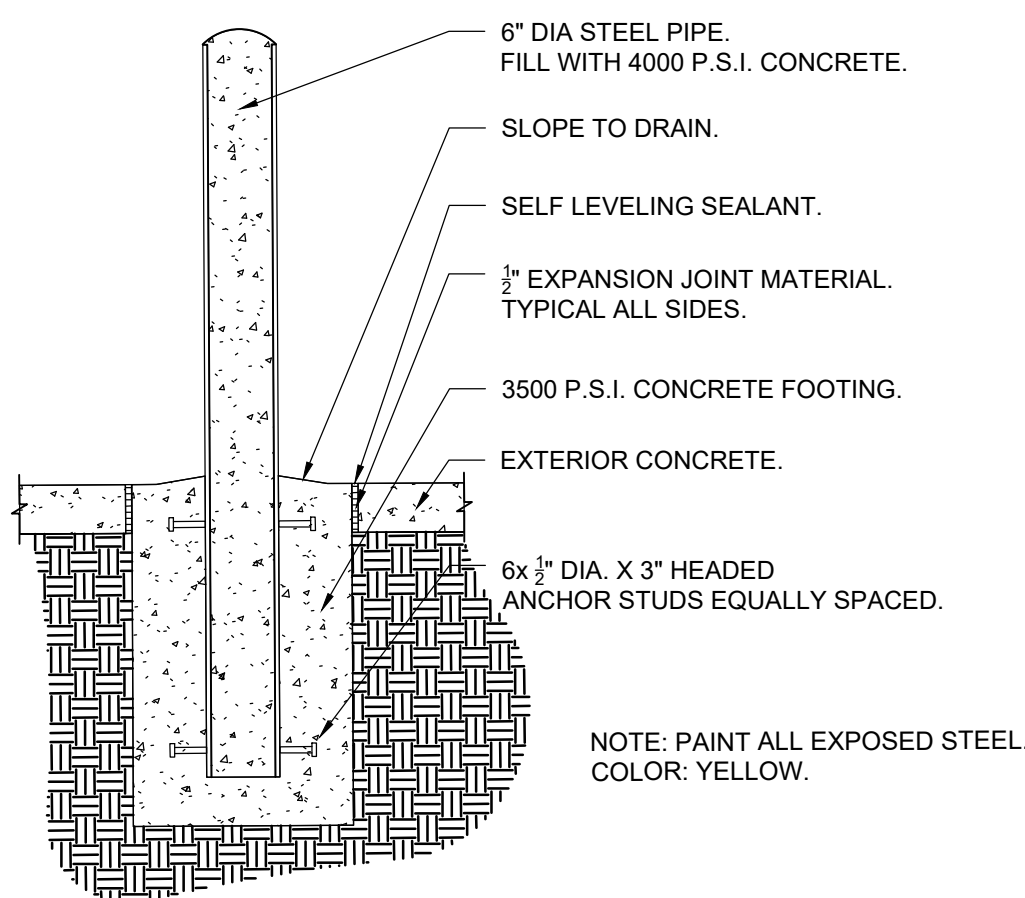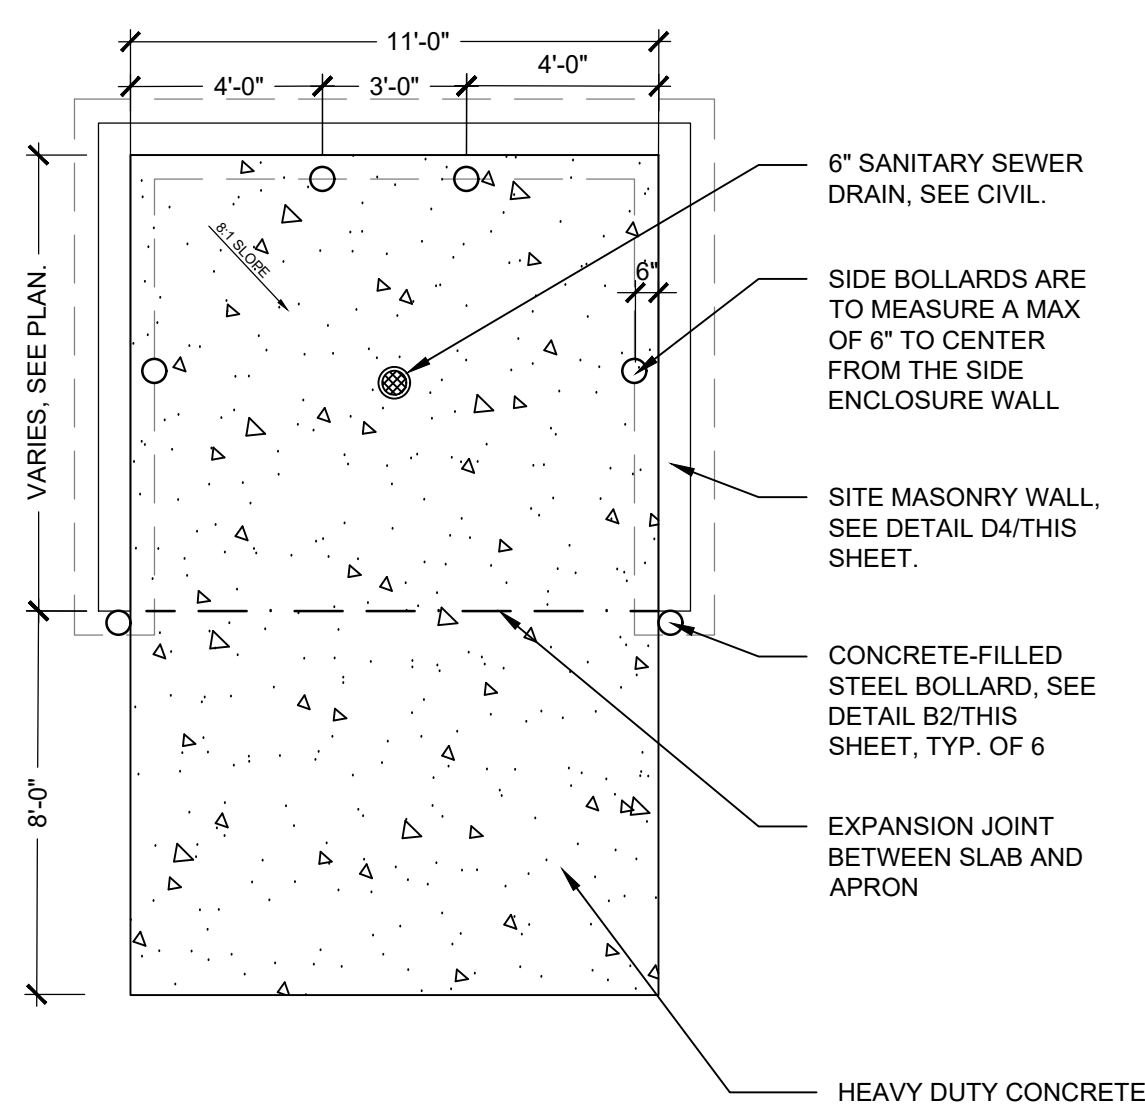D1 TYPE C ACCESSIBLE RAMP
SCALE: N.T.S.**B1 CONCRETE PARKING BUMPER**
SCALE: 3/4" = 1"**B2 CONCRETE FILLED BOLLARD**
SCALE: N.T.S.

GENERAL NOTES

1. SUBGRADE PREP, BACKFILL, AND COMPACTION SHALL BE PER THE GEOTECHNICAL REPORT'S RECOMMENDATION.
2. GROUT ALL REINFORCED CELLS SOLID.
3. GROUT ALL CELLS BELOW GRADE SOLID.
4. APPLY ANTI GRAFFITI COATING AT ALL EXPOSED CMU.
5. COORDINATE COLORS WITH ARCHITECT. COLOR AND FINISH TO BE SELECTED BY ARCHITECT FROM FULL RANGE OF MANUFACTURER'S STANDARD COLORS AND FINISHES.

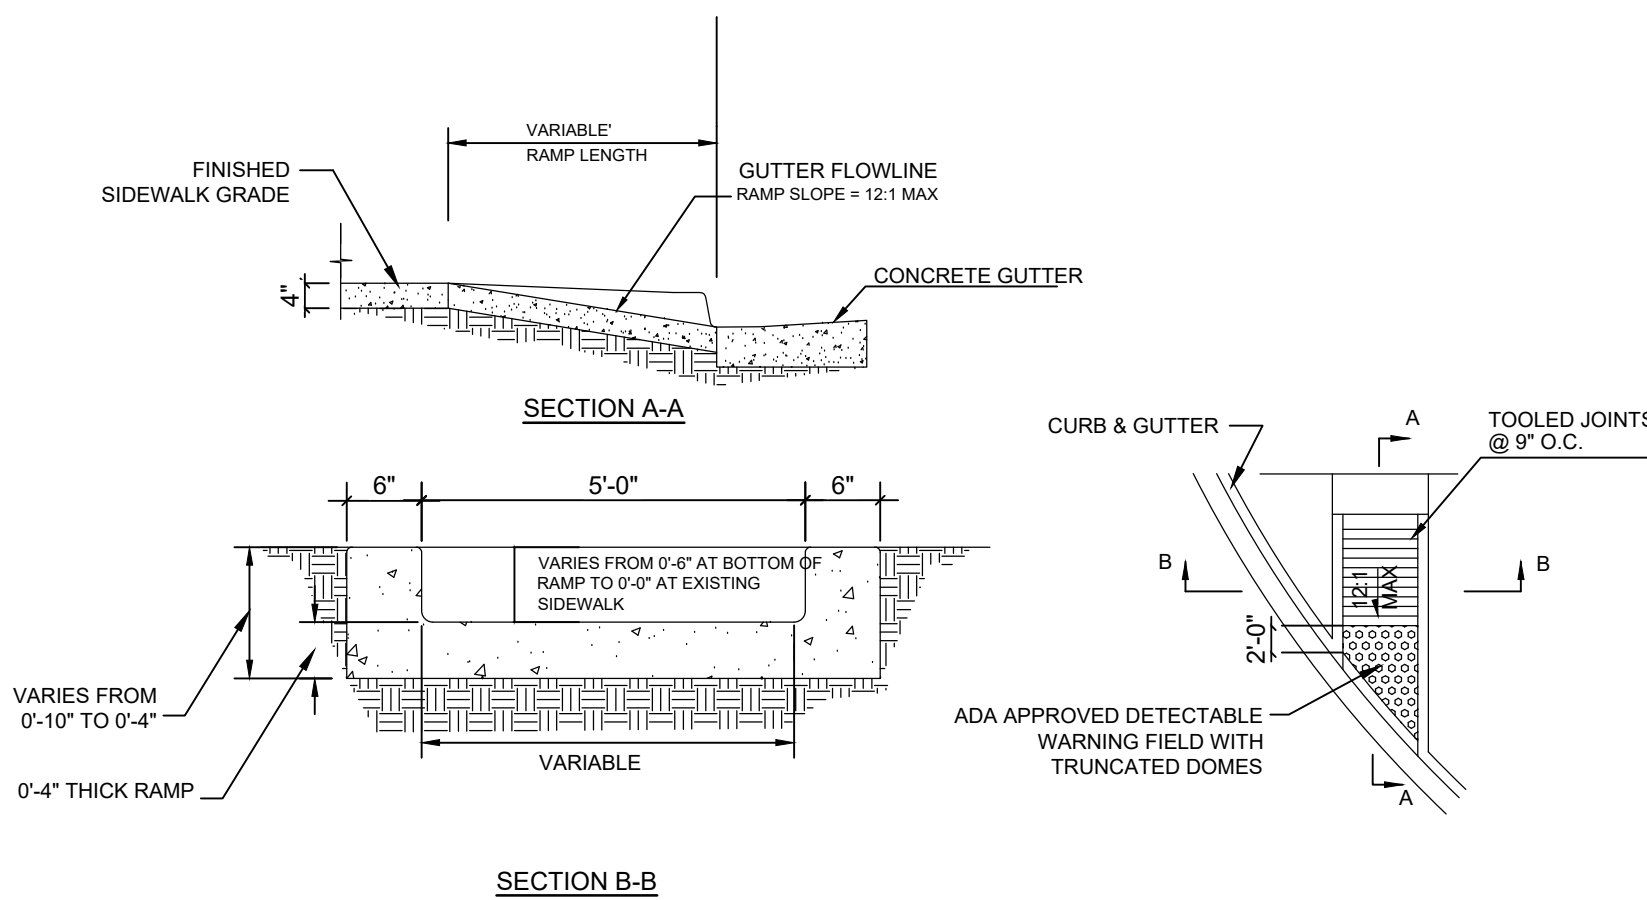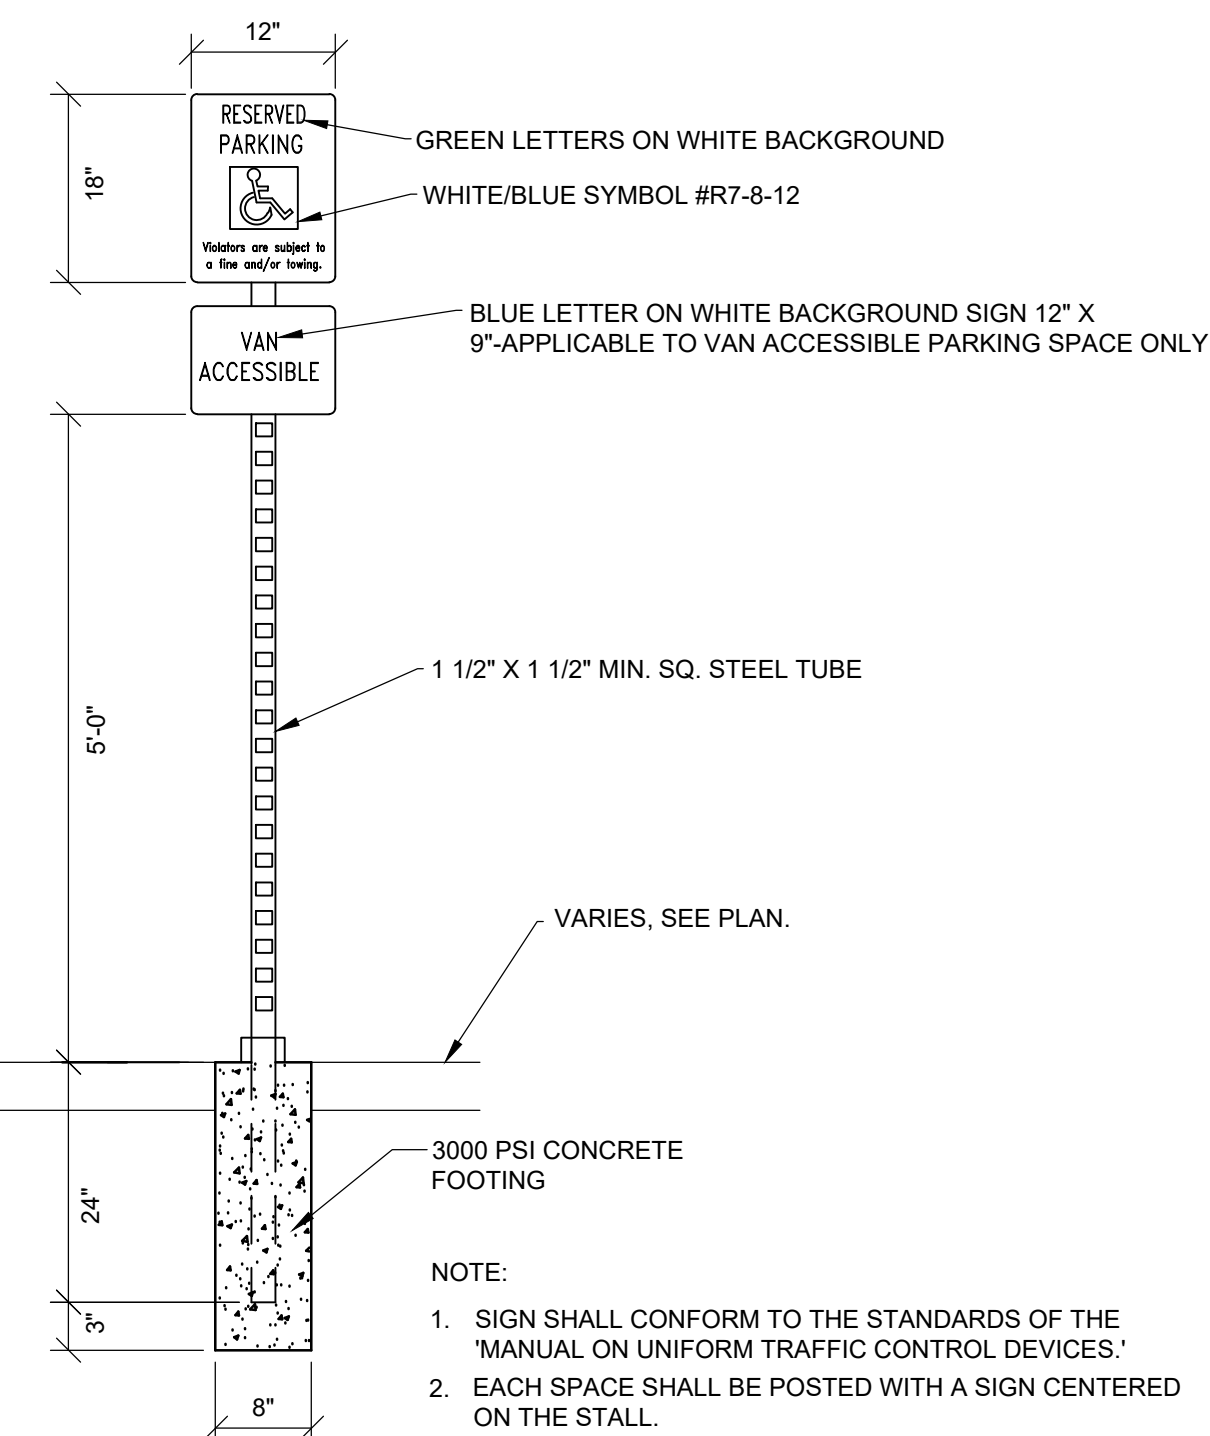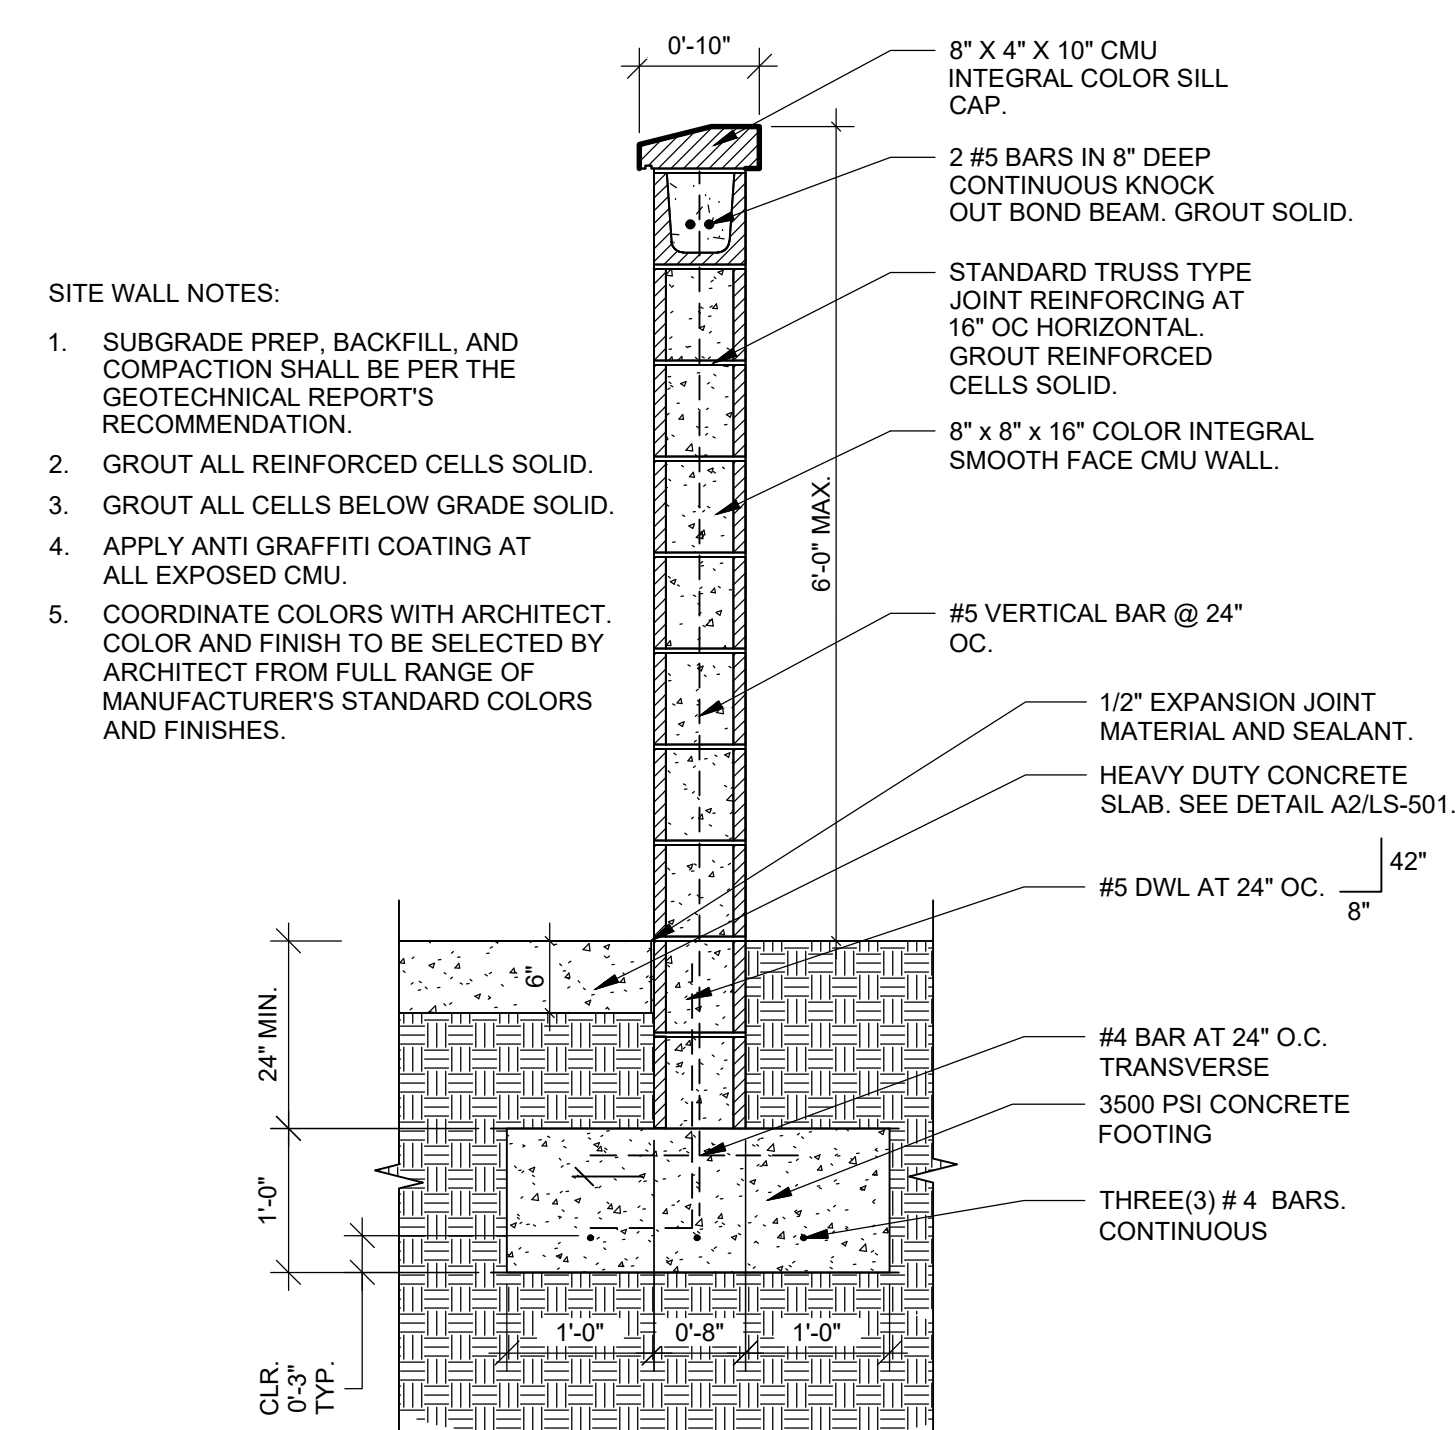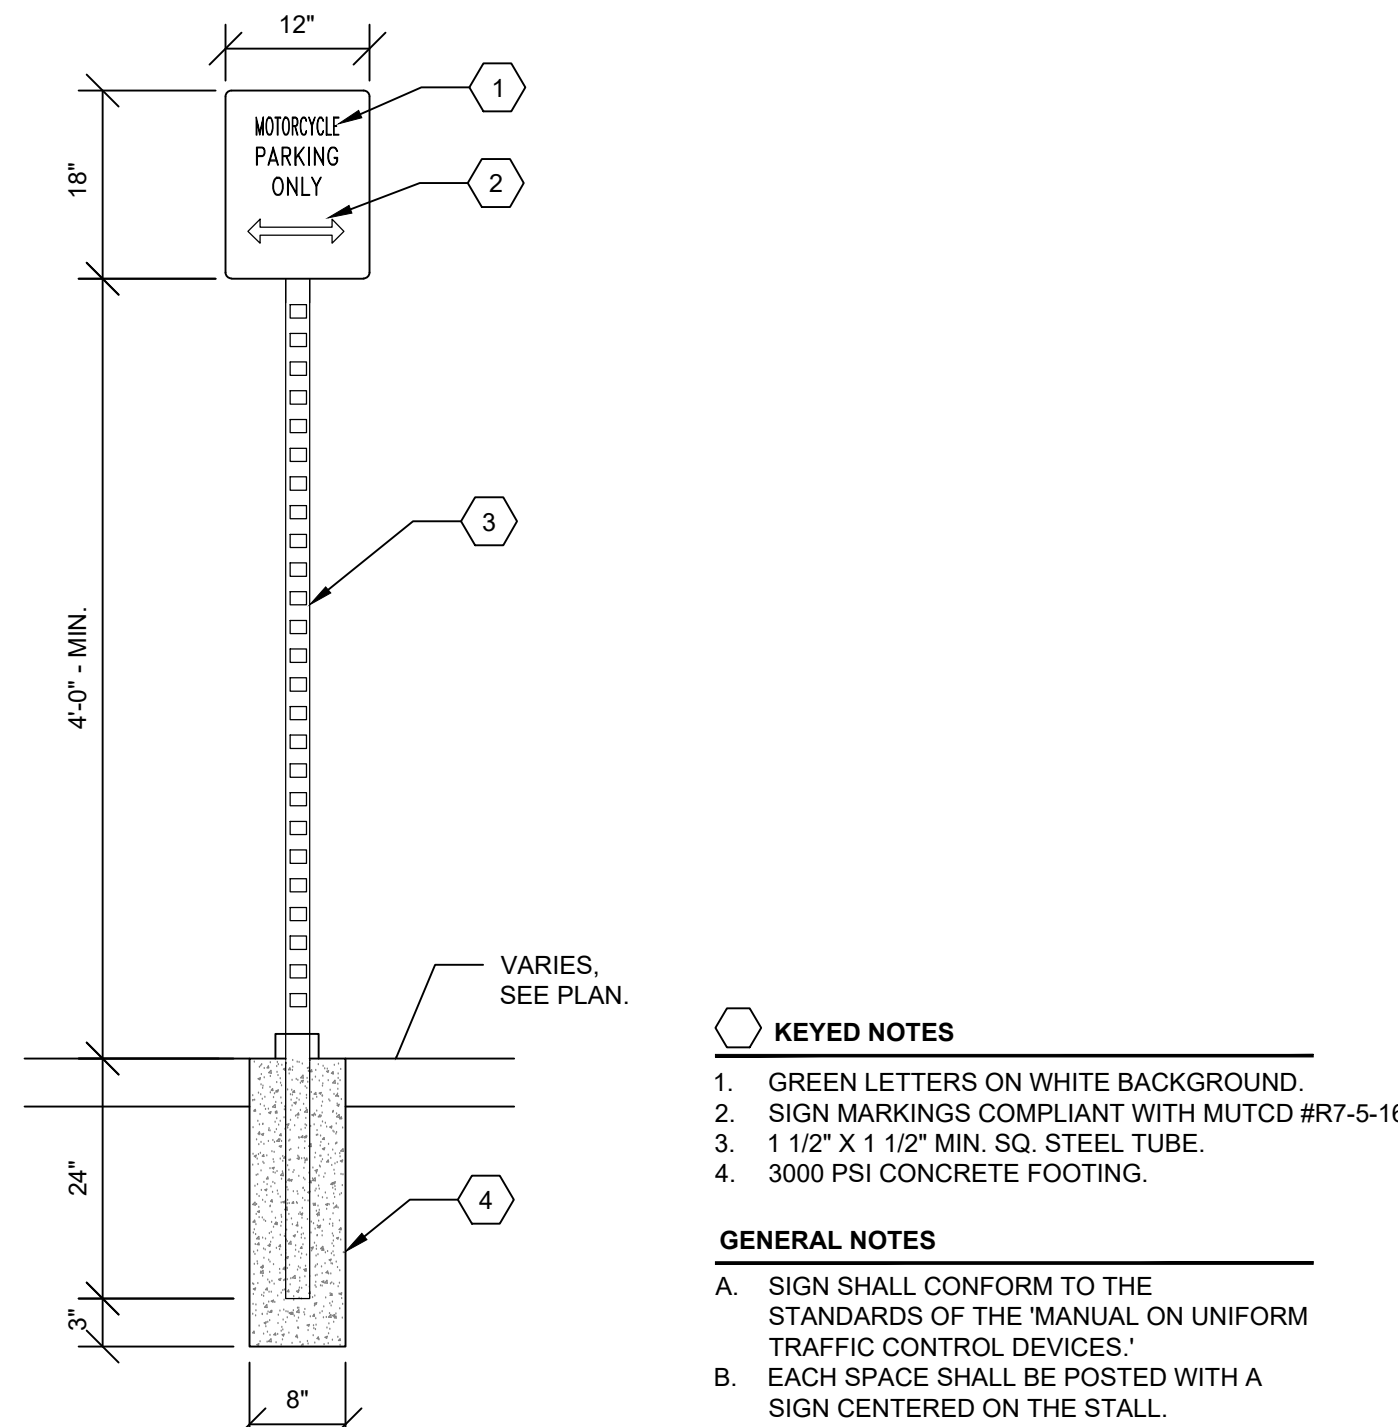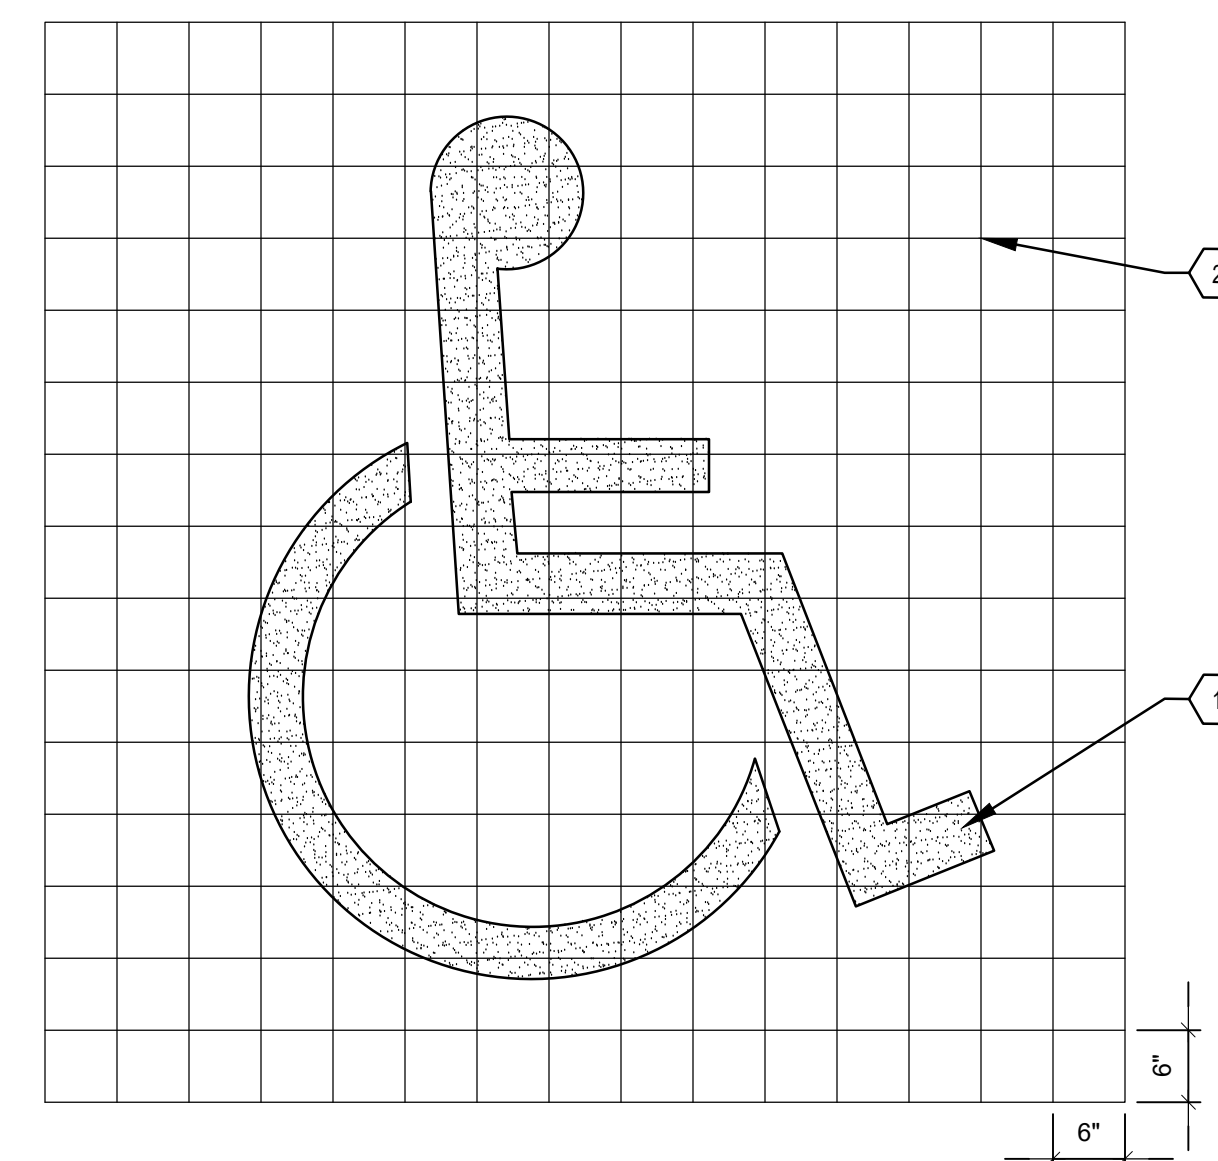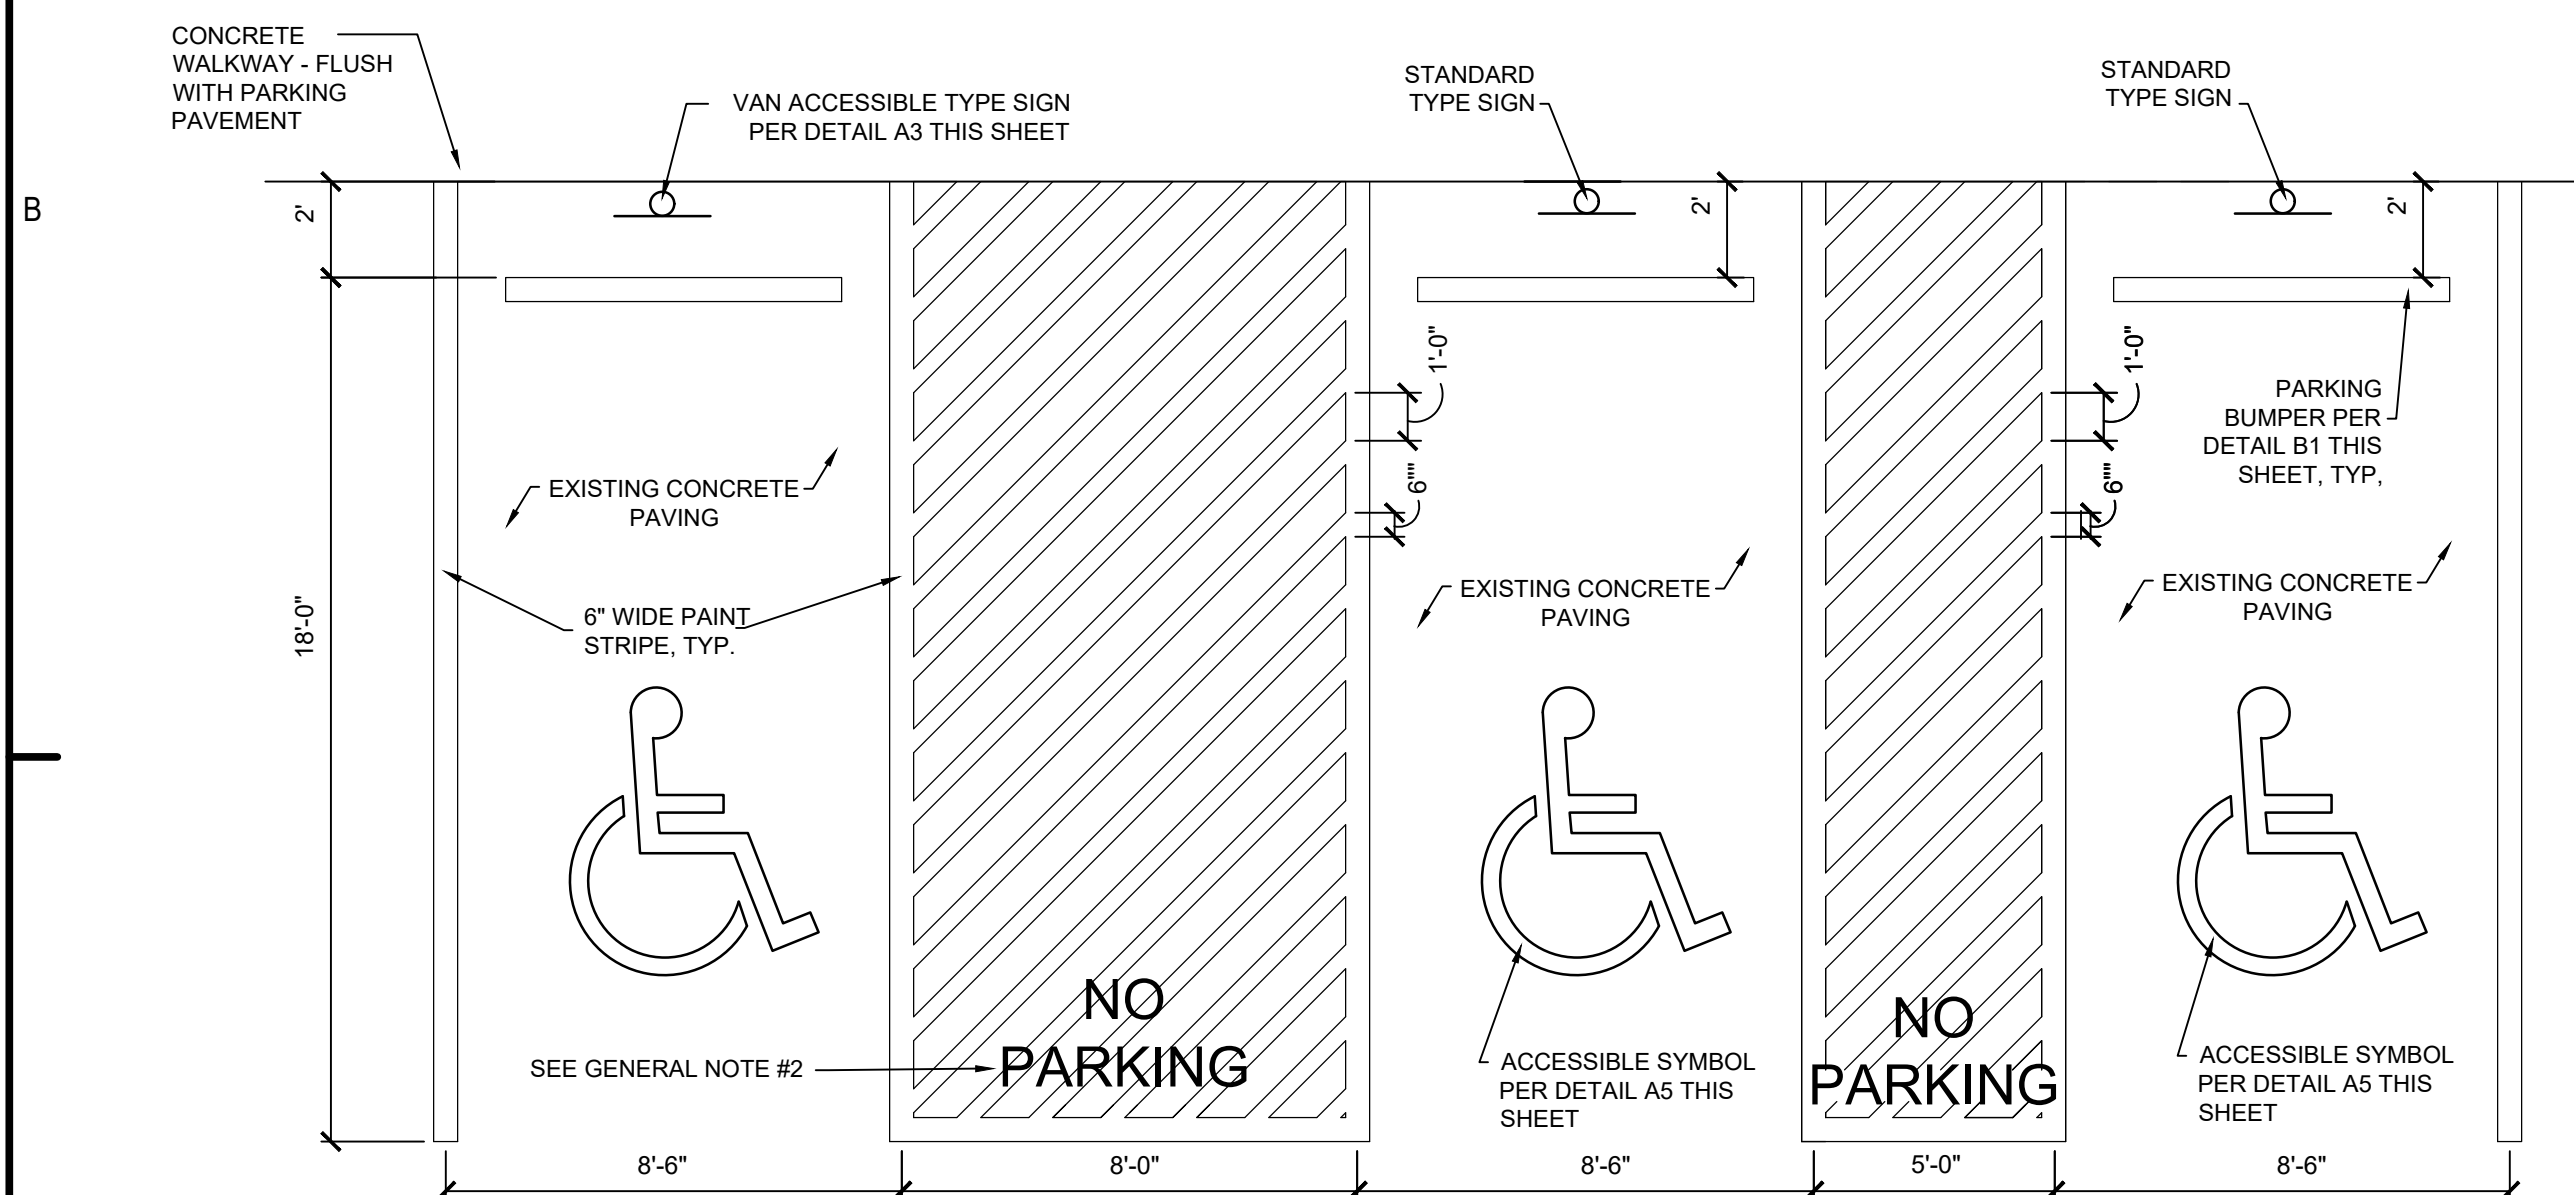D3 SINGLE DUMPSTER ENCLOSURE ENLARGEMENT
SCALE: 1/4" = 1'**B3 TYPE A ACCESSIBLE RAMP**
N.T.S.**A3 ACCESSIBLE PARKING SPACE SIGN**
SCALE: 3/4" = 1'-0"**D5 SITE MASONRY WALL**
SCALE: 3/4" = 1'-0"**B5 MOTORCYCLE PARKING SPACE SIGN**
SCALE: 3/4" = 1'-0"**A5 ACCESSIBLE PARKING SYMBOL STRIPING**
SCALE: 3/4" = 1'**A1 STRIPING DETAIL FOR ADA PARKING**
SCALE: 1/4" = 1'-0"

GENERAL NOTES

1. THE STRIPING AT ADA PARKING STALLS SHALL BE 6" WIDE. THE COLOR SHALL BE BLUE.
2. THE FOLLOWING WORDS SHALL BE PAINTED ON STRIPED ADA ACCESS AISLES AT LOCATION SHOWN IN DETAIL: "NO PARKING". EACH LETTER SHALL BE 1" HIGH BY AT LEAST 2" WIDE BY 1" THICK.

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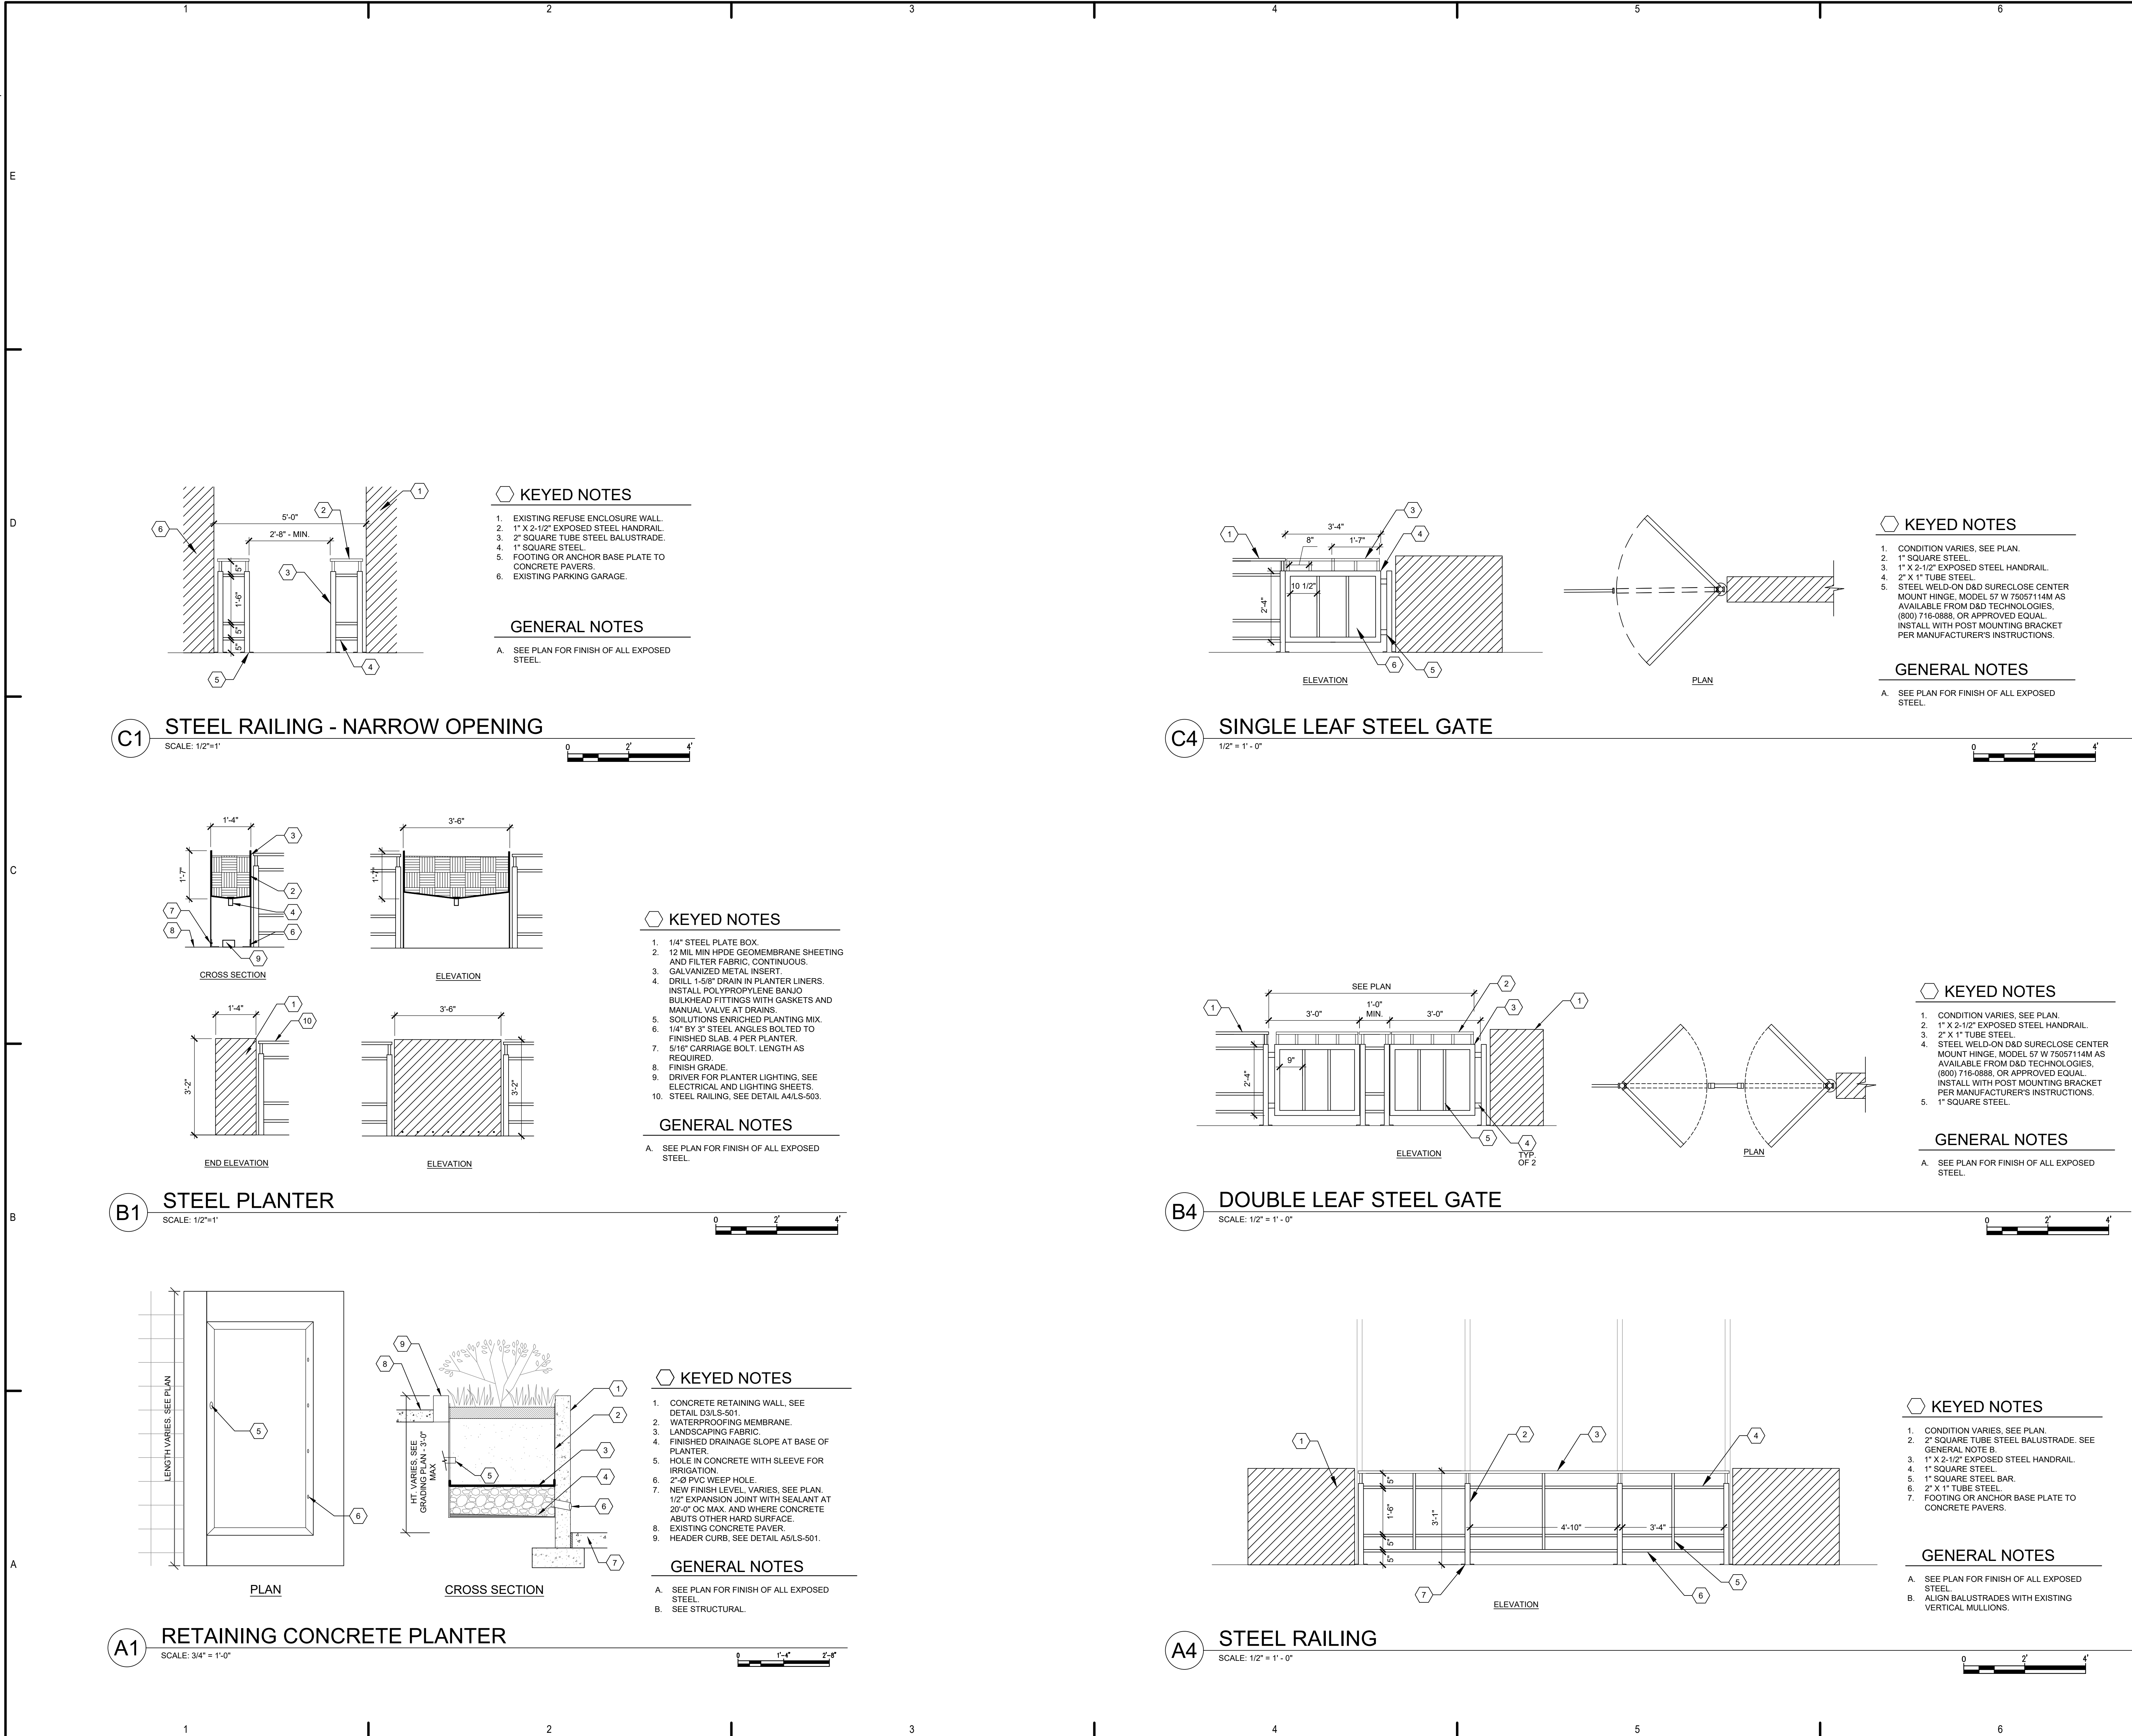
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LS-502

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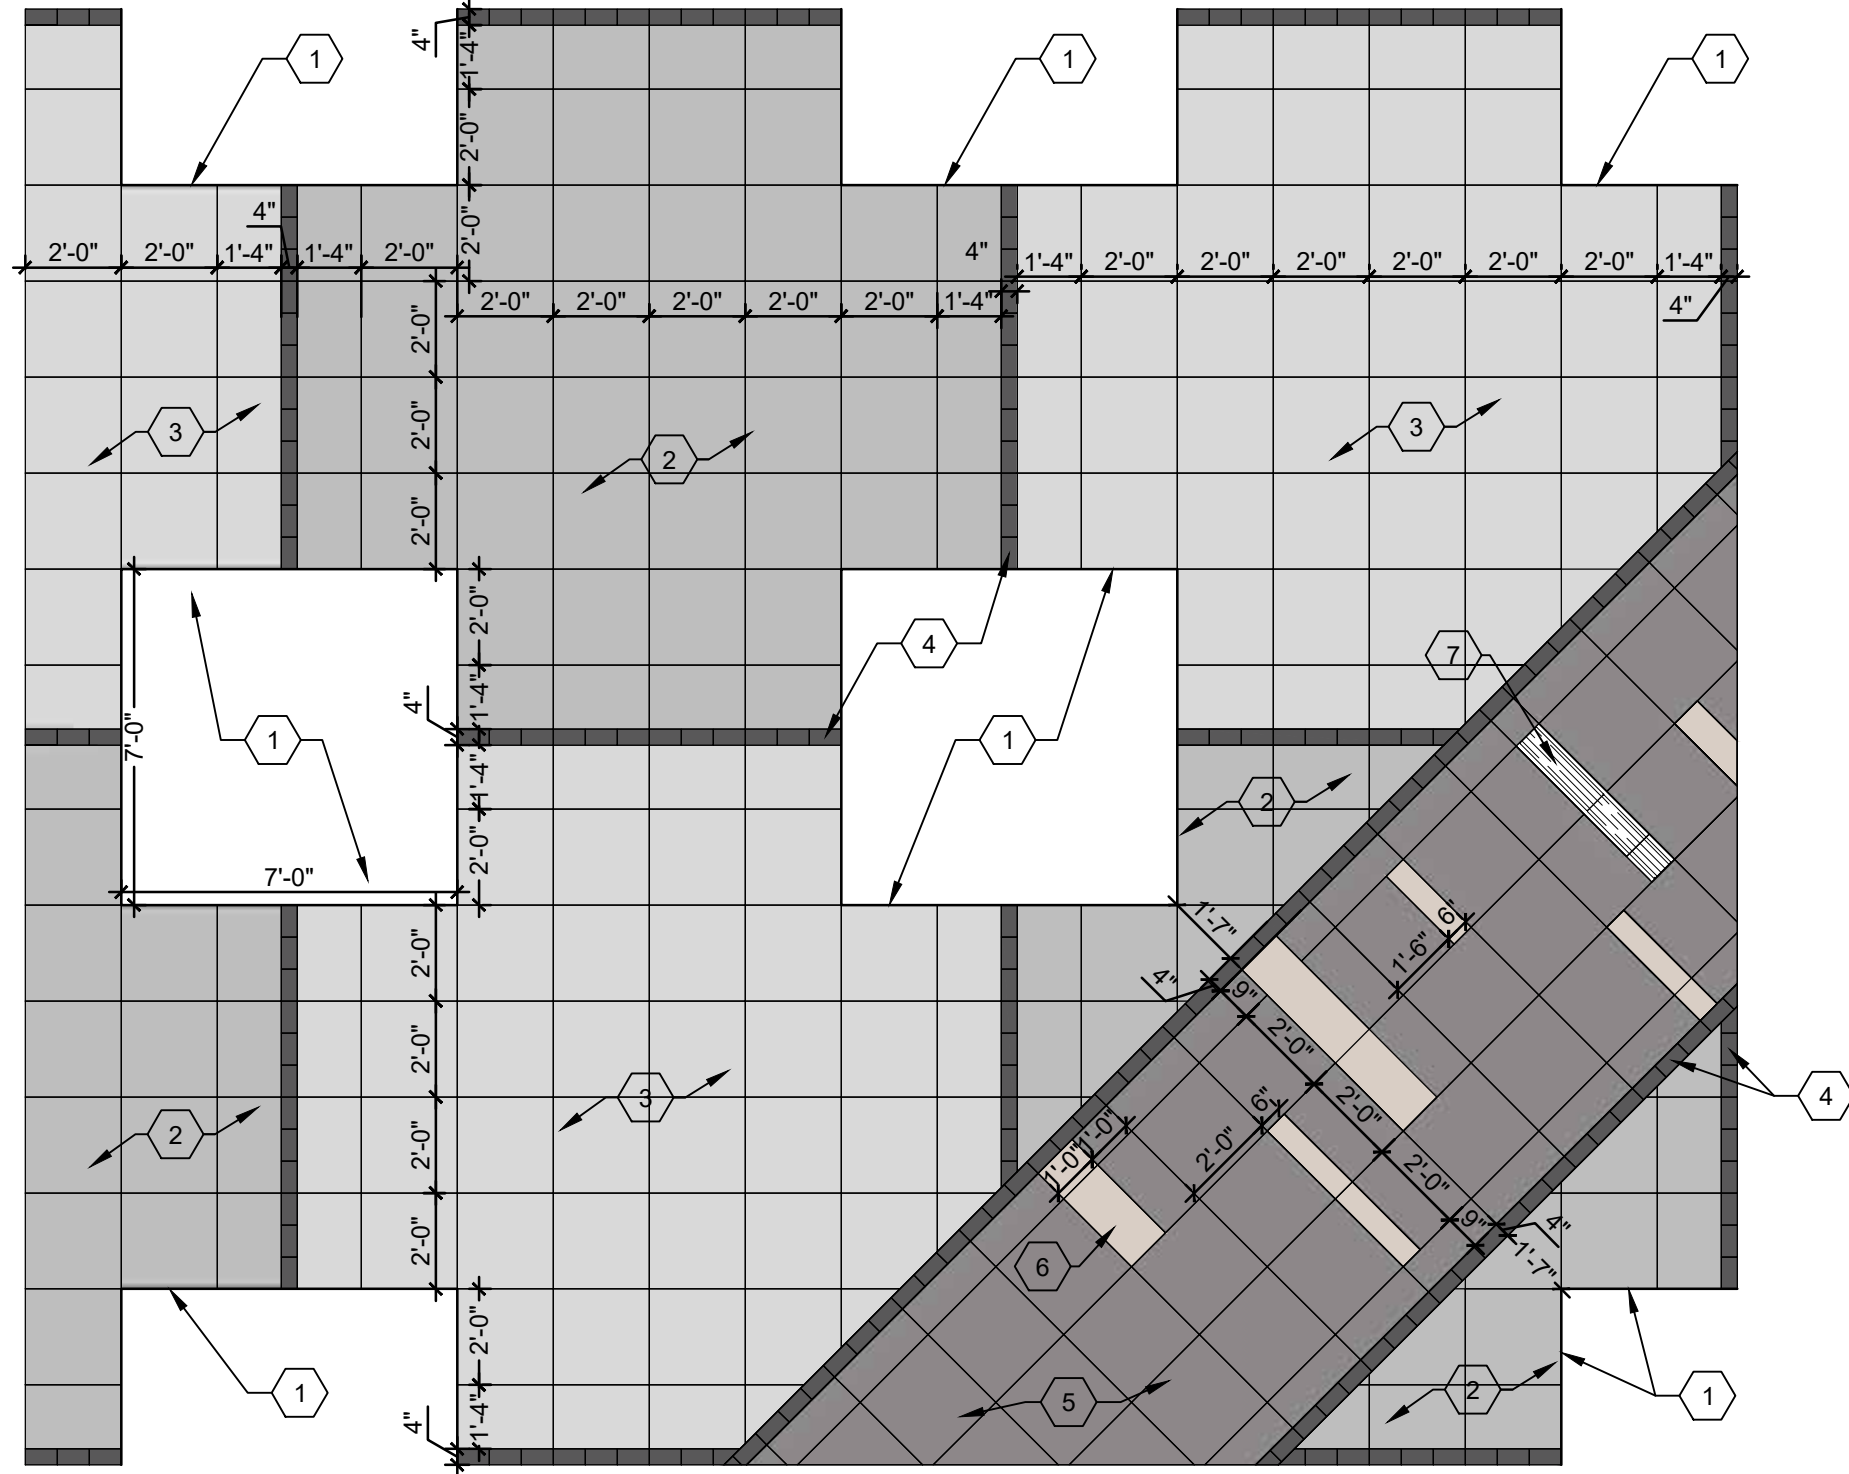
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LS-503

Park Square Plaza Renovation



KEYED NOTES


- EDGE RESTRAINT, SEE PLAN. SEE DETAIL B3/LS-501.
- 'ARCANA' CONCRETE PAVERS BY UNILOCK IN STANDARD COLOR: 'CORVAVA'.
- 'ARCANA' CONCRETE PAVERS BY UNILOCK IN STANDARD COLOR: 'MODENA'.
- 'UMBRANO' CONCRETE PAVERS BY UNILOCK IN STANDARD COLOR: 'MIDNIGHT SKY'.
- 'ARCANA' CONCRETE PAVERS BY UNILOCK IN STANDARD COLOR: 'VIVANTO'.
- 'ARCANA' CONCRETE PAVERS BY UNILOCK, IN STANDARD COLOR: 'AVORIO'.
- TRENCH GRATE, SEE PLAN.

GENERAL NOTES

- SEE SPECIFICATIONS.
- CONTRACTOR SHALL SUBMIT PRODUCT LITERATURE AND COLOR SAMPLES OF PROPOSED PAVERS AND JOINTING SAND FOR ARCHITECT REVIEW AND OWNER APPROVAL.
- CONTRACTOR SHALL SUBMIT SHOP DRAWINGS OF PROPOSED PAVES LAYOUTS FOR ARCHITECT REVIEW AND OWNER APPROVAL.

C1 CONCRETE PAVER LAYOUT 3

SCALE: 1/4" = 1'-0"

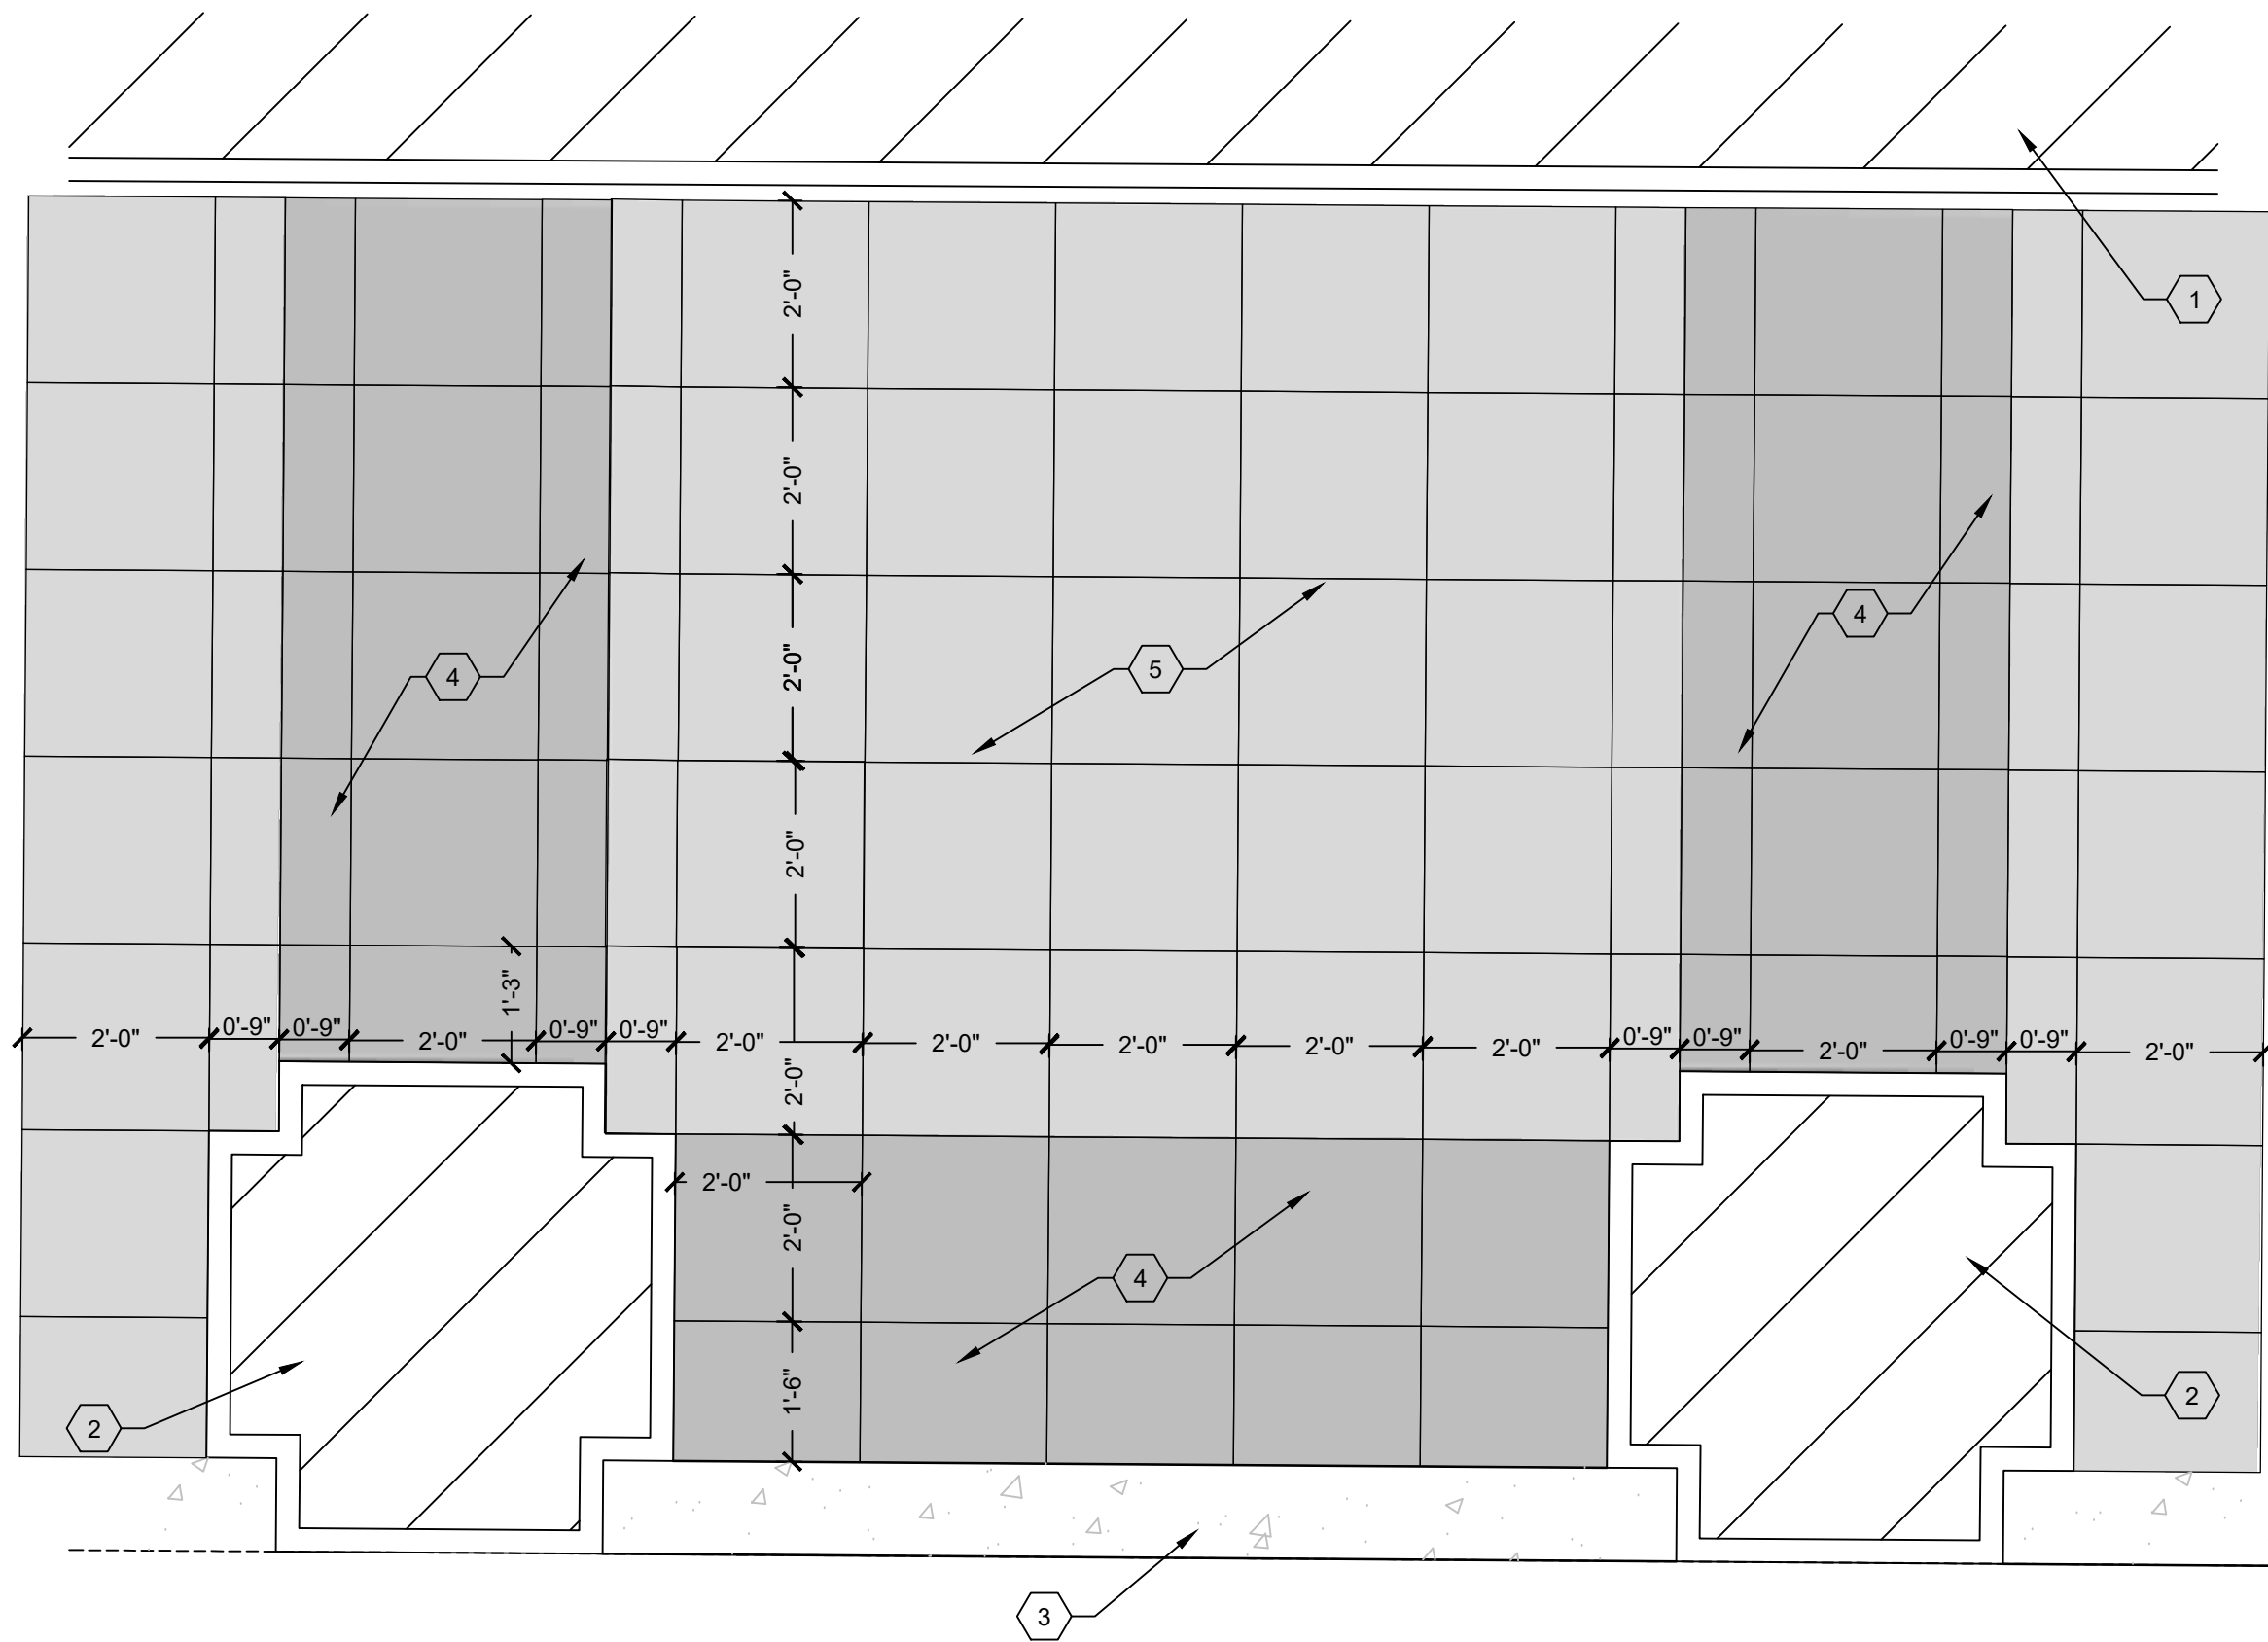

KEYED NOTES



- EXISTING BUILDING. SEE ARCHITECTURAL AND STRUCTURAL DETAILS FOR PAVES INSTALLATION AT BUILDING.
- EXISTING COLUMN. SEE ARCHITECTURAL AND STRUCTURAL DETAILS FOR PAVES INSTALLATION AT BUILDING.
- HEADER CURB, SEE PLAN. SEE DETAIL B5/LS-501.
- 'ARCANA' CONCRETE PAVERS BY UNILOCK IN STANDARD COLOR: 'CORVAVA'.
- 'ARCANA' CONCRETE PAVERS BY UNILOCK, (630) 892-9191, COLOR: 'MODENA'.

GENERAL NOTES

- SEE SPECIFICATIONS.
- CONTRACTOR SHALL SUBMIT PRODUCT LITERATURE AND COLOR SAMPLES OF PROPOSED PAVERS AND JOINTING SAND FOR ARCHITECT REVIEW AND OWNER APPROVAL.
- CONTRACTOR SHALL SUBMIT SHOP DRAWINGS OF PROPOSED PAVES LAYOUTS FOR ARCHITECT REVIEW AND OWNER APPROVAL.

A1 CONCRETE PAVER LAYOUT 1

SCALE: 1/2" = 1'-0"

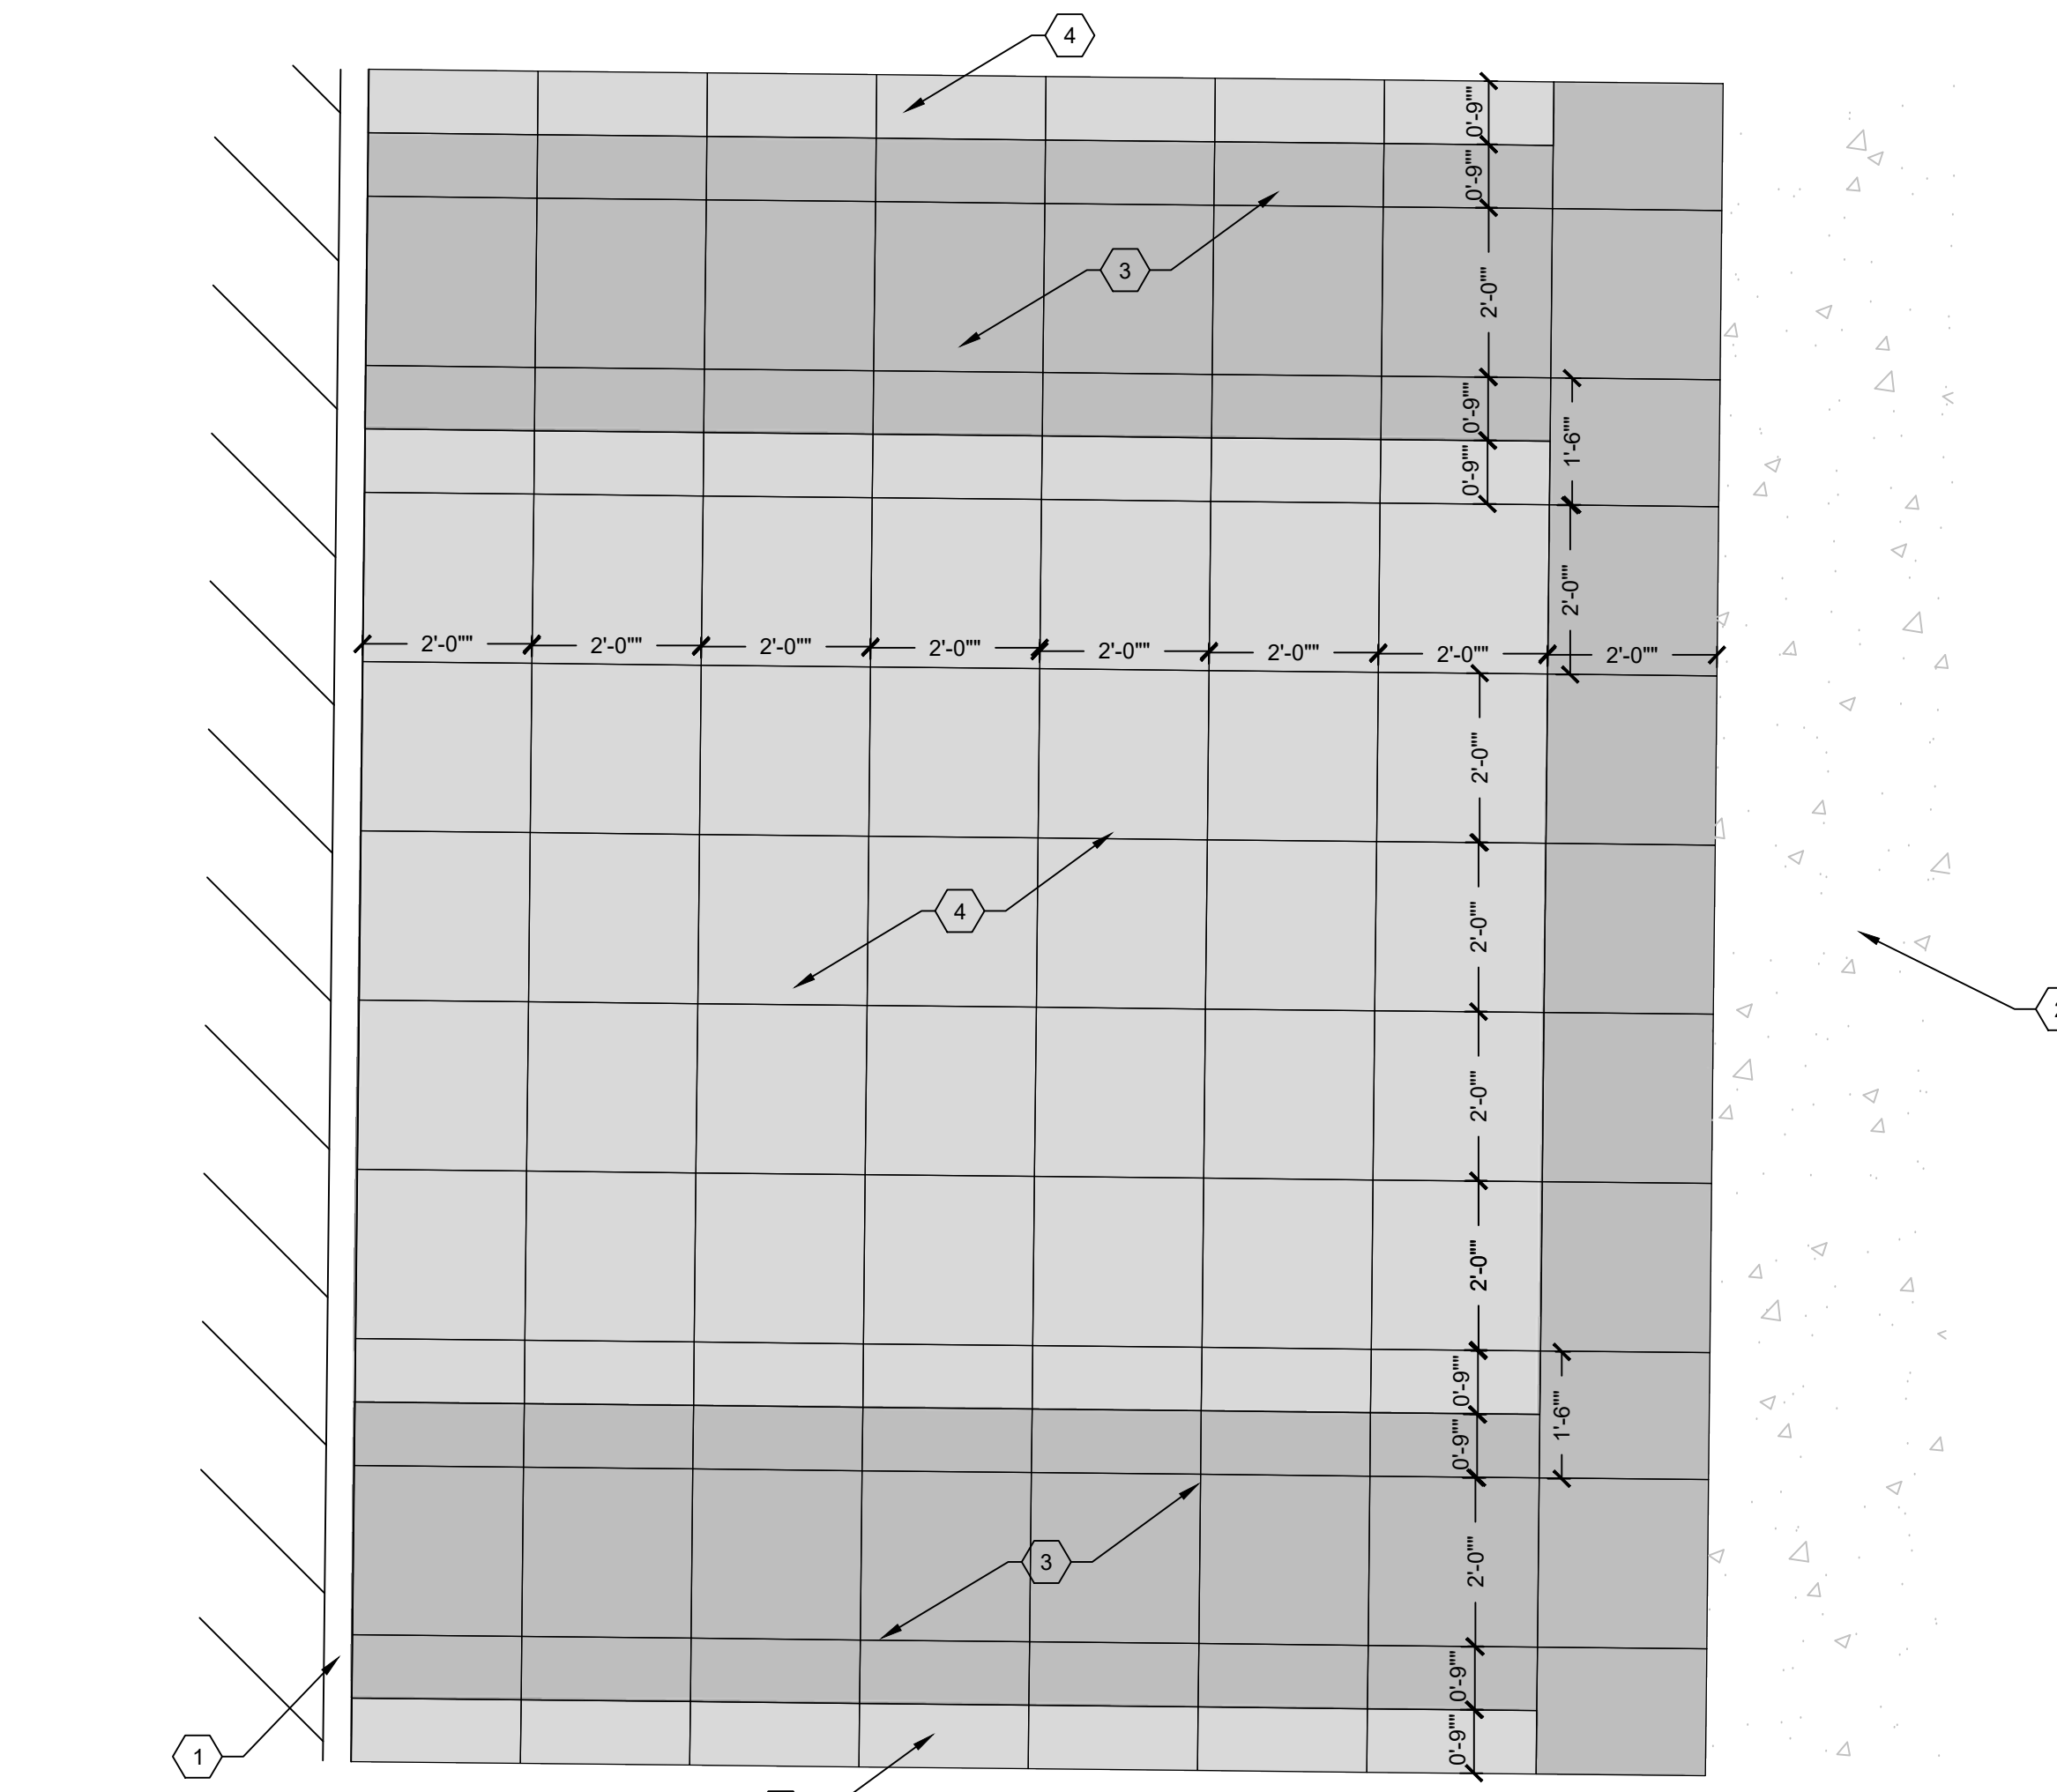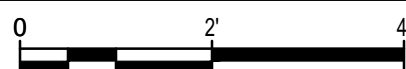

KEYED NOTES


- EXISTING BUILDING. SEE ARCHITECTURAL AND STRUCTURAL DETAILS FOR PAVES INSTALLATION AT BUILDING.
- SIDEWALK, SEE PLAN.
- 'ARCANA' CONCRETE PAVERS BY UNILOCK IN STANDARD COLOR: 'CORVAVA'.
- 'ARCANA' CONCRETE PAVERS BY UNILOCK, (630) 892-9191, COLOR: 'MODENA'.

GENERAL NOTES

- SEE SPECIFICATIONS.
- CONTRACTOR SHALL SUBMIT PRODUCT LITERATURE AND COLOR SAMPLES OF PROPOSED PAVERS AND JOINTING SAND FOR ARCHITECT REVIEW AND OWNER APPROVAL.
- CONTRACTOR SHALL SUBMIT SHOP DRAWINGS OF PROPOSED PAVES LAYOUTS FOR ARCHITECT REVIEW AND OWNER APPROVAL.

A3 CONCRETE PAVER LAYOUT 2

SCALE: 1/2" = 1'-0"

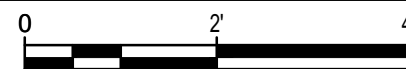

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LANDSCAPE ARCHITECT

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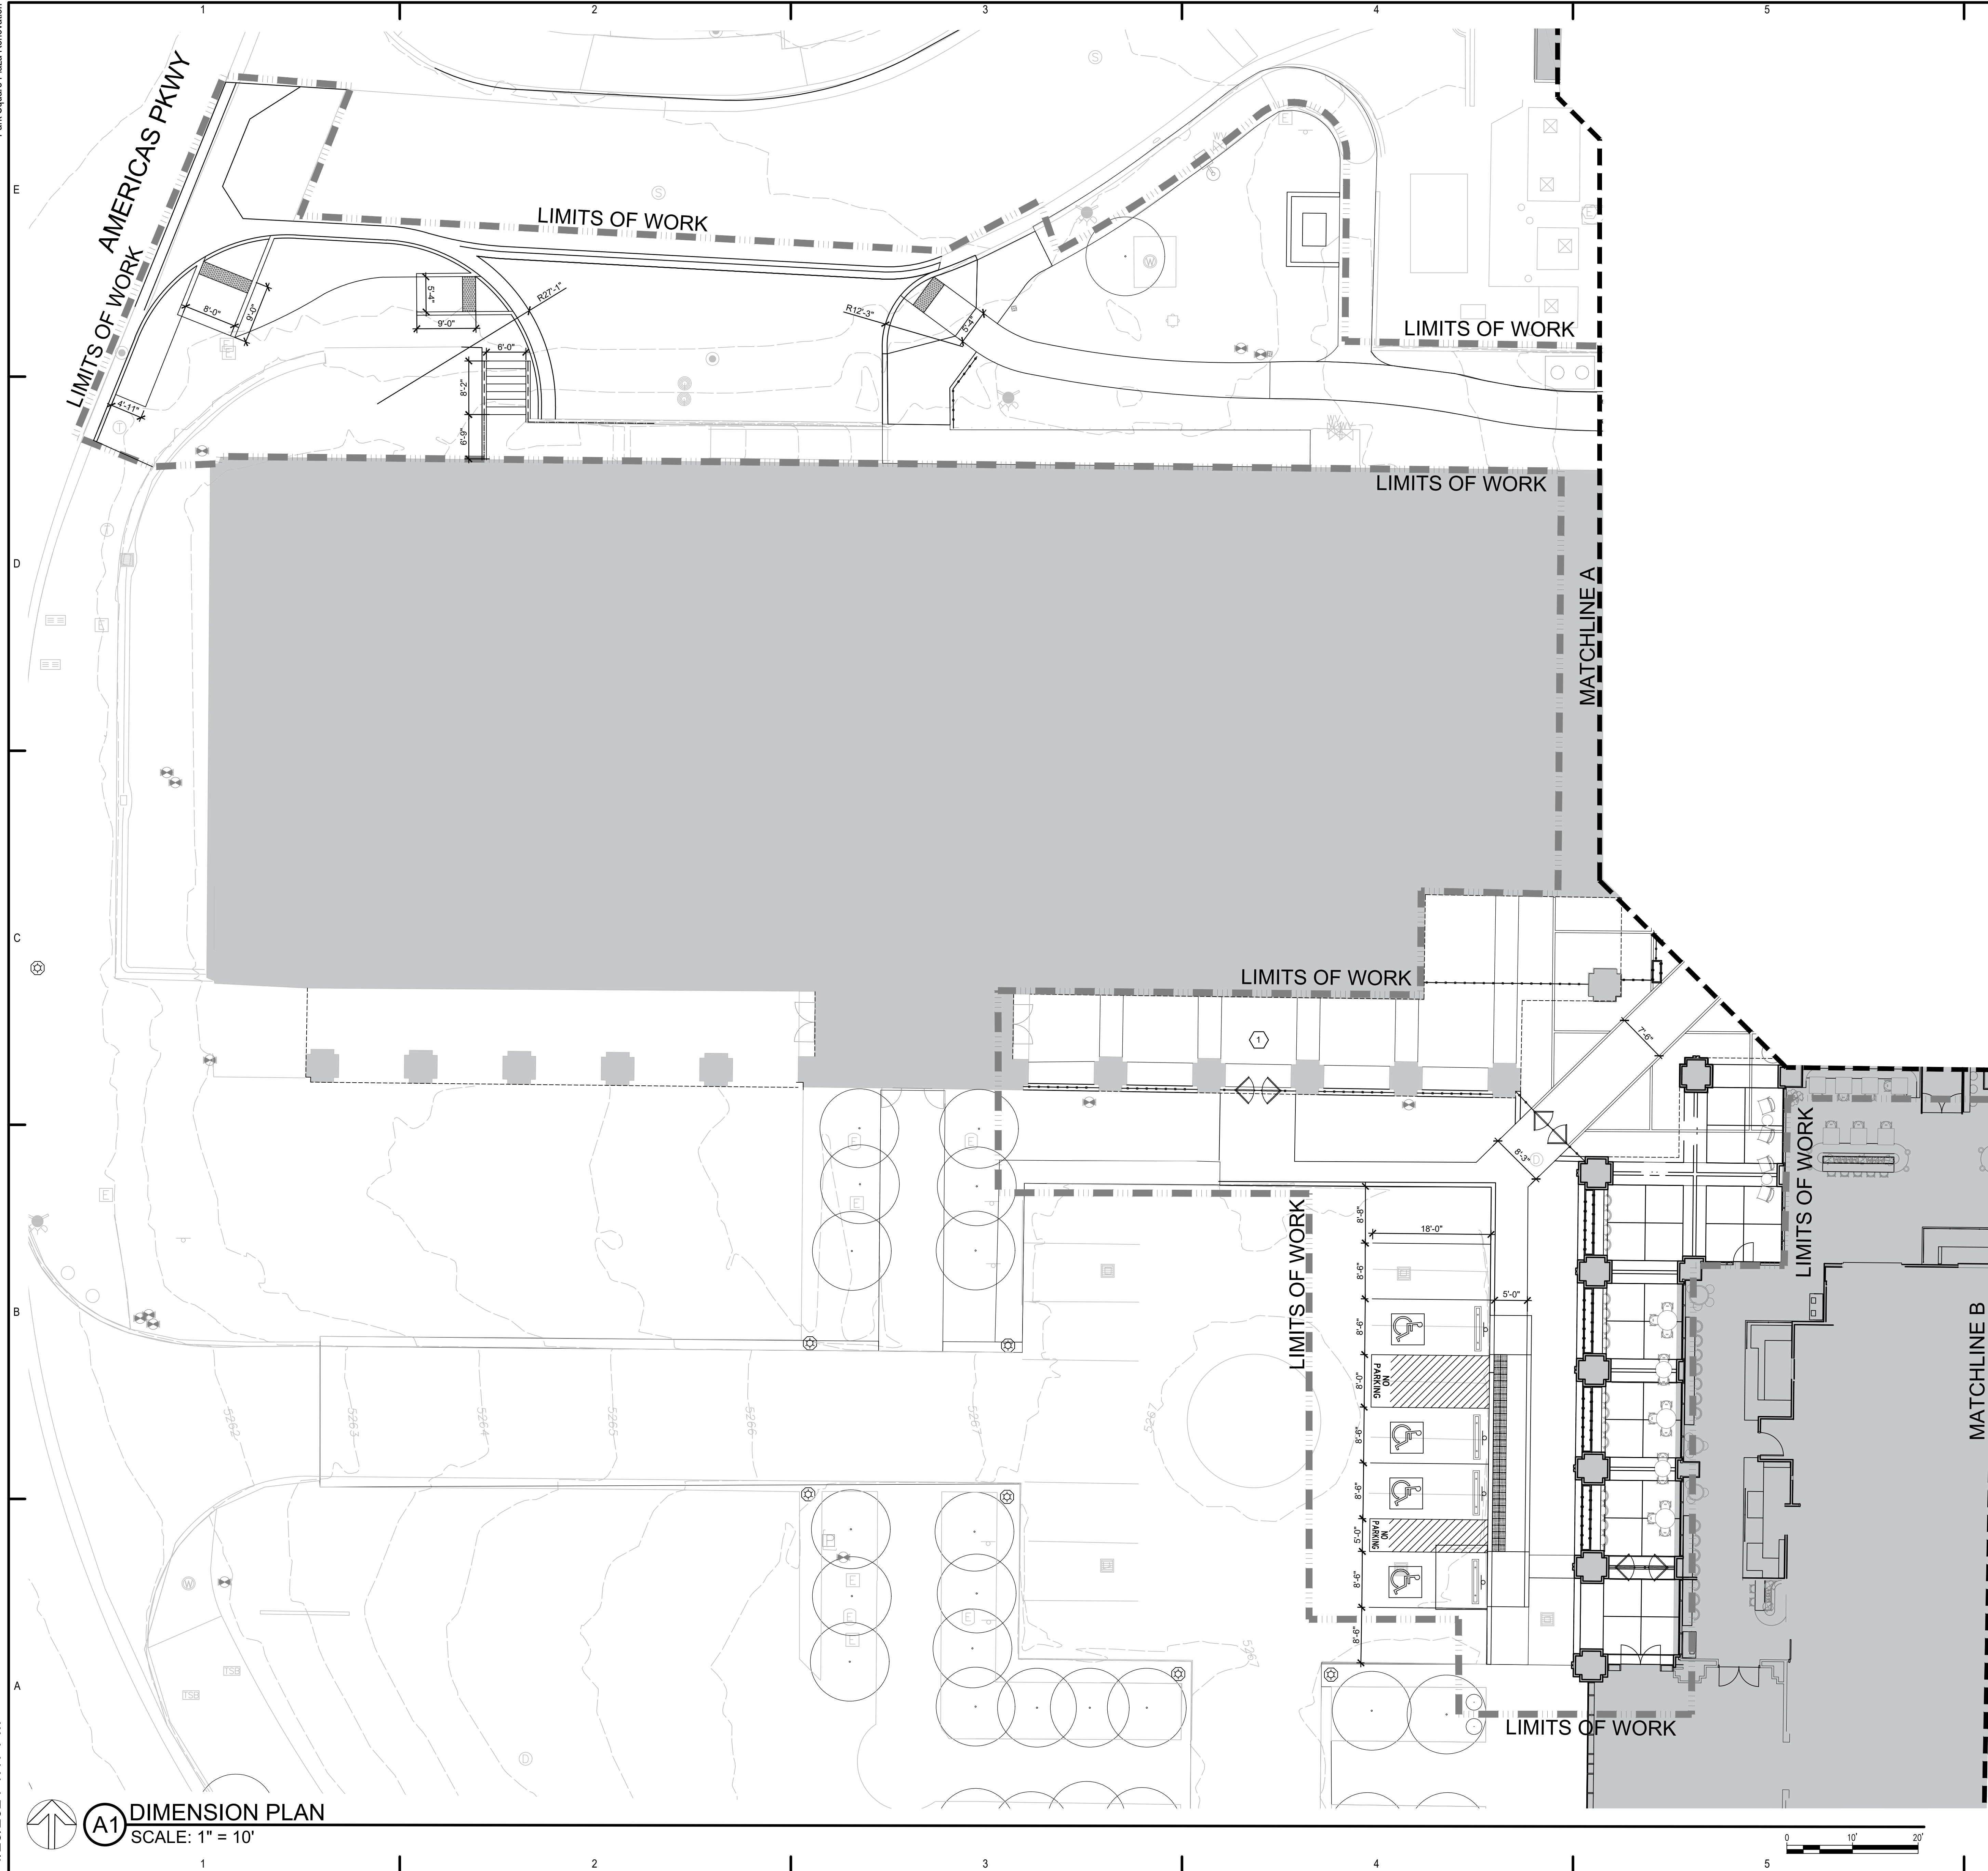
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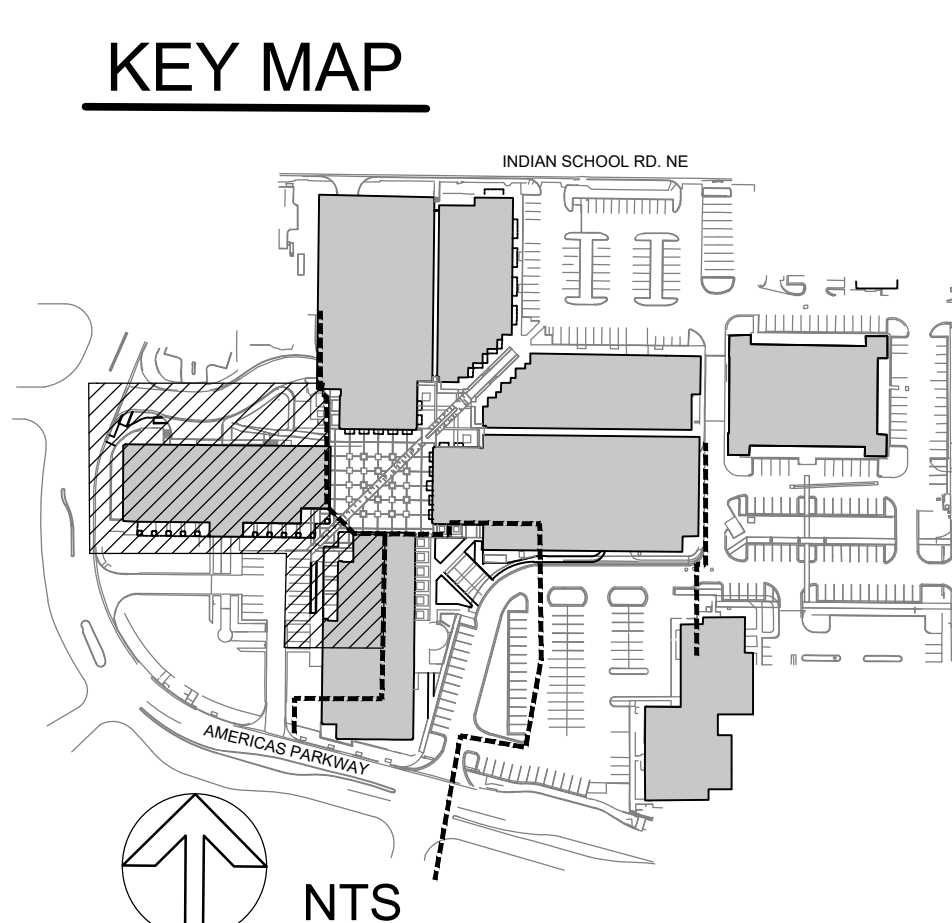
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LS-504

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- DIMENSION KEYED NOTES**
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 2. CONCRETE PAVER LAYOUT 2. SEE DETAIL A3/L.S-504.
 3. CONCRETE PAVER LAYOUT 3. SEE DETAIL C1/L.S-504.



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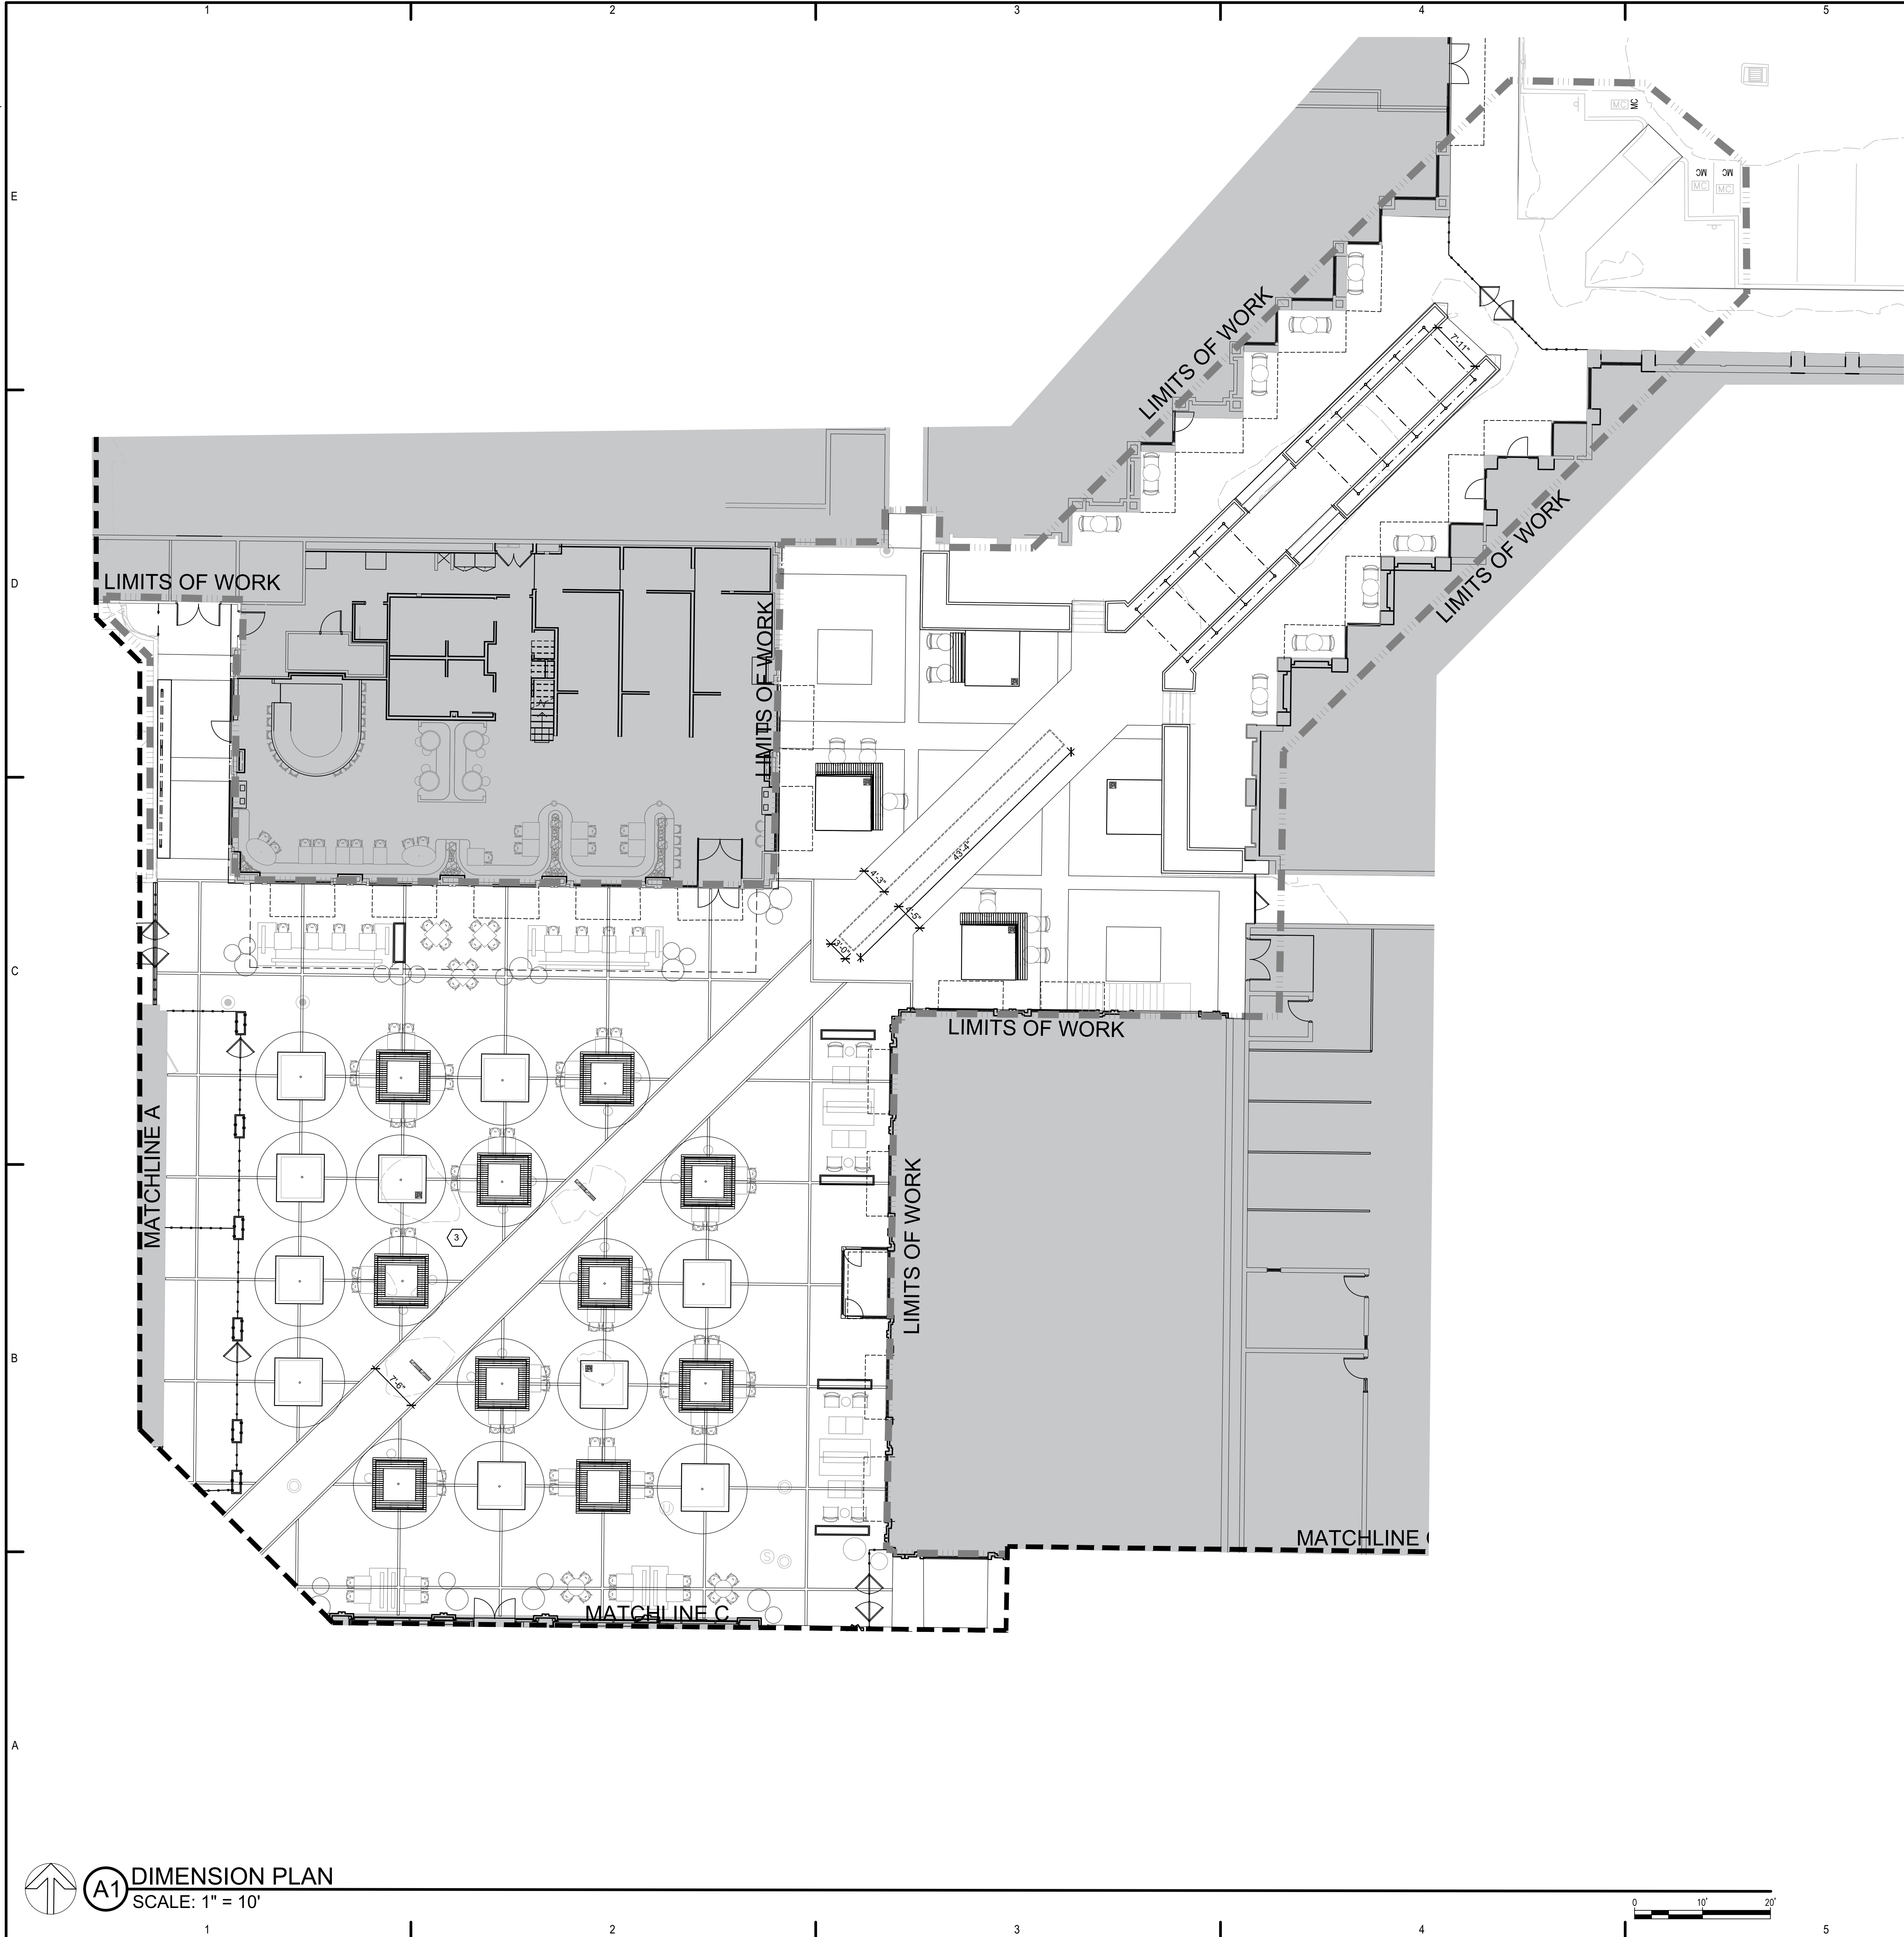
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LK-101

Park Square Plaza Renovation


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- DIMENSION KEYED NOTES**
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 2. CONCRETE PAVER LAYOUT 2. SEE DETAIL A3/L.S-504.
 3. CONCRETE PAVER LAYOUT 3. SEE DETAIL C1/L.S-504.

KEY MAP



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SHEET TITLE

DIMENSION PLAN

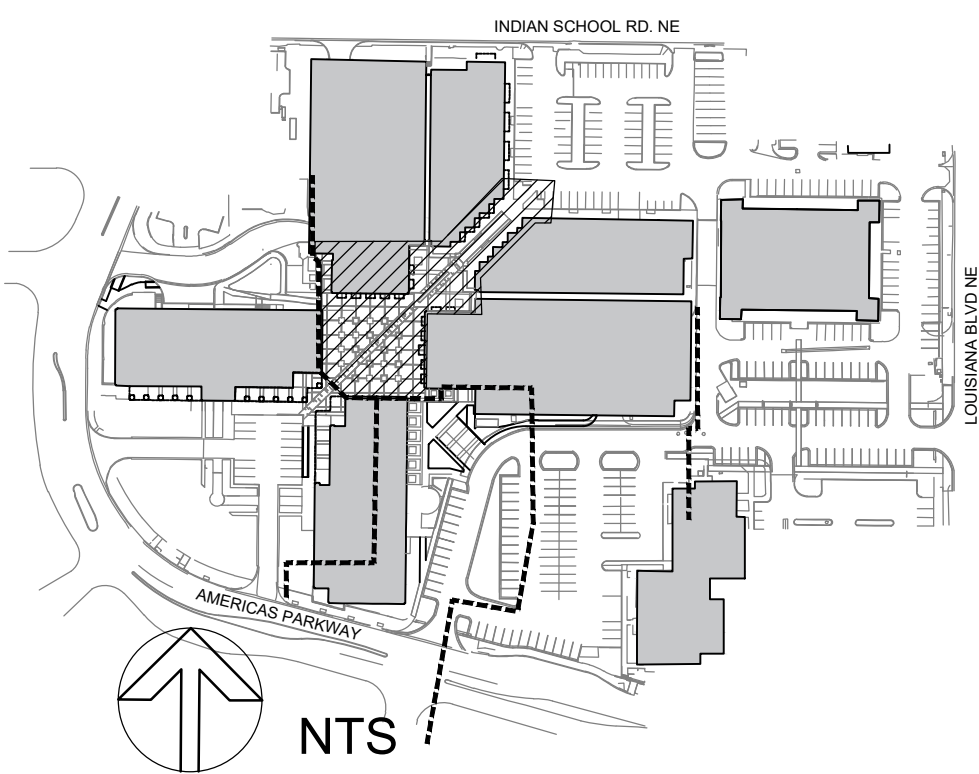LK-102

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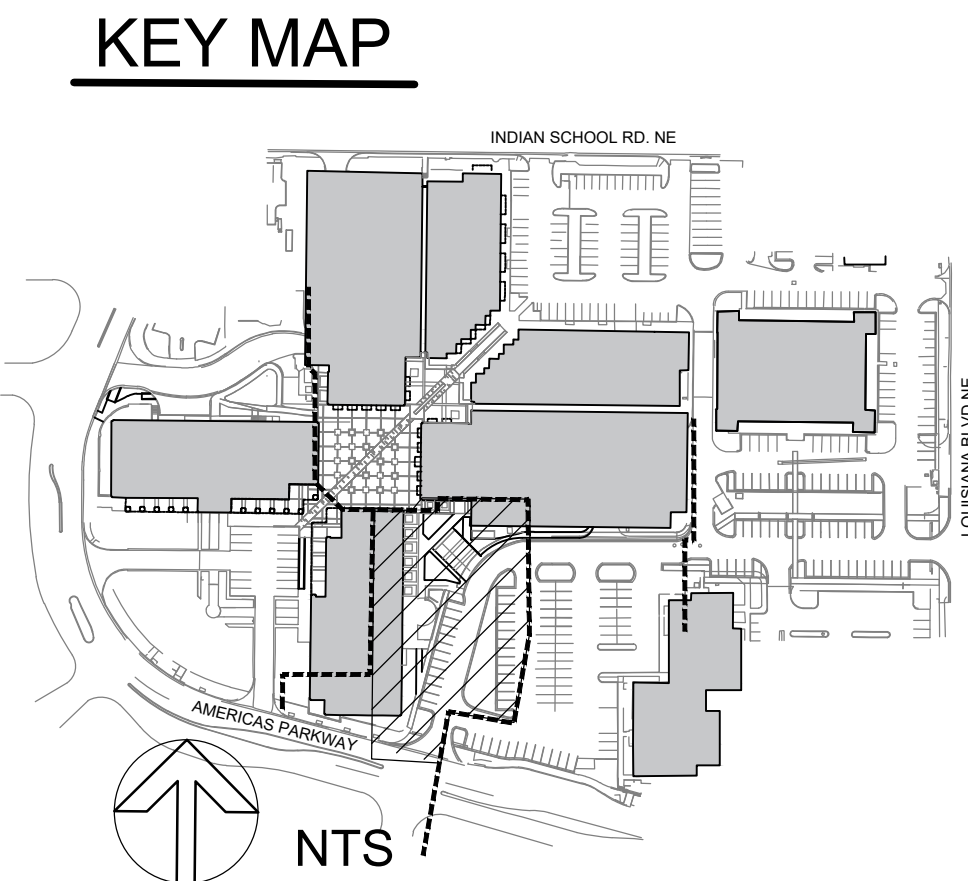
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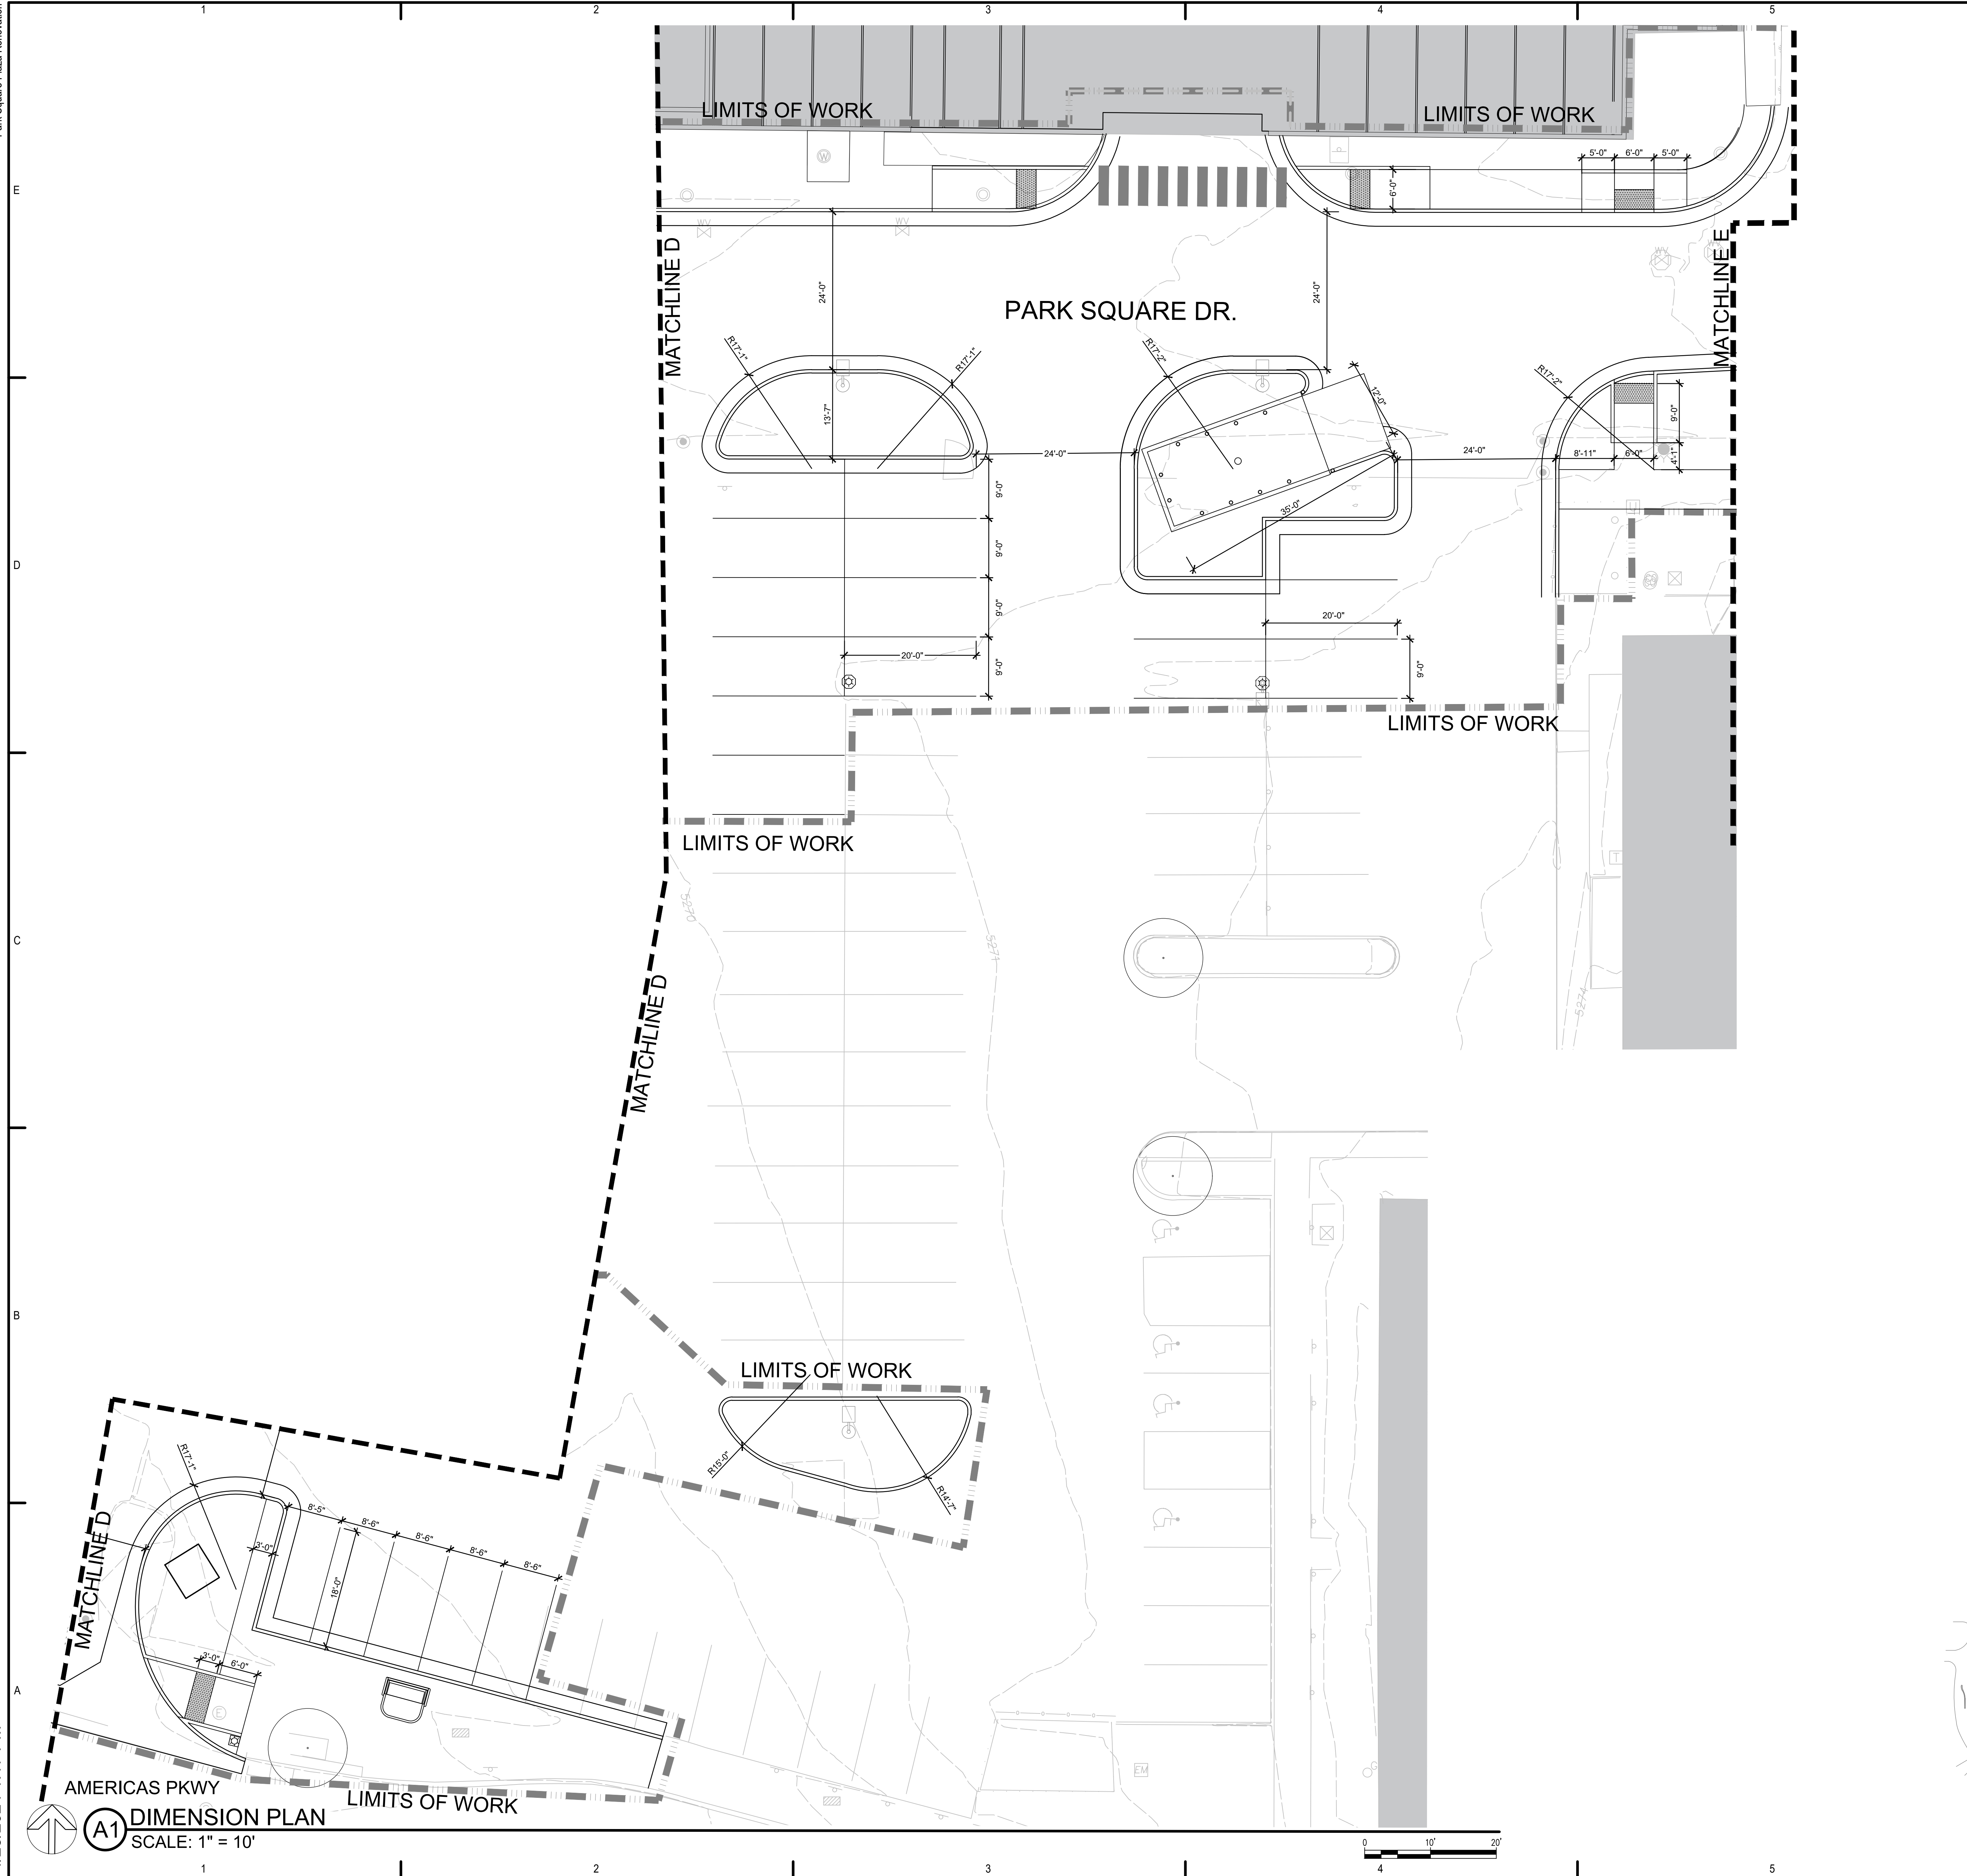
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LK-103




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- DIMENSION KEYED NOTES**
1. CONCRETE PAVER LAYOUT 1. SEE DETAIL A1/L/S-504.
 2. CONCRETE PAVER LAYOUT 2. SEE DETAIL A3/L/S-504.
 3. CONCRETE PAVER LAYOUT 3. SEE DETAIL C1/L/S-504.

KEY MAP



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| DRAWN BY: | TW/WM |
| CHECKED BY: | WM |

SHEET TITLE

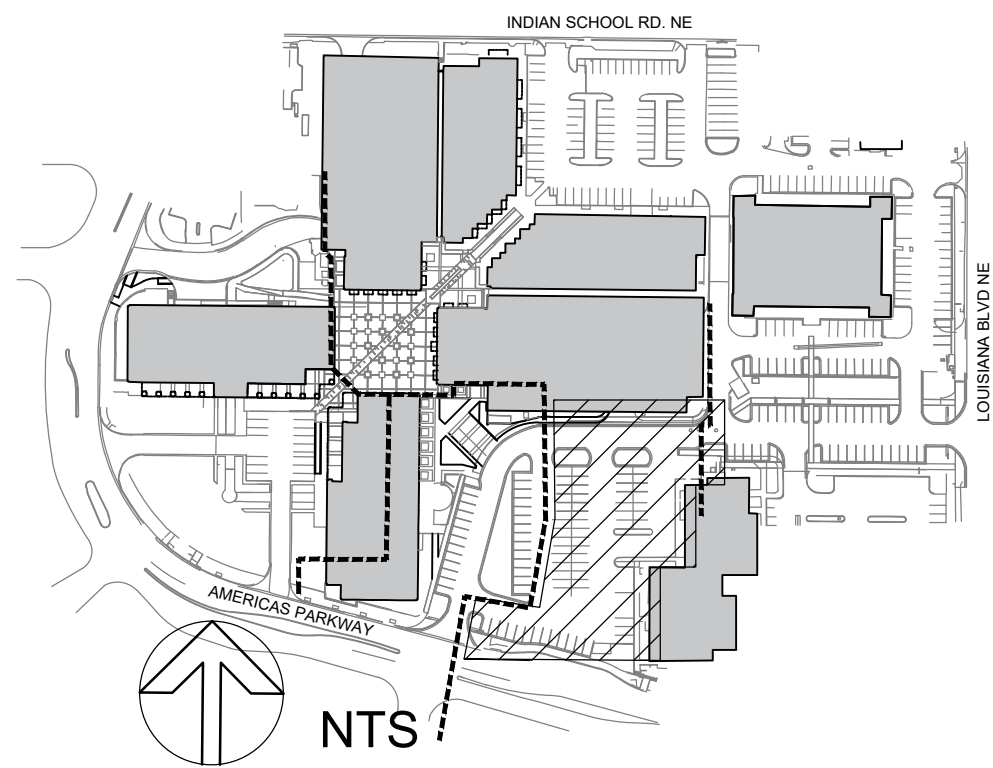DIMENSION PLAN

LK-104

Park Square Plaza Renovation

CONSULTANTS

LANDSCAPE ARCHITECT

Groundwork Studio
6501 Americas Pkwy NE, Ste. 350
Albuquerque, NM 87110
p_505.212.9126

CIVIL ENGINEER

6501 Americas Pkwy NE, Ste. 400
Albuquerque, NM 87110
p. 505.830.8753

LIGHTING

1900 Wazee Street #205
Denver, CO 80202
p_303.296.3034



6565 AMERICAS PKWY
ALBUQUERQUE, NM 87110

APRIL 2024


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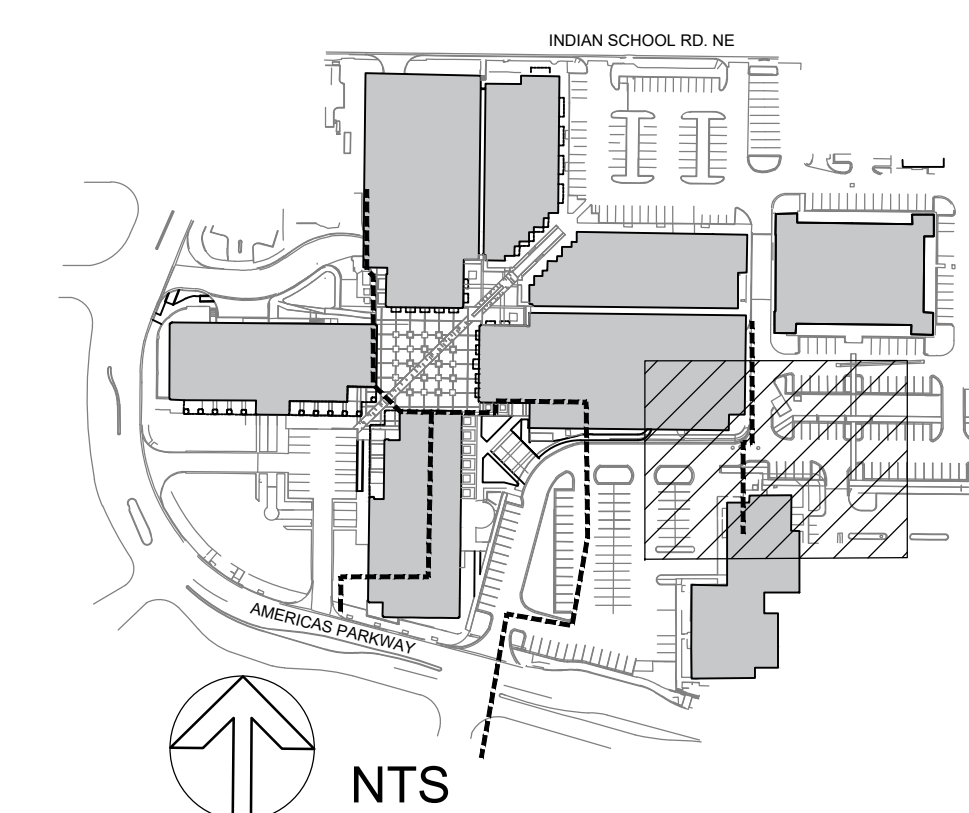
LK-105



6 DIMENSION KEYED NOTES


1. CONCRETE PAVER LAYOUT 1. SEE DETAIL A1/LS-504

KEY MAP

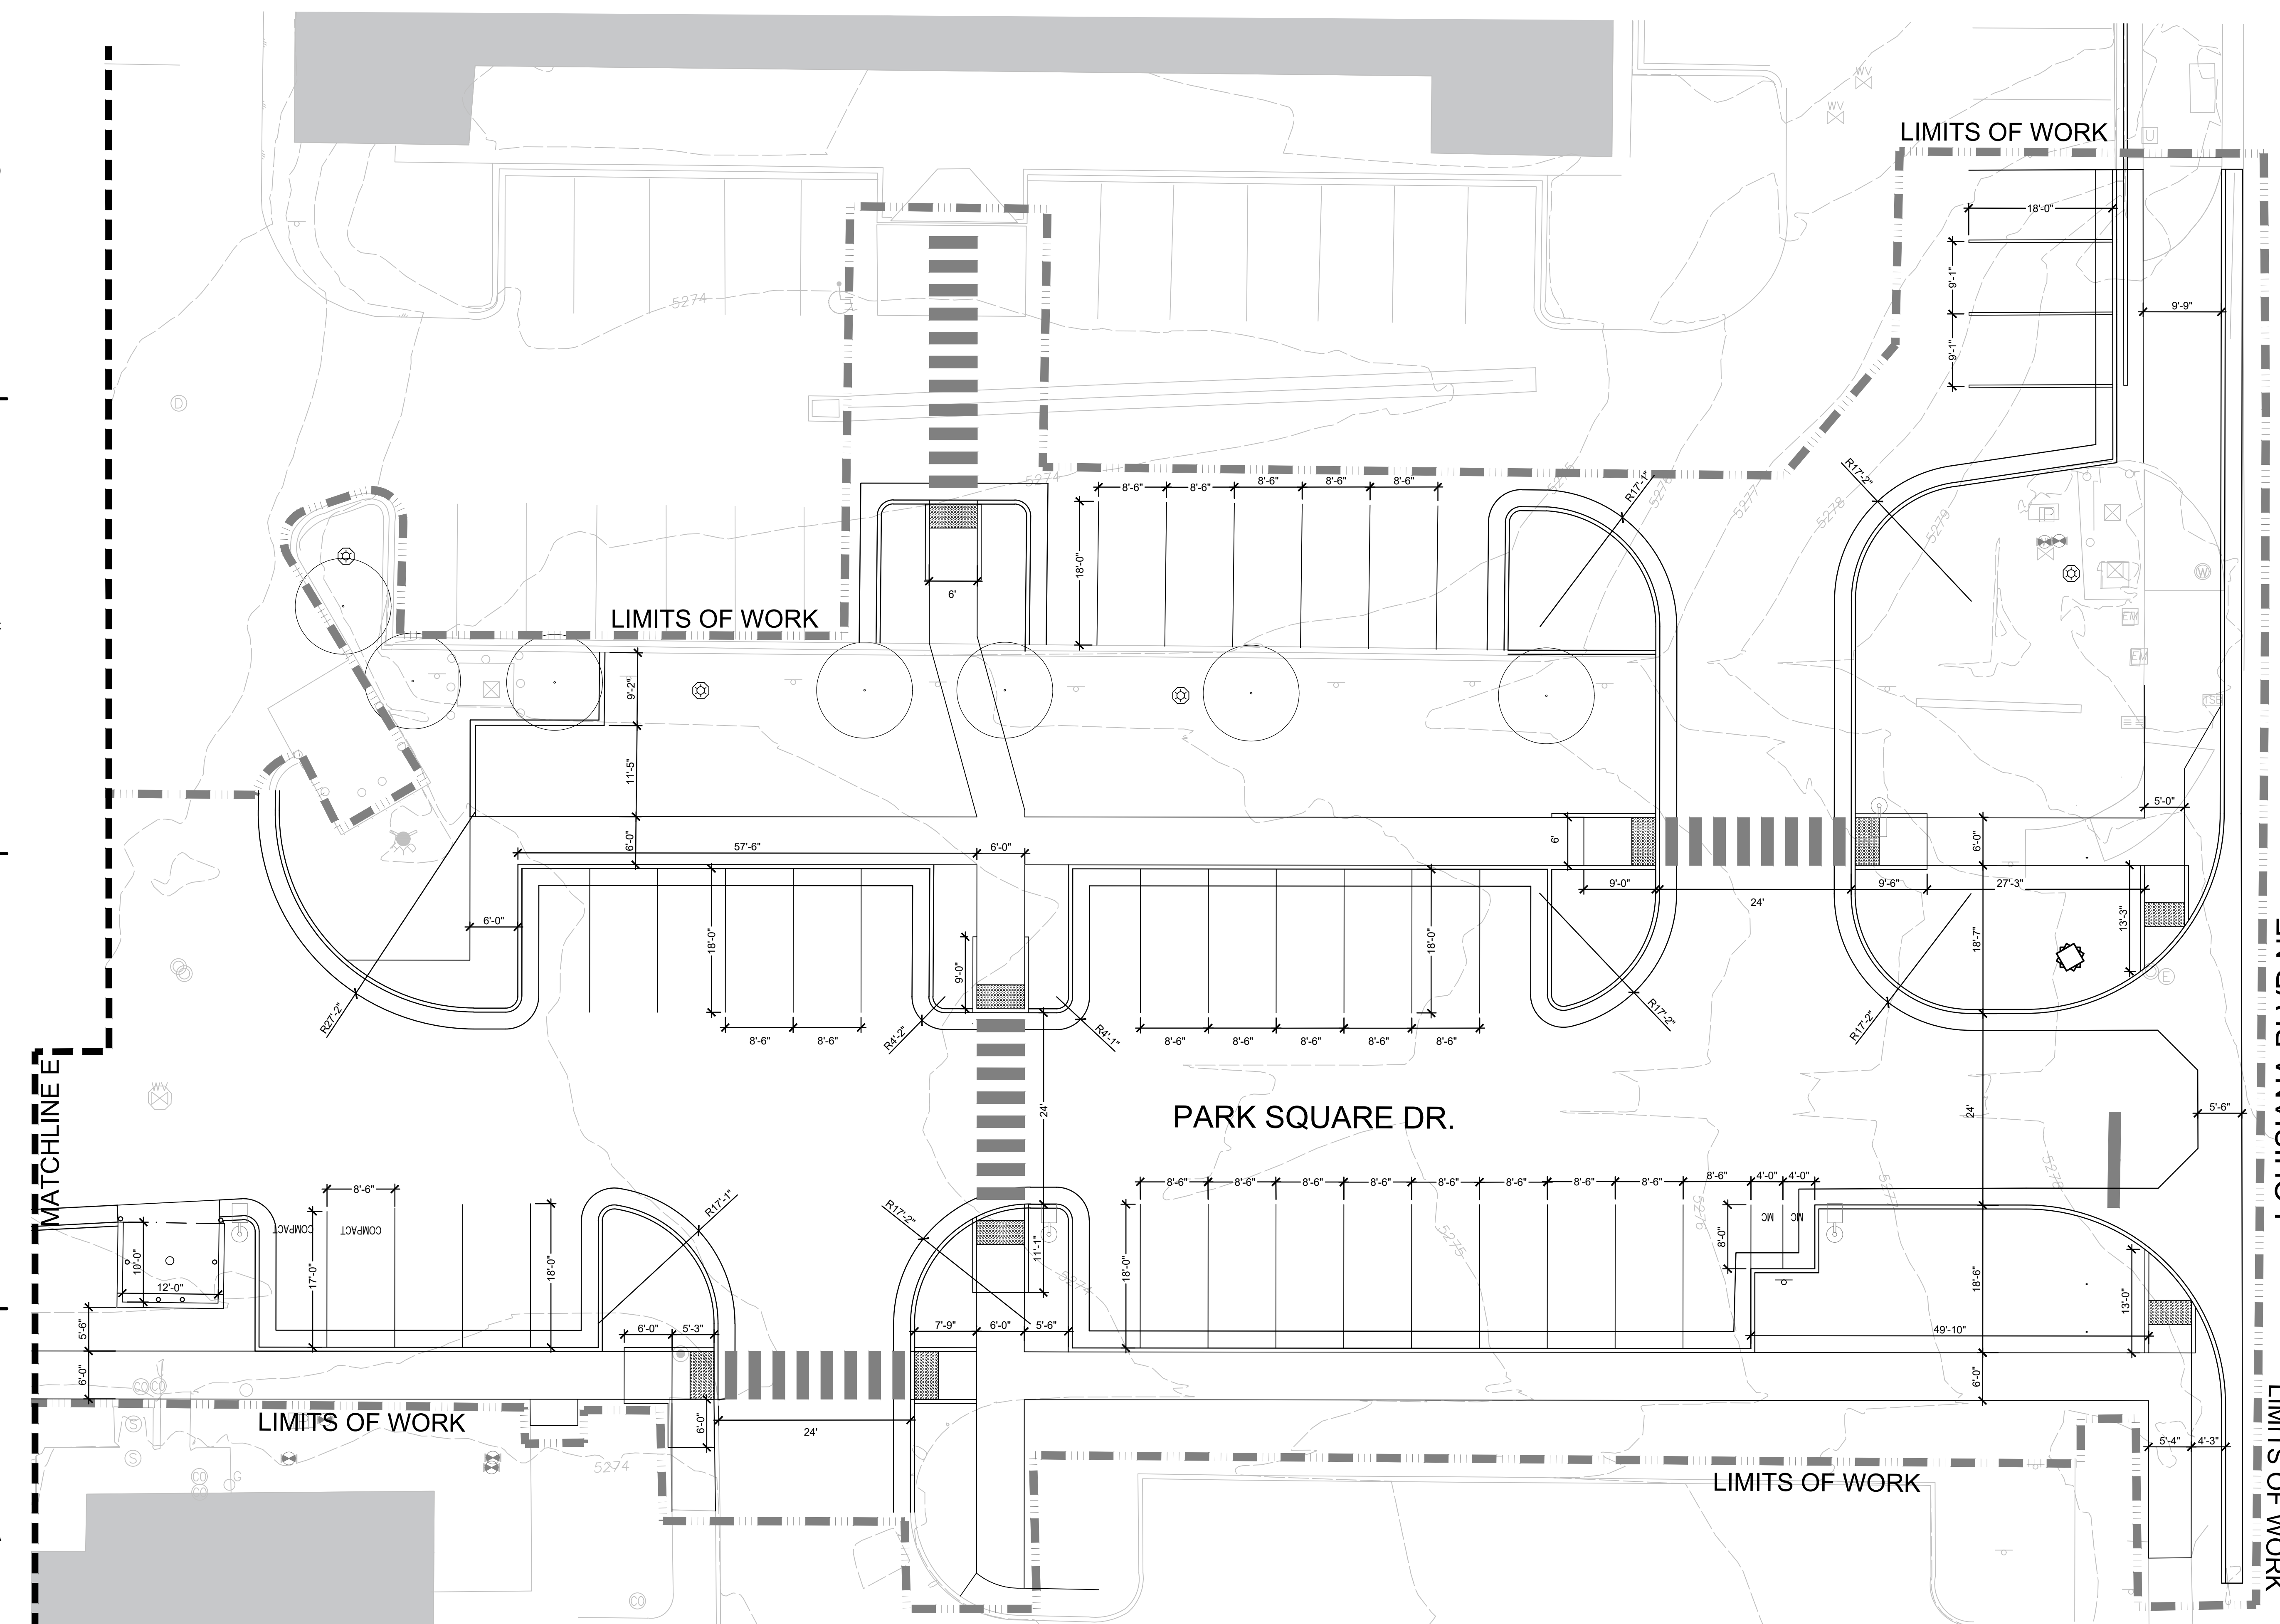


NTS

(A1) DIMENSION PLAN
SCALE: 1" = 10'

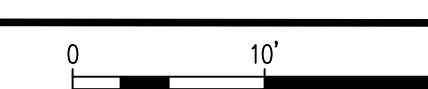

4/25/2024 1:14 PM

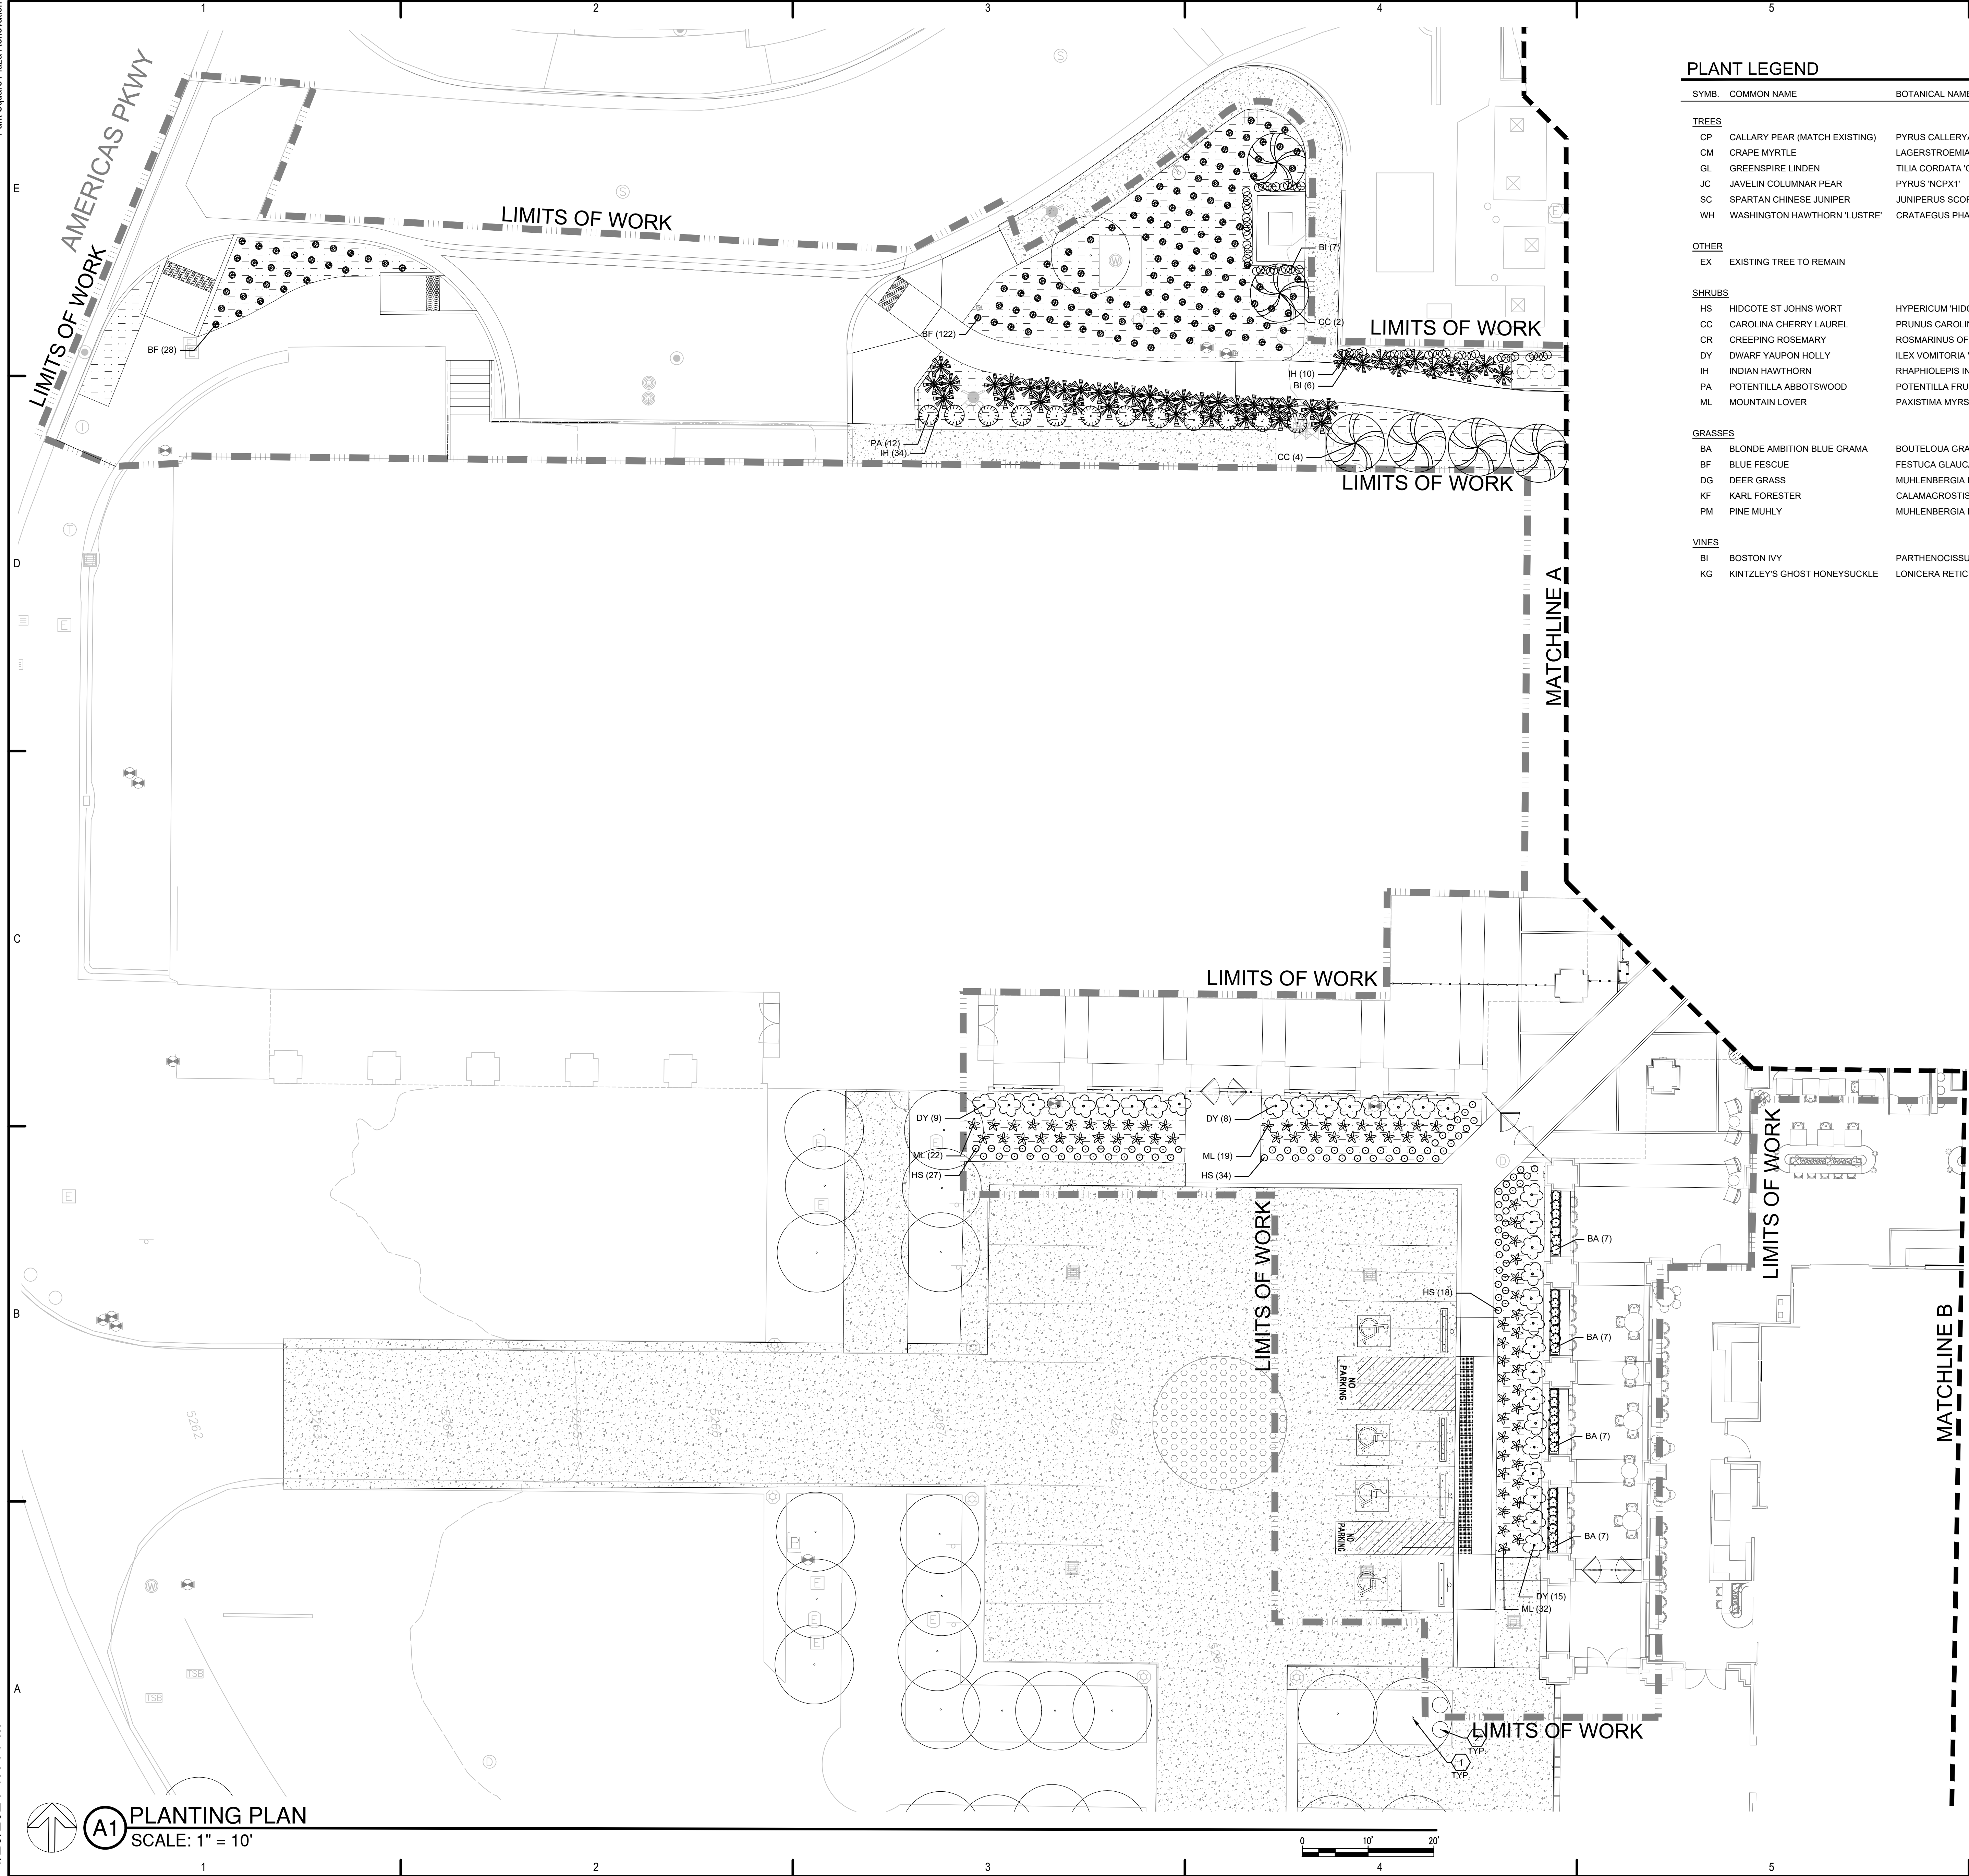

PLANT LEGEND

| SYMB. | COMMON NAME | BOTANICAL NAME | QTY | MIN. INSTALLED SIZE | CONTAINER | MATURE SIZE |
|---------|-------------------------------|--------------------------------------|-----|-----------------------|-----------|------------------|
| TREES | | | | | | |
| CP | CALLARY PEAR (MATCH EXISTING) | PYRUS CALLERYANA | 1 | 2" CAL, MIN 12' HT | B&B | 40' HT & 25' SPD |
| CM | CRAPE MYRTLE | LAGERSTROEMIA NATCHEZ | 6 | 2" CAL, MIN. 8' HT | B&B | 20' HT & 20' SPD |
| GL | GREENSPIRE LINDEN | TILIA CORDATA 'GREENSPIRE' | 9 | 2" CAL, MIN. 12' HT | B&B | 25' HT & 25' SPD |
| JC | JAVELIN COLUMNAR PEAR | PYRUS 'NCPX1' | 11 | 2" CAL, MIN. 12' HT | B&B | 30' HT & 10' SPD |
| SC | SPARTAN CHINESE JUNIPER | JUNIPERUS SCOPULORUM 'SPARTAN' | 3 | 2" CAL, MIN. 8' HT | B&B | 15' HT & 4' SPD |
| WH | WASHINGTON HAWTHORN 'LUSTRE' | CRATAEGUS PHAENOPYRUM 'LUSTRE' | 4 | 2.5" CAL, MIN. 10' HT | B&B | 20' HT & 20' SPD |
| OTHER | | | | | | |
| EX | EXISTING TREE TO REMAIN | | | | | |
| SHRUBS | | | | | | |
| HS | HIDCOTE ST JOHNS WORT | HYPERICUM 'HIDCOTE' | 87 | MIN. 5" HT | 1-GAL | 6" HT X 12" SPD |
| CC | CAROLINA CHERRY LAUREL | PRUNUS CAROLINIANA | 6 | MIN. 2" HT | 15-GAL | 10' HT & 10' SPD |
| CR | CREeping ROSEMARY | ROSMARINUS OFFICINALIS 'PROSTR.' | 16 | MIN. 18" SPD | 5-GAL | 1' HT & 4' SPD |
| DY | DWARF YAU-PON HOLLY | ILEX VOMITORIA 'NANA' | 52 | MIN. 18" HT | 5-GAL | 3' HT & 4' SPD |
| IH | INDIAN HAWTHORN | RHAPHIOLEPIS INDICA | 178 | MIN. 18" HT | 5-GAL | 3' HT & 5' SPD |
| PA | POTENTILLA ABBOTSWOOD | POTENTILLA FRUTICOSA 'ABBOTSWOOD' | 12 | MIN. 18" HT | 5-GAL | 3' HT & 4' SPD |
| ML | MOUNTAIN LOVER | PAXISTIMA MYRSINITES | 73 | MIN. 12" HT | 5-GAL | 3' HT X 6' SPD |
| GRASSES | | | | | | |
| BA | BLONDE AMBITION BLUE GRAMA | BOUTELOUA GRACILIS 'BLONDE AMBITION' | 94 | MIN. 8" HT | 1-GAL | 2' HT X 2' SPD |
| BF | BLUE FESCUE | FESTUCA GLAUCA | 152 | MIN. 12" HT | 5-GAL | 1' HT & 1' SPD |
| DG | DEER GRASS | MUHLBERGIA RIGENS | 109 | MIN. 12" HT | 5-GAL | 4' HT X 3' SPD |
| KF | KARL FORESTER | CALAMAGROSTIS ARUNDINACEA | 76 | MIN. 12" HT | 5-GAL | 6' HT X 18" SPD |
| PM | PINE MUHLY | MUHLBERGIA DUBIA | 489 | MIN. 12" HT | 5-GAL | 2' HT X 2' SPD |
| VINES | | | | | | |
| BI | BOSTON IVY | PARTHENOCISSUS TRICUSPIDATA | 36 | MIN. 4" HT | 5-GAL | 18" HT X 18" SPD |
| KG | KINTZLEY'S GHOST HONEYSUCKLE | LONICERA RETICULATA 'KINTZLEY'S GHT' | 18 | MIN. 4" HT | 5-GAL | 10' HT X 5' SPD |

HATCH LEGEND

- 3" DEPTH GRAVEL MULCH OVER FILTER FABRIC. SEE GENERAL NOTE B.
- 3" DEPTH GRAVEL MULCH OVER FILTER FABRIC. SEE GENERAL NOTE C.
- MONDO GRASS (OPHIPOGON JAPONICUS) SPACED 9" APART.
- LILY OF THE NILE (AGAPANTHUS AFRICANUS 'ALICE GLOCESTER'), FALL BLOOMING ALLIUM (ALLIUM SPLENDENS 'DEEP PINK'), AND MONDO GRASS (OPHIPOGON JAPONICUS) SPACED 9" APART.
- SOD. SEE GENERAL NOTE F.
- EXTERIOR POT PLANTING MIX - SEE GENERAL NOTE G.


GENERAL NOTES

- IF THERE IS A DISCREPANCY BETWEEN PLANT QUANTITIES LISTED IN THE PLANT SCHEDULE AND THOSE SHOWN ON THE PLANTING PLAN, QUANTITIES SHOWN ON THE PLAN SHALL GOVERN. CONTRACTOR SHALL VERIFY ALL QUANTITIES PRIOR TO BID. ADDITIONAL PAYMENT WILL NOT BE MADE FOR ANY DISCREPANCY IN QUANTITIES BETWEEN THE PLANTING PLAN AND THE PLANT SCHEDULE.
- CONTRACTOR SHALL INSTALL A 3" DEPTH OF 3/4" 'COYOTE MIST' GRAVEL MULCH AS AVAILABLE FROM JPR GRAVEL (505-877-4913). INSTALL MULCH OVER FILTER FABRIC, MIN. 3 OZ/SY NONWOVEN NEEDLE PUNCHED POLYPROPYLENE (MIRAFI MSCAPE OR EQUIVALENT). OVERLAP FABRIC ENDS 3". TURN DOWN EDGES 6". TOP OF GRAVEL MULCH SHALL BE 1" BELOW TOP OF ADJACENT PAVING. PROVIDE SAMPLE OF GRAVEL MULCH FOR REVIEW AND APPROVAL PRIOR TO INSTALLATION.
- CONTRACTOR SHALL INSTALL A 3" DEPTH OF 7/16" 'SANTA FE BROWN' GRAVEL MULCH AS AVAILABLE FROM SANTA FE CLASSIC ROCK (505) 471-3553 OR SIMILAR TO MATCH EXISTING. INSTALL MULCH OVER FILTER FABRIC, MIN. 3 OZ/SY NONWOVEN NEEDLE PUNCHED POLYPROPYLENE (MIRAFI MSCAPE OR EQUIVALENT). OVERLAP FABRIC ENDS 3". TURN DOWN EDGES 6". TOP OF GRAVEL MULCH SHALL BE 1" BELOW TOP OF ADJACENT PAVING. PROVIDE SAMPLE OF GRAVEL MULCH FOR REVIEW AND APPROVAL PRIOR TO INSTALLATION.
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- TREES SHALL BE PLANTED PER DETAIL A1LP-501 AND SHRUBS SHALL BE PLANTED PER DETAIL A4LP-501.
- SOD SHALL BE BLUEGRASS AS AVAILABLE FROM EVERGREEN TURF, (575) 589-0401, OR APPROVED EQUAL.
- CONTRACTOR SHALL FURNISH AND INSTALL THE FOLLOWING PLANTING MIX IN THE EXTERIOR POTS: 40% HEUCHERA SANGUINEA 'FIREFLY', 30% SALVIA FARRINCA, 30% PENSTEMON PINIFOLIUS 'COMPACTUM'. CONTRACTOR SHALL FIELD COORDINATE PLANTING LOCATIONS WITH LIGHTING DRIVER AND FIXTURE LOCATIONS FOR ARCHITECT REVIEW AND OWNER APPROVAL.

PLANTING KEYED NOTES

- EXISTING TREE TO REMAIN. SEE DEMOLITION PLANS.
- EXISTING SHRUB TO REMAIN. SEE DEMOLITION PLANS.

KEY MAP

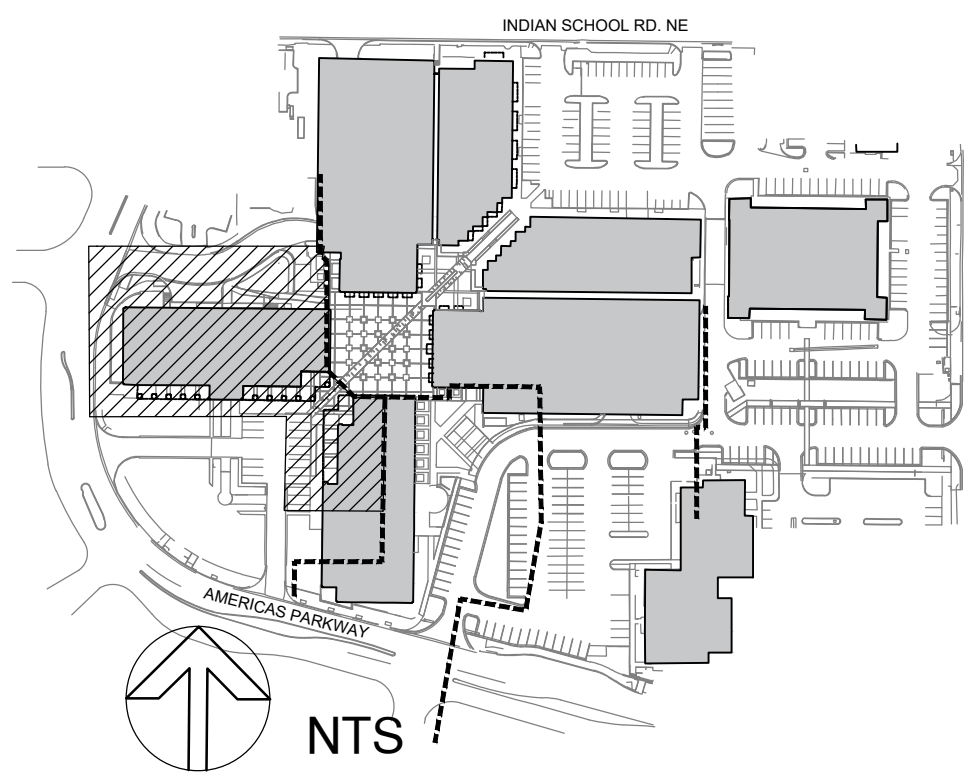

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Groundwork Studio
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CIVIL ENGINEER

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APRIL 2024


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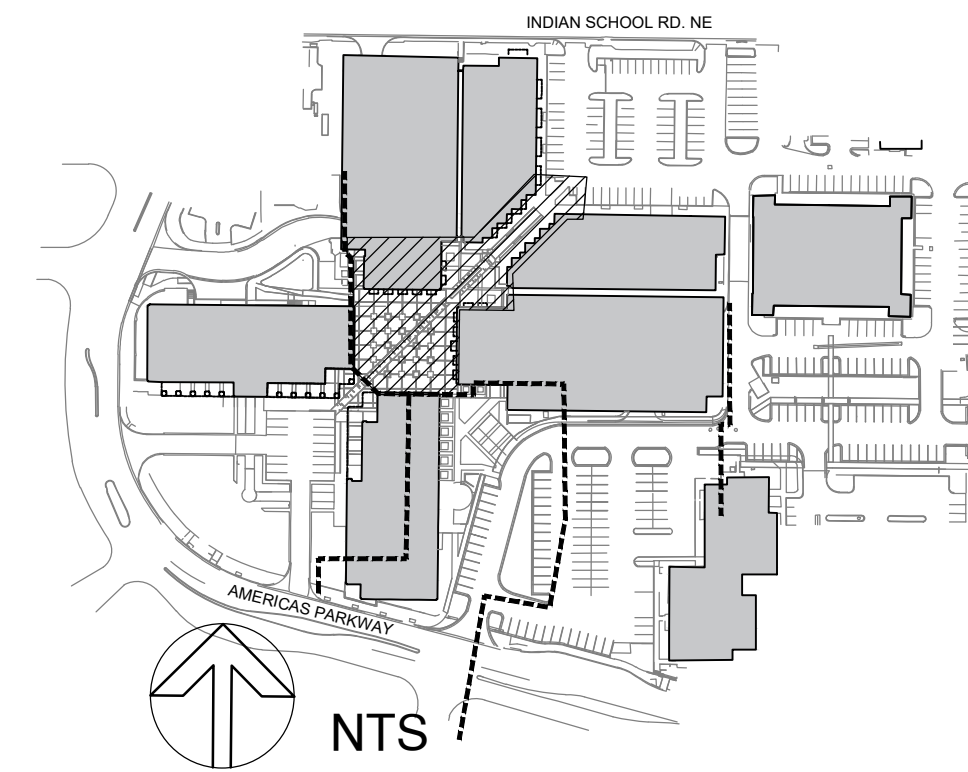
SHEET TITLE

PLANTING PLAN

LP-101



KEY MAP

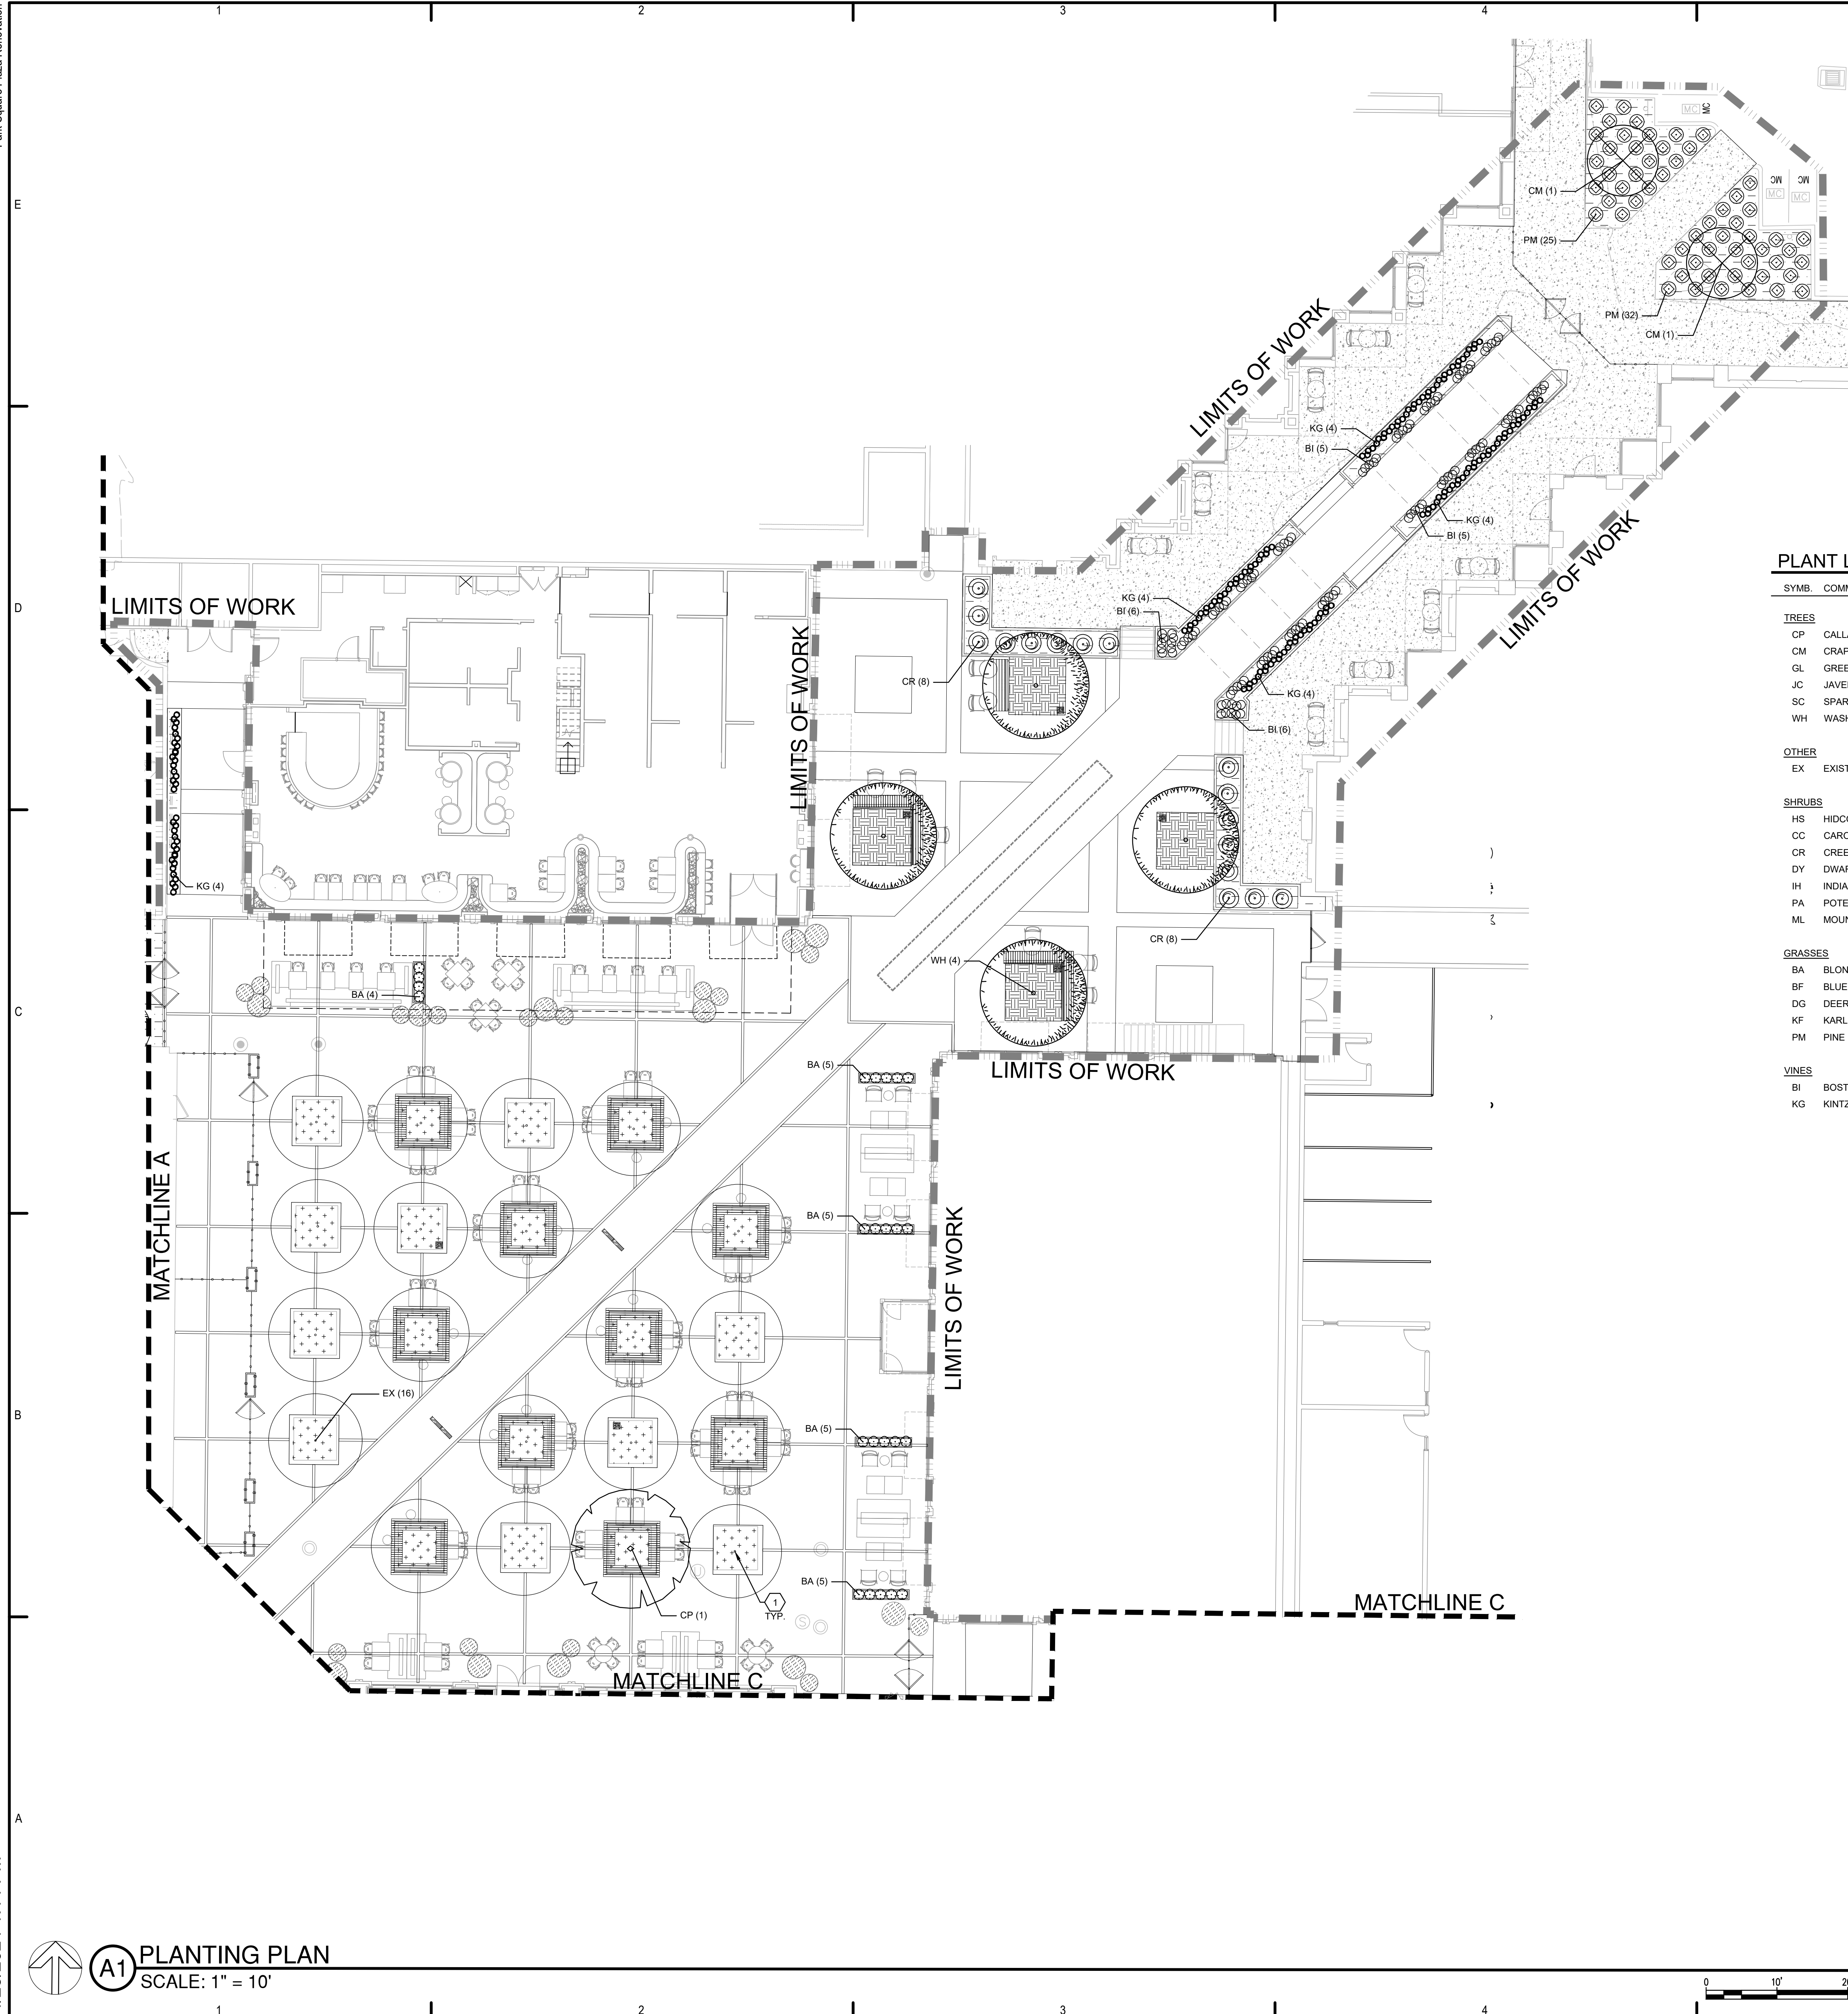

PLANT LEGEND

| SYMB. | COMMON NAME | BOTANICAL NAME | QTY | MIN. INSTALLED SIZE | CONTAINER | MATURE SIZE |
|---------|-------------------------------|--------------------------------------|-----|-----------------------|-----------|------------------|
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| OTHER | | | | | | |
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HATCH LEGEND

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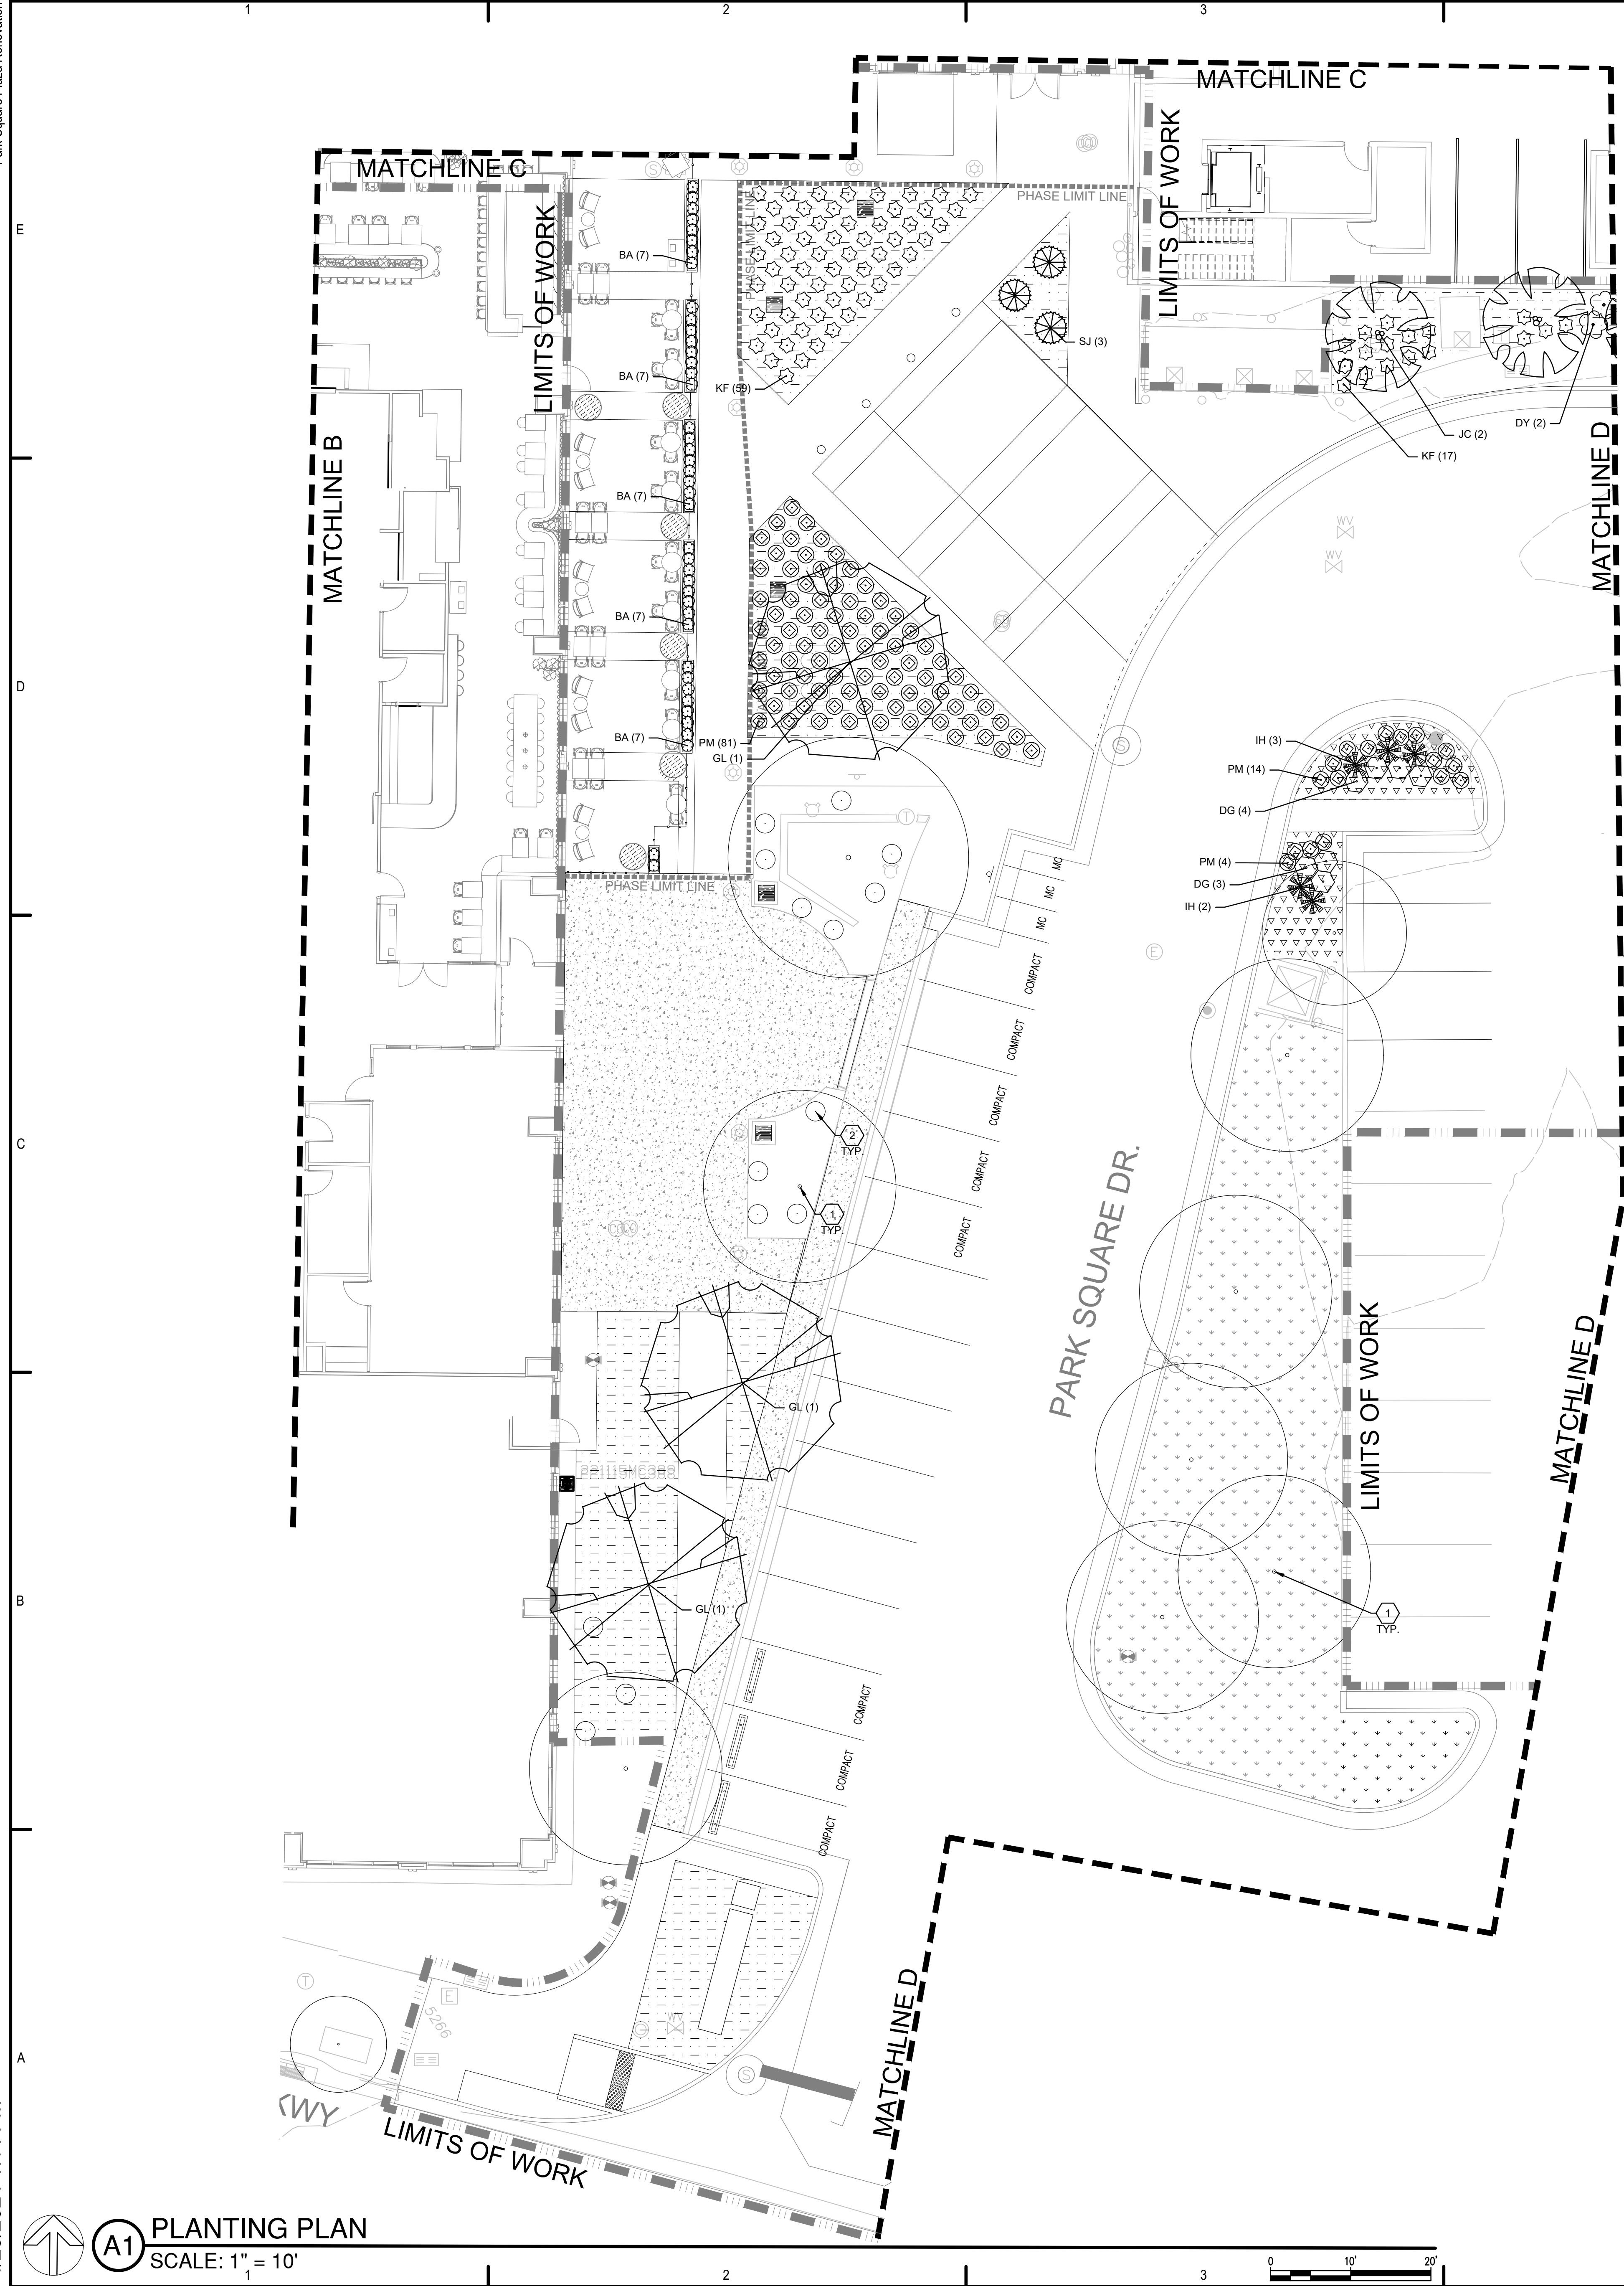
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PLANTING PLAN

LP-102

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PLANT LEGEND

| SYMB. | COMMON NAME | BOTANICAL NAME | QTY | MIN. INSTALLED SIZE | CONTAINER | MATURE SIZE |
|---------|-------------------------------|--------------------------------------|-----|-----------------------|-----------|------------------|
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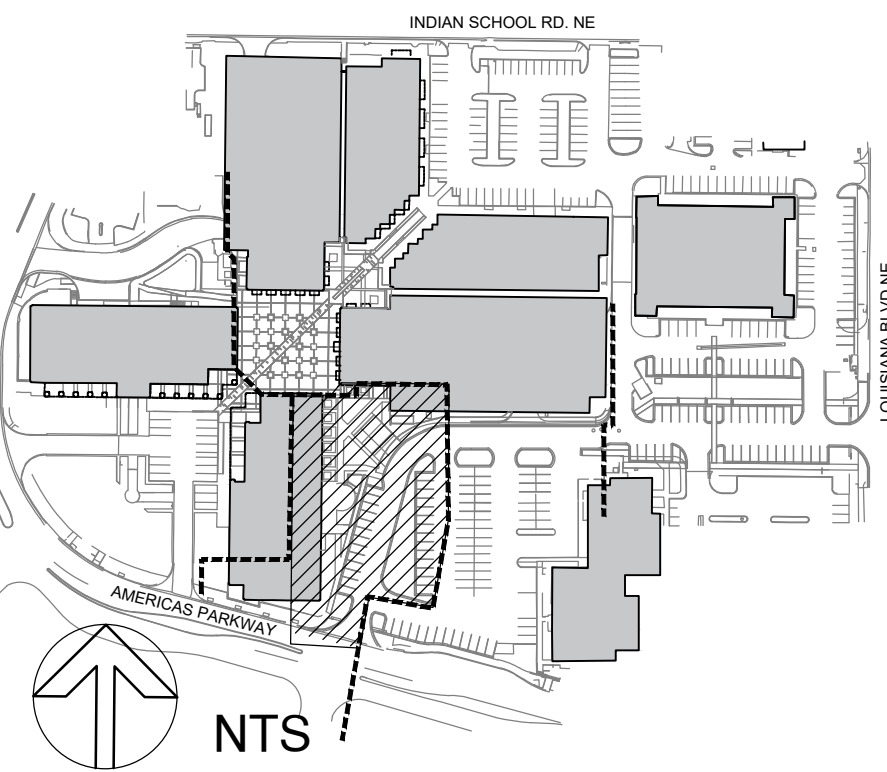
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PLANTING KEYED NOTES

- EXISTING TREE TO REMAIN. SEE DEMOLITION PLANS.
- EXISTING SHRUB TO REMAIN. SEE DEMOLITION PLANS.

KEY MAP



fbt|architects

6501 Americas Pkwy NE, Ste. 300
Albuquerque, NM 87110
P 505.883.5200 WEB: www.fbtarch.com

CONSULTANTS

LANDSCAPE ARCHITECT

Groundwork Studio
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p_505.212.9126

CIVIL ENGINEER

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6501 Americas Pkwy NE, Ste. 400
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p_505.830.8753

LIGHTING

AE Design
1900 Wazee Street #205
Denver, CO 80202
p_303.296.3034



LANDSCAPE ARCHITECT

Park Square Plaza Renovation

6565 AMERICAS PKWY
ALBUQUERQUE, NM 87110

APRIL 2024

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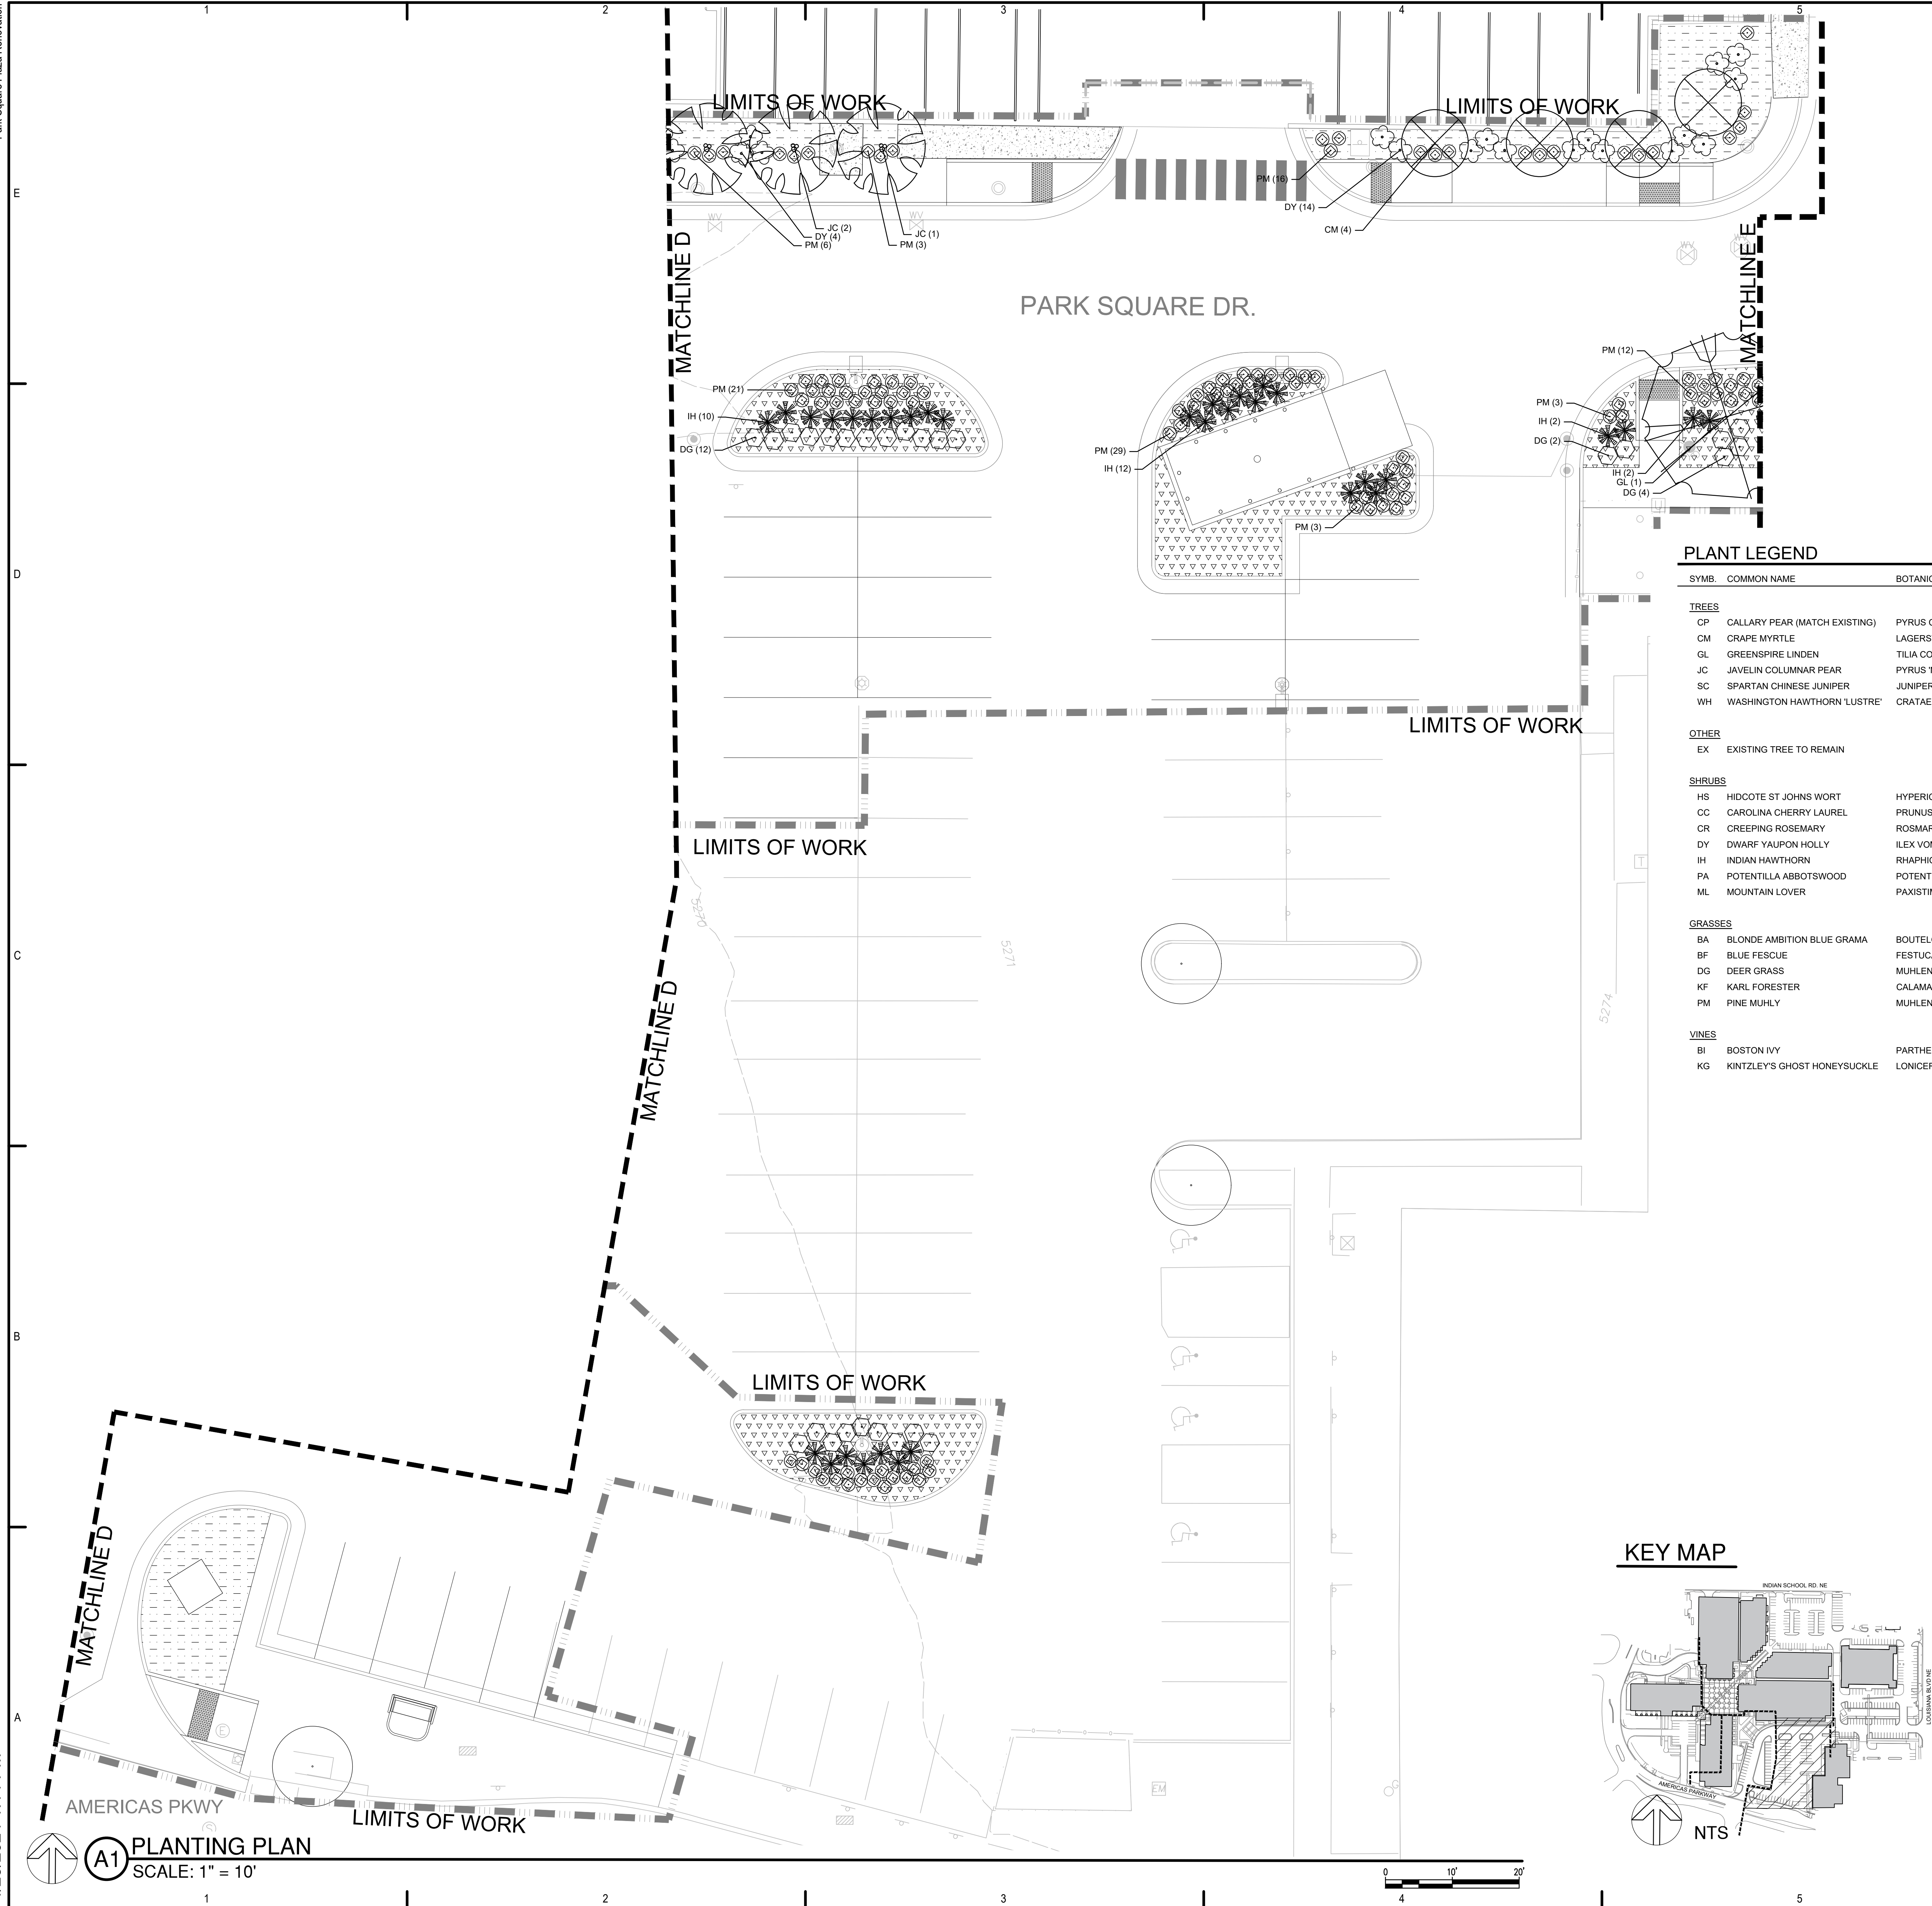
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PLANTING PLAN

LP-103

Park Square Plaza Renovation

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PLANT LEGEND

| SYMB. | COMMON NAME | BOTANICAL NAME | QTY | MIN. INSTALLED SIZE | CONTAINER | MATURE SIZE |
|--------------------------|-------------------------------|--------------------------------------|-----|-----------------------|-----------|------------------|
| TREES | | | | | | |
| CP | CALLARY PEAR (MATCH EXISTING) | PYRUS CALLERYANA | 1 | 2" CAL, MIN 12' HT | B&B | 40' HT & 25' SPD |
| CM | CRAPE MYRTLE | LAGERSTROEMIA NATCHEZ | 6 | 2" CAL, MIN. 8' HT | B&B | 20' HT & 20' SPD |
| GL | GREENSPIRE LINDEN | TILIA CORDATA 'GREENSPIRE' | 9 | 2" CAL, MIN. 12' HT | B&B | 25' HT & 25' SPD |
| JC | JAVELIN COLUMNAR PEAR | PYRUS 'NCPX1' | 11 | 2" CAL, MIN. 12' HT | B&B | 30' HT & 10' SPD |
| SC | SPARTAN CHINESE JUNIPER | JUNIPERUS SCOPULORUM 'SPARTAN' | 3 | 2" CAL, MIN. 8' HT | B&B | 15' HT & 4' SPD |
| WH | WASHINGTON HAWTHORN 'LUSTRE' | CRATAEGUS PHAENOPYRUM 'LUSTRE' | 4 | 2.5" CAL, MIN. 10' HT | B&B | 20' HT & 20' SPD |
| OTHER | | | | | | |
| EX | EXISTING TREE TO REMAIN | | | | | |
| SHRUBS | | | | | | |
| HS | HIDCOTE ST JOHNS WORT | HYPERICUM 'HIDCOTE' | 87 | MIN. 5" HT | 1-GAL | 6" HT X 12" SPD |
| CC | CAROLINA CHERRY LAUREL | PRUNUS CAROLINIANA | 6 | MIN. 2" HT | 15-GAL | 10' HT & 10' SPD |
| CR | CREeping ROSEMARY | ROSMARINUS OFFICINALIS 'PROSTR.' | 16 | MIN. 18" SPD | 5-GAL | 1' HT & 4' SPD |
| DY | DWARF YAUPON HOLLY | ILEX VOMITORIA 'NANA' | 52 | MIN. 18" HT | 5-GAL | 3' HT & 4' SPD |
| IH | INDIAN HAWTHORN | RHAPHIOLEPIS INDICA | 178 | MIN. 18" HT | 5-GAL | 3' HT & 5' SPD |
| PA | POTENTILLA ABBOTSWOOD | POTENTILLA FRUTICOSA 'ABBOTSWOOD' | 12 | MIN. 18" HT | 5-GAL | 3' HT & 4' SPD |
| ML | MOUNTAIN LOVER | PAXISTIMA MYRSINITES | 73 | MIN. 12" HT | 5-GAL | 3' HT X 6' SPD |
| GRASSES | | | | | | |
| BA | BLONDE AMBITION BLUE GRAMA | BOUTELOUA GRACILIS 'BLONDE AMBITION' | 94 | MIN. 8" HT | 1-GAL | 2' HT X 2' SPD |
| BF | BLUE FESCUE | FESTUCA GLAUCA | 152 | MIN. 12" HT | 5-GAL | 1' HT X 1' SPD |
| DG | DEER GRASS | MUHLENBERGIA RIGENS | 109 | MIN. 12" HT | 5-GAL | 4' HT X 3' SPD |
| KF | KARL FORESTER | CALAMAGROSTIS ARUNDINACEA | 76 | MIN. 12" HT | 5-GAL | 6' HT X 18" SPD |
| PM | PINE MUHLY | MUHLENBERGIA DUBIA | 489 | MIN. 12" HT | 5-GAL | 2' HT X 2' SPD |
| VINES | | | | | | |
| BI | BOSTON IVY | PARTHENOCISSUS TRICUSPIDATA | 36 | MIN. 4" HT | 5-GAL | 18' HT X 18" SPD |
| KG | KINTZLEY'S GHOST HONEYSUCKLE | LONICERA RETICULATA 'KINTZLEY'S GHT' | 18 | MIN. 4" HT | 5-GAL | 10' HT X 5' SPD |

HATCH LEGEND

| | |
|--|--|
| | 3" DEPTH GRAVEL MULCH OVER FILTER FABRIC. SEE GENERAL NOTE B. |
| | 3" DEPTH GRAVEL MULCH OVER FILTER FABRIC. SEE GENERAL NOTE C. |
| | MONDO GRASS (OPHIPOGON JAPONICUS) SPACED 9" APART. |
| | LILY OF THE NILE (AGAPANTHUS AFRICANUS 'ALICE GLOCESTER'), FALL-BLOOMING ALLIUM (ALLIUM SPLENDENS 'DEEP PINK'), AND MONDO GRASS (OPHIPOGON JAPONICUS) SPACED 9" APART. |
| | SOD. SEE GENERAL NOTE F. |
| | EXTERIOR POT PLANTING MIX - SEE GENERAL NOTE G. |


GENERAL NOTES

- A. IF THERE IS A DISCREPANCY BETWEEN PLANT QUANTITIES LISTED IN THE PLANT SCHEDULE AND THOSE SHOWN ON THE PLANTING PLAN, QUANTITIES SHOWN ON THE PLAN SHALL GOVERN. CONTRACTOR SHALL VERIFY ALL QUANTITIES PRIOR TO BID. ADDITIONAL PAYMENT WILL NOT BE MADE FOR ANY DISCREPANCY IN QUANTITIES BETWEEN THE PLANTING PLAN AND THE PLANT SCHEDULE.
- B. CONTRACTOR SHALL INSTALL A 3" DEPTH OF 3/4" 'COYOTE MIST' GRAVEL MULCH AS AVAILABLE FROM JPR GRAVEL (505-877-4913). INSTALL MULCH OVER FILTER FABRIC, MIN. 3 OZ/SY NONWOVEN NEEDLE PUNCHED POLYPROPYLENE (MIRAFI MSCAPE OR EQUIVALENT), OVERLAP FABRIC ENDS 3". TURN DOWN EDGES 6". TOP OF GRAVEL MULCH SHALL BE 1" BELOW TOP OF ADJACENT PAVING. PROVIDE SAMPLE OF GRAVEL MULCH FOR REVIEW AND APPROVAL PRIOR TO INSTALLATION.
- C. CONTRACTOR SHALL INSTALL A 3" DEPTH OF 7/16" 'SANTA FE BROWN' GRAVEL MULCH AS AVAILABLE FROM SANTA FE CLASSIC ROCK (505-471-3553 OR SIMILAR TO MATCH EXISTING). INSTALL MULCH OVER FILTER FABRIC, MIN. 3 OZ/SY NONWOVEN NEEDLE PUNCHED POLYPROPYLENE (MIRAFI MSCAPE OR EQUIVALENT), OVERLAP FABRIC ENDS 3". TURN DOWN EDGES 6". TOP OF GRAVEL MULCH SHALL BE 1" BELOW TOP OF ADJACENT PAVING. PROVIDE SAMPLE OF GRAVEL MULCH FOR REVIEW AND APPROVAL PRIOR TO INSTALLATION.
- D. IF THERE IS A DISCREPANCY IN THE FIELD OR NURSERY BETWEEN THE CONTAINER SIZE LISTED UNDER 'CONTAINER' AND HEIGHT & SPREAD LISTED UNDER 'INSTALLED SIZE', THE SPECIFIED PLANT SHALL MEET HEIGHT & SPREAD REQUIREMENTS SPECIFIED UNDER 'INSTALLED SIZE'. IF A LARGER CONTAINER SIZE IS REQUIRED TO MEET THESE SPECIFICATIONS, IT SHALL BE PROVIDED AT NO ADDITIONAL COST TO THE OWNER.
- E. TREES SHALL BE PLANTED PER DETAIL A1/LP-501 AND SHRUBS SHALL BE PLANTED PER DETAIL A4/LP-501.
- F. SOD SHALL BE BLUEGRASS AS AVAILABLE FROM EVERGREEN TURF, (575)569-0401, OR APPROVED EQUAL.
- G. CONTRACTOR SHALL FURNISH AND INSTALL THE FOLLOWING PLANTING MIX IN THE EXTERIOR POTS: 40% HEUCHERA SANGUINEA 'FIREFLY', 30% SALVIA FARNACIA, 30% PENSTEMON PINIFOLIUS 'COMPACTUM'. CONTRACTOR SHALL FIELD COORDINATE PLANTING LOCATIONS WITH LIGHTING DRIVER AND FIXTURE LOCATIONS FOR ARCHITECT REVIEW AND OWNER APPROVAL.

PLANTING KEYED NOTES

1. EXISTING TREE TO REMAIN. SEE DEMOLITION PLANS.
2. EXISTING SHRUB TO REMAIN. SEE DEMOLITION PLANS.

KEY MAP

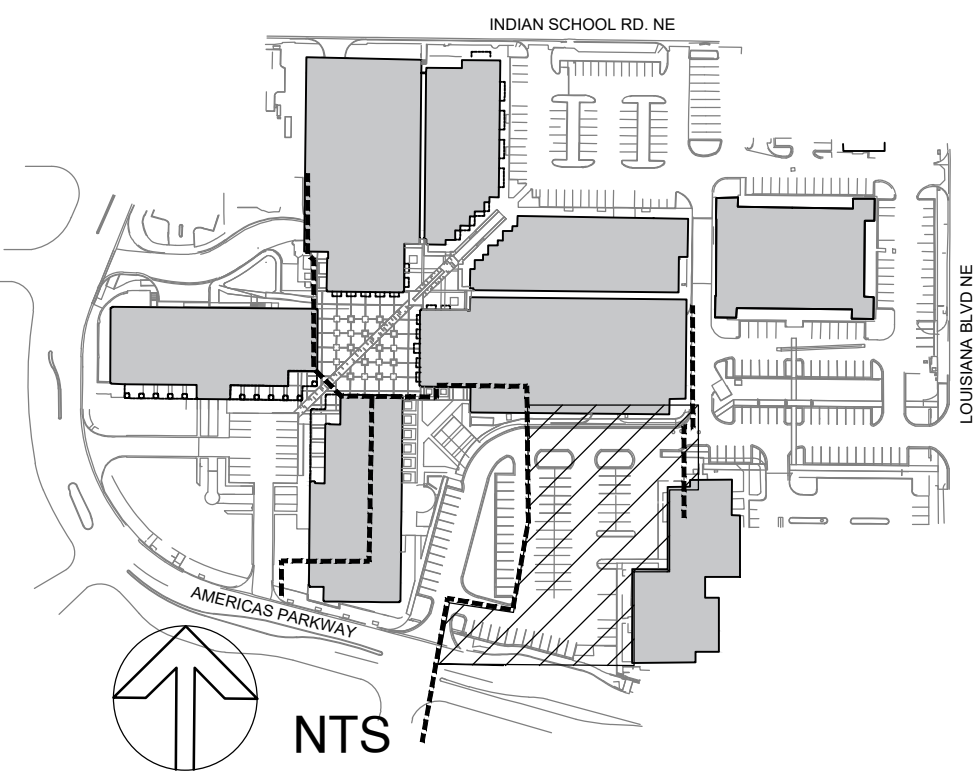

CONSULTANTS

LANDSCAPE ARCHITECT

Groundwork Studio
6501 Americas Pkwy NE, Ste. 350
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LANDSCAPE ARCHITECT

Park Square Plaza Renovation

6565 AMERICAS PKWY
ALBUQUERQUE, NM 87110

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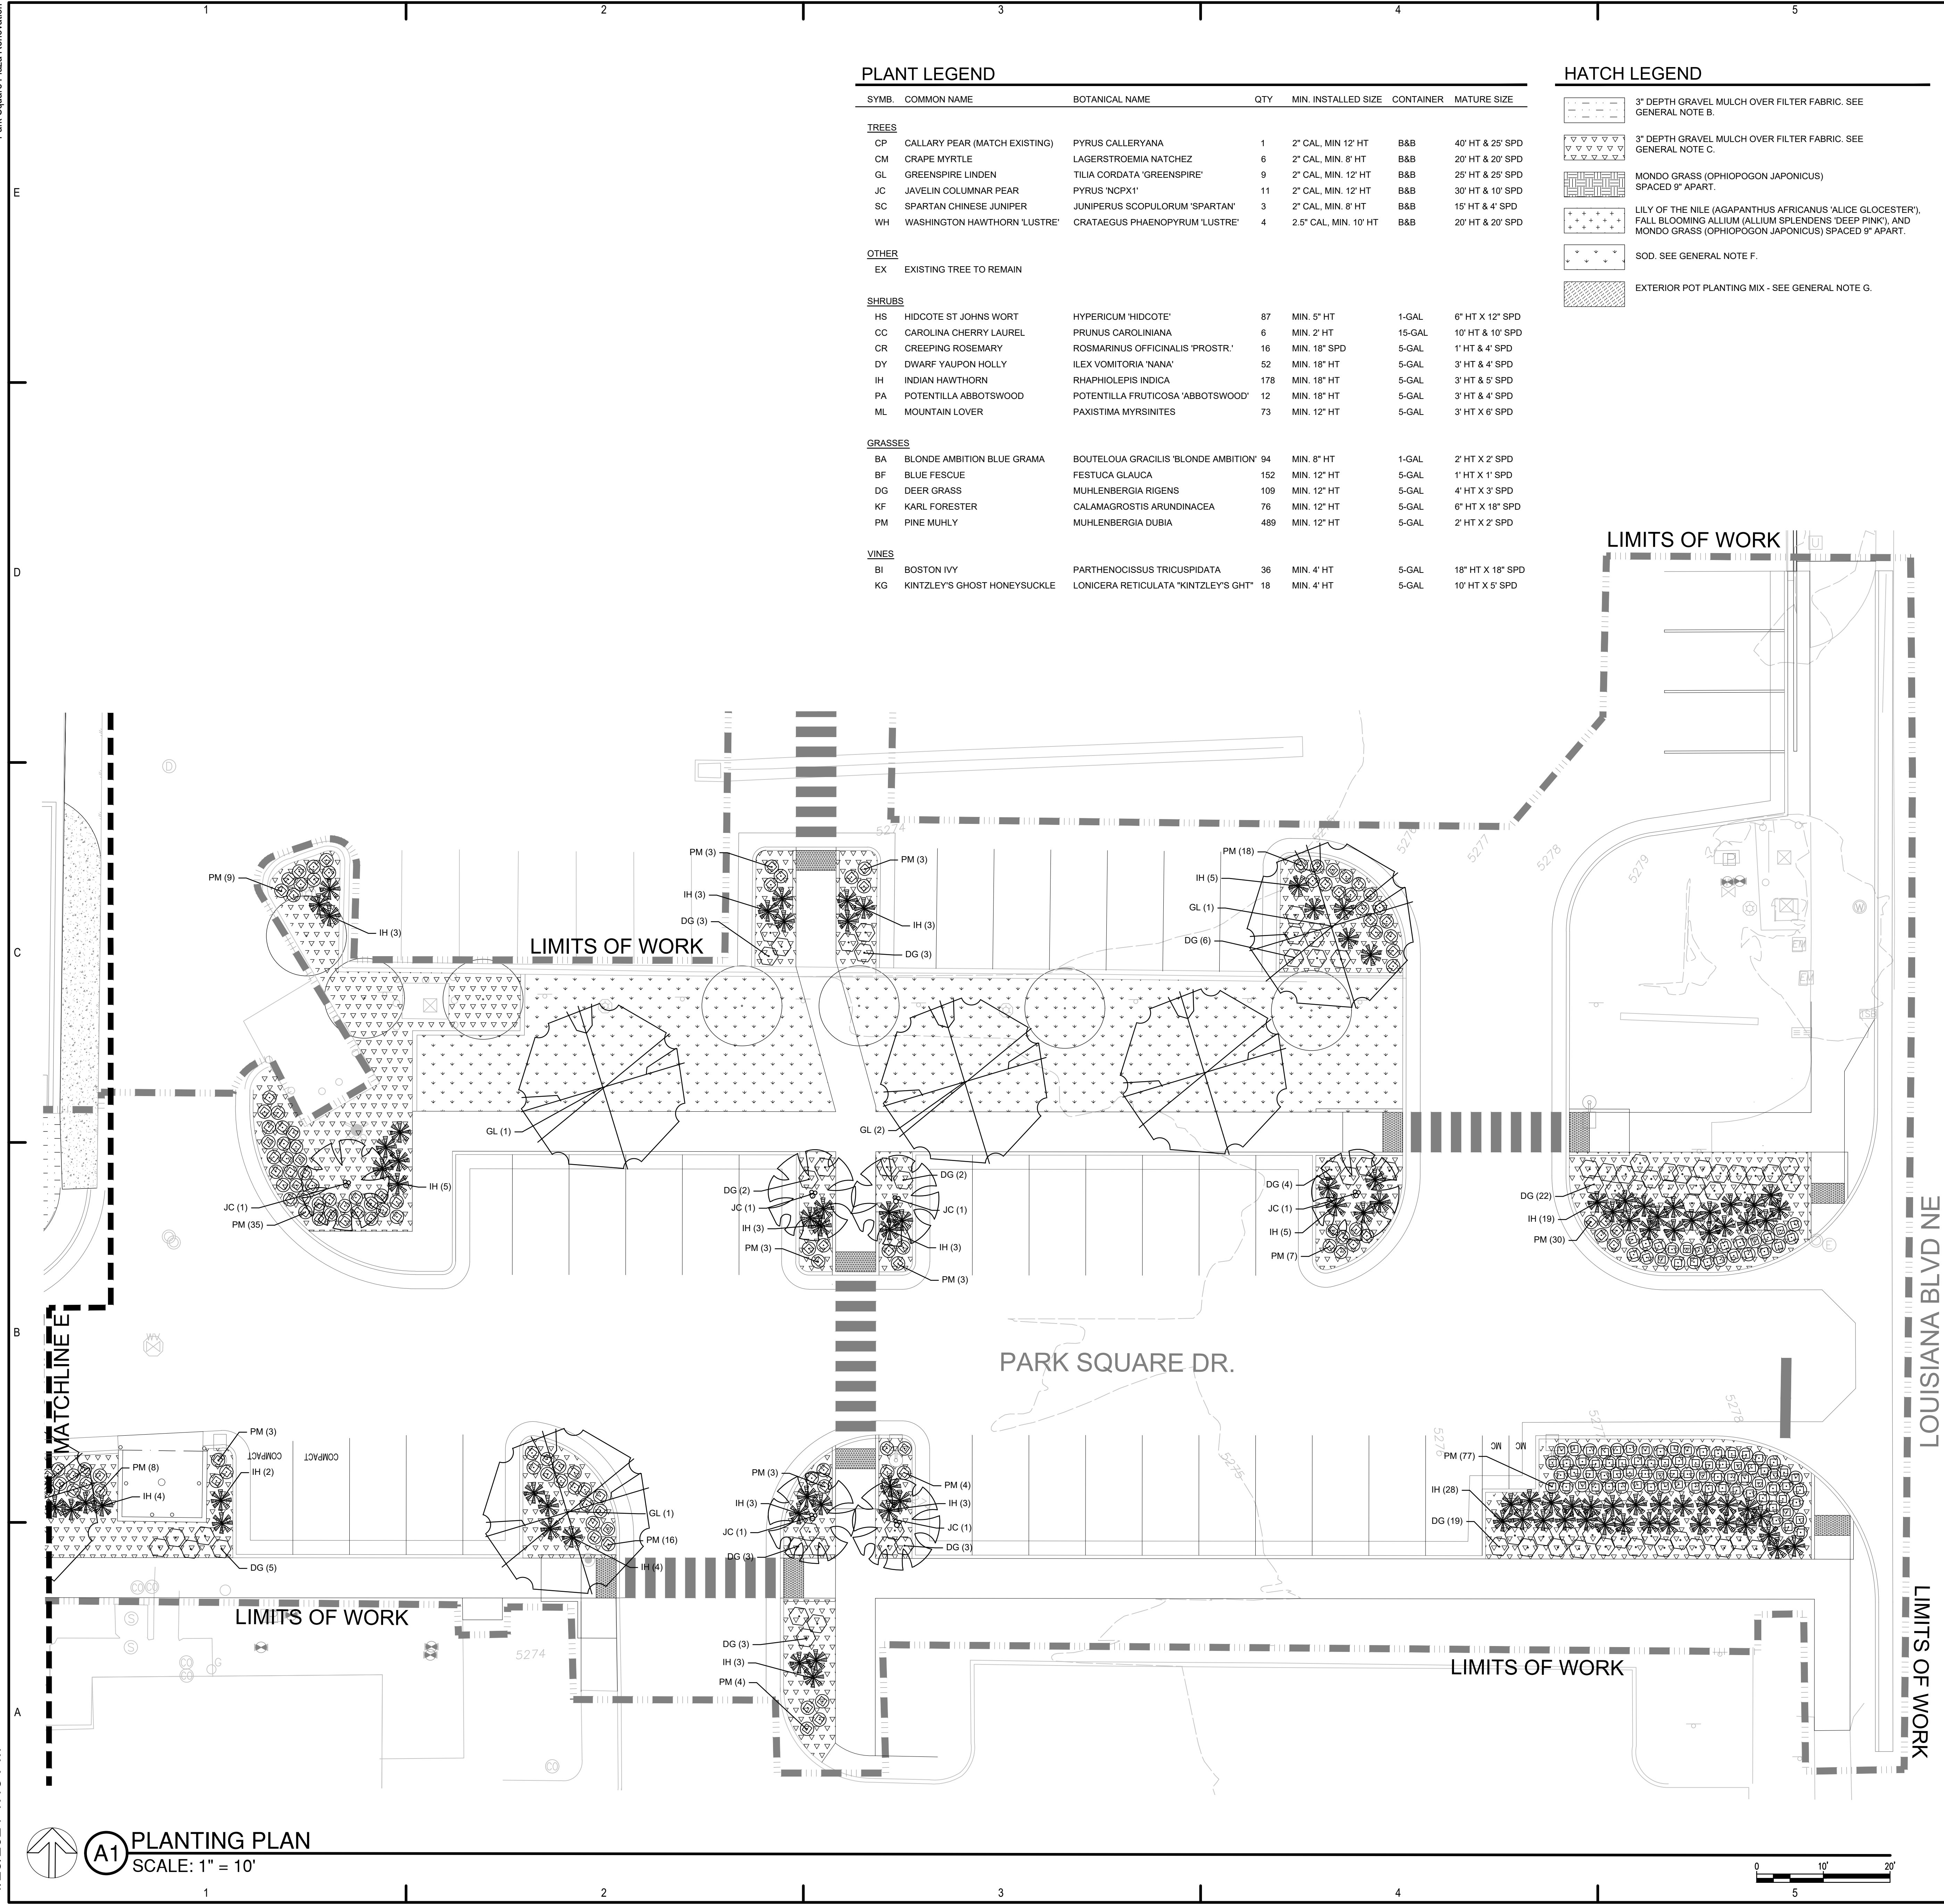
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PLANTING PLAN

LP-104

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Park Square Plaza Renovation



PLANT LEGEND

| SYMB. | COMMON NAME | BOTANICAL NAME | QTY | MIN. INSTALLED SIZE | CONTAINER | MATURE SIZE |
|---------|-------------------------------|--------------------------------------|-----|-----------------------|-----------|------------------|
| TREES | | | | | | |
| CP | CALLARY PEAR (MATCH EXISTING) | PYRUS CALLERYANA | 1 | 2" CAL, MIN. 12' HT | B&B | 40' HT & 25' SPD |
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| EX | EXISTING TREE TO REMAIN | | | | | |
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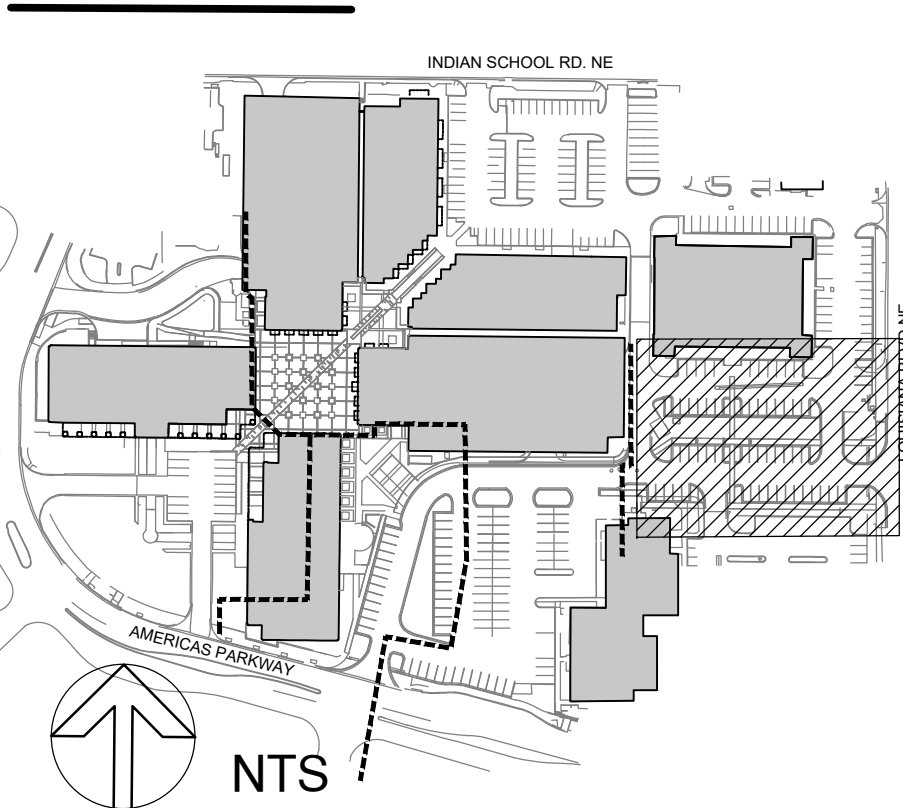
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PLANTING KEYED NOTES

1. EXISTING TREE TO REMAIN. SEE DEMOLITION PLANS.
2. EXISTING SHRUB TO REMAIN. SEE DEMOLITION PLANS.

KEY MAP



CONSULTANTS

LANDSCAPE ARCHITECT

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6501 Americas Pkwy NE, Ste. 350
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LANDSCAPE ARCHITECT

Park Square Plaza
Renovation

6565 AMERICAS PKWY
ALBUQUERQUE, NM 87110

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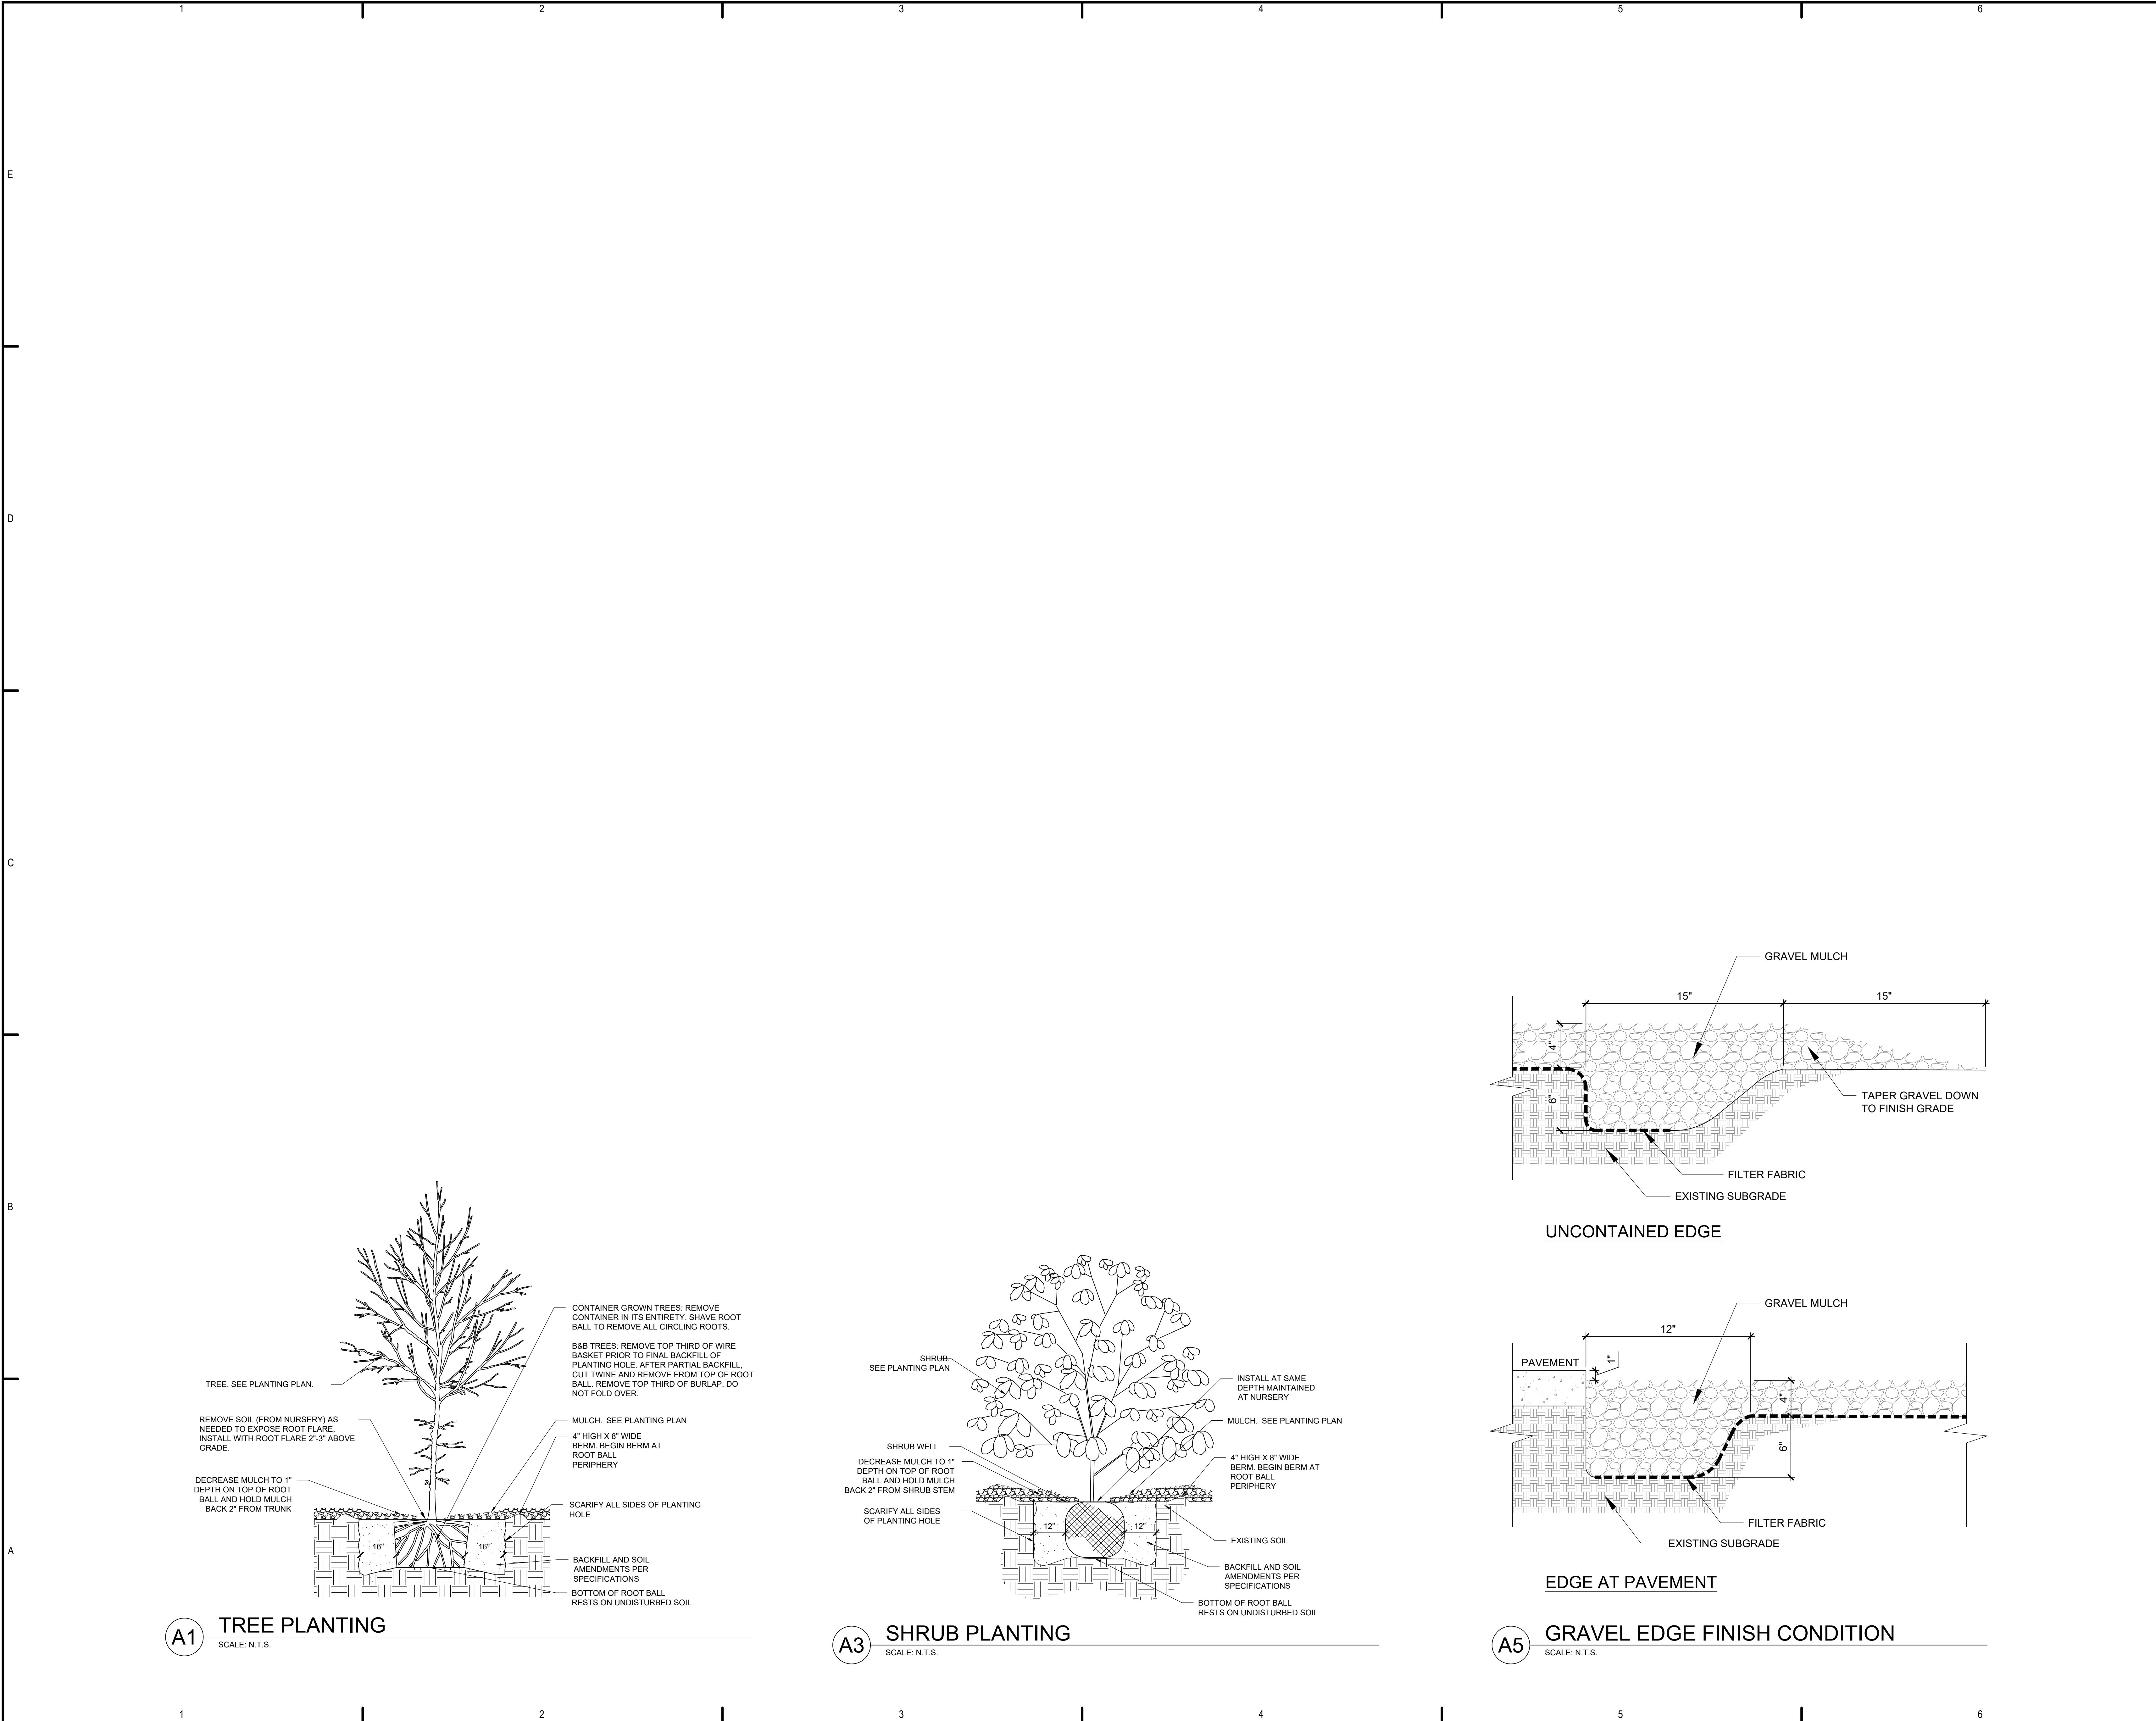
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PLANTING PLAN

LP-105

Park Square Plaza Renovation

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CONSULTANTS

LANDSCAPE ARCHITECT

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LANDSCAPE ARCHITECT

Park Square Plaza
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






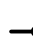







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







PLANTING DETAILS


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LIGHTING GENERAL NOTES

| | |
|---|---|
| A | LUMINAIRE TYPE, REFERENCING LUMINAIRE SCHEDULE, TYPICAL ALL FIXTURES, SUBSCRIPT, IF SHOWN, REFERENCES WALL SWITCH OR RELAY/ZONE CONTROL |
|  | WALL MOUNTED LUMINAIRE |
|  | SURFACE OR PENDANT MOUNTED LUMINAIRE |
|  | RECESSED LUMINAIRE |
|  | DOWNLIGHT LUMINAIRE |
|  | SURFACE CEILING LUMINAIRE |
|  | PENDANT LUMINAIRE |
|  | ARROW INDICATES DIRECTIONAL LUMINAIRE |
|  | MONOPOINT LUMINAIRE |
|  | LED TAPE LUMINAIRE |
|  | FESTOON LIGHTING |
|  | STEP LIGHT TYPE LUMINAIRE |
|  | IN-GRADE UPLIGHT |
|  | BOLLARD OR POST TOP LUMINAIRE |
|  | EXTERIOR AREA LIGHT |
|  | DIRECT BURIAL REMOTE DRIVER |

LIGHTING CONTROLS LEGEND

| | |
|---|--|
|  | TIMECLOCK |
|  | SINGLE POLE SWITCH |
|  | 3-WAY SWITCH |
|  | 4-WAY SWITCH |
|  | KEY OPERATED SWITCH |
|  | DIMMER SWITCH |
|  | RECESSED DOOR SWITCH |
|  | LIGHTING CONTROL DEVICE. REFER TO DETAILS FOR CONTROL INTENT. |

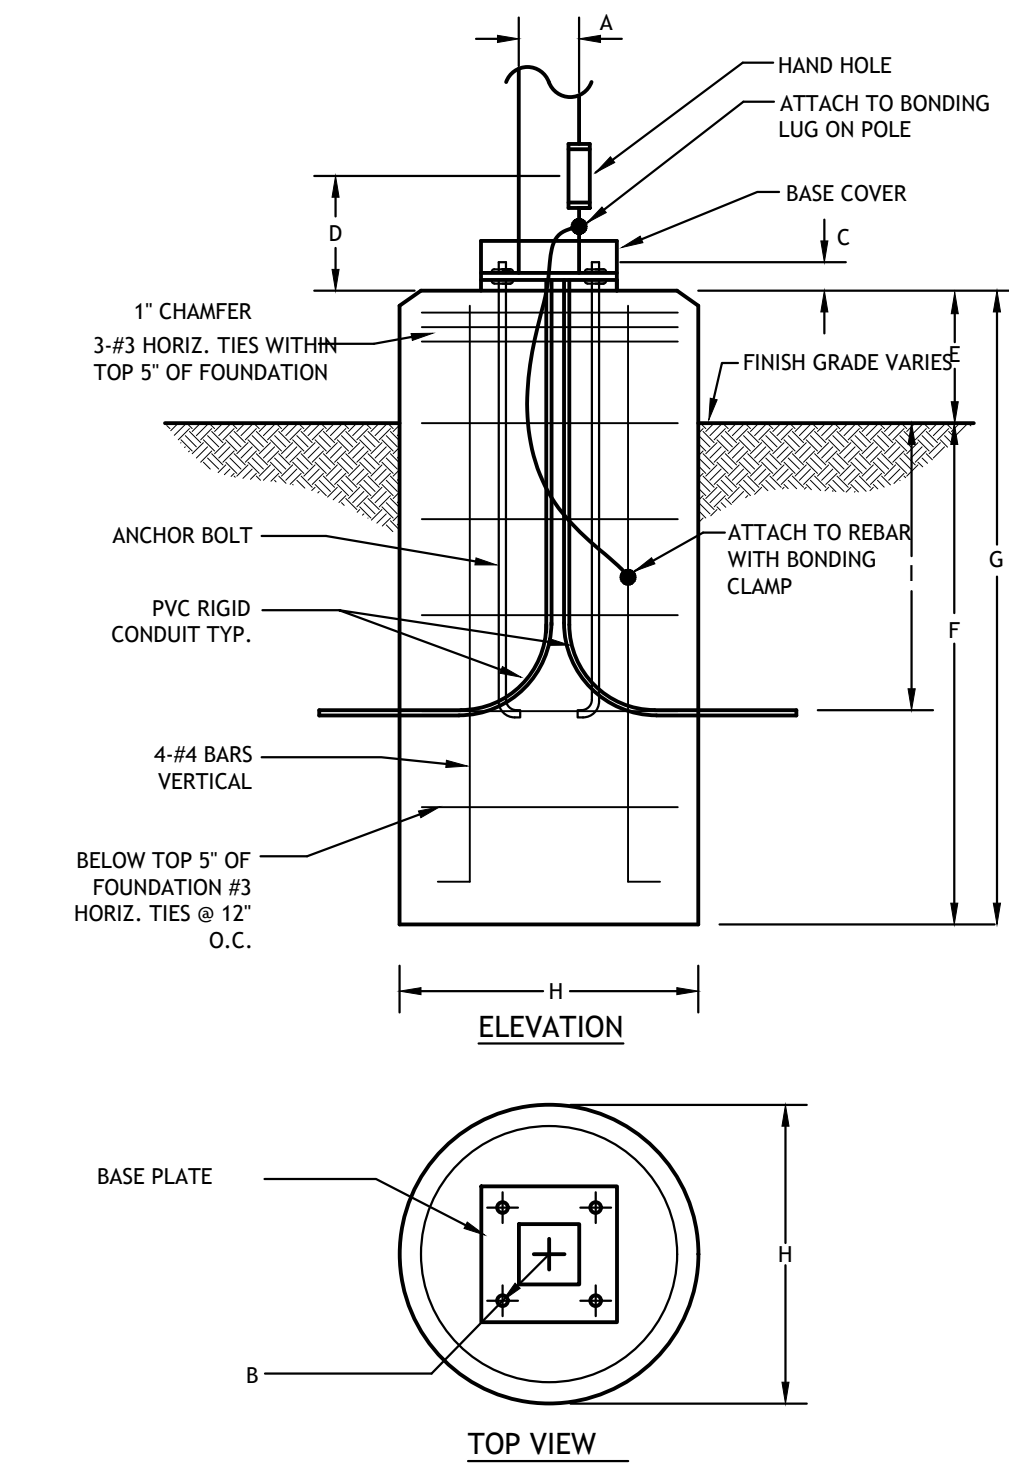


| POLE KEY | OVERALL HEIGHT | A | ANCHOR BOLT DATA | | | D | E | F | G | H | I |
|----------|----------------|---------|------------------|------|---|---|------|------|-------|-----|-----|
| | | | B | SIZE | C | | | | | | |
| EA3 | 25'0" | 4" | PER MANUFACTURER | | | | 2'0" | 8'0" | 10'0" | 24" | 36" |
| E44 | 14'0" | 4" | PER MANUFACTURER | | | | 8" | 6'0" | 6'8" | 10' | 36" |
| E45 | 16'0" | 3.5'x6" | PER MANUFACTURER | | | | 8" | 6'0" | 6'8" | 24" | 36" |
| E46 | 25'0" | 4" | PER MANUFACTURER | | | | 2'0" | 8'0" | 10'0" | 24" | 36" |
| EB1 | 4'0" | 6" | PER MANUFACTURER | | | | 0'0" | 3'0" | 3'0" | 8" | 24" |
| E83 | 22' | 1" | 10" GROUND STAKE | | | | 0'0" | 2'0" | 2'0" | 4" | 18" |

1 | POLE AND BOLLARD BASE DETAIL

| | |
|--------|-------------|
| LE-000 | SCALE: NONE |
|--------|-------------|

1. THE CONTRACTOR SHALL PROVIDE ALL LABOR AND MATERIAL NECESSARY FOR A COMPLETE AND FUNCTIONING LIGHTING SYSTEM.
2. MATERIALS AND INSTALLATION SHALL COMPLY WITH CODES, LAWS AND ORDINANCES OF FEDERAL, STATE AND LOCAL GOVERNING BODIES HAVING JURISDICTION.
3. ELECTRICAL COMPONENTS, DEVICES, AND ACCESSORIES SHALL BE LISTED AND LABELED AS DEFINED IN NFPA 70, ARTICLE 100, BY A TESTING AGENCY ACCEPTABLE TO AUTHORITIES HAVING JURISDICTION, AND MARKED FOR INTENDED USE.
4. ALL WORK REQUIRED FOR THE INSTALLATION AS SHOWN ON DRAWINGS INCLUDING LABOR, EQUIPMENT AND MATERIALS SHALL BE IN COMPLIANCE WITH THE BUILDING STANDARDS, NOTICES AS NOTED OTHERWISE.
5. THE CONTRACTOR SHALL NOTIFY THE ARCHITECT/ LTG DESIGNER/OWNER OF ANY MATERIALS OR APPARATUS BELIEVED TO BE INADEQUATE, UNSUITABLE, IN VIOLATION OF LAWS, ORDINANCES, RULES OR REGULATIONS OF AUTHORITIES HAVING JURISDICTION.
6. FOR ALL LUMINAIRES THAT ARE EXISTING TO REMAIN OR EXISTING TO BE RELOCATED, EC SHALL BE RESPONSIBLE FOR REMOVAL, STORAGE, CLEANING, AND RE-INSTALLATION, WITH WHATEVER NECESSARY REPLACEMENT WITH NEW LAMP, LUM.
7. THE CONTRACTOR SHALL CAREFULLY EXAMINE THE CONTRACT DOCUMENTS, VISIT THE SITE, AND THOROUGHLY BECOME FAMILIAR WITH THE BUILDING STANDARDS AND LOCAL CONDITIONS RELATING TO THE WORK. FAILURE TO DO SO WILL NOT RELIEVE THE CONTRACTOR OF THE OBLIGATIONS OF THE CONTRACT.
8. ALL MATERIALS, AND EQUIPMENT SHALL BE ERECTED, INSTALLED, CONNECTED, CLEANED, ADJUSTED, TESTED, COMMISSIONED, AND PLACED IN SERVICE IN ACCORDANCE WITH THE MANUFACTURERS DIRECTIONS AND RECOMMENDATIONS.
9. SUBMITTALS AND/OR SHOP DRAWINGS SHALL INCLUDE MANUFACTURERS NAMES, CATALOG NUMBERS, CUT SHEETS, DIMENSIONS AND SUCH DESCRIPTIVE DATA AS MAY BE REQUIRED TO IDENTIFY AND REVIEW THE EQUIPMENT. SUBMITTALS SHALL BE IN LOGICAL GROUPS, FOR EXAMPLE, ALL LIGHTING FIXTURES. PARTIAL SUBMITTALS WILL NOT BE REVIEWED.
10. SUBMIT (1) DIGITAL COPY OF THE FOLLOWING SUBMITTALS AND/OR SHOP DRAWINGS FOR REVIEW
- A. LIGHT FIXTURES
 - B. CUSTOM LIGHT FIXTURES
 - C. LIGHTING CONTROLS
 - D. LAMPS
 - E. LAMP LIST:
11. THE ELECTRICAL CONTRACTOR SHALL PROVIDE OWNER A COMPLETE LIST OF ALL INSTALLED FIXTURES INCLUDING INTEGRAL LED AND/OR LAMPS UTILIZED ON THE PROJECT FOR FUTURE MAINTENANCE. INCLUDE MANUFACTURER AND CATALOG INFORMATION FOR LAMP, OR FUTURE DRIVER COMBINATION, PROVIDE SOURCE, LUMEN OUTPUT, VOLTAGE, AND COLOR TEMPERATURE, ALONG WITH CONTACT NAME AND PHONE NUMBER. REFER TO RE-ORDERING.
12. IF AN ALTERNATE OR VALUE ENGINEERED FIXTURE PACKAGE IS PROVIDED, IT IS THE RESPONSIBILITY OF THE SUBMITTING PARTY TO VERIFY THAT THE PROPOSED PACKAGE MEETS THE SPECIFIED CONTROL INTENT AND IS COMPATIBLE WITH THE LIGHTING CONTROL SYSTEM PROVIDED. ANY CHANGES TO THE LIGHTING CONTROL SYSTEM, SUCH AS BY MODIFICATION TO THE FIXTURE PACKAGE MUST BE APPROVED BY LIGHTING DESIGNER AND ELECTRICAL ENGINEER AND COORDINATED PRIOR TO RELEASE OF LIGHTING CONTROL SHOP DRAWINGS.
13. ALL EXPOSED CONDUIT SHALL BE CONCEALED TO THE GREATEST EXTENT POSSIBLE, AND SHALL BE INSTALLED PARALLEL AND CLOSE TO STRUCTURAL MEMBERS. COORDINATE PAINTING REQUIREMENTS TO MATCH ADJACENT FINISHES WITH ARCHITECT.
14. ALL WALL-MOUNTED LUMINAIRES SHALL HAVE LOCATIONS AND MOUNTING HEIGHTS CONFORMED WITH ARCHITECTURAL ELEVATIONS AND OWNER PRIOR TO ROUGH-IN. ANY ADJUSTMENT TO MOUNTING HEIGHTS REQUIRED BY LACK OF COORDINATION WILL BE AT THE CONTRACTORS EXPENSE.
15. REFER TO THE ELECTRICAL ENGINEERS DRAWINGS FOR SPECIFICATIONS AND LAYOUT OF ALL EMERGENCY LUMINAIRES AND ALL REQUIRED CIRCUITING.
16. ALL FIXTURES SHALL BE CIRCUITED SUCH THAT CIRCUIT LENGTH AND CONDUCTOR SIZING MINIMIZES VOLTAGE DROP TO A MAXIMUM OF 3%. CONTROL ZONING IS SHOWN FOR DESIGN INTENT ONLY.
17. ALL DIMMED LIGHTING CIRCUITS ARE TO RECEIVE DESIGNATED NEUTRALS.
18. REFER TO THE LUMINAIRE SCHEDULE FOR INFORMATION REGARDING THE ALTERNATE FIXTURE SUBSTITUTION PROCESS. ALL SUBSTITUTIONS MUST BE APPROVED IN WRITING BY AE DESIGN.
19. THE ELECTRICAL CONTRACTOR SHALL PROVIDE NEMA 3P AND CORROSION RESISTANT ENCLOSURES FOR ANY REMOTE POWER SUPPLIES OR DRIVERS LOCATED OUTDOORS OR WITHIN AN INDOOR WET/DAMP/CORROSIVE ENVIRONMENT. CONCEAL IN AN ACCESSIBLE LOCATION.
20. FIXTURES THAT APPEAR TO BE CENTERED IN A SPACE OR CEILING PANEL SHOULD BE CENTERED, UNLESS REFER TO ARCHITECT'S REFLECTED CEILING PLANS) FOR THE DESIGNING INTENT. IF FIELD CONDITION OR CONFLICT REQUIRES THE RELOCATION OF A FIXTURE, PROVIDE RFI FOR ARCHITECT AND LIGHTING DESIGNERS APPROVAL.
21. FOR ALL SPECIFIC LUMINAIRES, THE ELECTRICAL CONTRACTOR SHALL BE RESPONSIBLE FOR PROVIDING ALL MOUNTING HARDWARE, ACCESSORIES, COMPONENTS, LEADER/JUNIOR CABLES, WIRE FEED, CONNECTORS, END CAPS, REMOTE POWER SUPPLIES, AND ANY OTHER NECESSARY COMPONENT AS REQUIRED FOR INSTALLING A SECURE AND FULLY FUNCTIONAL SYSTEM.
22. REFER TO LIGHTING DETAILS SHEET FOR FIXTURE INSTALLATION REQUIREMENTS INCLUDING MOUNTING INFORMATION AND ALL MOUNTING INFORMATION. CONCEAL LUMINAIRES AND ASSOCIATED WIRING FROM TOPALITY VIEWING ANGLES.
23. FOR LINEAR LUMINAIRES INSTALLED WITHIN A COVE OR OTHER CONTINUOUS LINEAR APPLICATION, THE ELECTRICAL CONTRACTOR SHALL FIELD VERIFY OVERALL AVAILABLE MOUNTING DIMENSIONS PRIOR TO ORDERING THE FIXTURE. LINEAR LUMINAIRES SHALL BE ORDERED CONTINUOUSLY TO MATCH THE AVAILABLE MOUNTING DIMENSIONS AS INDICATED ON THE DRAWINGS. THE LINEAR LUMINAIRE SHALL BE PROVIDED IN A SYMMETRICAL CONFIGURATION IN NECESSARY LENGTHS SUCH THAT FIXTURES ARE WITHIN A MINIMUM DISTANCE FROM THE END OF ASSOCIATED COVE, NOT TO EXCEED ONE-HALF THE LUMINAIRE'S SHORTEST AVAILABLE LENGTH, NO EXCEPTIONS.

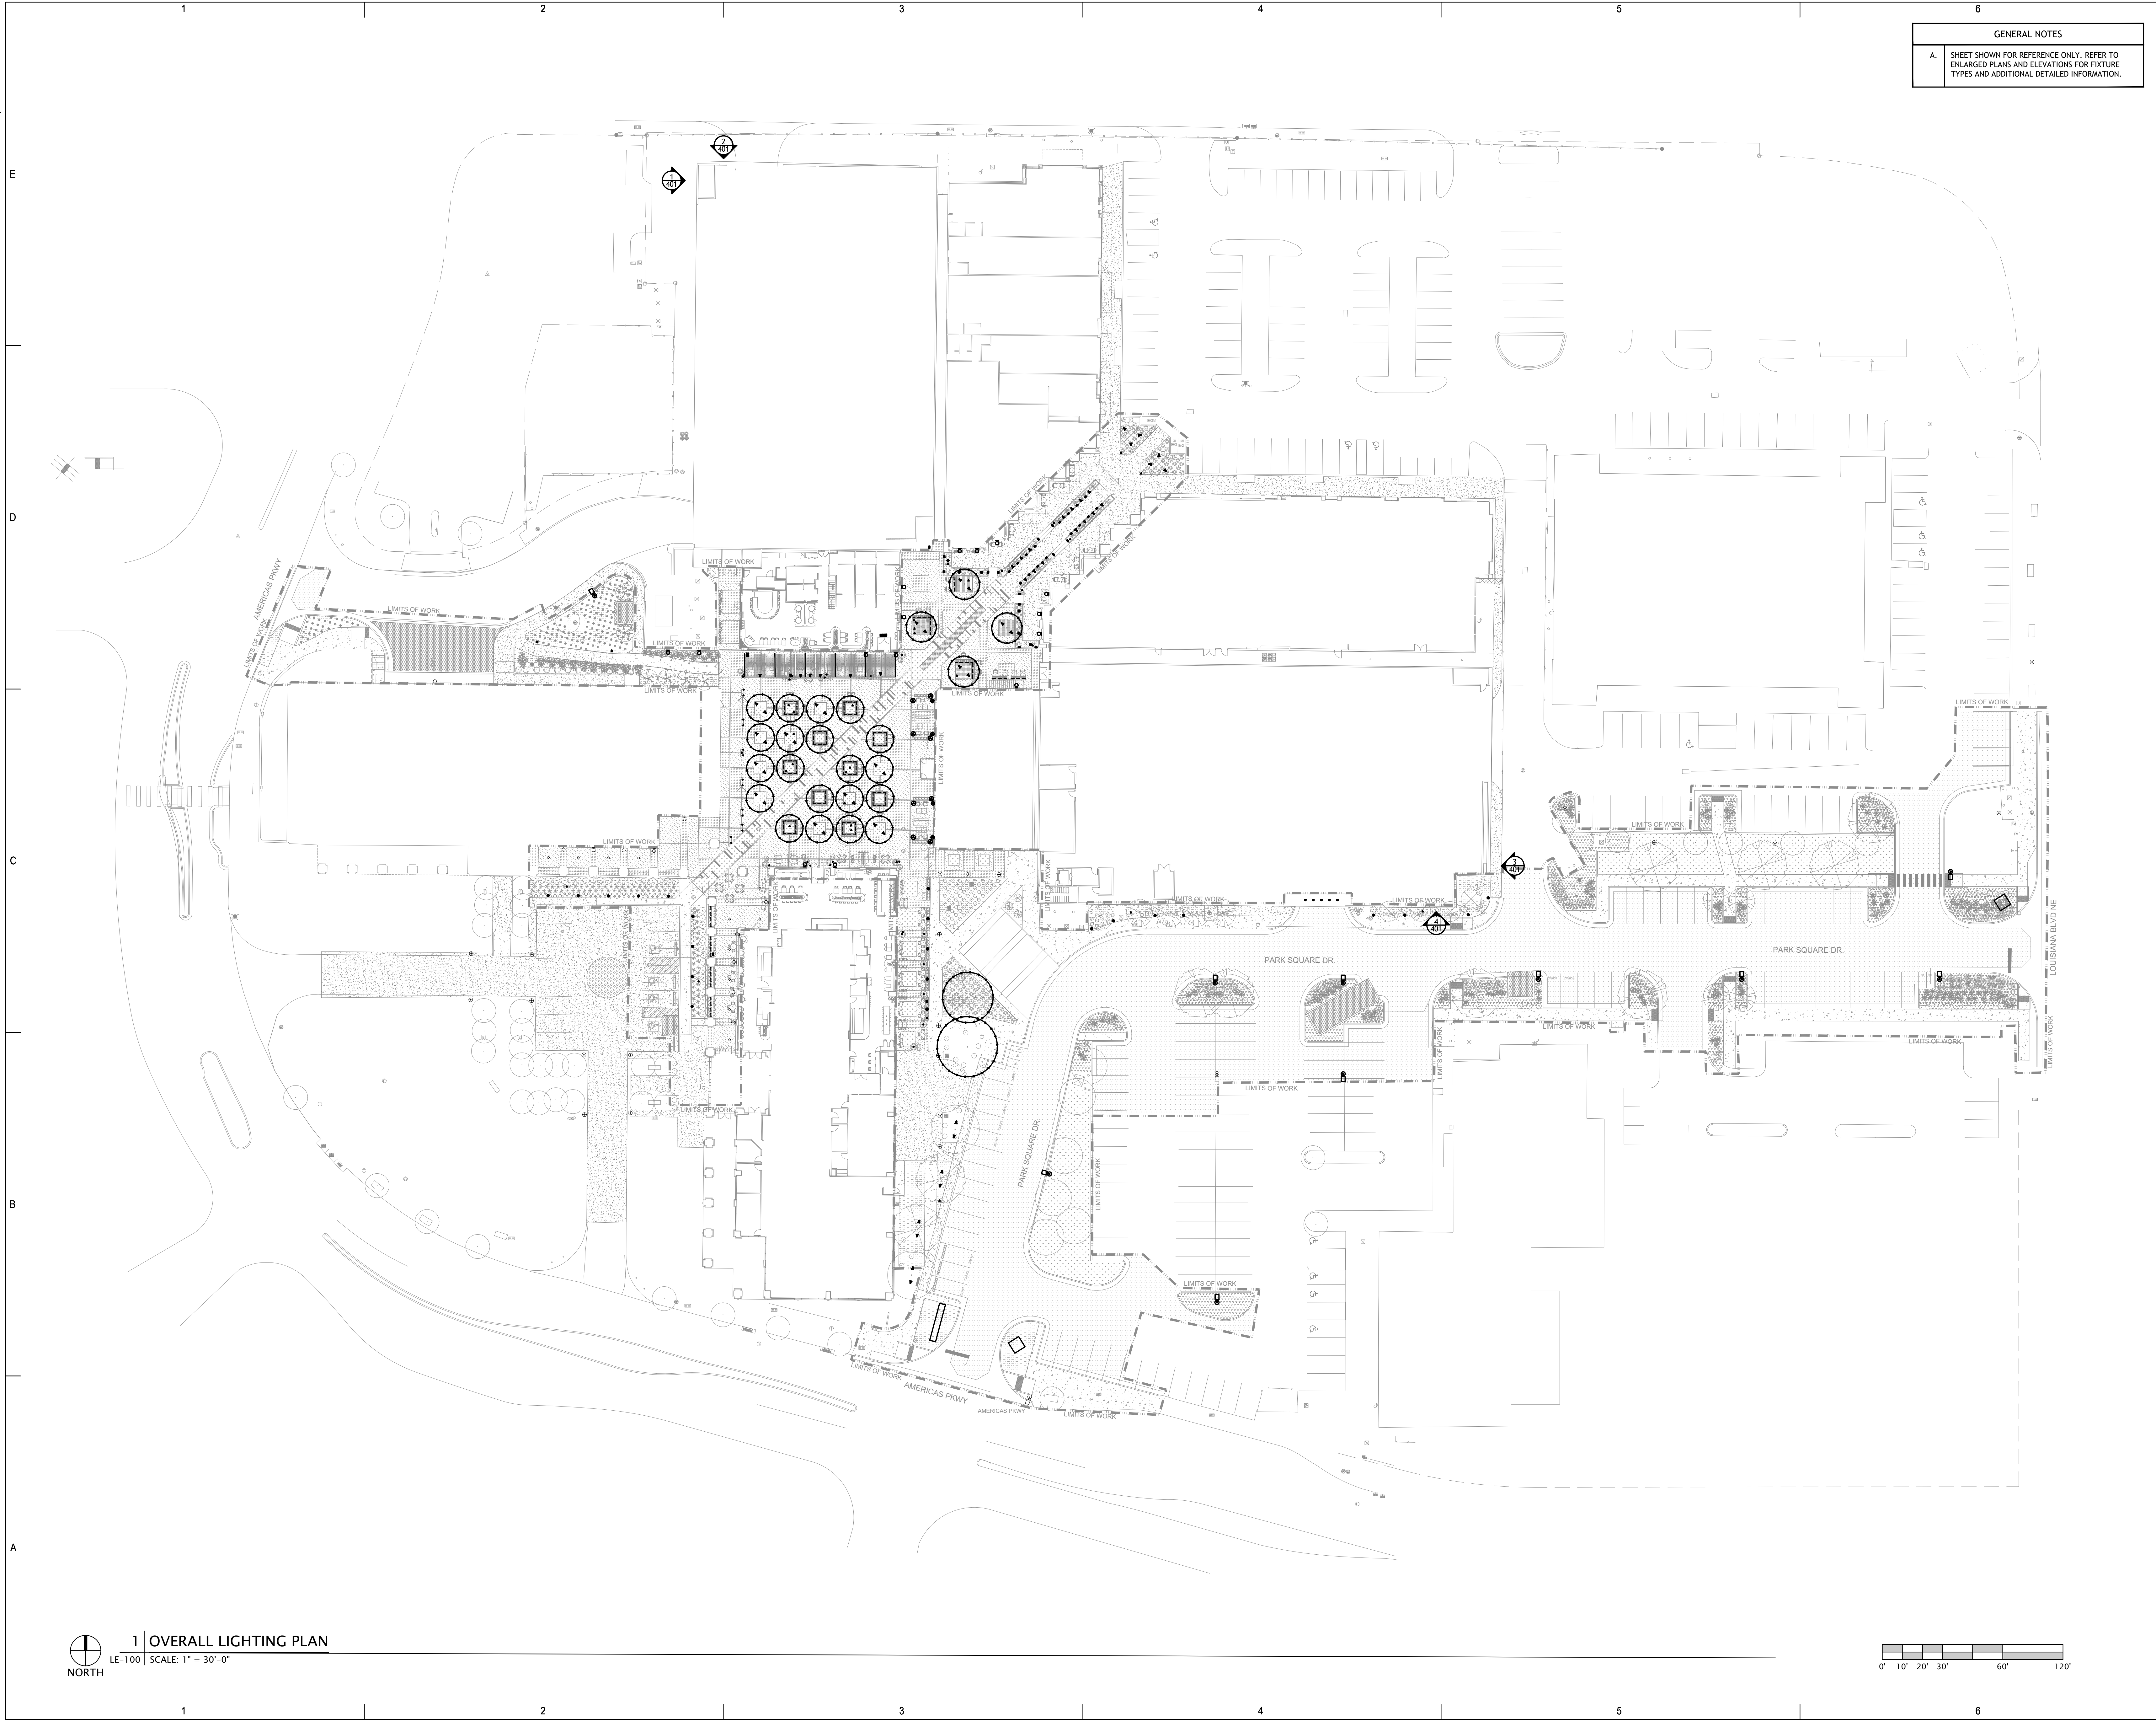

| GENERAL NOTES | |
|---------------|---|
| A. | SHEET SHOWN FOR REFERENCE ONLY. REFER TO ENLARGED PLANS AND ELEVATIONS FOR FIXTURE TYPES AND ADDITIONAL DETAILED INFORMATION. |

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aedesign-inc.com Project # 5883.00



Park Square Plaza Renovation

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ALBUQUERQUE, NM 87110

APRIL 2024

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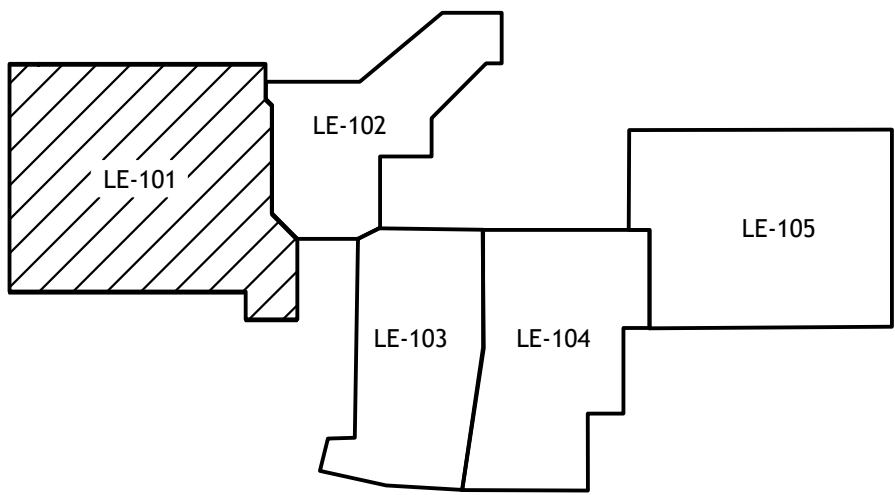
SHEET TITLE

OVERALL LIGHTING PLAN

LE-100



| GENERAL NOTES | |
|--|--|
| A. | AREAS OUTSIDE OF LIMITS OF WORK BOUNDARY ARE NOT IN SCOPE OF THIS PROJECT. |
| B. | REFER TO ELECTRICAL ENGINEERS DRAWINGS FOR REQUIRED CIRCUITING. |
| C. | PER CONCETTA TRUJILLO WITH CITY OF ALBUQUERQUE, UPLIGHTING PERMITTED. ALL UPLIGHTING SHALL BE CONTAINED WITHIN PROPERTY LINES, UTILIZE SHIELDING FOR GLARE AND BE AIMED TOWARDS BUILDING FACADE AND LANDSCAPE FEATURES 50 AS TO NOT TRANSVERSE OFF THE SITE. |
| D. | REMOTE DRIVERS ARE SHOWN FOR DESIGN INTENT ONLY FOR THE PURPOSES OF PRICING AND SHALL BE LOCATED IN A NEARBY CONCEALED, AND ACCESSIBLE AREA AS COORDINATED WITH ARCHITECT, LANDSCAPE ARCHITECT, AND ELECTRICAL ENGINEER. |
| E. | FOR ALL LOW VOLTAGE LIGHTING, RE: ELEC FOR LINE VOLTAGE FEED LOCATIONS. CONTRACTOR SHALL PROVIDE SUFFICIENT SLACK IN LOW VOLTAGE WIRING TO ALLOW FOR FINAL ADJUSTMENT OF LIGHTING ON SITE WITH OWNER, ARCHITECT/ INTERIOR DESIGNER AND/OR LANDSCAPE ARCHITECT. |
| KEYNOTE LEGEND | |
| KEY | VALUE |
| ◊ | |
| 1. | WALL SCONCE IS EXISTING TO REMAIN. CLEAN AND RELAMP WITH 2700K / 90 CRI LED. SUBMIT LAMP FOR APPROVAL BY LIGHTING DESIGNER. LIGHTING CONTROL SHALL BE EXISTING TO REMAIN. |
| 2. | REPLACE EXISTING PARKING LOT POLE LIGHT WITH NEW IN EXISTING LOCATION. REPLACE WITH NEW CONCRETE BASE, 16" POLE, AND HEAD AS SPECIFIED. INTERCEPT EXISTING PARKING LOT LIGHTING CIRCUITING AND CONTROLS FEEDING ADJACENT PARKING LOT LUMINAIRES. |
| 3. | EXISTING 11FT OVERALL PEDESTRIAN LIGHTING BASE AND POLE SHALL REMAIN. EXISTING LUMINAIRE LAMP SHALL BE REMOVED AND REPLACED WITH NEW DIMMABLE LED LAMP AS SPECIFIED. LIGHTING CONTROL SHALL BE EXISTING TO REMAIN. |
| 4. | DOWNLIGHT IS EXISTING TO REMAIN. CLEAN AND RELAMP WITH 2700K / 90 CRI LED. SUBMIT LAMP FOR APPROVAL BY LIGHTING DESIGNER. LIGHTING CONTROL SHALL BE EXISTING TO REMAIN. |
| 5. | EC SHALL REMOVE EXISTING FIXTURE AND REPLACE WITH NEW FIXTURE IN EXISTING LOCATION. LIGHTING SHALL REMAIN ON EXISTING CIRCUITRY AND CONTROLS. |
| SEQUENCE OF OPERATIONS GENERAL NOTES | |
| THE FOLLOWING CONTROL SEQUENCE OF OPERATIONS ARE UTILIZED IN THIS PLAN. REFER TO PLAN AND/OR ZONE/RELAY SCHEDULE FOR SPECIFIC ASSOCIATED SEQUENCE. | |
| ◊ | ET1 |
| ◊ | ET2 |
| ◊ | ET3 |
| ◊ | ET4 |



2 KEYMAP
LE-101 SCALE: 1"=0" = 200'

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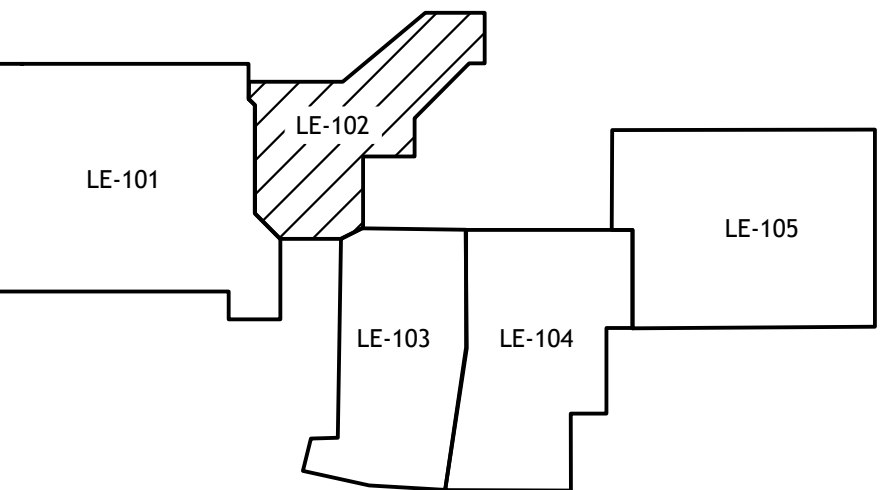
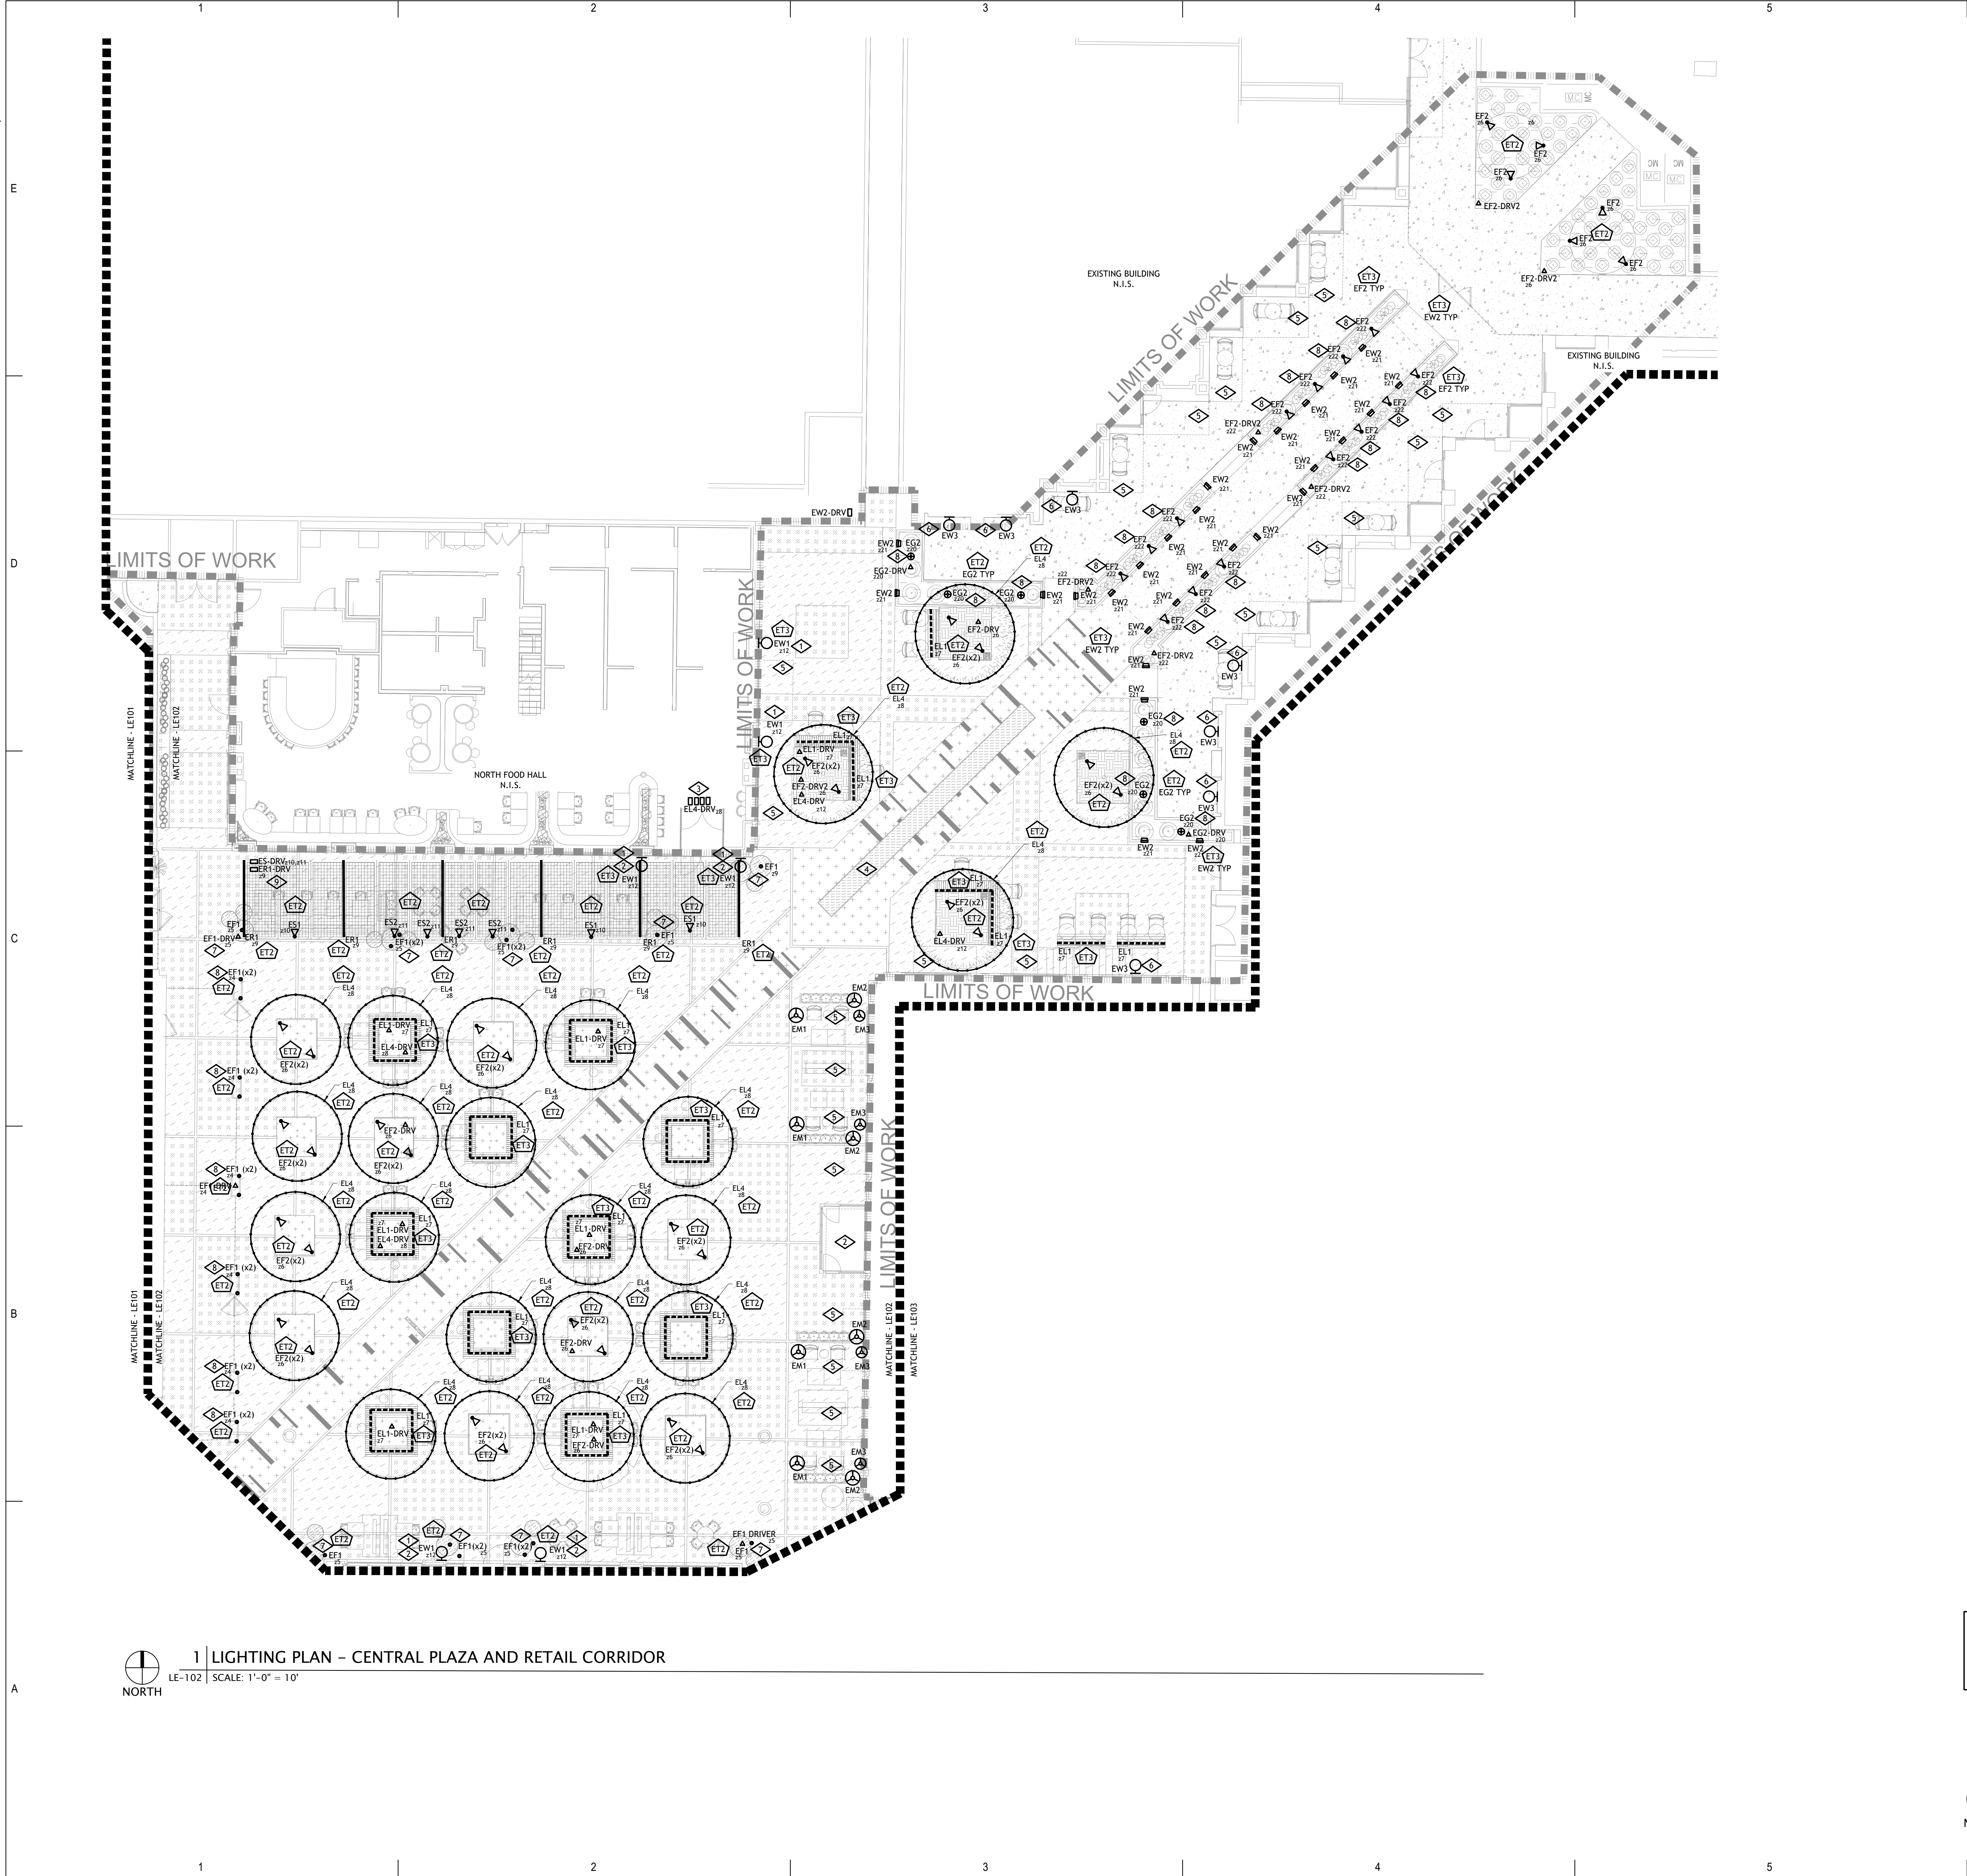
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| DRAWN BY: | AEC,CK,EB |
| CHECKED BY: | AJS,MRS |

SHEET TITLE
LIGHTING PLAN

LE-101



| GENERAL NOTES | |
|--|--|
| A. | HATCHED AREAS ARE NOT IN SCOPE OF THIS PROJECT. |
| B. | REFER TO ELECTRICAL ENGINEERS DRAWINGS FOR REQUIRED CIRCUITING. |
| C. | PER CONCETTA TRUJILLO WITH CITY OF ALBUQUERQUE, UPLIGHTING PERMITTED. ALL UPLIGHTING SHALL BE CONTAINED WITHIN PROPERTY LINES, UTILIZE SHIELDING FOR GLARE AND BE AIMED TOWARDS BUILDING FACADE AND LANDSCAPE FEATURES SO AS TO NOT TRANSVERSE OFF THE SITE. |
| D. | REMOTE DRIVERS ARE SHOWN FOR DESIGN INTENT ONLY FOR THE PURPOSES OF PRICING AND SHALL BE LOCATED IN A NEARBY CONCEALED, AND ACCESSIBLE AREA AS COORDINATED WITH ARCHITECT, LANDSCAPE ARCHITECT, AND ELECTRICAL ENGINEER. |
| E. | FOR ALL LOW VOLTAGE LIGHTING, RE: ELEC FOR LINE VOLTAGE FEED LOCATIONS, CONTRACTOR SHALL PROVIDE SUFFICIENT SLACK IN LOW VOLTAGE WIRING TO ALLOW FOR FINAL ADJUSTMENT OF LIGHTING ON SITE WITH OWNER, ARCHITECT/INTERIOR DESIGNER AND/OR LANDSCAPE ARCHITECT. |
| KEYNOTE LEGEND | |
| KEY | VALUE |
| | |
| 1. | CONTRACTOR SHALL COORDINATE EXACT ROUGH-IN LOCATION FOR JUNCTION BOX MOUNTING HEIGHT AND DETAIL WITH ARCHITECT AND OWNER. |
| 2. | REFER TO INTERIOR FOOD HALL DRAWINGS FOR CANOPY STRUCTURAL DETAILING. CONTRACTOR SHALL PROVIDE CONCEALED LOW VOLTAGE WIRING FOR CANOPY MOUNTED LIGHTING ROUTED THROUGH STRUCTURAL BEAM, RE-ARCH/ELEC. |
| 3. | REMOTE DRIVER QTY TBD PENDING OVERALL FIXTURE RUN LENGTHS WHICH SHALL BE DETERMINED BY A TREE LIGHTING MOCK-UP WITH OWNER. CONTRACTOR TO COORDINATE MOUNTING LOCATION FOR REMOTE DRIVERS PER EE/ARCHITECT. |
| 4. | FUTURE LIGHTING WITHIN REFLECTING FOUNTAIN SHALL BE TBD PENDING DESIGN BUILD COORDINATION WITH OWNER. |
| 5. | EXISTING CANOPY LUMINAIRES AND ASSOCIATED LIGHTING CONTROL SHALL REMAIN. CONTRACTOR SHALL COORDINATE WITH OWNER'S MAINTENANCE STAFF TO DE-ENERGIZE THE CIRCUIT. OWNER'S MAINTENANCE STAFF SHALL REPLACE EXISTING FIXTURE (1) FOR (1) WITH NEW 2200K LED FIXTURE IN UPLIGHT POSITION (JUL50-E-12-06-22-90-MULT-120- BY ECOSENSE) IF ADDITIONAL LIGHT IS DESIRED. |
| 6. | EC SHALL REMOVE EXISTING FIXTURE AND REPLACE WITH NEW FIXTURE IN EXISTING LOCATION. LIGHTING SHALL REMAIN ON EXISTING CIRCUITRY FOR CONTROL. |
| 7. | EC SHALL RUN LOW VOLTAGE WIRING FOR LIGHTING TO BOTTOM OF POT AND COORDINATE LOCATIONS FOR LINE VOLTAGE CONNECTIONS TO REMOTE DRIVERS, RE: ELECTRICAL. CONTRACTOR SHALL SUBMIT SHOP DRAWINGS OF PROPOSED WIRE ROUTING AND DRIVER INSTALLATION FOR ARCHITECT, ELECTRICAL ENGINEER, LANDSCAPE, AND LIGHTING DESIGNER REVIEW AND OWNER APPROVAL. CONTRACTOR SHALL CONFIRM OWNER SUPPLIED POT SPECIFICATION HAS DEDICATED PATHWAY FOR ELECTRICAL WIRING. |
| 8. | EC SHALL RUN LOW VOLTAGE WIRING FOR LIGHTING TO BOTTOM OF PLANTER AND COORDINATE LOCATIONS FOR LINE VOLTAGE CONNECTIONS TO REMOTE DRIVERS, RE: ELECTRICAL. CONTRACTOR SHALL COORDINATE WIRING RUNS WITH LANDSCAPE ARCHITECT RE: PLANTER SPECIFICATION. REFER TO B1/L-503 FOR MOUNTING DETAIL. |
| 9. | EC SHALL COORDINATE EXACT LOCATION OF REMOTE DRIVERS WITH CANOPY ELECTRICAL. LOCATE ABOVE CANOPY IN CONCEALED, ACCESSIBLE LOCATION. |
| SEQUENCE OF OPERATIONS GENERAL NOTES | |
| THE FOLLOWING CONTROL SEQUENCE OF OPERATIONS ARE UTILIZED IN THIS PLAN. REFER TO PLAN AND/OR ZONE RELAY SCHEDULE FOR SPECIFIC ASSOCIATED SEQUENCE. | |
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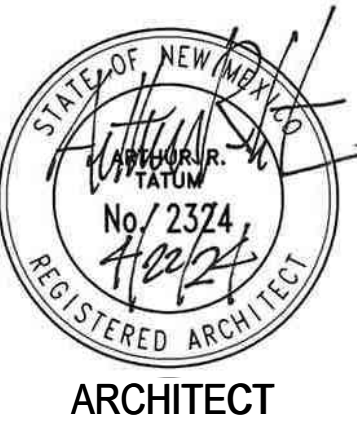
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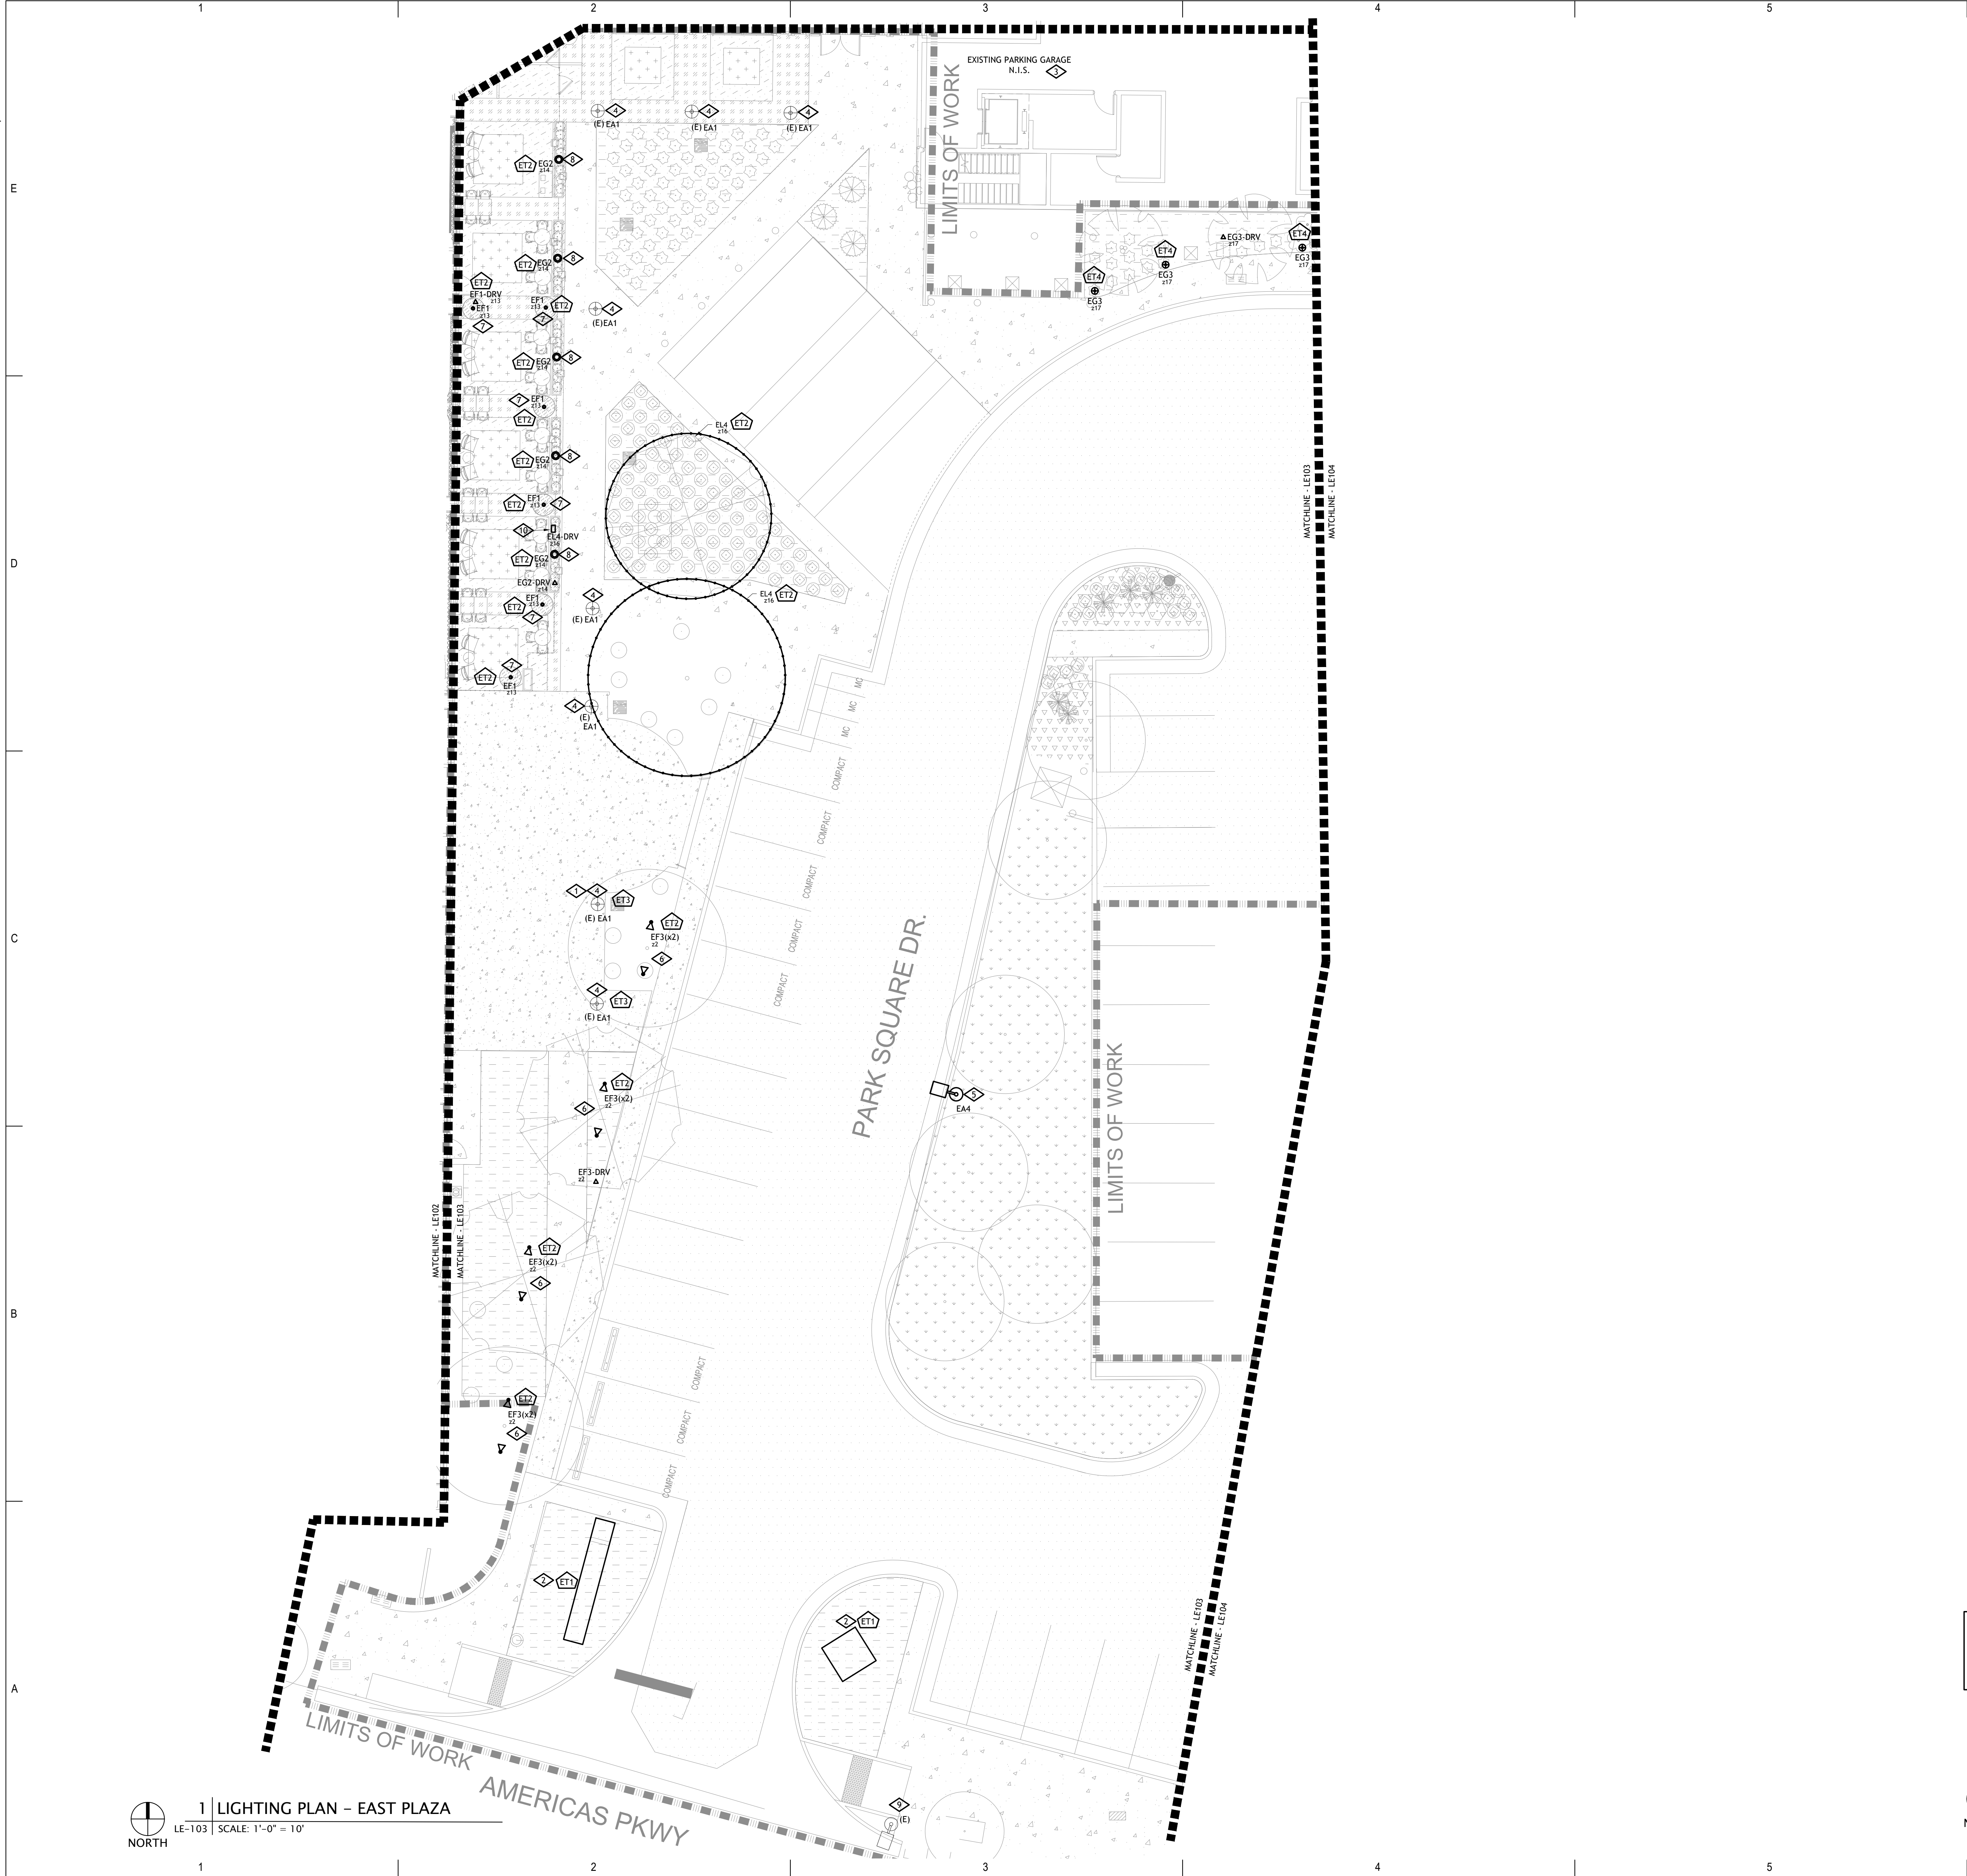
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| CHECKED BY: | AJS,MRS |

SHEET TITLE

LIGHTING PLAN

LE-102



GENERAL NOTES

A. HATCHED AREAS ARE NOT IN SCOPE OF THIS PROJECT.

B. REFER TO ELECTRICAL ENGINEERS DRAWINGS FOR REQUIRED CIRCUITING.

C. PER CONCETTA TRUJILLO WITH CITY OF ALBUQUERQUE, UPLIGHTING PERMITTED. ALL UPLIGHTING SHALL BE CONTAINED WITHIN PROPERTY LINES, UTILIZE SHIELDING FOR GLARE AND BE AIMED TOWARDS BUILDING FACADE AND LANDSCAPE FEATURES SO AS TO NOT TRANSVERSE OFF THE SITE.

D. REMOTE DRIVERS ARE SHOWN FOR DESIGN INTENT ONLY FOR THE PURPOSES OF PRICING AND SHALL BE LOCATED IN A NEARBY CONCEALED, AND ACCESSIBLE AREA AS COORDINATED WITH ARCHITECT, LANDSCAPE ARCHITECT, AND ELECTRICAL ENGINEER.

E. FOR ALL LOW VOLTAGE LIGHTING, RE: ELEC FOR LINE VOLTAGE FEED LOCATIONS, CONTRACTOR SHALL PROVIDE SUFFICIENT SLACK IN LOW VOLTAGE WIRING TO ALLOW FOR FINAL ADJUSTMENT OF LIGHTING ON SITE WITH OWNER, ARCHITECT, INTERIOR DESIGNER AND/OR LANDSCAPE ARCHITECT.

KEYNOTE LEGEND

| KEY | VALUE |
|-----|-------|
| | |

- EXISTING LUMINAIRE IN THIS LOCATION IS NOT WORKING. EC SHALL TROUBLESHOOT EXISTING ELECTRICAL TO REPAIR LIGHTING FOR FUNCTIONAL ILLUMINATION.
- ILLUMINATED SIGNAGE IS SHOWN FOR REFERENCE PURPOSES ONLY. SIGNAGE IS PENDING OWNERSHIP DESIGN DIRECTION AND SHALL BE PROVIDED BY SIGNAGE MANUFACTURER. SIGNAGE SHALL BE 3000K OR WARMER COLOR TEMPERATURE. ILLUMINATED SIGNAGE MOCK-UP WITH OWNER SHALL BE PROVIDED BY CONTRACTOR PRIOR TO FINAL APPROVAL.
- EXISTING LIGHTING FIXTURE AND ASSOCIATED LIGHTING CONTROL SHALL REMAIN.
- EXISTING 16FT OVERALL PEDESTRIAN LIGHTING BASE AND POLE SHALL REMAIN. EXISTING LUMINAIRE LAMP SHALL BE REMOVED AND REPLACED WITH NEW DIMMABLE LED LAMP AS SPECIFIED. LIGHTING CONTROL SHALL BE EXISTING TO REMAIN.
- LOCATION OF NEW PARKING LOT POLE AND LUMINAIRE HEAD, CONTRACTOR SHALL INTERCEPT EXISTING LIGHTING CIRCUIT/CONTROLS FEEDING ADJACENT PARKING LOT LUMINAIRES.
- CONTRACTOR TO INSTALL LOW VOLTAGE TREE UPLIGHTING WITH ASSOCIATED DIMMABLE TRANSFORMER PROVIDED BY OWNER.
- EC SHALL RUN LOW VOLTAGE WIRING FOR LIGHTING TO BOTTOM OF POT AND COORDINATE LOCATIONS FOR LINE VOLTAGE CONNECTIONS TO REMOTE DRIVERS, RE: ELECTRICAL. CONTRACTOR SHALL SUBMIT SHOP DRAWINGS OF PROPOSED WIRE ROUTING AND DRIVER INSTALLATION FOR ARCHITECT, ELECTRICAL ENGINEER, LANDSCAPE, AND LIGHTING DESIGNER REVIEW AND OWNER APPROVAL. CONTRACTOR SHALL CONFIRM OWNER SUPPLIED POT SPECIFICATION HAS DEDICATED PATHWAY FOR ELECTRICAL WIRING.
- EC SHALL RUN LOW VOLTAGE WIRING FOR LIGHTING TO BOTTOM OF PLANTER AND COORDINATE LOCATIONS FOR LINE VOLTAGE CONNECTIONS TO REMOTE DRIVERS, RE: ELECTRICAL. CONTRACTOR SHALL COORDINATE WIRING RUNS WITH LANDSCAPE ARCHITECT RE: PLANTER SPECIFICATION. REFER TO B1/L5-503 FOR MOUNTING DETAIL.
- EXISTING STREETSCAPE POLE LUMINAIRE TO REMAIN. LUMINAIRE IS PART OF OVERALL AMERICAS PKWY LIGHTING SYSTEM, OWNED AND MAINTAINED BY OTHERS, AND IS OUTSIDE THE SCOPE OF THIS PROJECT.
- EC SHALL LOCATE REMOTE DRIVER UNDER PLANTER IN CONCEALED, ACCESSIBLE AREA AS COORDINATED WITH ARCHITECT, LANDSCAPE ARCHITECT, AND ELECTRICAL ENGINEER.

THE FOLLOWING CONTROL SEQUENCE OF OPERATIONS ARE UTILIZED IN THIS PLAN. REFER TO PLAN AND/OR ZONE/RELAY SCHEDULE FOR SPECIFIC ASSOCIATED SEQUENCE.

2

KEYMAP

LE-103

SCALE: 1"=0" = 200'

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aedesign-nm.com | Project # 5883.00

STATE OF NEW MEXICO

ARCHITECT

No. 23324

REGISTERED ARCHITECT

Park Square Plaza Renovation

100% CD

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ALBUQUERQUE, NM 87110

APRIL 2024

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DATE:

APRIL 2024

PROJECT NO:

5883.00

DRAWN BY:

AEC,CK,EB

CHECKED BY:

AJS,MRS

SHEET TITLE


LIGHTING PLAN

LE-103



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1 LIGHTING PLAN - EAST PLAZA

LE-103 SCALE: 1"=0" = 10'

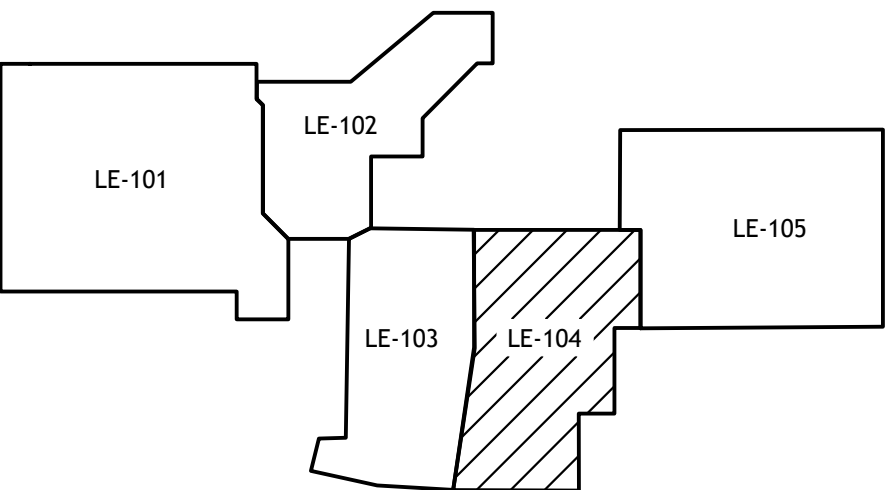


2 KEYMAP
LE-104 SCALE: 1"=200'



| | | |
|---|------|-------------|
| f b t architects 6501 Americas Pkwy NE., Ste. 300 Albuquerque, NM 87110 P_505.883.5200 WEB: www.fbtarch.com | | |
| CONSULTANTS | | |
| LANDSCAPE ARCHITECT Groundwork Studio 6501 Americas Pkwy NE, Ste. 350 Albuquerque, NM 87110 p_505.212.9126 | | |
| CIVIL ENGINEER NVS 6501 Americas Pkwy NE, Ste. 400 Albuquerque, NM 87110 p_505.830.8753 | | |
| <div> Integrated Lighting, Technology, and Electrical Solutions 1900 Weaver Street #205 Denver, CO 80202 303.296.3034 aedesign-inc.com Project F-5883.00</div> | | |
| <div> ARCHITECT</div> | | |
| Park Square Plaza Renovation | | |
| 100% CD | | |
| 6561 AMERICAS PKWY ALBUQUERQUE, NM 87110 | | |
| APRIL 2024 | | |
| MARK | DATE | DESCRIPTION |
| | | |
| ISSUE: | | 100% CD |
| DATE: | | APRIL 2024 |
| PROJECT NO: | | 5883.00 |
| DRAWN BY: | | AEC,C,K,E,B |
| CHECKED BY: | | AJS,MRS |
| SHEET TITLE | | |
| LIGHTING PLAN | | |
| LE-104 | | |

Park Square Plaza Renovation

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| GENERAL NOTES | |
|--|--|
| A. | HATCHED AREAS ARE NOT IN SCOPE OF THIS PROJECT. |
| B. | REFER TO ELECTRICAL ENGINEERS DRAWINGS FOR REQUIRED CIRCUITING. |
| C. | PER CONCETTA TRUJILLO WITH CITY OF ALBUQUERQUE, UPLIGHTING PERMITTED. ALL UPLIGHTING SHALL BE CONTAINED WITHIN PROPERTY LINES, UTILIZE SHIELDING FOR GLARE AND BE AIMED TOWARDS BUILDING FACADE AND LANDSCAPE FEATURES SO AS TO NOT TRANSVERSE OFF THE SITE. |
| D. | REMOTE DRIVERS ARE SHOWN FOR DESIGN INTENT ONLY FOR THE PURPOSES OF PRICING AND SHALL BE LOCATED IN A NEARBY CONCEALED, AND ACCESSIBLE AREA AS COORDINATED WITH ARCHITECT, LANDSCAPE ARCHITECT, AND ELECTRICAL ENGINEER. |
| E. | FOR ALL LOW VOLTAGE LIGHTING, RE: ELEC FOR LINE VOLTAGE FEED LOCATIONS. CONTRACTOR SHALL PROVIDE SUFFICIENT SLACK IN LOW VOLTAGE WIRING TO ALLOW FOR FINAL ADJUSTMENT OF LIGHTING ON SITE WITH OWNER, ARCHITECT/INTERIOR DESIGNER AND/OR LANDSCAPE ARCHITECT. |
| KEYNOTE LEGEND | |
| KEY | VALUE |
| 1. | ILLUMINATED SIGNAGE IS SHOWN FOR REFERENCE PURPOSES ONLY. SIGNAGE IS PENDING OWNERSHIP DESIGN DIRECTION AND SHALL BE PROVIDED BY SIGNAGE MANUFACTURER. SIGNAGE SHALL BE 3000K OR WARMER COLOR TEMPERATURE. ILLUMINATED SIGNAGE MOCK-UP WITH OWNER SHALL BE PROVIDED BY CONTRACTOR PRIOR TO FINAL APPROVAL. |
| 2. | EXISTING LIGHTING FIXTURE AND ASSOCIATED LIGHTING CONTROL SHALL REMAIN. RELAMP WITH 3000K LED LAMP EQUIVALENT TO EXISTING LAMP, WHERE POSSIBLE. |
| 3. | LOCATION OF NEW PARKING LOT POLE AND LUMINAIRE HEAD. CONTRACTOR SHALL INTERCEPT EXISTING LIGHTING CIRCUIT/CONTROLS FEEDING ADJACENT PARKING LOT LUMINAIRES. |
| 4. | EXISTING LUMINAIRE IN THIS LOCATION IS NOT WORKING. EC SHALL TROUBLESHOOT EXISTING ELECTRICAL TO REPAIR LIGHTING FOR FUNCTIONAL ILLUMINATION. |
| 5. | PARKING AND DRIVE POLE LIGHT WITH NEW CONCRETE BASE, 25' POLE AND HEAD IN NEW LOCATION. LIGHTING CONTROL SHALL BE EXISTING TO REMAIN. |
| SEQUENCE OF OPERATIONS GENERAL NOTES | |
| THE FOLLOWING CONTROL SEQUENCE OF OPERATIONS ARE UTILIZED IN THIS PLAN. REFER TO PLAN AND/OR ZONE/RELAY SCHEDULE FOR SPECIFIC ASSOCIATED SEQUENCE. | |
| E11 | E12 |
| E13 | E14 |

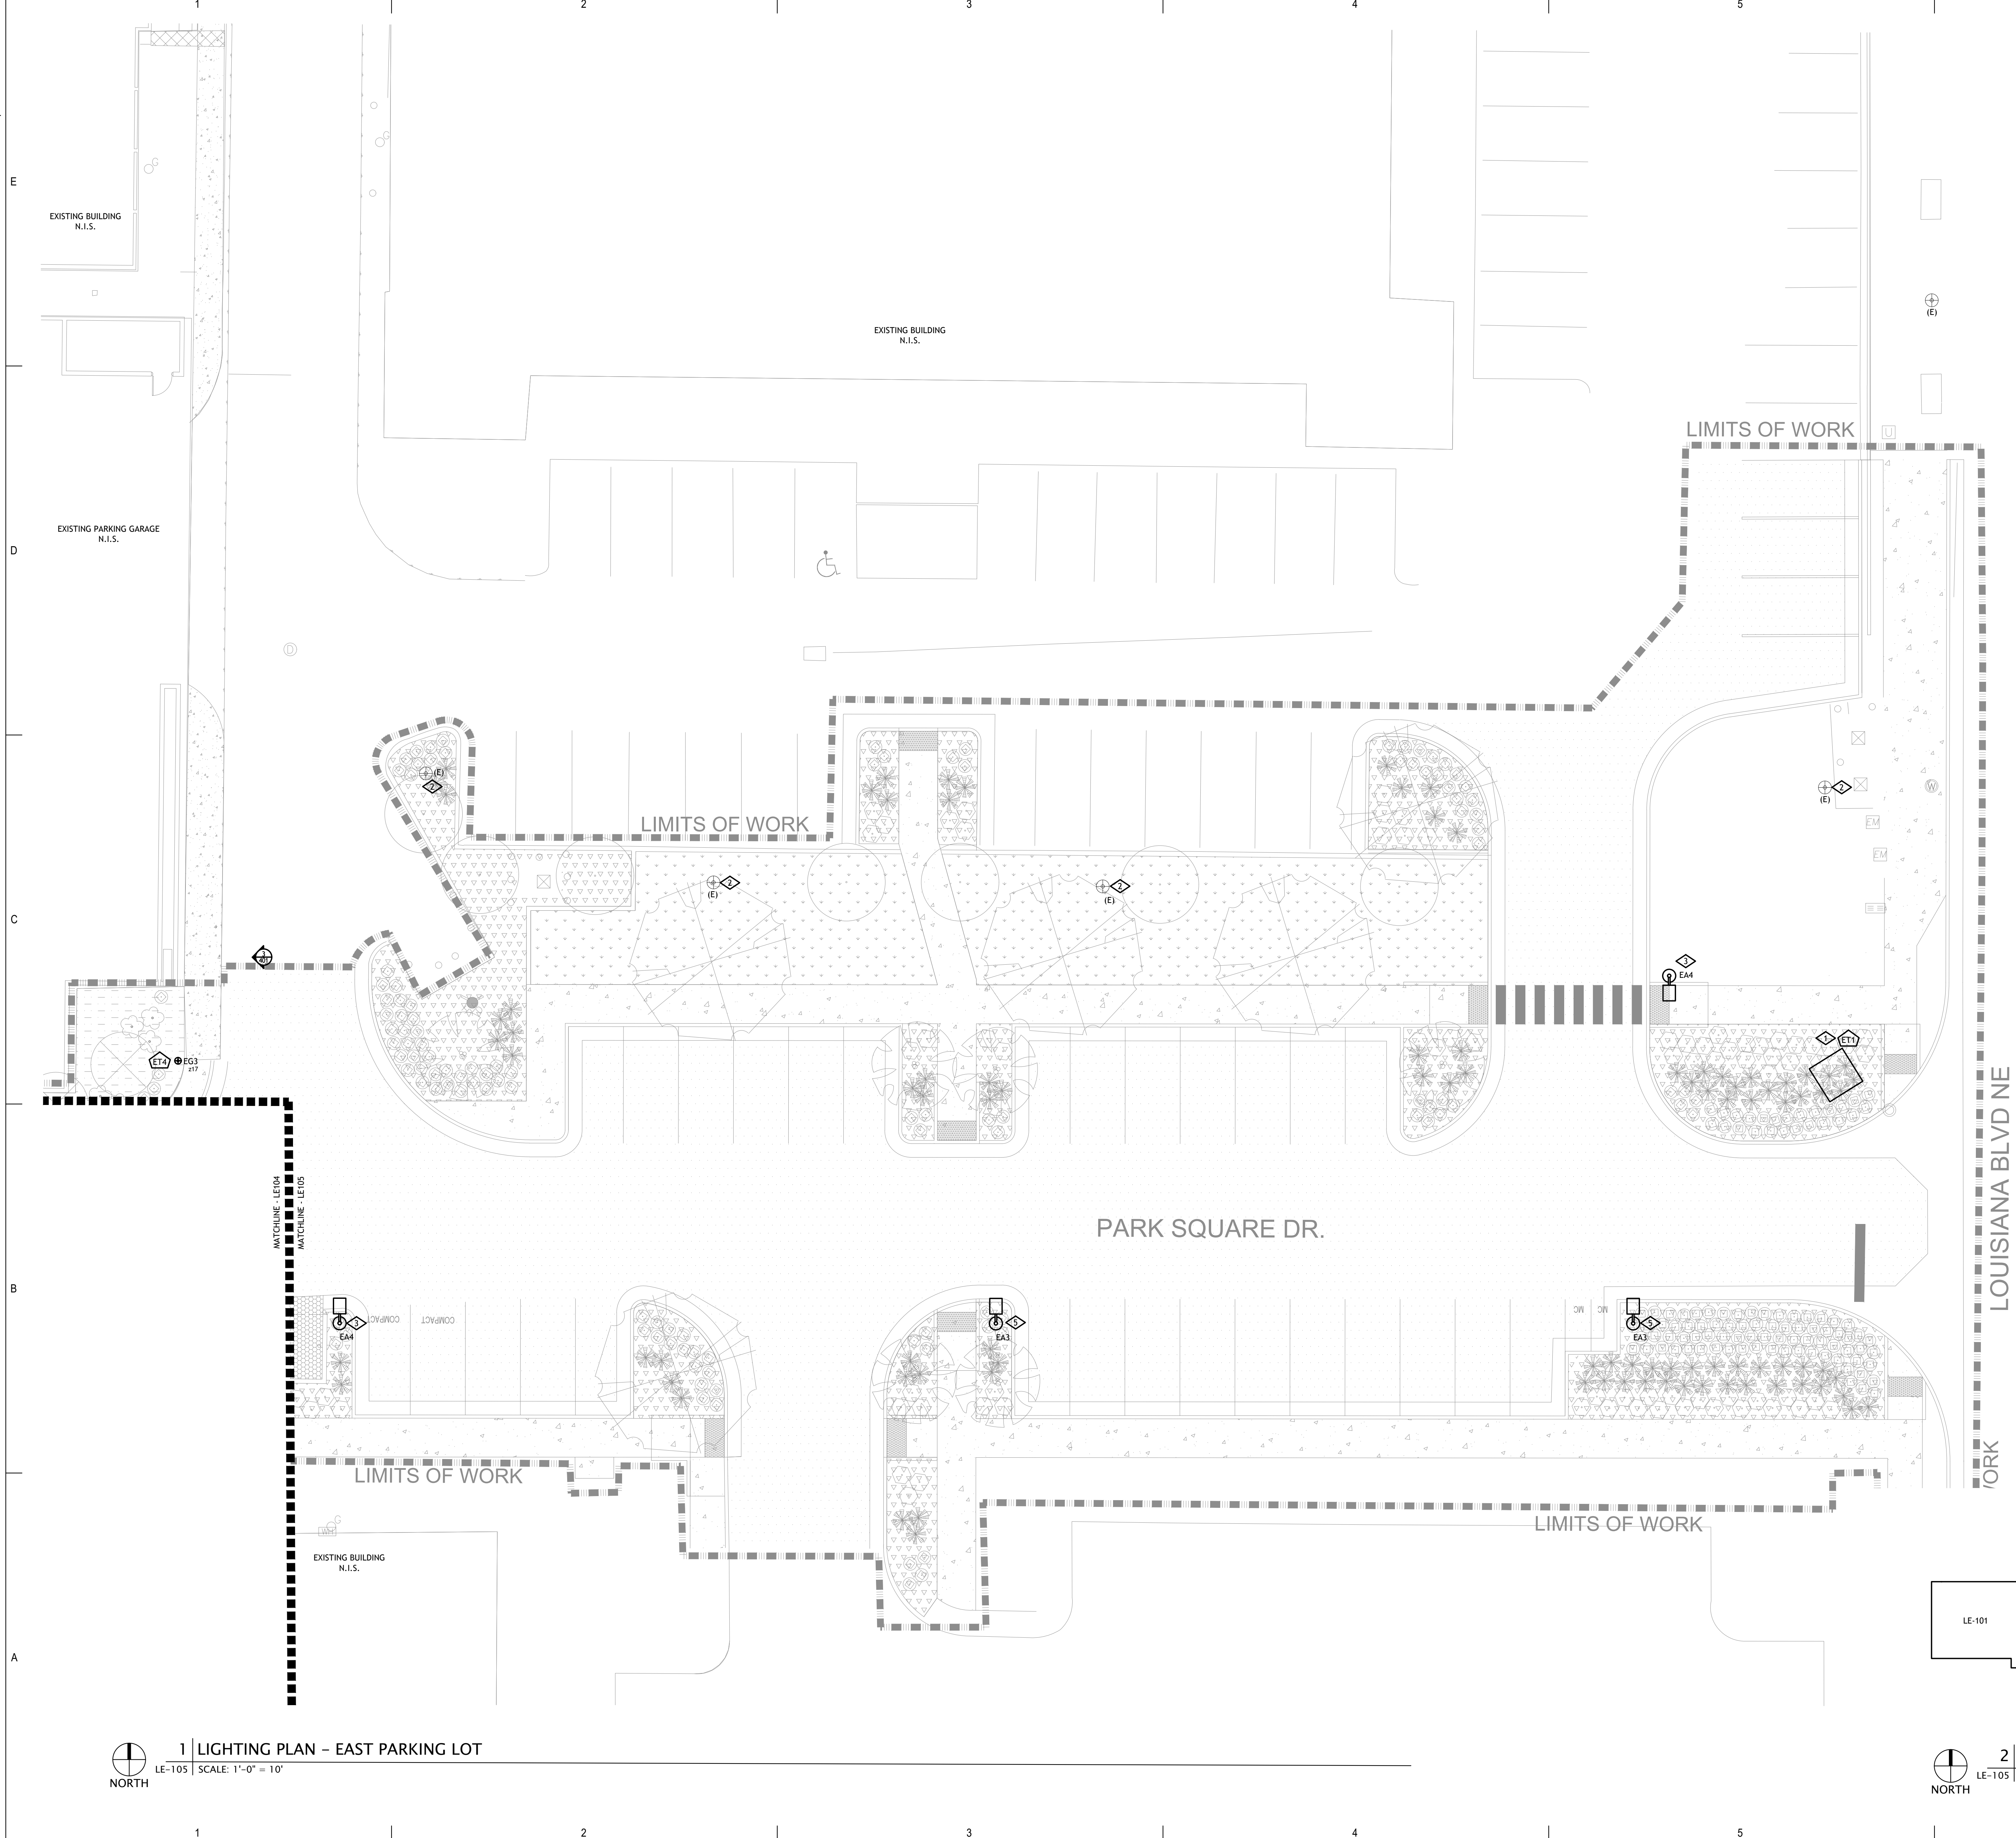

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P_505.883.5200 WEB: www.fbtarch.com
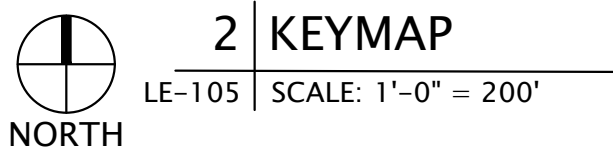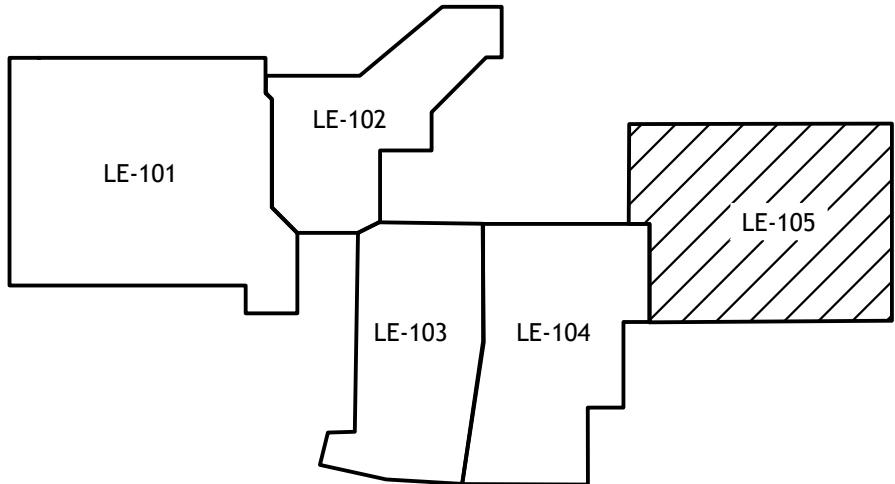
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CIVIL ENGINEER

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AEDESIGN
Integrated Lighting, Technology, and Electrical Solutions
1900 Wazee Street #205 | Denver, CO 80202 | 303.296.3034
aedesign-nlc.com Project # 5883.00



Park Square Plaza
Renovation

100% CD

6565 AMERICAS PKWY
ALBUQUERQUE, NM 87110

APRIL 2024

| MARK | DATE | DESCRIPTION |
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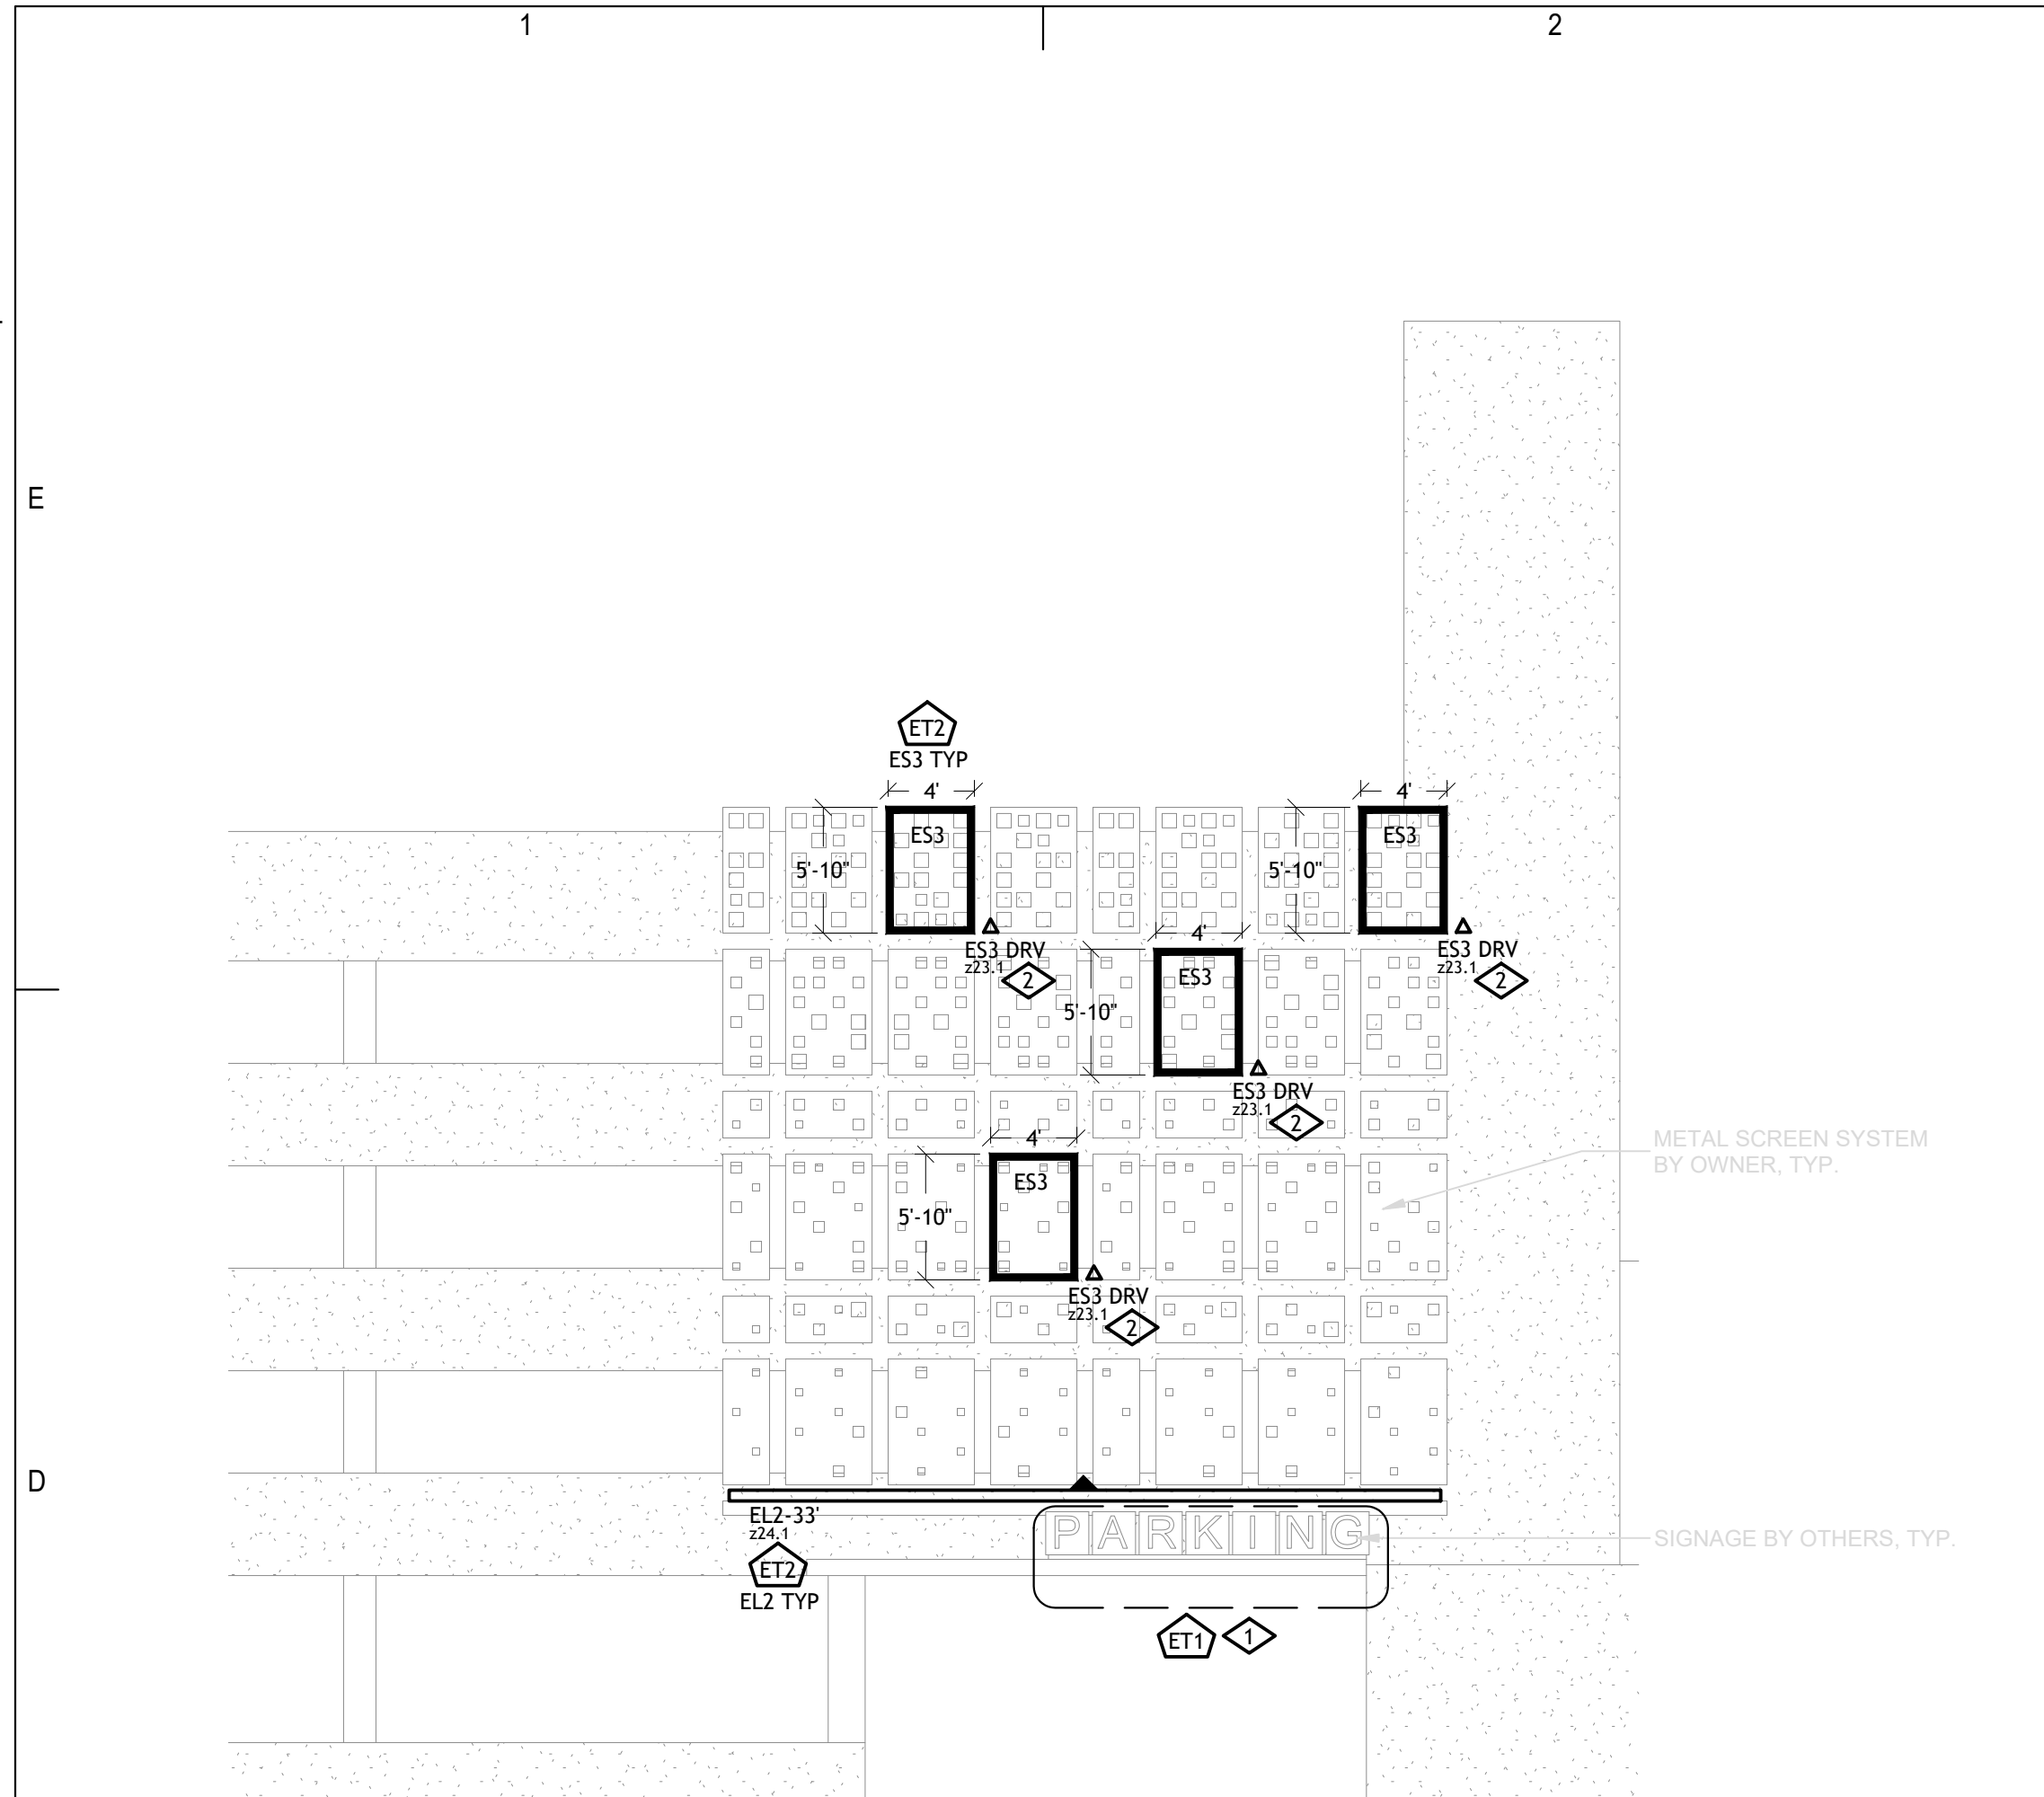
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| ISSUE: | 100% CD |
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| DRAWN BY: | AEC,CK,EB |
| CHECKED BY: | AJS,MRS |

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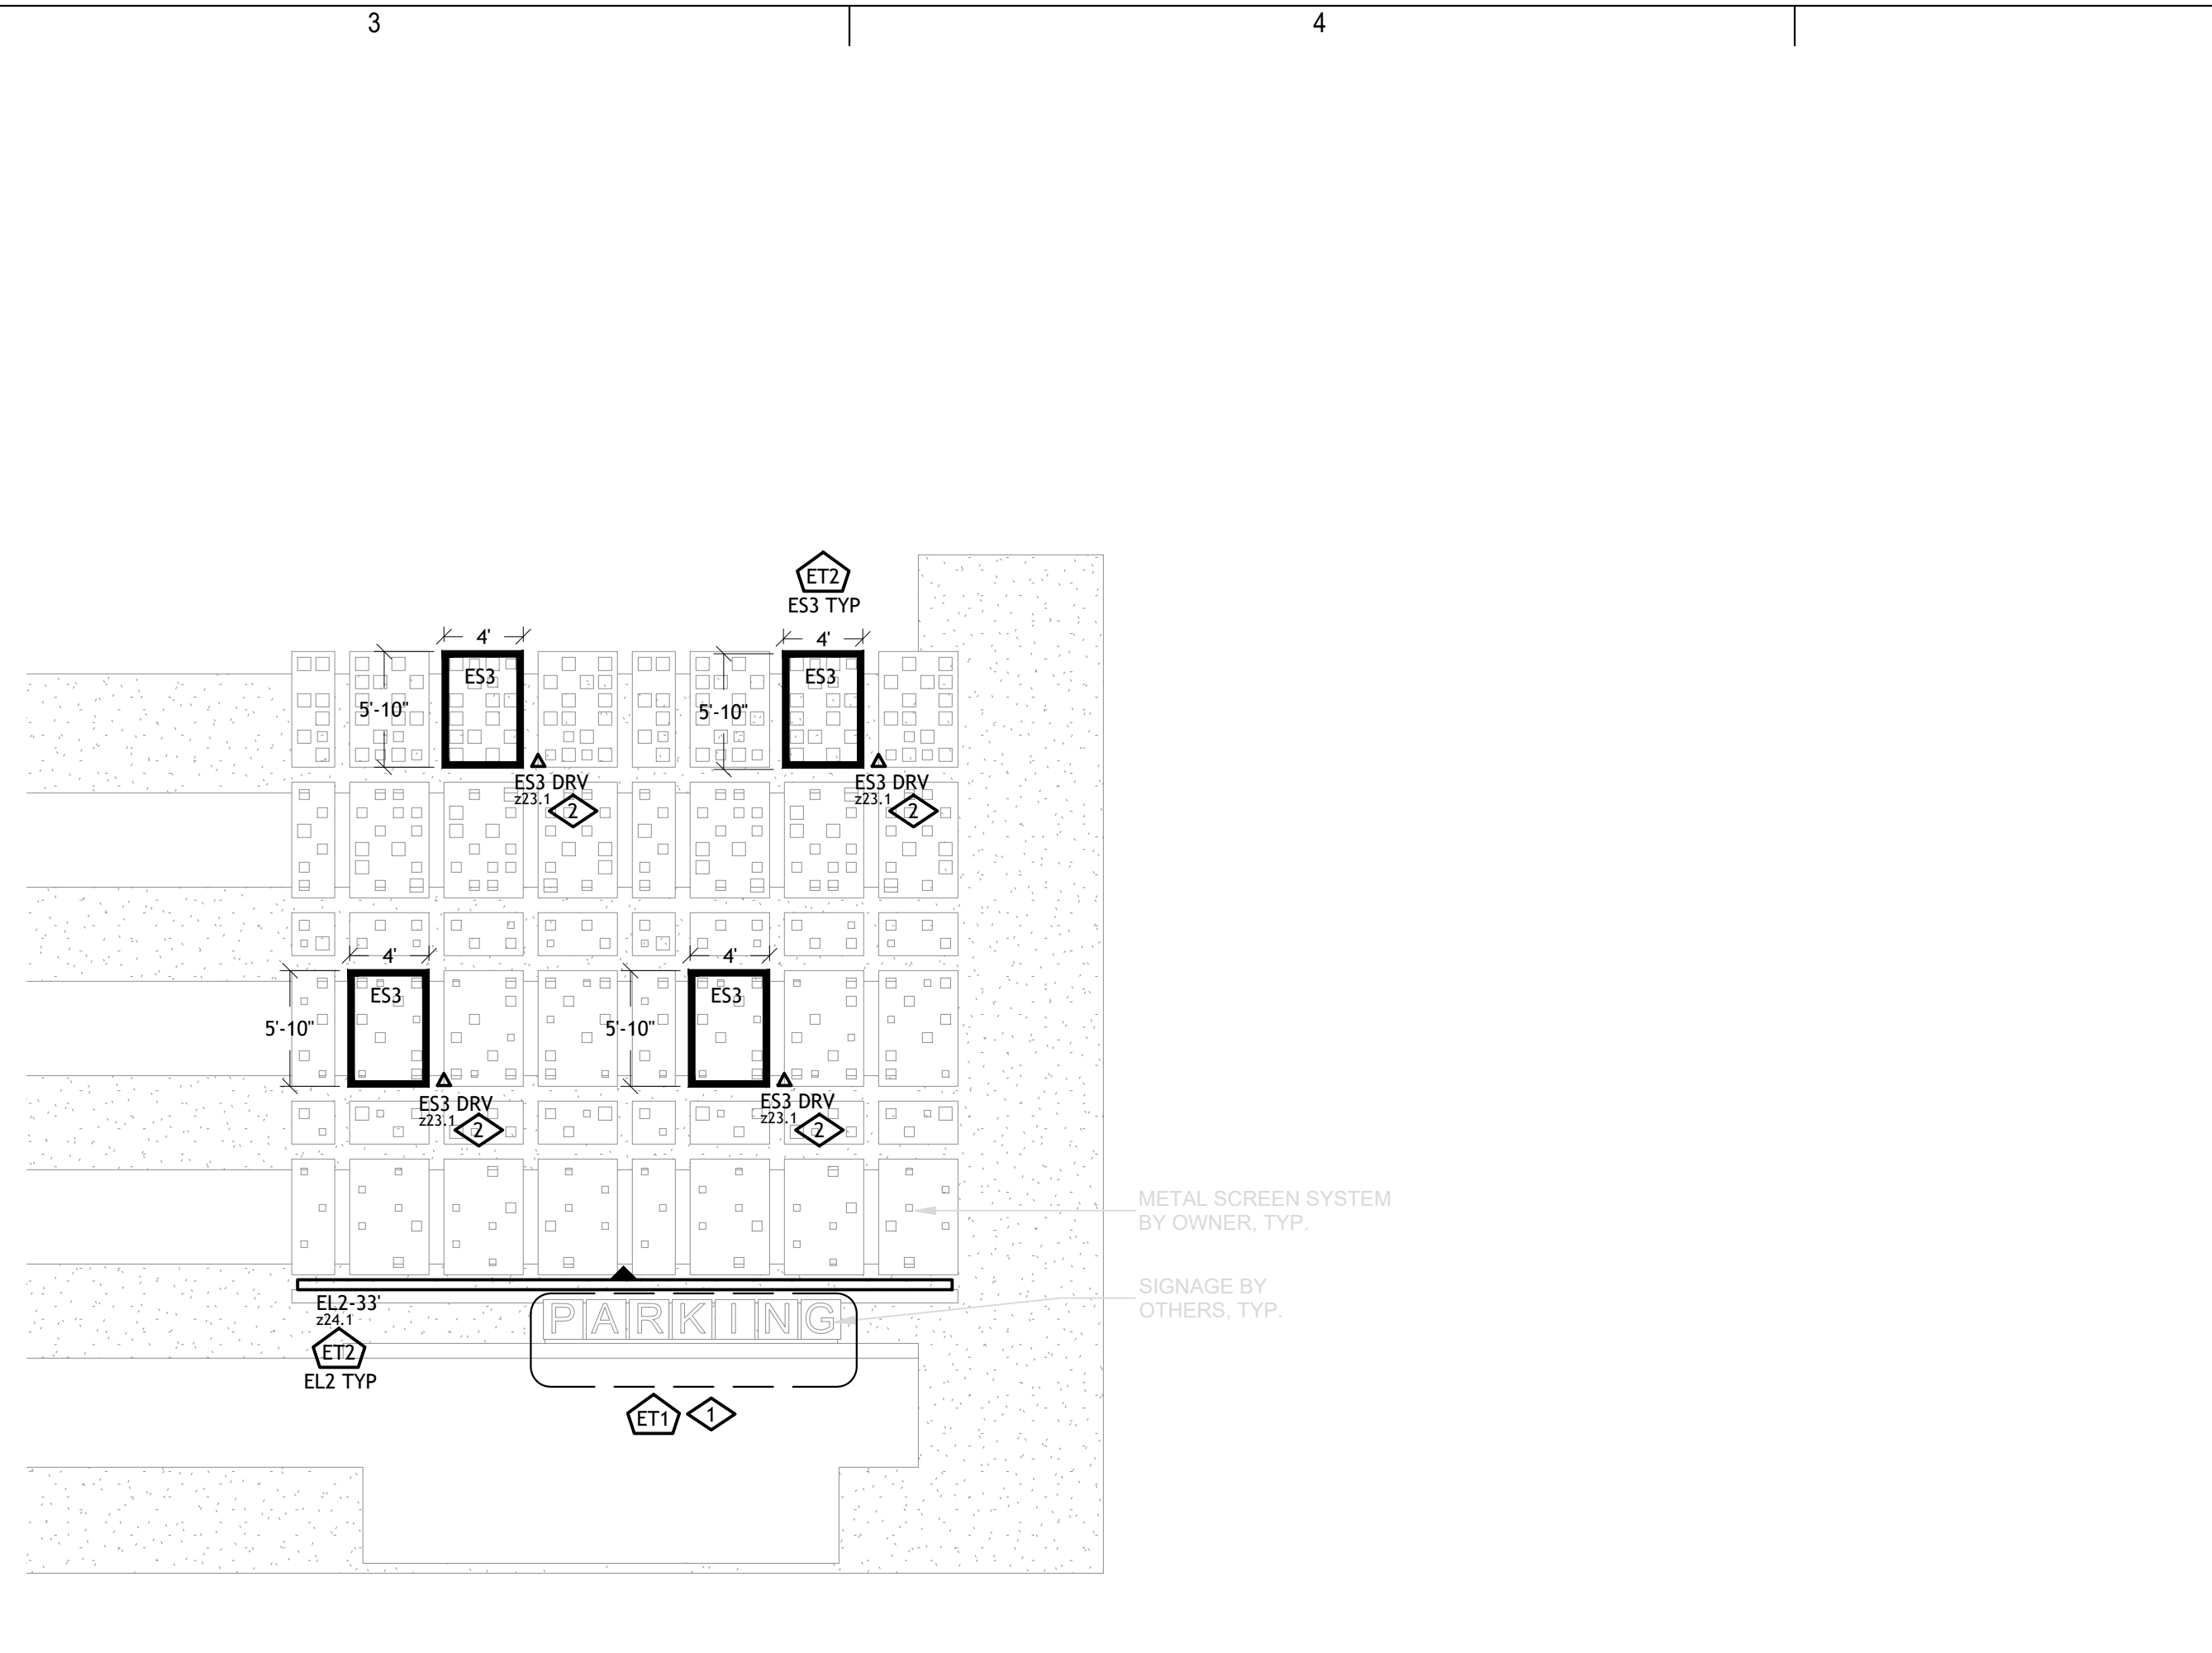
LIGHTING PLAN

LE-105


Park Square Plaza Renovation




1 | WEST ELEVATION – ONE PARK SQUARE PARKING STRUCTURE
LE-401 | SCALE: 1/8" = 1'-0"



2 | NORTH ELEVATION – ONE PARK SQUARE PARKING STRUCTURE
LE-401 | SCALE: 1/8" = 1'-0"

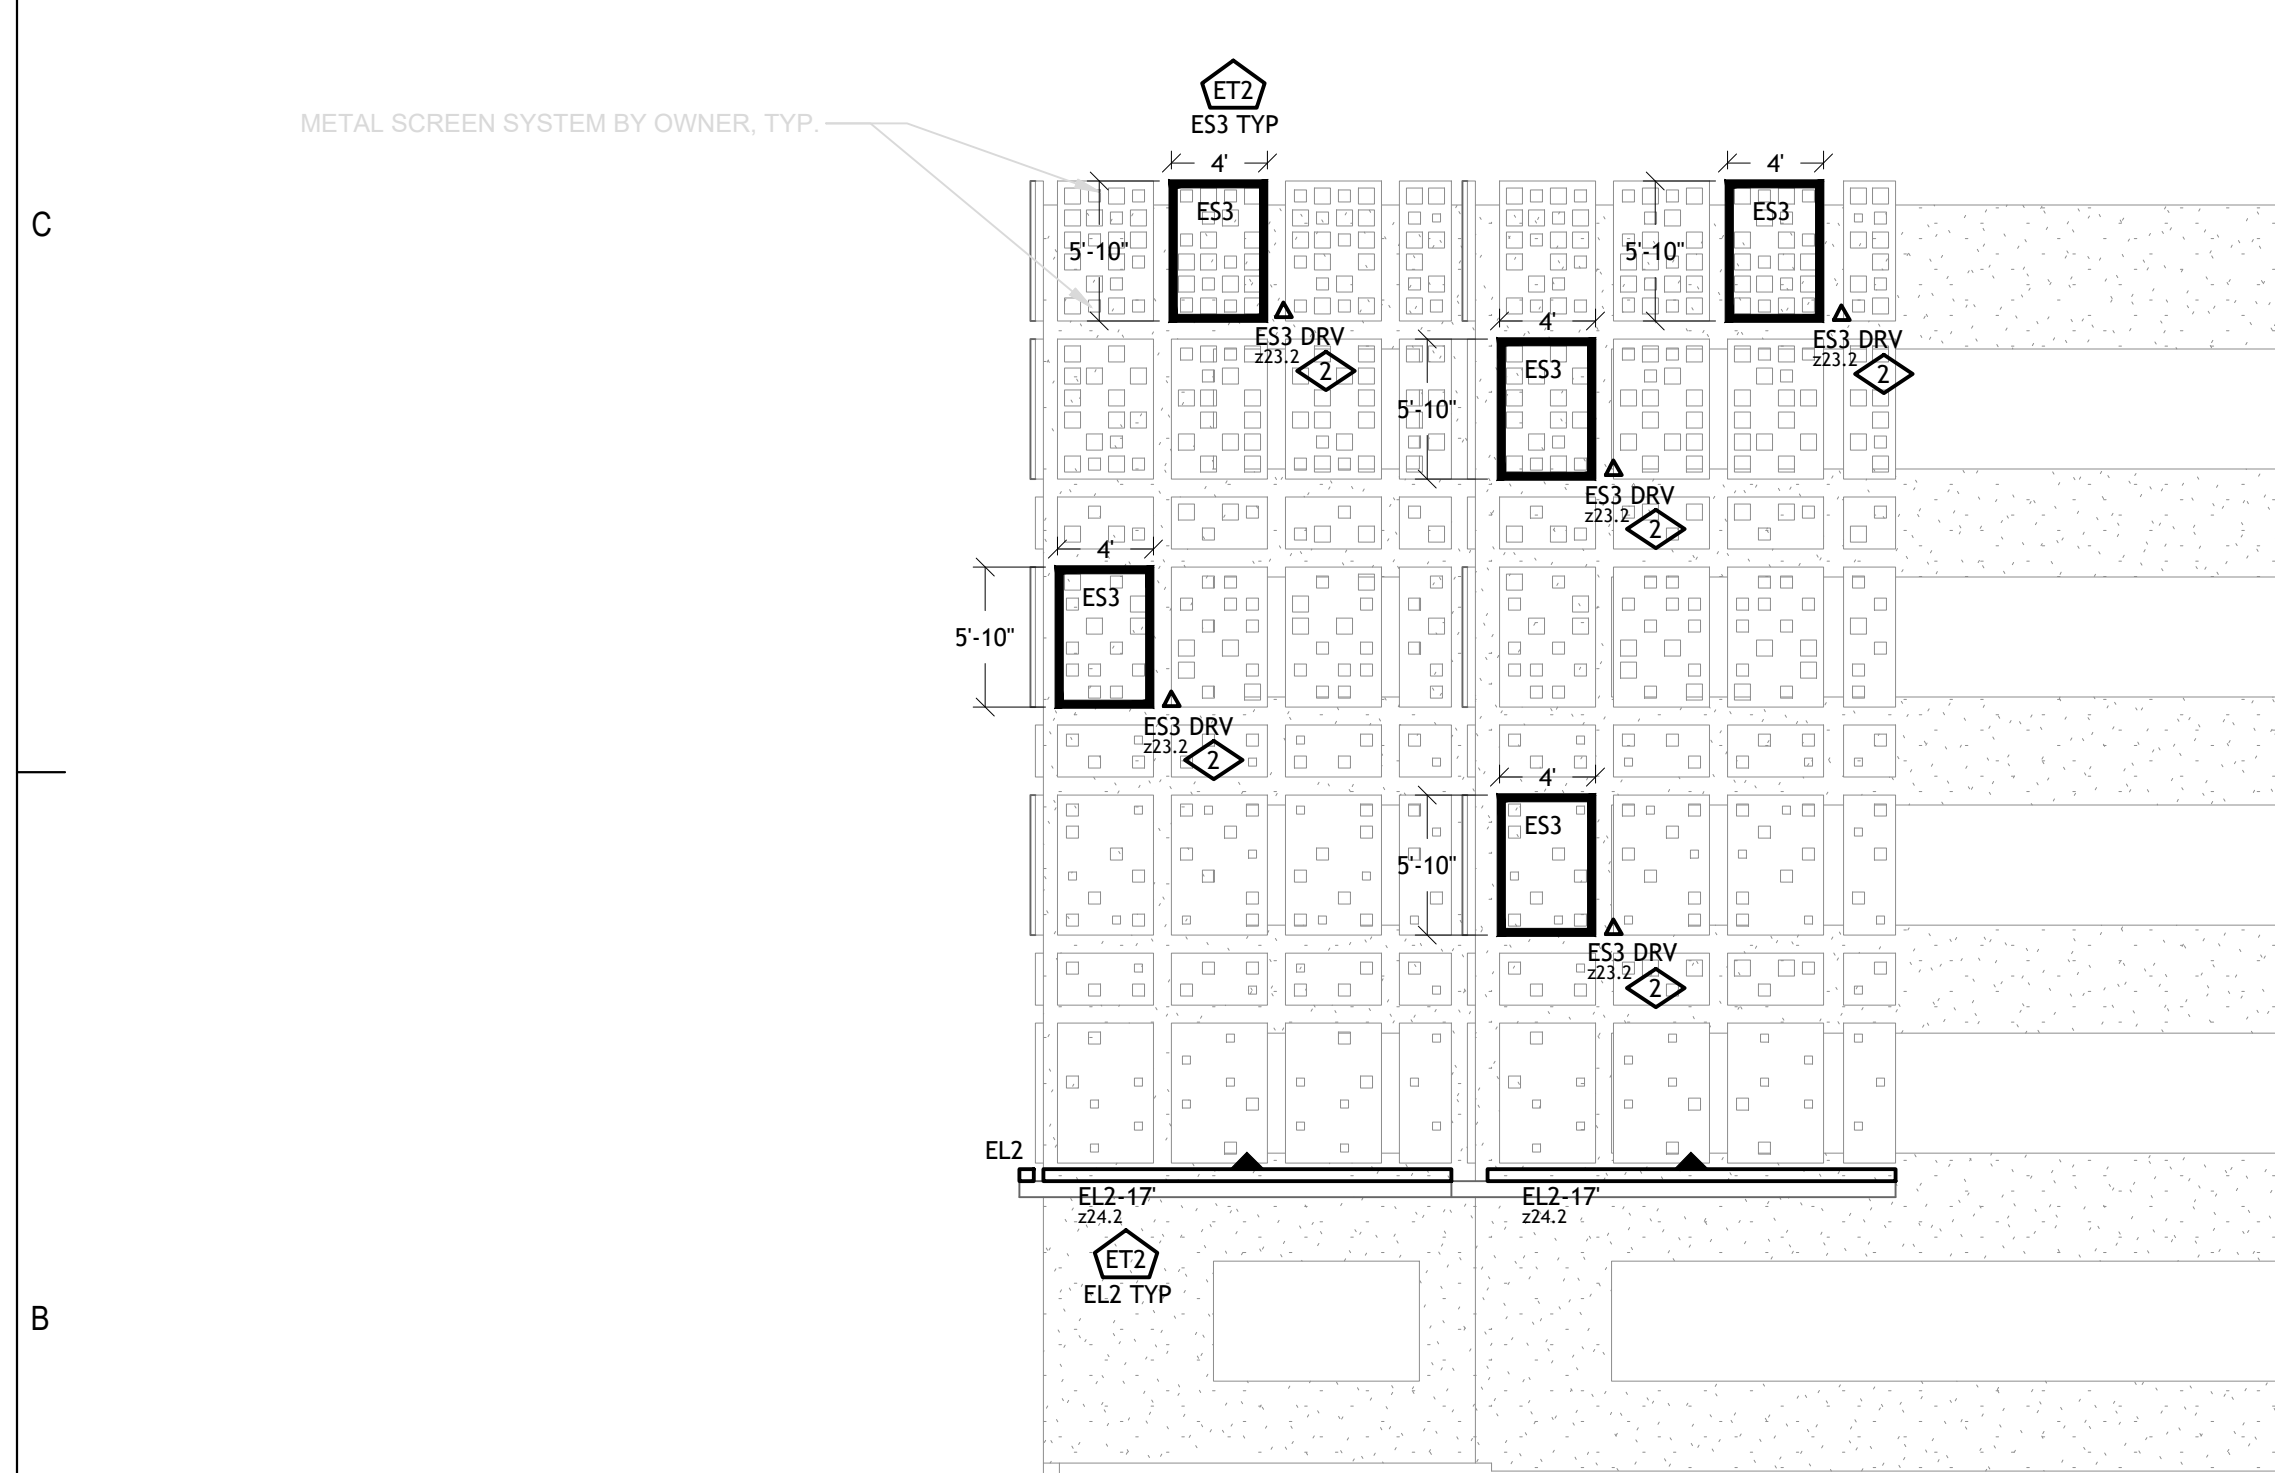

3 | EAST ELEVATION – TWO PARK SQUARE PARKING STRUCTURE
LE-401 | SCALE: 1/8" = 1'-0"

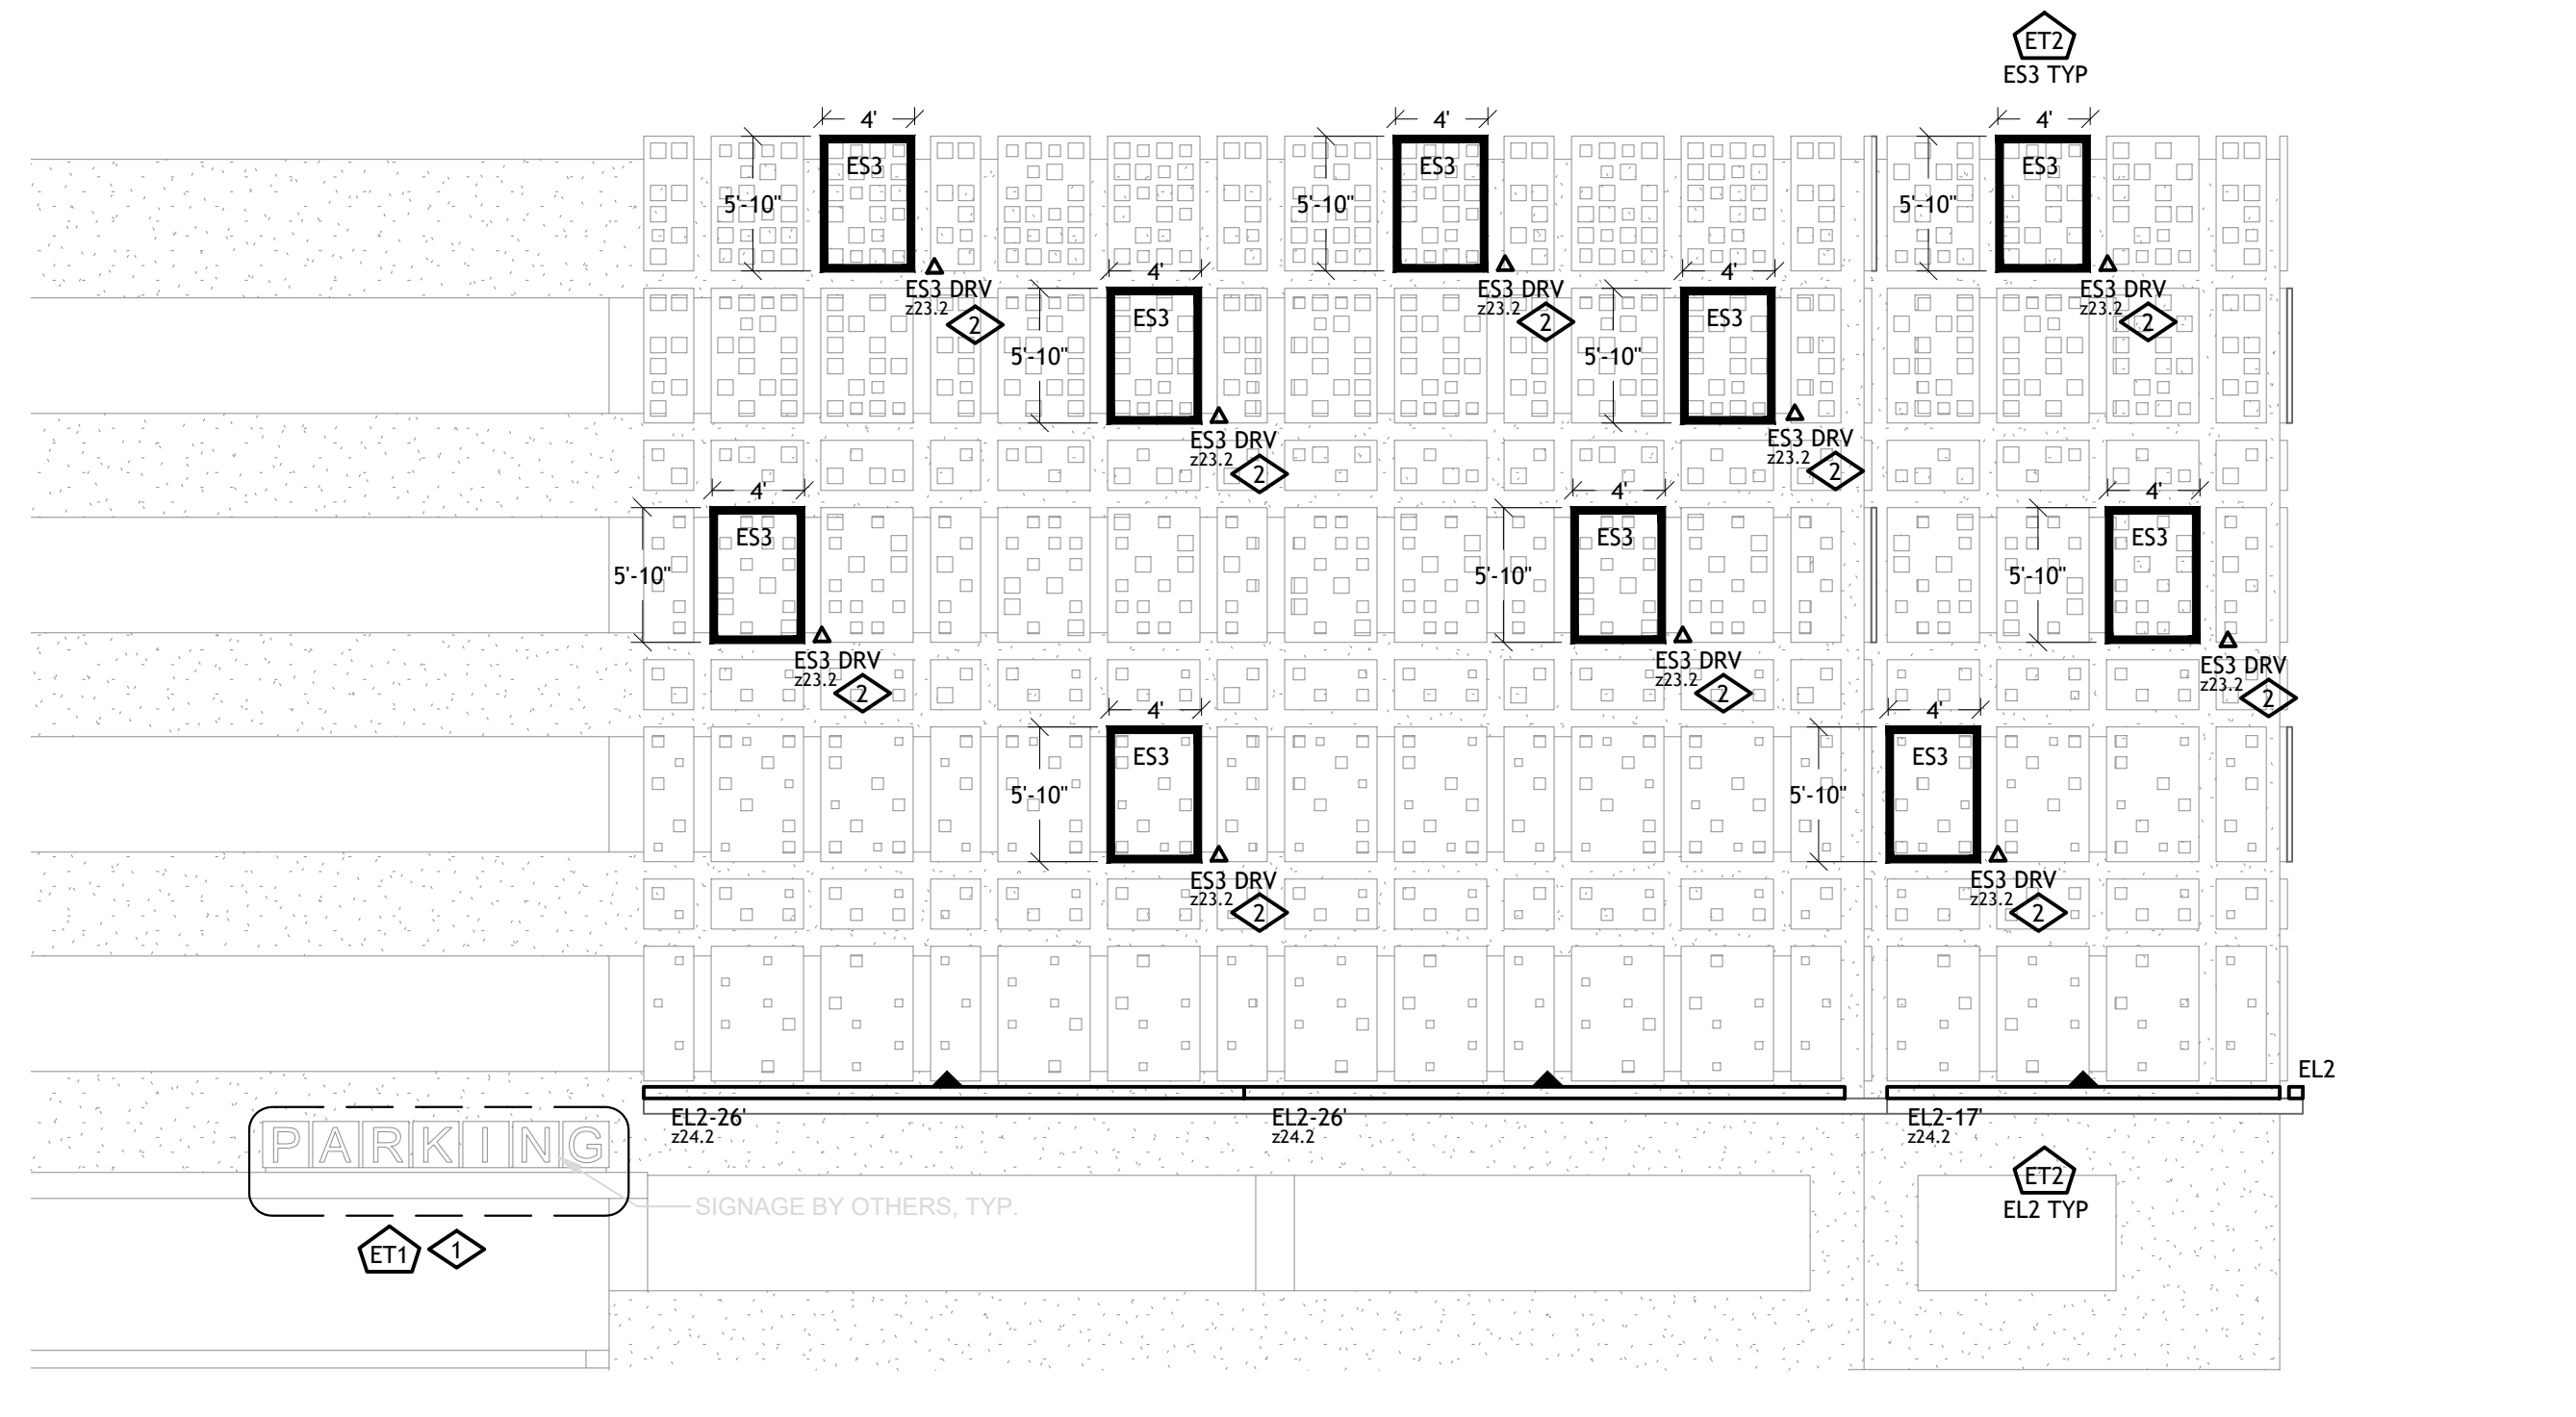

4 | SOUTH ELEVATION – TWO PARK SQUARE PARKING STRUCTURE
LE-401 | SCALE: 1/8" = 1'-0"

| GENERAL NOTES | |
|---------------|--|
| A. | HATCHED AREAS ARE NOT IN SCOPE OF THIS PROJECT. |
| B. | REFER TO ELECTRICAL ENGINEERS DRAWINGS FOR REQUIRED CIRCUITING. |
| C. | PER CONCETTA TRUJILLO WITH CITY OF ALBUQUERQUE, UPLIGHTING PERMITTED. ALL UPLIGHTING SHALL BE CONTAINED WITHIN PROPERTY LINES, UTILIZE SHIELDING FOR GLARE AND BE AIMED TOWARDS BUILDING FACADE AND LANDSCAPE FEATURES SO AS TO NOT TRANSVERSE OFF THE SITE. |
| D. | REMOTE DRIVERS ARE SHOWN FOR DESIGN INTENT ONLY FOR THE PURPOSES OF PRICING AND SHALL BE LOCATED IN A NEARBY CONCEALED, AND ACCESSIBLE AREA AS COORDINATED WITH ARCHITECT, LANDSCAPE ARCHITECT, AND ELECTRICAL ENGINEER. |
| E. | FOR ALL LOW VOLTAGE LIGHTING, RE: ELEC FOR LINE VOLTAGE FEED LOCATIONS. CONTRACTOR SHALL PROVIDE SUFFICIENT SLACK IN LOW VOLTAGE WIRING TO ALLOW FOR FINAL ADJUSTMENT OF LIGHTING ON SITE WITH OWNER, ARCHITECT/ INTERIOR DESIGNER AND/OR LANDSCAPE ARCHITECT. |

| KEYNOTE LEGEND | |
|--|--|
| KEY | VALUE |
| ES3 | ILLUMINATED SIGNAGE IS SHOWN FOR REFERENCE PURPOSES ONLY. SIGNAGE IS PENDING OWNERSHIP DESIGN DIRECTION AND SHALL BE PROVIDED BY SIGNAGE MANUFACTURER. SIGNAGE SHALL BE 3000K OR WARMER COLOR TEMPERATURE. ILLUMINATED SIGNAGE MOCK-UP WITH OWNER SHALL BE PROVIDED BY CONTRACTOR PRIOR TO FINAL APPROVAL. |
| ES3 DRV | EC SHALL LOCATE REMOTE DRIVER WITHIN PARKING STRUCTURE. COORDINATE CUSTOM FEED/WHIP LENGTH TO FIXTURE. |
| SEQUENCE OF OPERATIONS GENERAL NOTES | |
| THE FOLLOWING CONTROL SEQUENCE OF OPERATIONS ARE UTILIZED IN THIS PLAN. REFER TO PLAN AND/OR ZONE/RELAY SCHEDULE FOR SPECIFIC ASSOCIATED SEQUENCE. | |
| ET1 | ET2 |

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Renovation

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| PROJECT NO: | 5883.00 |
| DRAWN BY: | AEC,CK,EB |
| CHECKED BY: | AJS,MRS |

SHEET TITLE

LIGHTING DETAILS

LE-401

GENERAL NOTES:

1. ALL LED LAMPS AND/OR FIXTURES SHALL BE 3000K COLOR TEMPERATURE OR WARMER, AND A MINIMUM OF E8CRI, UDN.

2. LUMENS LISTED ARE DELIVERED LUMENS, NOT INITIAL.

3. FOR ALL SPECIFIED LUMINAIRES, THE ELECTRICAL CONTRACTOR SHALL BE RESPONSIBLE FOR PROVIDING ALL MOUNTING HARDWARE, ACCESSORIES, COMPONENTS, LEADERS/JUMPER CABLES, WIRE FEED, CONNECTORS, END CAPS, REMOTE POWER SUPPLIES, AND ANY OTHER NECESSARY COMPONENT AS REQUIRED FOR INSTALLING A SECURE AND FULLY FUNCTIONAL SYSTEM.

4. ALL FINISH SELECTIONS SHALL BE REVIEWED BY ARCHITECT/INTERIOR DESIGNER/OWNER AS PART OF THE SUBMITTAL PROCESS, UNLESS OTHERWISE NOTED. EC SHALL ASSUME STANDARD LUMINAIRE FINISH OPTION FOR PRICING.

5. EC SHALL VERIFY ALL FIXTURE MOUNTING HEIGHTS WITH ARCHITECTURAL ELEVATIONS PRIOR TO ANY ROUGH-IN.

6. REMOTE DRIVERS/TRANSFORMERS SHALL BE LOCATED IN A CONCEALED, ACCESSIBLE, AND VENTILATED LOCATION AS PROPOSED BY THE EC AND APPROVED BY THE ARCHITECT AND ELECTRICAL ENGINEER. REFER TO THE MANUFACTURER'S INSTALLATION INSTRUCTIONS FOR MINIMUM REQUIRED CLEARANCES FROM ADJACENT MATERIALS, AND WIRING REQUIREMENTS TO PREVENT VOLTAGE DROP. DO NOT EXCEED MANUFACTURER'S RECOMMENDATIONS REGARDING WIRE GAUGE AND MAXIMUM WIRE RUN LENGTHS.

7. FOR LUMINAIRES SPECIFIED WITH 0-10V DIMMING, 0-10V DIMMING DRIVERS) REQUIRE ADDITIONAL LOW VOLTAGE CONTROL WIRES IN ADDITION TO STANDARD WIRING FOR POWER.

8. EXTERIOR LUMINAIRES SHALL BE COLD WEATHER RATED FOR 0°F TO +18°F (+0° TO +8°F), AND RATED FOR OUTDOOR USE.

9. LOW VOLTAGE FIXTURES POWERED BY MAGNETIC OR ELECTRONIC LOW VOLTAGE TRANSFORMERS SHALL BE WIRED IN PARALLEL (HOME RUN) BETWEEN THE TRANSFORMER AND THE FIXTURE (SECONDARY, LOW VOLTAGE SIDE). CONTRACTOR SHOULD NEVER WIRE IN SERIES (DAISY CHAIN) UNLESS SPECIFICALLY INSTRUCTED BY MANUFACTURER'S INSTALLATION INSTRUCTIONS.

ALTERNATES AND VALUE ENGINEERED LIGHTING FIXTURES AND LIGHTING CONTROLS:

A. CONTRACTOR RESPONSIBILITIES:

1. IT IS THE RESPONSIBILITY OF THE CONTRACTOR TO VERIFY COMPATIBILITY OF ALTERNATE OR VALUE ENGINEERED LIGHTING FIXTURES WITH THE SPECIFIED, ALTERNATE OR VALUE ENGINEERED LIGHTING CONTROLS, INCLUDING DIMMING COMPATIBILITY.

2. IT IS THE RESPONSIBILITY OF THE CONTRACTOR TO VERIFY COMPATIBILITY OF ALTERNATE OR VALUE ENGINEERED EMERGENCY LIGHTING SYSTEM WITH THE SPECIFIED, ALTERNATE OR VALUE ENGINEERED LIGHTING CONTROLS AND FIXTURES, INCLUDING INVERTERS AND ULTRA TRANSFER DEVICES REQUIRED FOR A FULLY FUNCTIONAL SYSTEM.

3. IT IS THE RESPONSIBILITY OF THE CONTRACTOR TO PROVIDE A LIST OF THE FOLLOWING ITEMS FOR THE SPECIFIED FIXTURE AND PROPOSED ALTERNATES OR VALUE ENGINEERED LIGHTING FIXTURES PRIOR TO REVIEW: FAILURE TO PROVIDE REQUESTED ITEM WILL RESULT IN ADDITIONAL WORK BEING BILLED AT HOURLY RATES (SEE D3).

- CUT-SHEETS, AND SUMMARIZED TABLE FIXTURE WATTAGE, DELIVERED LUMEN OUTPUT, DISTRIBUTION BEAM ANGLE, COLOR TEMPERATURE (CCT), COLOR RENDERING INDEX (CRI)

B. PRIOR APPROVAL REQUEST PRIOR TO BID:

1. THE CONTRACTOR IS REQUIRED TO CALL THE ENGINEER OF RECORD / LIGHTING DESIGNER TO REQUEST APPROVAL TO SUBMIT ALTERNATE OR VALUE ENGINEERED LIGHTING FIXTURES AND LIGHTING CONTROL SYSTEMS. AE DESIGN'S OFFICE PHONE NUMBER IS (505)296-3034.

2. THE CONTRACTOR IS REQUIRED TO SUBMIT PRELIMINARY SUBMITTAL DRAWINGS OF ALL ALTERNATE OR VALUE ENGINEERED LIGHTING FIXTURES AND LIGHTING CONTROLS FOR PRIOR APPROVAL FROM THE ENGINEER OF RECORD / LIGHTING DESIGNER 10-DAYS PRIOR TO BID DATE. SUBMITTALS RECEIVED LESS THAN 10-DAYS PRIOR TO BID DATE WILL NOT BE CONSIDERED.

3. ALTERNATE OR VALUE ENGINEERED LIGHTING FIXTURES OF ANY EXTERIOR LIGHTING FIXTURES ARE REQUIRED TO INCLUDE AN EXTERIOR PHOTO-METRIC PLAN SHOWING COMPLIANCE WITH THE LOCALLY ADOPTED EXTERIOR LIGHTING ORDINANCE (CODE).

4. ALTERNATE OR VALUE ENGINEERED LIGHTING FIXTURES FOR EMERGENCY APPLICATIONS ARE REQUIRED TO MATCH OR EXCEED THE SPECIFIED LUMEN OUTPUT AND MATCH SPECIFIED DISTRIBUTION OR COMPLY WITH LIGHT LEVELS REQUIRED FOR EGRESS ILLUMINATION AS REQUIRED PER NFPA 101. SPECIFIC CONCERNS ON THE PART OF THE ENGINEER MAY RESULT IN REQUEST FOR PHOTO-METRIC CALCULATIONS TO BE PROVIDED FOR ALTERNATE OR VALUE ENGINEERED LIGHTING FIXTURES.

C. BID PRICING BREAKOUT REQUIREMENTS:

1. THE CONTRACTOR IS REQUIRED TO PROVIDE SEPARATE LINE ITEMS IN THE BASE BID FOR LIGHTING FIXTURES AND LIGHTING CONTROLS.

2. THE CONTRACTOR IS REQUIRED TO CARRY THE "AS SPECIFIED" LIGHTING FIXTURES AND LIGHTING CONTROLS IN THEIR BASE BID. ALL ALTERNATE OR VALUE ENGINEERED LIGHTING FIXTURES AND LIGHTING CONTROLS ARE TO BE INDICATED AS A NET CHANGE IN COST TO THE BASE BID.

3. THE CONTRACTOR IS REQUIRED TO PROVIDE UNIT PRICING FOR EACH "AS SPECIFIED" AND EACH ALTERNATE OR VALUE ENGINEERED LIGHTING FIXTURE AND LIGHTING CONTROLS. LUMP SUM COST SAVINGS WILL NOT BE ACCEPTED.

D. SUBMITTAL REVIEW AND DOCUMENT:

1. THE CONTRACTOR IS REQUIRED TO PAY FOR ANY INCURRED HOURS REQUIRED TO UPDATE THE PERMIT/CONSTRUCTION DOCUMENTS DUE TO ALTERNATE OR VALUE ENGINEERED LIGHTING FIXTURES AND CONTROLS BY THE ENGINEER OF RECORD / LIGHTING DESIGNER. HOURLY RATE SHALL BE BILLED AT \$135.00/Hr.

2. THE CONTRACTOR IS REQUIRED TO PAY FOR ANY INCURRED HOURS TO UPDATE THE ENERGY COMPLIANCE DOCUMENTATION BY THE ENGINEER OF RECORD / LIGHTING DESIGNER. HOURLY RATE SHALL BE BILLED AT \$135.00/Hr.

3. THE CONTRACTOR IS REQUIRED TO PAY FOR THE ADDITIONAL HOURS REQUIRED OF THE ENGINEER OF RECORD / LIGHTING DESIGNER TO REVIEW ALTERNATE OR VALUE ENGINEERED LIGHTING FIXTURES AND CONTROLS. HOURLY RATE SHALL BE BILLED AT \$135.00/Hr.

SPECIFIC NOTES:

1. THIS LUMINAIRE UTILIZES A REMOTE DRIVER OR TRANSFORMER. EC SHALL MOUNT REMOTE EQUIPMENT IN NEARBY, CONCEALED, DRY, VENTILATED, AND ACCESSIBLE LOCATION AS APPROVED BY ARCHITECT.

EC SHALL PROVIDE SIZE QUANTITIES AS REQUIRED PER MANUFACTURER'S RECOMMENDATIONS. EC SHALL REFER TO MANUFACTURER'S INSTALLATION INSTRUCTIONS FOR WIRE SIZE AND MAXIMUM RUN DISTANCES.

2. EC SHALL RUN LOW VOLTAGE WIRE FROM REMOTE DRIVER LOCATED UNDER PAVERS TO EACH POT LOCATION. ROUTE WIRING BETWEEN 1/4" GAP BETWEEN PAVERS INTO POT FOR INSTALLATION OF LIGHT FIXTURE.

LOCATE LIGHT FIXTURE AT FRONT OF POT AND AWAY/CLEAR AT PLANTING.

3. THIS LUMINAIRE UTILIZES A REMOTE DRIVER OR TRANSFORMER. EC SHALL MOUNT REMOTE EQUIPMENT IN NEARBY, CONCEALED, DRY, VENTILATED, AND ACCESSIBLE LOCATION AS APPROVED BY ARCHITECT.

EC SHALL PROVIDE SIZE QUANTITIES AS REQUIRED PER MANUFACTURER'S RECOMMENDATIONS. EC SHALL REFER TO MANUFACTURER'S INSTALLATION INSTRUCTIONS FOR WIRE SIZE AND MAXIMUM RUN DISTANCES.

4. THIS LINEAR LUMINAIRE IS CONCEALED AND INSTALLED WITHIN A CONTINUOUS LINEAR ARCHITECTURAL CONDITION AT SCREEN. REFER TO ARCHITECTURAL MOUNTING DETAIL. FIXTURE SHALL BE SETBACK 6" FROM FACE OF WALL AND CONCEALED BY ARCHITECTURAL VALANCE. EC SHALL VERIFY AVAILABLE MOUNTING DIMENSIONS PRIOR TO ORDERING THE FIXTURE. LINEAR LUMINAIRES SHALL RUN END TO END CONTINUOUSLY FOR THE ENTIRE LENGTH OF ASSOCIATED ARCHITECTURAL CONDITION AS INDICATED ON THE DRAWINGS. THE ELECTRICAL CONTRACTOR SHALL PROVIDE AND CONCEAL LEADERS/JUMPER CABLES, AND WIRING FEEDS TO THE GREATEST DEGREE POSSIBLE. THE LINEAR LUMINAIRES SHALL BE PROVIDED IN A SYMMETRICAL CONFIGURATION IN NECESSARY FIELD ASSEMBLED SEGMENT LENGTHS SUCH THAT FIXTURES ARE LOCATED A MINIMUM DISTANCE OF 1' FROM THE END OF ASSOCIATED ARCHITECTURAL SCREEN, NO EXCEPTIONS.

EC SHALL SUBMIT CONCEALED LINEAR STRAIGHT RUN LENGTHS AND CONFIGURATIONS TO LIGHTING FIXTURE MANUFACTURER AS PART OF THE PRICING AND SHOP DRAWING REVIEW PROCESS TO VERIFY FIXTURE SEGMENT LENGTHS AND CONFIGURATIONS WITH FEEDS, WIRE SIZE, AND MOUNTING ACCESSORIES.

5. EC SHALL VERIFY DRIVER SIZE SPECIFIED WITH FIXTURE LENGTHS AND WIRING CONFIGURATIONS NOTED ON PLAN.

6. OWNER SHALL PROVIDE EXCESS STOCK OF FIXTURES FROM HOTEL CHICAGO SPA PATIO POT LIGHTS, WITH TRANSFORMER.

7. THIS LINEAR LUMINAIRE IS INSTALLED IN A METAL CANOPY. CONTRACTOR SHALL VERIFY AVAILABLE MOUNTING LENGTHS, RECESS DEPTH, AND FINISH WITH STEEL CANOPY SHOP DRAWINGS PRIOR TO ORDERING THE FIXTURE. PROVIDE EQUAL AND SYMMETRICAL SCANTY LENGTHS TO COMPRISE ENTIRE RUN/TH LENGTH OF FIXTURE, WITH EXACT SPECIFIED LENGTH MADE TO ORDER.

8. LINEAR LUMINAIRES SHALL RUN END TO END CONTINUOUSLY FOR THE ENTIRE LENGTH OF ASSOCIATED WALLWORK AS INDICATED ON THE DRAWINGS. THE ELECTRICAL CONTRACTOR SHALL PROVIDE AND CONCEAL LEADERS/JUMPER CABLES, AND WIRING FEEDS TO THE GREATEST DEGREE POSSIBLE. THE LINEAR LUMINAIRES SHALL BE PROVIDED IN A SYMMETRICAL CONFIGURATION IN NECESSARY FIELD ASSEMBLED SEGMENT LENGTHS SUCH THAT FIXTURES ARE LOCATED A MINIMUM DISTANCE OF 2' FROM THE END OF ASSOCIATED ARCHITECTURAL SCREEN, NO EXCEPTIONS.

A FROSTED LENS IS REQUIRED TO PREVENT UNWANTED REFLECTIONS. EC LANDSCAPE ARCHITECT'S MOUNTING DETAIL FOR HOME INFORMATION.

9. MANUFACTURER SHALL PROVIDE CUSTOM SHOP DRAWING SHOWING MADE TO ORDER SQUARE LUMINAIRE FOR MOUNTING TO INNER SURFACE OF ARCHITECTURAL METAL FIN. EC SHALL LOCATE REMOTE DRIVER IN NEARBY, CONCEALED AREA WITH PARKING GARAGE STRUCTURE. EC SHALL CONFIRM CUSTOM FITTED / WIRE LENGTH FROM FIXTURE TO REMOTE DRIVER ON A PER FIXTURE BASIS.

10. EC SHALL COORDINATE FIXTURE LENGTH AND MOUNTING DETAIL WITH MANUFACTURER SHOP DRAWING FOR FIXTURE, PRIOR TO PROCEEDING.

11. SHOP DRAWINGS REQUIRED TO VERIFY ROUGH-IN LOCATIONS FOR CONCRETE CAST IN PLACE RECESSED FIXTURE HOUSING.

12. CONTRACTOR SHALL VERIFY FIXTURE SPECIFICATION WITH INSTALLED PLANTING MATERIAL, IN POT/PLANTERS WITH OWNER AND LIGHTING DESIGNER PRIOR TO FIXTURE RELEASE.

13. CONTRACTOR SHALL SUBMIT ULIST TYPE 4F AND IP68, WET LISTED, DIRECT BURIAL GROUND BOX FOR INSTALLATION IN LANDSCAPE TO HOUSE REMOTE DRIVERS), BASIS OF DESIGN A LIGERANO WIREMULU OUTDOOR GROUND BOX 180V4 OR APPROVED EQUAL, VERIFY COMPATIBILITY OF REMOTE DRIVER WITH ENCLOSURE.

| LIGHTING FIXTURE SCHEDULE | | | | | | | | | | | | | | | |
|---------------------------|---|------------------------|--|---------|----------|---------------|----------------|-------------------|------------|------------------|---------------------|------------------------------|--|------------------------|---------------|
| TYPE | DESCRIPTION | MANUFACTURER | CATALOG NUMBER | VOLTAGE | LAMP QTY | SOURCE | TYPE | CCT/CRI | MAX WATTS | LUMEN OUTPUT | DIMMING | FIXTURE FINISH | MOUNTING LOCATION | INFORMATION | NOTES |
| EAT | EXISTING LIGHT COLUMN 16" TALL 175W EQUIVALENT HID REPLACEMENT LED RETROFIT LAMP, IP65 WET RATED | LIGHT EFFICIENT DESIGN | LAMP: LED-803M30-G7 | 120 | 1 | 36 | EX39 MODUL LED | 3000K 82 CRI | 36 | 4144 | SWITCHING | N/A | EXISTING POLE | 82" OFF/20' H | 7.8" DIAMETER |
| EAT | EXISTING LIGHT COLUMN 11" TALL 120W EQUIVALENT HID REPLACEMENT LED RETROFIT LAMP, IP65 WET RATED | LIGHT EFFICIENT DESIGN | LAMP: LED-803M30-G7 | 120 | 1 | 36 | EX39 MODUL LED | 3000K 82 CRI | 36 | 4144 | SWITCHING | N/A | EXISTING POLE | 7.8" OFF/20' H | 7.8" DIAMETER |
| EAT | FULL CUTOFF POST-TOP PARKING LOT AREA LIGHT LIGHT DISTRIBUTION TYPE II STEEL 4" SQUARE POLE WITH SQUARE BASE, 25' TALL IP66 WET RATED | RAB | HEAD: ALED-W-3T-Y POLE: P54-11-15W2 / BC4 / BOLT/TA/11 | 120 | 1 | 90 | INTEGRAL LED | 3000K 82 CRI | 90 | 12,835 B2-UD-G2 | SWITCHING | BLACK | SURFACE GROUND CONCRETE BASE | 25' OFH | |
| EAT | PEDESTRIAN POLE LIGHT, 14' TALL WITH 3.5" X 6" POLE, MINIMALIST RECTANGULAR HEAD, TYPE IV DISTRIBUTION, FROSTED LENS, IP65 WET RATED | LIGMAN LIGHTING | HLI-12141-74-W30-01-14-120V-277-F | 120 | 1 | 55 | INTEGRAL LED | 3000K 80 CRI | 55 | 6193 LM B1-UD-G1 | SWITCHING | BLACK | SURFACE GROUND | 14' OFH | |
| EAT | FULL CUTOFF POST-TOP PARKING LOT AREA LIGHT LIGHT DISTRIBUTION TYPE II STEEL 4" SQUARE POLE WITH SQUARE BASE, 15' TALL IP66 WET RATED | RAB | HEAD: ALED-W-3T-Y POLE: P54-11-15W2 / BC4 / BOLT/TA/11 | 120 | 1 | 90 | INTEGRAL LED | 3000K 82 CRI | 90 | 12,835 B2-UD-G2 | SWITCHING | BLACK | SURFACE GROUND CONCRETE BASE | 15' OFH | |
| EAT | FULL CUTOFF POST-TOP PARKING LOT AREA LIGHT LIGHT DISTRIBUTION TYPE IV STEEL 4" SQUARE POLE WITH SQUARE BASE, 25' TALL IP66 WET RATED | RAB | HEAD: ALED-W-3T-Y POLE: P54-11-15W2 / BC4 / BOLT/TA/11 | 120 | 1 | 90 | INTEGRAL LED | 3000K 82 CRI | 90 | 12,835 B2-UD-G2 | SWITCHING | BLACK | SURFACE GROUND CONCRETE BASE | 25' OFH | |
| EAT | FULL CUTOFF LED BOLLARD WITH 360 DEG TYPE II DISTRIBUTION, 6" DIAMETER, 36" TALL ALUMINUM HOUSING, INTEGRAL PHOTOCELL, IP65 WET RATED | VISUAL COMFORT | 7000BARK-1830-36-B-LIN-PC | 120 | 1 | 28W | INTEGRAL LED | 3000K 80 CRI | 28W | 800 LM | SWITCHING | BLACK | SURFACE GROUND | 36.8" OFH | |
| EAT | SURFACE MOUNTED CYLINDER DOWNLIGHT, 6" DIAMETER, 11" TALL HOUSING, 250 DISTRIBUTION WITH SORT FIELD, INTEGRAL DRIVER, IP66 WET RATED | FC LIGHTING | FC6400-10-5F-UNV-930-05L-BKE-255-ET | 120 | 1 | 6.4W | INTEGRAL LED | 3000K 90 CRI | 6.4W | 475 LM | ELV TO 1% | BLACK | SURFACE PARKING DECK | 12" OFH | |
| EAT | LANDSCAPE STAKE MOUNTED LOW VOLTAGE LED ADJUSTABLE ACCENT LIGHT, 1.5" SQUARE PROFILE, 3.5" HEIGHT, BRASS HOUSING, STRAIGHT SHROUD, 6.3" MICRO SPIKE, IP65 WET RATED | AURORALIGHT | LQSL-90-27-BMS-BLP-XD BMS-BLP-XD | 12V | 1 | 3W | INTEGRAL LED | 2700K 80 CRI | 3W | 170 LM | MLV/LED 10% MIN | BRONZE LIVING PATINA (BLACK) | STAKE IN POT/ PLANTER | 4-1/4" OFH | 2,12 |
| EAT | 50W REMOTE 12VAC DRIVER MOUNTED IN DIRECT BURIAL HOUSING. | Q-TRAN | Q-HEX-M50W-120-12 Q-TRIX-R50 / Q-CLIK M5T/NPT | 120/12 | 1 | 50W | -- | -- | 50W | -- | MLV/LED 10% MIN | BLACK | DIRECT BURIAL | 12" RFD | 3 |
| EAT | LANDSCAPE STAKE MOUNTED LOW VOLTAGE LED ADJUSTABLE ACCENT LIGHT, 1.5" SQUARE PROFILE, 3.5" HEIGHT, BRASS HOUSING, STRAIGHT SHROUD, 6.3" MICRO SPIKE, IP65 WET RATED | AURORALIGHT | LQSL-90-27-FR-4-BMS-BLP-XD BMS-BLP-XD | 12V | 1 | 3W | INTEGRAL LED | 2700K 80 CRI | 3 W | 170 LM | MLV/LED 10% MIN | BRONZE LIVING PATINA (BLACK) | STAKE GROUND | 4-1/4" OFH | |
| EAT | 75W REMOTE 12VAC DRIVER MOUNTED IN DIRECT BURIAL HOUSING. | Q-TRAN | Q-HEX-M75W-120-12 Q-TRIX-R50 / Q-CLIK M5T/NPT | 120/12 | 1 | 75W | -- | -- | 75W | -- | MLV/LED 10% MIN | BLACK | DIRECT BURIAL | 12" RFD | 3 |
| EAT | 75W REMOTE 12VAC DRIVER MOUNTED IN DIRECT BURIAL HOUSING. | Q-TRAN | Q-HEX-M75W-120-12 Q-TRIX-R50 / Q-CLIK M5T/NPT | 120/12 | 1 | 20W | -- | -- | 20W | -- | MLV/LED 10% MIN | BLACK | DIRECT BURIAL | 12" RFD | 3 |
| EAT | OWNER PROVIDED STAKE MOUNTED LED ADJUSTABLE MONOPOINT PLANTER LIGHT MEDIUM OUTPUT, 18 DEGREE OPTICS, MATTE BRONZE FINISH, HALF SHOOT, WET RATED, DUAL FIN SPIKE | OFCI | OFCI | 120/12 | 1 | 6 | LED | 3000K 90 CRI | 6 | 300 | REVERSE PHASE TO 1% | MATTE BRONZE | STAKE GROUND AT TREES | 0'-6" OFH | 1,6 |
| EAT | EXTERIOR IP66 RATED REMOTE DRIVER | OFCI | QZ-94-UNV-24V-PH/010-BK | 120/12 | 1 | 96 | -- | -- | 96 | -- | REVERSE PHASE TO 0% | -- | -- | -- | |
| EAT | FULL CUTOFF STAKE MOUNTED LOW VOLTAGE LED AREA LIGHT, 22" HEIGHT WITH 1" DIAMETER STEM 6-3/4" SQUARE TRIANGULAR HEAD, BRASS HOUSING 0MM DISTRIBUTION, GROUND STAKE, IP65 WET RATED | AURORALIGHT | LPL7-SQ-3-27V-2GS-BLP-XD | 12V | 1 | 3W | INTEGRAL LED | 2700K 90 CRI | 3W | 260 LM | MLV/LED 10% MIN | BRONZE LIVING PATINA (BLACK) | STAKE LANDSCAPE GROUND/ PLANTER | 22" OFH | 3 |
| EAT | 50W REMOTE 12VAC POWER SUPPLY LOCATED IN DIRECT BURIAL HOUSING. | Q-TRAN | Q-HEX-M50W-120-12 Q-TRIX-R50 / Q-CLIK M5T/NPT | 120/12 | 1 | 20W | -- | -- | 20W | -- | MLV/LED 10% MIN | BLACK | DIRECT BURIAL | 12" RFD | 3 |
| EAT | FULL CUTOFF STAKE MOUNTED LOW VOLTAGE LED PATH LIGHT, 22" HEIGHT WITH 1" DIAMETER STEM 6-3/4" SQUARE TRIANGULAR HEAD, BRASS HOUSING 0MM DISTRIBUTION, GROUND STAKE, IP65 WET RATED | AURORALIGHT | LPL7-SQ-3-27V-2GS-BLP-XD | 12V | 1 | 7W | INTEGRAL LED | 2700K 90 CRI | 7W | 260 LM | MLV/LED 10% MIN | BRONZE LIVING PATINA (BLACK) | STAKE GROUND WITH CONCRETE BASE | 22" OFH | |
| EAT | 75W REMOTE 12VAC POWER SUPPLY LOCATED IN DIRECT BURIAL HOUSING. | Q-TRAN | Q-HEX-M75W-120-12 Q-TRIX-R50 / Q-CLIK M5T/NPT | 120/12 | 1 | 75W | -- | -- | 75W | -- | MLV/LED 10% MIN | BLACK | DIRECT BURIAL | 12" RFD | 3 |
| EAT | SURFACE MOUNTED CONCEALED CONTINUOUS LOW VOLTAGE LINEAR LED TAPELIGHT MOUNTED IN EXTRUDED ALUMINUM LINEAR CHANNEL, WITH DIFFUSED LENS, 1W/LF, FIELD ASSEMBLED | Q-TRAN | TAPE: SD-SW24-1.0-WET-27K-1LENTH1H CHANNEL: LA0-BK-SST-OF-XX-XX | 24V | 1 | 1 W PER FT | INTEGRAL LED | 2700K 90 CRI | 1 W PER FT | 100 LM PER FT | MLV/LED 10% MIN | BLACK | SURFACE UNDER BENCH | .75" OFH | 8,10 |
| EAT | 50W REMOTE 12VAC POWER SUPPLY LOCATED IN DIRECT BURIAL HOUSING. | Q-TRAN | Q-HEX-M50W-120-12 Q-TRIX-R50 / Q-CLIK M5T/NPT | 120/12 | 1 | 60 W | -- | -- | 60W | -- | MLV/LED 10% MIN | BLACK | DIRECT BURIAL | 12" RFD | 3,5 |
| EAT | SURFACE MOUNTED LINEAR ADJUSTABLE LED UPLIGHT, 10x10 OPTIC, 1.66" WIDE BY 2.7" TALL HOUSING, 17" OF LENGTH, 15W/LF, 450 LOUVER, IP66 WET RATED, 6" SETBACK FROM WALL | COOPER ID | GR2-15L-930-10x10-QD-UNV-S-ADJ-STD-24F / LM-LOUVER-45 | 120V | 1 | 15W PER FT | INTEGRAL LED | 3000K 82 CRI | 255W | 736 LM PER FT | 0-10V TO 1% | SILVER | SURFACE BEHIND VALANCE, 9" BELOW PANEL | 2.7" OFH | 4 |
| EAT | SURFACE MOUNTED LINEAR ADJUSTABLE LED UPLIGHT, 10x10 OPTIC, 1.66" WIDE BY 2.7" TALL HOUSING, 26" OF LENGTH, 15W/LF, 450 LOUVER, IP66 WET RATED, 6" SETBACK FROM WALL | COOPER ID | GR2-15L-930-10x10-QD-UNV-S-ADJ-STD-24F / LM-LOUVER-45 | 120V | 1 | 15W PER FT | INTEGRAL LED | 3000K 82 CRI | 390W | 736 LM PER FT | 0-10V TO 1% | SILVER | SURFACE BEHIND VALANCE, 9" BELOW PANEL | 2.7" OFH | 4 |
| EAT | SURFACE MOUNTED LINEAR ADJUSTABLE LED UPLIGHT, 10x10 OPTIC, 1.66" WIDE BY 2.7" TALL HOUSING, 33" OF LENGTH, 15W/LF, 450 LOUVER, IP66 WET RATED, 6" SETBACK FROM WALL | COOPER ID | GR2-15L-930-10x10-QD-UNV-S-ADJ-STD-24F / LM-LOUVER-45 | 120V | 1 | 15W PER FT | INTEGRAL LED | 3000K 82 CRI | 495W | 736 LM PER FT | 0-10V TO 1% | SILVER | SURFACE BEHIND VALANCE, 9" BELOW PANEL | 2.7" OFH | 4 |
| EAT | SURFACE MOUNTED CONCEALED CONTINUOUS LOW VOLTAGE LINEAR LED TAPELIGHT MOUNTED IN EXTRUDED ALUMINUM LINEAR CHANNEL, WITH DIFFUSED LENS, 1W/LF, FIELD ASSEMBLED | Q-TRAN | TAPE: SD-SW24-1.0-WET-27K-1LENTH1H CHANNEL: LA0-BK-SST-OF-XX-XX | 24V | 1 | 1 W PER FT | INTEGRAL LED | 2700K 90 CRI | 1 W PER FT | 100 LM PER FT | MLV/LED 10% MIN | BLACK | SURFACE UNDER COUNTER | .75" OFH | 8,10 |
| EAT | 50W REMOTE 12VAC POWER SUPPLY LOCATED IN DIRECT BURIAL HOUSING. | Q-TRAN | Q-HEX-M50W-120-12 Q-TRIX-R50 / Q-CLIK M5T/NPT | 120/12 | 1 | 60W | -- | -- | 60W | -- | MLV/LED 10% MIN | BLACK | DIRECT BURIAL | 12" RFD | 3 |
| EAT | TREE MOUNTED CONTINUOUS LOW VOLTAGE LED LIGHTS/HUNG MOUNTED AT CANOPY BRANCHES ONLY, 16.25" O.C. LED SPACING, 0.5W/LED 164 MAX RUN PER TREE, FULLY GASKETED JUNCTION BOX, VINYL ENDCAPS, NURSERY TAPE IP65 WET RATED | TOKSTAR | FLK-410-WW-WP FLK-410-WP-LED NBY-TP-200 | 8V | 1 | 0.1 W PER LED | INTEGRAL LED | 2400K 1200K 1200K | 120W | 10 LM | 0-10V TO 1% | BLACK | TREE CANOPY (BRANCHES) | -- | |
| EAT | EXTERIOR ROW BVD REMOTE DRIVER, 1.6" X 11" X 2.25" WITH (2) INDEPENDENT 40V OUTPUTS, INTEGRAL 0-10V DIMMING CARD IP65 WET RATED IN NEMA 3 enclosure | TOKSTAR | DRB-80 / LDR-DW | 8/120 | 1 | 80W | -- | -- | 80W | 80W | 0-10V TO 1% | WHITE | SURFACE | -- | 3,5,11 |
| EAT | OUTDOOR RATED FLOOR LAMP, LARGE BATTERY POWERED WITH REMOTE CONTROL | VONDOM | VASES FLOOR LAMP LARGE 47068Y | 120V | 1 | -- | INTEGRAL LED | 4000K RGBW | -- | -- | -- | WHITE | SURFACE GRADE | 7'-3" OFH | |
| EAT | OUTDOOR RATED FLOOR LAMP, MEDIUM BATTERY POWERED WITH REMOTE CONTROL | VONDOM | VASES FLOOR LAMP MEDIUM 47069Y | 120V | 1 | -- | INTEGRAL LED | 4000K RGBW | -- | -- | -- | WHITE | SURFACE GRADE | 5'-10" OFH | |
| EAT | OUTDOOR RATED FLOOR LAMP, SMALL BATTERY POWERED WITH REMOTE CONTROL | VONDOM | VASES FLOOR LAMP SMALL 47067Y | 120V | 1 | -- | INTEGRAL LED | 4000K RGBW | -- | -- | -- | WHITE | SURFACE GRADE | 27" OFH | |
| EAT | CANOPY BEAM RECESSED CONTINUOUS LINEAR LOW VOLTAGE LED STRAIGHT, 11.8" X 4" DEPTH WITH 120 DEG FLUSH FROSTED LENS, STAINLESS STEEL CLIPS, IP67 WET RATED | Q-TRAN | FLISSW-4-0-27-ENC-STD-1L-XX-XX-5" STD-BK-CLT-SST-BK-11-8" E | 24V | 1 | 4 W PER FT | INTEGRAL LED | 2700K 90 CRI | 48 W | 127 LM PER FT | PHASE TO 0.1% | BLACK | RECESSED METAL CANOPY | 0.81' RFD | 7 |
| EAT | 280W REMOTE 240VAC POWER SUPPLY IP66 WET RATED | Q-TRAN | QZ-280W-UNV-24V/PH/010-BK | 120/24 | 1 | 288 W | -- | -- | 288 W | -- | PHASE TO 0.1% | BLACK | SURFACE | -- | 3,5 |
| EAT | SURFACE MOUNTED LOW VOLTAGE HIGH OUTPUT LED ADJUSTABLE MONOPOINT, 2.5" DIAMETER X 6" LONG SHIELDED BRASS HOUSING, 900 FLUSH CAP, 30-DEG MFL OPTICS, STEPPED HEX BATTLE, LINEAR SPREAD LENS, TRELLIS MOUNT, IP66 WET RATED | AURORALIGHT | H0120-LM-90-6-M-279-SBH-1-TM-BLP-XD | 12V | 1 | 8W | INTEGRAL LED | 2700K 90 CRI | 8 W | 350 LM | MLV/LED 10% MIN | BRONZE LIVING PATINA (BLACK) | SURFACE METAL CANOPY | 6" OFH | |
| EAT | SURFACE MOUNTED LOW VOLTAGE HIGH OUTPUT LED ADJUSTABLE MONOPOINT, 2.5" DIAMETER X 6" LONG SHIELDED BRASS HOUSING, 900 FLUSH CAP, 30-DEG MFL OPTICS, STEPPED HEX BATTLE, MICRO PRISMATIC LENS, TRELLIS MOUNT, IP66 WET RATED | AURORALIGHT | H0120-LM-90-1E-M-279-SBH-1-TM-BLP-XD | 12V | 1 | 12W | INTEGRAL LED | 2700K 90 CRI | 12 W | 515 LM | MLV/LED 10% MIN | BRONZE LIVING PATINA (BLACK) | SURFACE METAL CANOPY | 6" OFH | |
| EAT | 100W REMOTE 12VAC POWER SUPPLY, 2 TAPS IP66 WET RATED | Q-TRAN | QZMG-100ST-120-12V-2-10-CK-S-00-CP | 120/12 | 1 | 100W | -- | -- | 100 W | -- | MLV/LED 10% MIN | BLACK | SURFACE | -- | 3 |
| EAT | SURFACE MOUNTED LINEAR LOW VOLTAGE LED CUSTOM SQUARE PATTERN, 2" DIRECT VIEW WHITE FLUSH LOW OUTPUT DOWNWARD / PERPENDICULAR TO ARCHITECTURAL, MATTE WHITE PANEL, 1.75" DEPTH, (5" 10" X 4" 0" SQUARE), TOTAL LENGTH 19" 8", CUSTOM FEED LENGTH PER EC TO REMOTE DRIVER, IP66 WET RATED | KELVIX | LED1PLIGHT: DL30K-WR-24V-WOD CHANNEL: CH-228-N-WH-CP-EC CUSTOM SHOP DRAWING REQUIRED BY MANUFACTURER | 120/24 | 1 | 2.6W PER FT | INTEGRAL LED | 3000K 90 CRI | 52 W | 189 PER FT | TO 1% | WHITE | SURFACE METAL FIN | 1.75" OFH | 9 |
| EAT | 50W REMOTE 12VAC POWER SUPPLY IP66 WET RATED | KELVIX | FLV96 | 120/24 | 1 | 96W | -- | -- | 96W | -- | ELV TO 1% | BLACK | SURFACE | -- | 3,5 |
| EAT | OWNER PROVIDED CUSTOM DECORATIVE ADA WALL SCORNE, 8" TALL X 6" 8" WIDE X 4" DEPTH TRIANGULAR, WET RATED, UL RATED, FULL CUTOFF | OFCI | OFCI | 120V | 1 | 15W | INTEGRAL LED | 2700K 90 CRI | 152 | 1000 LM | PHASE TO 1% | AGED BRASS | SURFACE WALL | 3'-0" OFH 80" PER I.D. | |
| EAT | POUR-IN CONCRETE WALL SLM RECESSED LOW VOLTAGE LED STRAIGHT, 1.4" SQUARE IP66 WET RATED, CONCRETE HOUSING MIT, DRY RATED LOCATED INDOORS | INTERLUX | EN66-50B-AE-16-1CC-27W-AS | 12V | 1 | 1 W | INTEGRAL LED | 2700K 85 CRI | 1 W | 30 LM | 0-10V TO 1% | DARK BROWN | SWM RECESSED (CONCRETE) | 1.6" OFH 1" RFD | 11 |
| EAT | 20W REMOTE DRIVER FOR 4-10 FIXTURES DRY RATED LOCATED INDOORS | INTERLUX | SC1010W-350 | 120/12 | 1 | 100W | -- | -- | 100W | -- | 0-10V TO 1% | -- | SURFACE | -- | 13 |
| EAT | FULL CUTOFF SURFACE MOUNTED LED ADA WALL SCORNE, 8" TALL X 6" 8" WIDE X 4" DEPTH, INTEGRAL PHOTOCELL, IP66 WET RATED | FC LIGHTING | FC10B84-UNV-827-BL-BKE-ASY-PE | 120V | 1 | 16W | INTEGRAL LED | 2700K 85 CRI | 16W | 800 LM | SWITCHING | BLACK | SURFACE WALL | MATCH EXISTING | |
| EAT | FULL CUTOFF SURFACE MOUNTED LED ADA WALL SCORNE, 8" TALL X 6" 8" WIDE X 4" DEPTH, INTEGRAL PHOTOCELL, IP66 WET RATED | FC LIGHTING | FC10B84-UNV-830-BL-BKE-ASY-PE | 120V | 1 | 16W | INTEGRAL LED | 3000K 85 CRI | 16W | 800 LM | SWITCHING | BLACK | SURFACE WALL | MATCH EXISTING | |

ABBREVIATIONS: EDP - BOTTOM OF FIXTURE, RFD - RECESSED FIXTURE DEPTH, OFH - OVERALL FIXTURE HEIGHT, AFFIAPG - ABOVE FINISHED FLOOR (GRADE), WFD - WALL FIXTURE DEPTH, OFCI - OWNER FURNISHED CONTRACTOR INSTALLED

E

D

C

B

A

COMcheck Software Version COMcheckWeb
Exterior Lighting Compliance Certificate

Project Information

Energy Code: 2018 IECC
Project Title: 5883.00 - Park Square Exterior
Project Type: New Construction
Exterior Lighting Zone: 2 (Neighborhood business district (LZ2))

Construction Site: Owner/Agent: Designer/Contractor:

Allowed Exterior Lighting Power

| A Area/Surface Category | B Quantity | C Allowed Watts / | D Tradable Wattage | E Allowed Watts (B X C) |
|--|---------------|-------------------------|--------------------------|-------------------------------|
| large lot (Parking area) | 85000 ft2 | 0.04 | Yes | 3400 |
| small lot (Parking area) | 7600 ft2 | 0.04 | Yes | 312 |
| Plaza area | 31900 ft2 | 0.1 | Yes | 3190 |
| illuminated area of facade wall or surface | 67652 ft2 | 0.07 | No | 5074 |
| sw site (Walkway < 10 feet wide) | 130 ft of | 0.5 | Yes | 65 |
| nw site (Walkway < 10 feet wide) | 220 ft of | 0.5 | Yes | 110 |
| se site (Walkway < 10 feet wide) | 430 ft of | 0.5 | Yes | 215 |

Total Tradable Watts (a) = 7792
Total Allowed Watts = 12366
Total Allowed Supplemental Watts (b) = 460

(a) Wattage tradeoffs are only allowed between tradable areas/surfaces.
(b) A supplemental allowance equal to 400 watts may be applied toward compliance of both non-tradable and tradable areas/surfaces.

Proposed Exterior Lighting Power

| Fixture ID : Description / Lamp / Wattage Per Lamp / Ballast | B Lamps/ Fixture | C # of Fixture | D Fixture Watt. | E (C X D) |
|--|------------------------|----------------------|-----------------------|--------------|
| large lot (Parking area, 85000 ft2): Tradable Wattage | | | | |
| LED: E1: Other: | 1 | 5 | 90 | 450 |
| LED: EA3: Other: | 1 | 2 | 90 | 180 |
| LED: EA6: Other: | 1 | 5 | 95 | 275 |
| LED: EA6: Other: | 1 | 2 | 90 | 180 |
| small lot (Parking area, 7600 ft2): Tradable Wattage | | | | |
| LED: EA2: Other: | 1 | 8 | 36 | 288 |
| Plaza area (31900 ft2): Tradable Wattage | | | | |
| LED: EA1: Other: | 1 | 6 | 36 | 216 |
| LED: EF1: Other: | 1 | 33 | 3 | 99 |
| LED: EF2: Other: | 1 | 48 | 3 | 144 |
| LED: EG2: Other: | 1 | 11 | 3 | 33 |
| LED: EG3: Other: | 1 | 11 | 7 | 77 |
| LED: EL1: Other: | 1 | 575 | 1 | 575 |
| LED: EL3: Other: | 1 | 40 | 1 | 40 |
| LED: EL4: Other: | 1 | 1000 | 0 | 100 |

Project Title: 5883.00 - Park Square Exterior Report date: 01/30/24
Data filename: Page 1 of 5

| Section # & Req. ID | Rough-In Electrical Inspection | Complies? | Comments/Assumptions |
|--------------------------------|--|---|--|
| C405.2.5 [EL28] ^{1,2} | Manual controls required by the energy code are in a location with ready access to occupants and located where the controlled lights are visible, or identify the area served and their status. | <input type="checkbox"/> Complies <input checked="" type="checkbox"/> Does Not <input type="checkbox"/> Not Observable <input type="checkbox"/> Not Applicable | Exception: Requirement does not apply. |
| C405.2.6 [EL30] ^{1,2} | Automatic lighting controls for exterior lighting installed. Controls will be daylight controlled, set based on business operation time-of-day, or reduce connected lighting > 30%. | <input type="checkbox"/> Complies <input checked="" type="checkbox"/> Does Not <input type="checkbox"/> Not Observable <input type="checkbox"/> Not Applicable | Requirement will be met. |
| C405.6 [EL26] ¹ | Low-voltage dry-type distribution electric transformers meet the minimum efficiency requirements of Table C405.6. | <input type="checkbox"/> Complies <input checked="" type="checkbox"/> Does Not <input type="checkbox"/> Not Observable <input type="checkbox"/> Not Applicable | |
| C405.7 [EL27] ¹ | Electric motors meet the minimum efficiency requirements of Tables C405.7(1) through C405.7(4). Efficiency verified through certification under an approved certification program or the equipment efficiency ratings shall be provided by motor manufacturer (where certification programs do not exist). | <input type="checkbox"/> Complies <input checked="" type="checkbox"/> Does Not <input type="checkbox"/> Not Observable <input type="checkbox"/> Not Applicable | |
| C405.8.2 [EL28] ¹ | Escalators and moving walks comply with ASME A17.1/CSA B44 and have automatic controls configured to reduce speed to the minimum permitted speed in accordance with ASME A17.1/CSA B44 or applicable local code when not conveying passengers. | <input type="checkbox"/> Complies <input checked="" type="checkbox"/> Does Not <input type="checkbox"/> Not Observable <input type="checkbox"/> Not Applicable | |
| C405.9 [EL29] ¹ | Total voltage drop across the combination of feeders and branch circuits <= 5%. | <input type="checkbox"/> Complies <input checked="" type="checkbox"/> Does Not <input type="checkbox"/> Not Observable <input type="checkbox"/> Not Applicable | |

Additional Comments/Assumptions:

1 High Impact (Tier 1) 2 Medium Impact (Tier 2) 3 Low Impact (Tier 3)
Project Title: 5883.00 - Park Square Exterior Report date: 01/30/24
Data filename: Page 4 of 5

| Fixture ID : Description / Lamp / Wattage Per Lamp / Ballast | B Lamps/ Fixture | C # of Fixture | D Fixture Watt. | E (C X D) |
|--|------------------------|----------------------|-----------------------|--------------|
| LED: EL4: Other: | 1 | 230 | 0 | 23 |
| LED: ER1: Other: | 1 | 72 | 4 | 288 |
| LED: ES1: Other: | 1 | 3 | 8 | 24 |
| LED: ES2: Other: | 1 | 4 | 12 | 48 |
| LED: EW1: Other: | 1 | 6 | 15 | 90 |
| LED: EW2: Other: | 1 | 28 | 1 | 28 |
| LED: EW3: Other: | 1 | 7 | 16 | 112 |
| LED: (E) DOWNLIGHT: Other: | 1 | 11 | 20 | 220 |
| LED: (E) WALL SCONCE: Other: | 1 | 10 | 20 | 200 |
| illuminated area of facade wall or surface (67652 ft2): Non-tradable Wattage | | | | |
| LED: ES3: Other: | 1 | 23 | 52 | 1196 |
| LED: EL2: Other: | 1 | 169 | 15 | 2535 |
| sw site (Walkway < 10 feet wide, 130 ft of walkway length): Tradable Wattage | | | | |
| LED: EG2: Other: | 1 | 9 | 3 | 27 |
| nw site (Walkway < 10 feet wide, 220 ft of walkway length): Tradable Wattage | | | | |
| LED: EA5: Other: | 1 | 1 | 90 | 90 |
| LED: EB1: Other: | 1 | 2 | 28 | 56 |
| LED: EW4: Other: | 1 | 2 | 16 | 32 |
| se site (Walkway < 10 feet wide, 430 ft of walkway length): Tradable Wattage | | | | |
| LED: EA1: Other: | 1 | 2 | 36 | 72 |
| LED: ED1: Other: | 1 | 5 | 6 | 32 |
| LED: EF9: Other: | 1 | 8 | 6 | 48 |
| LED: EG3: Other: | 1 | 9 | 7 | 63 |
| Total Tradable Proposed Watts = 4110 | | | | |

Exterior Lighting PASSES: Design 47% better than code

Exterior Lighting Compliance Statement

Compliance Statement: The proposed exterior lighting design represented in this document is consistent with the building plans, specifications, and other calculations submitted with this permit application. The proposed exterior lighting systems have been designed to meet the 2018 IECC requirements in COMcheck Version COMcheckWeb and to comply with any applicable mandatory requirements listed in the Inspection Checklist.

Emily Barnett - Senior Project Engineer
Name - Title: Signature: 01/30/2024
Date

Project Title: 5883.00 - Park Square Exterior Report date: 01/30/24
Data filename: Page 2 of 5

| Section # & Req. ID | Final Inspection | Complies? | Comments/Assumptions |
|-----------------------------|---|---|--|
| C405.5.1 [F19] ¹ | Exterior lighting power is consistent with what is shown on the approved lighting plans, demonstrating proposed watts are less than or equal to allowed watts. | <input type="checkbox"/> Complies <input checked="" type="checkbox"/> Does Not <input type="checkbox"/> Not Observable <input type="checkbox"/> Not Applicable | See the Exterior Lighting fixture schedule for values. |
| C408.1.1 [F15] ¹ | Building operations and maintenance documents will be provided to the owner. Documents will cover manufacturers' information, specifications, programming procedures and means of illustrating to owner how building, equipment and systems are intended to be installed, maintained, and operated. | <input type="checkbox"/> Complies <input checked="" type="checkbox"/> Does Not <input type="checkbox"/> Not Observable <input type="checkbox"/> Not Applicable | |

Additional Comments/Assumptions:

1 High Impact (Tier 1) 2 Medium Impact (Tier 2) 3 Low Impact (Tier 3)
Project Title: 5883.00 - Park Square Exterior Report date: 01/30/24
Data filename: Page 5 of 5

COMcheck Software Version COMcheckWeb
Inspection Checklist

Energy Code: 2018 IECC

Requirements: 100.0% were addressed directly in the COMcheck software
Text in the "Comments/Assumptions" column is provided by the user in the COMcheck Requirements screen. For each requirement, the user certifies that a code requirement will be met and how that is documented, or that an exception is being claimed. Where compliance is itemized in a separate table, a reference to that table is provided.

| Section # & Req. ID | Plan Review | Complies? | Comments/Assumptions |
|---------------------|---|---|--------------------------|
| C103.2 [PM1] | Plans, specifications, and/or calculations provide all information with which compliance can be determined for the exterior lighting and electrical systems and equipment and document where exceptions to the standard are claimed. Information provided should include exterior lighting power calculations, wattage of bulbs and ballasts, transformers and control devices. | <input type="checkbox"/> Complies <input checked="" type="checkbox"/> Does Not <input type="checkbox"/> Not Observable <input type="checkbox"/> Not Applicable | Requirement will be met. |
| C406 [PM9] | Plans, specifications, and/or calculations provide all information with which compliance can be determined for the additional energy efficiency package options. | <input type="checkbox"/> Complies <input checked="" type="checkbox"/> Does Not <input type="checkbox"/> Not Observable <input type="checkbox"/> Not Applicable | |

Additional Comments/Assumptions:

1 High Impact (Tier 1) 2 Medium Impact (Tier 2) 3 Low Impact (Tier 3)
Project Title: 5883.00 - Park Square Exterior Report date: 01/30/24
Data filename: Page 3 of 5

CONSULTANTS

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Park Square Plaza Renovation

100% CD

6565 AMERICAS PKWY
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APRIL 2024

MARK DATE DESCRIPTION



ISSUE: 100% CD
DATE: APRIL 2024
PROJECT NO: 5883.00
DRAWN BY: AEC,CK,EB
CHECKED BY: AJS,MRS

SHEET TITLE

LIGHTING COMPLIANCE

LE-900

PARK SQUARE MARKET

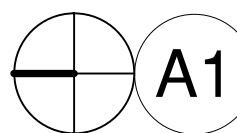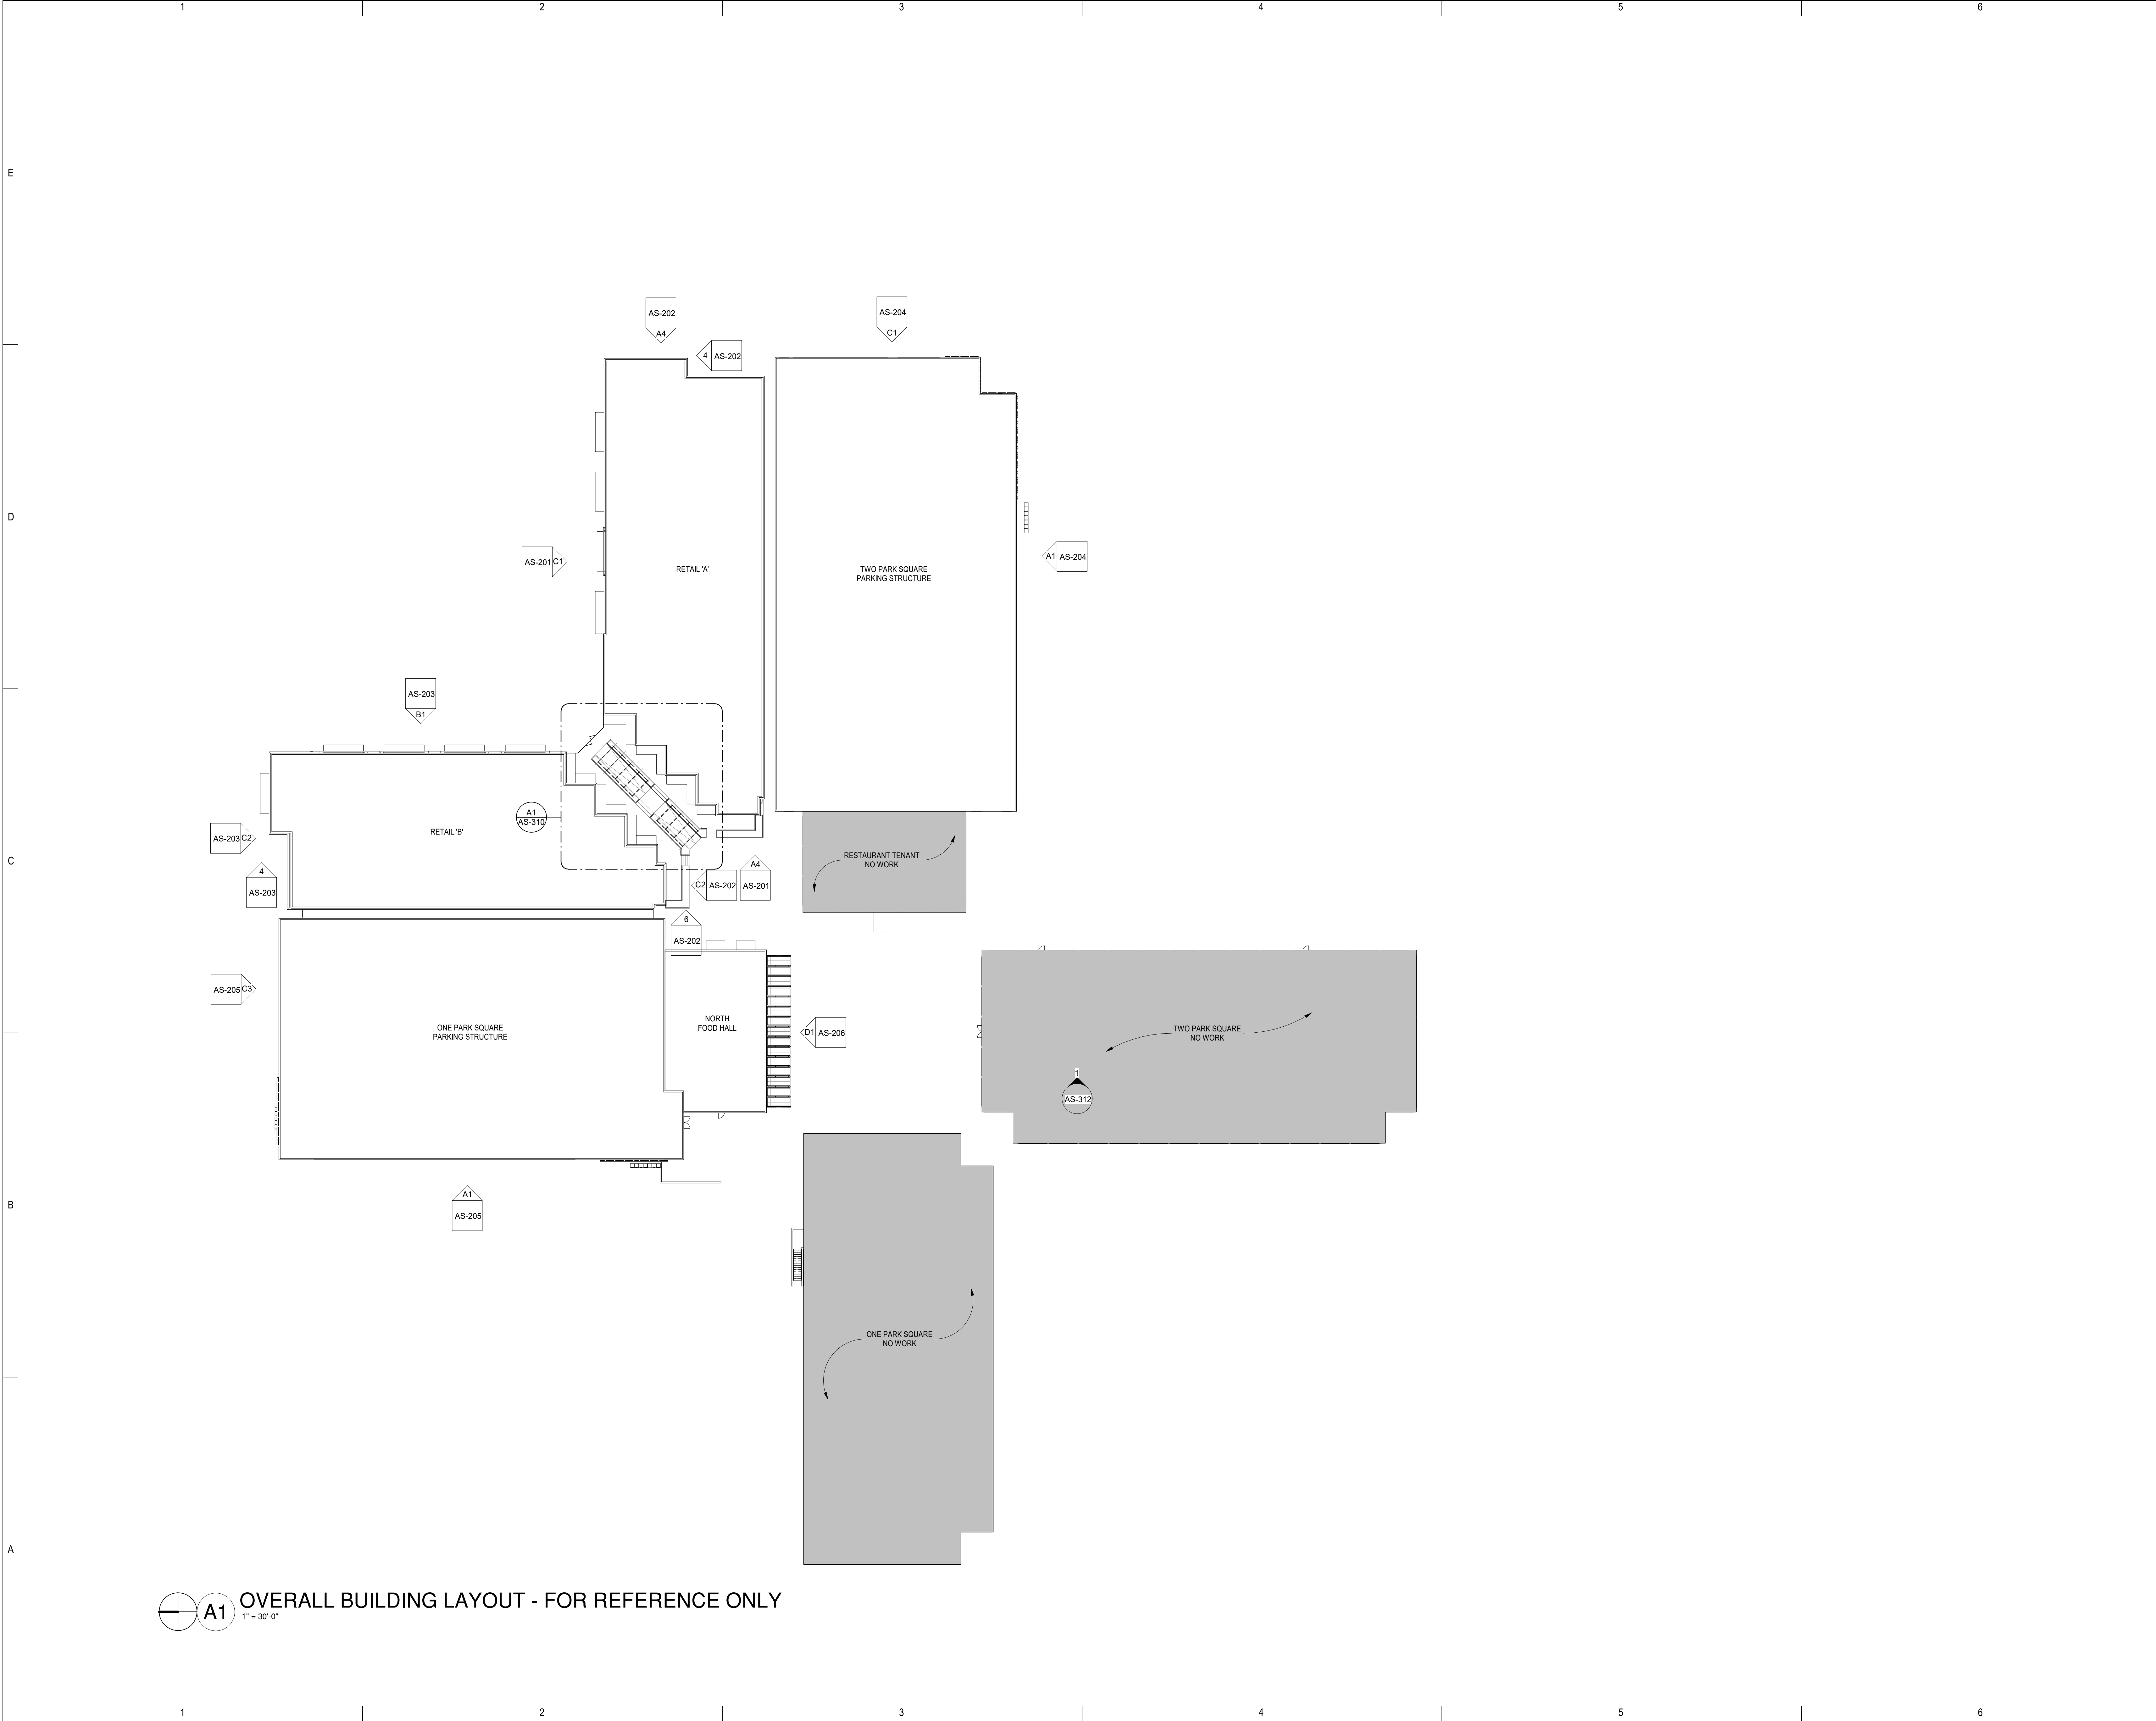

OVERALL BUILDING LAYOUT - FOR REFERENCE ONLY

1" = 30'-0"

4/22/2024 10:35:41 AM

fbt | architects

6501 Americas Pkwy NE, Ste. 300
Albuquerque, NM 87110
P_505.883.5200 WEB: www.fbtarch.com

CONSULTANTS

LIGHTING

AE Design
1900 Wazee St #205
Denver, CO 80202

LANDSCAPING

Groundwork Studio
6501 Americas Pkwy
Albuquerque, NM 87110
p_505.881.3008

CIVIL

NVS
6501 Americas Pkwy
Albuquerque, NM 87110
p_505.510.0850

INTERIORS

Maximalist Experience Design
Denver, CO
p_720.732.6838

ELECTRICAL

AC Engineering Enterprises, LLC
141 E Palace Ave
Santa Fe, NM 87501
p_505.842.5787

STRUCTURAL

Quiroga-Pfeiffer Engineering Corp.
4343 Pan American Freeway NE Suite #228
Albuquerque, NM 87107
p_505.858.1456



ARCHITECT

PARK SQUARE PLAZA
EXTERIOR IMPROVEMENTS

100% BID SET

6565 AMERICAS PKWY
ALBUQUERQUE, NM 87110

APRIL 2024

| MARK | DATE | DESCRIPTION |
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| DATE: | APRIL 2024 |
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| CHECKED BY: | AV |

SHEET TITLE

SCOPE OF WORK - FOR
REFERENCE ONLY

AS-100

PARK SQUARE MARKET

CONSULTANTS

LIGHTING

AE Design
1900 Wazee St #205
Denver, CO 80202

LANDSCAPING

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INTERIORS

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p. 720.732.5838

ELECTRICAL






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STRUCTURAL

Quiroga-Pfeiffer Engineering Corp.
4343 Pan American Freeway NE Suite #228
Albuquerque, NM 87107
p. 505.858.1456

KEYNOTES

| | |
|-----|---|
| 201 | ALUMINUM STOREFRONT ASSEMBLY TO REMAIN. |
| 205 | EXISTING FIXTURE REMOUNTED OVER NEW EXTERIOR TILE FINISH. TILE MANUFACTURER: DALTILE. SERIES: ELEMENTAL SELECTION. COLOR: MOONSTONE CM11 MATTE. |
| 208 | REMOVE EXISTING PAINTED STUCCO FINISH DOWN TO EXISTING CONCRETE SURFACE. |
| 213 | BUILDING SIGNAGE. REMOVE AND PROTECT DURING CONSTRUCTION. REMOUNT TO FACE OF CONCRETE. |
| 215 | EXISTING STUCCO TO REMAIN. |
| 216 | NEW METAL FRAMED BUMP OUT WITH A TILE FINISH SYSTEM. TILE MANUFACTURER: DALTILE. SERIES: ELEMENTAL SELECTION. COLOR: MOONSTONE CM11 MATTE. |
| 218 | NEW STUCCO FINISH OVER EXISTING CONCRETE. |
| 219 | EXISTING CONCRETE REVEAL. |
| 228 | REMOVE EXISTING EXTERIOR TILE AND METAL COPING. |
| 230 | NEW EXTERIOR TILE FINISH AND CAP. SEE DETAILS A2 & A3/A5-311. TILE MANUFACTURER: DALTILE. SERIES: ELEMENTAL SELECTION. COLOR: MOONSTONE CM11 MATTE. |
| 232 | REMOVE EXISTING SLATE TILE BEHIND LIGHT FIXTURE. LIGHT FIXTURE TO BE REINSTALLED. |
| 233 | NEW FOAM CAP WITH SYNTHETIC PASTER FINISH. SEE DETAIL B1/A5-311. |
| 237 | EXISTING CANOPY TO BE REMOVED. |
| 240 | EXISTING CANOPY TO REMAIN. NEW PAINT FINISH. COLOR TO BE SELECTED BY ARCHITECT. |
| 241 | REMOVE EXISTING SLATE TILE WAINSCOT SYSTEM AND STUCCO CAP. |
| 245 | EXISTING CONCRETE FINISH TO REMAIN. |
| 246 | EXISTING LIGHTING IN CANOPY TO REMAIN BUT DE-ENERGIZE THE CIRCUIT TO KEEP LIGHTS OFF. |
| 247 | REMOVE EXISTING SLATE TILE AND LIGHT FIXTURE. NEW LIGHT FIXTURE TO BE INSTALLED IN SAME LOCATION REFER TO LIGHTING. |
| 248 | NEW LIGHT FIXTURE REFER TO LIGHTING. |

C1 RENOVATION ELEVATION RETAIL 'A' NORTH
1/8" = 1'-0"B1 DEMOLITION ELEVATION RETAIL 'A' NORTH
1/8" = 1'-0"A1 DEMOLITION ELEVATION RETAIL 'A' WEST
1/8" = 1'-0"A4 RENOVATION ELEVATION RETAIL 'A' WEST
1/8" = 1'-0"PARK SQUARE PLAZA
EXTERIOR IMPROVEMENTS

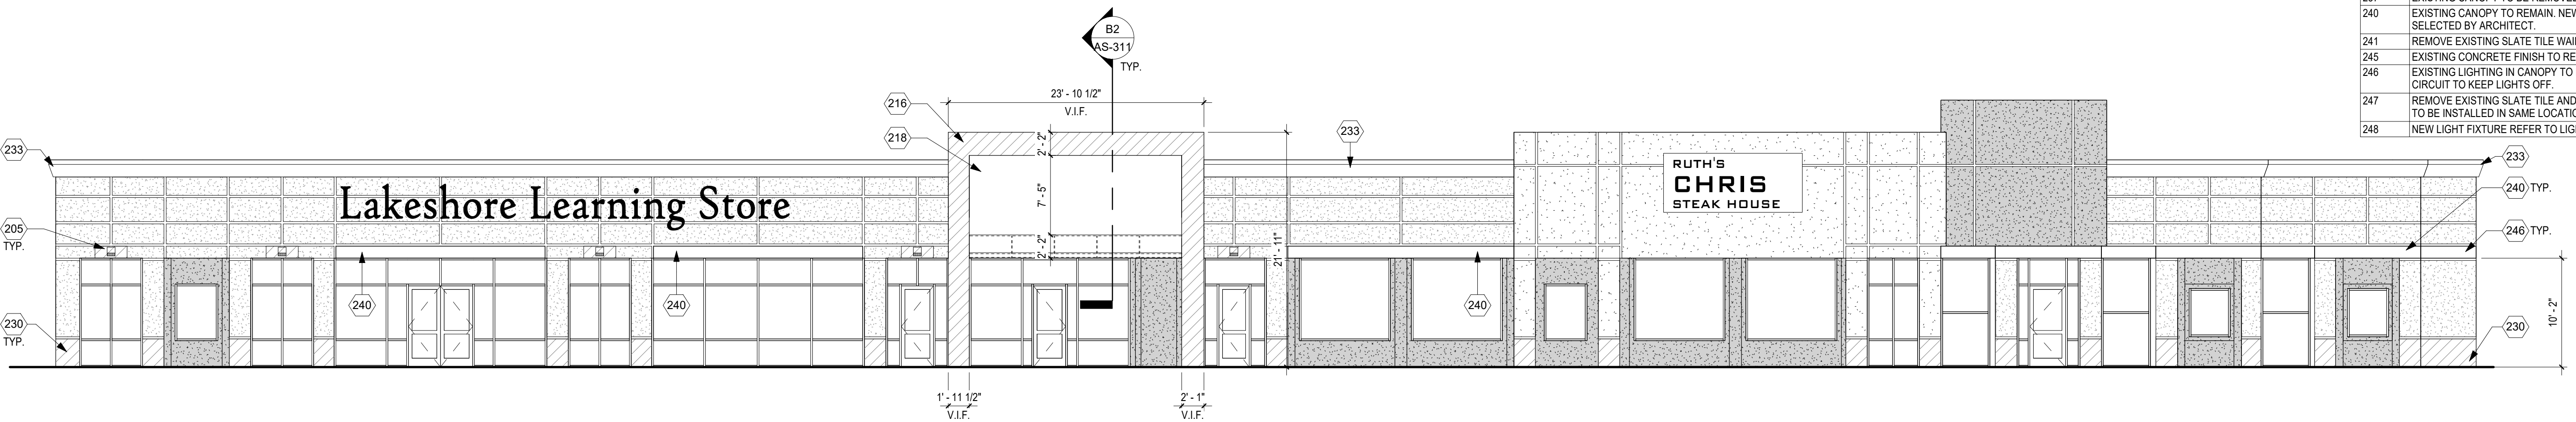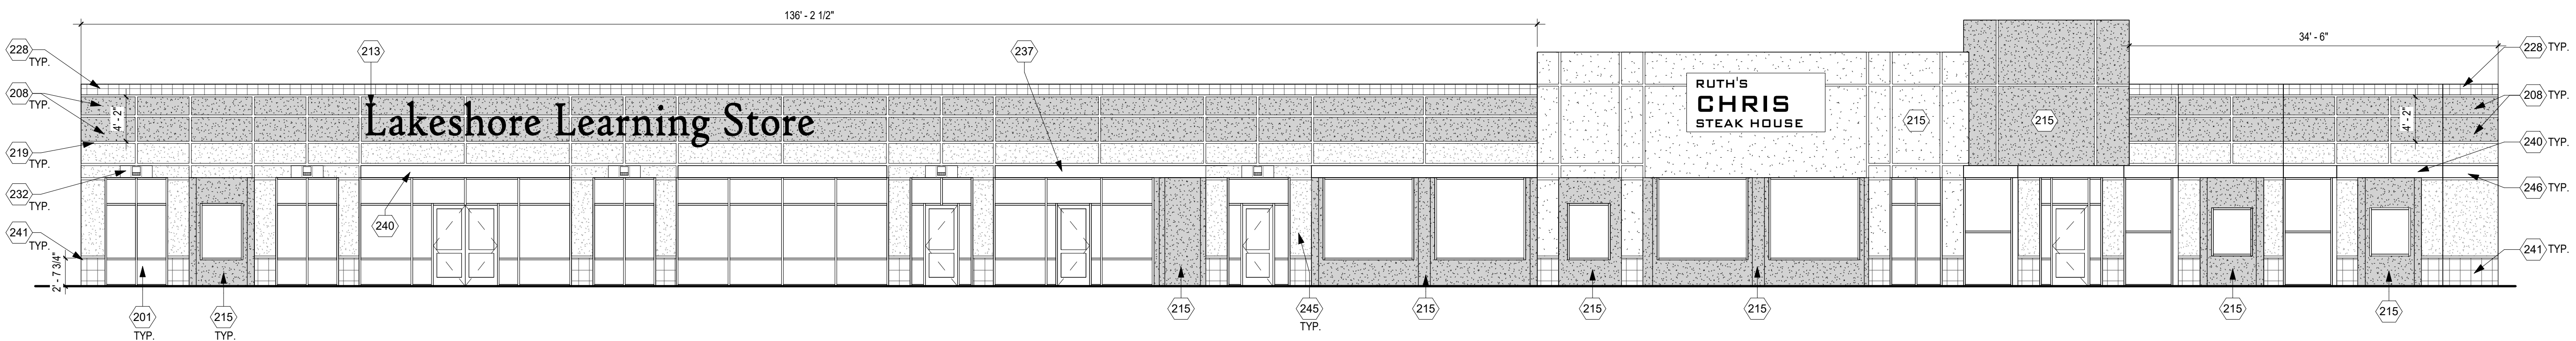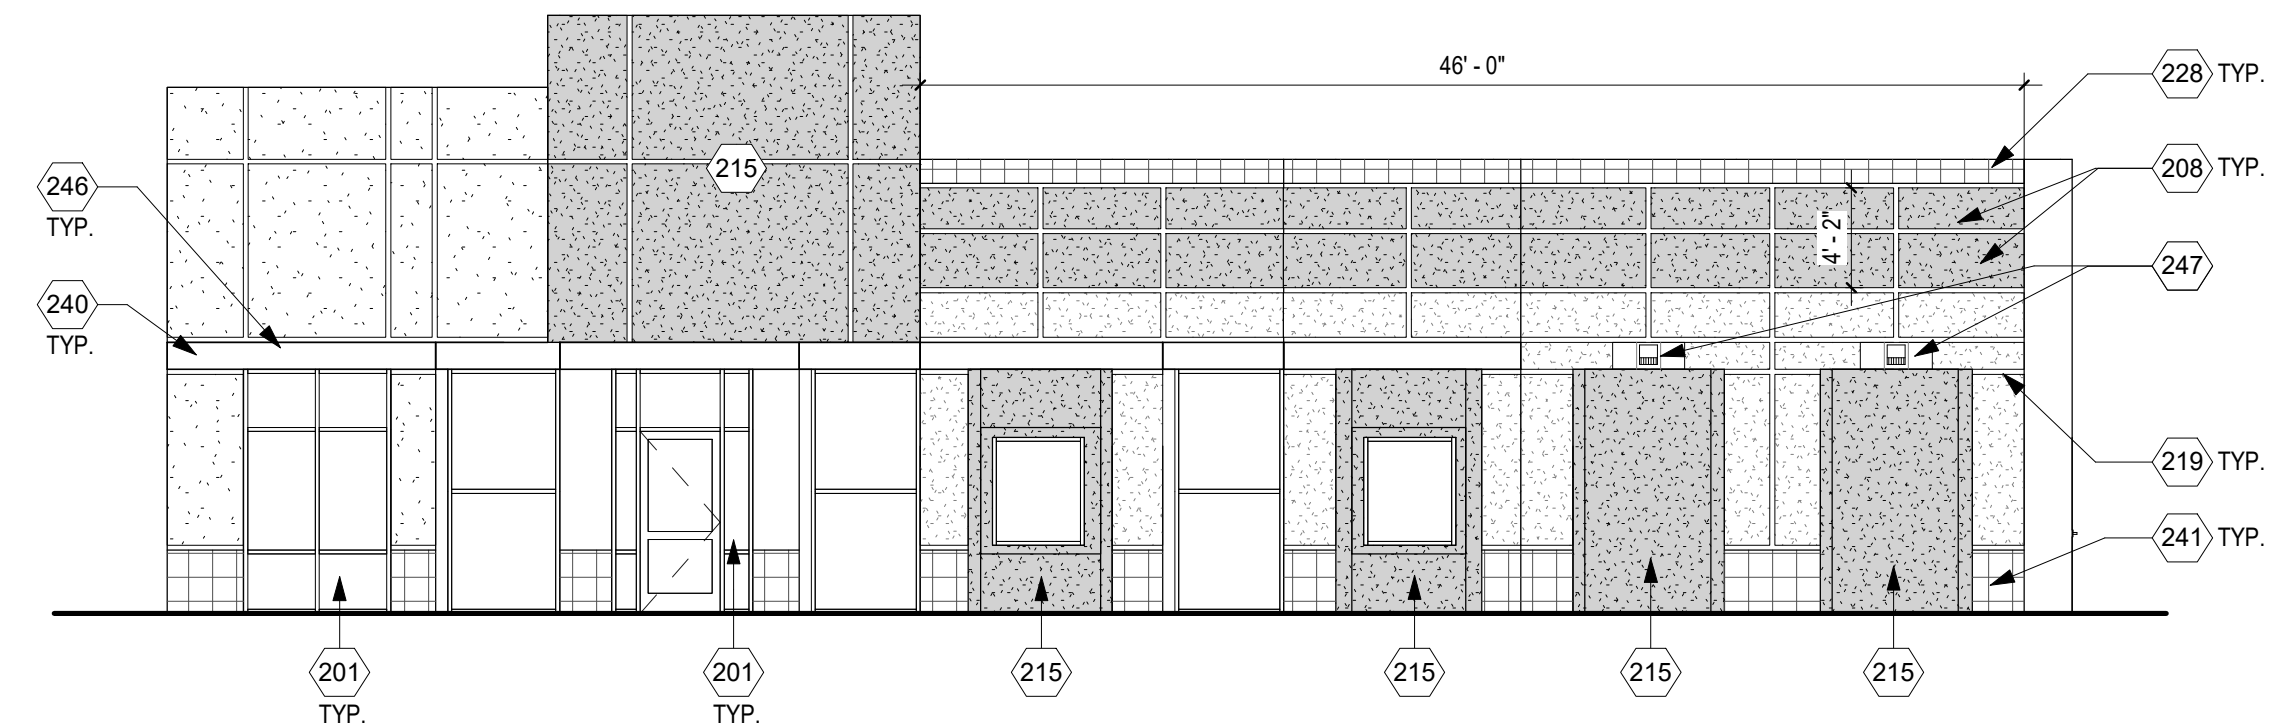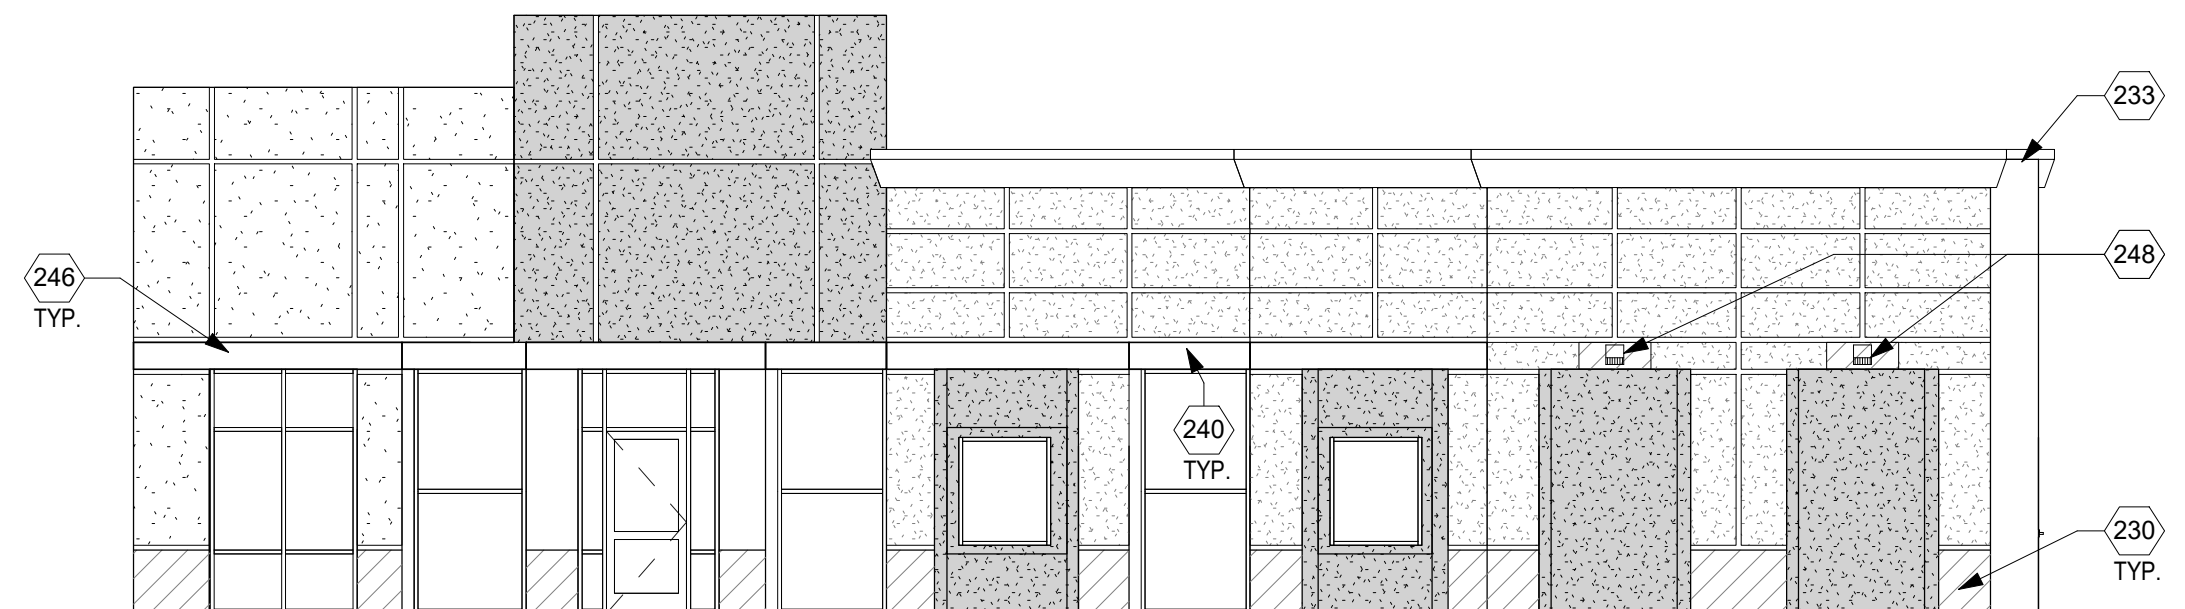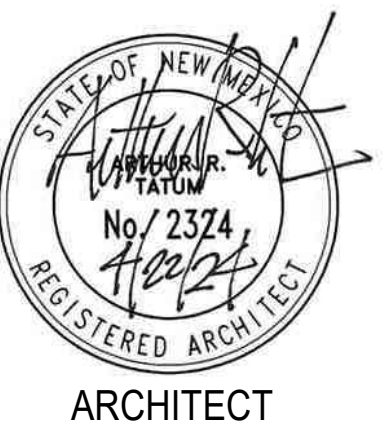100% BID SET

6565 AMERICAS PKWY
ALBUQUERQUE, NM 87110


APRIL 2024

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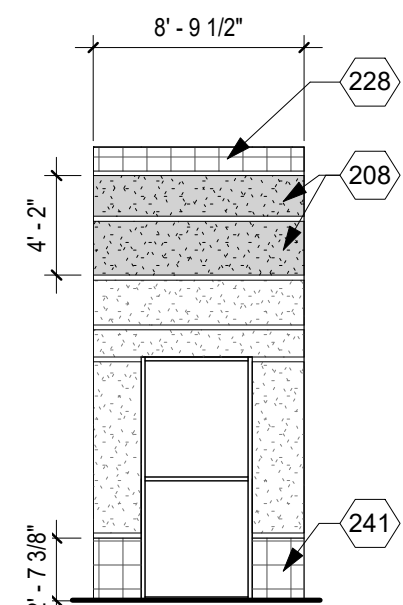
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SHEET TITLE


BUILDING ELEVATIONS



C1 DEMOLITION ELEVATION RETAIL 'B' SOUTH
1/8" = 1'-0"

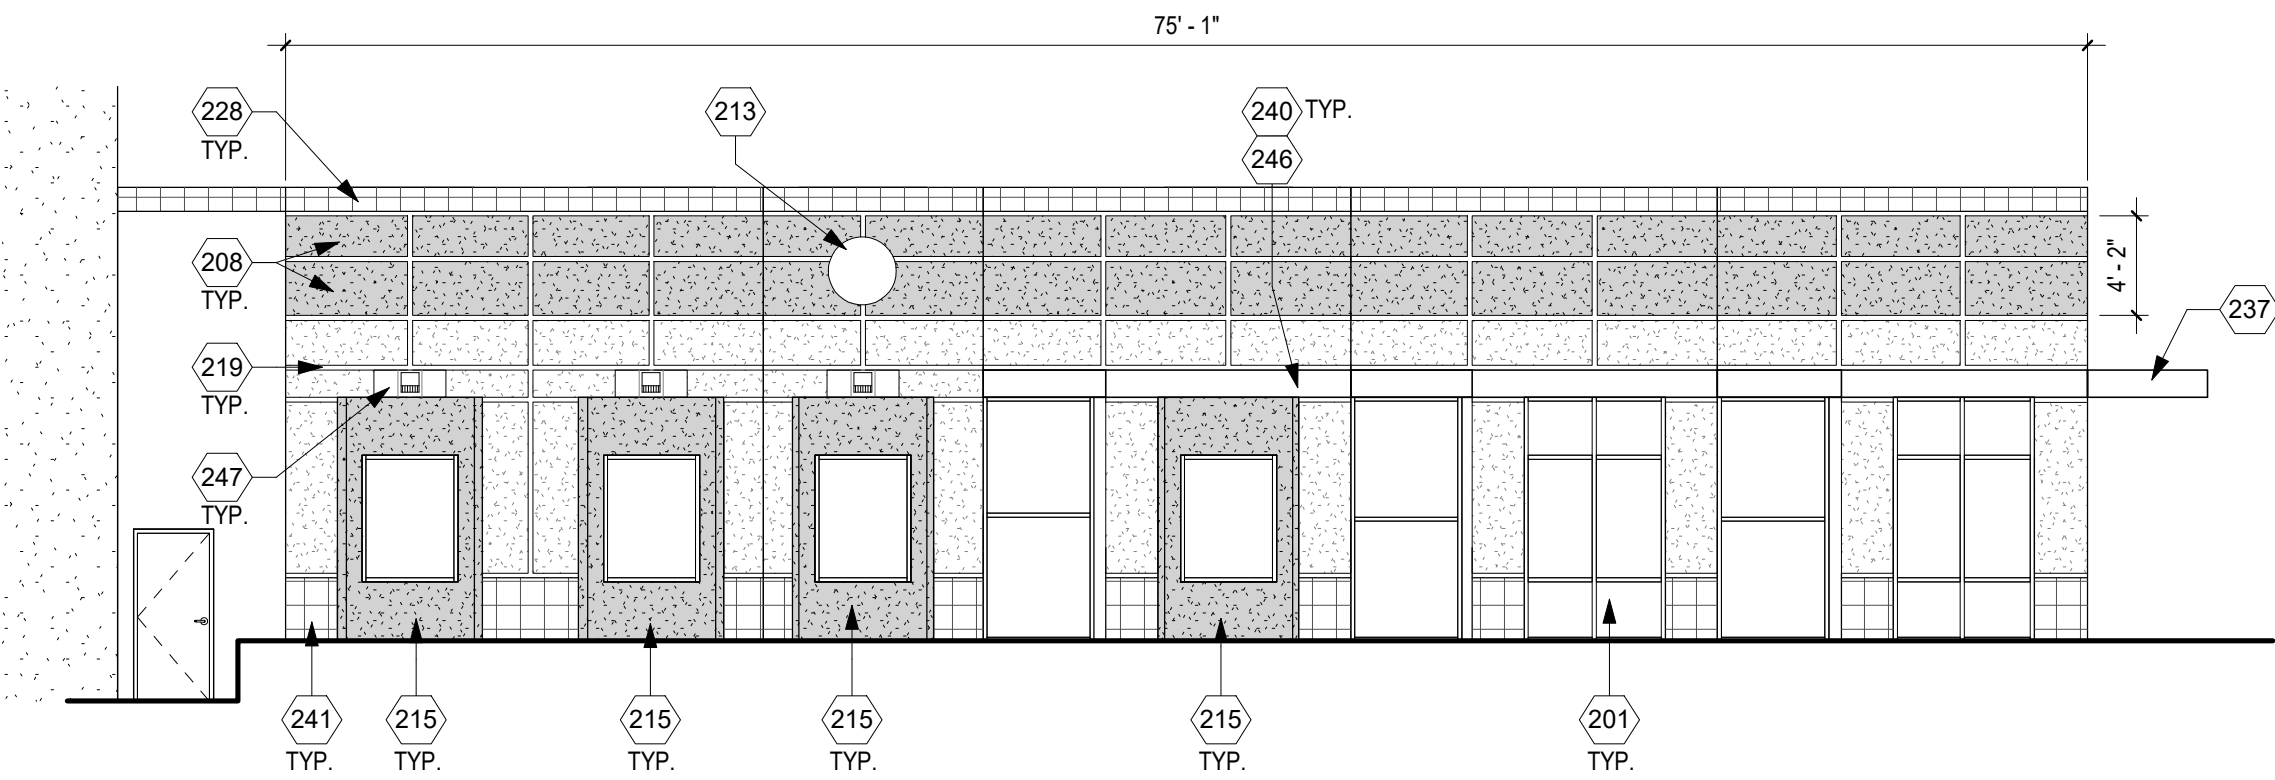


DEMOLITION

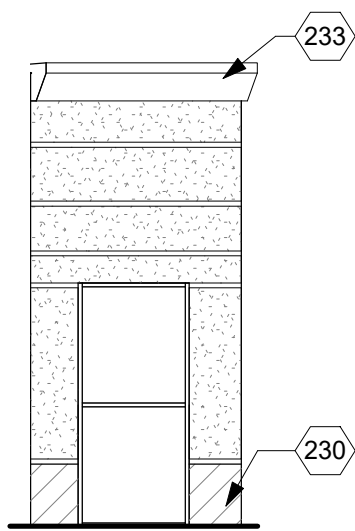


RENOVATION


B1 ELEVATION RETAIL 'A' SOUTH
1/8" = 1'-0"

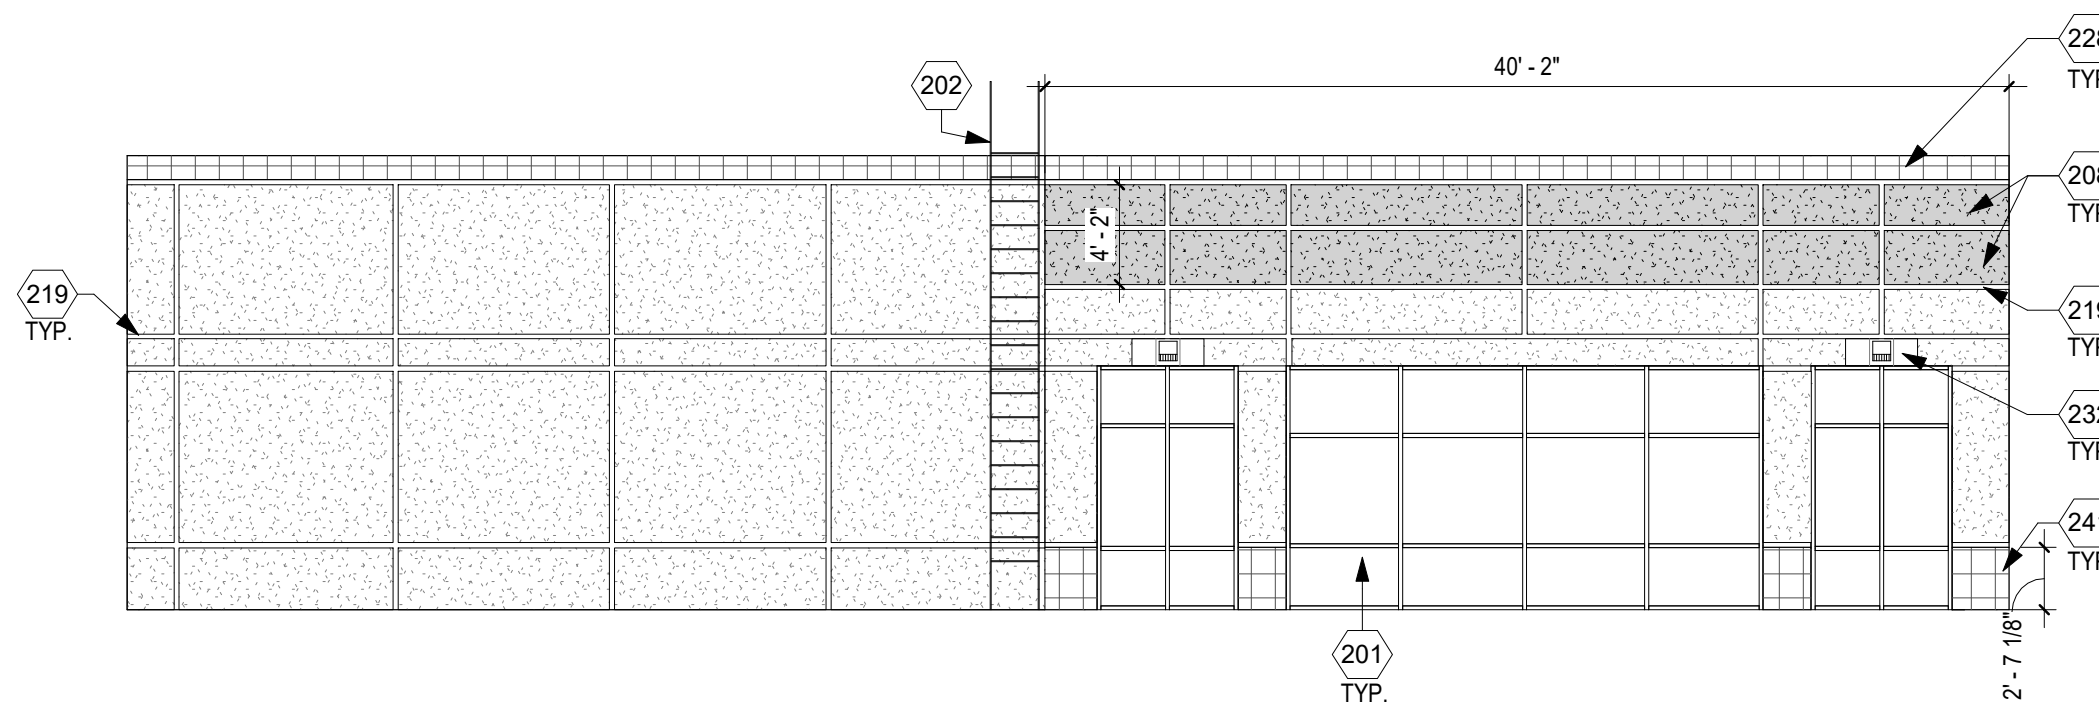


A1 DEMOLITION ELEVATION RETAIL 'A' EAST
1/8" = 1'-0"

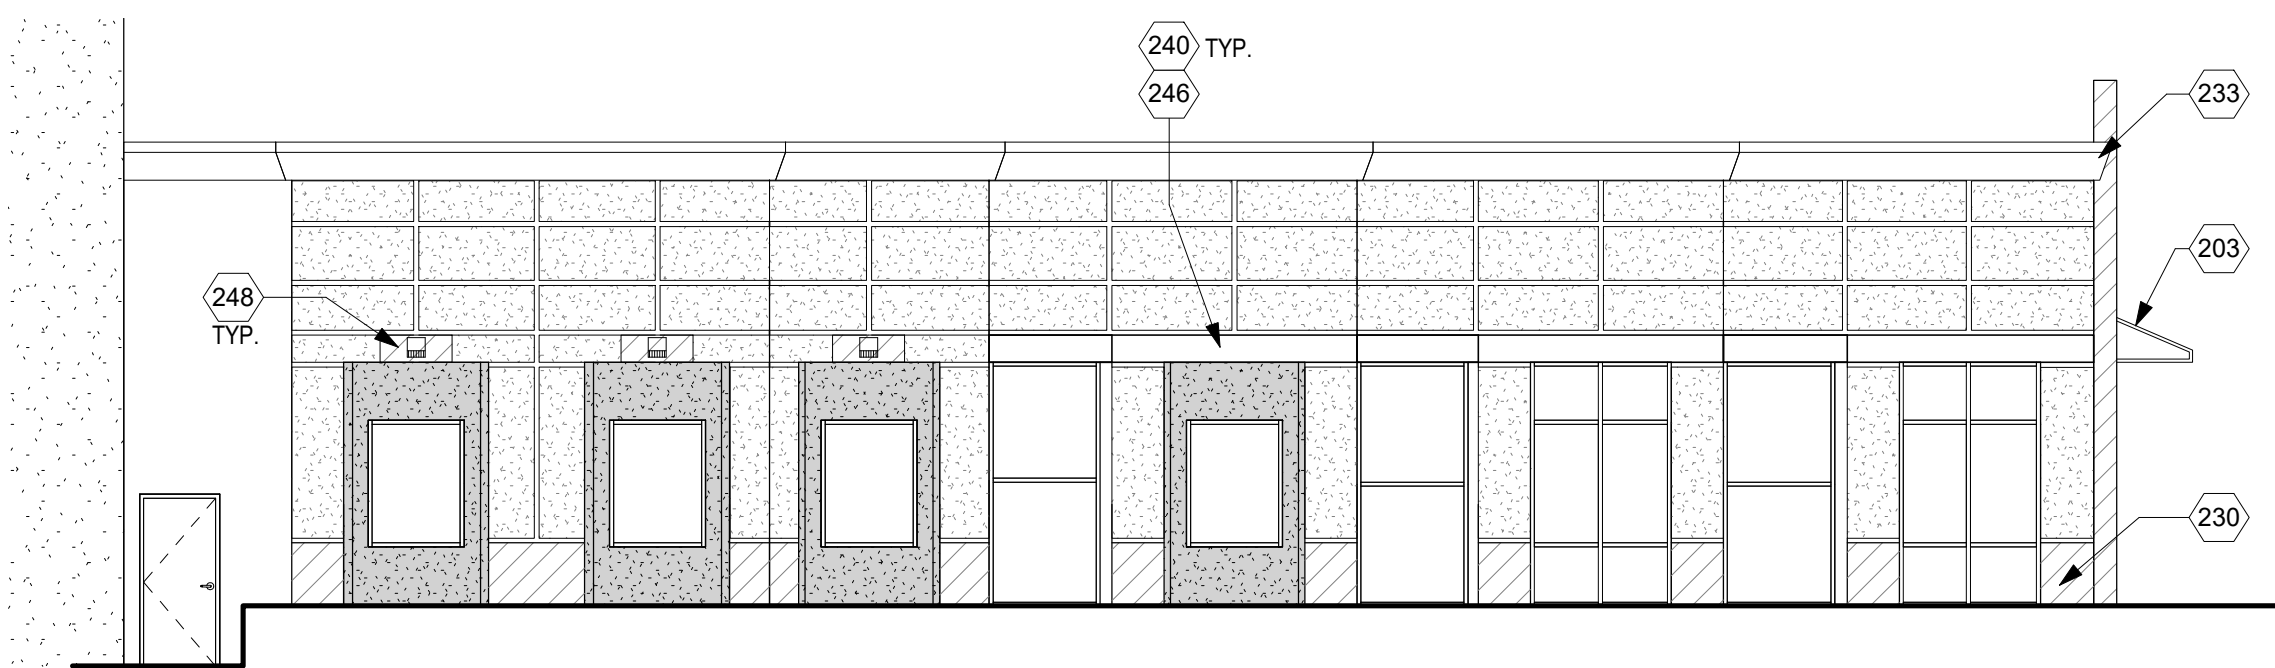

C2 RENOVATION ELEVATION RETAIL 'B' SOUTH
1/8" = 1'-0"

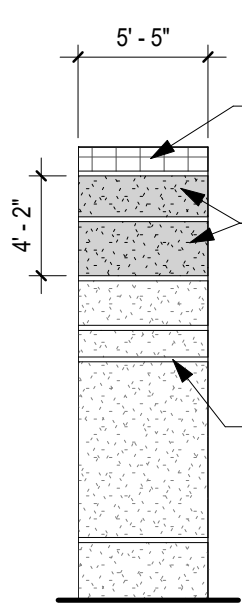


DEMOLITION

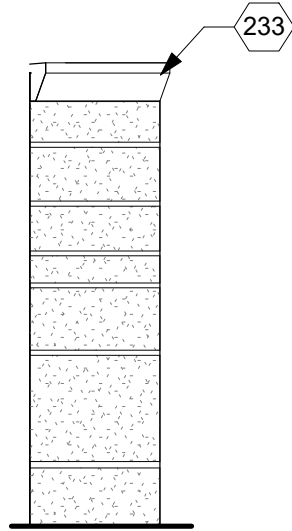

RENOVATION

B3 ELEVATION RETAIL 'B' WEST
1/8" = 1'-0"

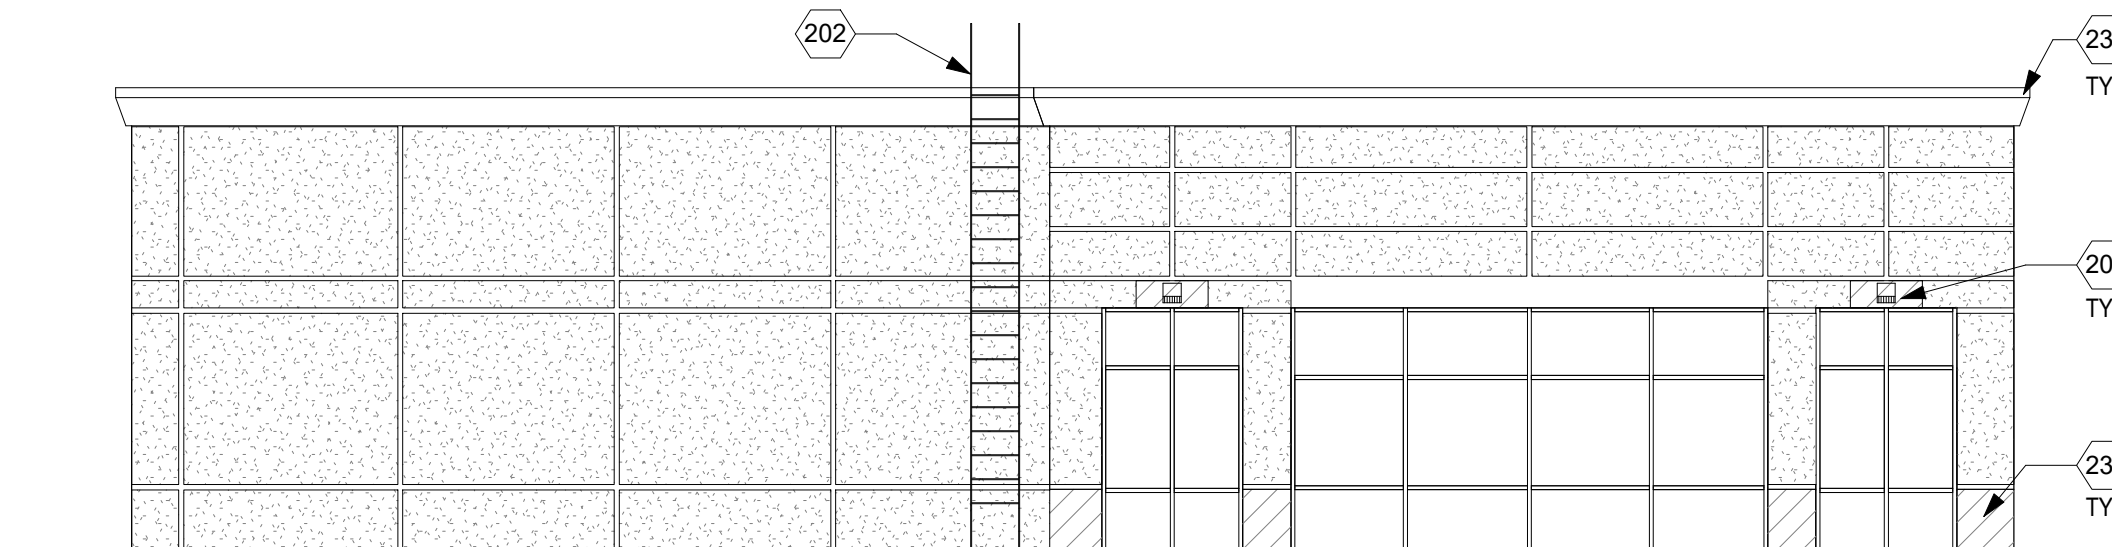

A4 RENOVATION ELEVATION RETAIL 'A' EAST
1/8" = 1'-0"

KEYNOTES

| | |
|-----|---|
| 201 | ALUMINUM STOREFRONT ASSEMBLY TO REMAIN. |
| 202 | EXISTING LADDER OVER PARAPET. |
| 203 | NEW AWNING. SEE STRUCTURAL AND WALL SECTIONS. |
| 205 | EXISTING FIXTURE REMOUNTED OVER NEW EXTERIOR TILE FINISH. TILE MANUFACTURER: DALTILE. SERIES: ELEMENTAL SELECTION. COLOR: MOONSTONE CM11 MATTE. |
| 208 | REMOVE EXISTING PAINTED STUCCO FINISH DOWN TO EXISTING CONCRETE SURFACE. |
| 213 | BUILDING SIGNAGE. REMOVE AND PROTECT DURING CONSTRUCTION. REMOUNT TO FACE OF CONCRETE. |
| 215 | EXISTING STUCCO TO REMAIN. |
| 219 | EXISTING CONCRETE REVEAL. |
| 228 | REMOVE EXISTING EXTERIOR TILE AND METAL COPING. |
| 230 | NEW EXTERIOR TILE FINISH AND CAP. SEE DETAILS A2 & A3/A5-311. TILE MANUFACTURER: DALTILE. SERIES: ELEMENTAL SELECTION. COLOR: MOONSTONE CM11 MATTE. |
| 232 | REMOVE EXISTING SLATE TILE BEHIND LIGHT FIXTURE. LIGHT FIXTURE TO BE REINSTALLED. |
| 233 | NEW FOAM CAP WITH SYNTHETIC PASTER FINISH. SEE DETAIL B1AS-311. |
| 237 | EXISTING CANOPY TO BE REMOVED. |
| 240 | EXISTING CANOPY TO REMAIN. NEW PAINT FINISH, COLOR TO BE SELECTED BY ARCHITECT. |
| 241 | REMOVE EXISTING SLATE TILE WAINSCOT SYSTEM AND STUCCO CAP. |
| 246 | EXISTING LIGHTING IN CANOPY TO REMAIN BUT DE-ENERGIZE THE CIRCUIT TO KEEP LIGHTS OFF. |
| 247 | REMOVE EXISTING SLATE TILE AND LIGHT FIXTURE. NEW LIGHT FIXTURE TO BE INSTALLED IN SAME LOCATION REFER TO LIGHTING. |
| 248 | NEW LIGHT FIXTURE REFER TO LIGHTING. |

CONSULTANTS

LIGHTING

AE Design

1900 Wazee St #205
Denver, CO 80202

LANDSCAPING

Groundwork Studio

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p_505.881.3008

CIVIL

NVS

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Albuquerque, NM 87110
p_505.510.0850

INTERIORS

Maximalist Experience Design

Denver, CO
p_720.732.5838

ELECTRICAL


AC Engineering Enterprises, LLC

141 E Palace Ave
Santa Fe, NM 87501
p_505.842.5787

STRUCTURAL

Quiroga-Pfeiffer Engineering Corp.

4343 Pan American Freeway NE Suite #228
Albuquerque, NM 87107
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PARK SQUARE PLAZA
EXTERIOR IMPROVEMENTS

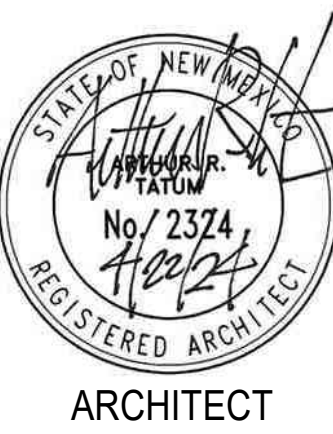100% BID SET

6565 AMERICAS PKWY
ALBUQUERQUE, NM 87110

APRIL 2024

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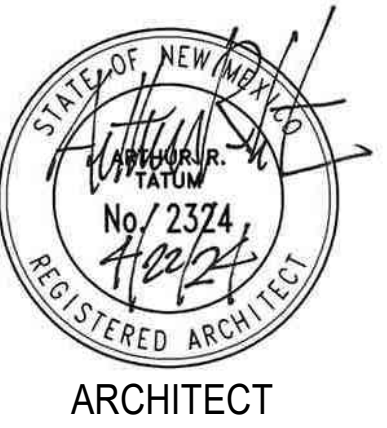
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| PROJECT NO: | Project Number |
| DRAWN BY: | MSP |
| CHECKED BY: | AV |

SHEET TITLE

BUILDING ELEVATIONS

KEYNOTES

| | |
|-----|---|
| 201 | ALUMINUM STOREFRONT ASSEMBLY TO REMAIN. |
| 202 | NEW ANVING. SEE STRUCTURAL AND WALL SECTIONS. |
| 203 | EXISTING FUTURE REMOUNTED OVER NEW EXTERIOR TILE FINISH. TILE MANUFACTURER: DALTE. SERIES: ELEMENTAL SELECTION. COLOR: MOONSTONE CM11 MATTE. |
| 208 | REMOVE EXISTING PATTERNED STUCCO FINISH DOWN TO EXISTING CONCRETE SURFACE. |
| 213 | REMOVE LIGHT GUARDS. REMOVE AND PROTECT DURING CONSTRUCTION. REMOUNT TO FACE OF CEILING. |
| 215 | EXISTING STUCCO TO REMAIN. |
| 216 | NEW METAL FRAMED BUILT UP WITH A TILE FINISH SYSTEM. TILE MANUFACTURER: DALTE. SERIES: ELEMENTAL SELECTION. COLOR: MOONSTONE CM11 MATTE. |
| 218 | NEW STUCCO FINISH OVER EXISTING CONCRETE. |
| 219 | EXISTING CONCRETE TO REMAIN. |
| 220 | REMOVE EXISTING EXTERIOR TILE AND METAL COPING. |
| 221 | NEW EXTERIOR TILE FINISH AND CAP. SEE DETAILS & A348-311. TILE MANUFACTURER: DALTE. SERIES: ELEMENTAL SELECTION. COLOR: MOONSTONE CM11 MATTE. |
| 232 | REMOVE EXISTING SLATE TILE BEHIND LIGHT FIXTURE. LIGHT FIXTURE TO BE REINSTALLED. |
| 233 | NEW PASTER CAP WITH SYNTHETIC PASTER FINISH. SEE DETAIL B14S-311. |
| 234 | EXISTING STEEL. CONCRETE FILLED BOLLARD. |
| 237 | EXISTING CANOPY TO BE REMOVED. |
| 240 | EXISTING CANOPY TO REMAIN. NEW PAINT FINISH. COLOR TO BE SELECTED BY ARCHITECT. |
| 241 | REMOVE EXISTING SLATE TILE. WATSCOT SYSTEM AND STUCCO CAP. |
| 246 | EXISTING LIGHT IN CANOPY TO REMAIN BUT DE-ENERGIZE THE CIRCUIT TO KEEP LIGHTS OFF. |



PARK SQUARE PLAZA

EXTERIOR IMPROVEMENTS

100% BID SET

5565 AMERICAS PKWY
ALBUQUERQUE, NM 87110

APRIL 2024

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SHEET TITLE

BUILDING ELEVATIONS

AS-203

CONSULTANTS

LIGHTING

AE Design
1900 Wazee St #205
Denver, CO 80202

LANDSCAPING

Groundwork Studio
6501 Americas Pkwy
Albuquerque, NM 87110
p_505.881.3008

CIVIL

NVS
6501 Americas Pkwy
Albuquerque, NM 87110
p_505.510.0850

INTERIORS


Maximalist Experience Design
Denver, CO
p_720.732.5838

ELECTRICAL

AC Engineering Enterprises, LLC
141 E Palace Ave
Santa Fe, NM 87501
p_505.842.5787

STRUCTURAL

Quiroga-Pfeiffer Engineering Corp.
4343 Pan American Freeway NE Suite #228
Albuquerque, NM 87107
p_505.858.1456

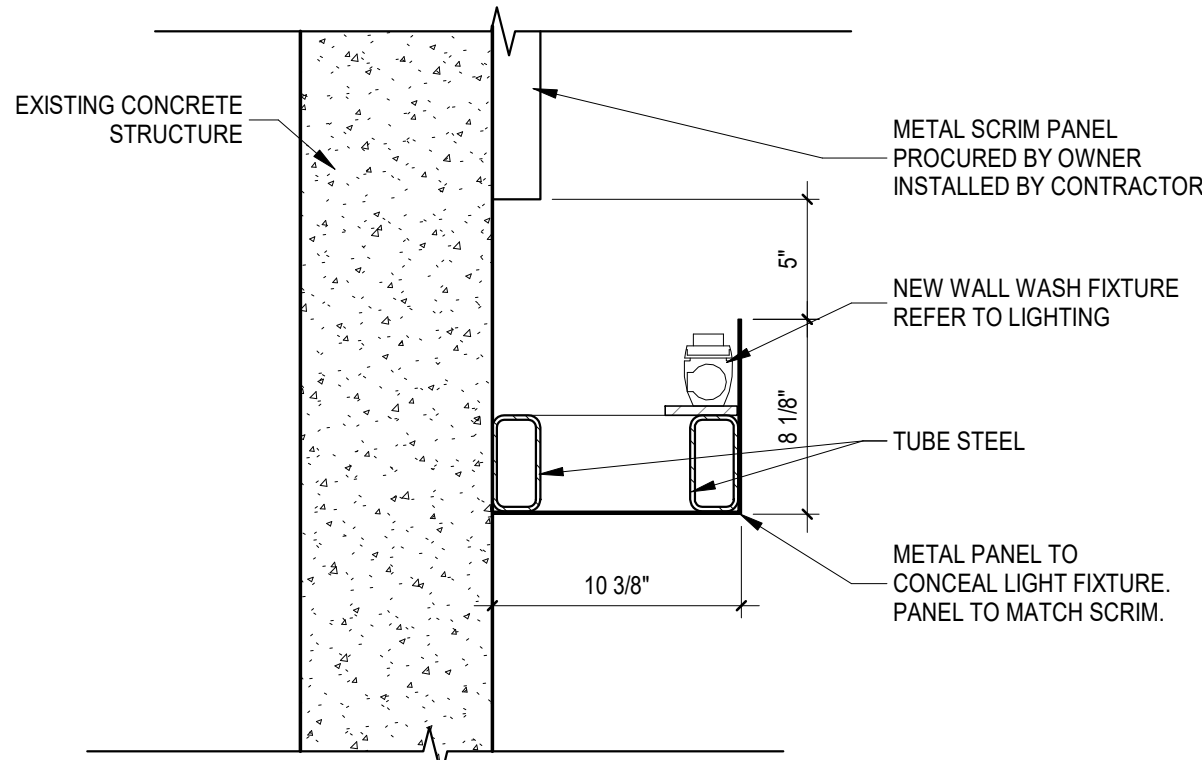

D4 TYP. LIGHT LEDGE
1 1/2" = 1'-0"


METAL SCREEN SYSTEM BY OWNER, TYP.

LIGHT LEDGE REFER TO
DETAIL D4/AS-204

ALIGN EDGE OF LIGHT LEDGE
WITH EDGE OF PANEL

SIGNAGE BY
OTHERS, TYP.

C1 EAST ELEVATION - TWO PARK SQUARE PARKING STRUCTURE
1/8" = 1'-0"

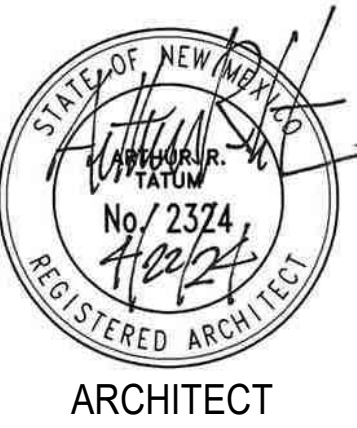

PARK SQUARE PLAZA
EXTERIOR IMPROVEMENTS

100% BID SET

6565 AMERICAS PKWY
ALBUQUERQUE, NM 87110

APRIL 2024

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SHEET TITLE

BUILDING ELEVATIONS

AS-204

A1 SOUTH ELEVATION - TWO PARK SQUARE PARKING STRUCTURE
1/8" = 1'-0"

CONSULTANTS

LIGHTING

AE Design
1900 Wazee St #205
Denver, CO 80202

LANDSCAPING

Groundwork Studio
6501 Americas Pkwy
Albuquerque, NM 87110
p_505.881.3008

CIVIL

NVS
6501 Americas Pkwy
Albuquerque, NM 87110
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INTERIORS


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Denver, CO
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ELECTRICAL

AC Engineering Enterprises, LLC
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STRUCTURAL

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4343 Pan American Freeway NE Suite #228
Albuquerque, NM 87107
p_505.858.1456



C3 NORTH ELEVATION - ONE PARK SQUARE PARKING STRUCTURE
1/8" = 1'-0"

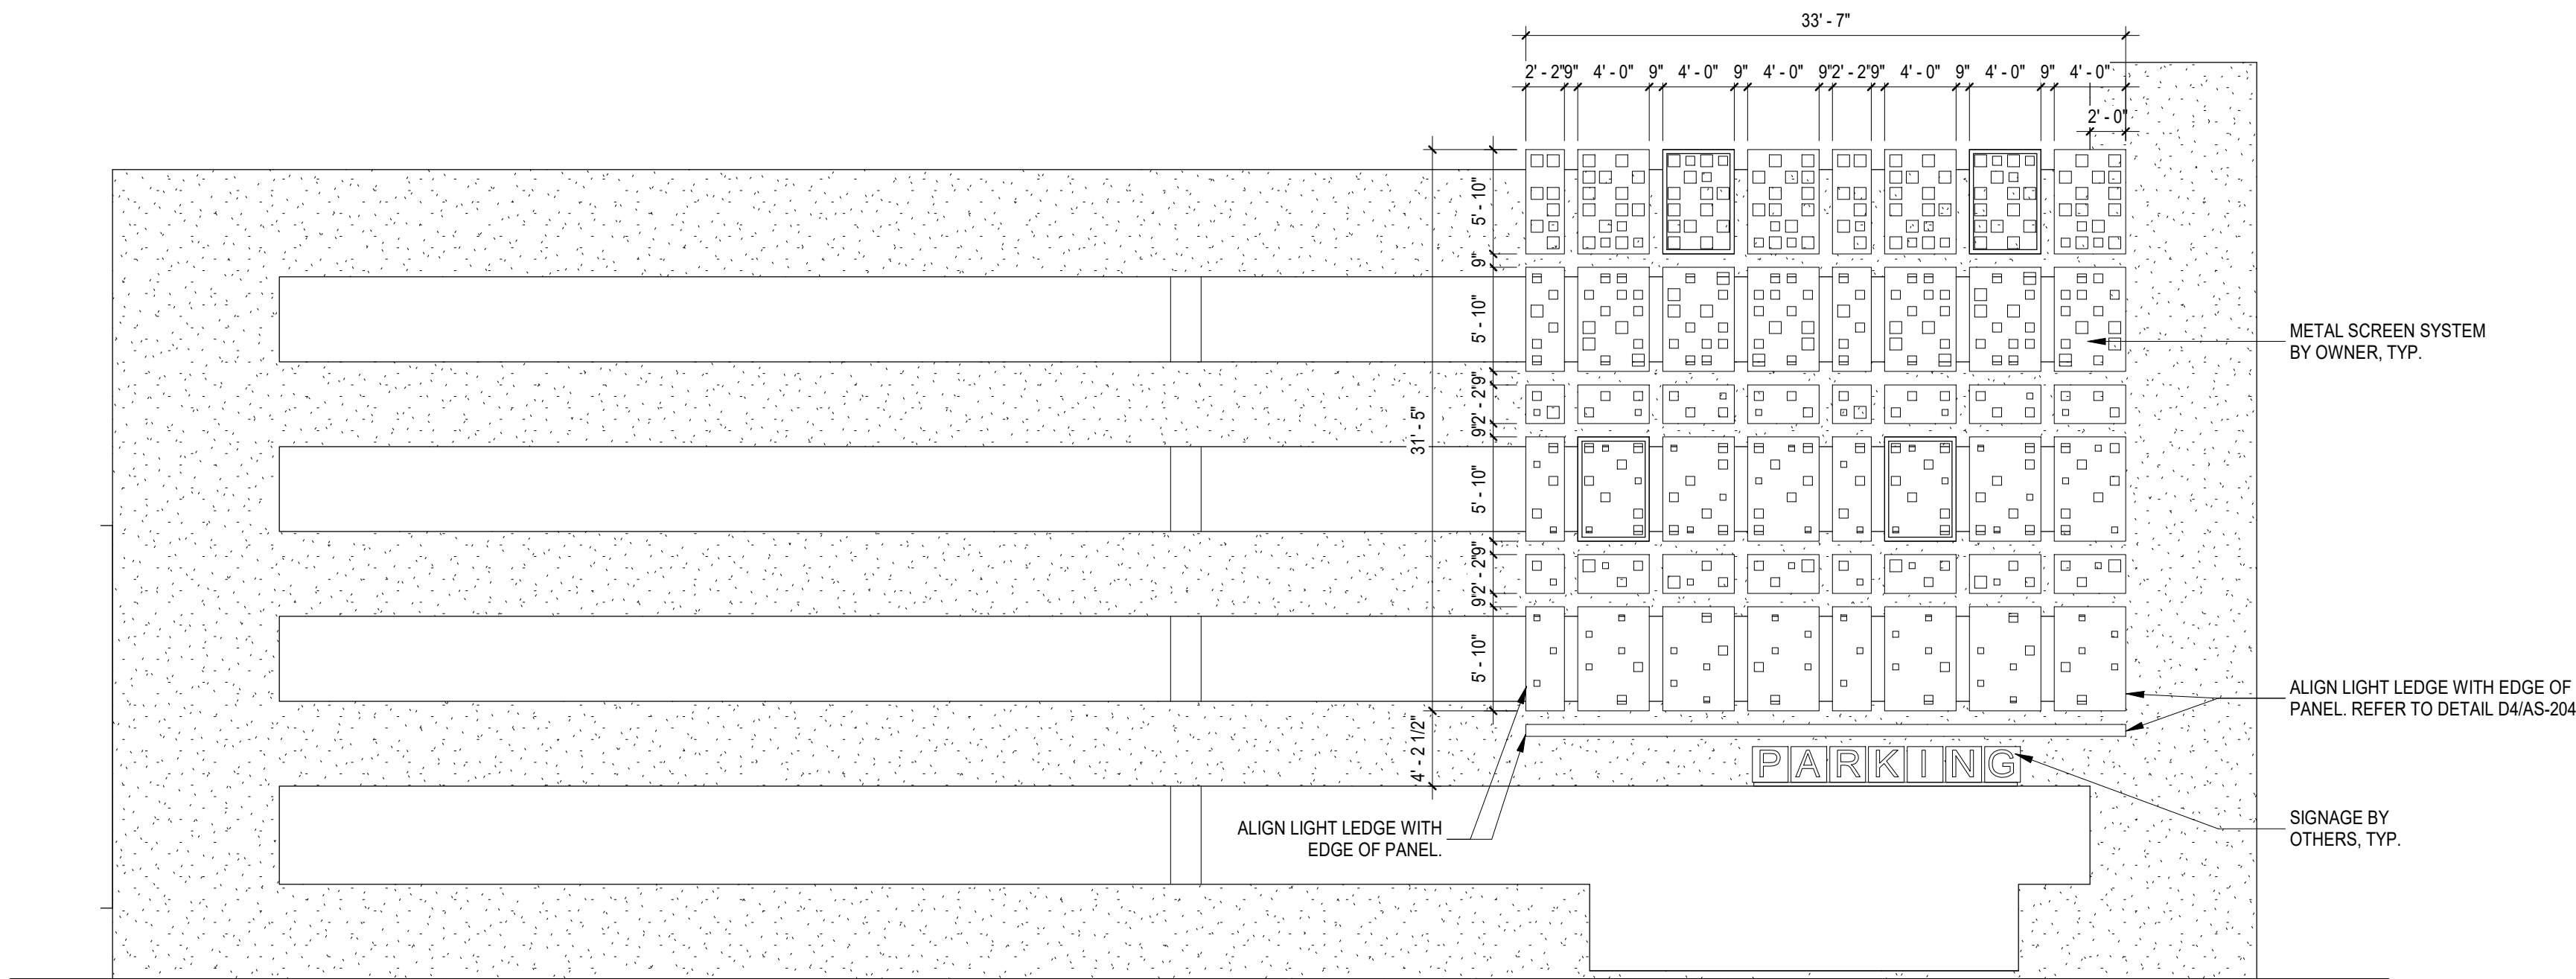

PARK SQUARE PLAZA
EXTERIOR IMPROVEMENTS

100% BID SET

6565 AMERICAS PKWY
ALBUQUERQUE, NM 87110

APRIL 2024

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SHEET TITLE

BUILDING ELEVATIONS

AS-205

A1 WEST ELEVATION - ONE PARK SQUARE PARKING STRUCTURE
1/8" = 1'-0"



CONSULTANTS

LIGHTING

AE Design

1900 Wazee St #205

Denver, CO 80202

LANDSCAPING

Groundwork Studio

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Albuquerque, NM 87110

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CIVIL

NVS

6501 Americas Pkwy

Albuquerque, NM 87110

p. 505.510.0850

INTERIORS

Maximalist Experience Design

Denver, CO

p. 720.732.5838

ELECTRICAL

AC Engineering Enterprises, LLC

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Santa Fe, NM 87501

p. 505.842.5787


STRUCTURAL

Quiroga-Pfeiffer Engineering Corp.

4343 Pan American Freeway NE Suite #228


Albuquerque, NM 87107

p. 505.858.1456

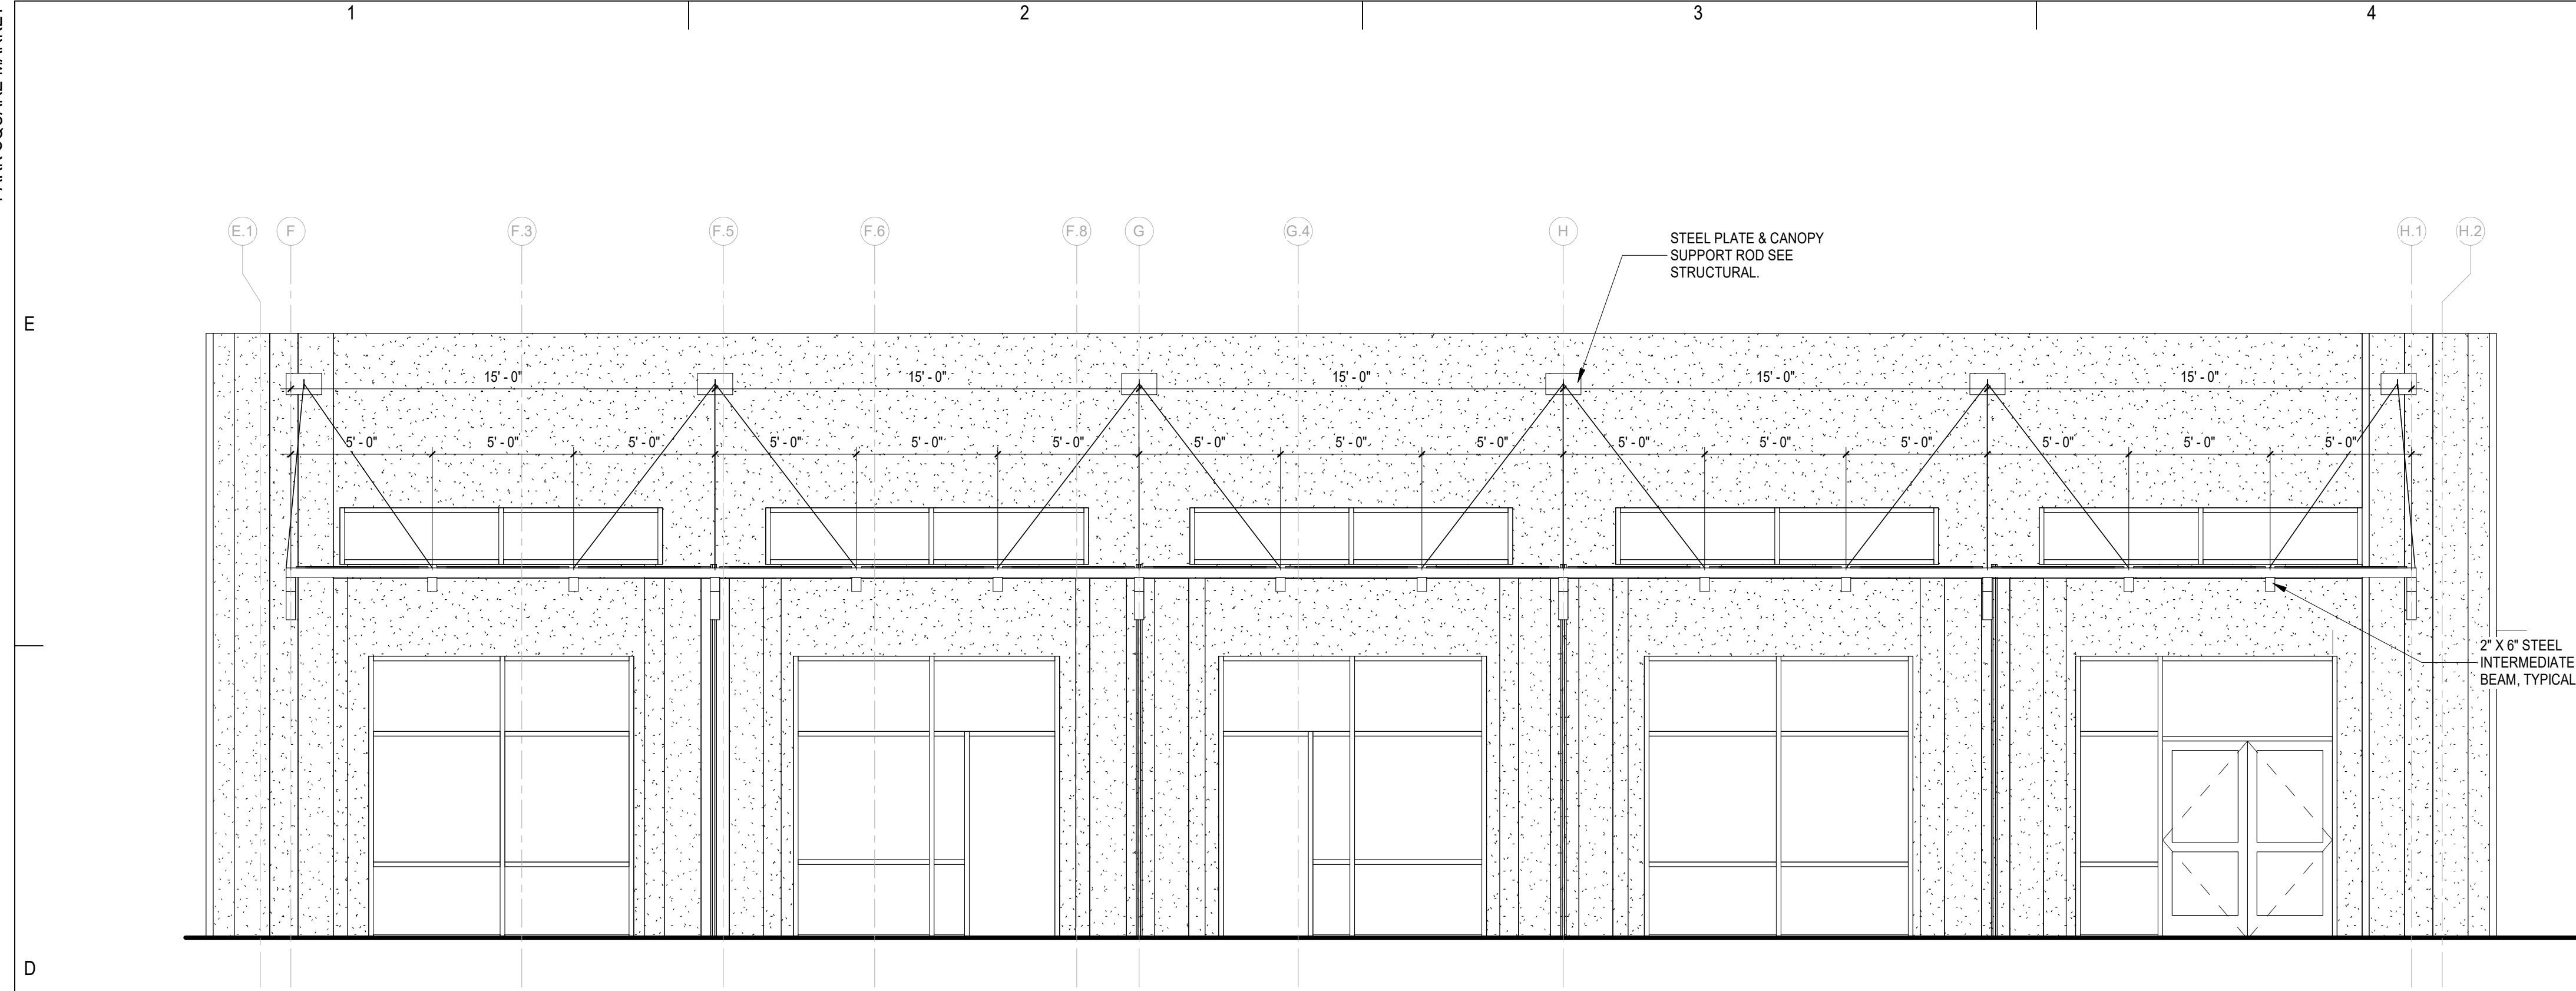


D1 SOUTH ELEVATION - NORTH FOOD HALL

1/4" = 1'-0"

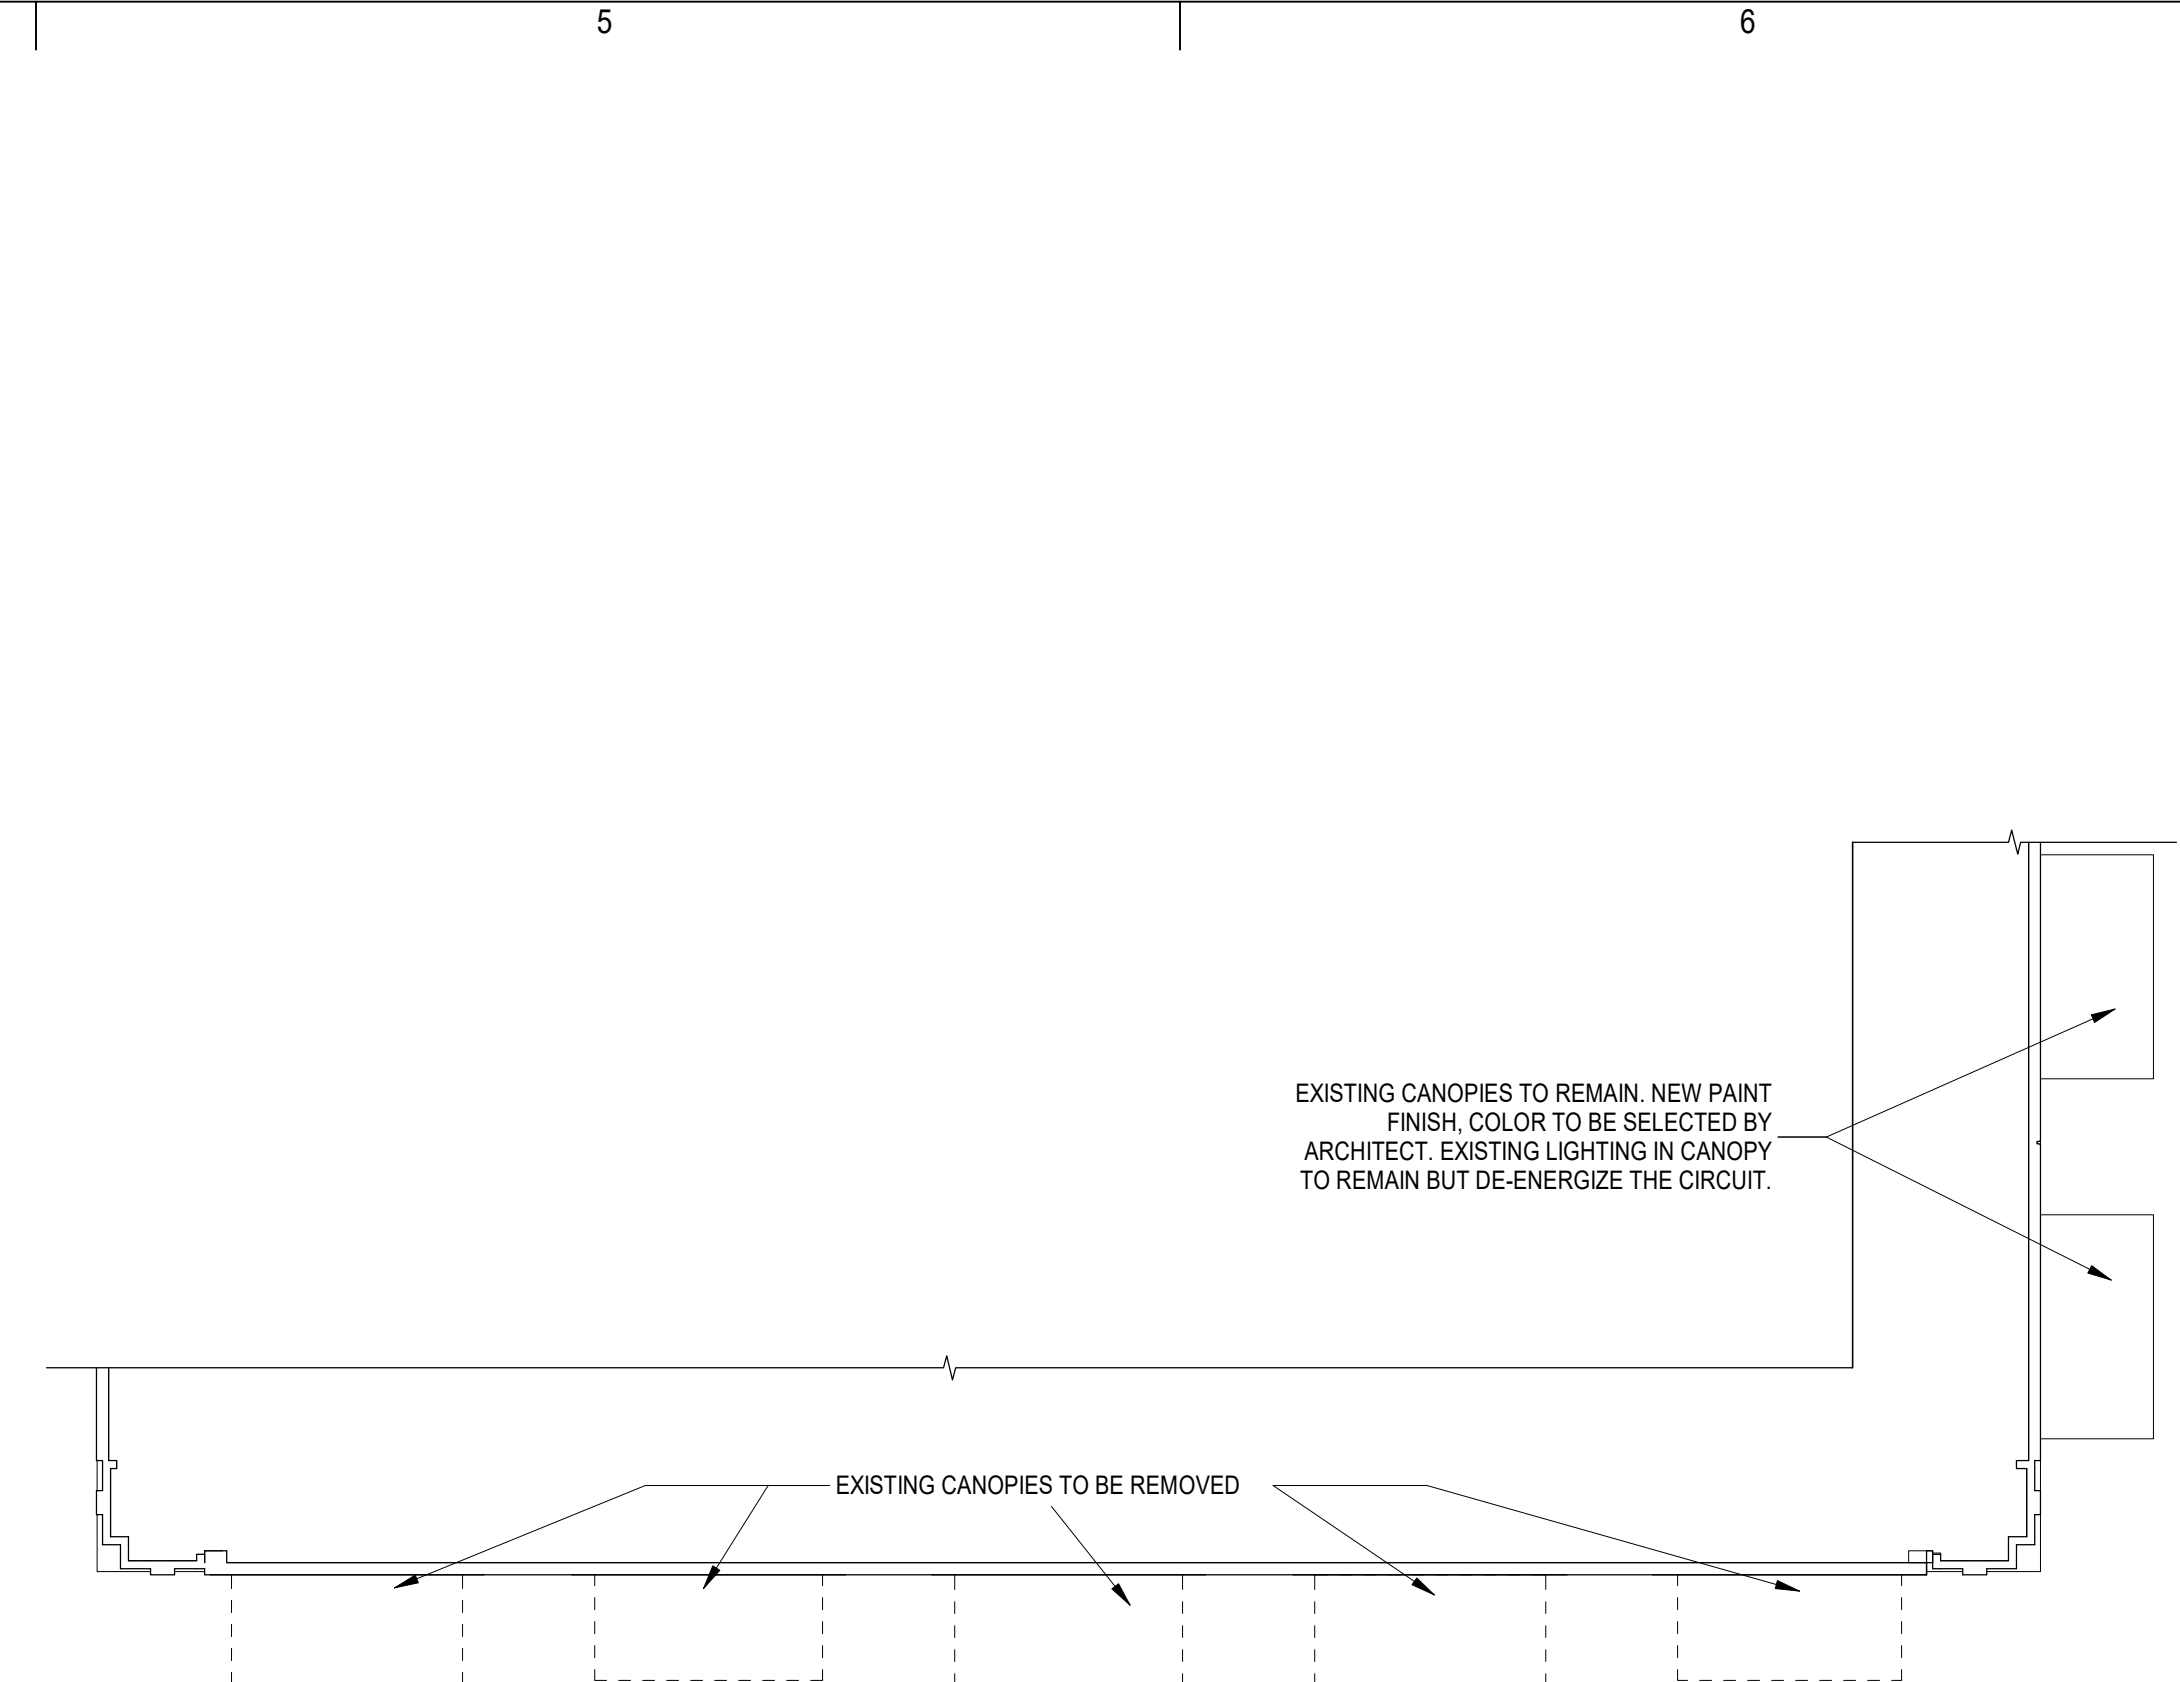


D5 CANOPY DEMOLITION PLAN

1/8" = 1'-0"

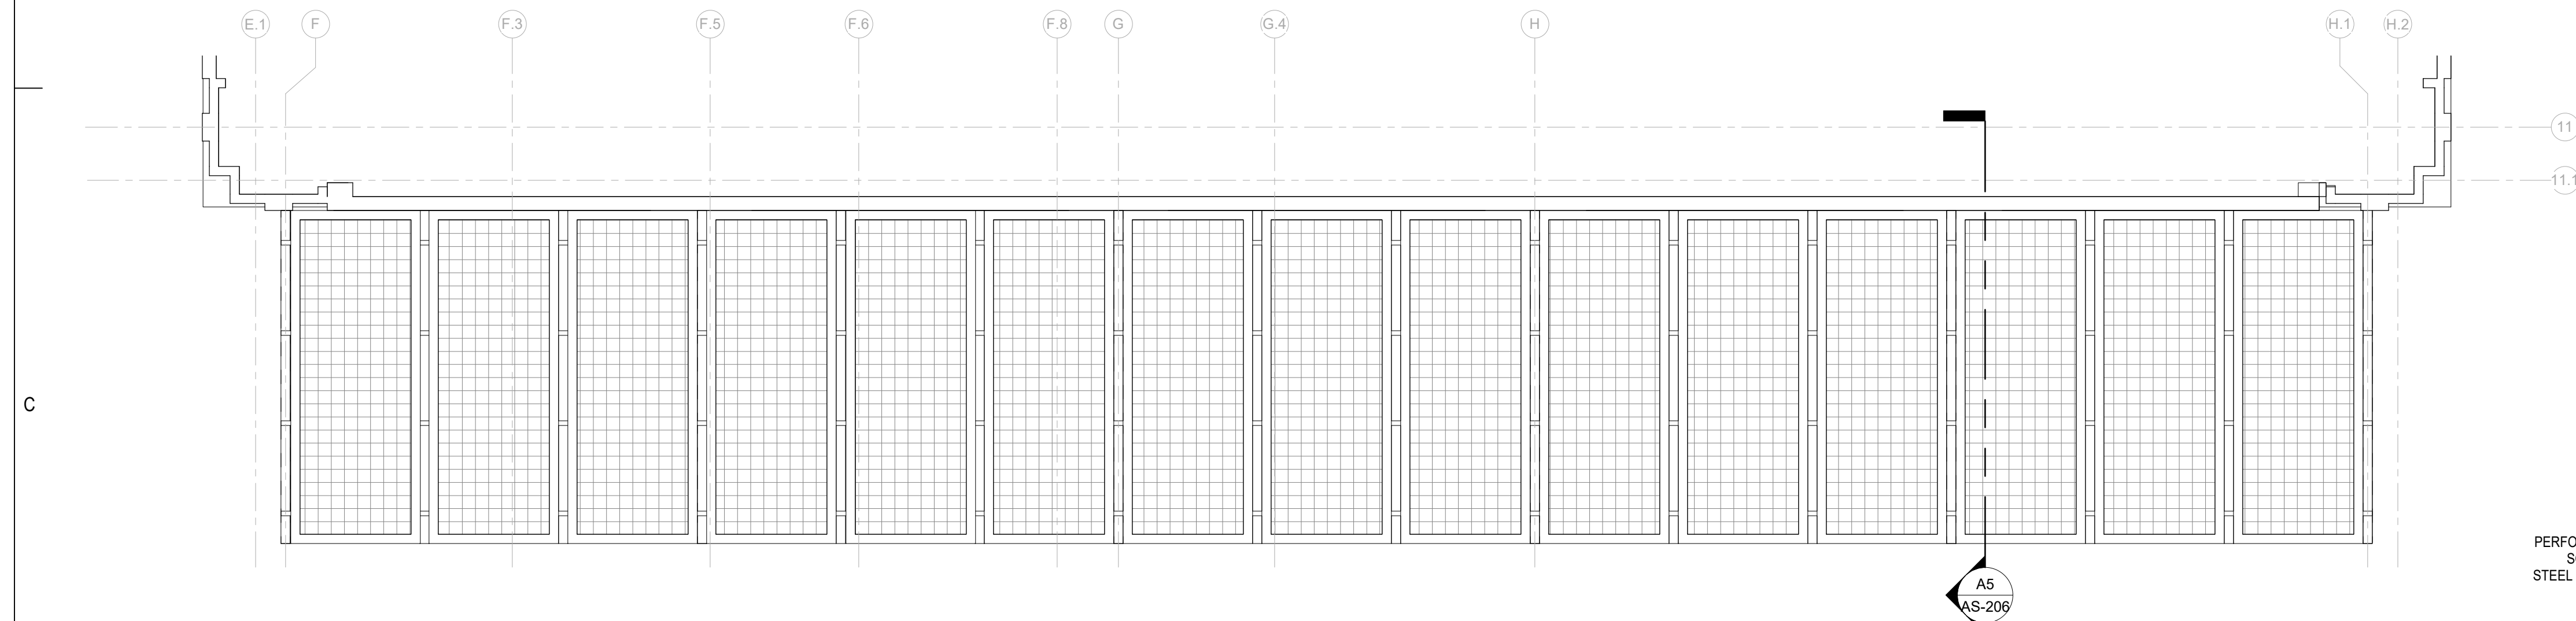


C1 CANOPY RENOVATION PLAN

1/4" = 1'-0"

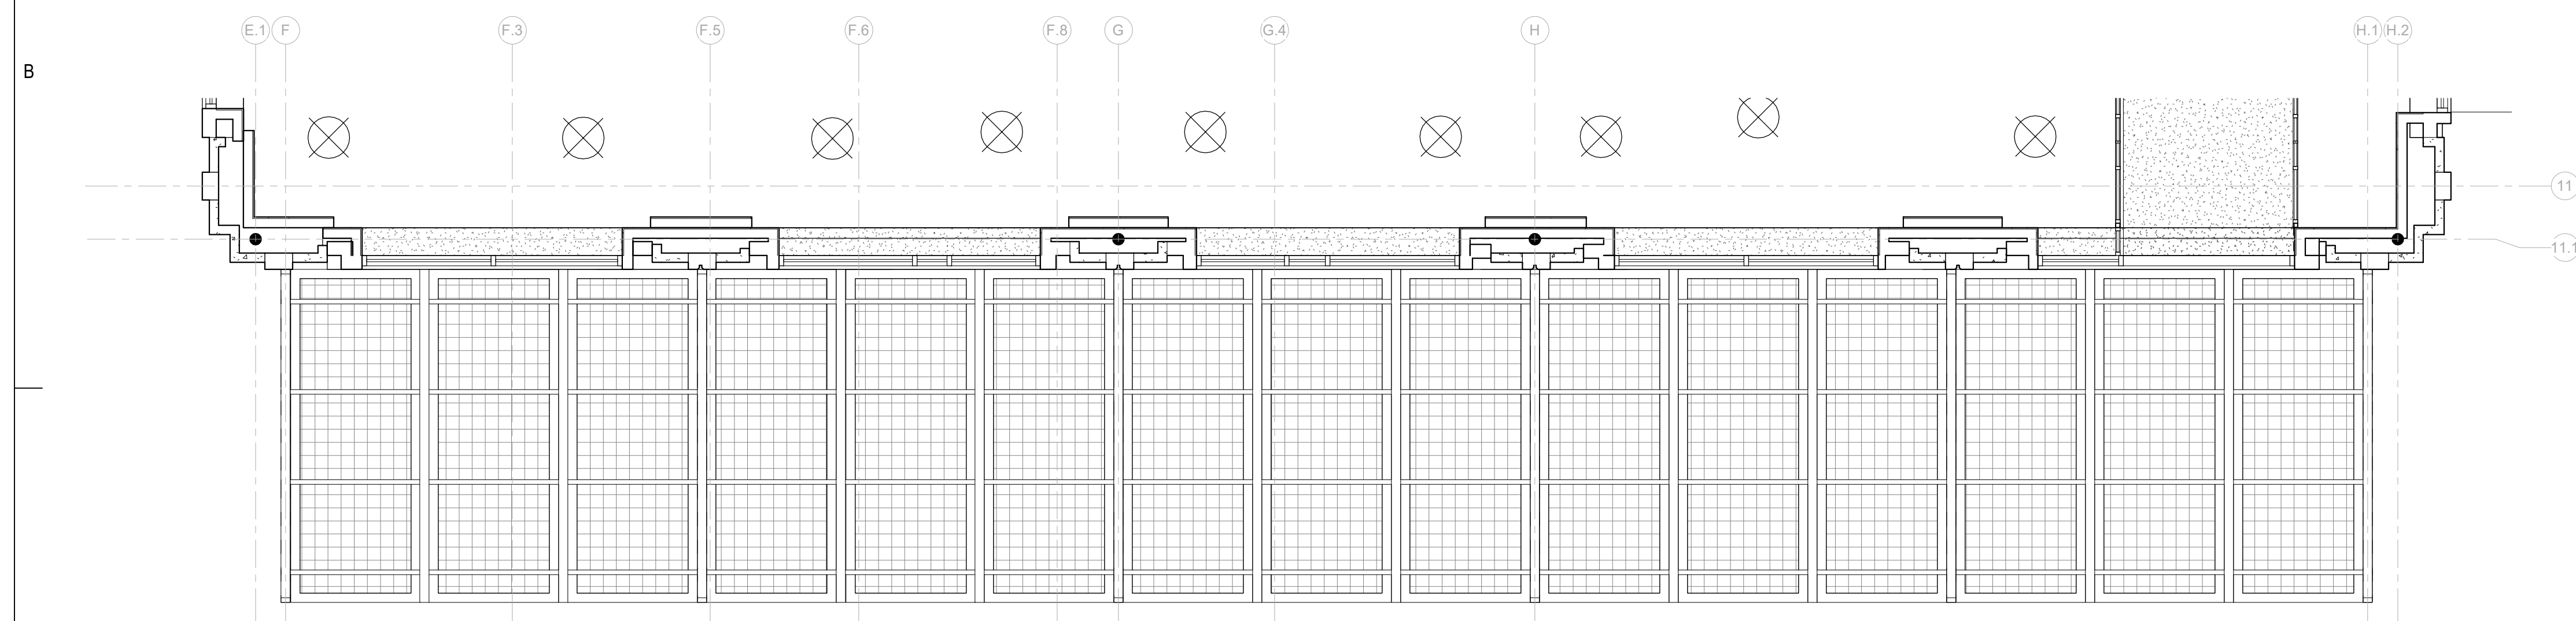

A1 REFLECTED CEILING PLAN - CANOPY

1/4" = 1'-0"

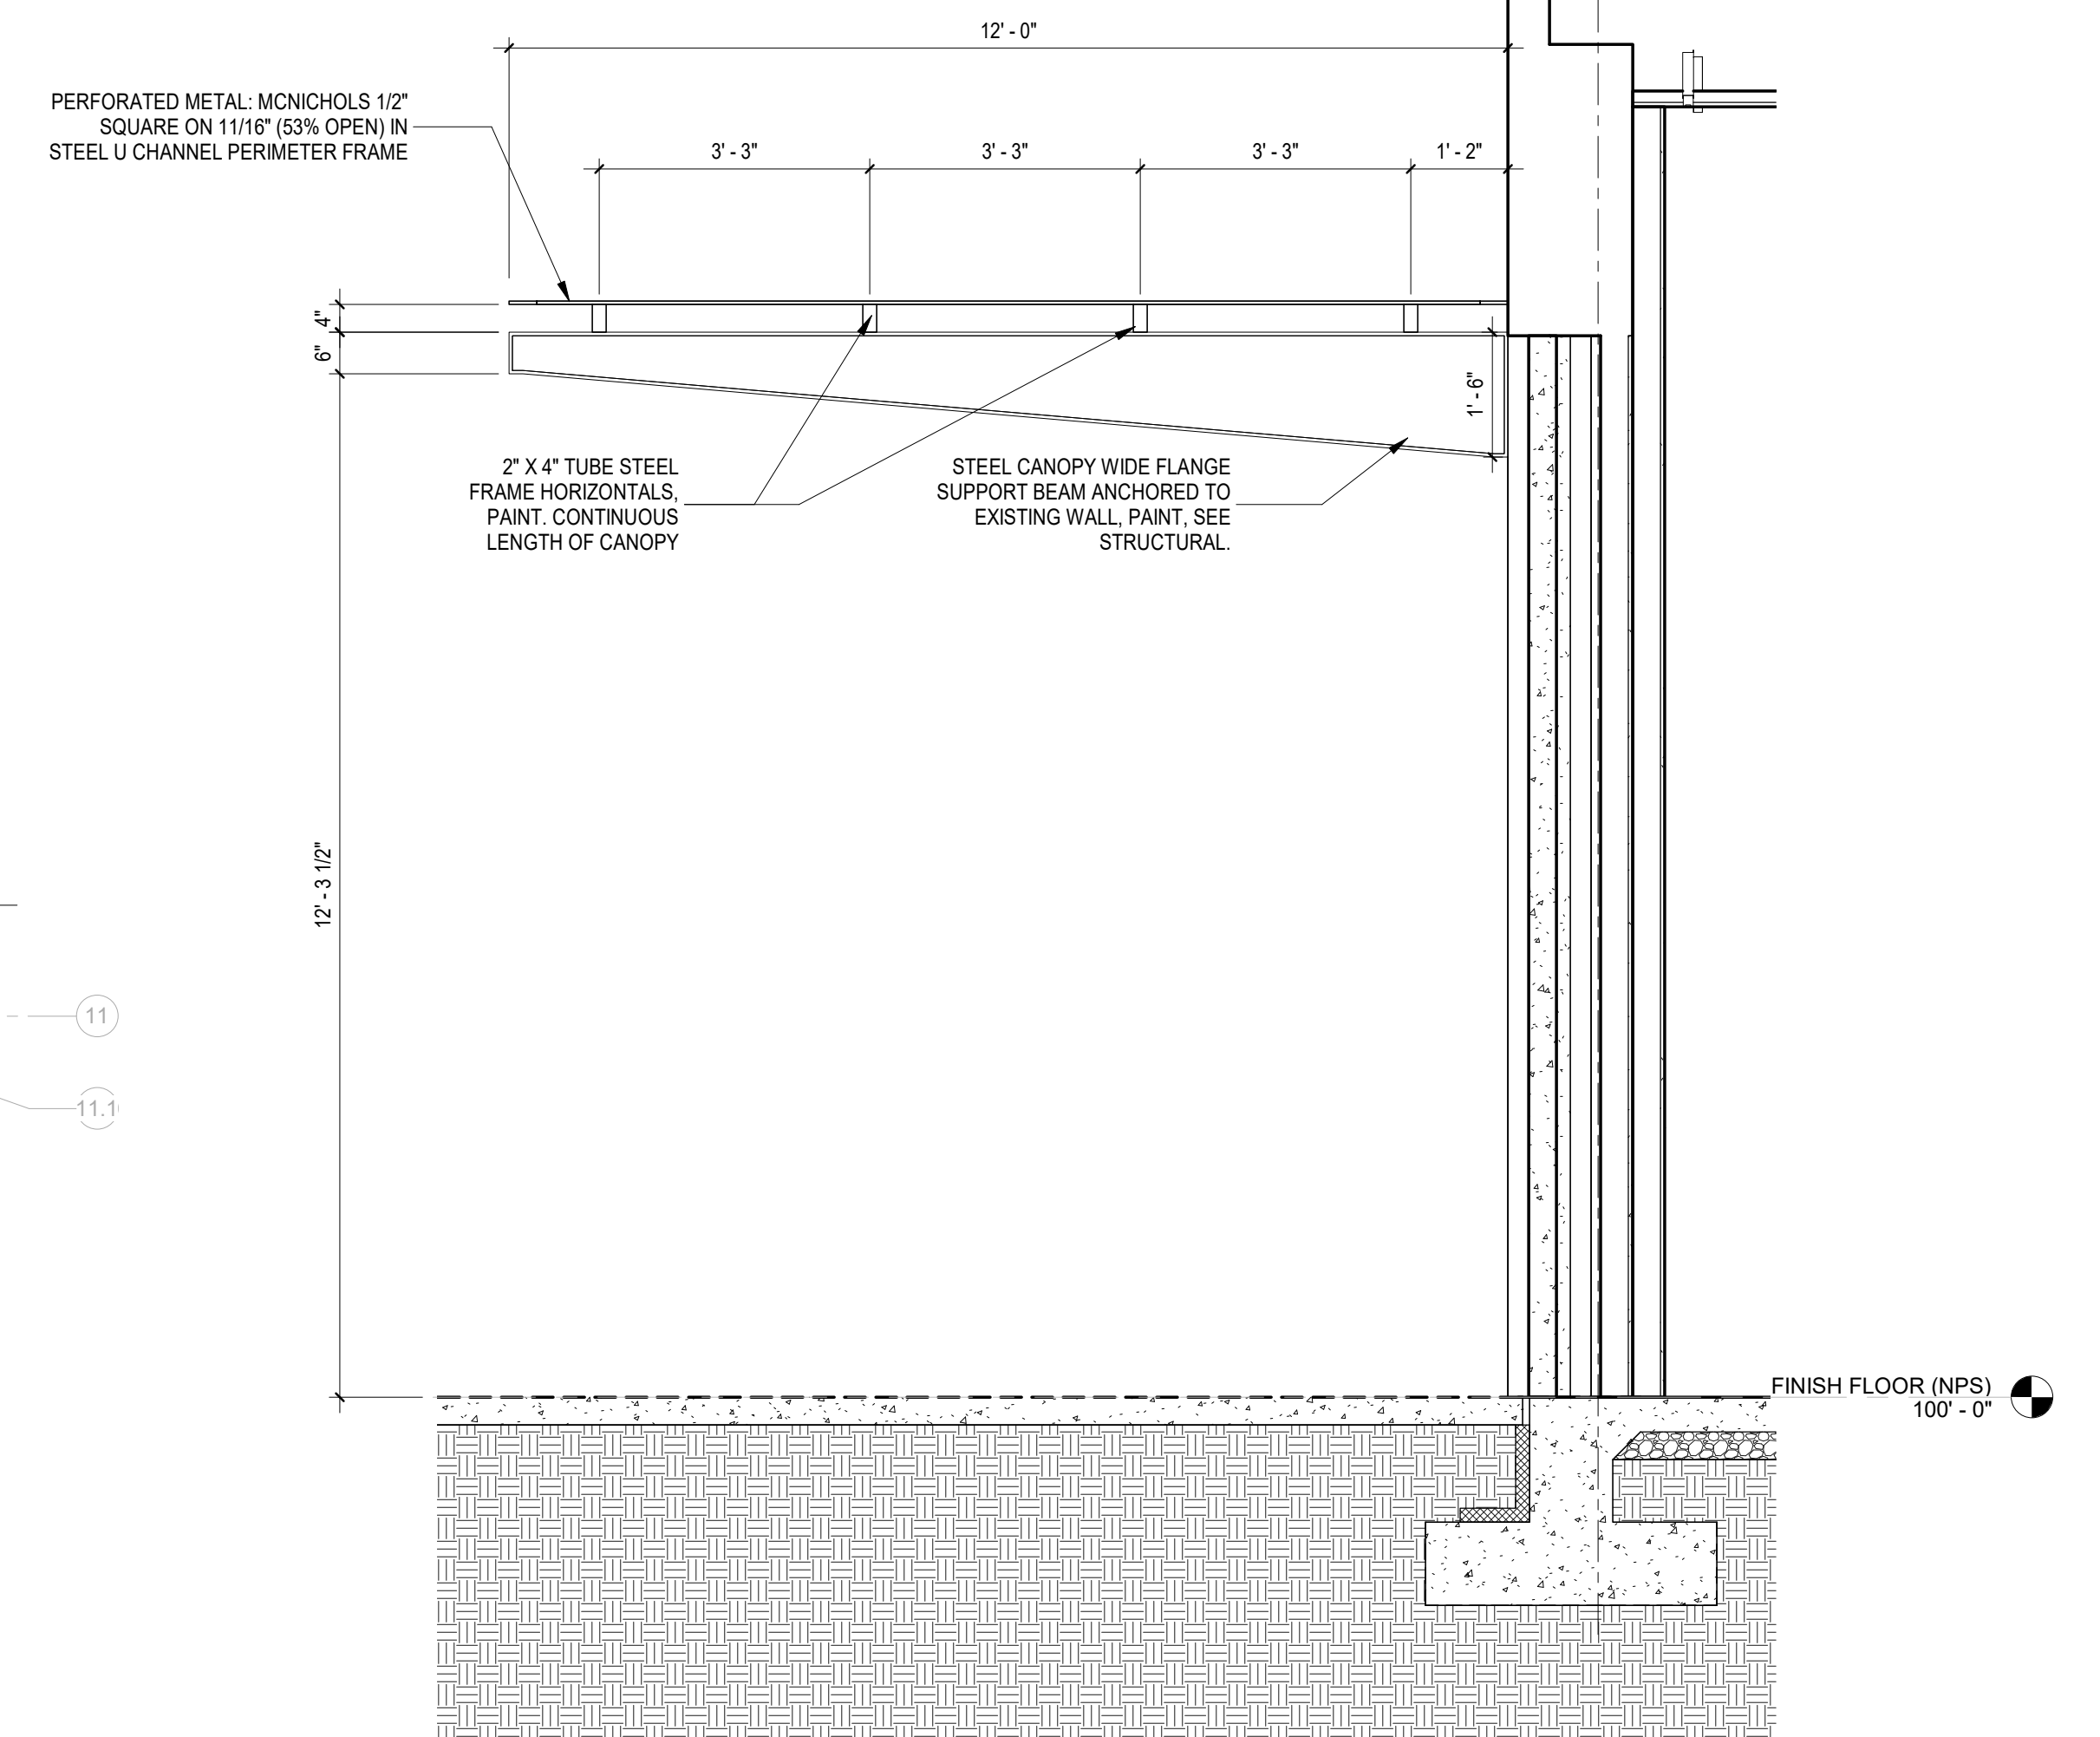

A5 WALL SECTION - CANOPY CONNECTION

1/2" = 1'-0"

PARK SQUARE PLAZA
EXTERIOR IMPROVEMENTS

100% BID SET

6565 AMERICAS PKWY
ALBUQUERQUE, NM 87110

APRIL 2024

MARK DATE DESCRIPTION

ISSUE: CONSTRUCTION DOCUMENTS
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CHECKED BY: AV

SHEET TITLE

BUILDING ELEVATIONS

AS-206

CONSULTANTS

LIGHTING

AE Design
1900 Wazee St #205
Denver, CO 80202

LANDSCAPING

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6501 Americas Pkwy
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CIVIL

NVS
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STRUCTURAL

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4343 Pan American Freeway NE Suite #228
Albuquerque, NM 87107
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PARK SQUARE PLAZA
EXTERIOR IMPROVEMENTS

100% BID SET

6565 AMERICAS PKWY
ALBUQUERQUE, NM 87110


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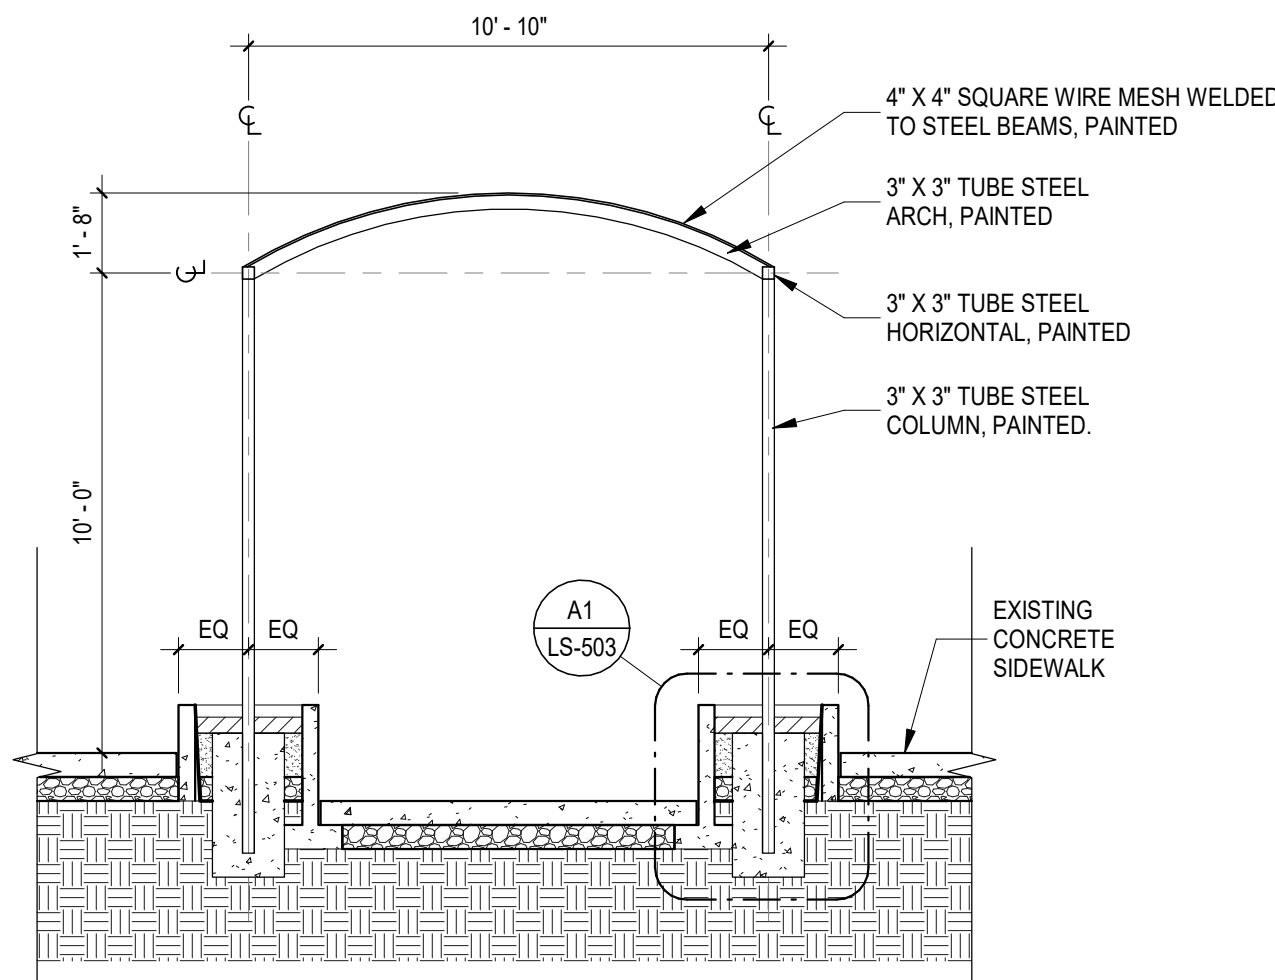
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| CHECKED BY: | AV |

SHEET TITLE
TRELLIS PLANS AND ELEVATIONS


AS-310



A1 TRELLIS PLAN
1/8" = 1'-0"

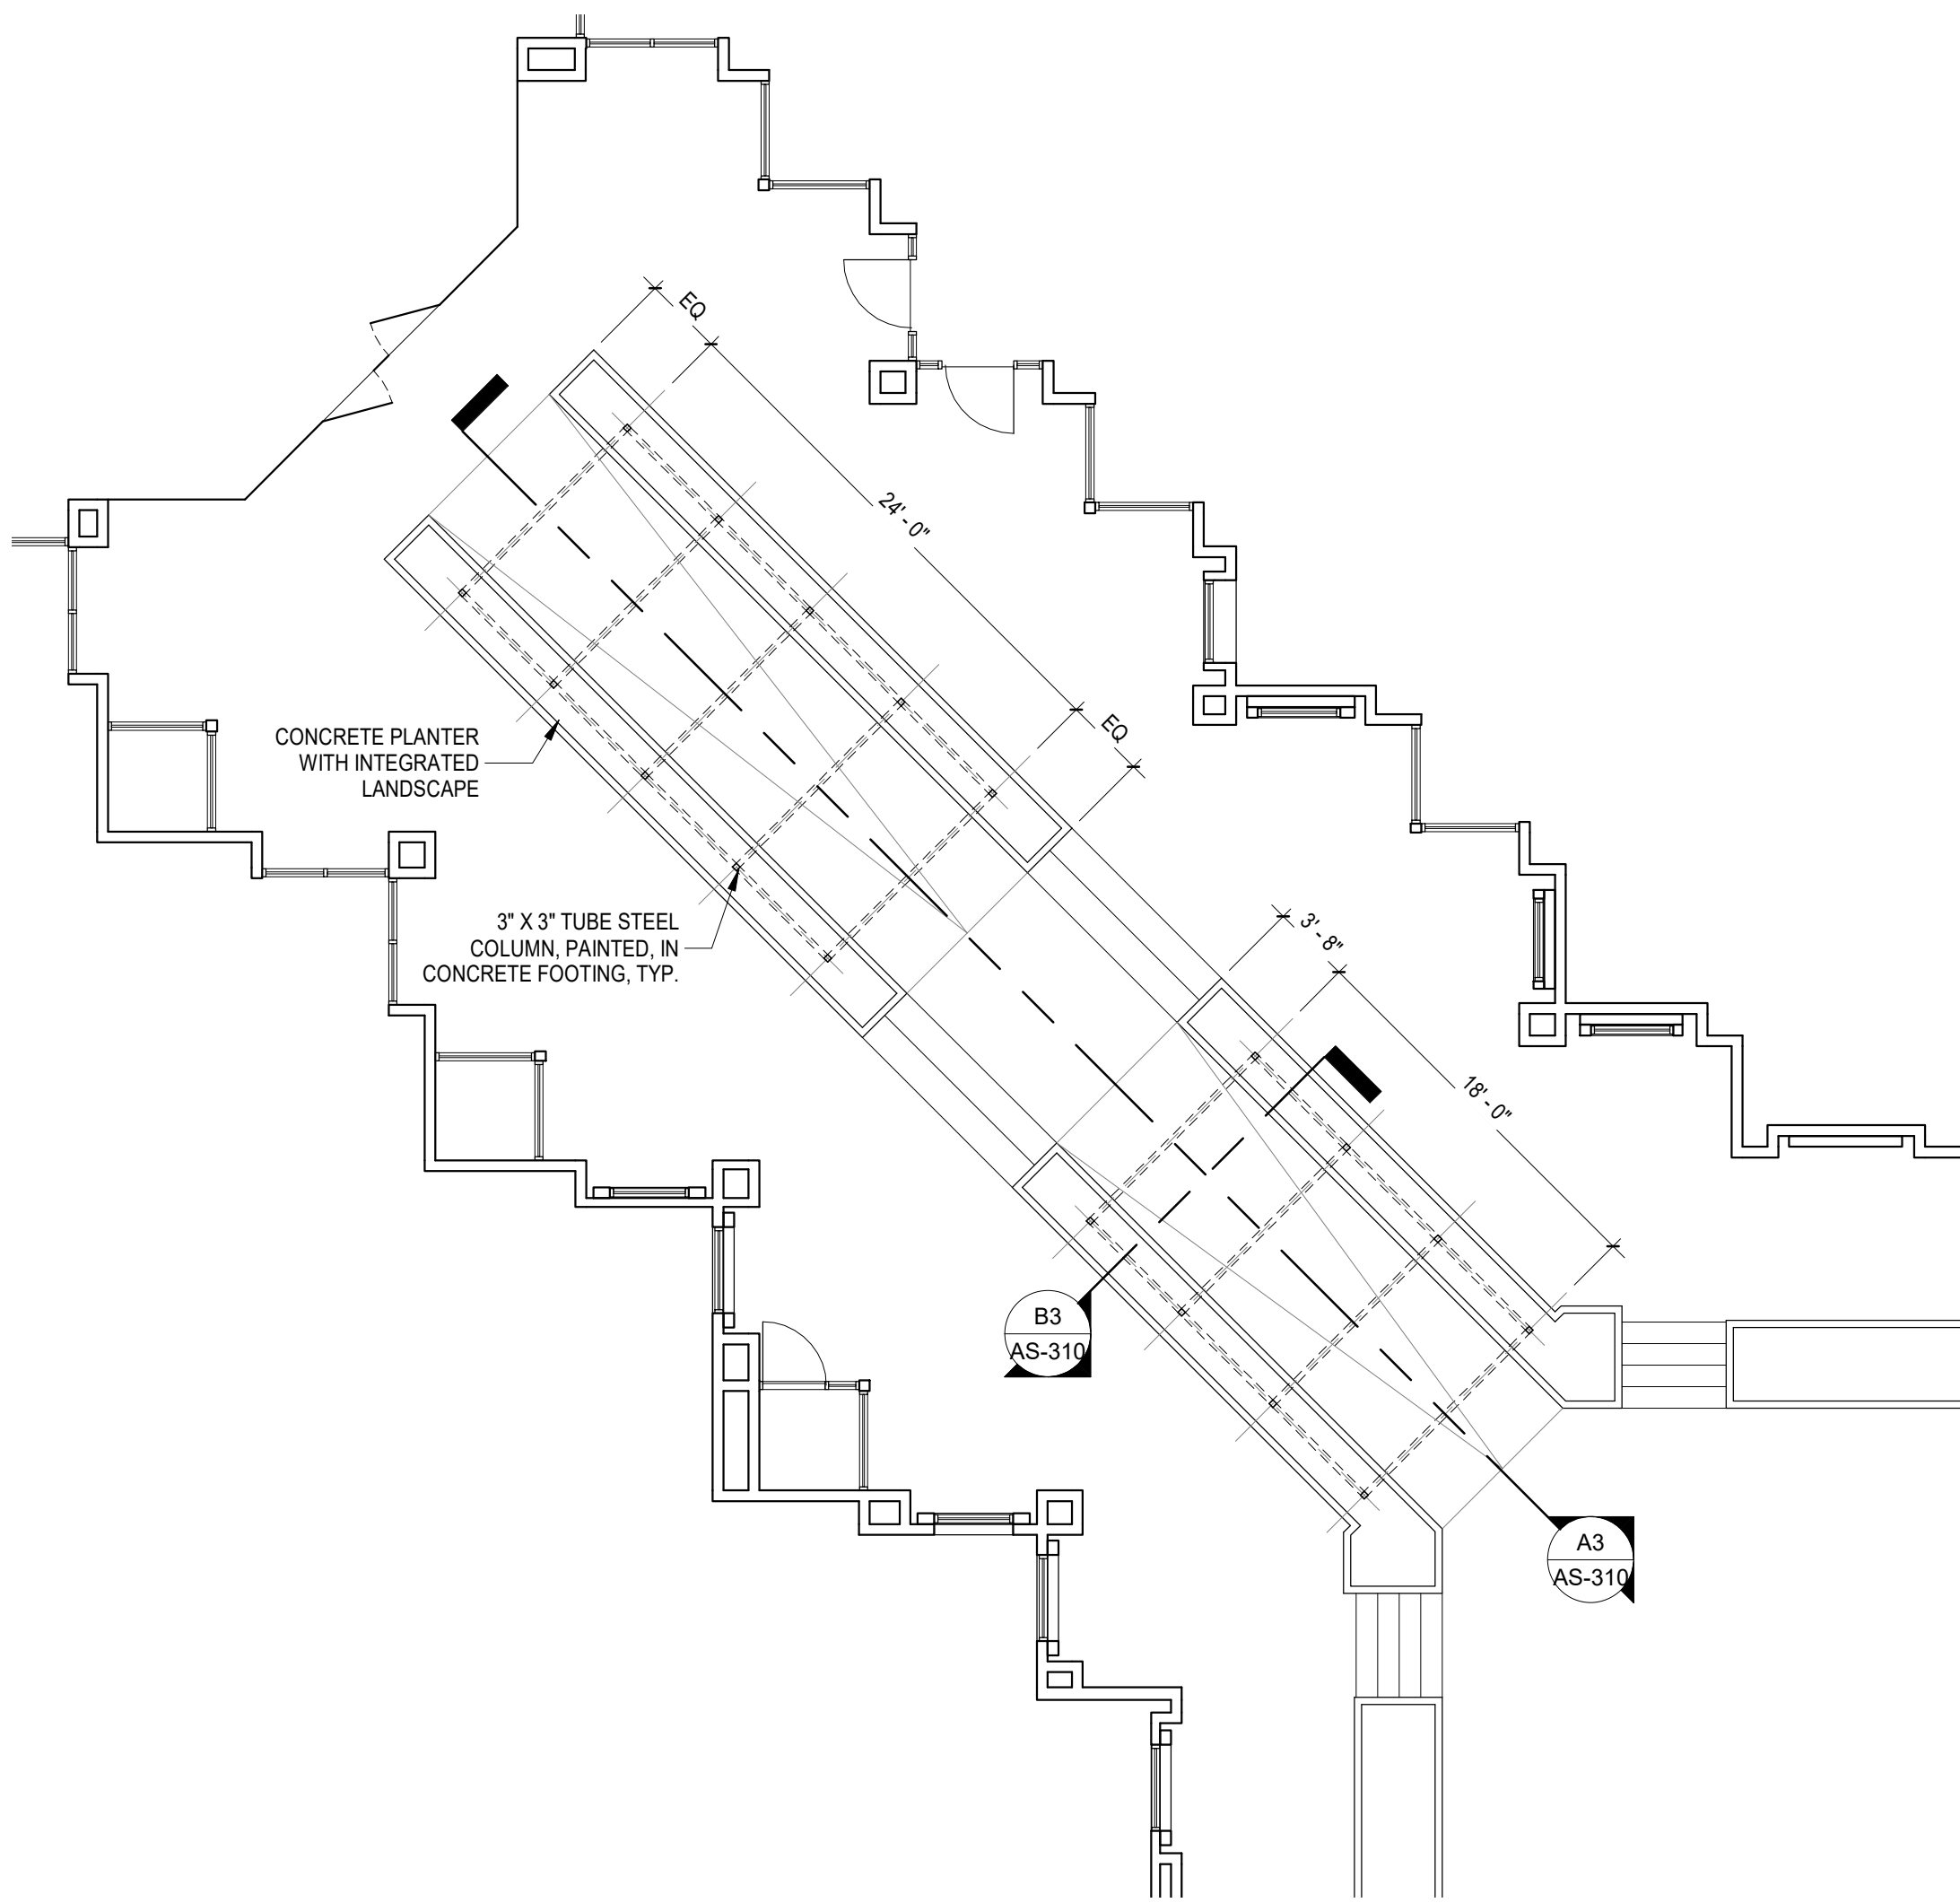

B3 TRELLIS ELEVATION
1/4" = 1'-0"

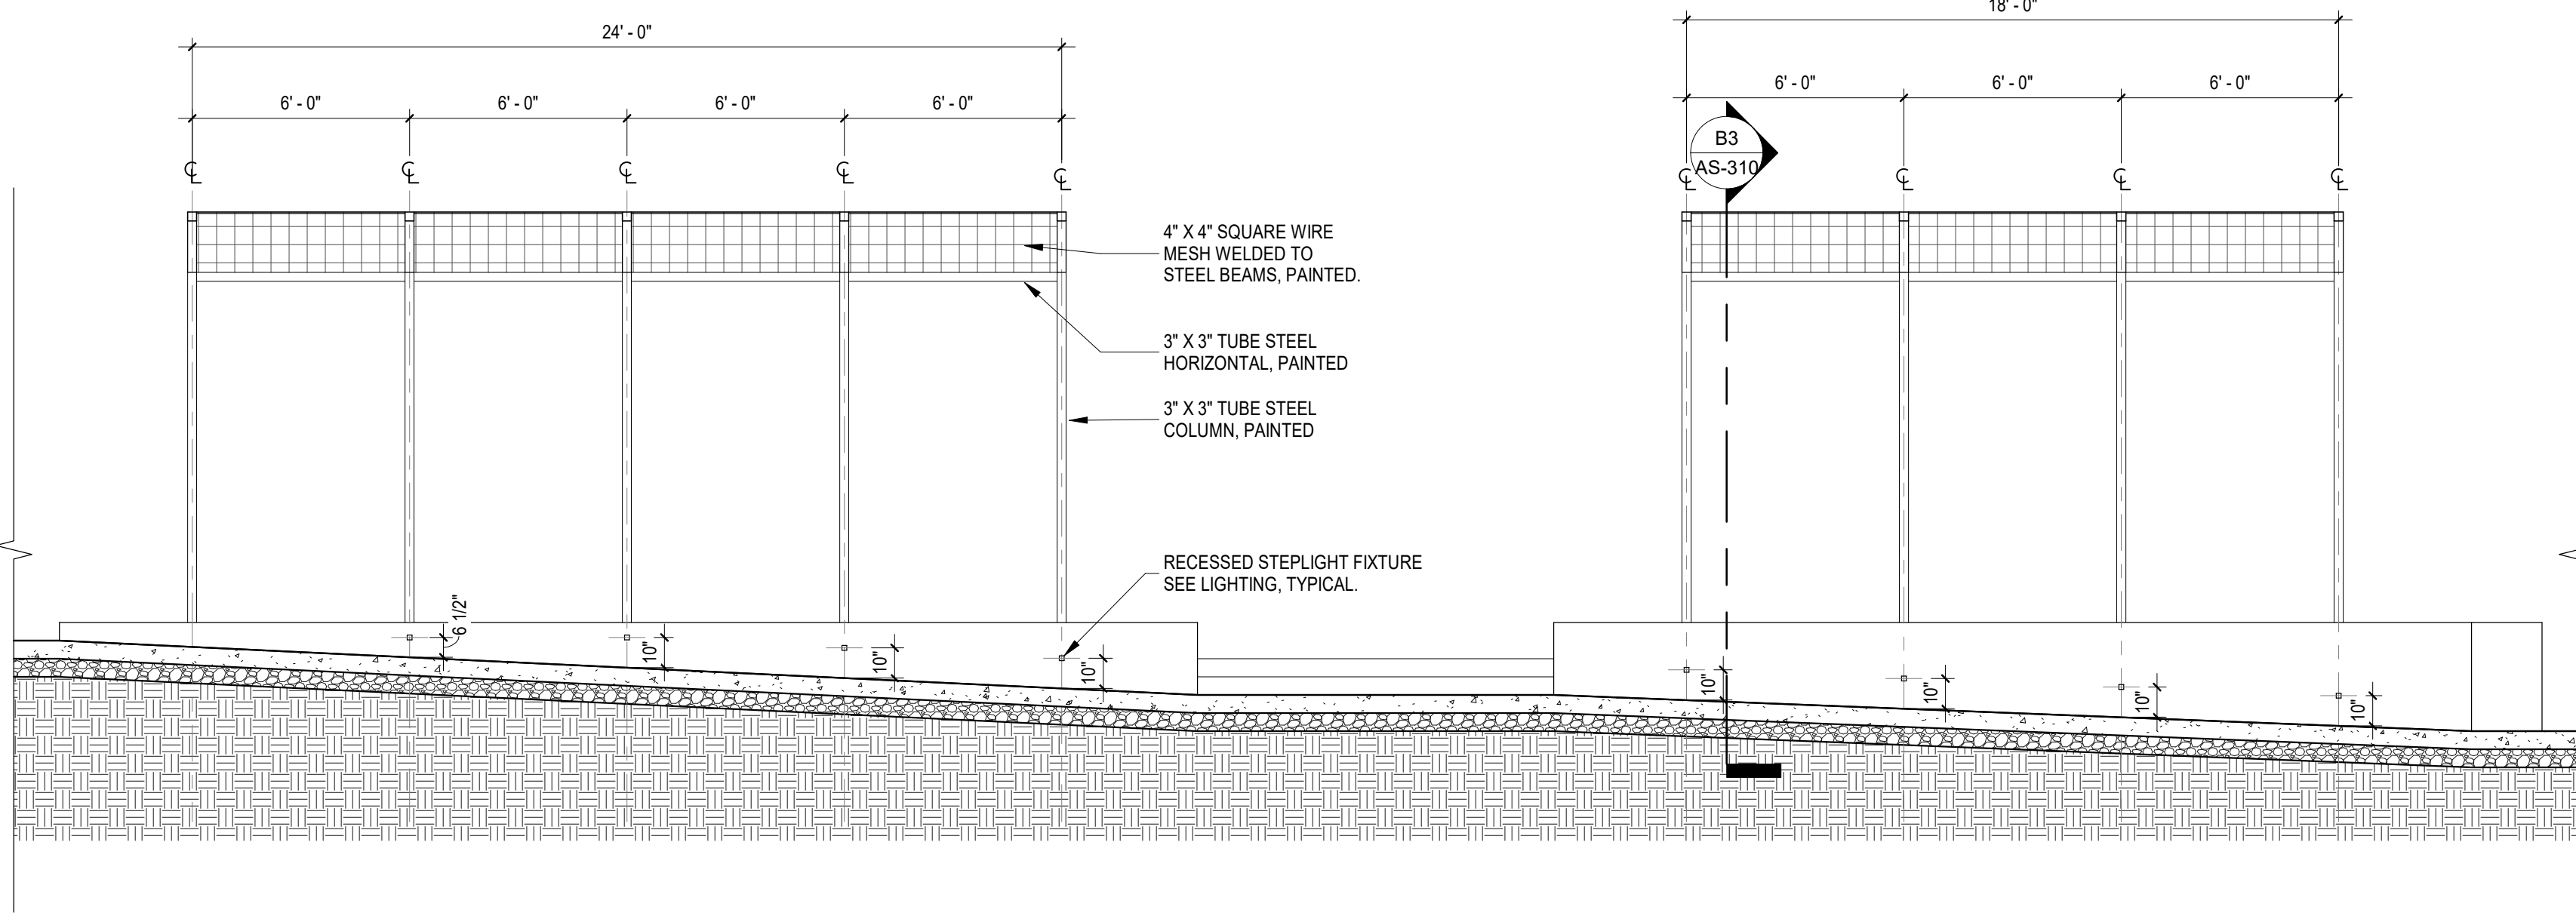

A3 TRELLIS SECTION
1/4" = 1'-0"

CONSULTANTS

LIGHTING

AE Design
1900 Wazee St #205
Denver, CO 80202

LANDSCAPING

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Albuquerque, NM 87110
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6501 Americas Pkwy
Albuquerque, NM 87110
p_505.510.0850

INTERIORS


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AC Engineering Enterprises, LLC
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Quiroga-Pfeiffer Engineering Corp.
4343 Pan American Freeway NE Suite #228
Albuquerque, NM 87107
p_505.858.1456



PARK SQUARE PLAZA
EXTERIOR IMPROVEMENTS

100% BID SET

6565 AMERICAS PKWY
ALBUQUERQUE, NM 87110

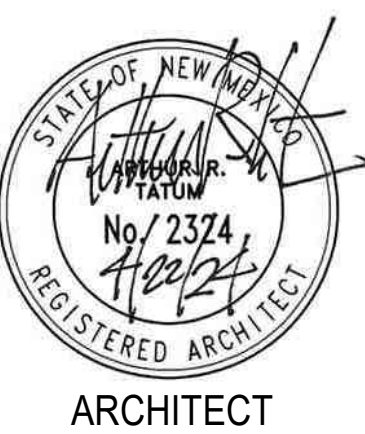APRIL 2024


| MARK | DATE | DESCRIPTION |
|------|------|-------------|
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| | |
|-------------|------------------------|
| ISSUE: | CONSTRUCTION DOCUMENTS |
| DATE: | APRIL 2024 |
| PROJECT NO: | Project Number |
| DRAWN BY: | MSP |
| CHECKED BY: | AV |

SHEET TITLE


WALL SECTIONS

AS-311

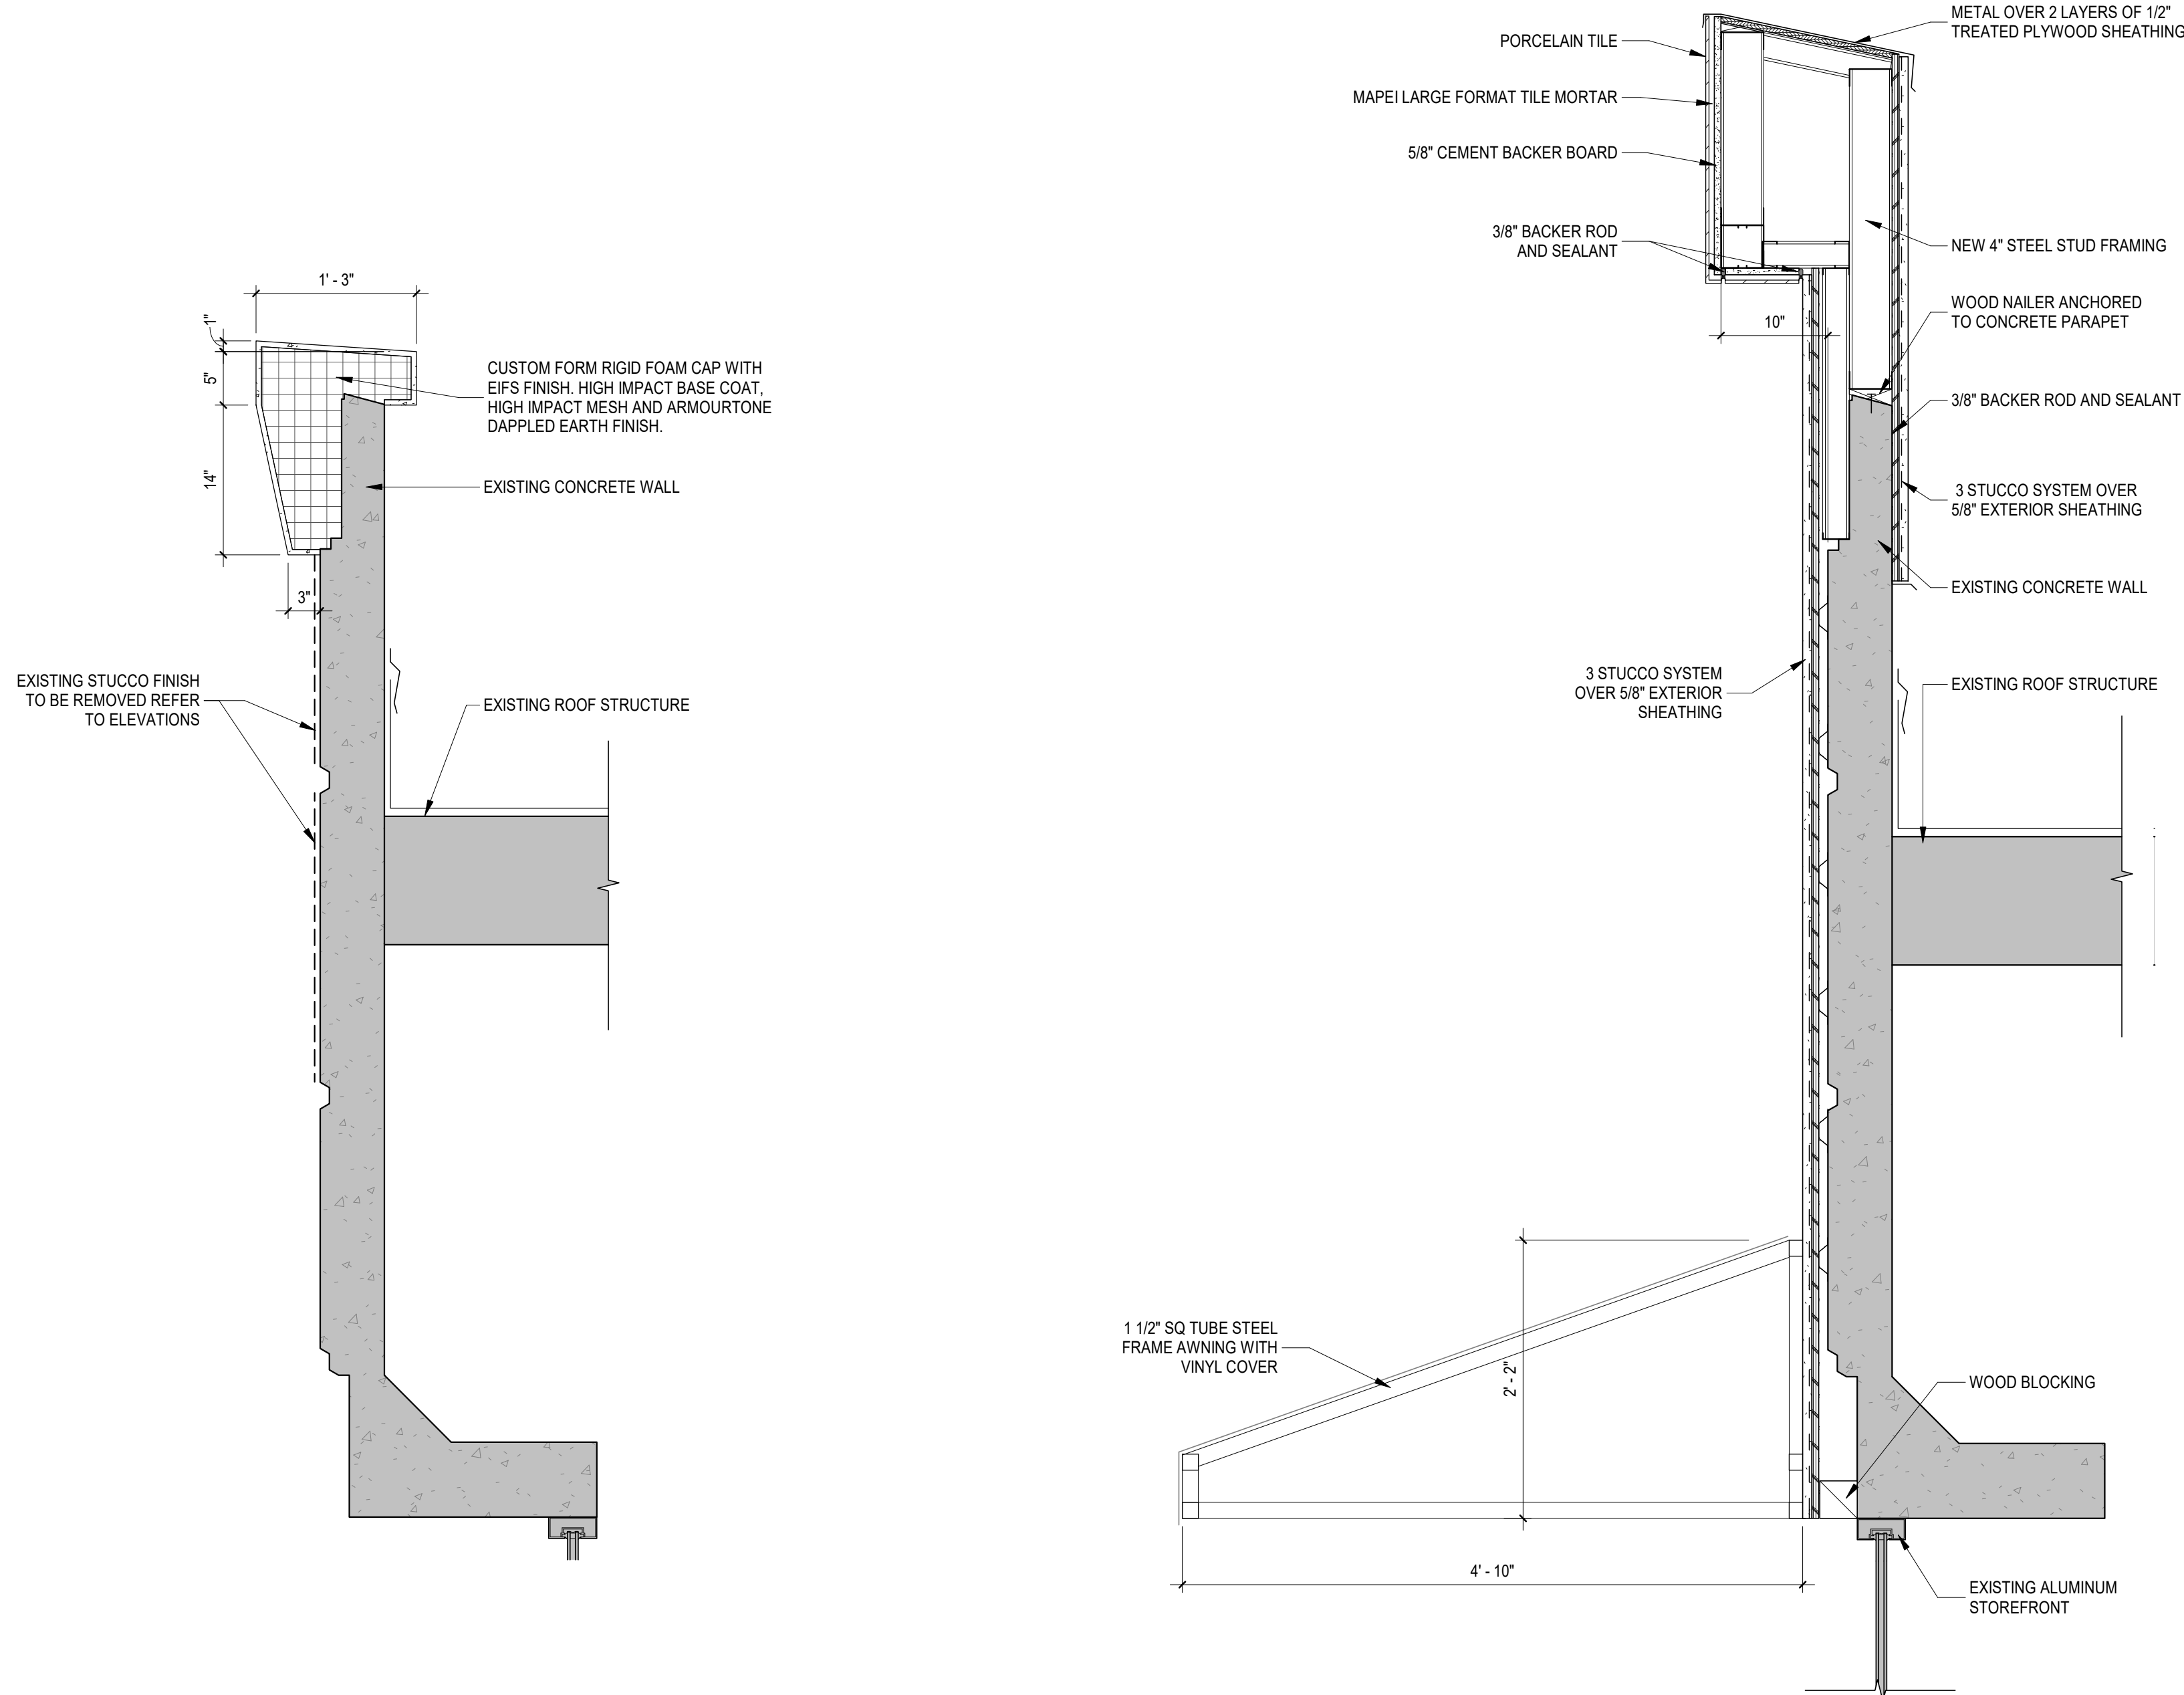


B1 TYPICAL NEW COPING
1" = 1'-0"


B2 TYPICAL NEW RETAIL W/ AWNING
1" = 1'-0"

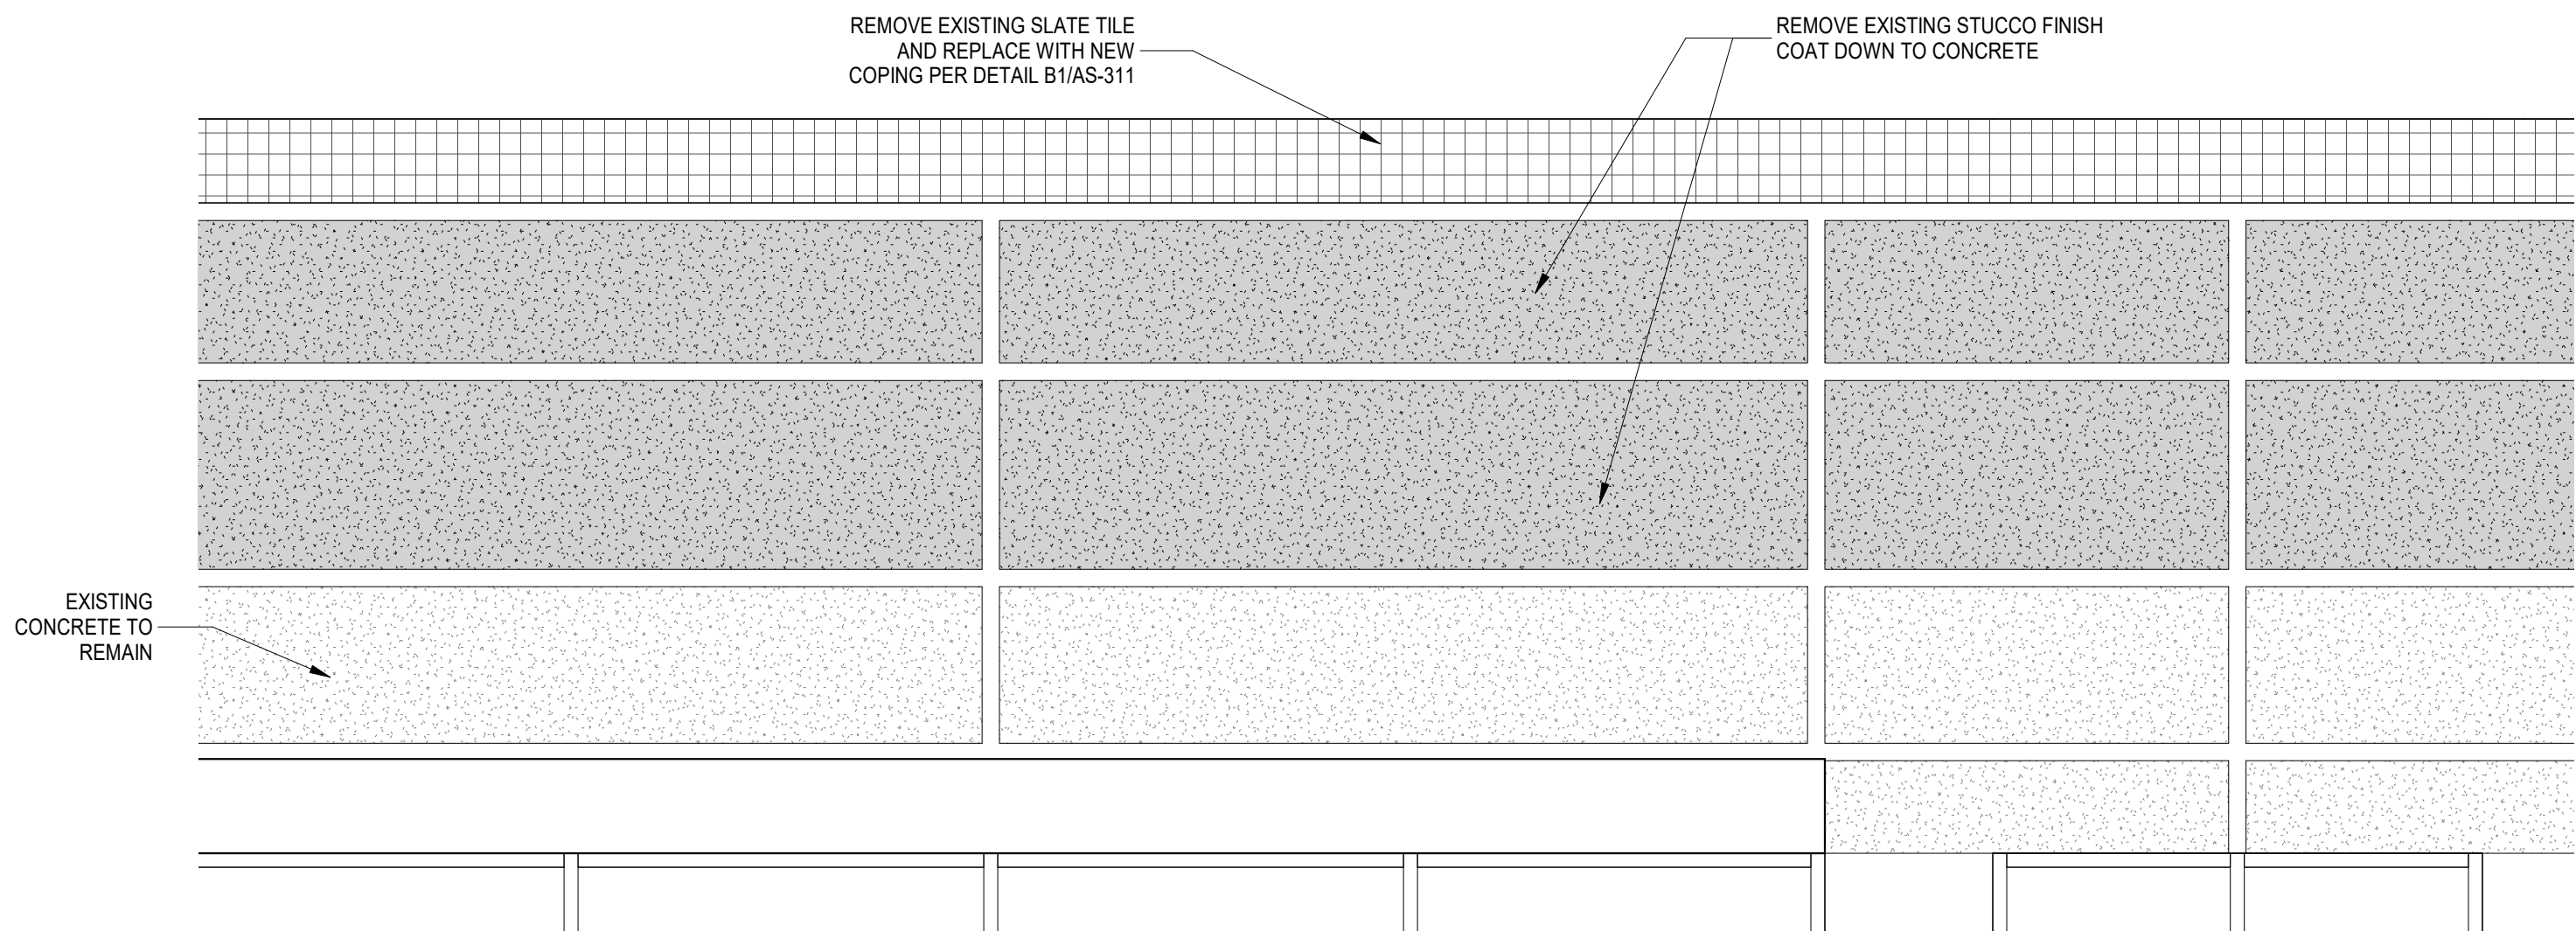

A1 TYPICAL STUCCO DEMO ELEVATION
1/2" = 1'-0"

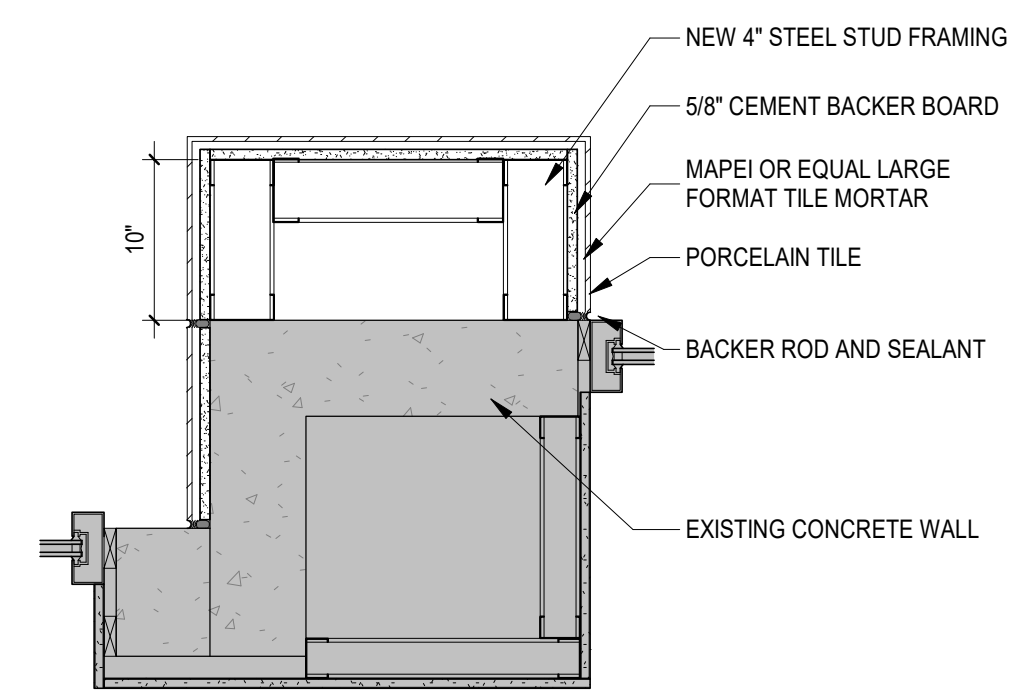

A2 PLAN DETAIL
1" = 1'-0"

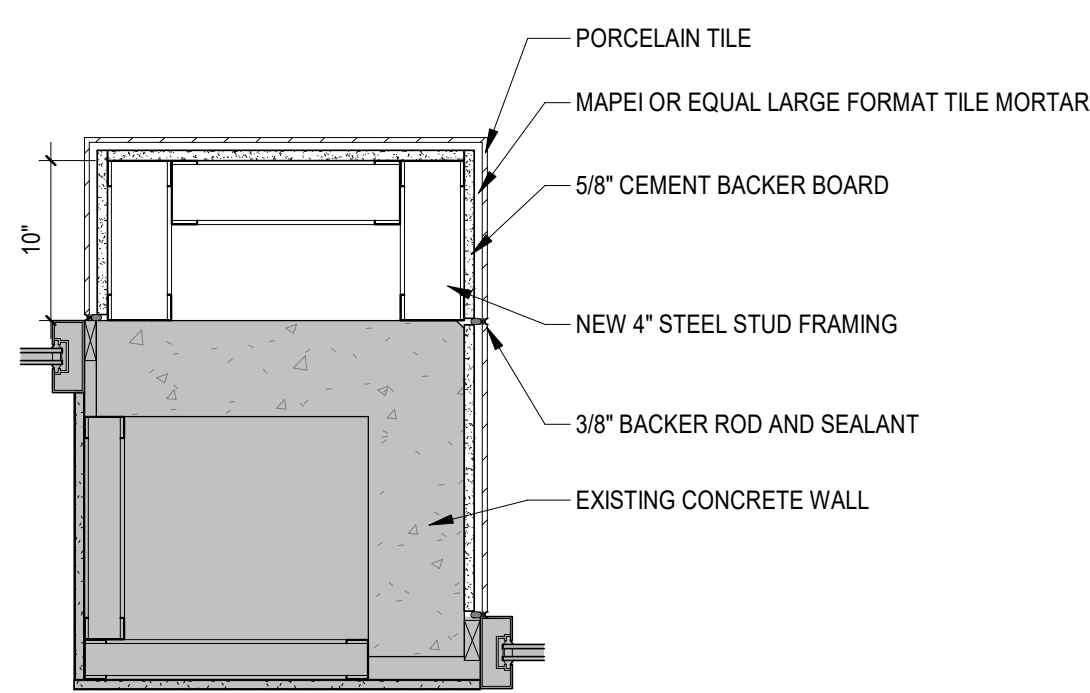

A3 PLAN DETAIL
1" = 1'-0"