

BP-2023-34420 Minor Amendment Justification Letter – Revision 2 7/18/2024

To Whom It May Concern:

Please consider approving BP-2023-34420 related modifications as a Minor Amendment to the approved site plan. This project is tenant improvement of an existing office building located at 14820 Central Av SE, Albuquerque, NM. The building occupancy of this facility, Group B, remains unchanged and the minor proposed changes are being pursued to meet the owner's Laboratory - Testing and Research needs. Access to the site remains unchanged and the user's intent is to keep this building and site in their current state with two minor exceptions:

- Rooftop Installation Rooftop deck with removable FRP railing will be added above a portion of the existing roof. At its highest elevation this deck will be approximately 18" above the existing parapet and its purpose is to house three removable research antennas. The structural frame of this deck will be comprised of steel framing members and its finishes will match the existing roofing color (gray).
- 2. Addition of a Fence Telescope trailer yard with approximately 160 linear feet of 8' R-panel security fencing will be added to the southern end of the existing parking lot.

We would appreciate your quick review of this request and are prepared to answer any questions that you may have.

Sincerely,

Srdan (Serge) Kalajdzic, Principal Architect

Hartman + Majewski Design Group

Attachment: Site and Elevations PDF, dated 07/18/2024

Design Group

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CONSULTANT

BUILDINGS ON NORTH

SIDE OF SITE BY

OTHER TENANT - NOT

PART OF PROJECT

SCOPE.

ZONE C

THE EXISTING

BUILDING FOOTPRINT

AND PARKING LOT/DRIVE ARE TO REMAIN UNCHANGED

UNDER PROJECT

SCOPE.

BACK AND SIDE SETBACK = 0' FRONT SETBACK = 5' NO CHANGES.

4	5
1 SHEET KEYED NOTES	REFERENCE KEYED NOTES
NOTE: SHEET KEYNOTES NOT SEQUENTIAL	
1 EXISTING TO REMAIN. 8 EXISTING TRASH ENCLOSURE TO REMAIN.	26 00 00.A01 NEW LIGHT FIXTURE, SEE ELECTRICAL. 26 00 00.A04 NEW GENERATOR AND PAD, SEE ELCTRICAL. 32 31 13.A01 8' TALL CHAIN LINK FENCING WITH PRIVACY SLATS, 1'6" BARBED WIRE EXTENSION ABOVE, ANGLED OUT. 32 31 13.B03 FIELD VERIFY GENERATOR ACCESS CLEARANCE AND CLEAR AREA REQUIREMENTS, PROVIDE SWING GATE WITH PADLOCK AS NEEDED TO PROVIDE ACCESS, AND MODIFY PRIVACY SCREENING INSTALLATION AS NECESSARY TO COMPLY WITH MANUFACTURER'S REQUIREMENTS.
	32 31 13.B05 FIELD VERIFY MECHANICAL EQUIPMENT CLEARANCE AND CLEAR AREA REQUIREMENTS. PROVIDE ACCESS DOORS AND MODIFY PRIVACY SCREENING INSTALLATION AS NECESSARY TO COMPLY WITH MANUFACTURER'S REQUIREMENTS.

TRAFFIC CIRCULATION LAYOUT APPROVED

Sertil A. Kanbar 6/7/2024

23'-8". EXIST. TO REMAIN

3 BIKE TX 30"h) (18"W X 30"h) SPACED 6' OC

_ R=20'-6"

23'-8".

EXIST. TO REMAIN

ROOFTOP DECK

PARKING SIGN -

EXISTING CONCRETE PAD FLUSH WITH ASPHALT

//DO NOT ENTER///,

BUILDING

GENERAL SHEET NOTES

FIELD VERIFY DIMENSIONS AND LAYOUT OF EXISTING SITE AND BUILDING DO NOT SCALE DRAWINGS. IF DIMENSIONS ARE IN QUESTION, REQUEST CLARIFICATION FROM ARCHITECT BEFORE PROCEEDING. REFER TO MECHANICAL, ELECTRICAL, AND PLUMBING SHEETS FOR ADDITIONAL SITE INFORMATION AND/OR WORK NOT SHOWN. LANDSCAPING APPROVED FOR THE ORIGINAL PROJECT SHALL BE MAINTAINED OR RESTORED TO THAT LEVEL OF COMPLETION. GOAL OF THIS PROJECT IS TO MAINTAIN THE EXISTING SITE FEATURES AND TO ADD SECURITY FENCING AROUND THE EXISTING MECHANICAL YARD AND RESEARCH PAD AT THE SOUTH END OF THE SITE. LANDSCAPING AND SIGNAGE WILL NOT INTERFERE WITH CLEAR SIGHT

REQUIREMENTS. THEREFORE, SIGNS, WALLS, TREES, AND SHRUBBERY BETWEEN 3 AND 8 FEET TALL WILL NOT BE ACCEPTABLE IN THE CLEAR

SIGHT TRIANGLE.) ALL BROKEN AND CRACKED SIDEWALK MUST BE REPLACED WITH SIDEWALK AND CURB AND GUTTER.

STAMP

PERMIT SET

PROJECT NAME **GENERAL ATOMICS TI**

14820 CENTRAL AVE, ALBUQUERQUE, NM 87123

GENERAL ATOMICS

STORMWATER TO BE MANAGED PER 14-16-5-4(H) GRADING TO BE DESIGNED PER 14-16-5-4(J) ALL WALLS, FENCES, RETAINING WALLS TO COMPLY PARKING FOR OFFICE OCCUPANCY (RESEARCH FACILITY) IDO REQUIRES 1.5 SPACES/1,000 SF GFA 11,837 GFA -11.84*1.5=17.76 ORIGINAL SPACES SPACES REQUIRED

IDO ZONE: NR-C

MAX HEIGHT: 38'

MIN. FRONT SETBACK: 5'

MIN. SIDE/REAR SETBACK: 0'

SPACES PROVIDED MINIMIM NUMBER OF PARKING SPACES: VEHICLES 18 REQUIRED / 41 PROVIDED ACCESSIBLE 2 REQUIRED / 2 PROVIDED MOTORCYCLES 1 REQUIRED / 1 PROVIDED BYCYCLES 3 REQUIRED / 3 PROVIDED

GENERAL ZONING COMPLIANCE REQUIREMENTS:

SITE LIGHTING LUMINAIRES LIMITED TO 20 FT. HIGH

ADA NOTES:

1. THE ADA ACCESS AISLE SHALL HAVE WORDS "NO PARKING" IN CAPITAL LETTERS, EACH OF WHICH SHALL BE AT LEAST ONE FOOT HIGH AND AT LEAST TWO INCHES WIDE, PLACED AT THE REAR OF THE PARKING SPACE SO AS TO BE CLOSE TO WHERE AN ADJECENT VEHICLE'S REAR TIRE WOULD BE PLACED (66-1-4.1.B NMSA 1978). 2. THE ADA ACCESSIBLE PARKING SIGN MUST HAVE REQUIRED LANGUAGE PER 66-7-352.4C NMSA 1978 "VIOLATORS ARE SUBJECT TO A FINE AND OR TOWING"

1. ALL NEW FENCING SHALL BE 8' CHAINLINK WITH 3-STRAND BARBED WIRE TOPPING. 2. MAIN BUILDING, NORTH SIDE - 175 LINEAR FEET. 3. TELESCOPE YARD - 160 LINEAR FEET.

SIGN TYPE R7-8 (12"×18") - sign field is white - sign lettering and border are green ACCESSIBLE - International Symbol of Accessibility is white on a blue background **PARKING** Optional Language Bottom of lowest sign 60" min. above the ground in parking lot. PLATE or PLACARD Required language per ANSI 502.7 NMSA 197866-7-352.4C VIOLATORS ARE 84" min. for on-street parking and in the pedestrian path of SUBJECT TO A FINE SIGN TYPE R7-8A (6"x12") AND/OR TOWING travel per MUTCD Sec 2A.18 -- sign field is white - sign lettering and border are green Required language (Van Accessible Spaces) -ACCESSIBLE ANSI 502.7

RESERVED PARKING SIGN

REVISIONS 06.05.2024 TCL Revision 1 05.24.2024 TCL 11.17.2023 | City Comment Response 10.30.2023 Addendum 2 10.23.2023 | Addendum 1 NO. DATE DESCRIPTION

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Checked by 10/23/2023 Project number

SHEET TITLE

SITE PLAN

SHEET NUMBER





EXISTING

UNINCORPORATED

ADJACENT SITE

SITE PLAN

ADD PAVEMENT STRIPING ON


BOTH SIDES, LETTERS SHALL

TOPOGRAPHY LINES REMOVED FOR CLARITY REFER TO CIVIL DRAWINGS.

FACE THE ONCOMING TRAFFIC

Site and Elevations - Page 1 H+Mdg, 07/18/2024


AS101

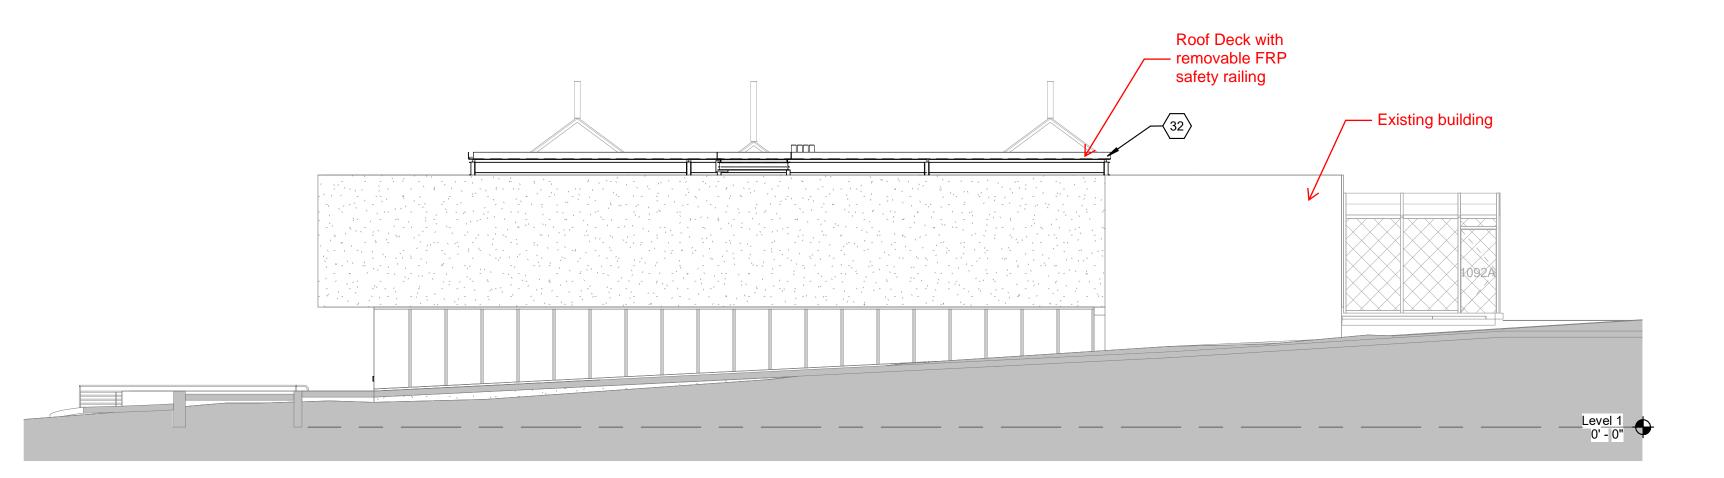


Roof Deck with removable FRP safety railing Existing building

C2 EXTERIOR ELEVATION - NORTH

D2 EXTERIOR ELEVATION - EAST

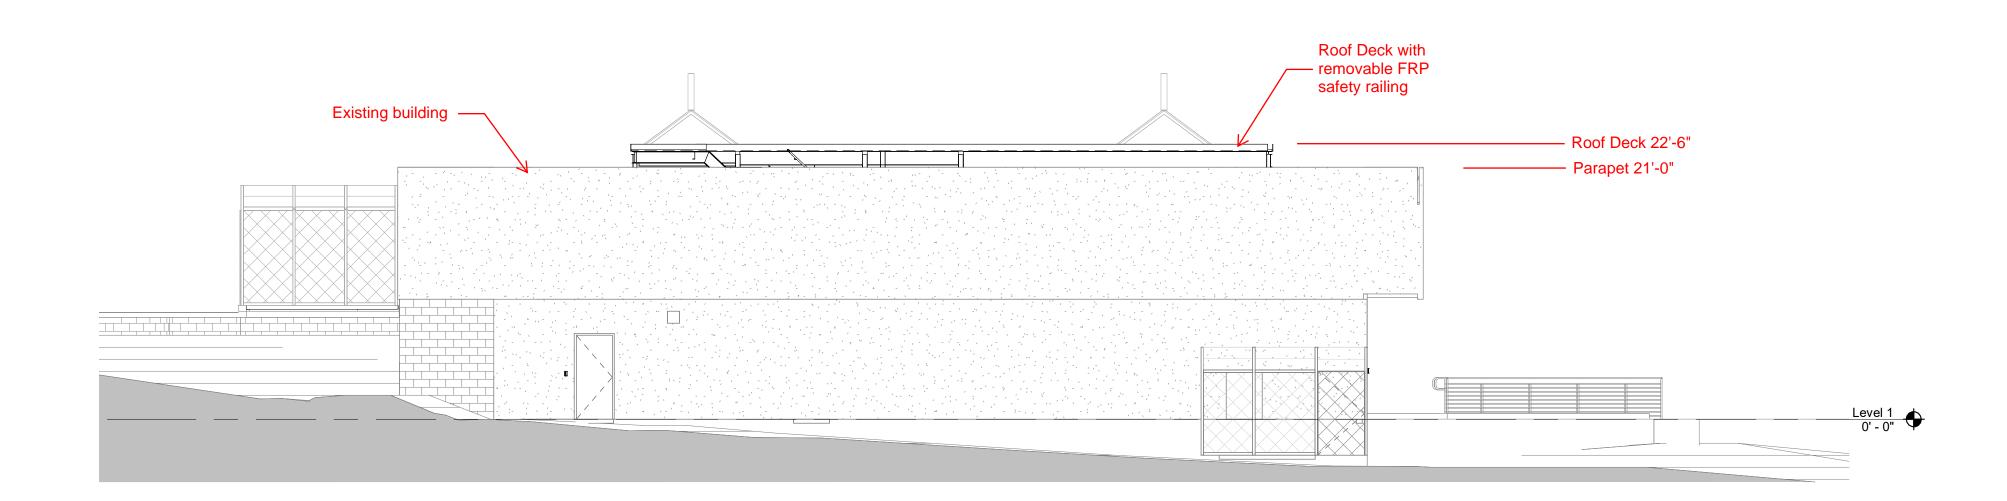

B2 EXTERIOR ELEVATION - WEST

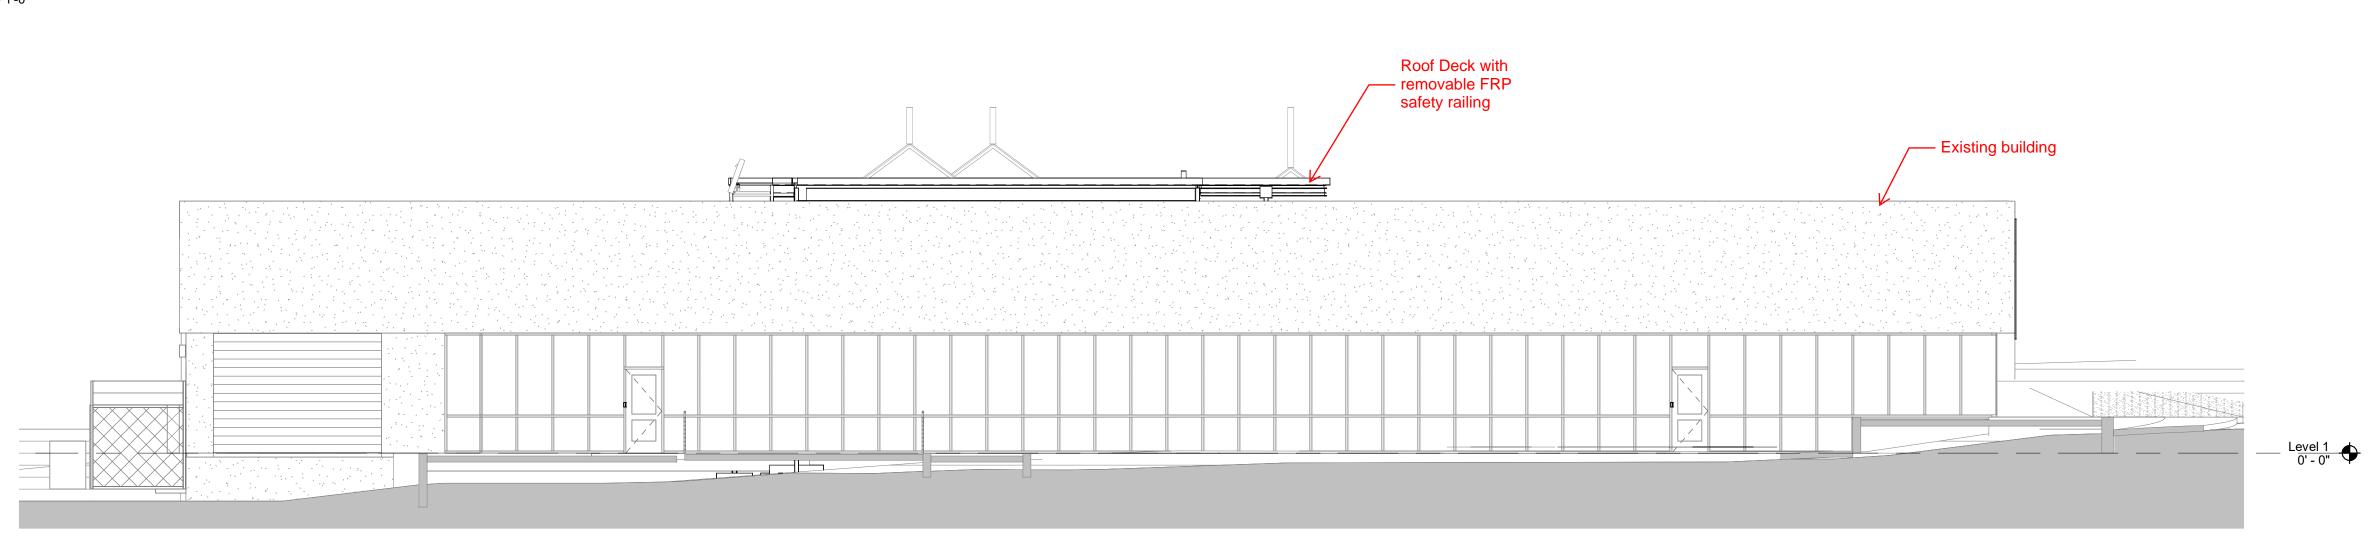

GENERAL SHEET NOTES

A. FIELD VERIFY DIMENSIONS AND LAYOUT OF SITE AND BUILDING ELEMENTS.
 B. DO NOT SCALE DRAWINGS. IF DIMENSIONS ARE IN QUESTION, REQUEST CLARIFICATION FROM ARCHITECT BEFORE PROCEEDING.
 C. EXISTING EXTERIOR STUCCO FINISHES TO REMAIN.

1) SHEET KEYED NOTES

FIELD VERIFY ELEVATION OF HIGH POINT OF STANDING SEAM ROOFING. FINISHED SURFACE OF ROOF PLATFORM TO BE 2'-2" HIGHER.

NOTE: SHEET KEYNOTES NOT SEQUENTIAL

DESIGN GROUP

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CONSULTANT

STAMP

PERMIT SET

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GENERAL ATOMICS

REVISIONS

NO. DATE DESCRIPTION

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BUILDING ELEVATIONS SHEET NUMBER

A2 EXTERIOR ELEVATION - SOUTH

1/8" = 1'-0"

Site and Elevations - Page 2 H+Mdg, 07/18/2024

A-201