



#### **DEVELOPMENT REVIEW APPLICATION**

Effective 6/14/23

Please check the appropriate box and refer to supplemental forms for submittal requirements. All fees must be paid at the time of application.								
Administrative Decisions	D	ecisions R	equiring a Pu	blic Meeting or Hearing	Policy	Policy Decisions		
☐ Archaeological Certificate (Form P3		☐ Site Plan – EPC including any Variances – EPC (Form P1)				☐ Adoption or Amendment of Comprehensive Plan or Facility Plan (Form Z)		
☐ Historic Certificate of Appropriatene (Form L)	ss – Minor	Master De	velopment Pla	nn (Form P1)		☐ Adoption or Amendment of Historic Designation (Form L)		
☐ Alternative Signage Plan (Form P3)		Historic Ce	ertificate of Ap	propriateness – Major	☐ Ame	☐ Amendment of IDO Text (Form Z)		
☐ Minor Amendment to Site Plan (For	m P3) □	Demolition	Outside of H	PO (Form L)	□ Ann	☐ Annexation of Land (Form Z)		
☐ WTF Approval (Form W1)		Historic De	esign Standard	ds and Guidelines (Form L)	□ Ame	☐ Amendment to Zoning Map – EPC (Form Z)		
☐ Alternative Landscaping Plan <i>(Form</i>		Wireless T Form W2)	elecommunica	ations Facility Waiver	□ Ame	☐ Amendment to Zoning Map – Council (Form Z)		
					Appea	ıls		
					☐ Dec	ision by EPC, LC, ZHE	, or City Staff (Form	
APPLICATION INFORMATION								
Applicant:					Ph	one:		
Address:					Em	nail:		
City:				State:	Zip	Zip:		
Professional/Agent (if any):					Phone:			
Address:				Em	Email:			
City: State:			State:	Zip:				
Proprietary Interest in Site: List <u>all</u> owners:								
BRIEF DESCRIPTION OF REQUEST								
SITE INFORMATION (Accuracy of the existing legal description is crucial! Attach a separate sheet if necessary.)								
Lot or Tract No.: Block:			Block:	Un	it:			
Subdivision/Addition:				MRGCD Map No.:	UP	UPC Code:		
Zone Atlas Page(s):		Existing Z	Zoning:		Pro	Proposed Zoning:		
# of Existing Lots:		# of Propo	osed Lots:		To	tal Area of Site (acres):		
LOCATION OF PROPERTY BY STRE	ETS	<u>l</u>			•			
Site Address/Street:		Between:			and:			
CASE HISTORY (List any current or prior project and case number(s) that may be relevant to your request.)								
Signature: Judis t					Date:			
Printed Name:			☐ Applicant or ☐ Agent					
FOR OFFICIAL USE ONLY								
Case Numbers	Action	Action Fees Case Numbers			Action	Fees		
Meeting/Hearing Date:					Fee Total:			
Staff Signature: Date:				Project #				

FORM P3 Page 1 of 3

#### FORM P3: ADMINISTRATIVE DECISIONS AND MINOR AMENDMENTS

#### \_ ARCHAEOLOGICAL CERTIFICATE

A Single PDF file of the complete application including all documents being submitted must be emailed to <a href="PLNDRS@cabq.gov">PLNDRS@cabq.gov</a> prior to making a submittal. Zipped files or those over 9 MB cannot be delivered via email, in which case the PDF must be provided to City Staff using other online resources such as Dropbox or FTP. The PDF shall be organized in the number order below.

1) Development Review application form completed, signed, and dated
2) Form P3 with all the submittal items checked/marked
3) Zone Atlas map with the entire site clearly outlined and labeled
4) Letter of authorization from the property owner if application is submitted by an agent
5) Archaeological Compliance Form with property information section completed
6) Only the information above is required unless the City Archaeologist determines that the application does not qualify for a Certificate of No Effect, in which case a treatment plan prepared by a qualified archaeologist that adequately mitigates any archeological impacts of the proposed development must be submitted and reviewed for a Certificate of Approval per the criteria in IDO Section 14-16-6-5(A)(3)(b)
_ MINOR AMENDMENT TO SITE PLAN – ADMIN, EPC, or DRB
A Single PDF file of the complete application including all documents being submitted must be emailed to <a href="https://example.com/PLNDRS@cabq.gov">PLNDRS@cabq.gov</a> prior to making a submittal. Zipped files or those over 9 MB cannot be delivered via email, in which case the PDF must be provided to City Staff using other online resources such as Dropbox or FTP. <a href="https://example.com/The PDF shall be organized in the number order below.">The PDF shall be organized in the number order below.</a>
1) Development Review application form completed, signed, and dated
2) Form P3 with all the submittal items checked/marked
3) Zone Atlas map with the entire site clearly outlined and labeled
4) Letter of authorization from the property owner if application is submitted by an agent
5) Justification letter describing, explaining, and justifying the request per the criteria in IDO Section 14-16-6-4(Y)(2)
6) The approved Site Plan being amended
7) Copy of the Official Notice of Decision associated with the prior approval
8) The proposed Site Plan, with changes circled and noted  Refer to the Site Plan Checklist for information need on the proposed Site Plan  Minor Amendments be within the thresholds established in IDO Table 6-4-4. Any amendment beyond these thresholds is

considered a Major Amendment and must be processed through the original decision-making body for the request

FORM P3 Page 2 of 3

## \_ MINOR AMENDMENT TO SITE DEVELOPMENT PLAN APPROVED PRIOR TO THE EFFECTIVE DATE OF THE IDO

A Single PDF file of the complete application including all documents being submitted must be emailed to <a href="https://example.com/PLNDRS@cabq.gov">PLNDRS@cabq.gov</a> prior to making a submittal. Zipped files or those over 9 MB cannot be delivered via email, in which case the PDF must be provided to City Staff using other online resources such as Dropbox or FTP. The PDF shall be organized in the number order below.

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2) Form P3 with all the submittal items checked/marked
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4) Letter of authorization from the property owner if application is submitted by an agent
5) Justification letter describing, explaining, and justifying the request per the criteria in IDO Section 14-16-6-4(Z)(1)(a)
6) The approved Site Plan being amended
7) Copy of the Official Notice of Decision associated with the prior approval
8) The proposed Site Plan, with changes circled and noted  Refer to the Site Plan Checklist for information need on the proposed Site Plan  Minor Amendments be within the thresholds established in IDO Table 6-4-4. Any amendment beyond these thresholds is considered a Major Amendment and must be processed through the original decision-making body for the request
_ ACCELERATED EXPIRATION OF SITE PLAN
A Single PDF file of the complete application including all documents being submitted must be emailed to <a href="mailto:PLNDRS@cabq.gov">PLNDRS@cabq.gov</a> prior to making a submittal. Zipped files or those over 9 MB cannot be delivered via email, in which case the PDF must be provided to City Staff using other online resources such as Dropbox or FTP. <a href="mailto:The PDF shall be organized in the number order below">The PDF shall be organized in the number order below</a> .
1) Development Review application form completed, signed, and dated
2) Form P3 with all the submittal items checked/marked
3) Zone Atlas map with the entire site clearly outlined and labeled
4) Letter of authorization from the property owner if application is submitted by an agent
5) Justification letter describing, explaining, and justifying the request per the criteria in IDO Section 14-16-6-5(C)(3)(b)

\_\_\_\_\_ 6) Site Plan to be Expired


FORM P3 Page 3 of 3

#### \_ ALTERNATIVE SIGNAGE PLAN

\_\_\_\_\_ 6) Landscape Plan

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1) Development Review application form completed, signed, and dated
2) Form P3 with all the submittal items checked/marked
3) Zone Atlas map with the entire site clearly outlined and labeled
4) Letter of authorization from the property owner if application is submitted by an agent
5) Proposed Alternative Signage Plan compliant with IDO Section 14-16-5-12(F)(5)
6) Justification letter describing, explaining, and justifying the request per the criteria in IDO Section 14-16-6-5(C)(3)(b)
7) Sign Posting Agreement
8) Required Content of Notice <u>at Submittal</u> per IDO Section 14-16-6-4(K)(1)
Office of Neighborhood Coordination notice inquiry response
Completed notification form(s), proof of additional information provided in accordance with IDO Section 6-4(K)(1)(b)
Proof of emailed notice to affected Neighborhood Association representatives
_ ALTERNATIVE LANDSCAPING PLAN
A Single PDF file of the complete application including all documents being submitted must be emailed to <a href="mailto:PLNDRS@cabq.gov">PLNDRS@cabq.gov</a> prior to making a submittal. Zipped files or those over 9 MB cannot be delivered via email, in which case the PDF must be provided to City Staff using other online resources such as Dropbox or FTP. The PDF shall be organized in the number order below.
1) Development Review application form completed, signed, and dated
2) Form P3 with all the submittal items checked/marked
3) Zone Atlas map with the entire site clearly outlined and labeled
4) Letter of authorization from the property owner if application is submitted by an agent
5) Justification letter describing, explaining, and justifying the request per the criteria in IDO Section 14-16-5-6(C)(16)

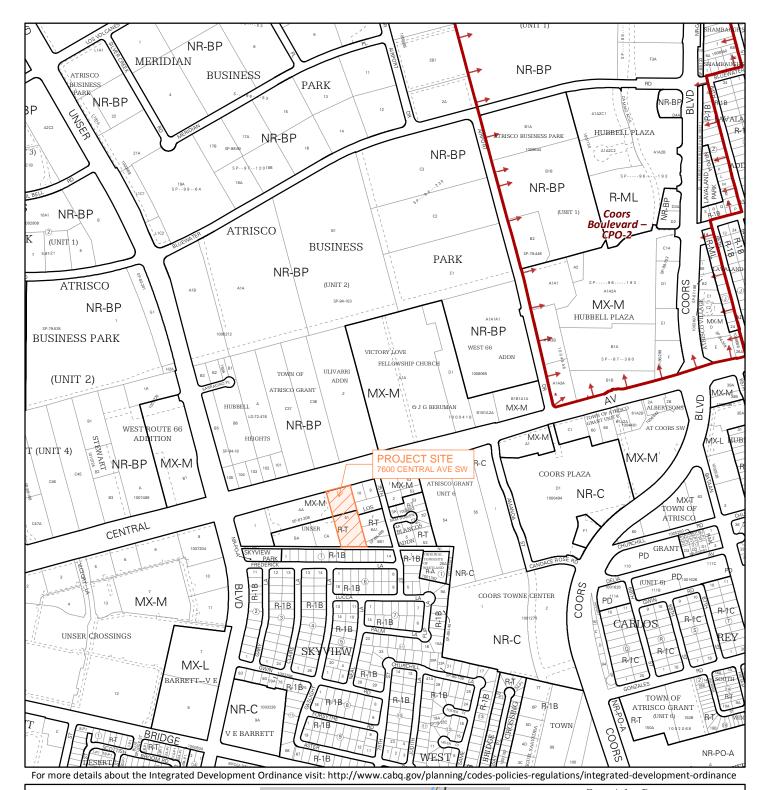

Zone Atlas Page: **IDO Zone Atlas** K-10-ZMay 2018 Escarpment Easement )Petroglyph National Monument Areas Outside of City Limits Airport Protection Overlay (APO) Zone Character Protection Overlay (CPO) Zone Historic Protection Overlay (HPO) Zone IDO Zoning information as of May 17, 2018 **Gray Shading** View Protection Overlay (VPO) Zone The Zone Districts and Overlay Zones Represents Area Outside are established by the Feet = of the City Limits Integrated Development Ordinance (IDO). 250 1,000



January 26, 2024

City of Albuquerque Planning Department 600 2nd St. NW Albuquerque, NM 87102

Re: Route 66 Flats Site Plan Document Submission

To whom it may concern,

As the Owner of the property located at 7600 Central Ave. SW, in the City of Albuquerque, this letter is to authorize Shopworks Architecture, LLC as agent of BlueLine Development, Inc., to submit the enclosed Route 66 Flats Site Plan application and associated documents.

Please contact us with any questions or concerns.

Sincerely,

Christian Pritchett Director of Development



#### **Route 66 Flats**

#### Alternative Landscape Plan-Justification Letter

#### 03/27/2024

Due to utilities, within the Right of Way of Central Ave SW on the North side of the property, trees are not able to be planted within the ROW along the required walk. Due to this, we are unable to meet ULD 5-6 (C)(4)(i), with a requirement of 1 tree per 25 linear feet, equaling the requirement of 8 trees. The 8 trees have been relocated within the site. Plans show a total site tree requirement of 32 trees, we added the 8 ROW trees to this total, totaling to 40 trees as shown on the Alternative Landscape Plans. Due to the relocation of the trees, we believe we are still providing the benefits that trees provide to the site and do not include a reduction of tree planting requirements meeting ULD 5-6(C)(16)(c).

The site plan review comments we have received from Albuquerque on 3/20/24 have been addressed.

Thank you,

Ally Balderston

Flow Design Collaborative

#### **GENERAL NOTES**

- 1. A KICK-OFF MEETING WITH THE LANDSCAPE ARCHITECT IS REQUIRED PRIOR TO BEGINNING ANY SITE OR LANDSCAPE WORK.
- 2. OBTAIN NECESSARY PERMITS FROM ALL JURISDICTIONS AS REQUIRED TO CONSTRUCT THE WORK OF THIS PROJECT. ALL WORK SHALL BE PERFORMED IN ACCORDANCE WITH PLANS APPROVED BY CITY OF ALBUQUERQUE.
- 3. REFER TO SURVEY DRAWINGS AND OTHER AVAILABLE DOCUMENTS FOR PROPERTY LIMITS, EXISTING CONDITIONS, AND HORIZONTAL AND VERTICAL CONTROL.
- 4. PROVIDE AND MAINTAIN UTILITY LOCATES DURING ALL PHASES OF WORK. DO NOT DAMAGE UTILITY LINES/STRUCTURES. NOTIFY OWNER'S REPRESENTATIVE OF ANY DISCREPANCIES BEFORE STARTING ANY WORK. CONTRACTOR SHALL BE RESPONSIBLE FOR LOCATION OF UNDERGROUND UTILITIES OR STRUCTURES, WHETHER OR NOT SHOWN OR DETAILED AND INSTALLED BY ANY OTHER CONTRACT.
- 5. RESTORATION OF UTILITIES DAMAGED BY THE CONTRACTOR SHALL BE AT THE CONTRACTOR'S EXPENSE.
- 6. THOROUGHLY REVIEW AND DOCUMENT THE SITE CONDITIONS PRIOR TO CONSTRUCTION.
- 7. THOROUGHLY REVIEW DRAWINGS, AND TECHNICAL SPECIFICATIONS AND NOTIFY OWNER'S REPRESENTATIVE OF ANY DISCREPANCIES PRIOR TO CONSTRUCTION.
- 8. CONSTRUCTION INSTALLATION, MATERIALS, TESTING, AND INSPECTION SHALL COMPLY WITH APPLICABLE CODES AND ORDINANCES.
- 9. TAKE NECESSARY STEPS TO PROTECT AND MAINTAIN ALL FINISHED WORK FOR THE DURATION OF THE CONTRACT UNTIL FINAL ACCEPTANCE.
- 10. CONTRACTOR SHALL PROVIDE ALL MOCK-UPS, SUBMITTALS AND SHOP DRAWINGS FOR APPROVAL PER SPECIFICATIONS PRIOR TO CONSTRUCTION.
- 11. THE WORK OF THIS CONTRACT WILL NOT BE CONSIDERED COMPLETE UNTIL ALL AREAS HAVE BEEN CLEANED OF ALL DIRT AND DEBRIS AND ALL DAMAGED ITEMS ARE REPAIRED.
- 12. UNLESS OTHERWISE NOTED, EXISTING TREES WITHIN THE LIMIT OF WORK TO BE PROTECTED. VEHICLES, EQUIPMENT AND MATERIALS SHOULD NOT INTERFERE WITH THE LIMITS OF THE PROTECTED TREES AND REMAIN OUTSIDE OF THE DRIPLINE OR TREE PROTECTION LIMITS.
- 13. THE CONTRACTOR SHALL BE SOLELY AND COMPLETELY RESPONSIBLE FOR THE SAFETY OF ALL PERSONS AND PROPERTY DURING PERFORMANCE OF THE WORK. THE CONTRACTOR SHALL PROVIDE ALL LIGHTS, SIGNS, BARRICADES, FLAGMEN, OR OTHER DEVICES NECESSARY TO PROVIDE FOR PUBLIC SAFETY. THIS REQUIREMENT SHALL APPLY CONTINUOUSLY AND NOT BE LIMITED TO NORMAL WORKING HOURS.
- 14. THE CONTRACTOR SHALL BE RESPONSIBLE FOR THE REMOVAL AND REPLACEMENT OF ALL MATERIALS WITHIN DEDICATED RIGHT-OF-WAYS AND ALL MATERIALS AND WORKMANSHIP SHALL MEET THE ROADWAY DESIGN AND CONSTRUCTION STANDARDS OF THE APPROPRIATE GOVERNING AGENCY.
- 15. THE CONTRACTOR IS RESPONSIBLE FOR THE REPAIR, AT NO ADDITIONAL COST TO THE OWNER, FOR DAMAGE OF PROPERTY OUTSIDE OF THE LIMIT OF WORK INDICATED ON THE DRAWINGS, AND FOR ANY DAMAGE CAUSED TO SITE ELEMENTS THAT ARE TO BE PROTECTED OR REINSTALLED.
- 16. PER 5-6(C)(15)(C) ANY DAMAGE TO UTILITY LINES RESULTING FROM THE NEGLIGENCE OF THE ABUTTING PROPERTY OWNER OR THE PROPERTY OWNER'S AGENTS OR EMPLOYEES IN THE INSTALLATION AND MAINTENANCE OF ANY LANDSCAPING, SCREENING, OR BUFFERING IN A PUBLIC RIGHT-OF-WAY, PRIVATE WAY, OR EASEMENT SHALL BE THE RESPONSIBILITY OF SUCH PROPERTY OWNER. ANY DAMAGE TO UTILITY LINES RESULTING FROM THE GROWTH OF PLANT MATERIALS THAT HAVE BEEN APPROVED BY THE APPLICABLE PUBLIC UTILITY AS PART OF A PLAN FOR LANDSCAPING, SCREENING, OR BUFFERING ON THE PUBLIC RIGHT OF WAY SHALL BE THE RESPONSIBILITY OF SUCH PUBLIC UTILITY. IF A PUBLIC UTILITY DISTURBS LANDSCAPING, SCREENING, OR BUFFERING IN A PUBLIC RIGHT-OF-WAY, PRIVATE WAY, OR EASEMENT, IT SHALL MAKE EVERY REASONABLE EFFORT TO PRESERVE THE LANDSCAPING MATERIALS AND RETURN THEM TO THEIR PRIOR LOCATIONS AFTER THE UTILITY WORK. IF THE PLANT MATERIALS DIE DESPITE THOSE EFFORTS, IT IS THE OBLIGATION OF THE ABUTTING PROPERTY OWNER TO REPLACE THE PLANT MATERIALS.
- 17. PER 5-6(C)(15)(D) PROPERTY OWNERS ACKNOWLEDGE THAT APPROVED LANDSCAPING AND TREES INSTALLED AND MAINTAINED IN A PUBLIC RIGHT-OF-WAY, PRIVATE WAY, OR EASEMENT ABUTTING PRIVATE PROPERTIES ARE THE PROPERTY OF THE CITY, AND THAT THAT THE CITY RESERVES THE RIGHT TO REMOVE THEM IF NECESSARY FOR A TRANSPORTATION PROJECT WITHOUT COMPENSATION, BUT AT NO COST TO THE PROPERTY OWNER. LANDSCAPING INSTALLED IN AN ABUTTING PUBLIC RIGHT-OF-WAY, PRIVATE WAY, OR EASEMENT BY PROPERTY OWNERS AND LATER REMOVED BY THE CITY SHALL NOT IMPACT PREVIOUSLY APPROVED NET LOT AREA CALCULATIONS FOR REQUIRED LANDSCAPING.
- 18. PER 5-6(E)(2)(A) IF A WALL AT LEAST 3 FEET IN HEIGHT IS PROVIDED OR EXISTS ALONG THE PROPERTY LINE BETWEEN THE 2 PROPERTIES, 1
  TREE AT LEAST 8 FEET HIGH AT THE TIME OF PLANTING SHALL BE PROVIDED EVERY FOR 15 FEET ALONG THE WALL, WITH SPACING DESIGNED
  TO MINIMIZE SOUND AND LIGHT IMPACTS OF THE PROPOSED DEVELOPMENT ON THE ADJACENT PROPERTY.
- 19. PER 4-3(D)(1)(D) OPERATION OF POWER EQUIPMENT OR GENERATORS SHALL NOT OCCUR BETWEEN THE HOURS OF 10:00 P.M AND 7:00 A.M.
- 20. PER 4-3(D)(1)(F) A COMPOSITE SAMPLE OF THE NATIVE SOIL, CONSISTING OF NO LESS THAN 5 INDIVIDUAL SAMPLES WILL BE TESTED FOR METAL CONTENT USING THE US EPA 3050B, 3051, OR A COMPARABLE METHOD AND THAT THE METALS ARSENIC, CADMIUM, MERCURY, MOLYBDENUM, NICKEL, SELENIUM, AND ZINC ARE AT OR BELOW THE THRESHOLDS LISTED IN TABLE 4-3-1

### **PLANTING PLAN NOTES**

- 1. PER 5-6(C)(4)(H) ALL REQUIRED PLANT MATERIALS SHALL BE FREE OF DISEASE AND INSECTS AND SHALL CONFORM TO THE AMERICAN STANDARD FOR NURSERY STOCK (ASNA) OF THE AMERICAN NURSERY AND LANDSCAPE ASSOCIATION.
- 2. STAKE ALL TREES BASED ON THESE DRAWINGS. LOCATIONS OF PLANT MATERIALS TO BE APPROVED BY THE OWNER'S REPRESENTATIVE IN THE FIELD PRIOR TO INSTALLATION. THE CONTRACTOR SHALL FOLLOW THE LANDSCAPE PLAN. ANY DISCREPANCIES BETWEEN THE PLAN AND FIELD CONDITIONS SHALL BE REPORTED TO THE OWNER'S REPRESENTATIVE AND LANDSCAPE ARCHITECT BEFORE PROCEEDING WITH WORK.
- 3. NOTIFY OWNER'S REPRESENTATIVE OF ANY CONFLICTS BETWEEN UTILITIES AND PLANTINGS TO COORDINATE FIELD ADJUSTMENTS.
- 4. TREES SHALL BE A MINIMUM OF 10' FROM ALL UTILITIES, UNLESS NOTED OTHERWISE
- IF THERE IS A DISCREPANCY BETWEEN THE PLANT COUNTS ON THE CALLOUTS AND/OR SCHEDULES ON THE PLANS AND THE ACTUAL NUMBER OF PLANTS DEPICTED ON THE PLANS, THE CONTRACTOR IS RESPONSIBLE FOR INSTALLING THE ACTUAL NUMBER OF PLANTS DEPICTED ON THE DRAWINGS.
- 6. THE CONTRACTOR IS RESPONSIBLE FOR WEED CONTROL FOR ALL LANDSCAPE AREAS UNTIL FINAL PROJECT ACCEPTANCE.
- 7. FINE GRADING MUST BE APPROVED BY OWNER'S REPRESENTATIVE PRIOR TO SEEDING, SODDING, AND PLANTING.
- 8. PER 5-6(C)(6) ALL PLANT MATERIAL TO MEET THE SIZES SPECIFIED IN THE PLANT SCHEDULE.
- 9. POND STABILIZATION TO FOLLOW SECTION 1013
- 10. ALL VEGETATION SHALL MEET THE MINIMUM SIZE REQUIREMENTS IN TABLE 5-6-1 OF ALBUQUERQUE IDO.
- 11. PER 5-6(C)(9)(A) ALL PLANTING OF VEGETATED MATERIAL OR INSTALLATION OF ANY LANDSCAPING, BUFFERING, OR SCREENING MATERIAL IN THE PUBLIC RIGHT-OFWAY SHALL REQUIRE THE PRIOR APPROVAL OF THE CITY. THE PROPERTY OWNER SHALL BE RESPONSIBLE FOR THE MAINTENANCE, REPAIRS, OR LIABILITY FOR ALL THE LANDSCAPING PLACED IN OR OVER THE PUBLIC RIGHT-OF-WAY.
- 12. PER 5-6(C)(9)(B) ANY TREES THAT OVERHANG A PUBLIC SIDEWALK OR MAJOR PUBLIC OPEN SPACE SHALL BE TRIMMED TO MAINTAIN AN 8 FOOT CLEARANCE OVER THE SIDEWALK. ANY TREES THAT OVERHANG A PUBLIC STREET SHALL BE TRIMMED TO MAINTAIN A 9 FOOT CLEARANCE OVER THE STREET SURFACE.
- 13. PER 5-6(C)(9)(C), WHERE LANDSCAPING IS INSTALLED IN THE PUBLIC RIGHT-OF-WAY, THE APPLICANT SHALL INSTALL AN ADEQUATE IRRIGATION SYSTEM THAT MEETS THE MINIMUM TECHNICAL REQUIREMENTS IN ARTICLE 6-6 OF ROA 1994 (TREES, VEGETATION AND LANDSCAPING) AND THE DPM, WITH A SEPARATE METER FOR THE LANDSCAPE AREA IN THE PUBLIC RIGHT-OF-WAY, OR A SEPARATE VALVE(S) AT THE PROPERTY LINE ALLOWING ISOLATION OF THE IRRIGATION TO THE LANDSCAPE WITHIN THE PUBLIC RIGHT-OF-WAY. DRIP IRRIGATION SYSTEMS AND
- 14. PER 5-6(C)(4)(G) ALL VEGETATION SHALL COMPLY WITH ARTICLE 9-12 AND PARTS 6-1-1 AND 60602 OF ROA 1994 (POLLEN CONTROL, WATER CONSERVATION LANDSCAPING AND WATER WASTE, AND STREE TREES) AND SECTION 4 OF THE ALBUQUERQUE BERNALILLO COUNTY WATER AUTHORITY (ABCWUA) LEGISLATION AND ORDINANCE (WATER WASTE REDUCTION ORDINANCE) AS APPLICABLE
- 15. PER 5-6(C)(5)(A) ALL VEGETATED MATERIAL REQUIRED BY THIS SECTION 14-16-5-6 SHALL BE PLANTED IN UNCOMPACTED SOIL
- 16. PER 5-6(C)(5)(B) IF USED, WEED BARIER SHALL BE PERMEABLE TO OPTIMIZE STORMWATER INFILTRATION AND PREVENT RUNOFF
- 17. PER 5-6(C)(7)(A), VEGETATION REQUIRED BY THIS SECTION 14-16-5-6 SHALL BE LOCATED AT LEAST 3 FEET IN ANY DIRECTION FROM ANY FIRE HYDRANTS, VALVE VAULTS, HOSE BIBS, MANHOLES, HYDRANTS, AND FIRE DEPARTMENT CONNECTIONS. PLEASE CONFIRM COMPLIANCE WITH THIS CODE
- 18. PER 5-6(C)(5)(D), A MINIMUM OF 2 INCHES OF ORGANIC MULCH IS REQUIRED IN ALL PLANTING AREAS, WITH 3-4 INCHES RECOMMENDED.

### **LAYOUT NOTES**


- 1. CONTRACTOR TO IMMEDIATELY NOTIFY THE LANDSCAPE ARCHITECT AND PROJECT MANAGER OF ANY DISCREPANCIES BETWEEN THE SITE SURVEY AND ACTUAL SITE CONDITIONS.
- 2. ADDITIONAL LAYOUT INFORMATION MAY BE PROVIDED TO THE CONTRACTOR PRIOR TO CONSTRUCTION AS NEEDED. ELECTRONIC FILES MAY BE OBTAINED BY THE CONTRACTOR FOR LAYOUT PURPOSES.
- FINAL LOCATION OF ALL SITE FURNISHINGS, TREES & LANDSCAPE BOULDERS TO BE COORDINATED WITH LANDSCAPE ARCHITECT PRIOR TO FINAL INSTALLATION.
- 4. WRITTEN DIMENSIONS SHALL PREVAIL. DO NOT SCALE DIRECTLY FROM DRAWINGS.
- 5. ALL PAVED SURFACES SHALL HAVE SMOOTH, CONTINUOUS LINES OR CURVES AS INDICATED ON PLANS AND SHALL CONFORM TO GRADES INDICATED ON THE GRADING PLANS. ALL LINES OF PAVING TO BE PARALLEL UNLESS OTHERWISE NOTED
- 6. ALL ANGLES TO MATCH THOSE NOTED ON DRAWING
- 7. ADJUSTMENTS: IF THE CONTRACTOR BELIEVES IT IS NECESSARY TO MAKE AN ADJUSTMENT IN THE LAYOUT OF PROPOSED IMPROVEMENTS, SUCH ADJUSTMENT SHALL BE PROPOSED TO THE OWNER'S REPRESENTATIVE. NO ADJUSTMENTS WILL BE PERMITTED UNTIL IT HAS FIRST BEEN APPROVED BY THE OWNERS REPRESENTATIVE.
- 8. REFER TO CIVIL PLANS FOR ADDITIONAL SITE LAYOUT INFORMATION.

LANDSCAPE AREAS BREAKDOWN (TABLE 2)				
AREA	DESCRIPTION	PROPOSED		
PLANTING BEDS	GRAVEL/ORGANIC MULCHED AREA	12,894 SF GRAVEL, 4,292 SF ORGANIC MULCH, 17,166 SF TOTAL		
NATIVE SEED AREA	AREAS SPRAYED WITH NATIVE SEED	9,853 SF		
SEATING/GATHERING AREAS	COURTYARD, NORTH GATHERING AREA	2,182 SF		
COMMUNITY GARDEN	GARDEN, SHADED AREA	6,288 SF		


NET LOT AREA BREAKDOWN				
CALCULATION	DESCRIPTION	NET LOT AREA		
91,995 SF - 14,072 SF	AREA WITHIN PROPERTY LINE MINUS BUILDING FOOTPRINT	77,923 SF		

USABLE OPEN SPACE AREAS BREAKDOWN (TABLE 5)				
AREA	DESCRIPTION	PROPOSED		
PLANTING BEDS	GRAVEL/ORGANIC MULCHED AREA	17,166 SF		
NATIVE SEED AREA	AREAS SPRAYED WITH NATIVE SEED	9,853 SF		
SEATING/GATHERING AREAS	COURTYARD, NORTH GATHERING AREA	2,182 SF		
COMMUNITY GARDEN	GARDEN, SHADED AREA	6,288 SF		
WALKS	CONCRETE WALKS, CRUSHER FINES WALKING PATH AROUND DETENTION AREA	7,316 SF		

### **SAMPLE KEYNOTE DRAWING CALL-OUT:**

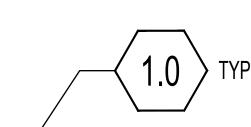

### **SITE DETAIL KEYNOTES:**

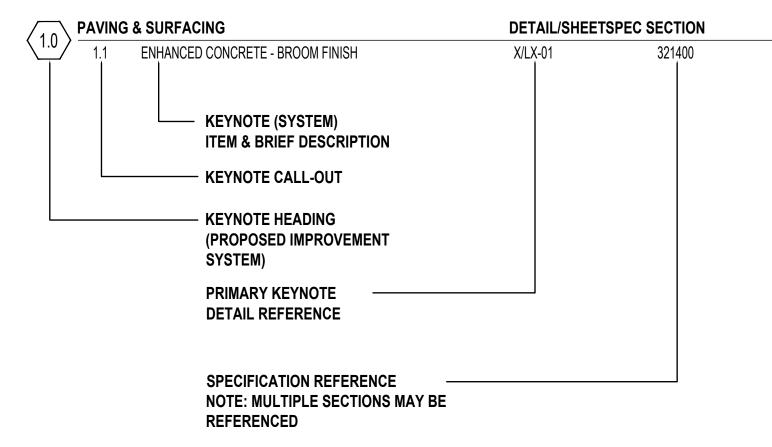


THE FOLLOWING LIST OF KEYNOTE HEADINGS (PROPOSED IMPROVEMENT SYSTEMS) HAVE BEEN INCORPORATED WITHIN THIS DRAWING SET:


- 0.0 EXISTING CONDITIONS
  1.0 PAVING & SURFACING
- 2.0 STEPS & RAMPS3.0 WALL, CURBS & EDGERS
- 4.0 RAILINGS, BARRIERS & FENCING 5.0 SITE FURNISHINGS & SIGNS
- 6.0 DRAINAGE
  7.0 SITE LIGHTING & ELECTRICAL
- 8.0 PLANTING & LANDSCAPE
- 9.0 MISCELLANEOUS

NOTE: IF A KEYNOTE HEADING IS NOT INCORPORATED IN THE PROJECT, A "NOT USED AT THIS TIME" REFERENCE HAS BEEN PROVIDED.

# SAMPLE REFERENCE NOTE DRAWING CALL-OUT:

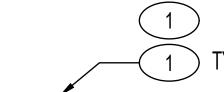

#### "X" REFERENCE NOTES

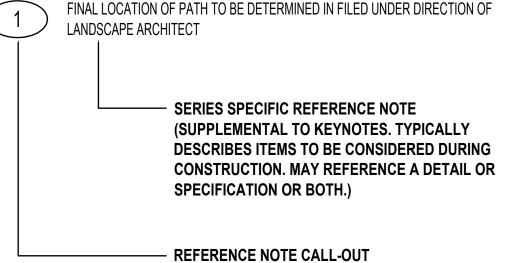

NOTE: "X" REFERS TO DRAWING SERIES (i.e. SITE DEMOLITION REFERENCE NOTES). THERE SHOULD BE SPECIFIC REFERENCE NOTES FOR EACH DRAWING SERIES. HOWEVER, SOME NOTES MAY APPEAR ON MULTIPLE SERIES.

LANDSC	APE REQUIRE	MENTS (TABLE	1)
REQUIREMENT	CALCULATION	REQUIRED	PROPOSED
25% OF NET LOT AREA SHALL BE LANDSCAPED <b>5-6(C)(2)</b>	.25 X (77,923 SF) =	22,402 SF	35,489 SF (SEE TABLE 2)
75% OF LANDSCAPED AREA TO BE COVERED WITH VEGETATION 5-6(C)(2)(c)	35,489 SF X .75 =	26,616 SF	30,147 SF
25% OF REQUIRED VEGETATION TO BE GROUND COVERS, SHRUBS, ORNAMENTAL GRASSES 5-6(C)(2)(c)	26,616 X .25 =	6,654 SF	13,882 SF
LANDSCAPE ROW-1 TREE PER 25 LF 5-6(C)(4)(i)	199LF / 25FT	8 TREES	0 TREES*
1 TREE PER GROUND FLOOR UNIT, 1 TREE PER 2ND FLOOR UNIT 4-3(B)(8)(c)	1 x 15 GROUND FLOOR UNITS 1 x 17 2ND FLOOR UNITS	32 TREES	32 TREES
AREA OF CHANGE BUFFER REQUIREMENT, 1 TREE PER 15' ALONG 6' WALL 5-6(E)(2)(a)	257 ft / 15 ft	17 TREES	17 TREES
USABLE OPEN SPACE MINIMUM TABLE 5-1-2	225 SF X 47 1BR = 285 SF X 1 2BR	10,575 SF + 285 SF =10,860 SF	42,805 SF (SEE TABLE 5)
NO MORE THAN 40% OF USABLE OPEN SPACE CAN BE PRIVATE TO A HOUSEHOLD 4-3(B)(8)(a)	.40 X 43,950 SF =	<17,580 SF PRIVATE TO HOUSEHOLD	NO OPEN SPACE IS PRIVATE TO A HOUSEHOLD
CRUSHER FINES LIMITED TO 75% OF LANDSCAPED AREA 5-6(C)(5)(C)	.75 X 35,489 SF =	<26,616 SF OF GRAVEL	12,874 SF OF GRAVEL
SEATING/GATHERING AREAS LIMITED TO $\frac{1}{3}$ OF REQUIRED LANDSCAPING 5-6(C)(3)(e)	.33 X 19,470 SF =	<6,425 SF OF GATHERING AREAS	2,182 SF OF GATHERING AREAS
COOL SEASON GRASSES RESTRICTED TO 20% OF	00 7 02 400 02	<7.097 SF OF COOL	0 SF OF COOL

|<7,097 SF OF COOL | 0 SF OF COOL

SEASON GRASSES | SEASON GRASSES

\*DUE TO WATER LINES IN THE ROW, REQUIRED ROW TREES ARE RELOCATED ELSEWHERE ON SITE

THE LANDSCAPE AREA .20 X 35,489 SF =

4-3(B)(8)(c)

COMMUNITY GARDEN REQUIREMENTS (TABLE 3)					
REQUIREMENT	CALCULATION	REQUIRED	PROPOSED		
MAX SIZE 3 ACRES 4-3(D)(1)(a)			6,288 SF = .14 ACRES		
LIMITED TO PROPOGATION AND CULTIVATION OF PLANTS 4-3(D)(1)(b)			REQUIREMENT MET		
ACCESSORY STRUCTURES SHALL BE NOT EXCEED 25% OF OF THE GARDEN AREA 4-3(D)(1)(c)	400 SF/6,288 SF = 6%	<1,572 SF	6%		


PARKING LOT LANDSCAPING REQUIREMENTS (TABLE 4)					
REQUIREMENT	CALCULATION	REQUIRED	PROPOSED		
0% OF PARKING LOT AREA LANDSCAPED 5-6-(F)(2)(a)	.10 X 36,147 SF =	3,614.7 SF	5,973 SF		
1 TREE PER 10 PARKING SPACES <b>5-6(F)(2)(c)</b>	40 SPACES/10	4 TREES	10 TREES		
NO PARKING SPACE MAY BE MORE THAN 100 FT IN ANY DIRECTION FROM A TREE TRUNK 5-6(F)(2)(c)			REQUIREMENT MET		
AT LEAST 75% OF EQUIRED TREES SHALL BE DECIDUOUS SHADE TREES 5-6(F)(2)(c)	10/10 TREES = 100%	75% DECIDUOUS SHADE TREES	100% DECIDUOUS SHADE TREES		


· · · /(-/(-/						
OUTDOOR SEATING AND GATHERING AREAS REQUIREMENTS						
(TABLE 4)						
REQUIREMENT	CALCULATION	REQUIRED	PROPOSED			
400 SF AREA PER 30,000 SF OF GROSS FLOOR AREA	GFA = 35,884, 400SF x 2	800 SF	2,182 SF			
25% OF REQUIRED SEATING/GATHERING SHADED FROM THE SUN	.25 X 800 SF	200 SF	794 SF			

99

LANDSCAPE NOTES

LS100

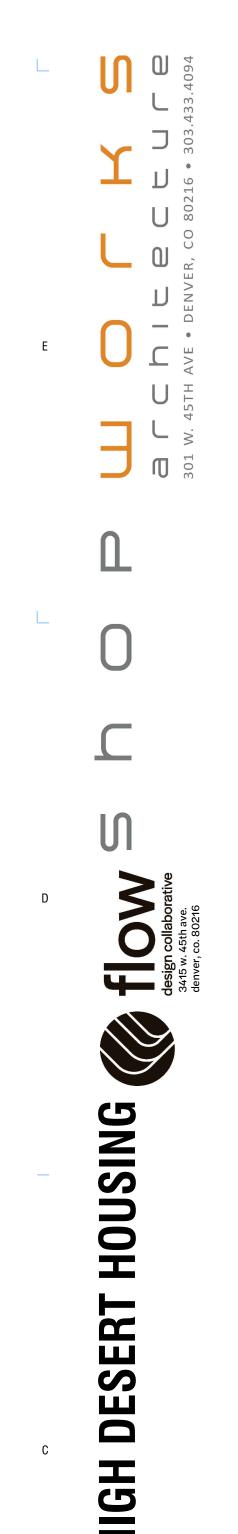

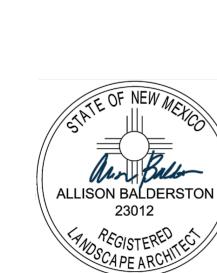

ALLISON BALDERSTO 23012

AND SCAPE ARCHITECT

MS

ROUTE 7600 CENTRA ALBUQUERQI

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REVIEWED: Approver


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PROJECT #: 21018

GILE:
GHEET TITLE:

OVERALL LANDSCAPE SITE PLAN
SCALE:

NO. LS101



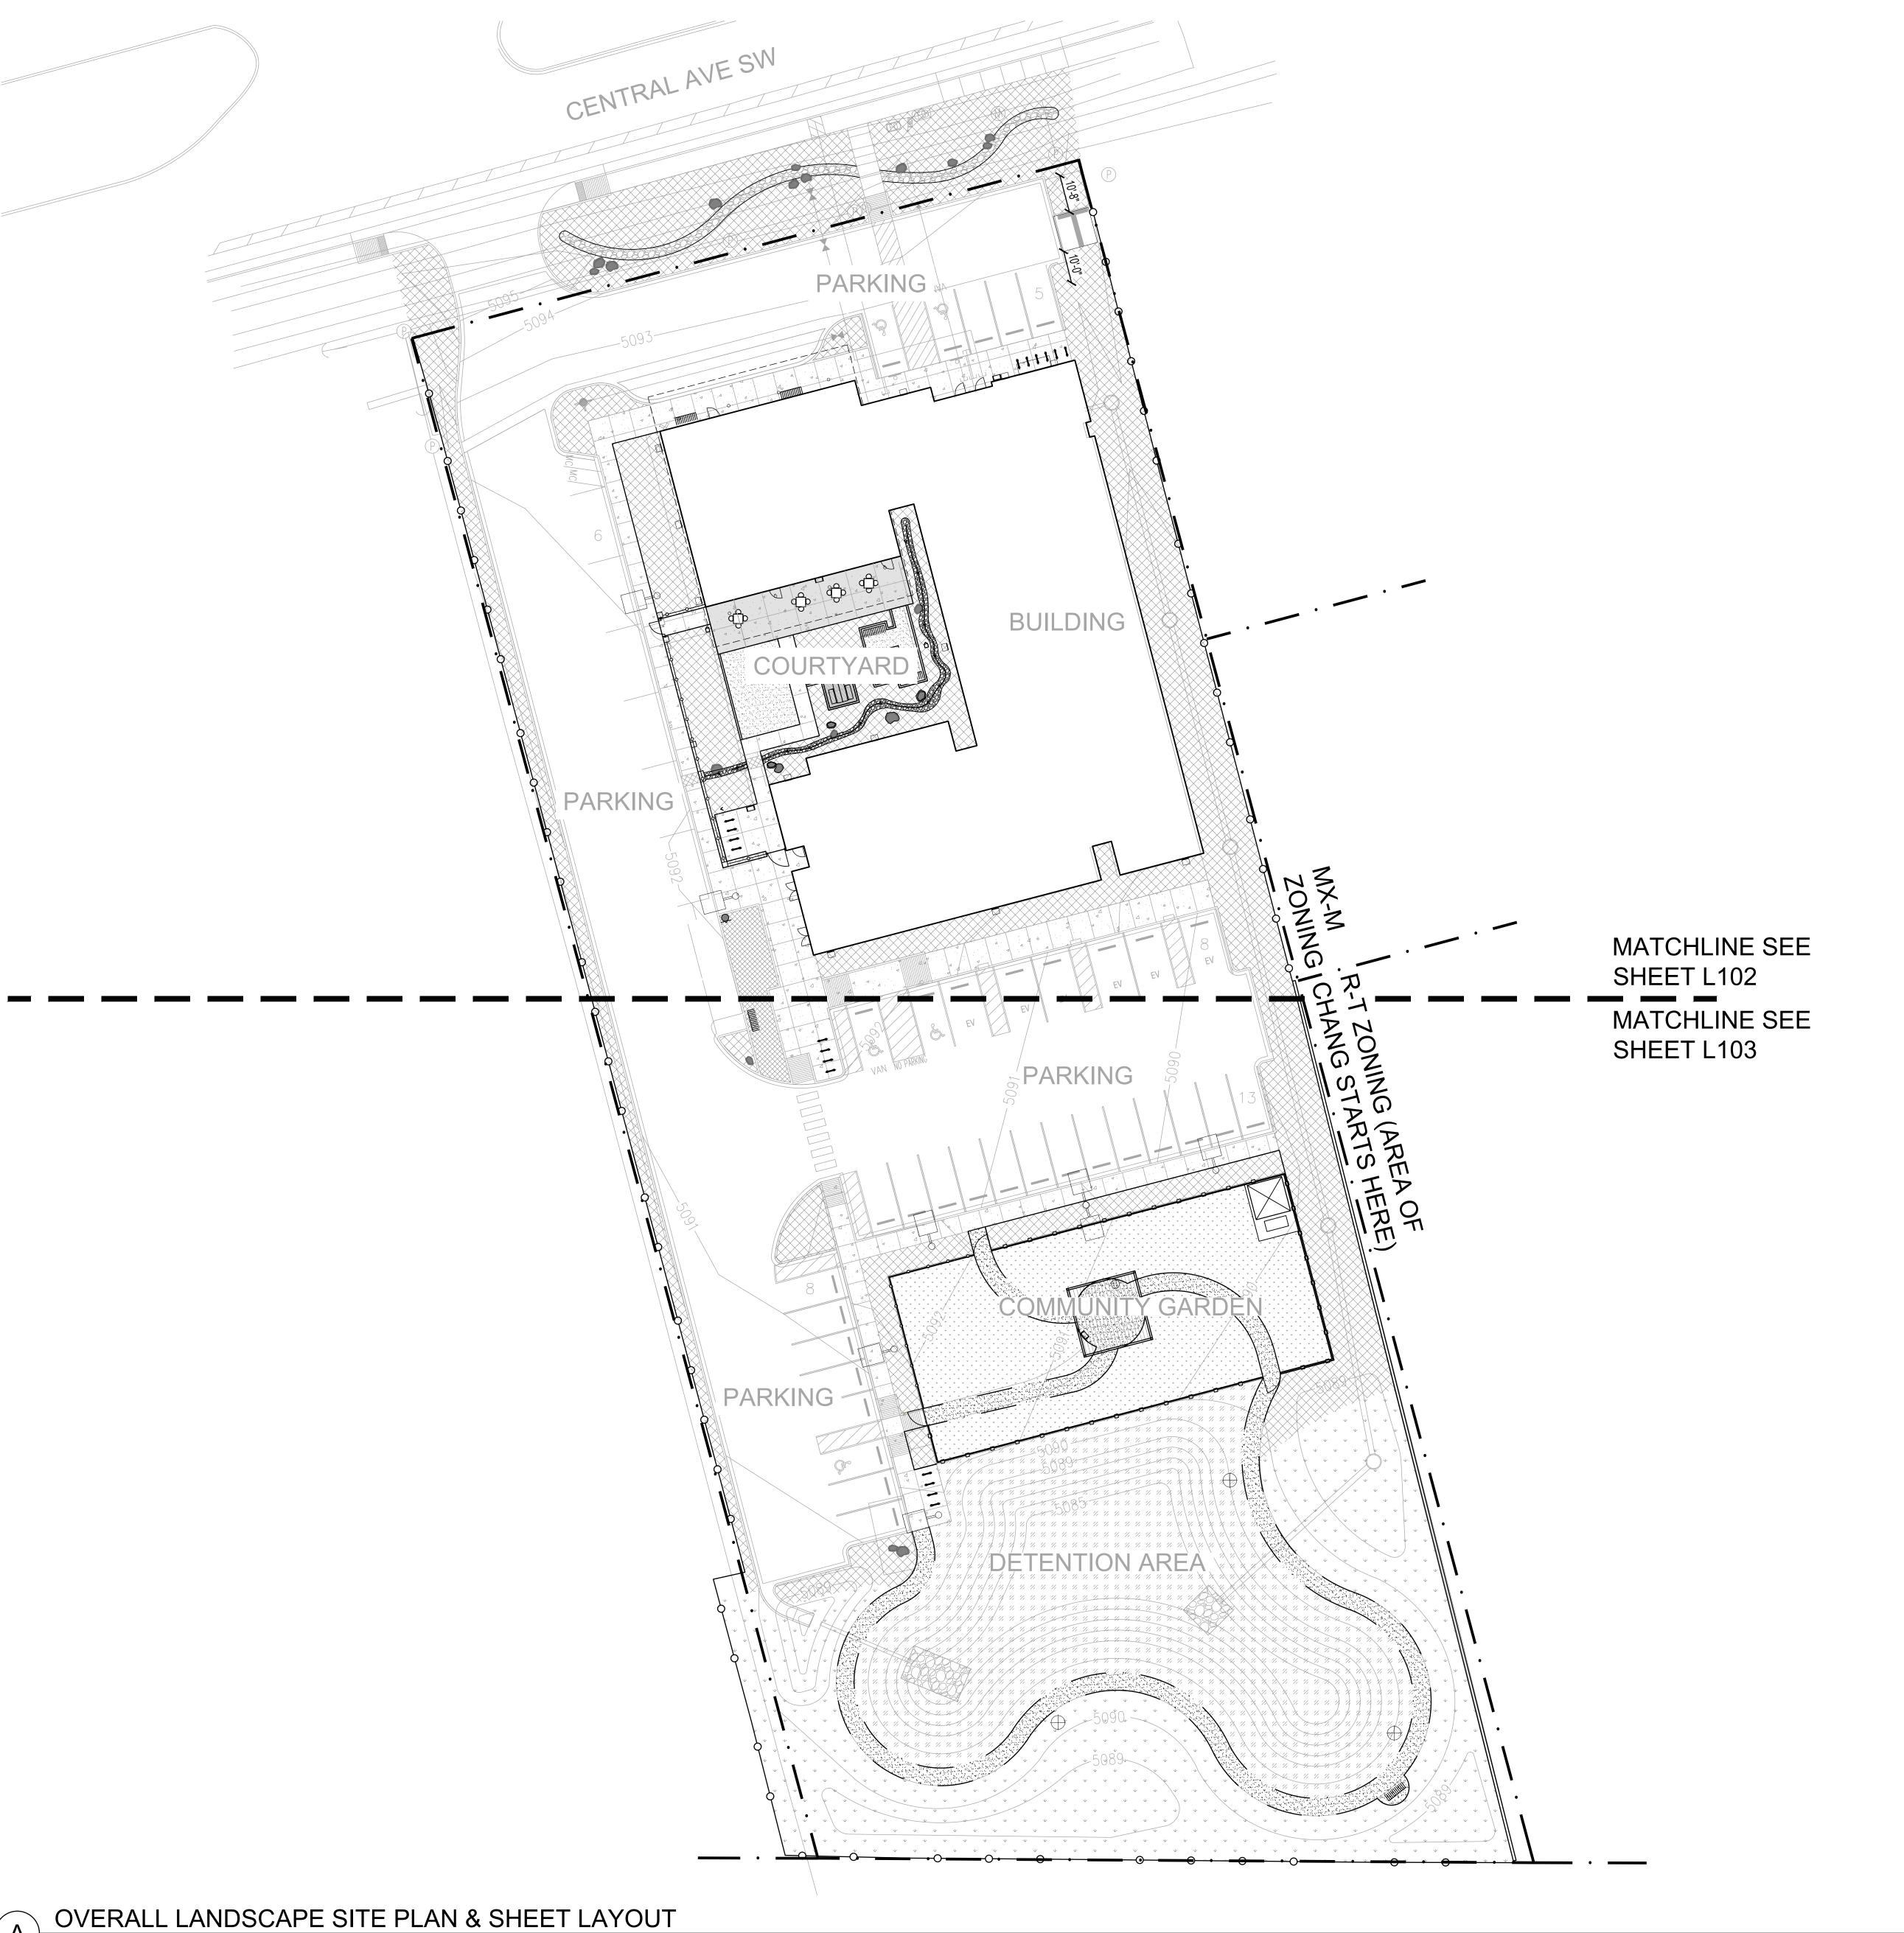














REVIEWED: Approver

FILE: SHEET TITLE:

LANDSCAPE SITE PLAN LS102

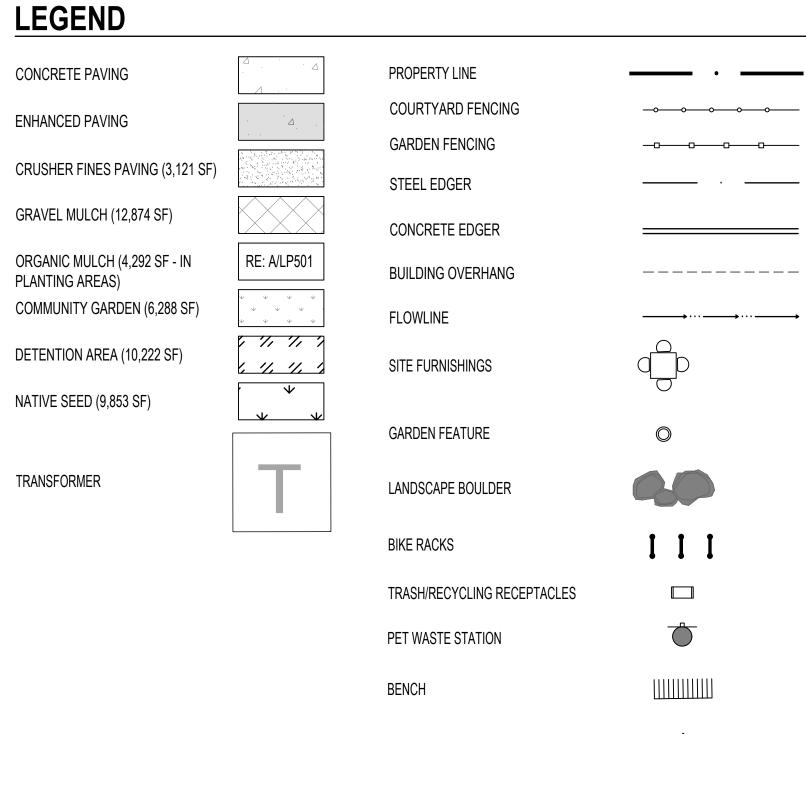

$\langle 0.0 \rangle \frac{27.05}{0.1}$	TING CONDITIONS  EXISTING FENCE	
0.1		
PΔV	ING & SURFACING	DETAIL/SHEETSPEC SECTION
$\langle 1.0 \rangle \frac{1.0}{1.0}$		RE: CIVIL
1.		A/LS501
1.2		7020001
1.3		
1.4	· · · · · · · · · · · · · · · · · · ·	
1.5		
—\ STEP	S & RAMPS	DETAIL
$\frac{2.0}{2.X}$	NOT USED	
$\overline{0}$	LS, CURBS & EDGERS	DETAIL
3.0	FLUSH CONCRETE HEADER	B/LS501
3.1	STEEL EDGER	H/LS502
RAIL	NGS, BARRIERS & FENCING	DETAIL
$0 \rightarrow \frac{10 \text{ m}}{4.0}$	COURTYARD FENCING	C/LS501
4.1	NORTHERN COURTYARD GATE	D/LS501
4.2	SOUTHERN COURTYARD GATE	E/LS501
4.3	GARDEN FENCE	C/LS502
4.4	GARDEN GATE	D/LS502
4.5	COURTYARD FENCE COLUMN	C/LS501
$\frac{1}{2}$ SITE	FURNISHINGS & SIGNS	DETAIL
$\frac{1}{5.0}$	BIKE RACK	J/LS501
5.1	LITTER & RECYCLING RECEPTACLE	
5.2	SITE FURNISHINGS	
5.3	SITE FURNISHINGS	
5.4	COURTYARD GARDEN FEATURE	
5.5	DOG WASTE STATION	
5.6	BENCH	
5.7	SHADE STRUCTURE-COMMUNITY GARDEN	B/LS502
5.8	SHADE STRUCTURE-WORK BOOTH	F/LS501
5.9		
5.10		DETAIL
$6.0$ $\frac{\text{DRA}}{6.1}$	COBBLE SWALE	G/LS501,
	LIGHTING & ELECTRICAL	DETAIL
$7.0 > \frac{3112}{7.0}$		RE: ELECTRICAL
		RE: ELECTRICAL
7.2		RE: ELECTRICAL
7.3		RE: ELECTRICAL
_\ PIΔI	NTING & LANDSCAPE	
$0 > \frac{1.271}{8.0}$	DECIDUOUS TREE IN PLANTING AREA	A/LP501
,		B/LP501
8.2		C/LP501
8.3		E/LS502
MISC	ELLANEOUS	DETAIL
9.0		PEINE


SITE DETAIL KEYNOTES: SITE PLAN

# 9.0 MISCELLANEOUS 9.X NOT USED **REFERENCE NOTES:**


- CHAISE DRAIN TO EXTEND UNDER FENCE
- COBBLE MULCH IS PURELY DECORATIVE AND NOT INTENDED TO ACT AS A SWALE
- DO NOT USE EDGER BETWEEN SQUEEGEE MULCH AND COBBLE
- CLEAR AND GRUB ENTIRE SITE RE: DEMO PLAN
- EXISTING FENCE TO REMAIN
- 7 DO NOT INSTALL LANDSCAPE FABRIC UNDER DOG RUN GRAVEL DETENTION POND TREATMENT IS TO FOLLOW CITY OF ALBUQUERQUE STANDARD SPECIFICATIONS FOR PUBLIC WORKS CONSTRUCTION SECTION 1013 AS OUTLINED IN SPEC 32990 'NATIVE SEEDING'





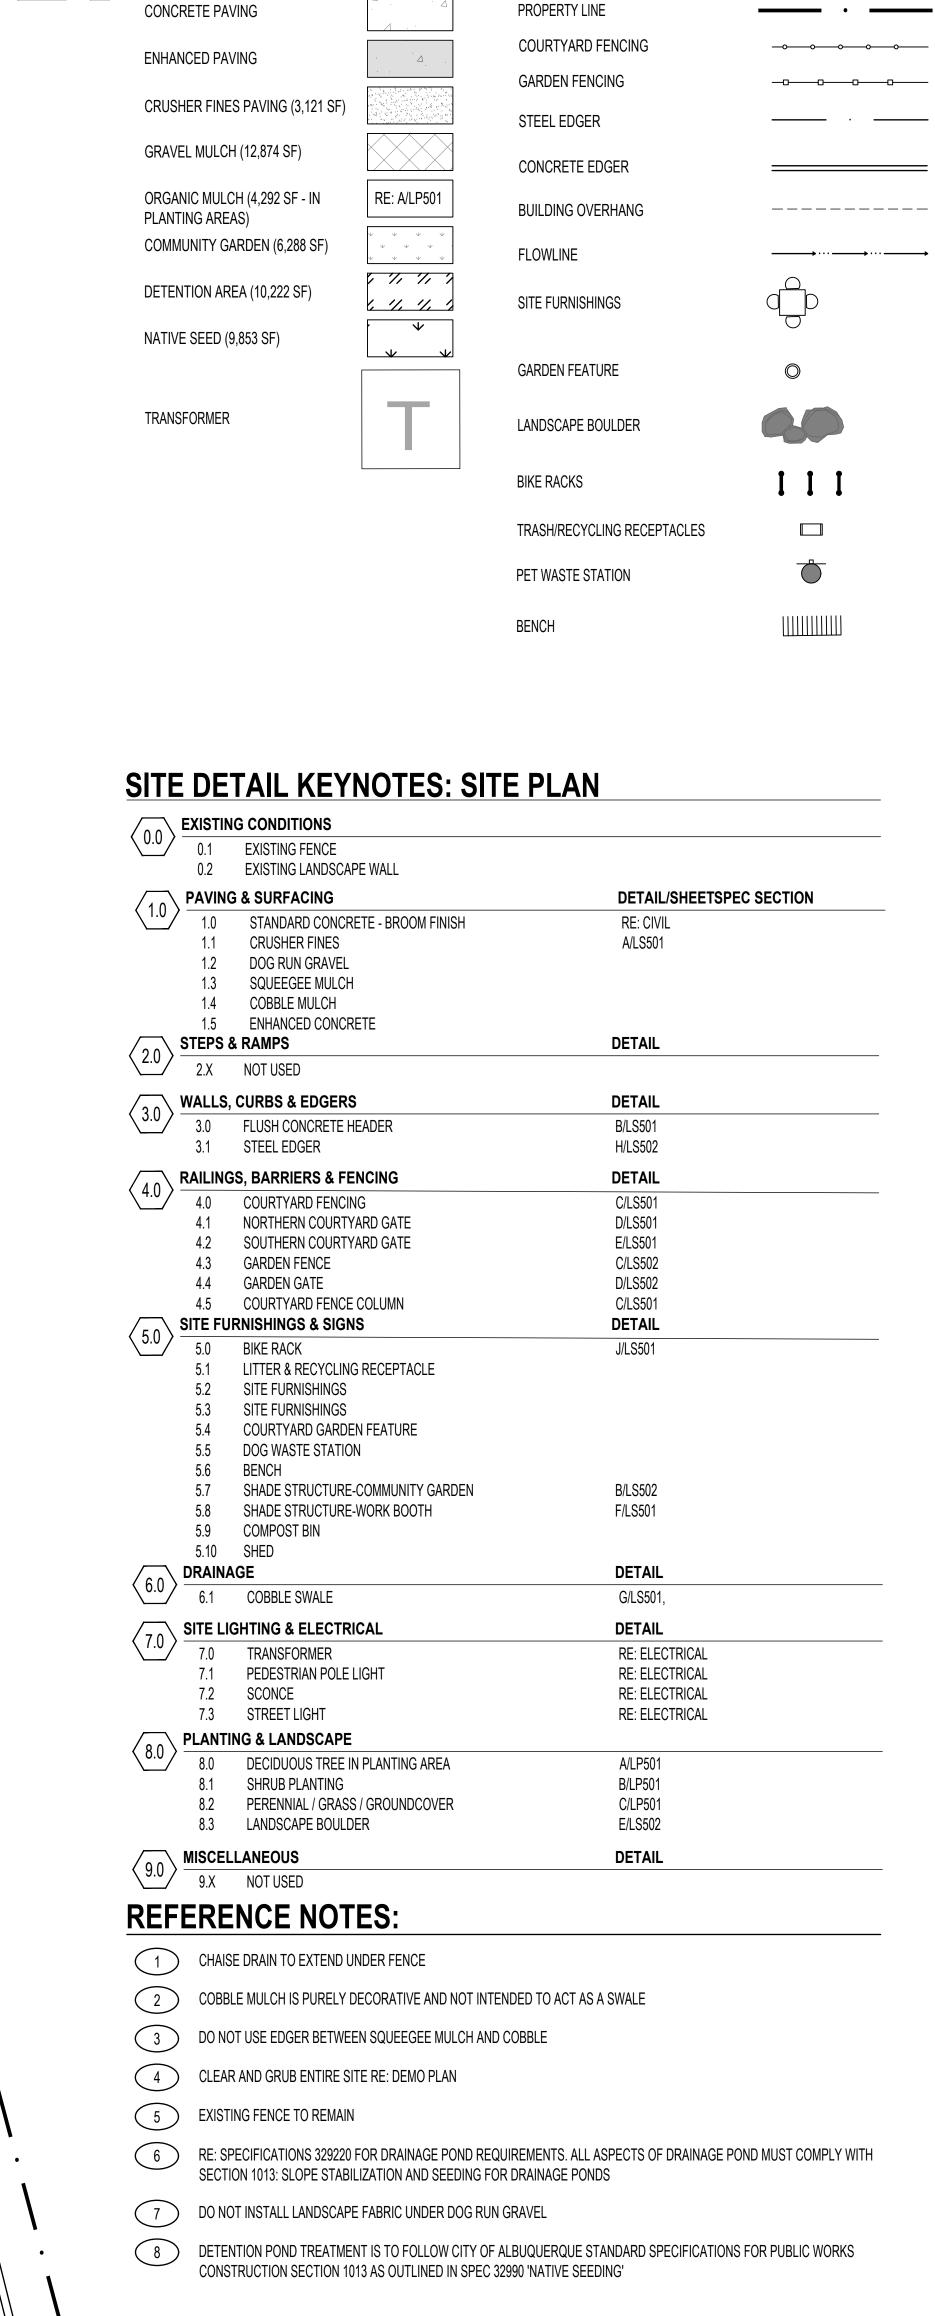


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REVIEWED: Approver

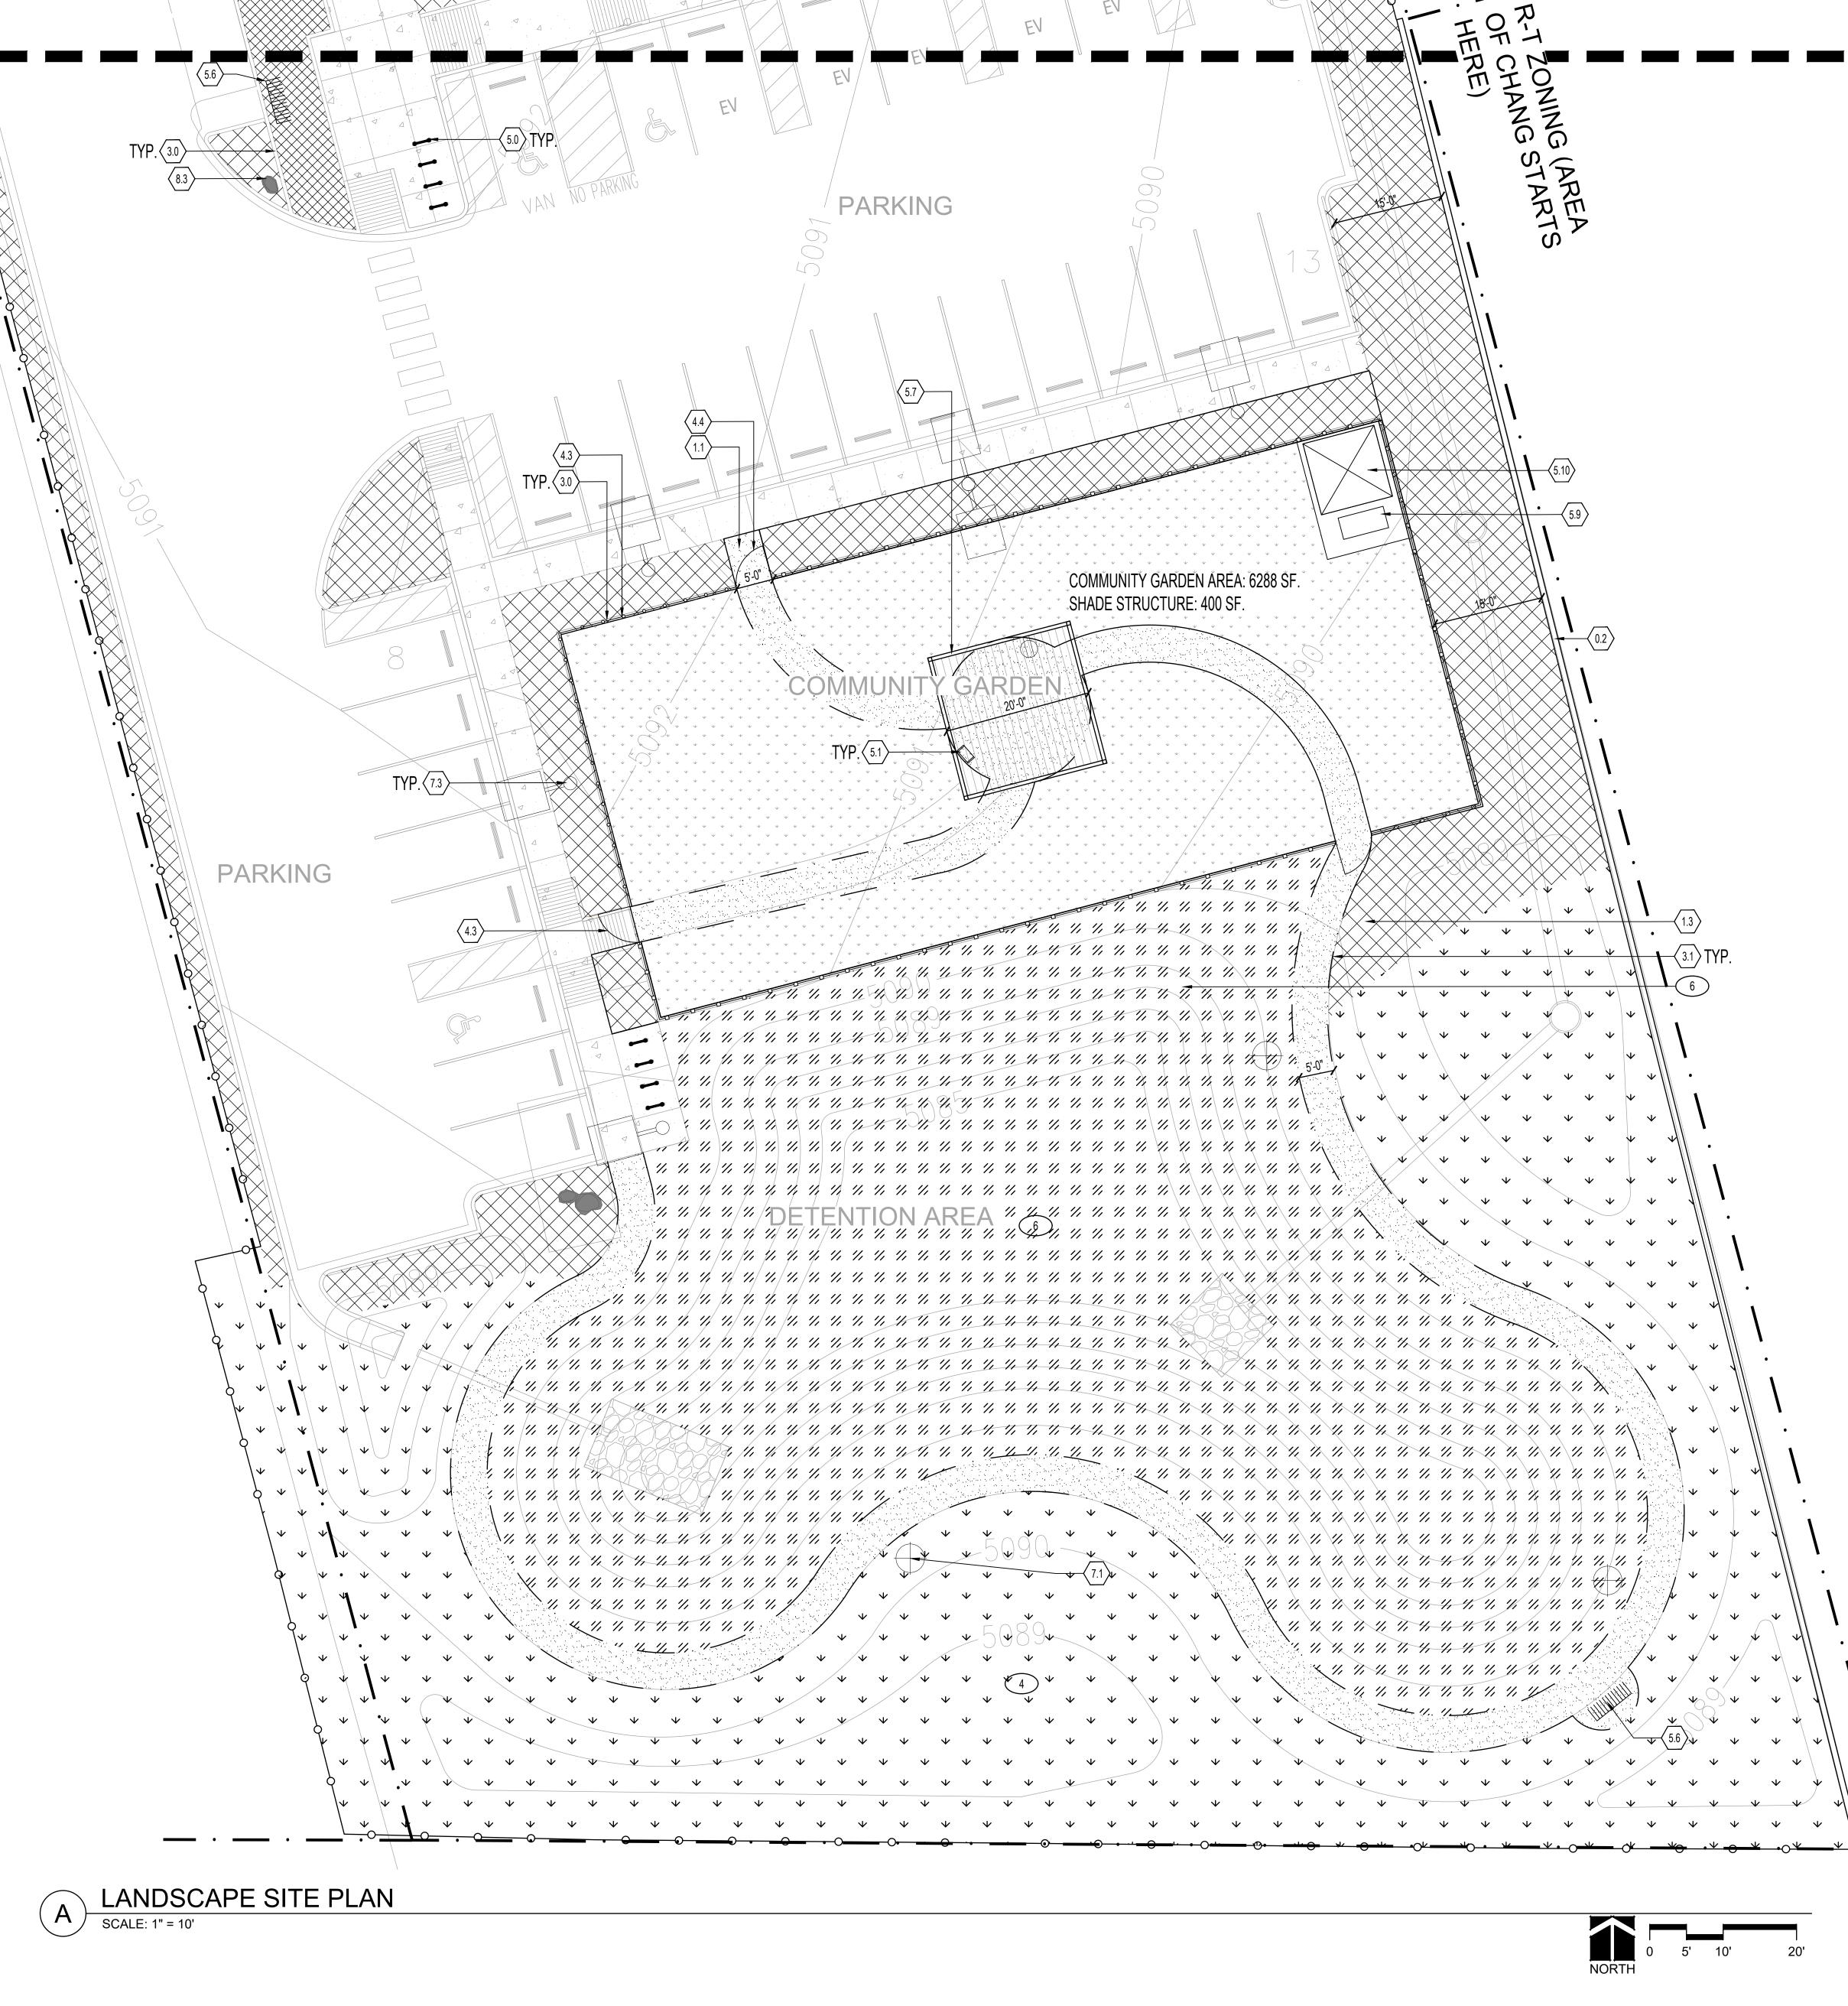SHEET TITLE: LANDSCAPE SITE PLAN

LS103



LS501

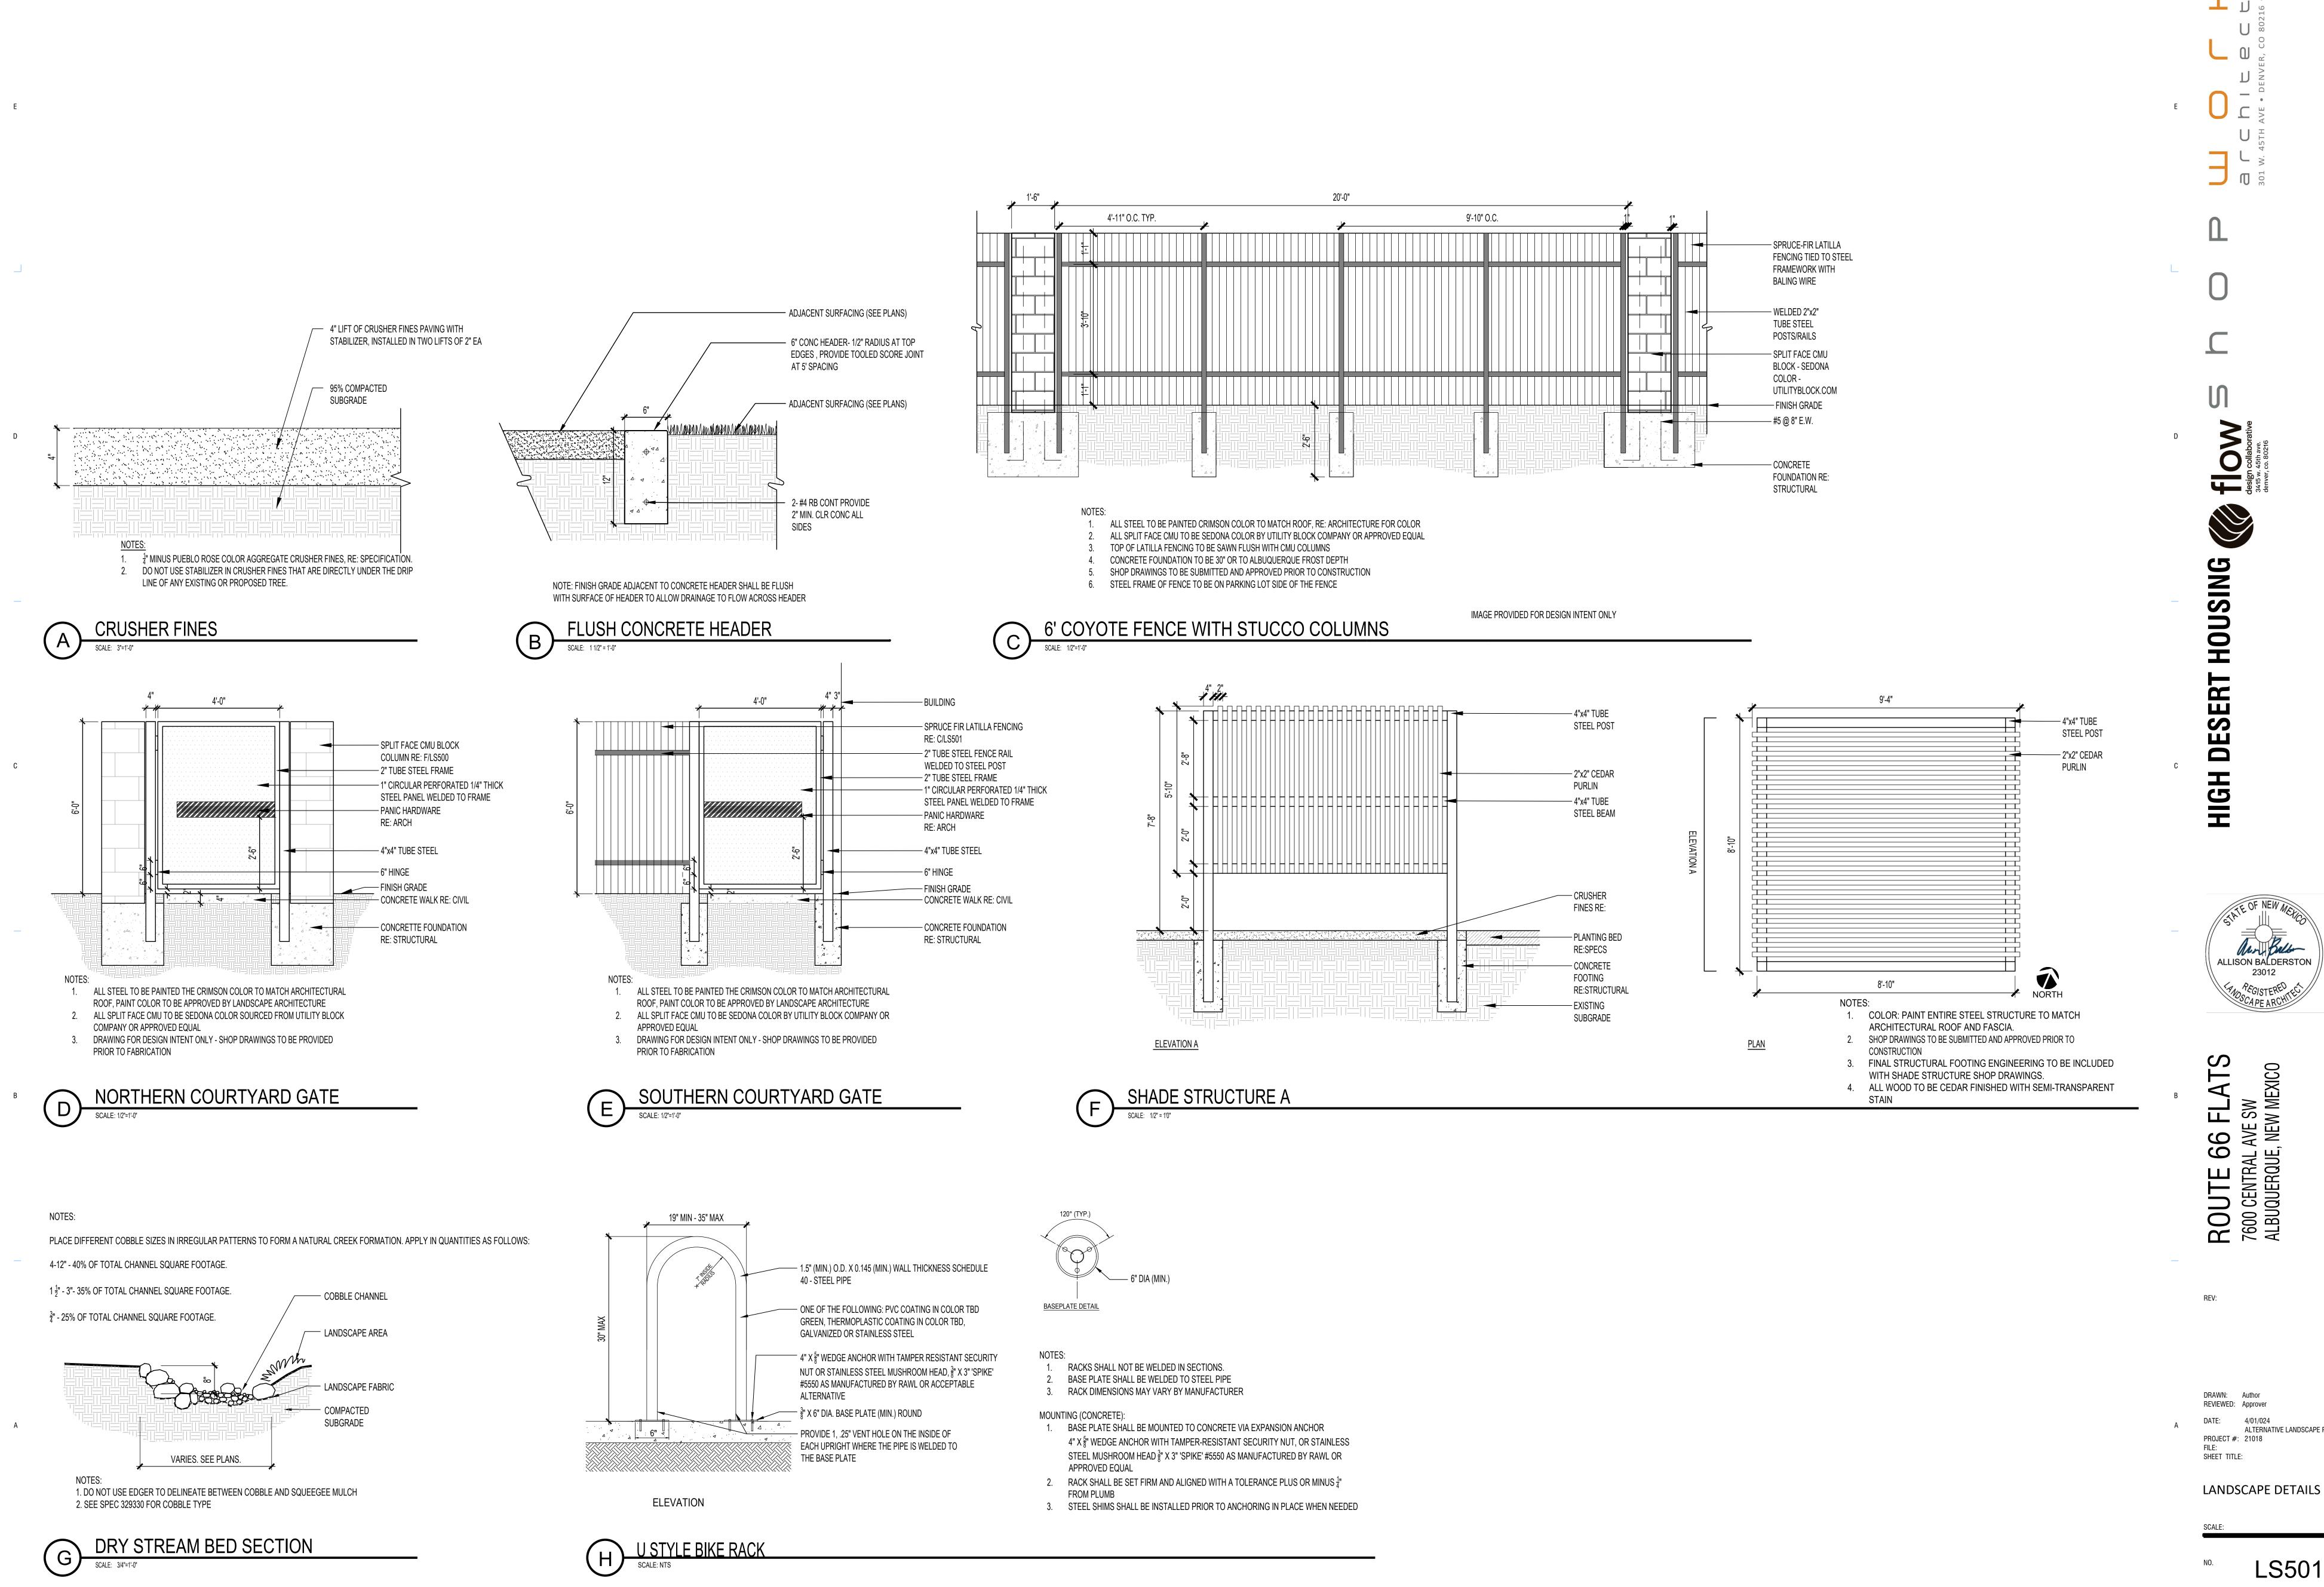ALTERNATIVE LANDSCAPE PLAN

23012


























HOU

**HIGH DESERT** 


ALLISON BALDERSTON 23012

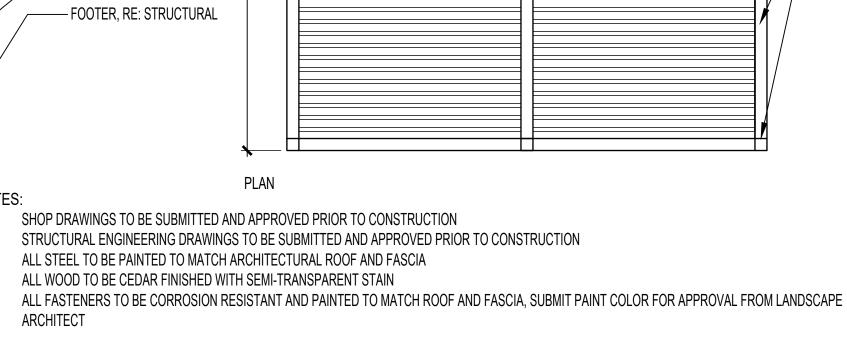

— 2X6 CEDAR RAFTER


— 6X6 TUBE STEEL POST


9'-3"

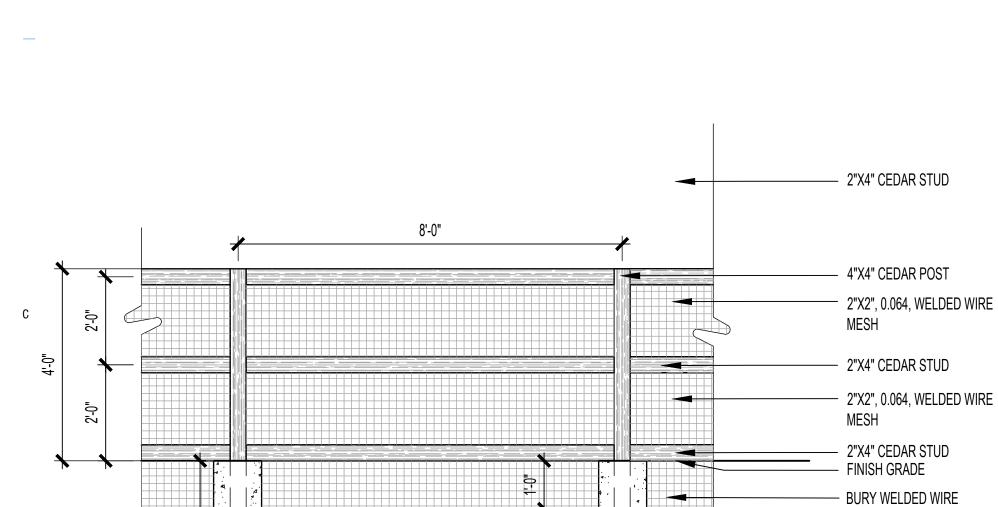

— 4" ROLL TOP STEEL LANDSCAPE EDGER 14 GAUGE MINIMUM PAINTED GREEN

- PLANTING BED OR CRUSHER FINES

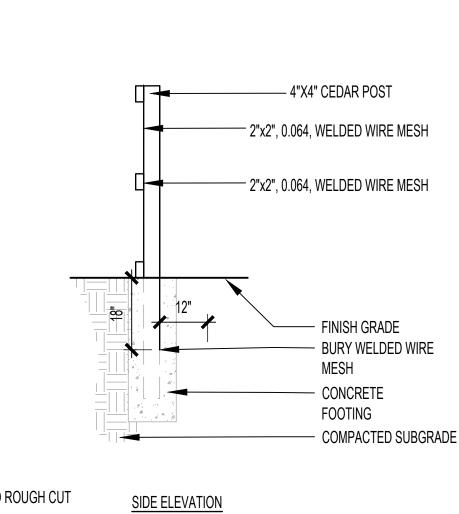

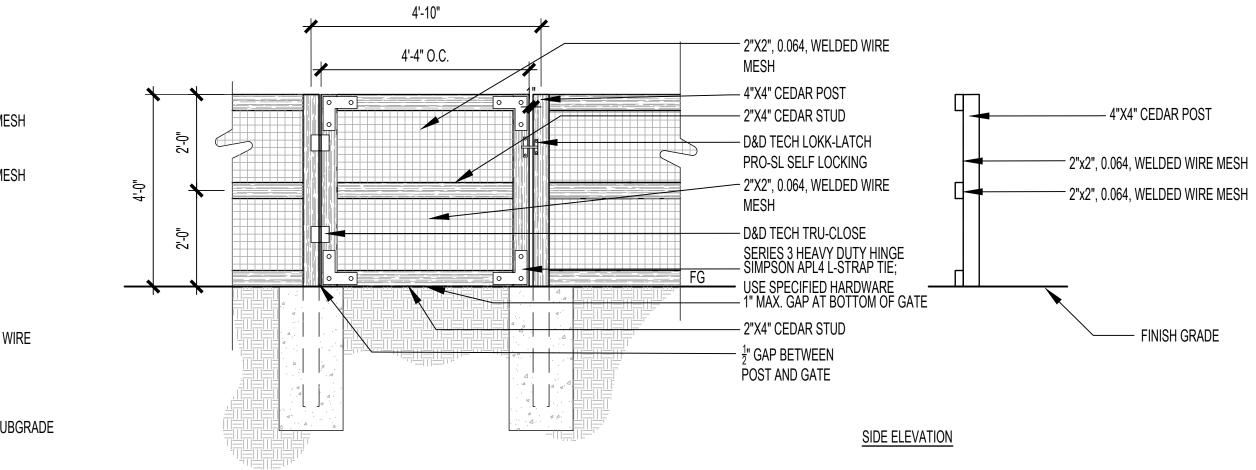

\_\_\_\_\_ 2X6 CEDAR RAFTER

----- 6X6 TUBE STEEL BEAM ----- 6X6 TUBE STEEL POST

NOTE: ALL FENCING MATERIAL TO BE STAINED ROUGH CUT CEDAR.

STAPLE MESH TO FRAME AND RAILS @ EVERY POINT OF

CONNECTION

FRONT ELEVATION GARDEN FENCING

STEEL EDGER TO BE LEVEL WITH FINISH GRADE

SCALE: 3"=1'-0"

SQUEEGEE MULCH —

NOTE: ALL FENCING MATERIAL TO BE STAINED ROUGH CUT STAPLE MESH TO FRAME AND RAILS @ EVERY POINT OF CONNECTION

MESH


- COMPACTED SUBGRADE

- CONCRETE FOOTING

FRONT ELEVATION

- SET BOULDERS IN AN BOULDER HEIGHT. BACK LESS THAN 3 1/2" AND GREATER TO FINISH GRADE OF THAN 9" VARIES-SEE PLANS ADJACENT AREA. / FINISH GRADE



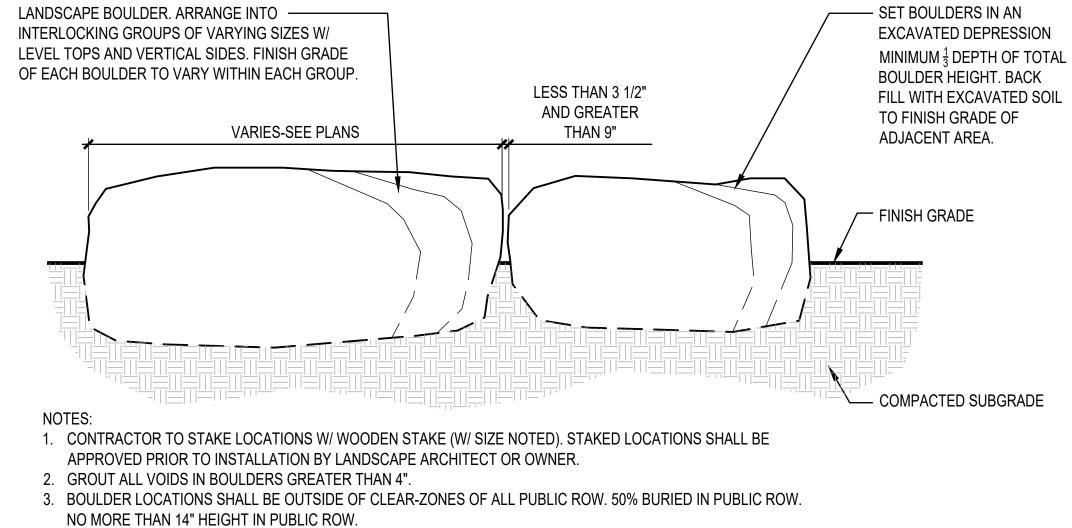

99 ROUTE 6 7600 CENTRAL A ALBUQUERQUE,

> REVIEWED: Approver ALTERNATIVE LANDSCAPE PLAN PROJECT #: 21018 SHEET TITLE:

LANDSCAPE DETAILS



































**HIGH DESERT** 


4/01/024 ALTERNATIVE LANDSCAPE PLAN


LANDSCAPE DETAILS


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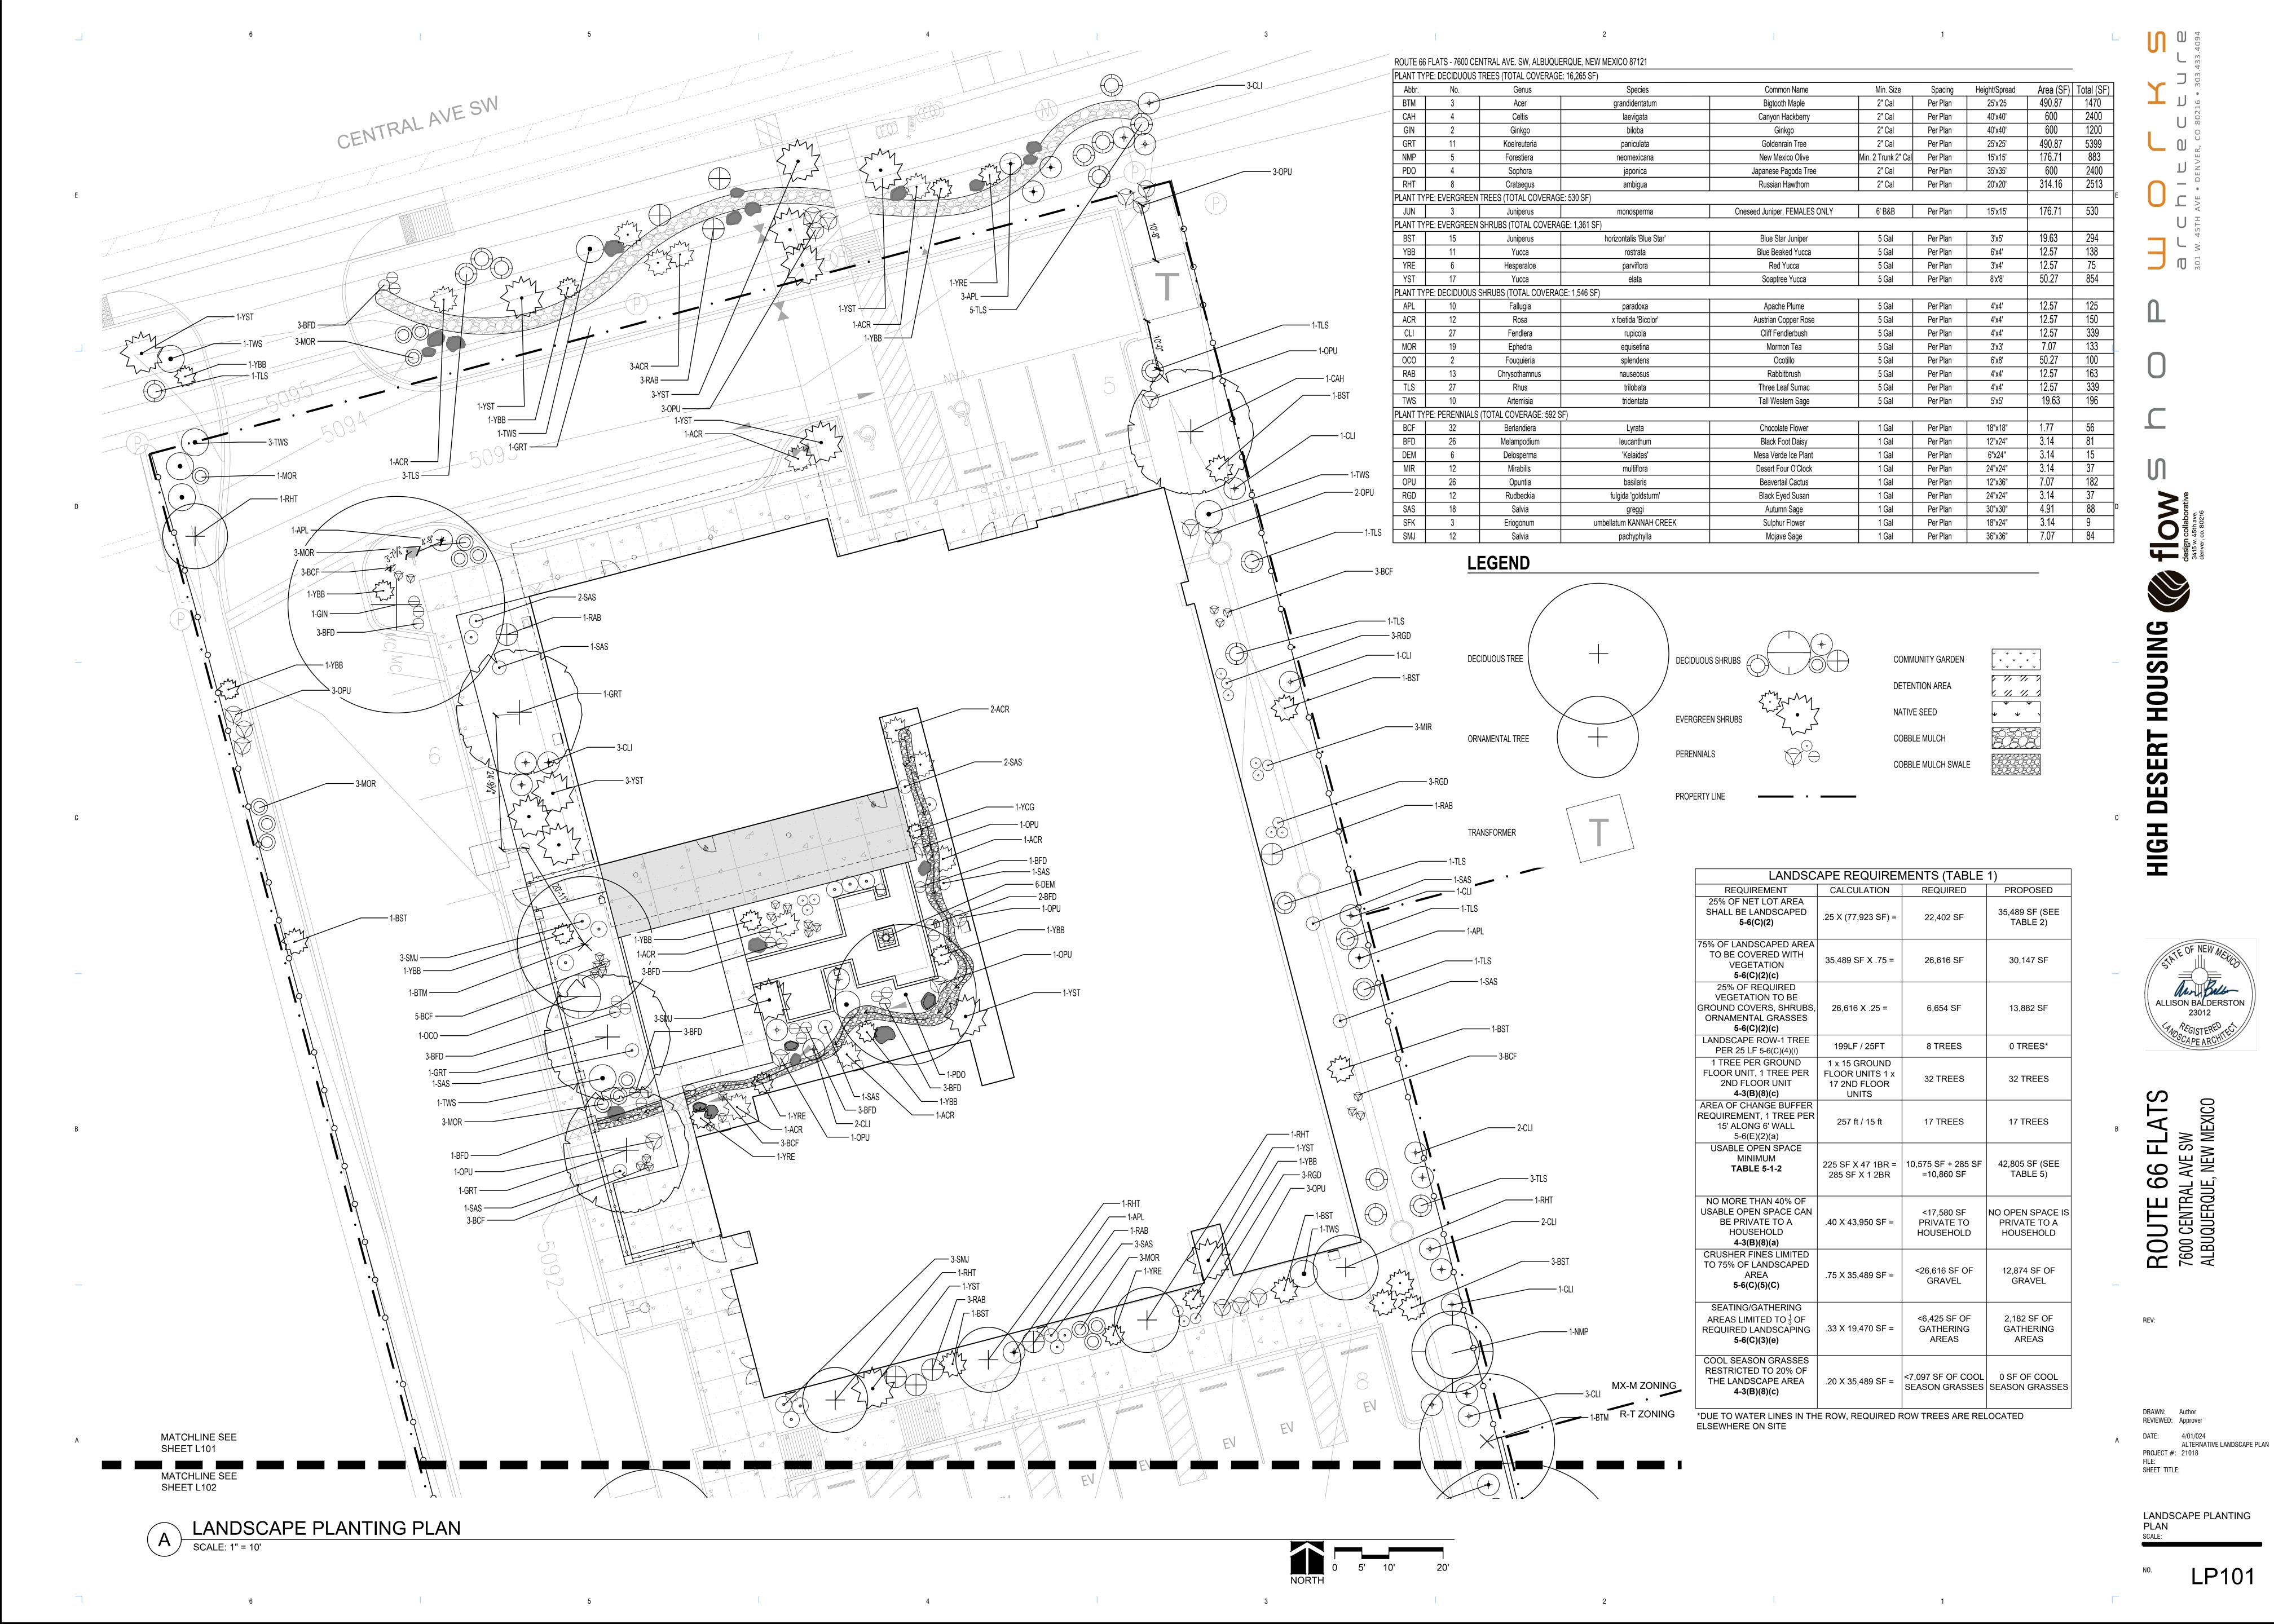








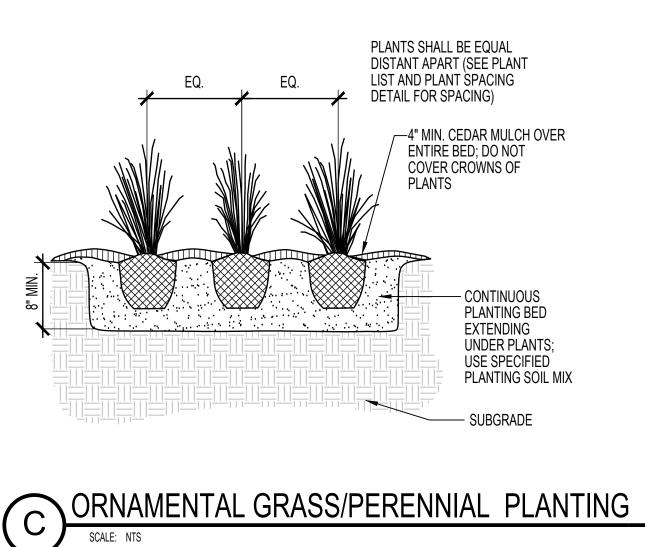

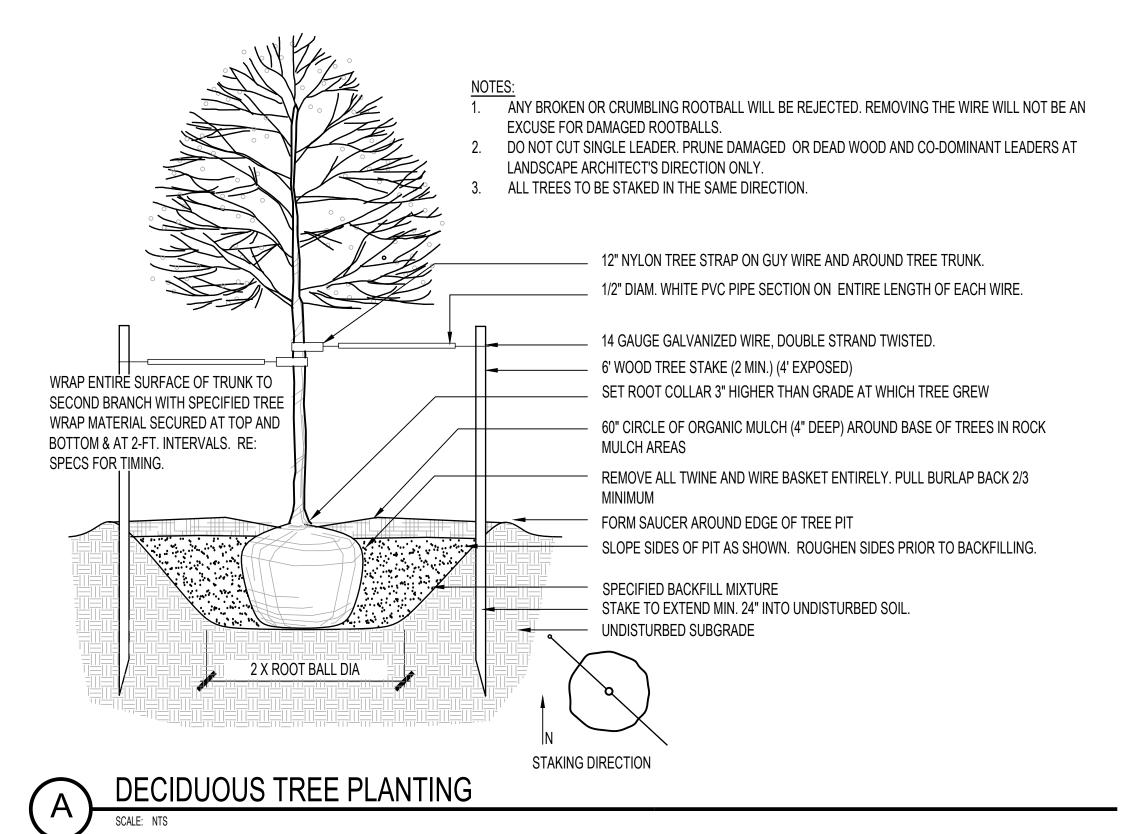

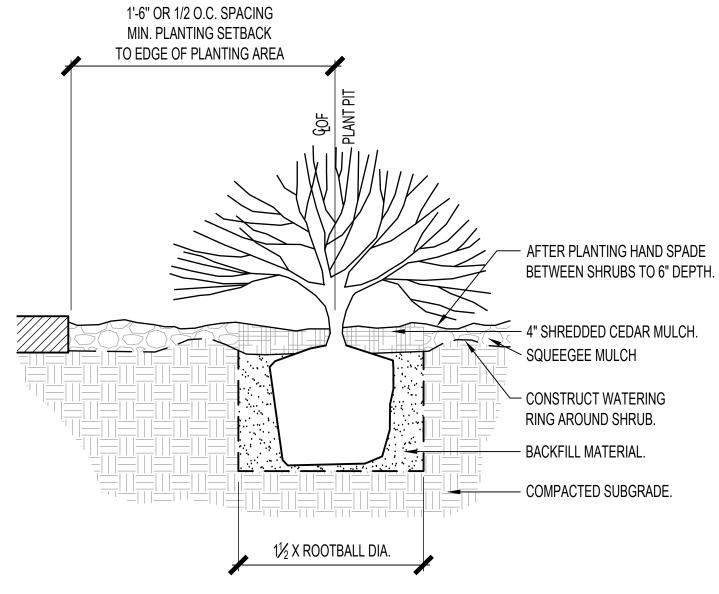

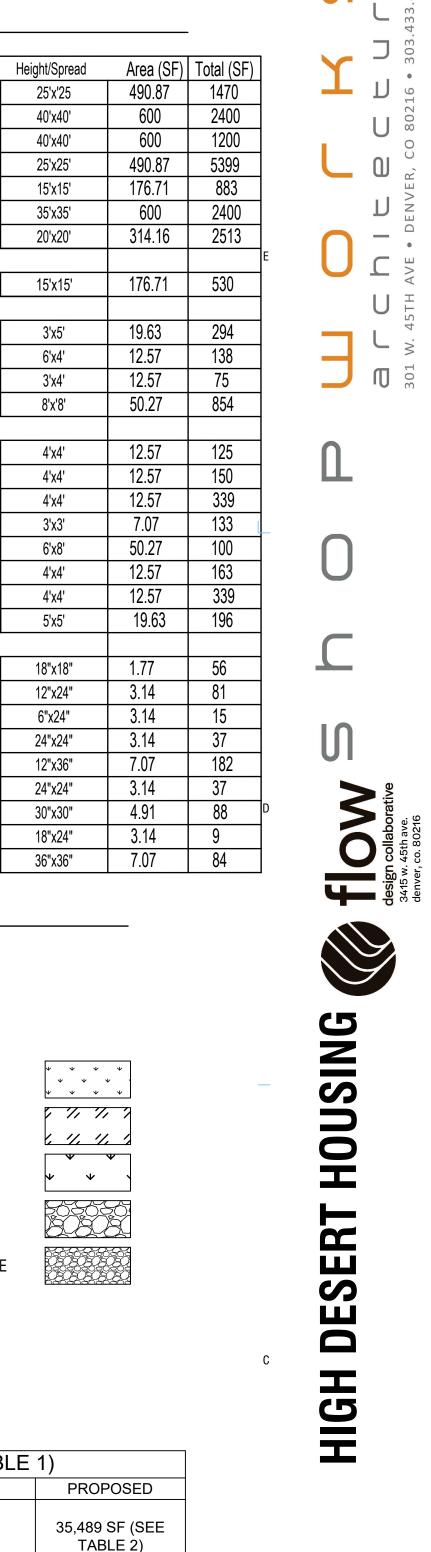

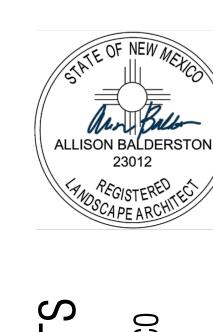




REVIEWED: Approver ALTERNATIVE LANDSCAPE PLAN PROJECT #: 21018

LP102

FILE: SHEET TITLE: LANDSCAPE PLANTING

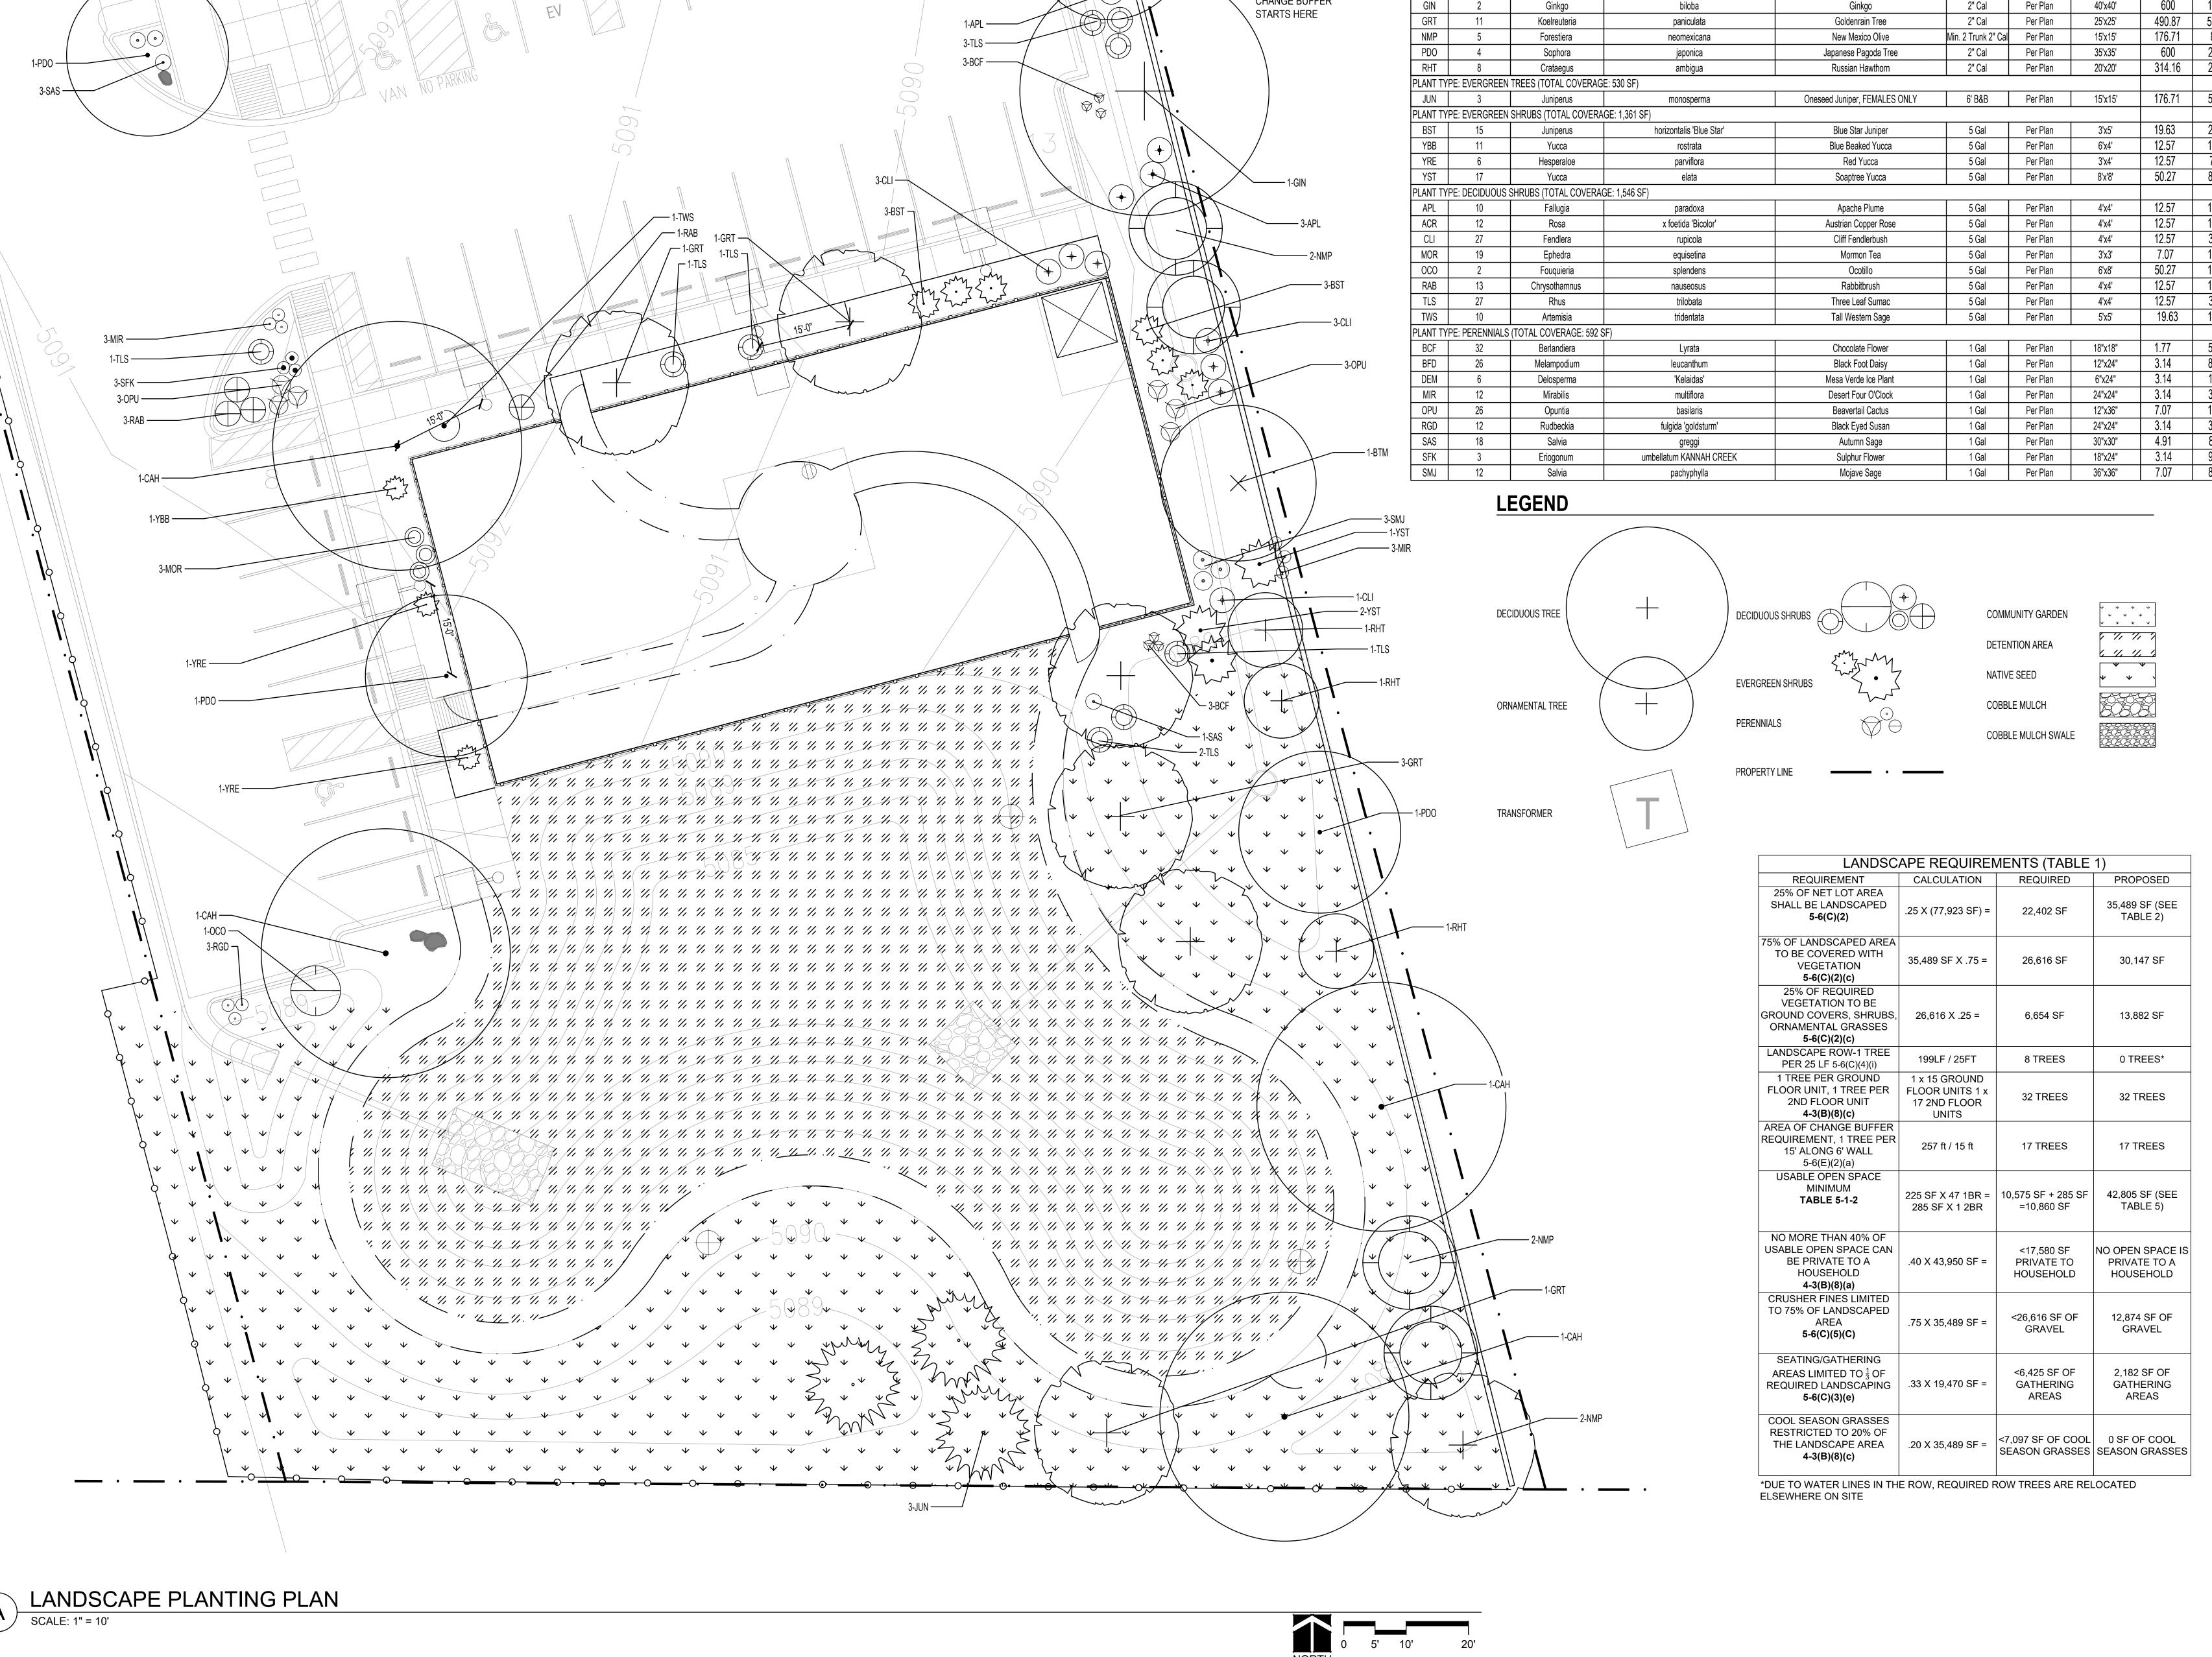

MATCHLINE SEE

SHEET L101

MATCHLINE SEE

SHEET L102

ROUTE 66 FLATS - 7600 CENTRAL AVE. SW, ALBUQUERQUE, NEW MEXICO 87121

Acer

Celtis

Species

grandidentatum

Common Name

Bigtooth Maple

Canyon Hackberry

Min. Size

2" Cal

2" Cal

Spacing

25'x'25

40'x40'

Per Plan

Per Plan

PLANT TYPE: DECIDUOUS TREES (TOTAL COVERAGE: 16,265 SF)

BTM

CAH

- R-T ZONE AREA OF

CHANGE BUFFER

### GENERAL IRRIGATION NOTES

- 1. THE IRRIGATION CONTRACTOR SHALL BECOME THOROUGHLY FAMILIAR WITH THE SPECIFICATIONS FOR THIS AND RELATED WORK PRIOR TO CONSTRUCTION.
- 2. THE CONTRACTOR SHALL PROVIDE FOR UNINTERRUPTED LANDSCAPE WATERING/IRRIGATION THROUGHOUT THE CONSTRUCTION PERIOD UNTIL SITE IS TRANSFERRED TO THE OWNER AND PER WRITTEN SPECIFICATIONS.
- 3. IF DISCREPANCIES EXIST BETWEEN THE DRAWINGS AND THE ACTUAL CONDITIONS IT IS THE CONTRACTORS RESPONSIBILITY TO NOTIFY THE LANDSCAPE ARCHITECT.
- 4. INSTALL POP-UP TYPE SPRINKLER HEADS IN LAWN AREAS SO THAT TOP OF SPRINKLER HEAD IS 1.5" AWAY FROM ADJACENT SIDEWALK OR CURB.
- 5. SET SPRINKLER HEADS PERPENDICULAR TO FINISH GRADE OF AREA TO BE IRRIGATED UNLESS OTHERWISE INDICATED ON DRAWINGS.
- 6. WHEN VERTICAL OBSTRUCTIONS (FIRE HYDRANTS, TREES, LIGHTS, ETC.) INTERFERE WITH SPRAY PATTERN OF SPRINKLER HEADS SO AS TO PREVENT PROPER COVERAGE, ADJUST SPRINKLER SYSTEM BY INSTALLING A QUARTER CIRCLE, HALF CIRCLE, OR ADJUSTABLE CIRCLE SPRINKLER HEAD ON EACH SIDE OF OBSTRUCTION SO AS TO PROVIDE PROPER COVERAGE. PERFORM ADJUSTMENTS AT NO COST TO OWNERS AUTHORIZED REPRESENTATIVE..
- 7. SPRINKLER SYSTEM DESIGN IS BASED ON MINIMUM OPERATING PRESSURE AND MAXIMUM FLOW DEMAND SHOWN ON IRRIGATION DRAWINGS AT THE PROPOSED POINT OF CONNECTION. VERIFY WATER PRESSURE PRIOR TO CONSTRUCTION. REPORT DIFFERENCES BETWEEN WATER PRESSURE INDICATED ON DRAWINGS AND ACTUAL PRESSURE READING AT IRRIGATION POINT-OF-CONNECTION TO OWNER'S AUTHORIZED REPRESENTATIVE. IN THE EVENT PRESSURE DIFFERENCES ARE NOT REPORTED PRIOR TO START OF CONSTRUCTION, CONTRACTOR ASSUMES FULL RESPONSIBILITY FOR REVISIONS.
- 8. THIS DESIGN IS DIAGRAMMATIC. PIPING, VALVES, ETC. MAY BE SHOWN WITHIN PAVED AREAS FOR DESIGN CLARIFICATION ONLY AND SHALL BE INSTALLED IN PLANTING AREAS WHERE POSSIBLE. AVOID CONFLICTS BETWEEN SPRINKLER SYSTEM, PLANTING, AND ARCHITECTURAL FEATURES. VALVE BOXES SHALL BE LOCATED TO BE AS INCONSPICUOUS AS POSSIBLE, WHILE STILL FULFILLING THE DESIGN INTENT. NO VALVE BOXES SHALL BE PLACED WITHIN PLAY FIELD AREAS.
- 9. FLUSH AND ADJUST SPRINKLER HEADS FOR OPTIMUM PERFORMANCE AND TO PREVENT OVER SPRAY ONTO WALKS, ROADWAYS, AND BUILDINGS. THIS INCLUDES SELECTING THE BEST DEGREE OF ARC TO FIT SITE CONDITIONS AND TO THROTTLE FLOW CONTROL AT EACH VALVE TO OBTAIN OPTIMUM PRESSURE FOR EACH SYSTEM.
- 10. DO NOT WILLFULLY INSTALL SPRINKLER SYSTEM AS INDICATED ON DRAWINGS WHEN IT IS OBVIOUS IN FIELD THAT OBSTRUCTIONS OR GRADE DIFFERENCES IN AREA DIMENSIONS EXIST THAT MIGHT NOT HAVE BEEN CONSIDERED DURING DESIGN. BRING SUCH OBSTRUCTIONS OR DIFFERENCES TO THE ATTENTION OF OWNER'S AUTHORIZED REPRESENTATIVE. IN EVENT THIS NOTIFICATION IS NOT PERFORMED, CONTRACTOR ASSUMES FULL RESPONSIBILITY FOR REVISIONS.
- 11. INSTALL PIPE MATERIALS AND EQUIPMENT AS SHOWN IN DETAILS. USE TEFLON TAPE ON PVC MALE PIPE THREADS ON SPRINKLER SWING JOINT AND VALVE ASSEMBLIES.
- 12. IT IS THE CONTRACTOR'S RESPONSIBILITY TO BECOME FAMILIAR WITH GRADE DIFFERENCES, LOCATION OF WALLS, RETAINING WALLS, ETC. COORDINATE WORK WITH GENERAL CONTRACTOR AND OTHER SUB-CONTRACTORS FOR LOCATION AND INSTALLATION OF PIPE SLEEVES THROUGH WALLS, UNDER ROADWAYS, PAVING, STRUCTURES, ETC.
- 13. IN ADDITION TO SLEEVES SHOWN ON THE DRAWINGS, CONTRACTOR IS RESPONSIBLE FOR THE INSTALLATION OF PIPE SLEEVING AND SEPARATE CONTROL WIRE SLEEVES OF SUFFICIENT SIZE UNDER PAVED AREAS.
- 14. THE FOLLOWING SHOULD BE NOTED REGARDING PIPE SIZING: IF A SECTION OF UN-SIZED LATERAL IS LOCATED BETWEEN TWO IDENTICALLY SIZED SECTIONS THE UN-SIZED SECTION SHALL BE OF THE SAME SIZE. IN NO CASE SHALL A SECTION OF PIPE BE SMALLER THAN ANY DOWNSTREAM SECTION LOCATED ON THE SAME LATERAL
- 15. PER 5-6(C)(14)(A) IRRIGATION SYSTEMS SHALL COMPLY WITH SECTION 8 OF THE ABCWUA LEGISLATION AND ORDINANCES (CROSS CONNECTION PREVENTION AND CONTROL ORDINANCE).
- 16. PER 5-6(C)(14)(B) ALL IRRIGATION SYSTEMS SHALL BE DESIGNED TO MINIMIZE THE USE OF WATER.
- 17. PER 5-6(C)(14)(C) ALL NON-RESIDENTIAL LANDSCAPE IRRIGATION SHALL HAVE AUTOMATIC TIMERS AND/OR PROGRAMMABLE SETTINGS TO AVOID OVERWATERING.
- 18. PER 5-6(C)(14)(D) THE IRRIGATION SYSTEM SHALL NOT SPRAY OR IRRIGATE IMPERVIOUS SURFACES, INCLUDING SIDEWALKS, DRIVEWAYS, DRIVE AISLES, STREETS, AND PARKING AND LOADING AREAS.
- 19. PER 5-6(C)(15)(C) ANY DAMAGE TO UTILITY LINES RESULTING FROM THE NEGLIGENCE OF THE ABUTTING PROPERTY OWNER OR THE PROPERTY OWNER'S AGENTS OR EMPLOYEES IN THE INSTALLATION AND MAINTENANCE OF ANY LANDSCAPING, SCREENING, OR BUFFERING IN A PUBLIC RIGHT-OF-WAY, PRIVATE WAY, OR EASEMENT SHALL BE THE RESPONSIBILITY OF SUCH PROPERTY OWNER. ANY DAMAGE TO UTILITY LINES RESULTING FROM THE GROWTH OF PLANT MATERIALS THAT HAVE BEEN APPROVED BY THE APPLICABLE PUBLIC UTILITY AS PART OF A PLAN FOR LANDSCAPING, SCREENING, OR BUFFERING ON THE PUBLIC RIGHT-OF-WAY, SHALL BE THE RESPONSIBILITY OF SUCH PUBLIC UTILITY. IF A PUBLIC UTILITY DISTURBS LANDSCAPING, SCREENING, OR BUFFERING IN A PUBLIC RIGHT-OF-WAY, PRIVATE WAY, OR EASEMENT, IT SHALL MAKE EVERY REASONABLE EFFORT TO PRESERVE THE LANDSCAPING MATERIALS AND RETURN THEM TO THEIR PRIOR LOCATIONS AFTER THE UTILITY WORK. IF THE PLANT MATERIALS DIE DESPITE THOSE EFFORTS, IT IS THE OBLIGATION OF THE ABUTTING PROPERTY OWNER TO REPLACE THE PLANT MATERIALS.
- 20. PER 5-6(C)(15)(D) PROPERTY OWNERS ACKNOWLEDGE THAT APPROVED LANDSCAPING AND TREES INSTALLED AND MAINTAINED IN A PUBLIC RIGHT-OF-WAY, PRIVATE WAY, OR EASEMENT ABUTTING PRIVATE PROPERTIES ARE THE PROPERTY OF THE CITY, AND THAT THAT THE CITY RESERVES THE RIGHT TO REMOVE THEM IF NECESSARY FOR A TRANSPORTATION PROJECT WITHOUT COMPENSATION, BUT AT NO COST TO THE PROPERTY OWNER. LANDSCAPING INSTALLED IN AN ABUTTING PUBLIC RIGHT-OF-WAY, PRIVATE WAY, OR EASEMENT BY PROPERTY OWNERS AND LATER REMOVED BY THE CITY SHALL NOT IMPACT PREVIOUSLY APPROVED NET LOT AREA CALCULATIONS FOR REQUIRED LANDSCAPING.

# PLANTING IRRIGATION NOTES

- 1. PROVIDE PIPE AND SPACING PER SCHEDULE TO ALL PLANT MATERIAL SERVED BY DRIP LINE IRRIGATION SYSTEM.
- 2. DRIPPERLINE IS INTENDED TO IRRIGATE PLANT MATERIAL BY PLANT TYPE IN ORDER TO APPLY APPROPRIATE AMOUNTS OF WATER AS NEEDED FOR PROPER PLANT GROWTH AND PLANT CARE. EXCEPTIONS TO PLANT MATERIAL SYSTEM SEPARATIONS ARE NOTED WITH VALVE CALLOUTS ON PLAN. ADJUSTMENTS MAY BE NECESSARY AS PLANT MATERIAL ESTABLISHES.
- 3. IRRIGATION AREAS ARE SHOWN DIAGRAMMATIC FOR CLARITY. INSTALL ALL PIPING IN LANDSCAPE PLANTING AREAS.
- 4. INSTALL SUPPLY LATERAL WITHIN PVC SLEEVE WHEN ROUTING THROUGH PAVED SURFACES OR THROUGH PLANTER'S WALLS.
- 5. PROVIDE ONE (1) FLUSH-VALVE ASSEMBLY AT EACH END OF DRIP SYSTEM OR AS SHOWN ON DETAILS. LOCATE FLUSH-VALVE ASSEMBLY BOXES ADJACENT TO PLANTING BORDERS OR PAVING EDGES FOR MAINTENANCE CONVENIENCE.
- 6. EACH EMITTER SHALL HAVE THE ABILITY TO INDEPENDENTLY REGULATE DISCHARGE RATES, WITH AN INLET PRESSURE RANGE OF 14.5 58 POUNDS PER SQUARE INCH (PSI), AT A CONSTANT FLOW AND WITH A MANUFACTURER'S COEFFICIENT OF VARIABILITY (CV) OF 0.03 OR LESS.

### LANDSCAPE IRRIGATION NARRATIVE


- 1. PLANT MATERIAL WILL BE GROUPED INTO LATERAL ZONES BASED ON SIMILAR WATER REQUIREMENTS TO REDUCE OVERALL WATER CONSUMPTION WHILE ALLOWING PLANTS TO SUSTAIN HEALTHY, VIGOROUS GROWTH.
- 2. TURF AREAS WILL BE IRRIGATED USING 6" POP-UP ROTATOR TYPE SPRINKLER HEADS.
- 3. ALL AREAS LOCATED OFF-SITE DISTURBED THROUGH PROJECT INFRASTRUCTURE CONSTRUCTION ARE TO BE RE-SEEDED. ALL RE-SEEDED AREAS TO BE IRRIGATED BY WATER TRUCK OR OTHER MEANS OF SUPPLEMENTAL WATERING UNTIL FINAL ESTABLISHMENT.

### EQUIPMENT SCHEDULE

SYMBOL	DESCRIPTION
	SLEEVING: CLASS 200 PVC PROVIDE SEPARATE 2" MIN. SLEEVE FOR WIRING
	MAINLINE PIPE: CLASS 200 BE PVC - 1.5"
	· - DRIPPER LINE SUPPLY LATERAL PIPE: CLASS 200 BE PVC (1-INCH UNLESS OTHERWISE INDICATED)
	UNCONNECTED PIPE CROSSING
BF	BACKFLOW DEVICE RE:PLUMBIING
D	DRAIN VALVE
H	FROST FREE GARDEN HYDRANT
	ISOLATION GATE VALVE ASSEMBLY
Q	QUICK COUPLING VALVE ASSEMBLY
•	REMOTE CONTROL VALVE ASSEMBLY FOR SPRINKLER LATERALS (RAIN BIRD PESB-R - SIZED AS INDICATED)
	REMOTE CONTROL VALVE ASSEMBLY FOR DRIPPER LINE LATERALS (RAIN BIRD XCZ-100-PBR-LC) DRIP SUPPLY LATERAL
	PLANT IRRIGATION RING: SIZED PER PLANT NETAFIM TECHLINE CV - TLHCVXR-RW11-12
$\langle A \rangle$	IRRIGATION CONTROLLER: RAIN BIRD ESP-ME3
A 12 1.5 55	INDICATES CONTROLLER AND CONTROLLER STATION NUMBER INDICATES LATERAL DISCHARGE IN GPM OR DRIP INDICATES REMOTE CONTROL VALVE SIZE IN INCHES
WS	WEATHER SENSOR: RAIN BIRD WR-2 RAIN FREEZE

# PIPE SCHEDULE

MAXIMUM FLOW RATE - PVC PLASTIC PIPE
PIPE SIZE MAXIMUM FLOW (GPM)
1" 16

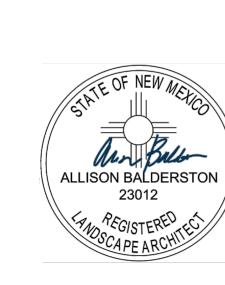

0

H G

OUTE 66 FLAT

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DRAWN: Author
REVIEWED: Approver

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ALTERNATIVE
PROJECT #: 21018
FILE:
SHEET TITLE:

RIGATION NOT


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REVIEWED: Approver

PROJECT #: 21018 FILE: SHEET TITLE: IRRIGATION PLAN

IR101



**EQUIPMENT SCHEDULE** 

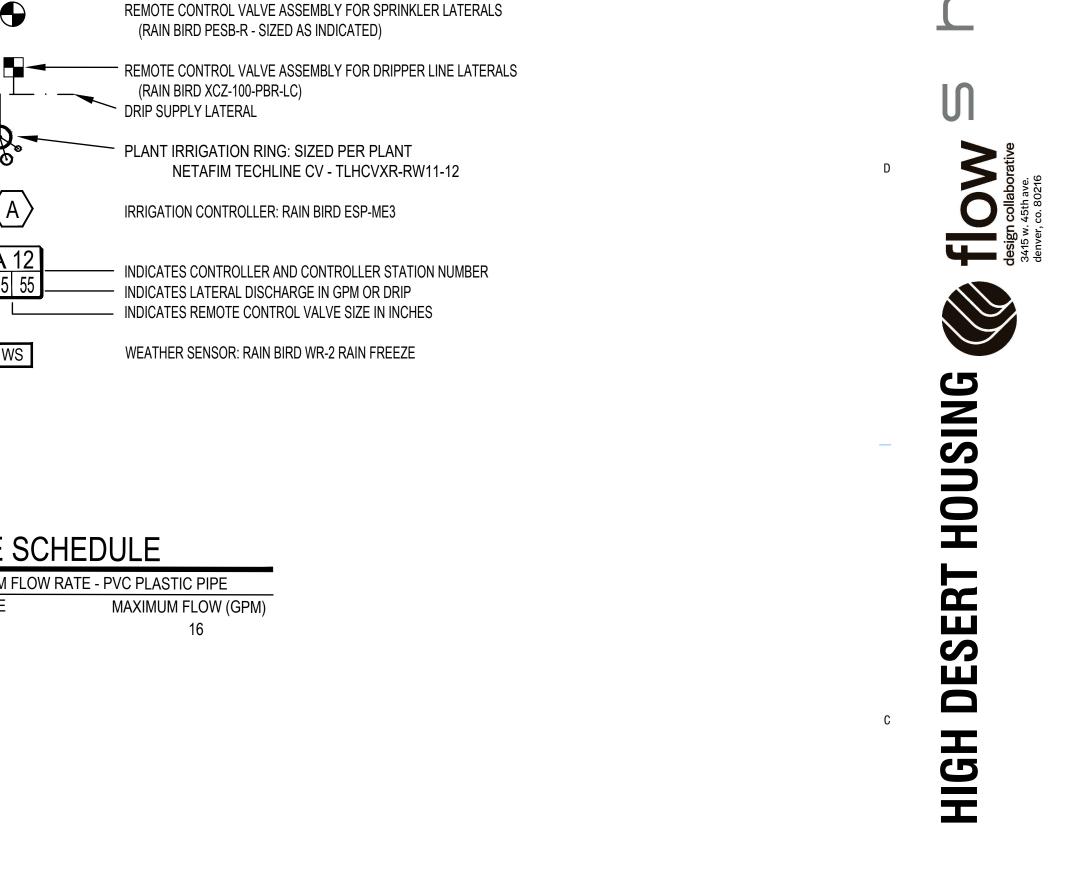SYMBOL

WS

PIPE SCHEDULE

DESCRIPTION

SLEEVING: CLASS 200 PVC

-·-··-· DRIPPER LINE SUPPLY LATERAL PIPE: CLASS 200 BE PVC

DRAIN VALVE

UNCONNECTED PIPE CROSSING

BACKFLOW DEVICE RE:PLUMBIING

FROST FREE GARDEN HYDRANT

ISOLATION GATE VALVE ASSEMBLY

QUICK COUPLING VALVE ASSEMBLY

PROVIDE SEPARATE 2" MIN. SLEEVE FOR WIRING

MAINLINE PIPE: CLASS 200 BE PVC - 1.5"

(1-INCH UNLESS OTHERWISE INDICATED)



SEE PLUMBING SHEETS FOR IRRIGATION SERVICE LOCATION DETAILS AND INSTALLATION OF NEW COPPER SERVICE WITHIN THE WATER ENTRY ROOM. EXTEND SERVICE LINE THROUGH THE BACKFLOW DEVICE AND EXTEND 1" COPPER SERVICE LINE 24" BELOW GRADE TO EXTERIOR OF THE BUILDING AND EXTEND PVC MAINLINE AS SHOWN. SYSTEM DESIGN PRESSURE: 70 PSI STATIC SERVICE SIZE: 1 INCH MAX FLOW: 15 GPM

# IRRIGATION CONTROLLER "A"

INSTALL CONTROLLER "A" PER DETAILS, EXTERIOR WALL MOUNT IN APPROXIMATE LOCATION SHOWN. CONNECT TO 120V POWER. COORDINATE POWER CONNECTION WITH OTHER TRADES. FOLLOW ALL APPLICABLE ELECTRICAL CODES. FINAL LOCATION OF CONTROLLER AND RAIN/FREEZE SENSOR TO BE APPROVED BY LA / OWNERS REP. PRIOR TO INSTALLATION.


MODEL: RAIN BIRD ESP-ME3 TOTAL STATIONS: 6 STATIONS

A 02 1" DR

A 03

DETENTION AREA

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HOU

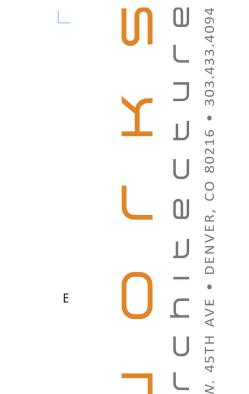ALLISON BALDERSTON 23012 ANDSCAPE ARCHITECT

99 ROUTE 6 7600 CENTRAL A ALBUQUERQUE,

> DRAWN: Author REVIEWED: Approver ALTERNATIVE LANDSCAPE PLAN PROJECT #: 21018

FILE:

SHEET TITLE:

**IRRIGATION DETAILS** 



FINISH GRADE LEEMCO LS-100 STABILIZER PVC SCH. 80 NIPPLE (LENGTH AS REQUIRED) PVC SCH. 40 EL PVC MAINLINE PIPE - PVC SCH. 80 NIPPLE (12-INCH LENGTH)

— VALVE BOX W/COVER: RAINBIRD

3-INCH MINIMUM DEPTH 3/4" WASHED GRAVEL

QUICK COUPLING VALVE

VB-10RNDP


PVC SCH. 40 STREET EL

QUICK COUPLING VALVE ASSEMBLY

SCALE: 1"-1'-0"

1. BRAND "QC" INTO LID OF EACH VALVE BOX W/3-INCH HIGH LETTERS.

SIDE VIEW

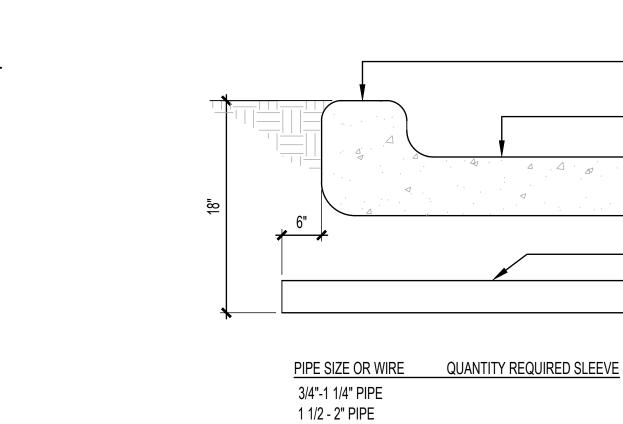

2 1/2 - 3" PIPE

1-25 CONTROL WIRES

26-75 CONTROL WIRES

SEPARATE SLEEVE

6" PIPE

8" PIPE

CONTROLLER: INSTALL PER MANUFACTURERS

CONTROL WIRING & MASTER VALVE WIRES

- BARE COPPER WIRE (#10 AWG MIN.)

SHOULD BE AS STRAIGHT AS POSSIBLE.

WALLMOUNT CONTROLLER INSTALLATION
SCALE: NTS

— 5/8" X 8' COPPER CLAD GROUNDING ROD OR PLATE

FINISH GRADE

REQUIRED)

GATE VALVE

--- PVC MAINLINE PIPE

WASHED GRAVEL

PVC SCH. 40 MALE ADAPTER

- ELECTRICAL CONDUIT W. JUNCTION BOX FOR POWER AND

CONNECT TO GROUNDING BUSS IN CONTROLLER CABINET AND ROUTE TO GROUND ROD. PATH TO GROUND ROD

- VALVE BOX W/COVER: RAINBIRD

— 2-INCH MINIMUM DEPTH OF 3/4-INCH WASHED

- 2-INCH PVC CL 200 PIPE (LENGTH AS

3-INCH MINIMUM DEPTH OF 3/4-INCH

RECOMMENDATIONS.

CONTROL WIRING CONDUIT

- POWER WIRING

GROUND ROD ASSEMBLY

2. BRAND "GV" INTO LID OF EACH VALVE BOX W/3-INCH HIGH LETTERS.

1. TAPE AND BUNDLE WIRING AT 10-FOOT INTERVALS. 2. ALL MAINLINE PIPING TO BE INSTALLED IN ACCORDANCE WITH MANUFACTURER'S INSTALLATION SPECIFICATIONS.

MAINLINE, LATERAL,


AND WIRING

3. ROUTE TRENCH MINIMUM 6 FEET FROM ANY TREE PLANTING AND OUTSIDE THE DRIP LINE OF EXISTING TREES.


MARKING RIBBON

- 4. TIE A 20-INCH LOOP IN ALL WIRING AT CHANGES OF DIRECTIONS GREATER THAN 30 DEGREES. UNTIE AFTER ALL CONNECTIONS HAVE BEEN MADE.
- 5. BACK FILL MATERIAL TO BE FREE OF ALL DEBRIS AND ROCKS LARGER THAN  $\frac{3}{4}$ " IN DIAMETER.



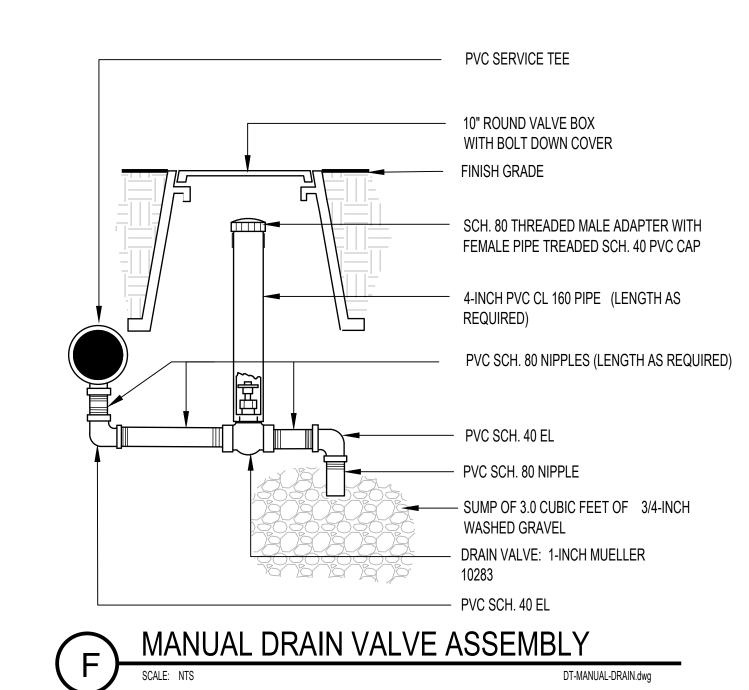

MAINLINE

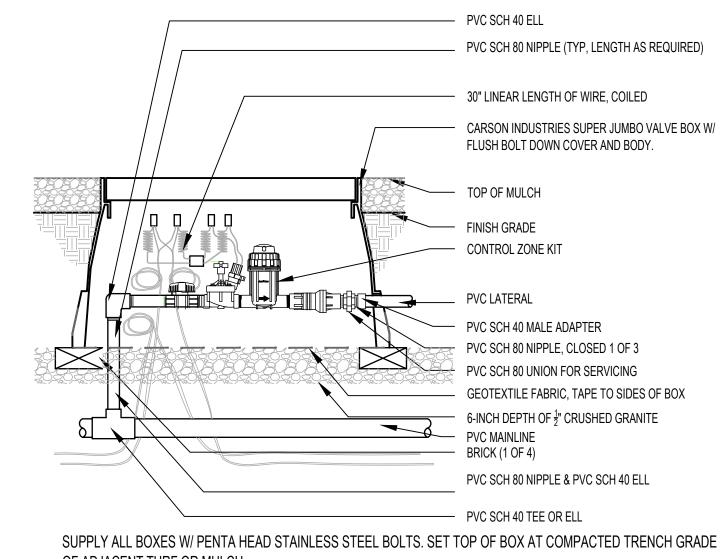

1 - 2"

1 - 3"


NOTE: EACH LENGTH OF SLEEVED PIPE SHOWN SHALL BE ROUTED THROUGH A


SLEEVE LOCATION


HARD SURFACE


CL200 PVC SLEEVE. SIZE

MARKING

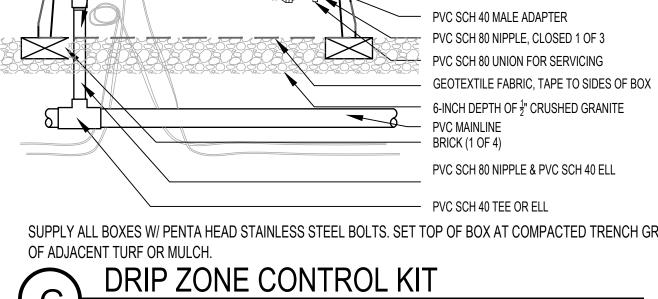

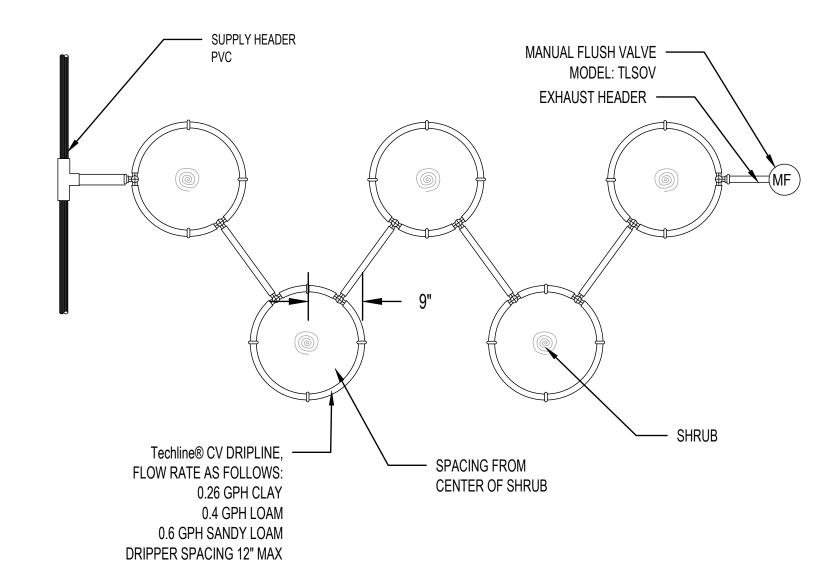

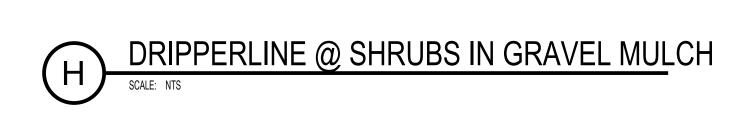


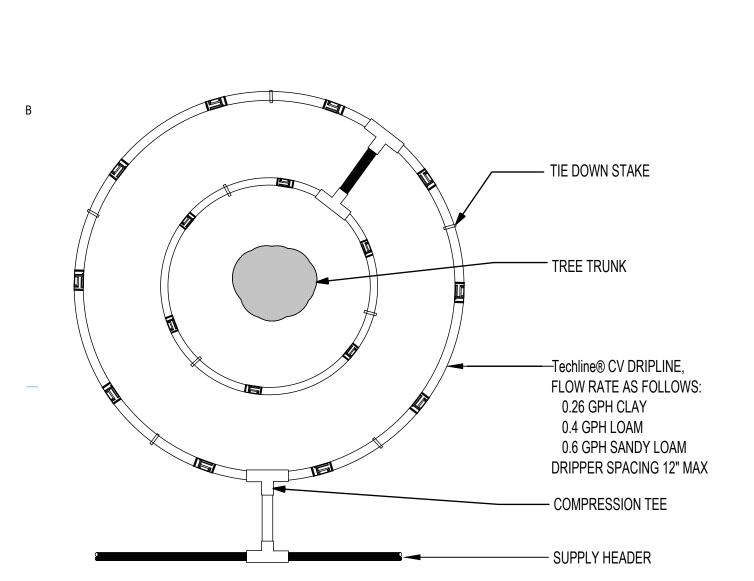



DRIPPERLINE @ TREE IN GRAVEL MULCH

1. LOCATE GATE VALVE AT LEAST 12" FROM, AND ALIGN WITH ADJACENT WALLS OR EDGES OF PAVED

ISOLATION GATE VALVE ASSEMBLY

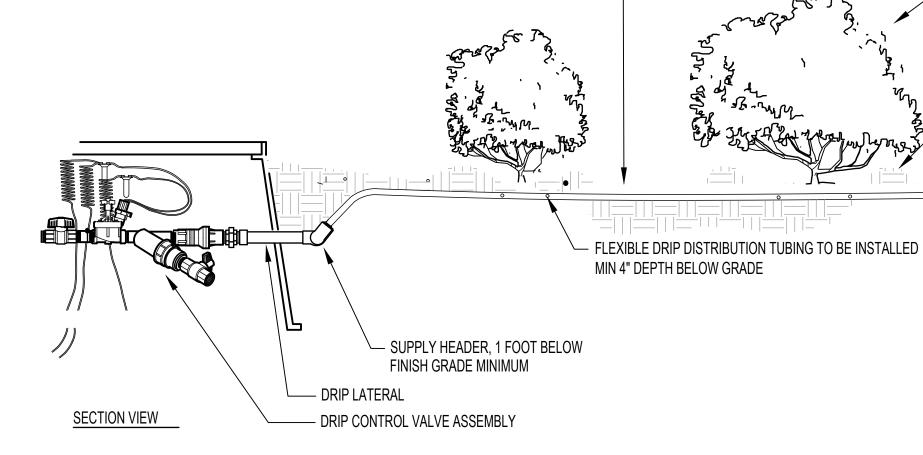

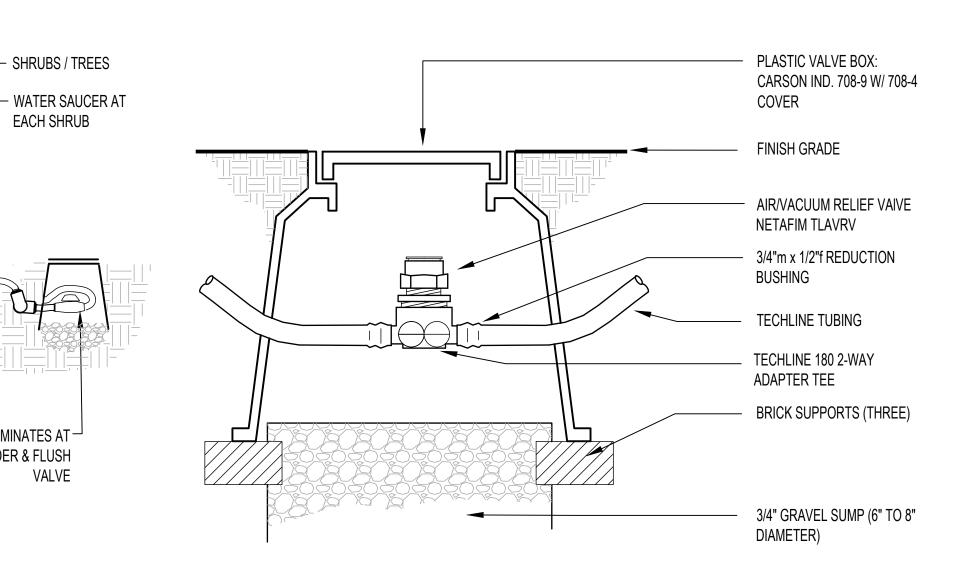

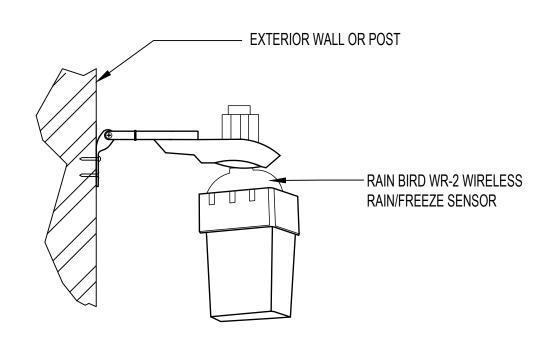


FINAL LOCATION TO BE APPROVED BY THE LANDSCAPE ARCHITECT PRIOR TO INSTALLATION. INSTALL IN A LOCATION WHERE RAINFALL WILL NOT BE OBSTRUCTED.

RAIN SENSOR
SCALE: NTS





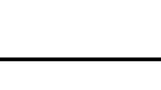

DRIPLINE TERMINATES AT-

EXHAUST HEADER & FLUSH

- SHRUBS / TREES

EACH SHRUB

