

RP BACKFLOW/MASTER VALVE DETAIL

Qty.	Symbol	Scientific Name Common Name	Installed	Mature	Landscape	Water	Drip
- Gir	Trees	COMMON VALUE			ead Coverage		mitter
2	(·)	Fraxinus Autumn Purple Ash	2" B&B	40'/40'	50 sf=100 sf	Medium	+6-2 (
5	\odot	Ulmus Lacebark Elm	2" B&B	50'/20'	50 sf=250 sf	Medium	6-2 9
4	\bigcirc	Pistacia chinensis Chinese Pistache	2" B&B	60'/60'	50 sf=200 sf	Medium	+6-2 g
7	\odot	Forestiera NM Olive	5-Gal	20'/20'	100 sf=700 sf	Medium-	+ 6-2 g
7	\bigcirc	Chilopsis Desert Willow	5-Gal	20'/20'	100 sf=700 sf	Low	6-2 g
6		Vitex Chaste Tree	5-Gal	20'/20'	100 sf=600 sf	Medium	6-2 g
Shrub	s/Groundo	overs		·			
17	0	Buddleia davidii Butterfly Bush	1-Gal	6'/6'	64 sf=1088 sf	Medium	2-2 g
9		Caryopteris clandonensis Blue Mist	1-Gal	4'/4'	25 sf=225 sf	Medium	2-2 g
23		Vauquelinia Rosewood	5-Gal	10'/10	' 100 sf=2300 sf	Medium	2-2 g
18	0	Rhus aromatica Gro Low Sumac	5-Gal	2'/6'	64 sf=1152 sf	Low +	2-2 g
18	\otimes	Ericameria laricifolia 'Aguirre' Turpentine Bush	5-Gal	3'/4'	35 sf=630 sf	Low	2-1 g
37	X	Hesperaloe parviflora Red Yucca	5-Gal	3'/4'	30 sf=1110 sf	Low	2-1 g
11	THE SHAPE	Juniperus sabina 'Buffalo' Buffalo Juniper (female)	5-Gal	2'/6'	64 sf=704 sf	Low +	2-2 g
25	\bigotimes	Perovskia atriplicifolia Russian Sage	1-Gal	5'/5'	50 sf=1250 sf	Medium	2-2 g
1		Lagerstroemia Crape Myrtle	5-Gal	15'/10'	100 sf=100 sf	Medium-	+2-2 g
7	③	Nepeta Catmint	1-Gal	1'/3'	6 sf=42 sf	Medium	2-2 g
2	0	Pinus mugo Mugho Pine	5-Gal	4'/4'	30 sf=60 sf	Medium	2-2 g
12		Caesalpinia Bird of Paradise	5-Gal	10'/10'	100 sf=1200 sf	Medium	2-2 g _l
15	\otimes	Rhus trilobata 3 Leaf Sumac	5-Gal	2'/6'	64 sf=960 sf	Low +	2-2 g
31	**	Dasylirion Sotol	5-Gal	4'/4'	64 sf=1984 sf	Low	2-1 g
39	*	Yucca pendula Softblade Yucca	5-Gal	4'/4'	64 sf=2496 sf	Low +	2-1 g
Grasse	:s	**************************************			·		· · · · · · · · · · · · · · · · · · ·
47	*	Muhlenbergia	1-Gal	4'/4'	40 sf=1880 sf	Low+	2-2 gr

MATERIALS LEGEND

Deer Grass Muhlenbergia

Regal Mist Grass

Calamagrotis

Karl Foerster Grass

7/8" BROWN GRAVEL MULCH
2"-4" COBBLESTONE

NATIVE SEED

89,631 SF

<u>13,779</u> SF

11,378 SF

11/11

23,531 SF MIN.

2,325 SF

21,235 SF

<u>75,852</u> SF

____31,375 SF

SITE DATA

LESS BUILDING(S)

REQUIRED LANDSCAPE

15% OF NET LOT AREA PROPOSED LANDSCAPE

HIGH WATER USE TURF

PERCENT OF NET LOT AREA

REQUIRED STREET TREES

PROVIDED STREET TREES

38 SPACES (Phase 1)/10

1 PER 10 SPACES

(2" cal or 6' ht.)

REQUIRED PARKING LOT TREES

TOTAL TREE REQUIRED/PROVIDED

REQUIRED LANDSCAPE COVERAGE

75% LIVE VEGETATIVE MATERIAL

NATIVE SEED/100 % COVERAGE

MAX. 20% OF LANDSCAPE AREA

PROPOSED HIGH WATER USE TURF PERCENT OF LANDSCAPE AREA

1 PER 30 L.F. OF STREET FRONTAGE

PROVIDED PARKING LOT TREES (Phase 1)

(31,375 SF PROPOSED LANDSCAPE X 75%)

TOTAL PROVIDED GROUNDCOVER COVERAGE 23,560 SF

PROVIDED GROUNDCOVER COVERAGE

PERCENT GROUNDCOVER COVERAGE

OF REQUIRED LANDSCAPE AREAS

IRRIGATION NOTE

DRIP SYSTEM RUN CYCLES: ESTABLISHMENT AND SUMMER:

1 HOUR/4 DAYS A WEEK

1 HOUR/2-3 DAYS A WEEK

1 HOUR/2-3 DAYS A WEEK

WINTER: 1 HOUR/2 DAYS PER MONTH

NET LOT AREA

GROSS LOT AREA (2.05 ac)

2"-4" COBBLESTONE

NOTE

MAINTENANCE OF LANDSCAPE (ONSITE AND WITHIN ROW)
TO BE MAINTAINED BY PROPERTY OWNER

3'/3' 15 sf=150 sf Medium 2-2 gph

3'/2' 10 sf=490 sf Medium 2-2 gph

Total Landscape Coverage=21,235 SF

PLANTINGS TO BE WATERED BY AUTO. DRIP IRRIGATION SYSTEM WITH REDUCED PRESSURE BACKFLOW PREVENTER PER CITY OF ALBUQUERQUE

WATER MANAGEMENT IS THE SOLE RESPONSIBILITY OF THE PROPERTY OWNER

THIS PLAN IS TO COMPLY WITH C.O.A. LANDSCAPE AND WATER WASTE ORDINANCE 6-1-1. PLANTING RESTRICTIONS APPROACH

IT IS THE INTENT OF THIS PLAN TO PROVIDE MIN. 75% LIVE GROUNDCOVER OF LANDSCAPE AREAS AT MATURITY PER ORDINANCE 14-16-3-10 (SEE CALCULATIONS PROVIDED ABOVE)

LANDSCAPE AREAS TO BE MULCHED WITH GRAVEL MULCH AT 2"-3" DEPTH

APPROVAL OF THE LANDSCAPE PLAN DOES NOT CONSTITUTE OR IMPLY COMPLIANCE WITH, OR EXEMPTION FROM, THE C.O.A LANDSCAPE AND WATER WASTE ORDINANCE 6-1-1.

NO PARKING SPACE SHALL BE MORE THEN 100' FROM A TREE.

STREET TREES TO CONFORM TO STREET TREE ORDINANCE

LANDSCAPE PLAN TO CONFORM TO ZONING REGULATIONS

ORDINANCE14-16-3-10.

LANDSCAPING AND SIGNING WILL NOT INTERFERE WITH CLEAR SIGHT REQUIREMENTS. THEREFORE, SIGNS, WALLS, TREES AND SHRUBBERY BETWEEN 3 AND 8 FEET TALL (AS MEASURED FROM THE GUTTER PAN) WILL NOT BE

ALLOWED IN THIS AREA.

IRRIGATION SYSTEM: AN AUTOMATIC UNDERGROUND IRRIGATION SYSTEM WILL BE UTILIZED TO PROVIDE EVEN AND ADEQUATE WATER LEVELS TO ALL PLANT MATERIAL. WATER USE SHALL BE DONE IN SUCH A MANNER AS TO CONSERVE ITS USE AND PREVENT ANY AND ALL RUNOFF FROM LANDSCAPE MATERIALS. IRRIGATION SHALL BE

FROM LANDSCAPE MATERIALS. IRRIGATION SHALL BE RESTRICTED TO EARLY MORNING HOURS TO CONSERVE THIS LIMITED RESOURCE.

STREETSCAPE LANDSCAPING SHALL CONSIST PRIMARILY OF SHRUBS AND DECIDUOUS TREES IN A SETBACK AREA BETWEEN THE RIGHT-OF-WAY OF THE STREET AND THE

CLEAR-SIGHT TRIANGLE REQUIREMENTS MUST BE MET.


TREES IN PROXIMITY OF DUMPSTER TO BE MAINTAINED TO ALLOW FOR TRUCK ACCESS WITHOUT DAMAGE TO TRUCK OR TREES

FACE OF THE CURB OF AN ADJACENT PARKING AREA.

JOWING Detter John LANDSCAPE CONTRACTOR www.headsuplandscape.com

Albuquerque, NM 87184 505.898.9615 505.898.2105 (fax) design@hulc.com


PO Box 10597

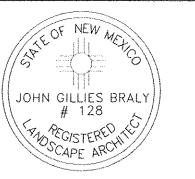

Date:_	2/21/18
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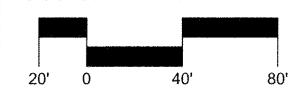
Drawn by: jc Reviewed by: jb

Primrose School of NW Albuquerque

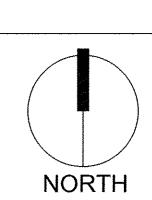

9

Scale: 1" = 40'




Sheet Title:

Landscape Plan

Sheet Number:

LS-01

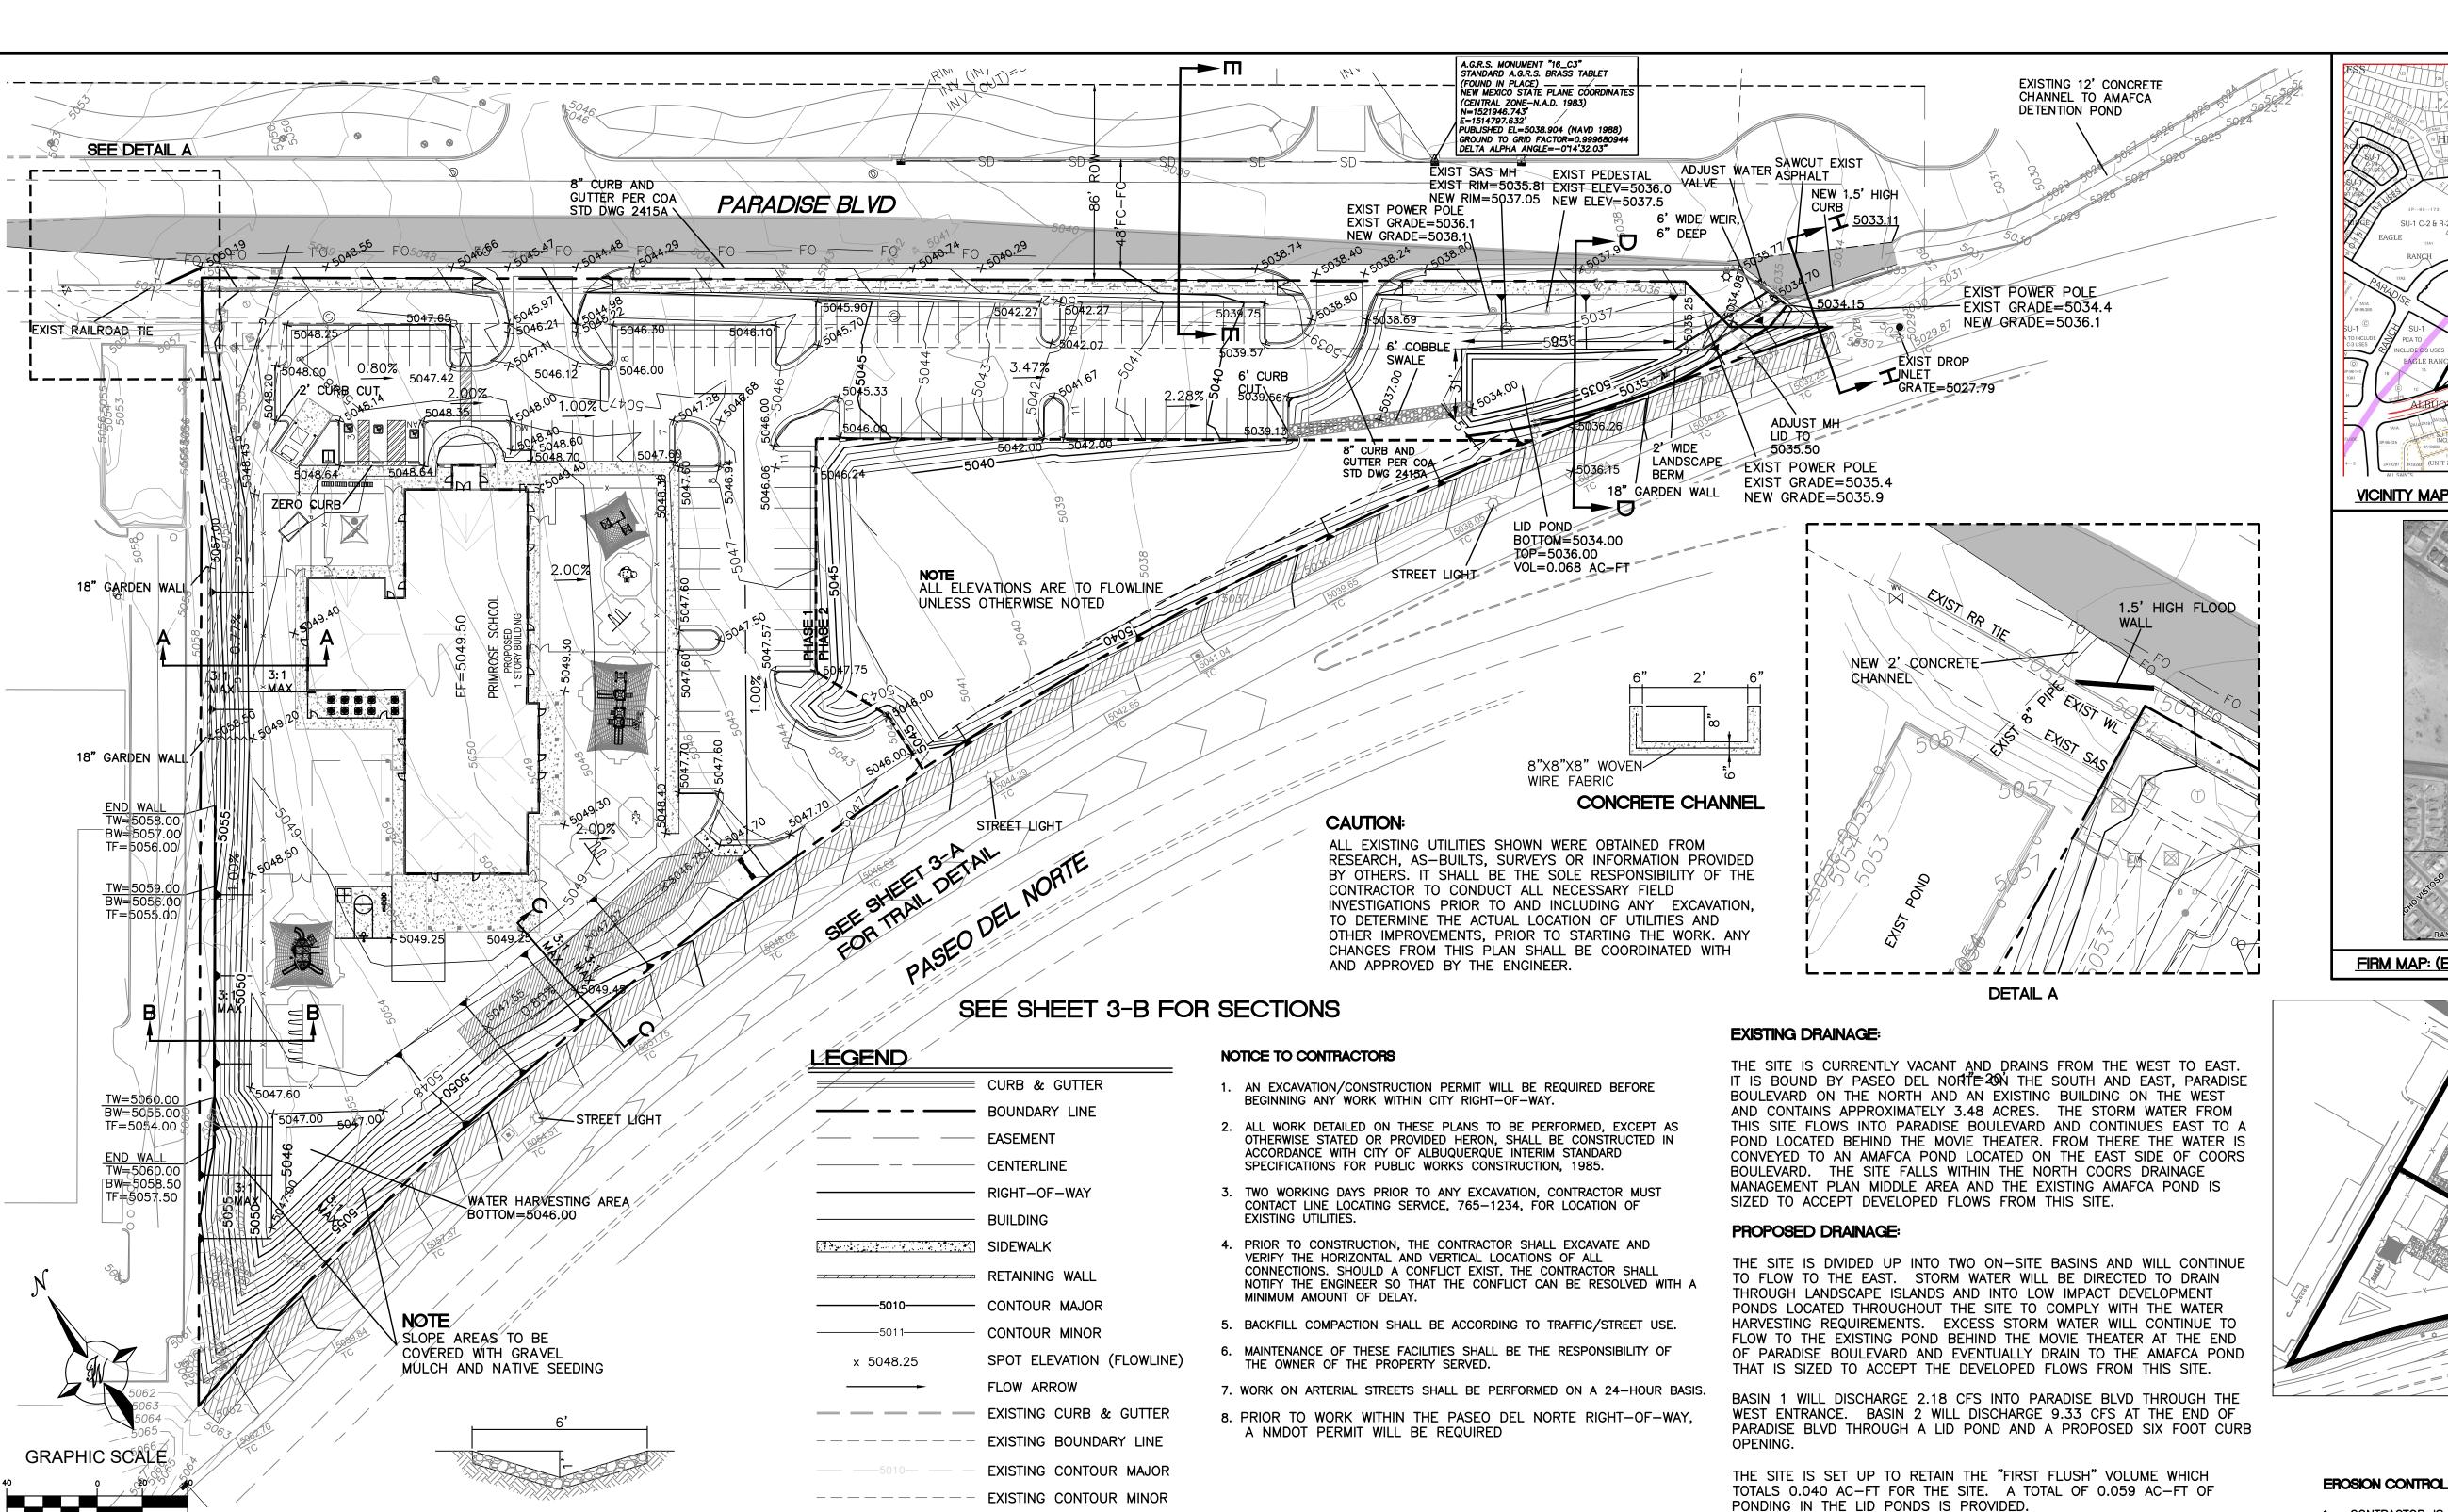

EXISTING SPOT ELEVATION

EXISTING LIGHT STANDARD

10-Year

(ac-ft)

0.044

0.178

1.30

5.39

5036.00

| Weighted E | Volume | Flow

0.832

0.751

PHASE LINE

Flow

2.18

9.33

11.51

100-Year

0.077

0.320

0.397

0.24

0.76

1.49

2.89

x 5048.25

Treatment D | Weighted E | Volume

1.450

1.349

Peak Discharge (cfs/acre)

Zone 1 | 100-Year | 10 - Year

1.29

2.03

2.87

4.37

% (acres)

60% 0.38

1.42

1.81

 Q_a

 Q_b

 Q_c

 Q_d

COBBLE SWALE

Treatment B

40%

40%

(acres)

0.25

1.14

Weighted E Method

Treatment C

0%

10%

Excess Precipitation, E (inches)

Zone 1 | 100-Year | 10 - Year

0.44

0.67

0.99

1.97

(acres)

0.08

0.22

0.44

1.24

0.00

0.28 50%

(IN FEET)

1 inch = 40 ft.

On-Site Basins

Area

Volume = Weighted D * Total Area

27,711

124,063

Flow = Qa * Aa + Qb * Ab + Qc * Ac + Qd * Ad

Basin

Equations:

Area

(acres)

Weighted E = Ea*Aa + Eb*Ab + Ec*Ac + Ed*Ad / (Total Area)

0.64

2.85

3.48

Treatment A


% (acres)

0%

POND CALCULATIONS First Flush Pond Ab - Bottom Of The Pond Surface Area At - Top Of The Pond Surface Area D - Water Depth Dt - Total Pond Depth C - Change In Surface Area / Water Depth Volume = $Ab * D + 0.5 * C * D^2$ C = (At - Ab) / DtAb = 1,201.00At = 2,202.00Dt = 2.00 500.50 C = ACTUAL DEPTH | VOLUME (AC-FT) (FT) 0.00 5034.00 0.00 0.50 0.0138 0.75 0.0210 5034.75 5035.00 1.00 0.0290 5035.32 1.32 0.0403 First Flush Volume 1.50 0.0471

2.00 0.0681

FIRST FLUSH CALCULATION BASIN 1: 16552 SF X 0.34"/12"=469 CF BASIN 2: 61855 SF X 0.34"/12"=1753 CF BASIN 1 WILL BE COVERED BY A WAIVER FOR 16552 SF

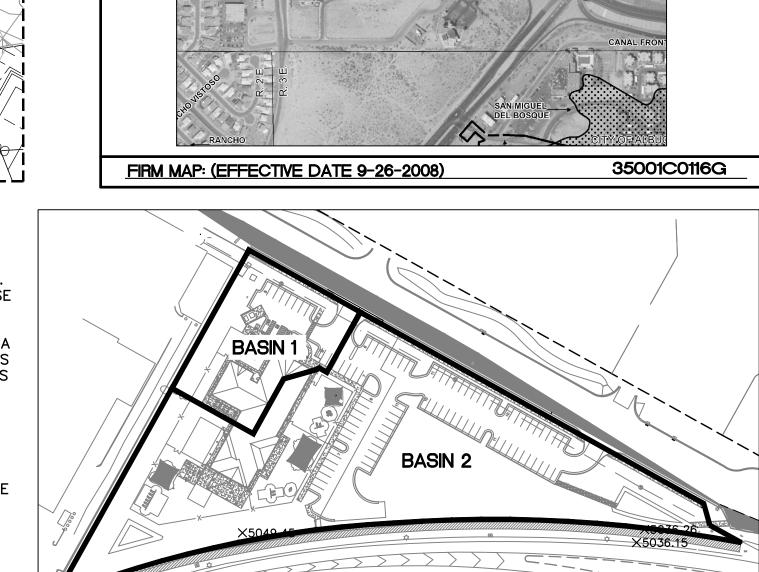

PLAZA AT PASEO DEL NORTE

PARTITION OF T


C-13Z

PROPOSED BASIN MAP


EROSION CONTROL NOTES:

- 1. CONTRACTOR IS RESPONSIBLE FOR OBTAINING A TOPSOIL DISTURBANCE PERMIT PRIOR TO BEGINNING WORK.
- 2. CONTRACTOR IS RESPONSIBLE FOR MAINTAINING RUN-OFF ON SITE DURING CONSTRUCTION.
- 3. CONTRACTOR IS RESPONSIBLE FOR CLEANING ALL SEDIMENT THAT GETS INTO EXISTING RIGHT-OF-WAY.
- 4. REPAIR OF DAMAGED FACILITIES AND CLEANUP OF SEDIMENT ACCUMULATIONS ON ADJACENT PROPERTIES AND IN PUBLIC
- FACILITIES IS THE RESPONSIBILITY OF THE CONTRACTOR. 5. ALL EXPOSED EARTH SURFACES MUST BE PROTECTED FROM
- WIND AND WATER EROSION PRIOR TO FINAL (CITY) ACCEPTANCE OF ANY PROJECT.

ENGINEER'S SEAL	PRIMROSE SCHOOL OF NW ALBUQUERQUE	<i>DRAWN BY</i> pm
DR. BOH	OI INVI ALBOCOLINCOL	DATE
ON MEXICO Z	GRADING AND DRAINAGE	11-1-18
(7868)	PLAN	DRAWING
THE SONAL ENGINE		SHEET #
27/16/2018	5571 MIDWAY PARK PL NE ALBUQUERQUE, NEW MEXICO 87109	3
RONALD R. BOHANNAN P.E. #7868	(505) 858-3100 www.tierrawestllc.com	<i>JOB #</i> 2017092

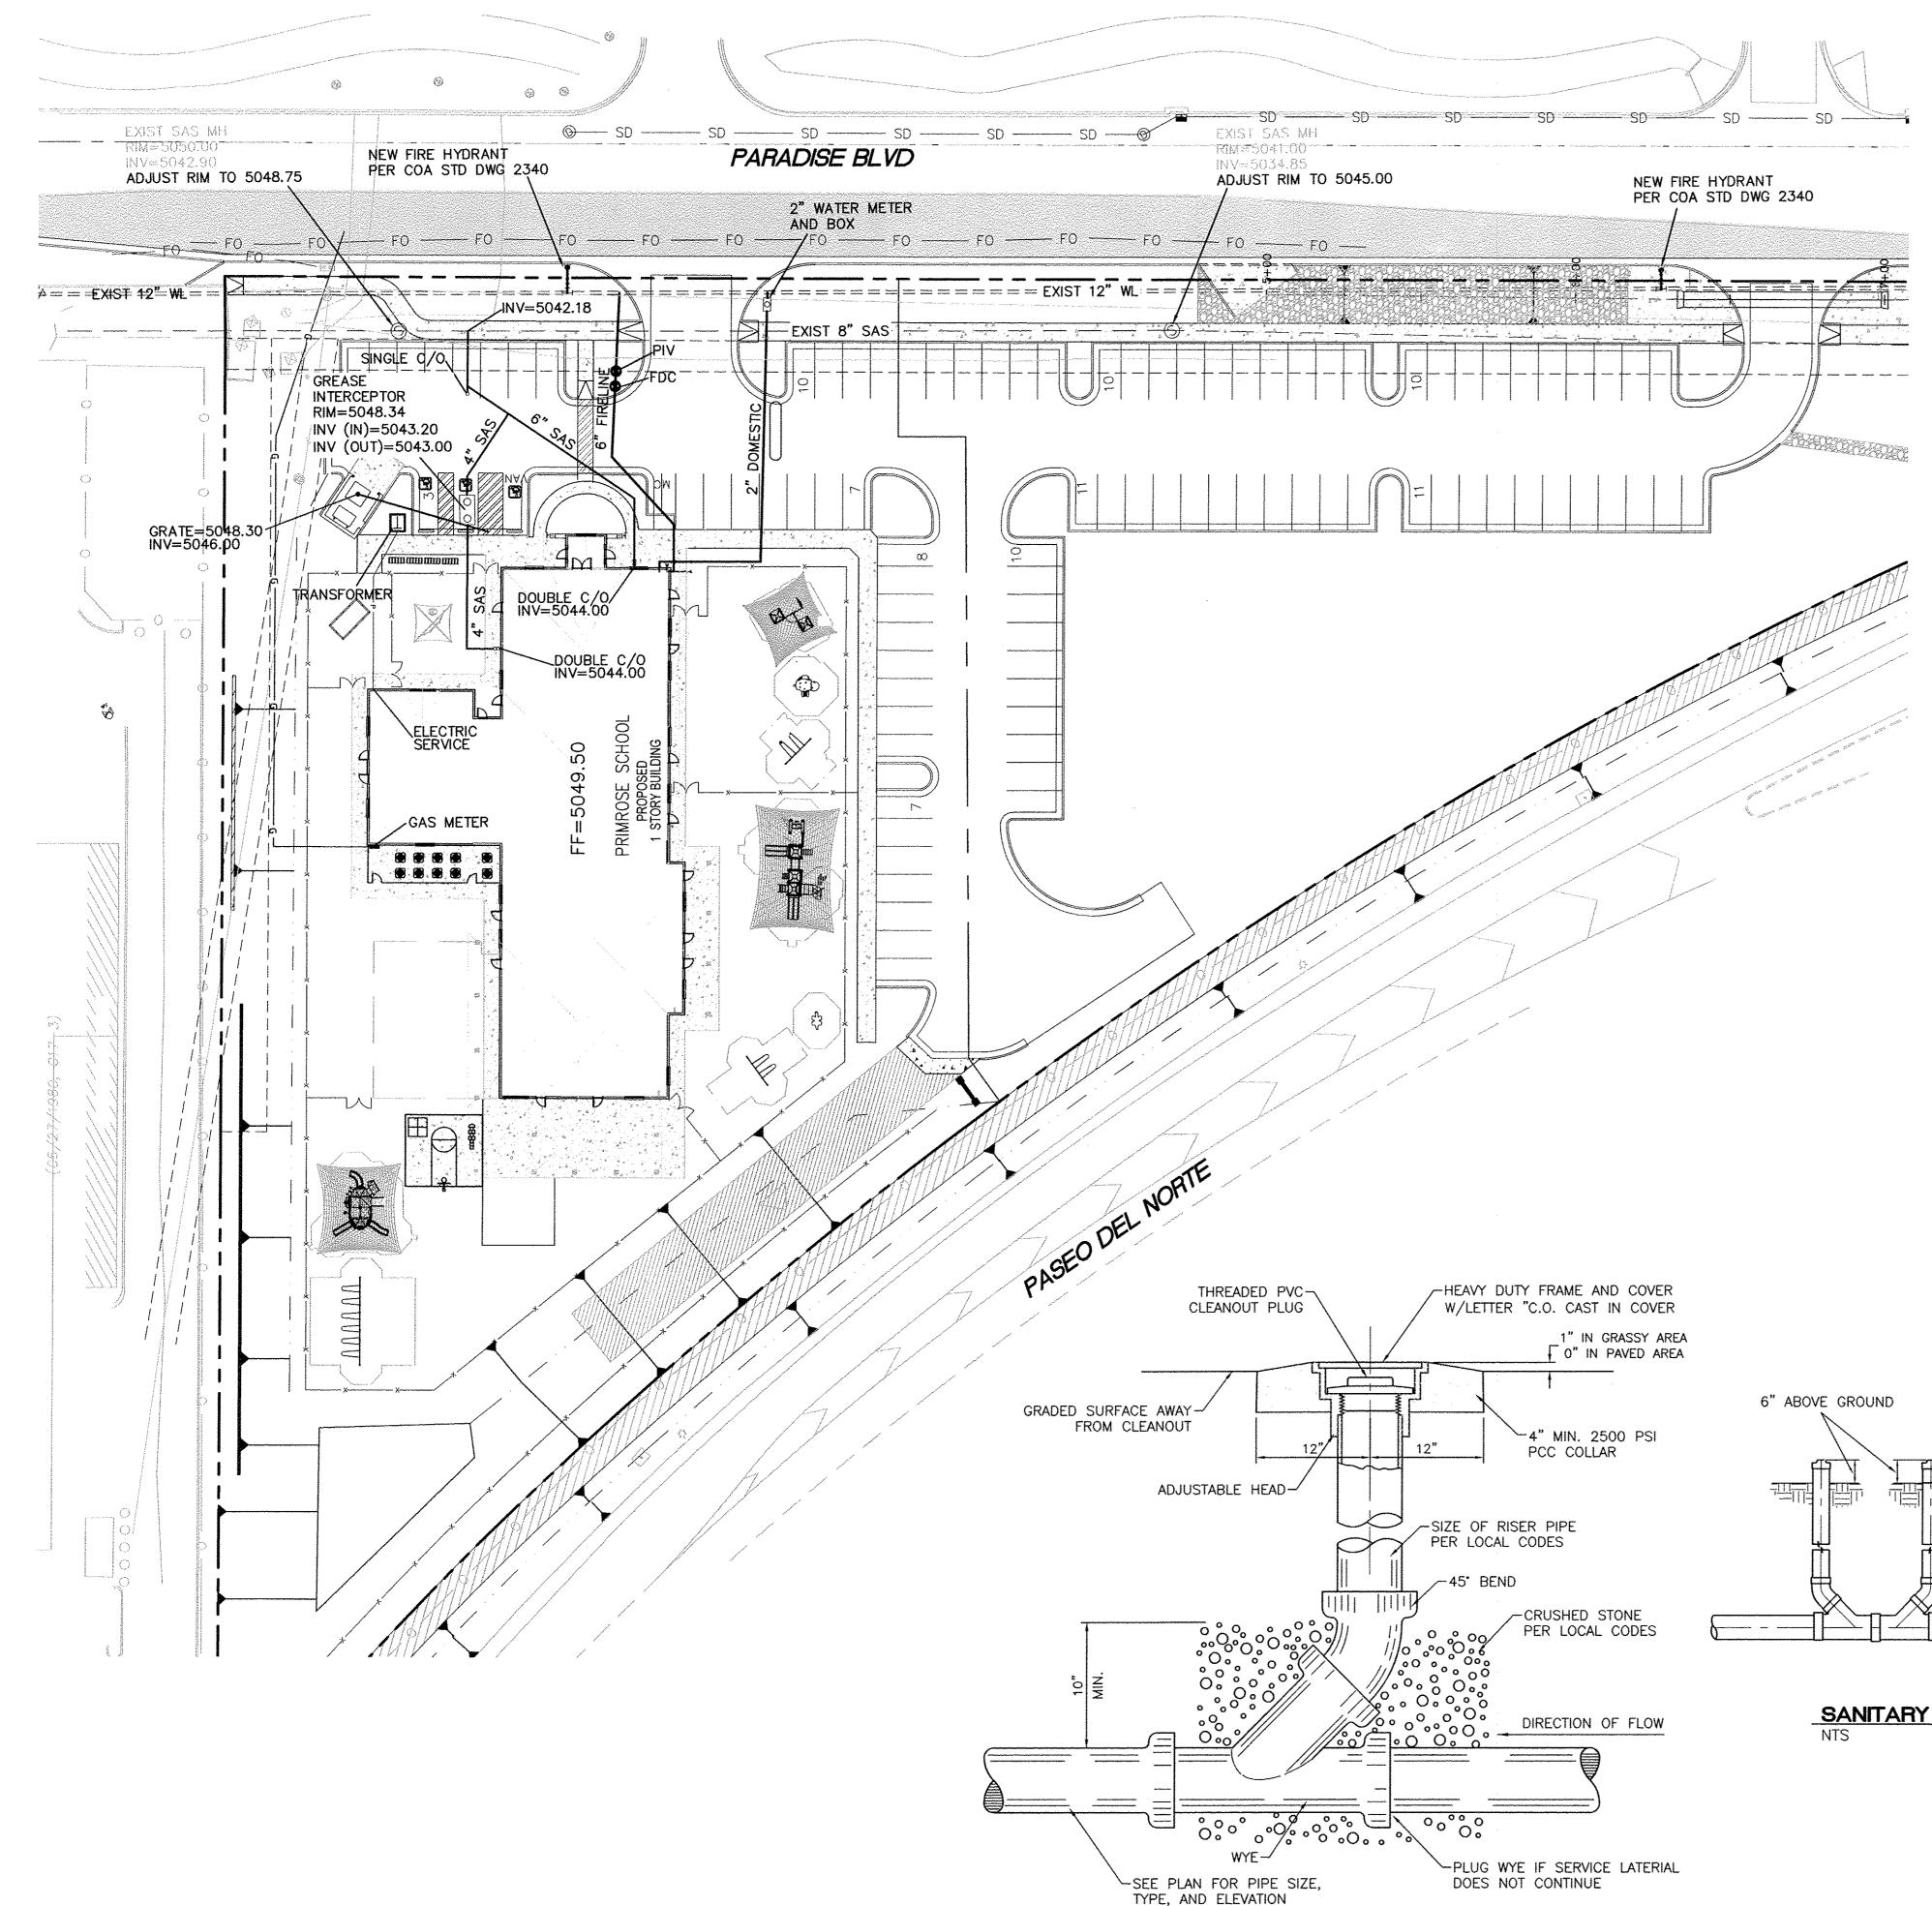

SANITARY SEWER CLEAN-OUT

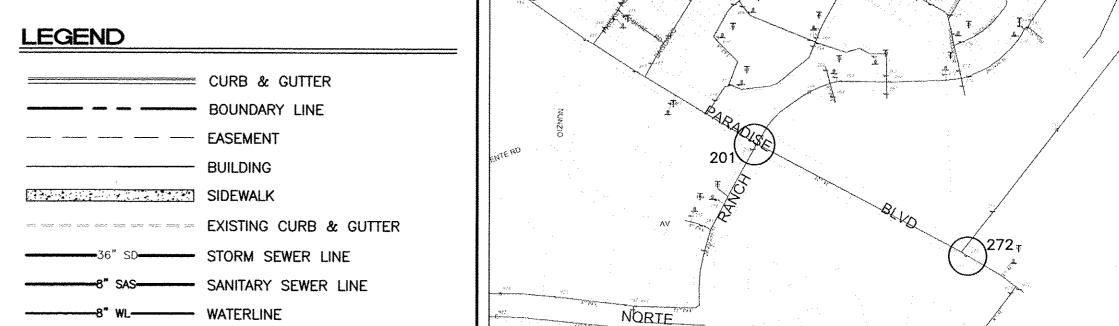

SHUTOFF VALVES 201, 272 WATER SHUTOFF PLAN

THE CONTRACTOR SHALL COORDINATE WITH THE WATER AUTHORITY SEVEN (7) DAYS IN ADVANCE OF PERFORMING WORK THAT WILL AFFECT THE PUBLIC WATER OR SANITARY SEWER INFRASTRUCTURE. WORK REQUIRING SHUTOFF OF FACILITIES DESIGNATED AS MASTER PLAN FACILITIES MUST BE COORDINATED WITH THE WATER AUTHORITY 14 DAYS IN ADVANCE OF PERFORMING SUCH WORK. ONLY WATER AUTHORITY CREWS ARE AUTHORIZED TO OPERATE PUBLIC VALVES. SHUTOFF REQUESTS MUST BE MADE ONLINE AT HTTP://ABCWUA.ORG/CONTENT/VIEW/463/729/.

GENERAL UTILITY NOTES:

SINGLE CLEAN OUT

DOUBLE CLEAN OUT

EXISTING INLET

EXISTING SD MANHOLE

EXISTING SAS MANHOLE

EXISTING FIRE HYDRANT

EXISTING WATER METER

EXISTING POWER POLE

EXISTING GAS VALVE

EXISTING GAS

--- EX. 8" SAS--- EXISTING SANITARY SEWER LINE

- EX. RCP - EXISTING STORM SEWER LINE

----EX. WL---- EXISTING WATER LINE


------ G-------- PROPSED GAS

P PROPOSED POWER

PROPOSED TELEPHONE

- 1. ALL WATER AND SEWER UTILITY WORK TO BE DONE IN ACCORDANCE WITH COA STANDARDS AND SPECIFICATIONS LATEST EDITION.
- 2. 4' MINIMUM BURY REQUIRED FOR ALL UTILITIES UNLESS OTHERWISE NOTED.
- 3. REFERENCE ARCHITECTURAL PLANS FOR WATER LINE RISER LOCATIONS.
- 4. CLEAN OUTS ARE TO BE BUILT PER UNIFORM PLUMBING CODE STANDARDS.
- 5. ALL PLUMBING PIPE MATERIAL TO BE USED PER UPC.
- 6. FIRE LINE AND DOMESTIC WATERLINE MUST HAVE BACKFLOW PREVENTORS PER UPC. IF BACKFLOW PREVENTOR IS INSTALLED EXTERIOR OF BUILDING A HOT BOX SHALL BE INSTALLED AND USED.
- 7. ALL EX. SD INLETS AND MH SHALL HAVE CONCRETE COLLARS POURED AND BE ADJUSTED TO FINISHED GRADE.
- 8. ALL EXCAVATION, TRENCHING AND SHORING ACTIVITIES MUST BE CARRIED-OUT IN ACCORDANCE WITH OSHA 29 CFR 1926.650 SUBPART P.
- 9. ALL UTILITY DISTANCES SHOWN ARE FOR REFERENCE ONLY.


- 10. PNM HAS NUMEROUS ELECTRIC FACILITIES AT THIS SITE CURRENTLY SERVING EXISTING CUSTOMERS. THE APPLICANT SHALL COORDINATE WITH PNM REGARDING THESE EXISTING FACILITIES. ANY RELOCATION, CHANGES OR REALIGNMENT OF EXISTING ELECTRIC UTILITIES WILL BE THE DEVELOPER EXPENSE. IN SOME CASES, RELOCATION OR CHANGES TO EXISTING FACILITIES MAY NOT BE FEASIBLE DUE TO PHYSICAL, USE OR SAFETY CLEARANCE CONSTRAINTS.
- 11. PNM WILL REVIEW ALL TECHNICAL NEEDS, ISSUES AND SAFETY CLEARANCES FOR ITS ELECTRIC POWER SYSTEMS. ANY EXISTING AND PROPOSED PUBLIC UTILITY EASEMENTS SHALL BE INDICATED ON THE SITE PLAN UTILITY SHEET PRIOR TO DRB REVIEW. PNM'S STANDARD FOR PUBLIC UTILITY EASEMENTS IS 10 FEET IN WIDTH TO ENSURE ADEQUATE, SAFE CLEARANCES.
- 12. SCREENING SHALL BE DESIGNED TO ALLOW FOR ACCESS TO UTILITY FACILITIES. IT IS NECESSARY TO PROVIDE ADEQUATE CLEARANCE OF TEN FEET SURROUNDING ALL GROUND-MOUNTED UTILITIES FOR SAFE OPERATION, MAINTENANCE AND REPAIR PURPOSES.
- 13. ALL BUILDINGS CONSTRUCTION TYPE IS II-B

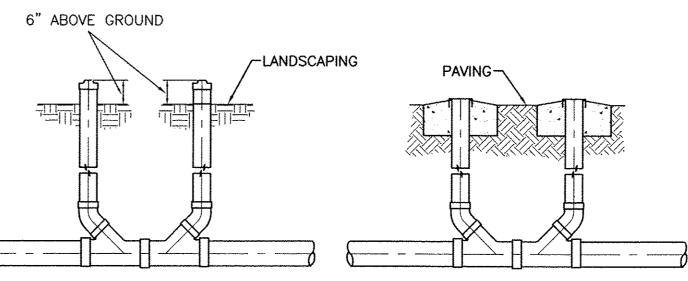



CAUTION:

ALL EXISTING UTILITIES SHOWN WERE OBTAINED FROM RESEARCH, AS-BUILTS, SURVEYS OR INFORMATION PROVIDED BY OTHERS. IT SHALL BE THE SOLE RESPONSIBILITY OF THE CONTRACTOR TO CONDUCT ALL NECESSARY FIELD INVESTIGATIONS PRIOR TO AND INCLUDING ANY EXCAVATION, TO DETERMINE THE ACTUAL LOCATION OF UTILITIES AND OTHER IMPROVEMENTS, PRIOR TO STARTING THE WORK. ANY CHANGES FROM THIS PLAN SHALL BE COORDINATED WITH AND APPROVED BY THE ENGINEER.

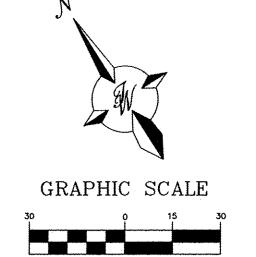

(IN FEET) 1 inch = 30 ft.

DRAWN BY

pm


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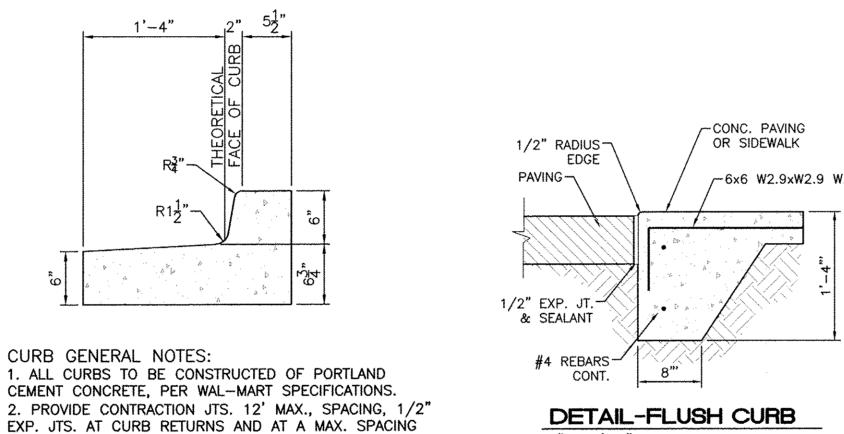
ENGINEER'S SEAL

PRIMROSE SCHOOL OF NW ALBUQUERQUE

(505) 858-3100

5-21-18 MASTER UTILITY PLAN DRAWING SHEET # TIERRA WEST, LLC 5571 MIDWAY PARK PL NE ALBUQUERQUE, NEW MEXICO 87109 JOB # RONALD R. BOHANNAN www.tierrawestllc.com 2017092 P.E. #7868



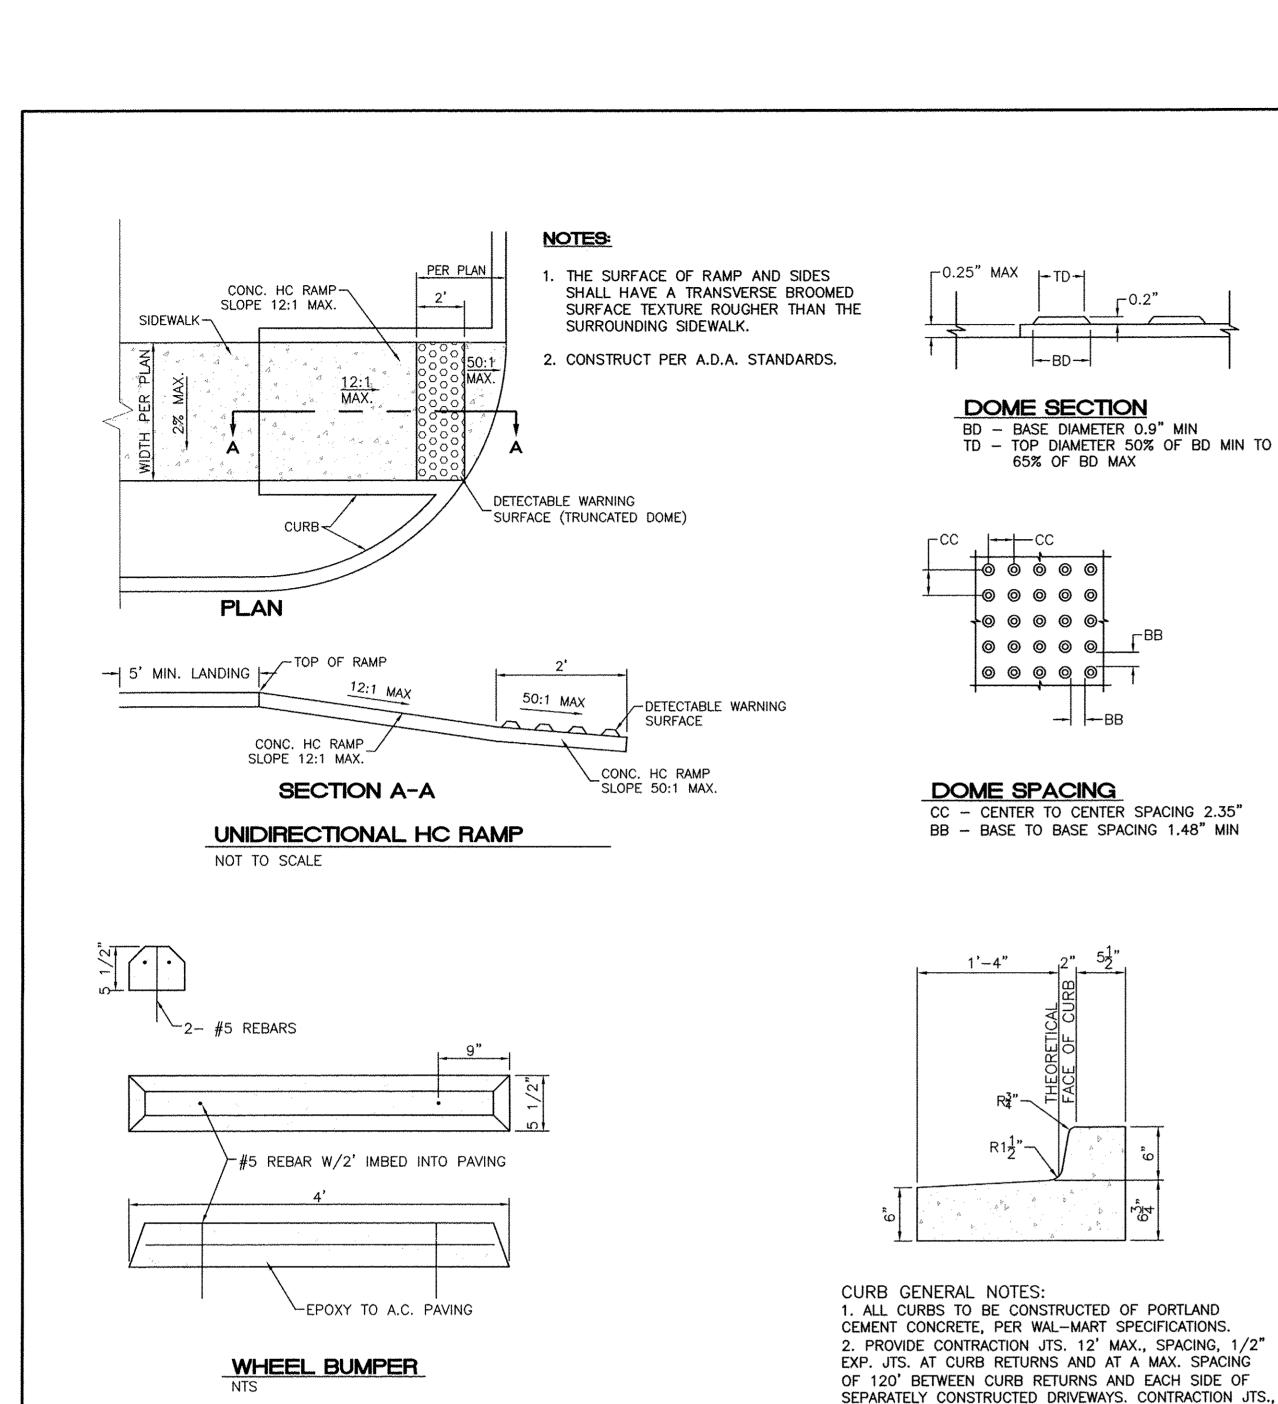

-0.25" MAX |-TD-

DOME SECTION

+000000

00000

DOME SPACING

CC - CENTER TO CENTER SPACING 2.35" BB - BASE TO BASE SPACING 1.48" MIN

SHALL BE EITHER SAWED OR TOOLED A MINIMUM OF 1"

3. ALL EDGES SHALL BE EDGED WITH A 3/8" RADUIS

4. 1/4" ISOLATION JOINT SHALL BE PLACED BETWEEN SIDEWALK AND CURB WHEN CAST ADJACENT TO EACH

STANDARD CURB / GUTTER


DEEP AT FINISHED FACES.

EDGING TOOL.

BD - BASE DIAMETER 0.9" MIN

65% OF BD MAX

TD - TOP DIAMETER 50% OF BD MIN TO

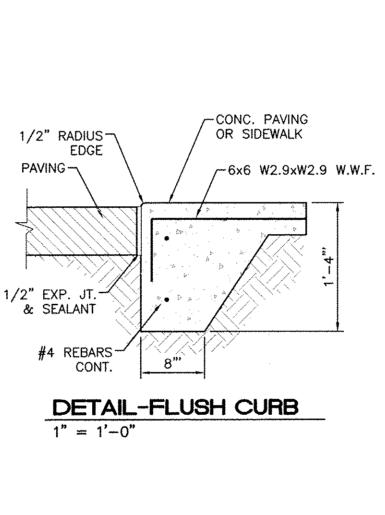

HANDICAPPED SIGNAGE -

PARKING BUMPER


2' FROM CURB

INSTALLED W/#4 BARS

HC PARKING DETAIL

HC PARKING DETAIL SECTION A-A

SEE DETAIL THIS SHEET

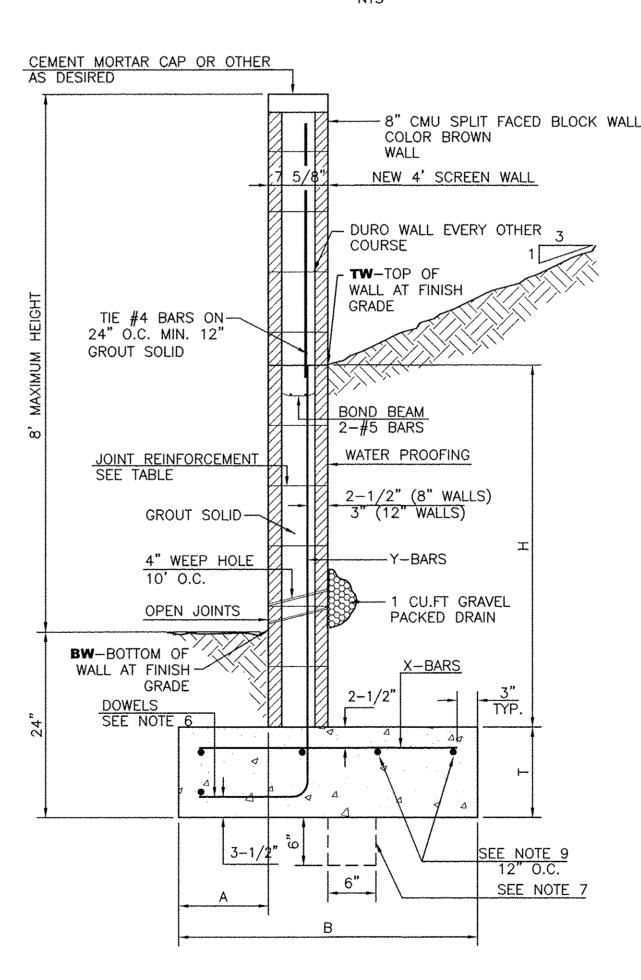

NON-VAN ACCESSIBLE SPACES

-HANDICAPPED SIGNAGE

INSTALLED W/#4 BARS

- PARKING BUMPER

2' FROM CURB

-6" HEADER CURB

SEE DETAIL THIS SHEET

BOTTOM OF THIS SIGN

ANSI 502.7-

ANSI 502.7

2" DIA.x.188 GALV.

TRAFFIC YELLOW

PAVING-AREA

STEEL PIPE

ACCESSIBLE PARKING SIGN

60" MIN. ABOVE GROUND

VAN ACCESSIBLE SPACES-


60" MIN. ABOVE GROUND

WHEN SIGN IS IN PAVED AREAS, -USE 4" PIPE BOLLARD FILLED W/ CONCRETE AND PAINTED

1'-6" DIA. CONC.-

BASE 3000 PSI

BOTTOM OF THIS SIGN

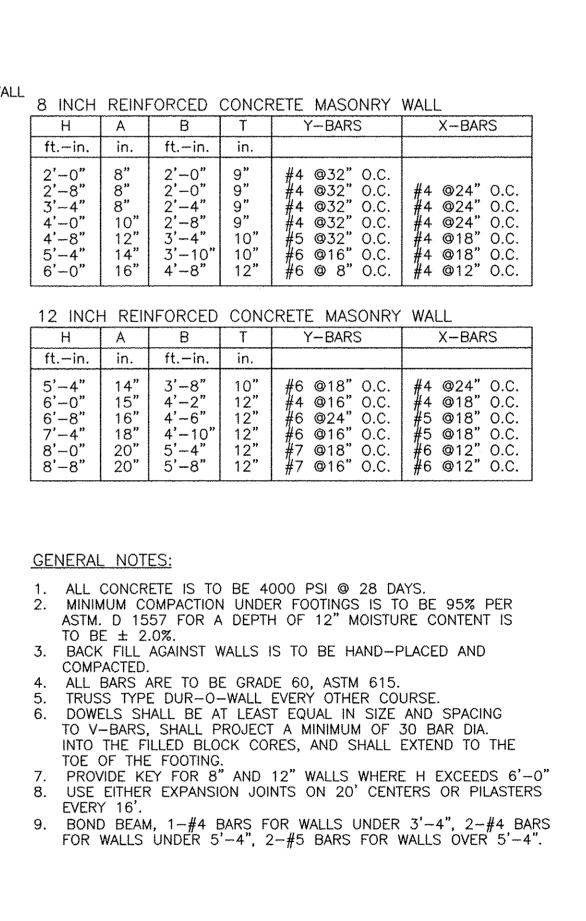

SIGN TYPE R7-8 (12"x18")

SIGN LETTERING AND BORDER ARE GREEN INTERNATIONAL SYMBOL OF ACCESSIBILITY

SIGN LETTERING AND BORDER ARE GREEN

2" DIA.x.188 GALV.

FINISH GRADE -

1'-6" DIA. CONC.-

BASE 3000 PSI

STEEL PIPE

MOTORCYCLE PARKING SIGN

IS WHITE ON A BLUE BACKGROUND

REQUIRED LANGUAGE PER

NMSA 197866-7-352.4C

fine and/or towing)

SIGN FIELD IS WHITE

-REQUIRED LANGUAGE


(VAN ACCESSIBLE)

PER ANSI 502.7


(Violators are subject to a

_SIGN TYPE R7-8A (6"x12")

SIGN FIELD IS WHITE

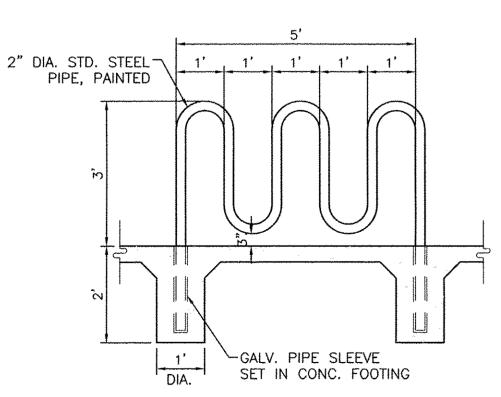



BIKE RACK DETAIL SCALE: 1/2"=1

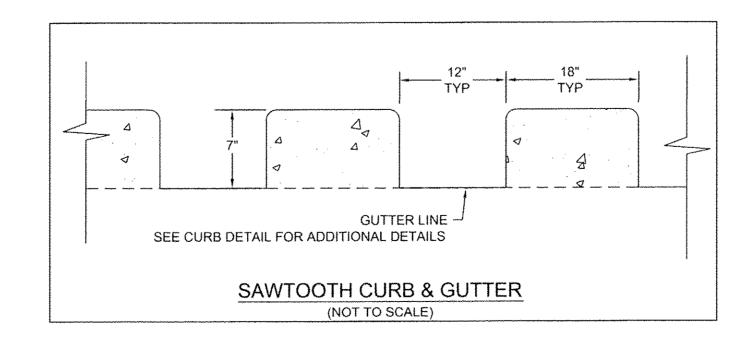

RETAINING WALL DETAIL

ENGINEER'S SEAL	PRIMROSE SCHOOL OF NW ALBUQUERQUE	<i>DRAWN BY</i> pm
NO R PP4.		<i>DATE</i> 5–21–18
SIBBA HOWN RESISTANCE OF THE STATE OF THE ST	CONSTRUCTION DETAILS	DRAWING
		SHEET #
ROFESSIONAL	TIERRA WEST, LLC 5571 MIDWAY PARK PL NE ALBUQUERQUE, NEW MEXICO 87109	6
RONALD R. BOHANNAN P.E. #7868	(505) 858-3100 www.tierrawestllc.com	<i>JOB #</i> 2017092

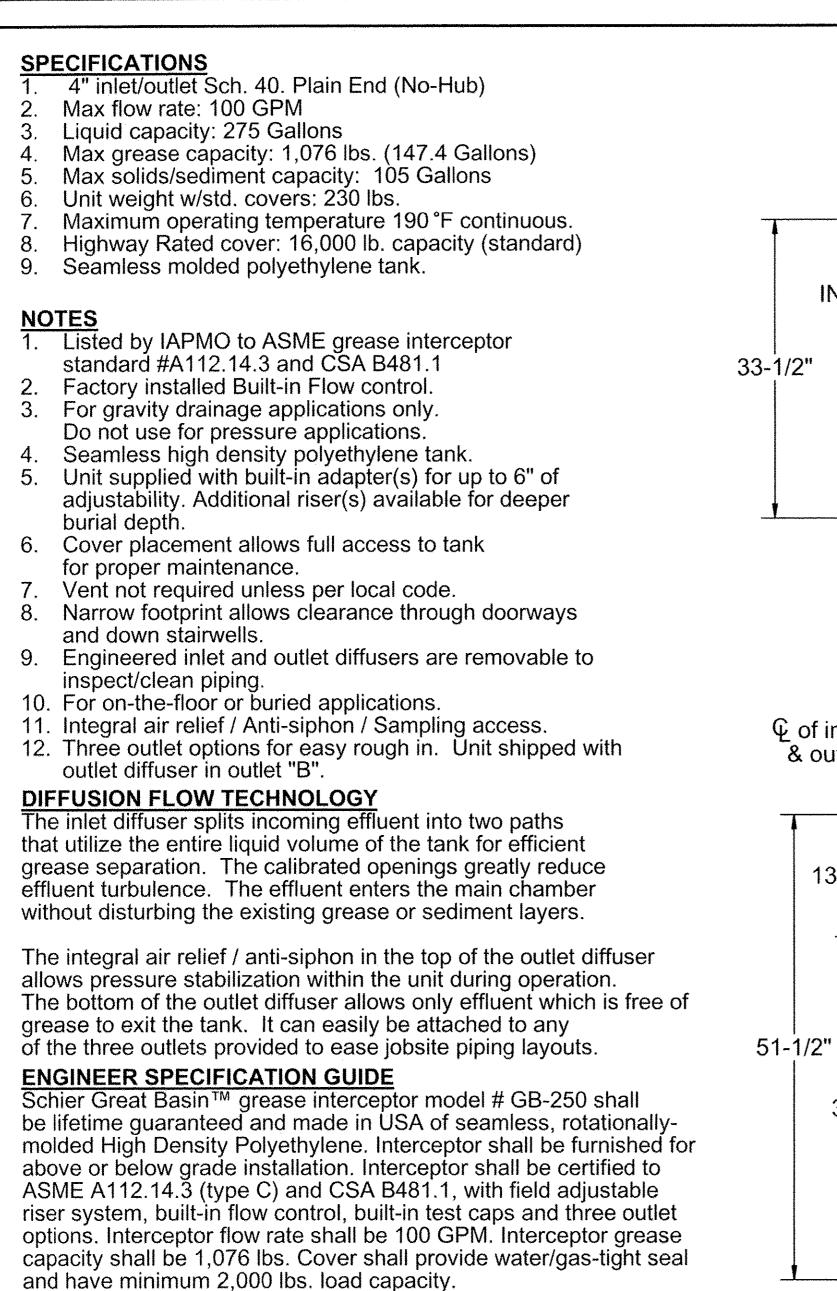

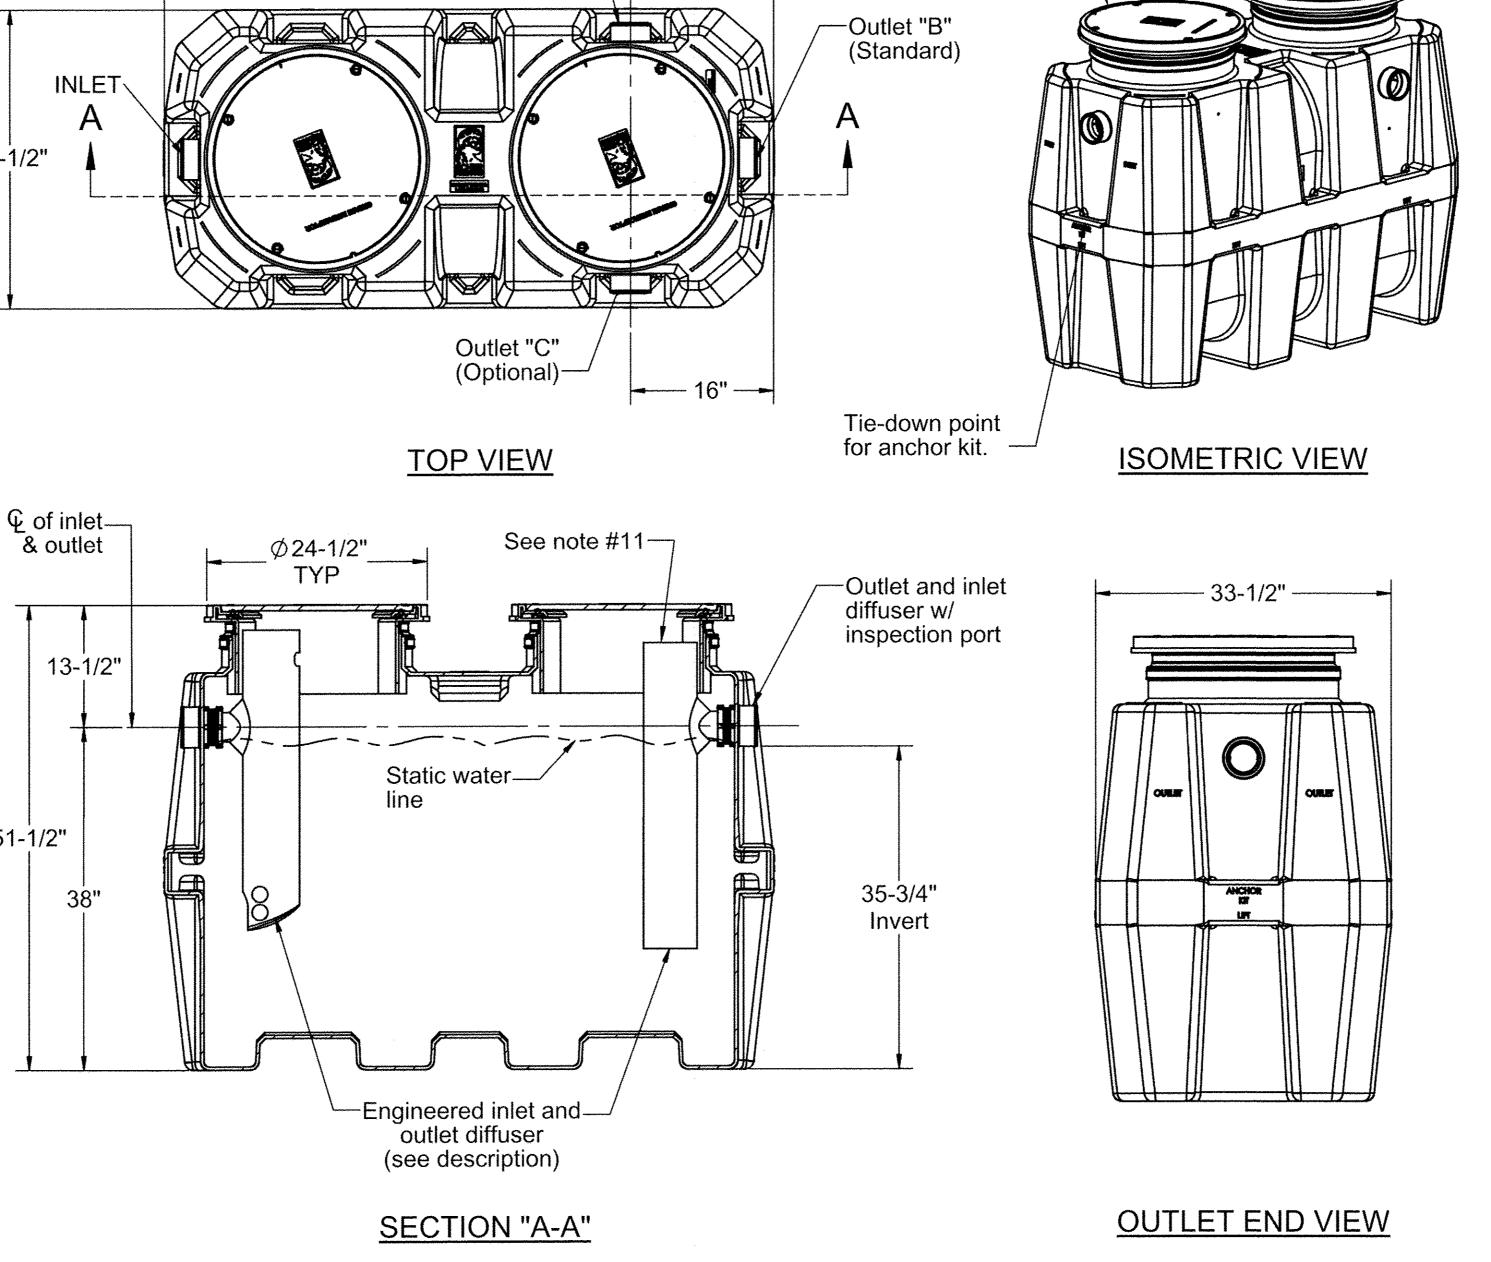


Outlet "A"

FLOW

(Optional)—


Adjustable

adapter

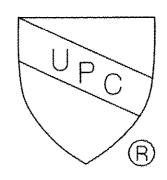

Clamping collar kit

OPTIONS:

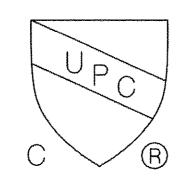

PROPRIETARY AND CONFIDENTIAL

Teleglide field adjustable risers for extending covers to grade

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H20 rated Cast Iron Cover: 20,000lb capacity

Pedestrian rated cover: 2,000 lb. capacity

6" Plain end pipe connections (Inlet/Outlet "B" only)
High water anchor kit

Male pipe thread connections

MODEL NUMBER: GB-250 PART NUMBER: 4055-001-XX

SPECIFICATION SHEET

DESCRIPTION:

DWG BY: N.EBERT

100 GPM POLYETHYLENE GREASE INTERCEPTOR

DATE: 07/02/2014 REV: 9 ECO: 1035

Schier Products
9500 Woodend Road
Edwardsville, KS 66111
Tel: 800-827-7119
Fax: 800-827-9664
www.schierproducts.com

Made in the U.S.A

PRODUCTS Pioneering Drain Line Purity

ENGINEER'S SEAL	PRIMROSE SCHOOL OF NW ALBUQUERQUE	<i>DRAWN BY</i> pm
O B BC	OF INVI ALBOCOLINCOL	DATE
AND RAOMANA	CONSTRUCTION DETAILS	5-21-18
REG 44 868 HE	CONCINCOTION DETAILO	DRAWING
1/3/ 171/8		SHEET #
PROFESSIONAL	TIERRA WEST, LLC 5571 MIDWAY PARK PL NE ALBUQUERQUE, NEW MEXICO 87109	7
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