

DEVELOPMENT REVIEW BOARD SUPPLEMENTAL SUBMITTAL

PROJECT NO. 1004000/ PR-2018-0001
Application No. SI-2018-00031

10:
Kym Dicome, DRB Chair, Planning Department
James Hughes, P.E., HydrologyRacquel Michel, P.E., Transportation DevelopmentKris Cadena, P.E., Albuquerque/ Bernalillo Co. WUABen McIntosh, Code EnforcementJason Coffey, Parks/Municipal Development
NOTE: PDF Required *(Please attach this sheet with each collated set per board member)
NEXT HEARING DATE: July 11, 2018
NOTE: REQUESTS FOR DEFERRAL OF CASES WILL BE DISCUSSED BY THE BOARD AND THE APPLICANT AND/OR AGENT AT THE BEGINNING OF THE AGENDA. BOTH PARTIES MUST AGREE UPON THE DATE OF DEFERRAL. IF THE APPLICANT/AGENT IS NOT PRESENT, THE ADMINISTRATIVE ASSISTANT MUST RECEIVE A LETTER, PRIOR TO THE HEARING DATE, REQUESTING A SPECIFIC DEFERRAL DATE. THE BOARD WILL DISCUSS AND MAKE A DECISION AT THE HEARING. THE APPLICANT/AGENT WILL THEN BE INFORMED OF THE DEFERRAL DATE AND REASON. IF THE APPLICANT IS NOT PRESENT WHEN THEIR REQUEST IS CALLED, THEN THE REQUEST MAY BE INDEFIINITELY DEFERRED ON A NO SHOW.
SUBMITTAL DESCRIPTION: Updated Plan Set with comments
CONTACT NAME: Jonathan Niski
TELEPHONE: 505-858-3100 EMAIL: jniski@tierrawestll.com

TIERRA WEST, LLC

June 28, 2018

Kym Dicome DRB Chair P.O. Box 1293 Albuquerque, NM 87103

RE: PRIMROSE DRB PROJECT NUMBER: 2018-001183 (1004000) SITE DEVELOPMENT PLAN FOR BUILDING PERMIT

Dear: Ms. Dicome:

Please find the following responses addressing comments received at DRB listed below:

Transportation Development

- 1. Remove ramp at NW corner of the site and place sidewalk at property line. The ramp was removed.
- 2. Provide sidewalk width on site around playground. Dimensions were added to all of the sidewalks around the playground.
- 3. Provide detail for "speed reducer". The speed reducer detail is found on Sheet 6.
- 4. Verify with NMDOT whether sidewalk along Paseo del Norte is required. We have contacted NMDOT and they are reviewing if they need the sidewalk or not. We should receive a response back from them prior to the DRB Hearing. We have left it on the plans for now and will update the sheets if it is not required.
- 5. Right of way dedication is required. We are unsure why a right of way dedication is required. The current right of way width is 86 feet and the street ends at a cul de sac. The sidewalk was moved to the back of the right of way line and a public pedestrian easement will be recorded at the time of platting.
- 6. A cross lot access easement is required. A cross lot access easement is noted on Sheet 1 and will be provided on the plat.

Hydrology

- Revisions are still required to the Grading and Drainage Plan.
 A revised Conceptual Grading Plan and Drainage Report was submitted to Hydrology on June 26th.
- Hydrology recommends that any necessary revisions to the previously approved Infrastructure List be made prior to Work Order.
 Base on the revised Grading Plan and Drainage Report there are no public drainage facilities required for this project.


If you have any questions or need additional information regarding this matter, please do not hesitate to contact me.


Sincerely,

Ronald R. Bohannan, PE

CC:

JN: 2017092 RRB/jn/kw

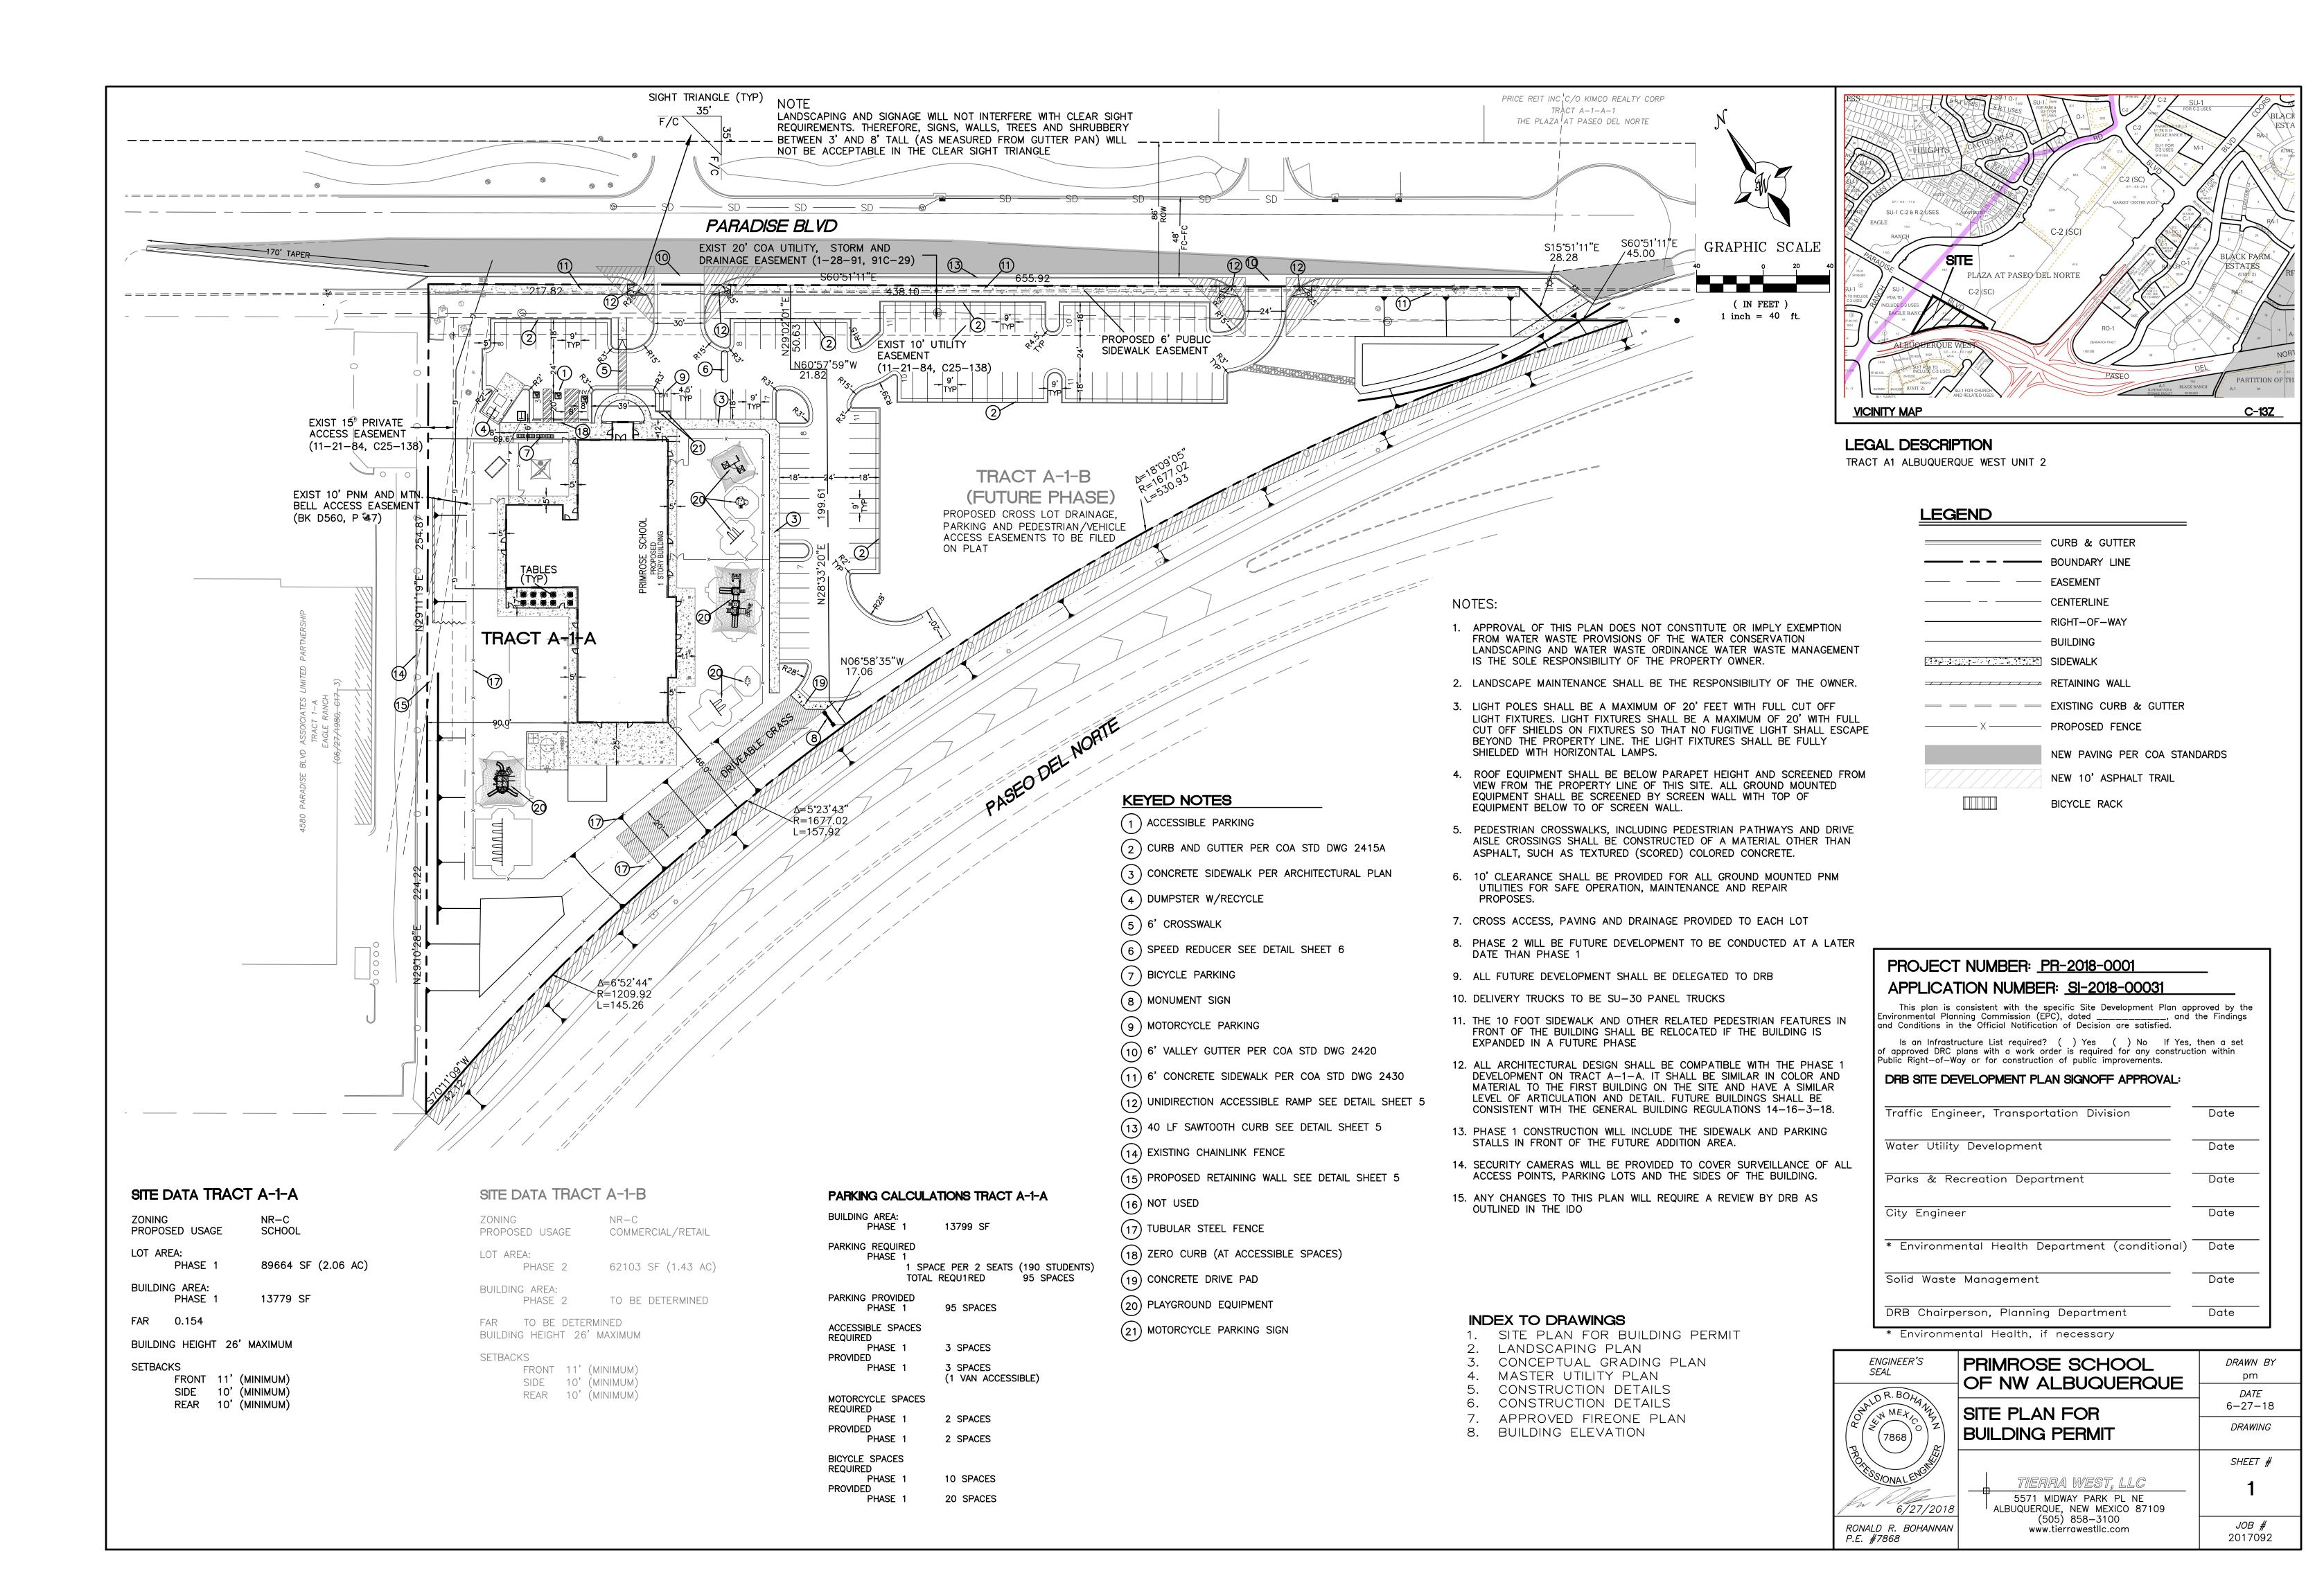

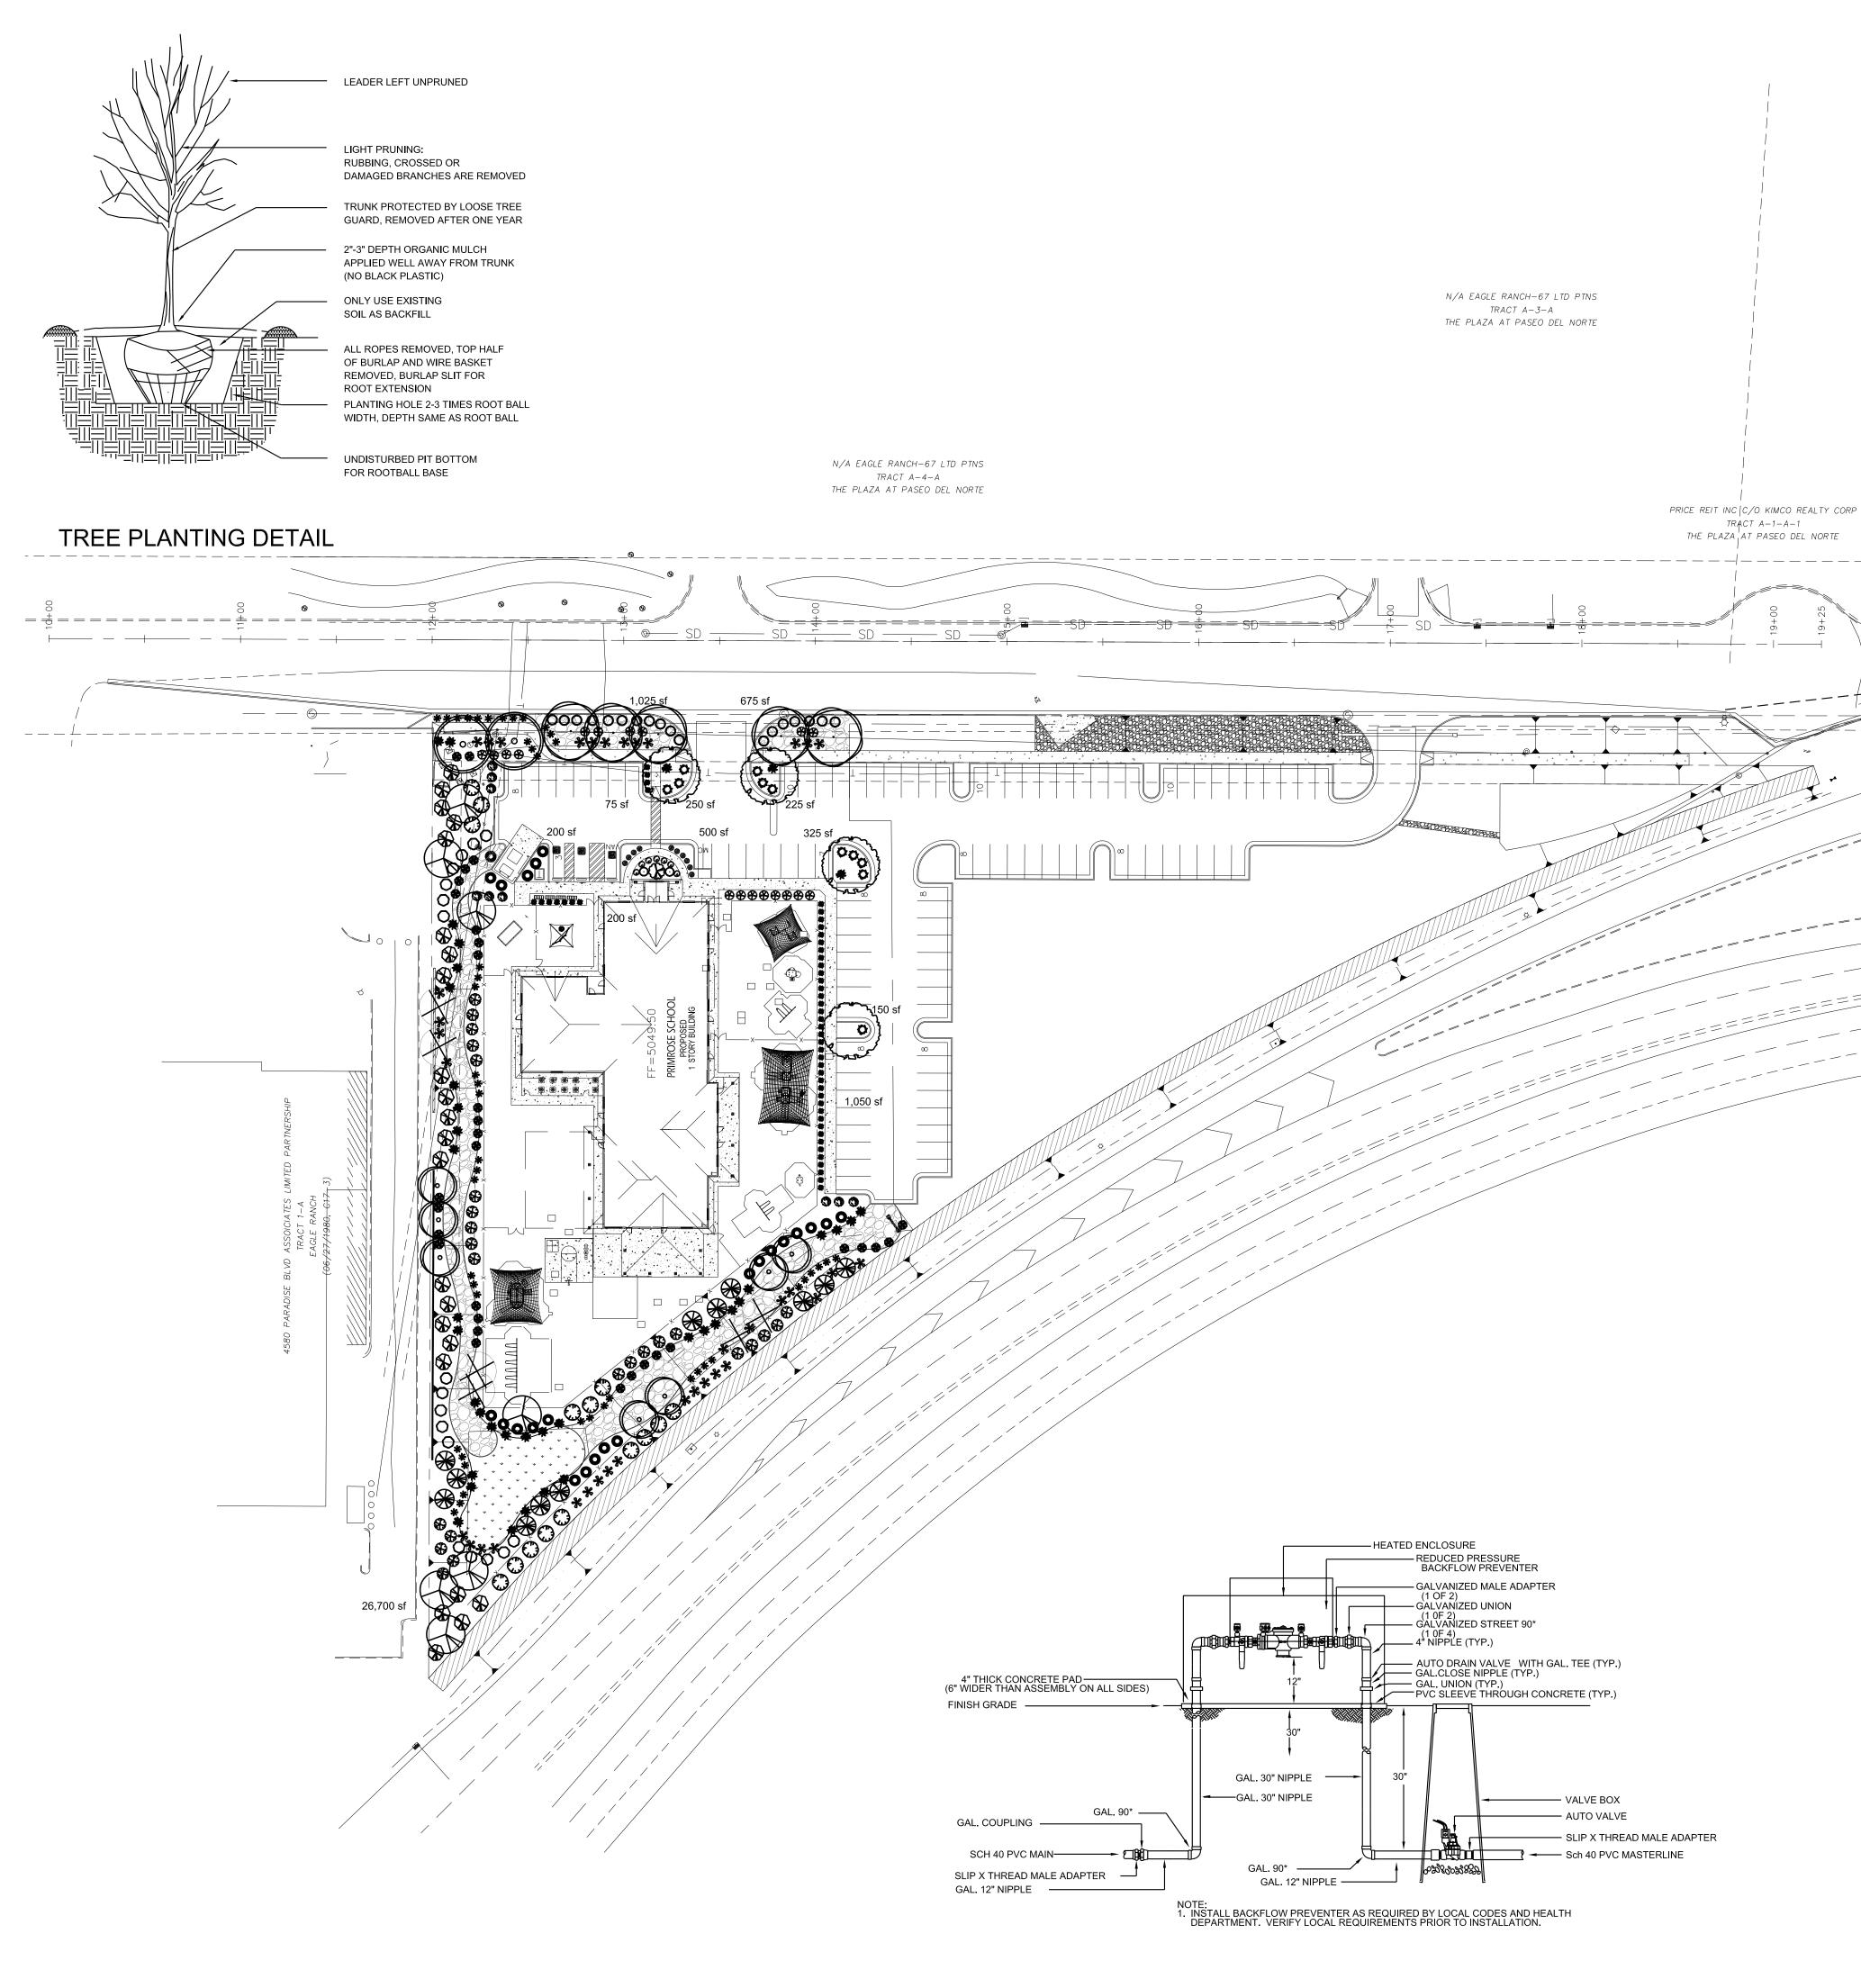

RP BACKFLOW/MASTER VALVE DETAIL

PLANT LEGEND

Qty.	Symbol	Scientific Name Common Name	Installed	Mature	Landscape	Water	Drip
	Trees				ead Coverage		mitters
2	\odot	Fraxinus Autumn Purple Ash	2" B&B	40'/40'	50 sf=100 sf	Medium	+6-2 gp
5	$\overline{(\cdot)}$	Ulmus Lacebark Elm	2" B&B	50'/20'	50 sf=250 sf	Medium	6-2 gp
4		Pistacia chinensis Chinese Pistache	2" B&B	60'/60'	50 sf=200 sf	Medium	+6-2 gp
7	\odot	Forestiera NM Olive	5-Gal	20'/20'	100 sf=700 sf	Medium-	+ 6 - 2 gp
7	\bigcirc	Chilopsis Desert Willow	5-Gal	20'/20'	100 sf=700 sf	Low	6-2 gp
6		Vitex Chaste Tree	5-Gal	20'/20'	100 sf=600 sf	Medium	6-2 gp
Shrubs	s/Groundco	overs					
17	\bigcirc	Buddleia davidii Butterfly Bush	1-Gal	6'/6'	64 sf=1088 sf	Medium	2-2 gp
9	13. 36.78 13. 36.78	Caryopteris clandonensis Blue Mist	1-Gal	4'/4'	25 sf=225 sf	Medium	2-2 gp
23	\otimes	Vauquelinia Rosewood	5-Gal	10'/10	' 100 sf=2300 sf	Medium	2-2 gp
18	0	Rhus aromatica Gro Low Sumac	5-Gal	2'/6'	64 sf=1152 sf	Low +	2-2 gp
18	\bigotimes	Ericameria laricifolia 'Aguirre' Turpentine Bush	5-Gal	3'/4'	35 sf=630 sf		2-1 gp
37	*	Hesperaloe parviflora Red Yucca	5-Gal	3'/4'	30 sf=1110 sf		2-1 gpl
11	Shall F	Juniperus sabina 'Buffalo' Buffalo Juniper (female)	5-Gal	2'/6'	64 sf=704 sf		2-2 gpl
25		Perovskia atriplicifolia Russian Sage	1-Gal	5'/5'	50 sf=1250 sf	Medium	2-2 gpl
1		Lagerstroemia Crape Myrtle	5-Gal		100 sf=100 sf		-
7		Nepeta Catmint	1-Gal	1'/3'	6 sf=42 sf	Medium	2-2 gpl
2	0	Pinus mugo Mugho Pine	5-Gal	4'/4'	30 sf=60 sf	Medium	
12		Caesalpinia Bird of Paradise	5-Gal		100 sf=1200 sf		<u>.</u>
15	₩	Rhus trilobata 3 Leaf Sumac	5-Gal	2'/6'	64 sf=960 sf		2-2 gp
31 39	**	Dasylirion Sotol Yucca pendula	5-Gal 5-Gal		64 sf=1984 sf		2-1 gpl
ວອ Grasse	**	Softblade Yucca	5-Gai	4/4	64 sf=2496 sf	LOW +	2-1 gpl
47	*	Muhlenbergia Deer Grass	1-Gal		40 sf=1880 sf	Low+	2-2 gph
10	**	Muhlenbergia Regal Mist Grass	1-Gal	3'/3'	15 sf=150 sf	Medium	
24		Panicum Switch Grass	1-Gal	8'/6'	36 sf=864 sf	Medium	-
49		Calamagrotis Karl Foerster Grass	5-Gal	3'/2'	10 sf=490 sf	Medium	2-2 gph
	.O.	Nami Derster Grass	Tota	I Landsca	ape Coverage=2	21,235 SF	

MATERIALS LEGEND

NATIVE SEED

_____89,631 SF _____13,779 SF

_____75,852 SF

31,375 SF

11/11

23,531 SF MIN.

21,235 SF

SITE DATA

LESS BUILDING(S) NET LOT AREA

REQUIRED LANDSCAPE

15% OF NET LOT AREA

PROPOSED LANDSCAPE

HIGH WATER USE TURF

PERCENT OF NET LOT AREA

REQUIRED STREET TREES

PROVIDED STREET TREES

38 SPACES (Phase 1)/10

1 PER 10 SPACES

(2" cal or 6' ht.)

MAX. 20% OF LANDSCAPE AREA

REQUIRED PARKING LOT TREES

TOTAL TREE REQUIRED/PROVIDED

REQUIRED LANDSCAPE COVERAGE

75% LIVE VEGETATIVE MATERIAL

NATIVE SEED/100 % COVERAGE

PROVIDED GROUNDCOVER COVERAGE

PERCENT GROUNDCOVER COVERAGE

OF REQUIRED LANDSCAPE AREAS

IRRIGATION NOTE

DRIP SYSTEM RUN CYCLES: ESTABLISHMENT AND SUMMER: 1 HOUR/4 DAYS A WEEK

1 HOUR/2-3 DAYS A WEEK

FALL: 1 HOUR/2-3 DAYS A WEEK

1 HOUR/2 DAYS PER MONTH

PROPOSED HIGH WATER USE TURF PERCENT OF LANDSCAPE AREA

1 PER 30 L.F. OF STREET FRONTAGE

PROVIDED PARKING LOT TREES (Phase 1)

(31,375 SF PROPOSED LANDSCAPE X 75%)

TOTAL PROVIDED GROUNDCOVER COVERAGE 23,560 SF

GROSS LOT AREA (2.05 ac)

7/8" BROWN GRAVEL MULCH 2"-4" COBBLESTONE

NOTE

MAINTENANCE OF LANDSCAPE (ONSITE AND WITHIN ROW) TO BE MAINTAINED BY PROPERTY OWNER

PLANTINGS TO BE WATERED BY AUTO. DRIP IRRIGATION SYSTEM WITH REDUCED PRESSURE BACKFLOW PREVENTER PER CITY OF ALBUQUERQUE

WATER MANAGEMENT IS THE SOLE RESPONSIBILITY OF THE PROPERTY OWNER

THIS PLAN IS TO COMPLY WITH C.O.A. LANDSCAPE AND WATER WASTE ORDINANCE 6-1-1. PLANTING RESTRICTIONS APPROACH

IT IS THE INTENT OF THIS PLAN TO PROVIDE MIN. 75% LIVE GROUNDCOVER OF LANDSCAPE AREAS AT MATURITY PER ORDINANCE 14-16-3-10 (SEE CALCULATIONS PROVIDED ABOVE)

LANDSCAPE AREAS TO BE MULCHED WITH GRAVEL MULCH AT 2"-3" DEPTH

APPROVAL OF THE LANDSCAPE PLAN DOES NOT CONSTITUTE OR IMPLY COMPLIANCE WITH, OR EXEMPTION FROM, THE C.O.A LANDSCAPE AND WATER WASTE ORDINANCE 6-1-1.

NO PARKING SPACE SHALL BE MORE THEN 100' FROM A TREE.

STREET TREES TO CONFORM TO STREET TREE ORDINANCE

LANDSCAPE PLAN TO CONFORM TO ZONING REGULATIONS ORDINANCE14-16-3-10.

LANDSCAPING AND SIGNING WILL NOT INTERFERE WITH CLEAR SIGHT REQUIREMENTS. THEREFORE, SIGNS, WALLS, TREES AND SHRUBBERY BETWEEN 3 AND 8 FEET TALL (AS MEASURED FROM THE GUTTER PAN) WILL NOT BE ALLOWED IN THIS AREA.


IRRIGATION SYSTEM: AN AUTOMATIC UNDERGROUND IRRIGATION SYSTEM WILL BE UTILIZED TO PROVIDE EVEN AND ADEQUATE WATER LEVELS TO ALL PLANT MATERIAL. WATER USE SHALL BE DONE IN SUCH A MANNER AS TO CONSERVE ITS USE AND PREVENT ANY AND ALL RUNOFF FROM LANDSCAPE MATERIALS. IRRIGATION SHALL BE RESTRICTED TO EARLY MORNING HOURS TO CONSERVE THIS LIMITED RESOURCE.

STREETSCAPE LANDSCAPING SHALL CONSIST PRIMARILY OF SHRUBS AND DECIDUOUS TREES IN A SETBACK AREA BETWEEN THE RIGHT-OF-WAY OF THE STREET AND THE FACE OF THE CURB OF AN ADJACENT PARKING AREA. CLEAR-SIGHT TRIANGLE REQUIREMENTS MUST BE MET.

TREES IN PROXIMITY OF DUMPSTER TO BE MAINTAINED TO ALLOW FOR TRUCK ACCESS WITHOUT DAMAGE TO TRUCK OR TREES


www.headsuplandscape.com

PO Box 10597 Albuquerque, NM 87184 505.898.9615 505.898.2105 (fax) design@hulc.com

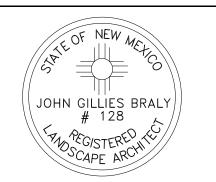


Date:_	2/21/18	
Revisio	ns:	
A _		_
_		
_		
_		

Drawn by: jc Reviewed by: jb

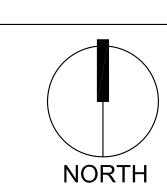


Scale: 1" = 40'

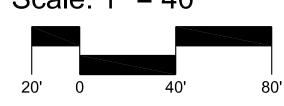

Sheet Title:

Landscape Plan

Sheet Number:

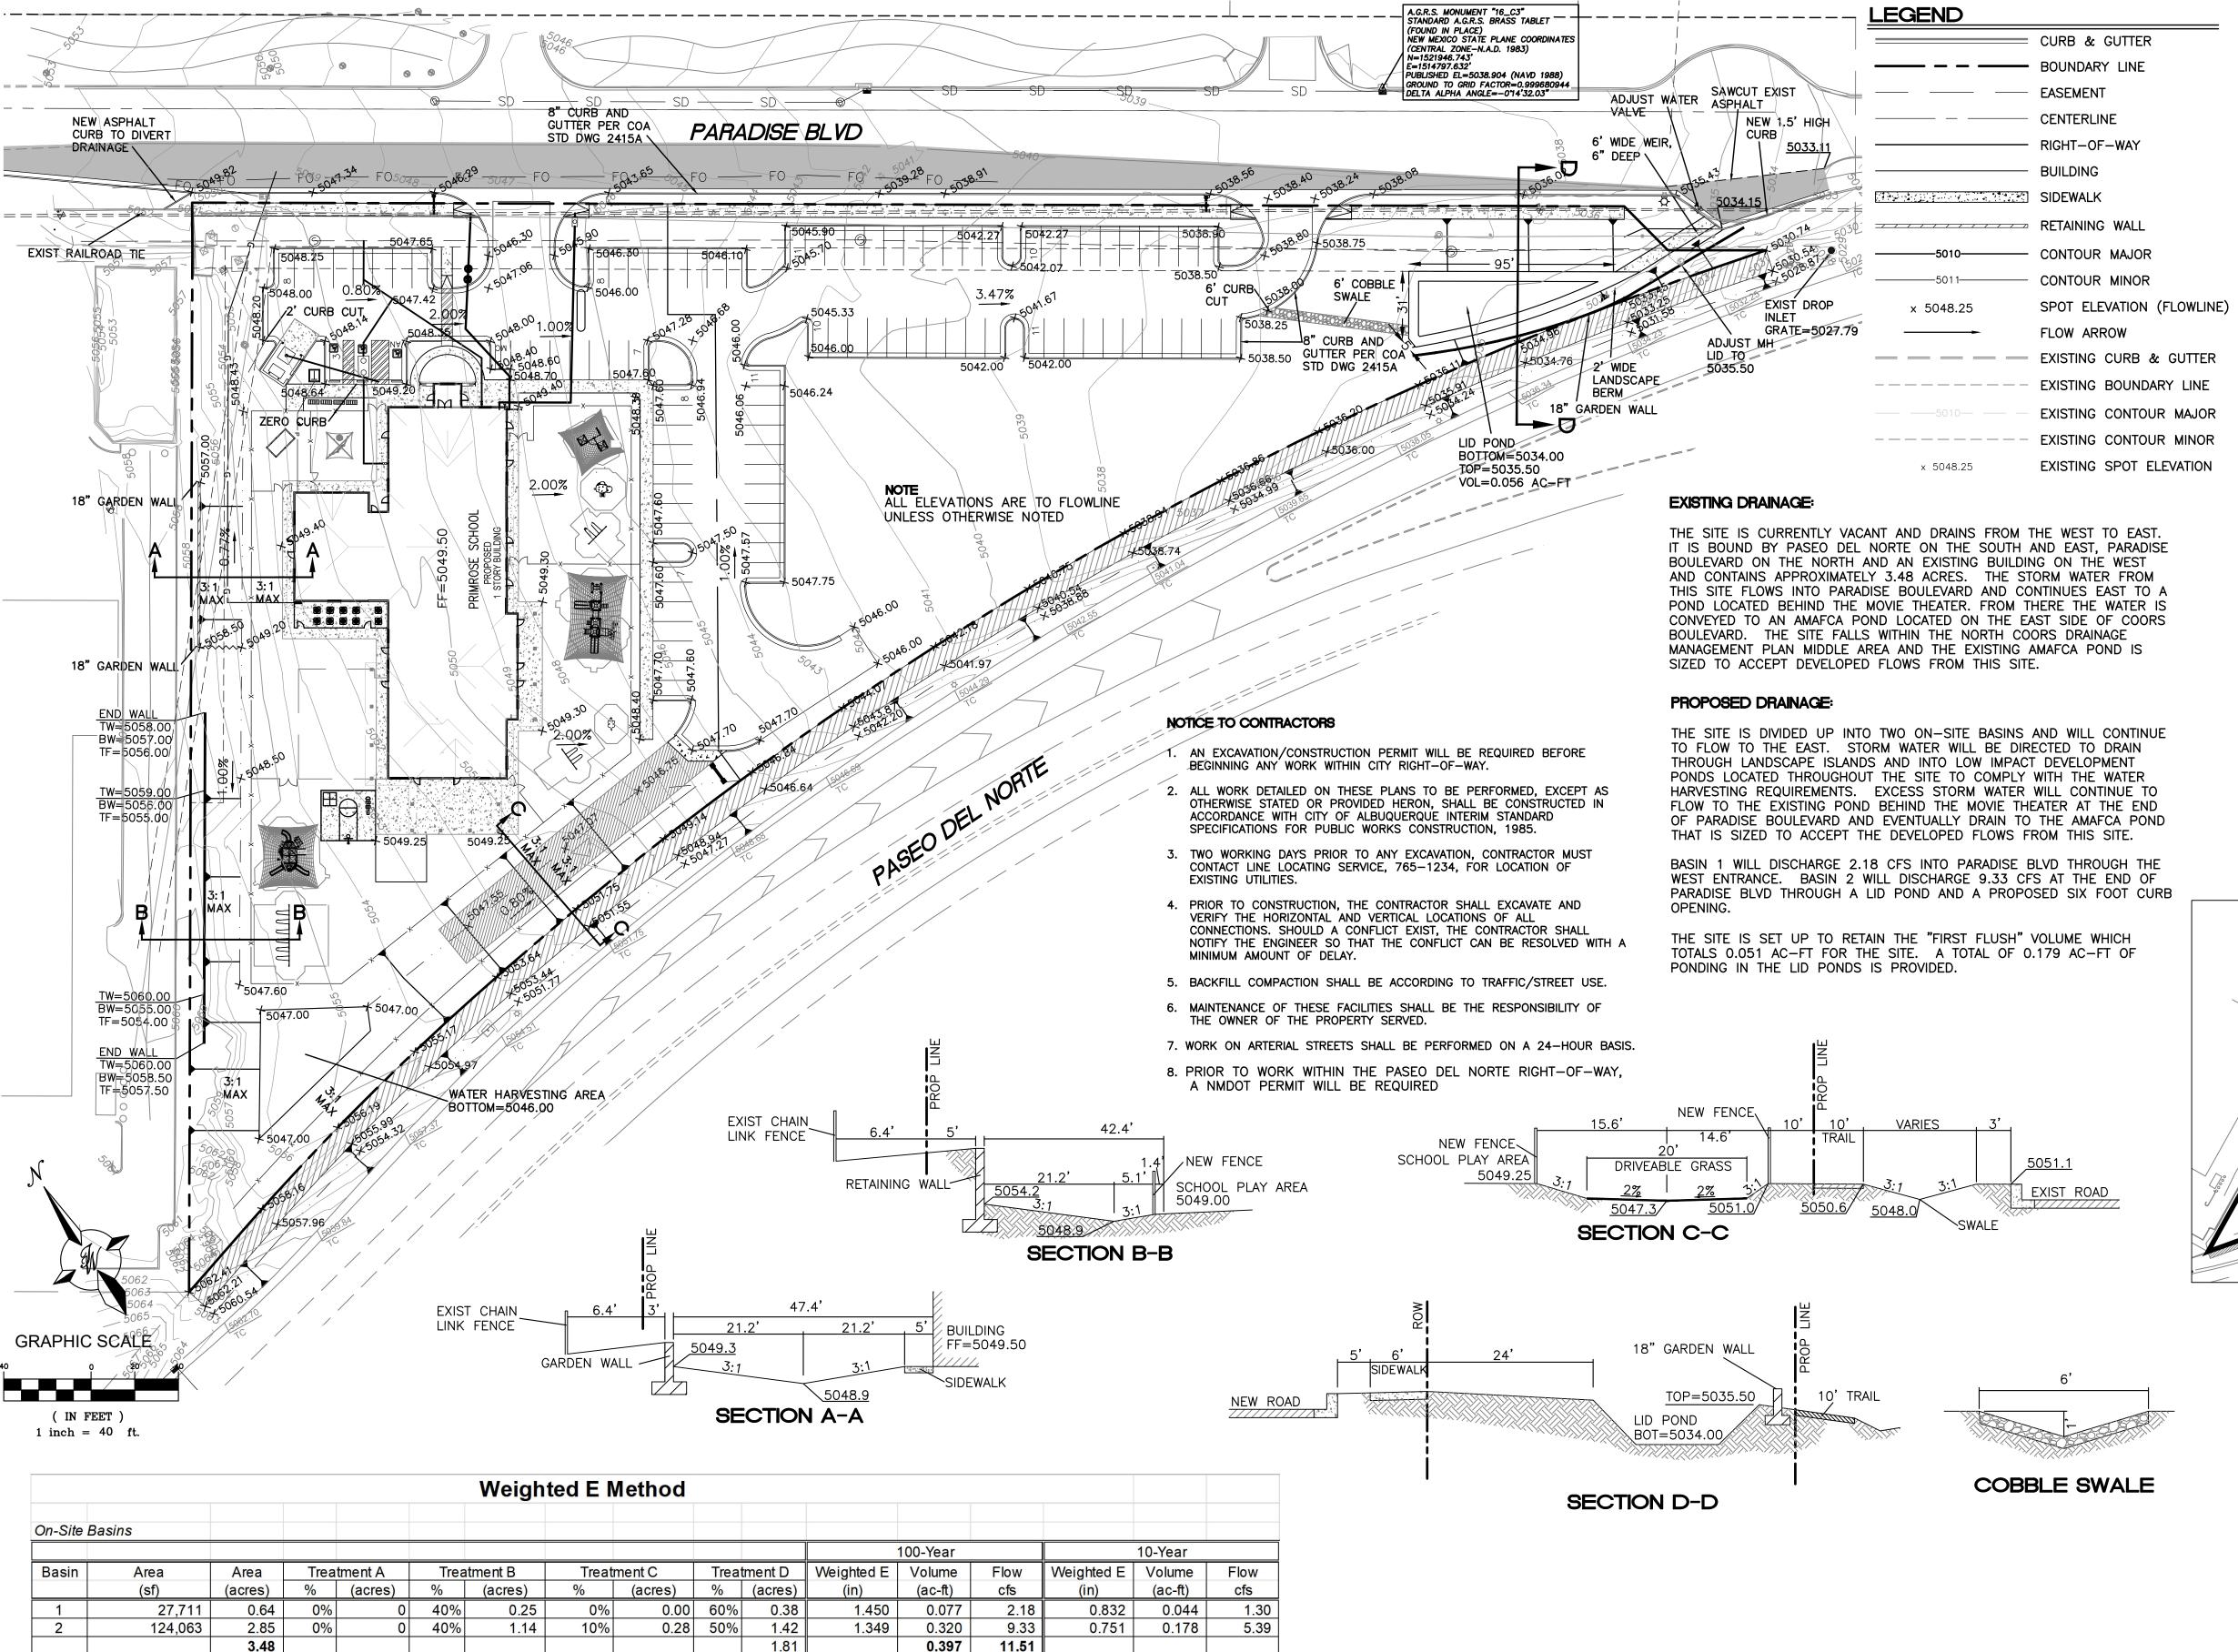

Peak Discharge (cfs/acre)

1.29

2.03

2.87

4.37

100-Year | 10 - Year

0.24

0.76

1.49

2.89

Zone 1

 Q_a

 Q_b

 Q_c

 Q_d

Excess Precipitation, E (inches)

Zone 1 | 100-Year | 10 - Year

0.44

0.67

0.99

1.97

0.08

0.22

0.44


1.24


Equations:

Volume = Weighted D * Total Area

Flow = Qa * Aa + Qb * Ab + Qc * Ac + Qd * Ad

Weighted E = Ea*Aa + Eb*Ab + Ec*Ac + Ed*Ad / (Total Area)

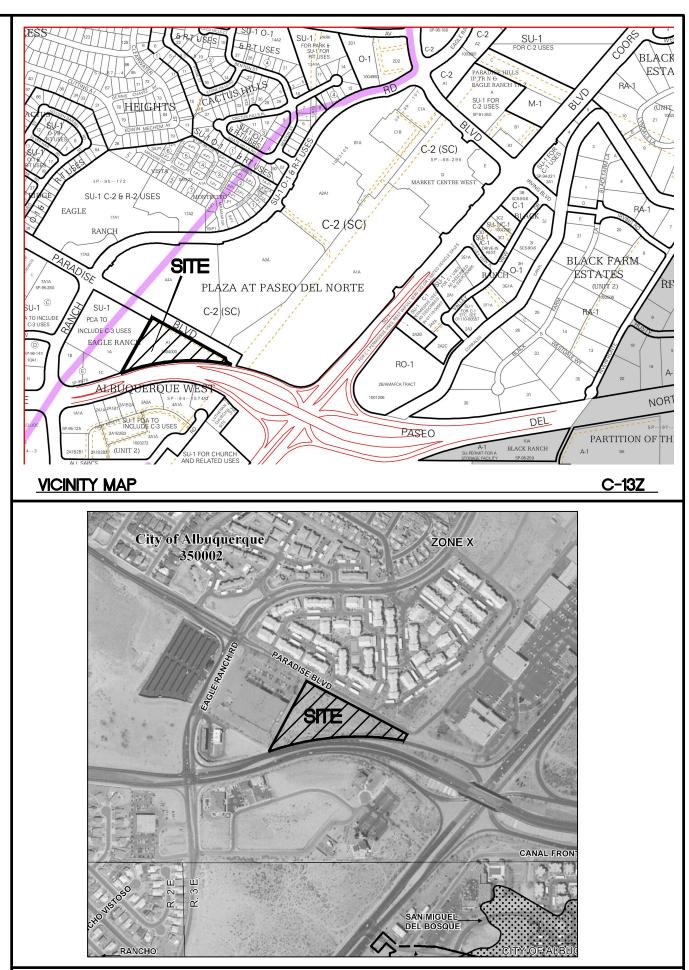

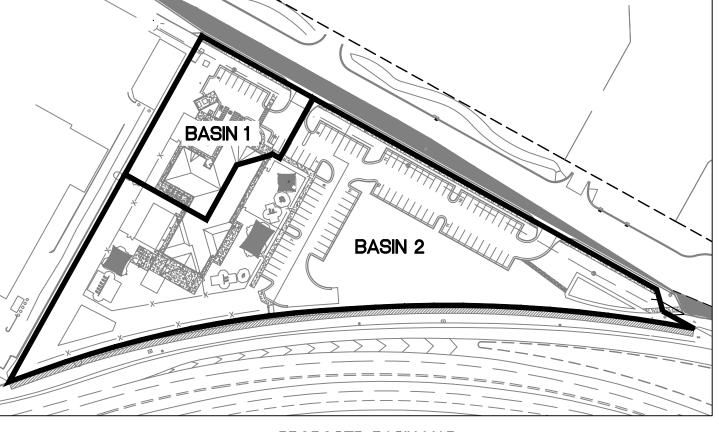

35001C0116G

PROPOSED BASIN MAP

EROSION CONTROL NOTES:

1. CONTRACTOR IS RESPONSIBLE FOR OBTAINING A TOPSOIL DISTURBANCE PERMIT PRIOR TO BEGINNING WORK.

FIRM MAP: (EFFECTIVE DATE 9-26-2008)


- 2. CONTRACTOR IS RESPONSIBLE FOR MAINTAINING RUN-OFF ON SITE DURING CONSTRUCTION.
- 3. CONTRACTOR IS RESPONSIBLE FOR CLEANING ALL SEDIMENT THAT GETS INTO EXISTING RIGHT-OF-WAY.
- 4. REPAIR OF DAMAGED FACILITIES AND CLEANUP OF SEDIMENT ACCUMULATIONS ON ADJACENT PROPERTIES AND IN PUBLIC FACILITIES IS THE RESPONSIBILITY OF THE CONTRACTOR.
- 5. ALL EXPOSED EARTH SURFACES MUST BE PROTECTED FROM WIND AND WATER EROSION PRIOR TO FINAL (CITY) ACCEPTANCE OF ANY PROJECT.

ENGINEER'S SEAL	PRIMROSE SCHOOL OF NW ALBUQUERQUE	<i>DRAWN BY</i> pm
OR. BOHANA DE LA	CONCEPTUAL GRADING	<i>DATE</i> 6-27-18
((7868))	PLAN	DRAWING
PORTESSIONAL ENGINE		SHEET #
25/1257/220188	TIERRA WEST, LLC 5571 MIDWAY PARK PL NE ALBUQUERQUE, NEW MEXICO 87109	3
RONALD R. BOHANNAN P.E. #7868	(505) 858-3100 www.tierrawestllc.com	<i>JOB #</i> 2017092

CAUTION:


FIRST FLUSH CALCULATION

78844 SF X 0.34"/12"=2,234 CF =0.051 AC-FT ALL EXISTING UTILITIES SHOWN WERE OBTAINED FROM RESEARCH, AS-BUILTS, SURVEYS OR INFORMATION PROVIDED BY OTHERS. IT SHALL BE THE SOLE RESPONSIBILITY OF THE CONTRACTOR TO CONDUCT ALL NECESSARY FIELD INVESTIGATIONS PRIOR TO AND INCLUDING ANY EXCAVATION, TO DETERMINE THE ACTUAL LOCATION OF UTILITIES AND OTHER IMPROVEMENTS, PRIOR TO STARTING THE WORK. ANY CHANGES FROM THIS PLAN SHALL BE COORDINATED WITH AND APPROVED BY THE ENGINEER.

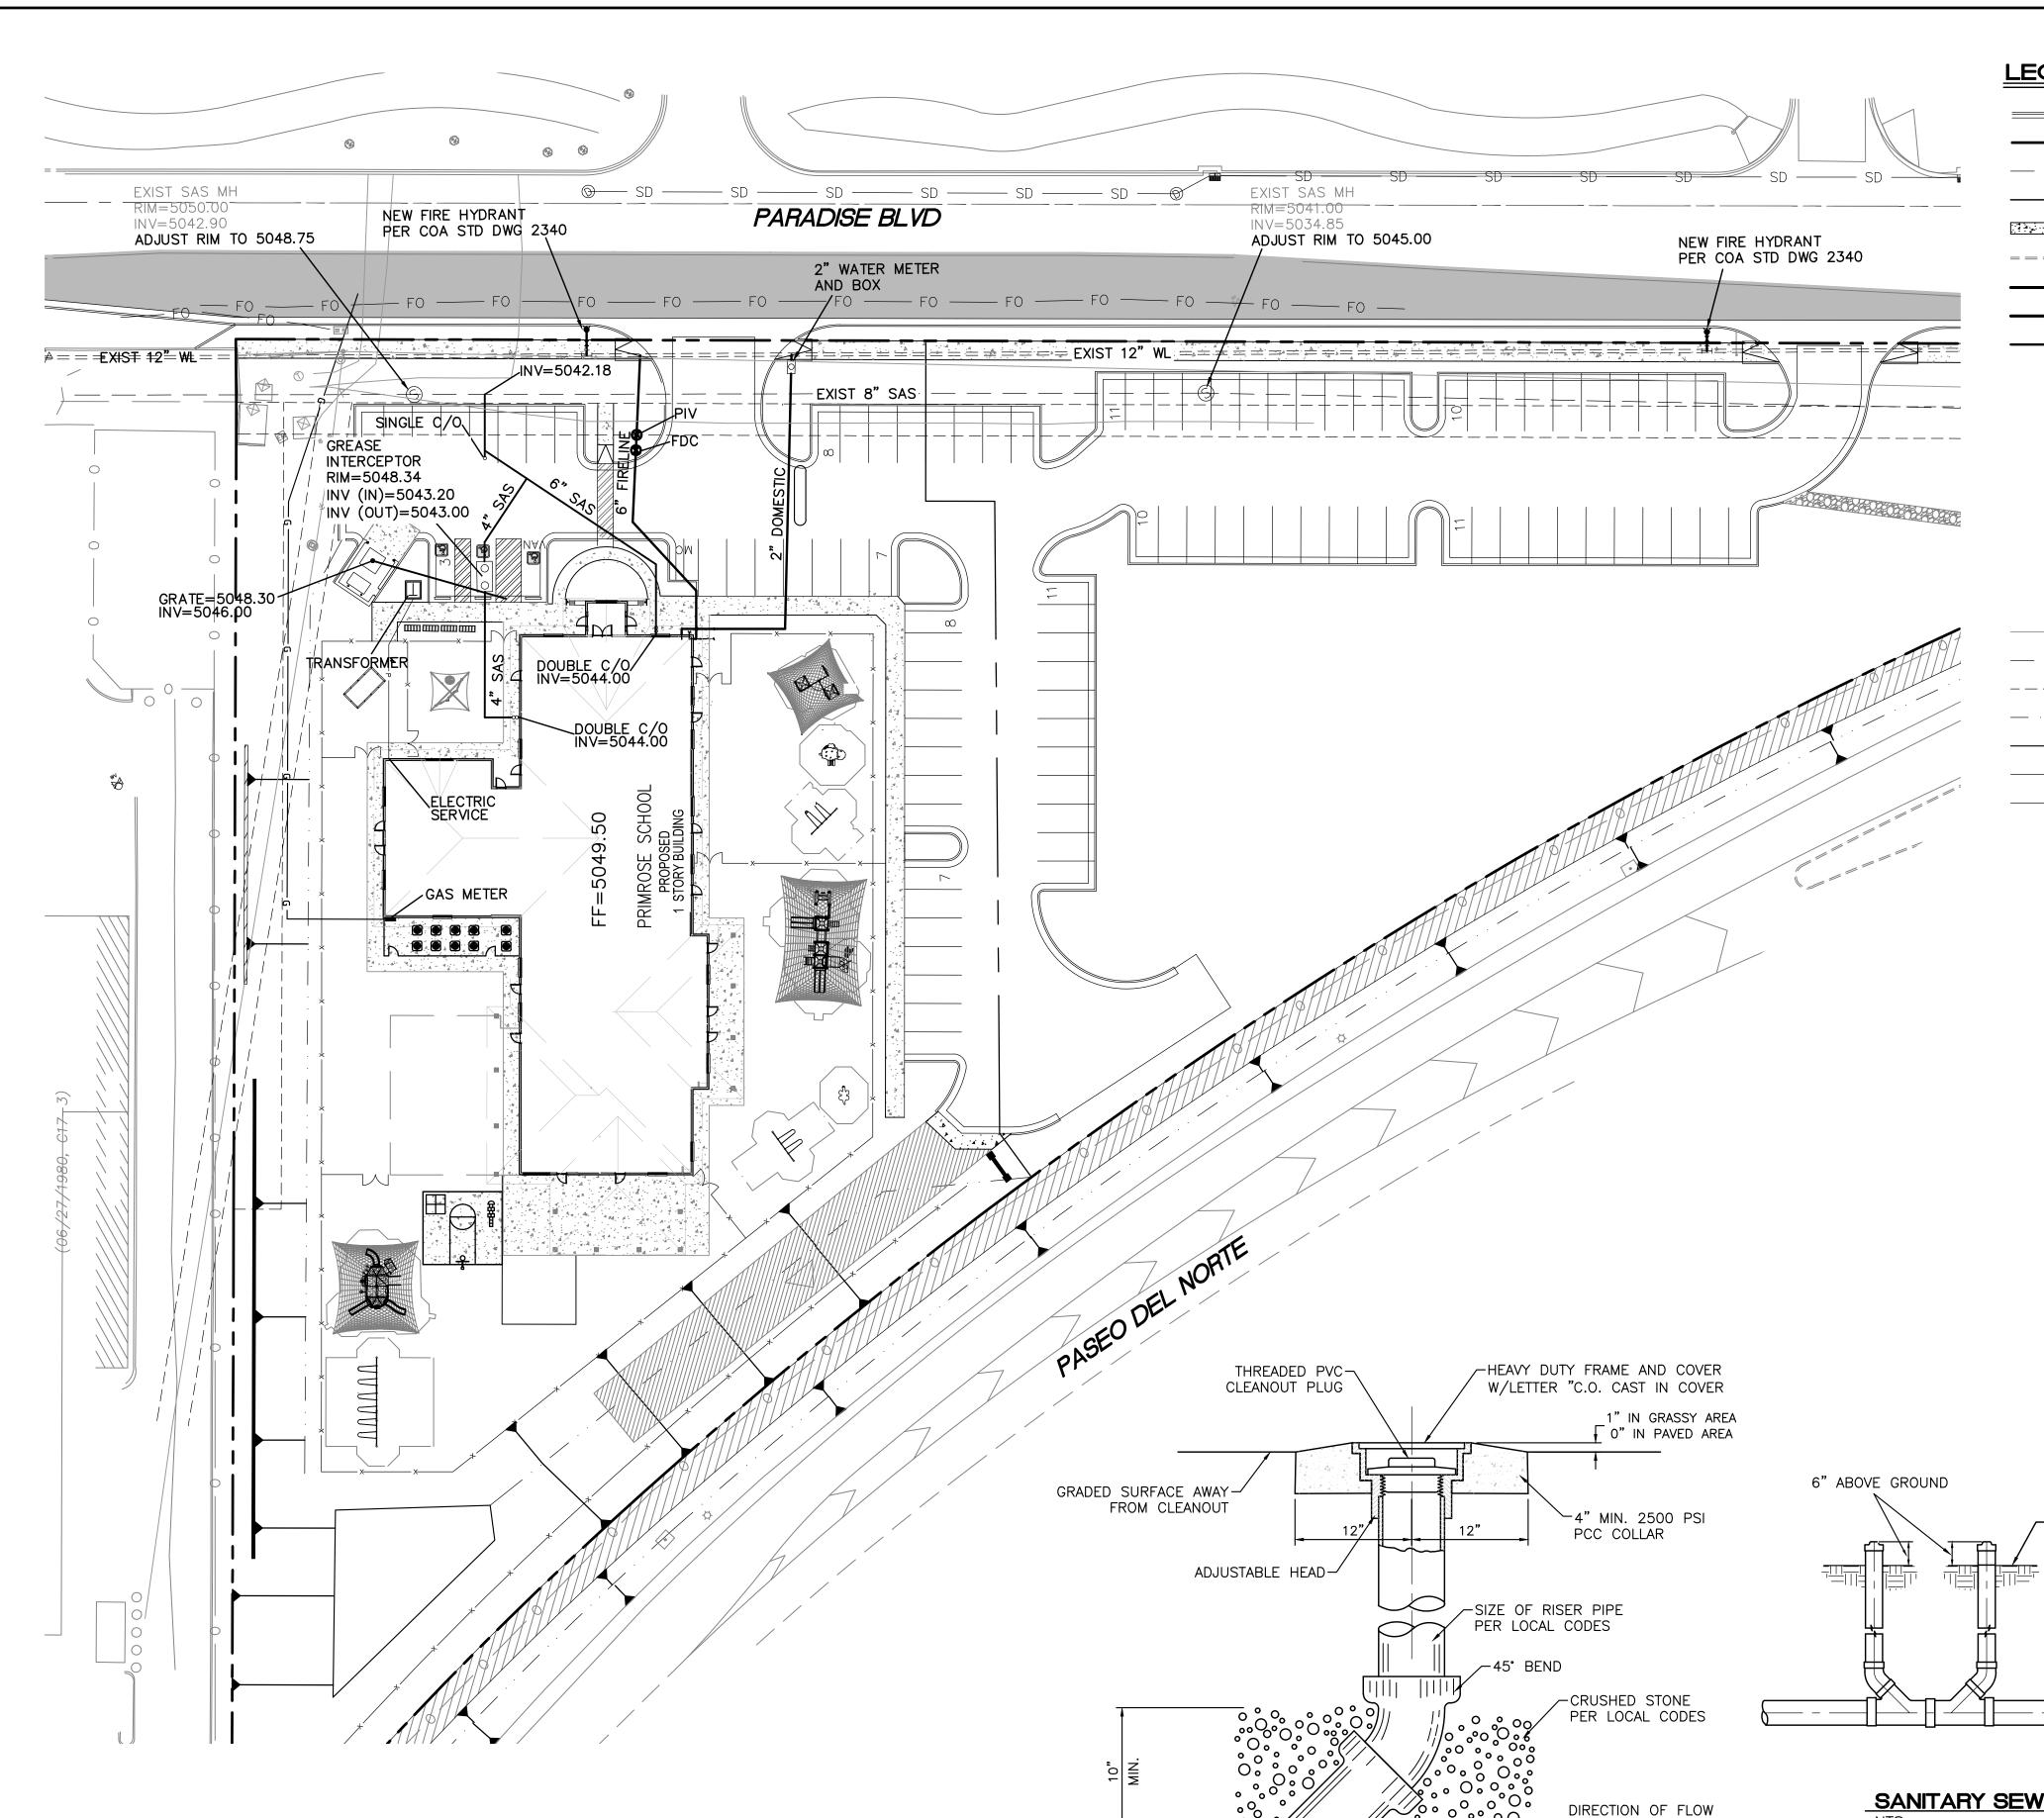



CURB & GUTTER BOUNDARY LINE — BUILDING SIDEWALK ======= EXISTING CURB & GUTTER -36" SD------ STORM SEWER LINE 8" SAS——— SANITARY SEWER LINE WL——— WATERLINE SINGLE CLEAN OUT DOUBLE CLEAN OUT EXISTING SD MANHOLE EXISTING INLET EXISTING SAS MANHOLE EXISTING FIRE HYDRANT EXISTING WATER METER EXISTING POWER POLE EXISTING GAS VALVE EXISTING GAS — EX. 8" SAS— EXISTING SANITARY SEWER LINE ----EX. WL---- EXISTING WATER LINE — · —EX. RCP— · — EXISTING STORM SEWER LINE

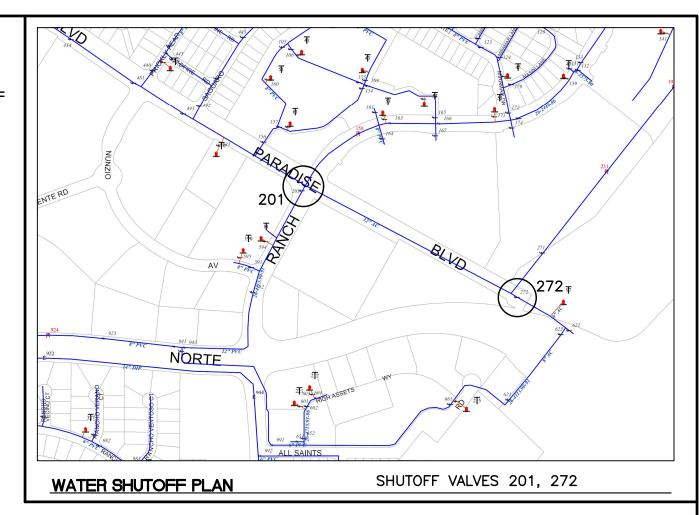

THE CONTRACTOR SHALL COORDINATE WITH THE WATER AUTHORITY SEVEN (7) DAYS IN ADVANCE OF PERFORMING WORK THAT WILL AFFECT THE PUBLIC WATER OR SANITARY SEWER INFRASTRUCTURE. WORK REQUIRING SHUTOFF OF FACILITIES DESIGNATED AS MASTER PLAN FACILITIES MUST BE COORDINATED WITH THE WATER AUTHORITY 14 DAYS IN ADVANCE OF PERFORMING SUCH WORK. ONLY WATER AUTHORITY CREWS ARE AUTHORIZED TO OPERATE PUBLIC VALVES. SHUTOFF REQUESTS MUST BE MADE ONLINE AT http://abcwua.org/content/view/463/729/.

GENERAL UTILITY NOTES:


PROPSED GAS

PROPOSED POWER

PROPOSED TELEPHONE

- 1. ALL WATER AND SEWER UTILITY WORK TO BE DONE IN ACCORDANCE WITH COA STANDARDS AND SPECIFICATIONS LATEST EDITION.
- 2. 4' MINIMUM BURY REQUIRED FOR ALL UTILITIES UNLESS OTHERWISE NOTED.
- 3. REFERENCE ARCHITECTURAL PLANS FOR WATER LINE RISER LOCATIONS.
- 4. CLEAN OUTS ARE TO BE BUILT PER UNIFORM PLUMBING CODE STANDARDS.
- 5. ALL PLUMBING PIPE MATERIAL TO BE USED PER UPC.
- 6. FIRE LINE AND DOMESTIC WATERLINE MUST HAVE BACKFLOW PREVENTORS PER UPC. IF BACKFLOW PREVENTOR IS INSTALLED EXTERIOR OF BUILDING A HOT BOX SHALL BE INSTALLED AND USED.
- 7. ALL EX. SD INLETS AND MH SHALL HAVE CONCRETE COLLARS POURED AND BE ADJUSTED TO FINISHED GRADE.
- 8. ALL EXCAVATION, TRENCHING AND SHORING ACTIVITIES MUST BE CARRIED-OUT IN ACCORDANCE WITH OSHA 29 CFR 1926.650 SUBPART P.
- 9. ALL UTILITY DISTANCES SHOWN ARE FOR REFERENCE ONLY.

- 10. PNM HAS NUMEROUS ELECTRIC FACILITIES AT THIS SITE CURRENTLY SERVING EXISTING CUSTOMERS. THE APPLICANT SHALL COORDINATE WITH PNM REGARDING THESE EXISTING FACILITIES. ANY RELOCATION, CHANGES OR REALIGNMENT OF EXISTING ELECTRIC UTILITIES WILL BE THE DEVELOPER EXPENSE. IN SOME CASES, RELOCATION OR CHANGES TO EXISTING FACILITIES MAY NOT BE FEASIBLE DUE TO PHYSICAL, USE OR SAFETY CLEARANCE CONSTRAINTS.
- 11. PNM WILL REVIEW ALL TECHNICAL NEEDS, ISSUES AND SAFETY CLEARANCES FOR ITS ELECTRIC POWER SYSTEMS. ANY EXISTING AND PROPOSED PUBLIC UTILITY EASEMENTS SHALL BE INDICATED ON THE SITE PLAN UTILITY SHEET PRIOR TO DRB REVIEW. PNM'S STANDARD FOR PUBLIC UTILITY EASEMENTS IS 10 FEET IN WIDTH TO ENSURE ADEQUATE, SAFE CLEARANCES.
- 12. SCREENING SHALL BE DESIGNED TO ALLOW FOR ACCESS TO UTILITY FACILITIES. IT IS NECESSARY TO PROVIDE ADEQUATE CLEARANCE OF TEN FEET SURROUNDING ALL GROUND-MOUNTED UTILITIES FOR SAFE OPERATION, MAINTENANCE AND REPAIR PURPOSES.
- 13. ALL BUILDINGS CONSTRUCTION TYPE IS II-B

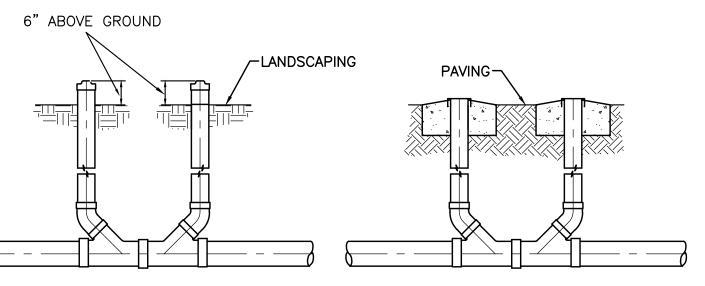



CAUTION:

-PLUG WYE IF SERVICE LATERIAL


DOES NOT CONTINUE

SEE PLAN FOR PIPE SIZE,


SANITARY SEWER CLEAN-OUT


TYPE, AND ELEVATION

ALL EXISTING UTILITIES SHOWN WERE OBTAINED FROM RESEARCH, AS-BUILTS, SURVEYS OR INFORMATION PROVIDED BY OTHERS. IT SHALL BE THE SOLE RESPONSIBILITY OF THE CONTRACTOR TO CONDUCT ALL NECESSARY FIELD INVESTIGATIONS PRIOR TO AND INCLUDING ANY EXCAVATION, TO DETERMINE THE ACTUAL LOCATION OF UTILITIES AND OTHER IMPROVEMENTS, PRIOR TO STARTING THE WORK. ANY CHANGES FROM THIS PLAN SHALL BE COORDINATED WITH AND APPROVED BY THE ENGINEER.

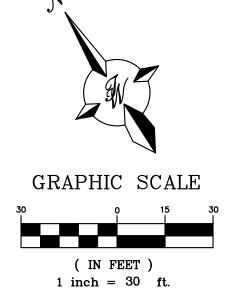

	1e	
ENGINEER'S SEAL	PRIMROSE SCHOOL OF NW ALBUQUERQUE	<i>DRAWN BY</i> pm
DR. BOHANAPA WMEXICO W		<i>DATE</i> 6-27-18
(((7868)))	MASTER UTILITY PLAN	DRAWING
PROPERTY OF THE PROPERTY OF TH		SHEET #
6/27/2018		4
RONALD R. BOHANNAN P.E. #7868	(505) 858-3100 www.tierrawestllc.com	<i>JOB #</i> 2017092

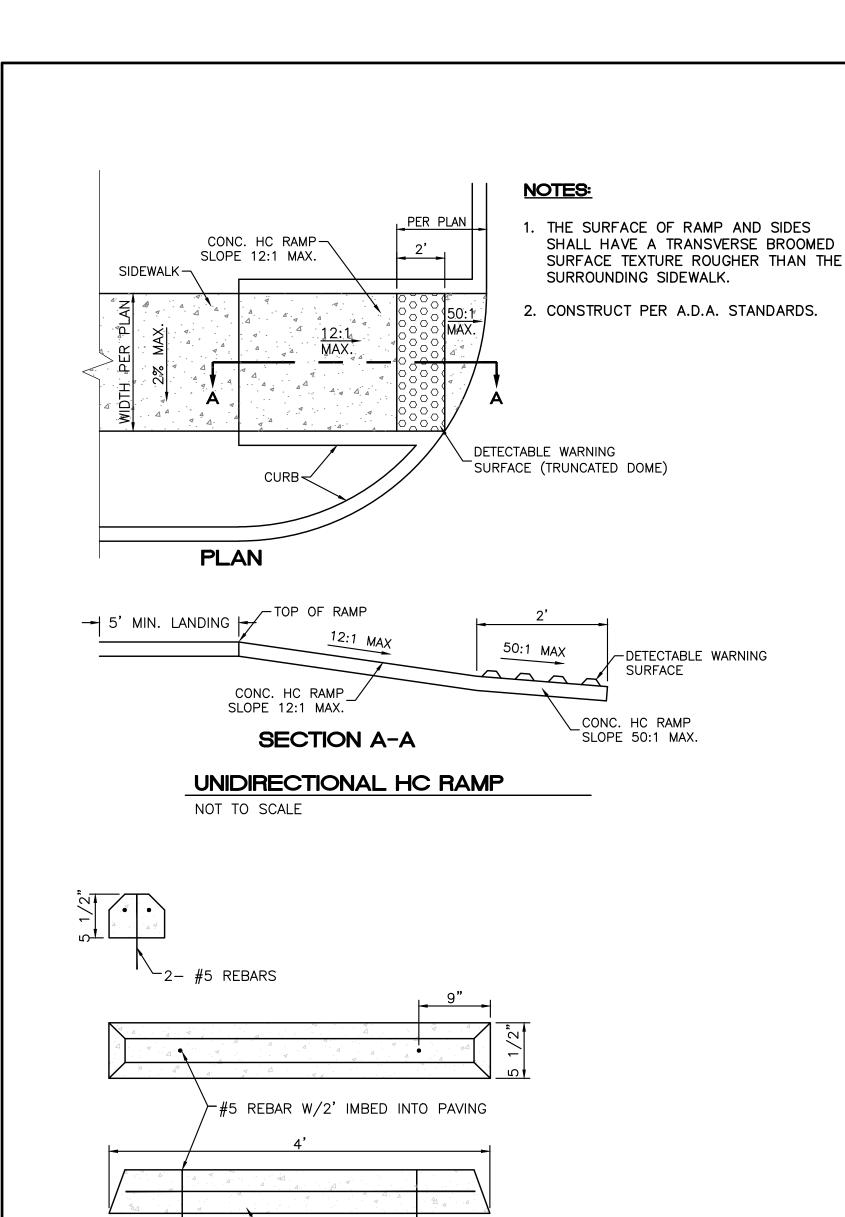

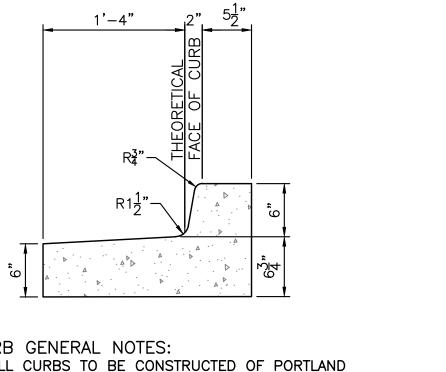

DOME SECTION

+ \odot \odot \odot \odot


DOME SPACING

CC - CENTER TO CENTER SPACING 2.35" BB - BASE TO BASE SPACING 1.48" MIN

BD - BASE DIAMETER 0.9" MIN


65% OF BD MAX

TD - TOP DIAMETER 50% OF BD MIN TO

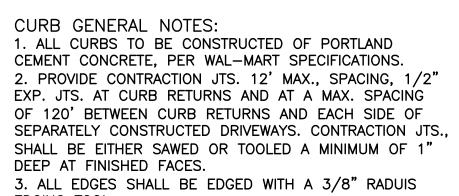

EDGING TOOL. 4. 1/4" ISOLATION JOINT SHALL BE PLACED BETWEEN SIDEWALK AND CURB WHEN CAST ADJACENT TO EACH

OTHER.

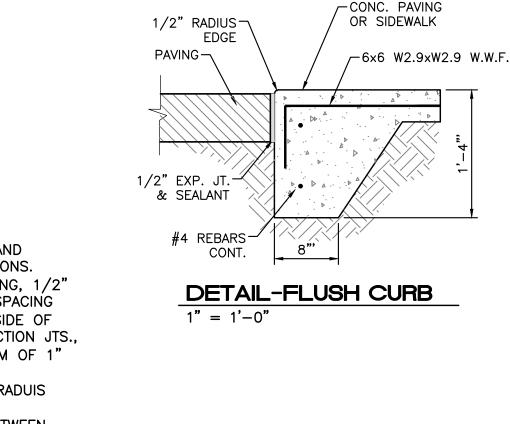

HANDICAPPED SIGNAGE-

SEE DETAIL THIS SHEET

PARKING BUMPER

2' FROM CURB"

INSTALLED W/#4 BARS

HC PARKING DETAIL

HC PARKING DETAIL SECTION A-A

- HANDICAPPED SIGNAGE

INSTALLED W/#4 BARS

- PARKING BUMPER


2' FROM CUŔB"

── 6" HEADER CURB


TYPICAL HC SPACE

SEE DETAIL THIS SHEET




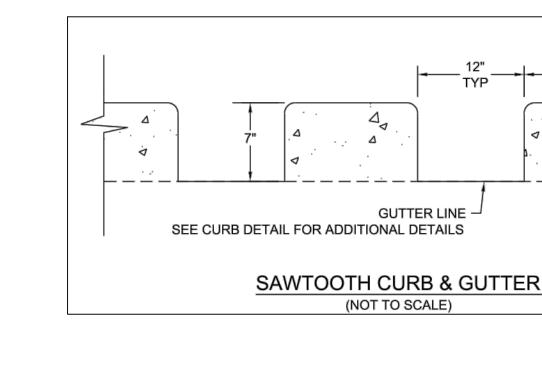




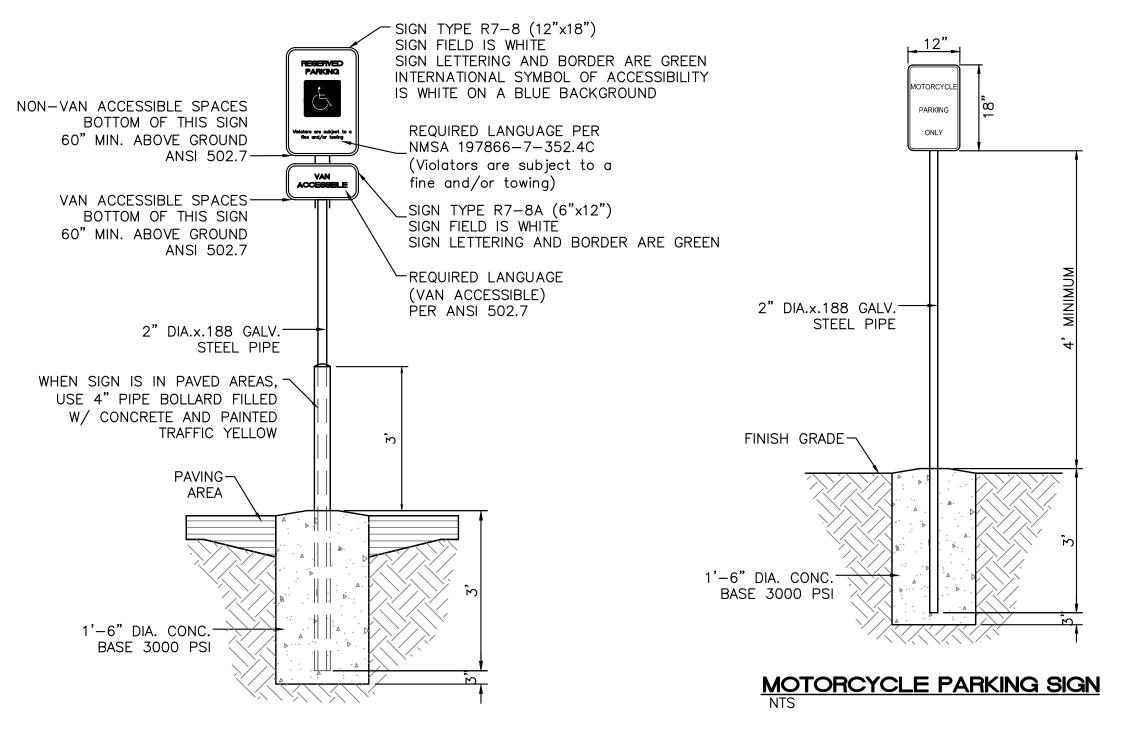

ACCESSIBLE PARKING SIGN

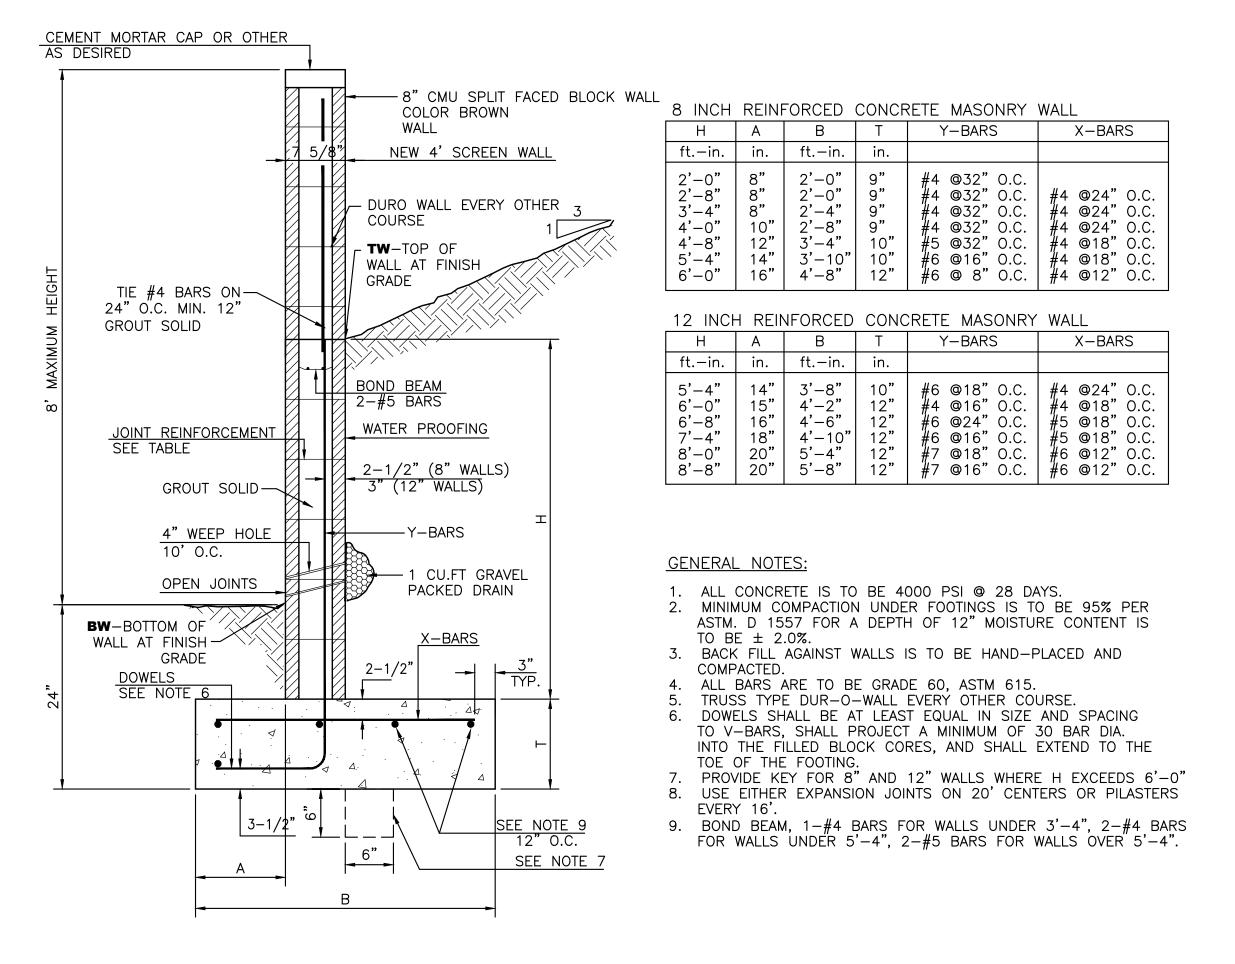

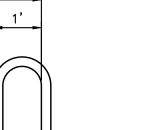

2" DIA. STD. STEEL ¬ PIPE, PAINTED GALV. PIPE SLEEVE

SET IN CONC. FOOTING

EPOXY TO A.C. PAVING

WHEEL BUMPER

SCALE: 1/2"=1'

BIKE RACK DETAIL

RETAINING WALL DETAIL

ENGINEER'S SEAL	PRIMROSE SCHOOL OF NW ALBUQUERQUE	<i>DRAWN BY</i> pm
OR. BOW	OI 1444 ALBOGOLITGOL	DATE
ON MEXICO Z	CONSTRUCTION DETAILS	6-27-18
(((7868)))		DRAWING
PROTEIN SONAL ENGINE		SHEET #
6/27/2018	T 5571 MIDWAY PARK PL NE ALBUQUERQUE, NEW MEXICO 87109	5
RONALD R. BOHANNAN P.E. #7868	(505) 858—3100 www.tierrawestllc.com	<i>JOB #</i> 2017092

SPECIFICATIONS

- 4" inlet/outlet Sch. 40. Plain End (No-Hub)
- Max flow rate: 100 GPM
- Liquid capacity: 275 Gallons
- Max grease capacity: 1,076 lbs. (147.4 Gallons)
 Max solids/sediment capacity: 105 Gallons
- Unit weight w/std. covers: 230 lbs.
- Maximum operating temperature 190 °F continuous. Highway Rated cover: 16,000 lb. capacity (standard) Seamless molded polyethylene tank.

- 1. Listed by IAPMO to ASME grease interceptor standard #A112.14.3 and CSA B481.1
- 2. Factory installed Built-in Flow control.
- For gravity drainage applications only.
- Do not use for pressure applications.
- 4. Seamless high density polyethylene tank.
 5. Unit supplied with built-in adapter(s) for up to 6" of adjustability. Additional riser(s) available for deeper burial depth.
- Cover placement allows full access to tank for proper maintenance.
- 7. Vent not required unless per local code.8. Narrow footprint allows clearance through doorways and down stairwells.
- Engineered inlet and outlet diffusers are removable to inspect/clean piping.
- 10. For on-the-floor or buried applications.
- 11. Integral air relief / Anti-siphon / Sampling access.
- 12. Three outlet options for easy rough in. Unit shipped with outlet diffuser in outlet "B".

DIFFUSION FLOW TECHNOLOGY

The inlet diffuser splits incoming effluent into two paths that utilize the entire liquid volume of the tank for efficient grease separation. The calibrated openings greatly reduce effluent turbulence. The effluent enters the main chamber without disturbing the existing grease or sediment layers

The integral air relief / anti-siphon in the top of the outlet diffuser allows pressure stabilization within the unit during operation.

The bottom of the outlet diffuser allows only effluent which is free of grease to exit the tank. It can easily be attached to any of the three outlets provided to ease jobsite piping layouts.


ENGINEER SPECIFICATION GUIDE

Schier Great Basin™ grease interceptor model # GB-250 shall be lifetime guaranteed and made in USA of seamless, rotationallymolded High Density Polyethylene. Interceptor shall be furnished for above or below grade installation. Interceptor shall be certified to ASME A112.14.3 (type C) and CSA B481.1, with field adjustable riser system, built-in flow control, built-in test caps and three outlet options. Interceptor flow rate shall be 100 GPM. Interceptor grease capacity shall be 1,076 lbs. Cover shall provide water/gas-tight seal and have minimum 2,000 lbs. load capacity.

OPTIONS:


- H20 rated Cast Iron Cover: 20,000lb capacity
- Pedestrian rated cover: 2,000 lb. capacity
 Teleglide field adjustable risers for extending covers to grade
 Male pipe thread connections
- 6" Plain end pipe connections (Inlet/Outlet "B" only)
- High water anchor kit
- Clamping collar kit




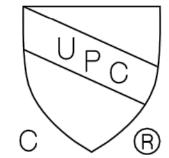

PROPRIETARY AND CONFIDENTIAL

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FLOW

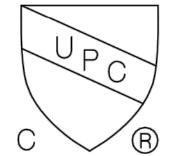
INLET.

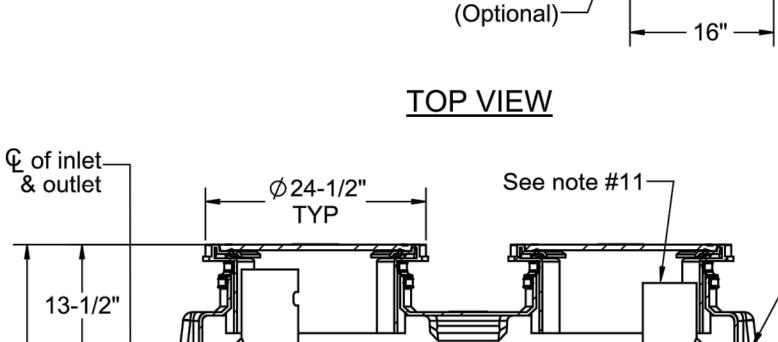33-1/2"

DESCRIPTION:

DWG BY:


N.EBERT

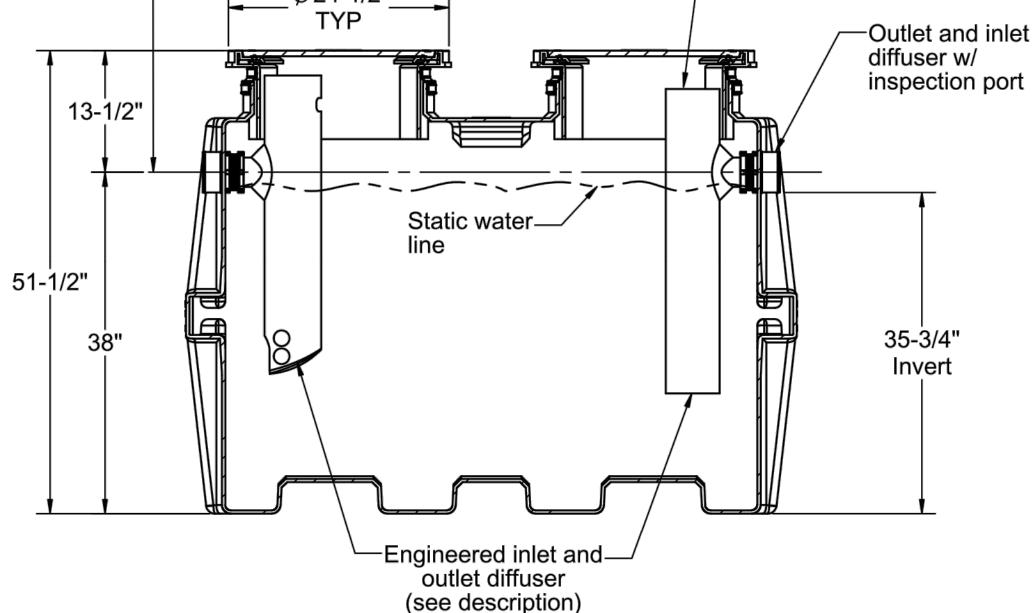

Outlet "A"

Outlet "C"

(Optional)—

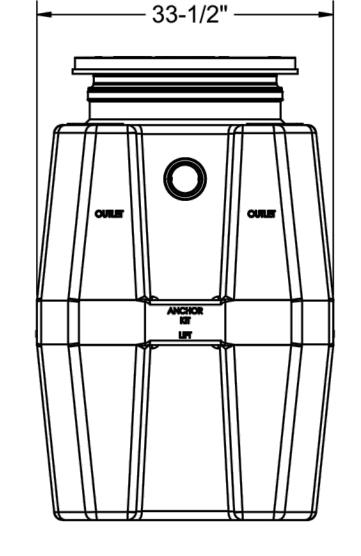

ISOMETRIC VIEW

OUTLET END VIEW

SPECIFICATION SHEET

MODEL NUMBER: GB-250 | PART NUMBER: 4055-001-XX

100 GPM POLYETHYLENE GREASE INTERCEPTOR

SECTION "A-A"

DATE: 07/02/2014 **REV**: 9 **ECO**: 1035

Schier Products 9500 Woodend Road Edwardsville, KS 66111 Tel: 800-827-7119 Fax: 800-827-9664 www.schierproducts.com

Adjustable

adapter


-Outlet "B" (Standard)

Tie-down point


for anchor kit. —

Made in the U.S.A


Pioneering Drain Line Purity

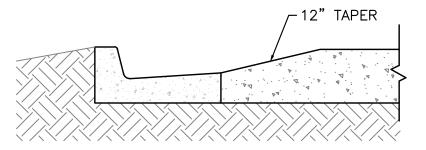

SPEED REDUCER CURB TREATMENT

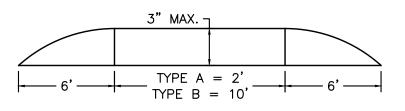

SPEED REDUCER PROFILE

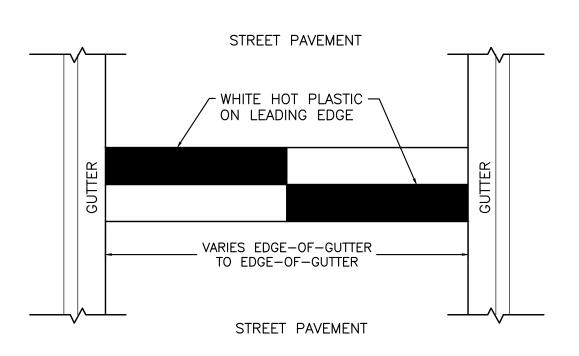

SPEED REDUCER PLAN VIEW

ENGINEER'S SEAL 6/27/20

RONALD R. BOHANNAN

	PRIMROSE SCHOOL OF NW ALBUQUERQUE	<i>DRAWN BY</i> pm
2.		<i>DATE</i> 6-27-18
2	CONSTRUCTION DETAILS	DRAWING
		0.4557 //
	L TIERRA WEST, LLC	SHEET #
/2018	5571 MIDWAY PARK PL NE ALBUQUERQUE, NEW MEXICO 87109	6

(505) 858-3100

www.tierrawestllc.com

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