


#### SITE PLAN KEYNOTES:

- 1A 6" VERTICAL CURB PER GRADING PLANS.
- (1B) 6" CURB AND GUTTER PER GRADING PLANS.
- 1C TURNDOWN SIDEWALK PER GRADING PLANS.
- 2 ACCESSIBLE RAMP PER DET. 8/C2.11
- 2A ACCESSIBLE RAMP PER DET. 9/C2.11.
- ACCESSIBLE RAMP PER DET. 10/C2.11.
- 2C LOADING ZONE PER GRADING PLANS.
- CONCRETE SIDEWALK, PER C.O.A. STD. DET. DWG. 2430 WIDTH PER PLAN.
- 4 EXISTING SIDEWALK TO REMAIN.
- 5 EXISTING TRASH ENCLOSURE.
- 6 PROVIDE PAINTED ADA SYMBOL PER DET. 1/C2.10.
- PROVIDE 4" WIDE WHITE PAINTED STRIPING. TYP.
- PROVIDE 6' WIDE PEDESTRIAN PATHWAY WITH 4" WIDE YELLOW PAINT, AT 45° 2 FEET O.C PER DET. 13/C2.11.
- PROVIDE 8' WIDE PEDESTRIAN PATHWAY AT ACCESIBLE PARKING WITH 4" WIDE YELLOW PAINT, AT 45° 2 FEET
- 9 INSTALL 6" STEEL BOLLARDS PER DET. 3/C2.10.
- 9A INSTALL 6" LIT STEEL BOLLARDS PER STRUCTURAL PLANS DET. D4/S5.1.
- PROVIDE HEAVY DUTY ASPHALT PAVEMENT PER CIVIL PLANS.
- (10B) CONCRETE PAVEMENT PER GRADING PLANS.
- 10C EXISTING ASPHALT.
- 11 INSTALL ACCESSIBLE PARKING SIGN PER DET. 2/C2.10.
- INSTALL DRIVE-THRU CLEARANCE BAR PER ARCHITECTURAL
- 13 INSTALL DRIVE-THRU MENU BOARD. PER STRUCTURAL PLANS DET. D1/S5.1.
- [14] PROVIDE RESTAURANT CANOPY PER ARCHITECTURAL PLANS.
- 15) RELOCATED FIRE HYDRANT LOCATION.
- 16 INSTALL 28' HIGH FLAG POLE BY G.C.
- 17 INSTALL FREE STANDING MAILBOX BY G.C.
- 18 INSTALL BIKE RACK (4 SPACES). PER DET. 5/C2.10.
- 19 REMOVE AND REPLACE SIDEWALK. WIDTH PER PLAN.
- [21] FURNISH AND INSTALL WHEEL STOP PER DET. 4/C2.10.
- PROPOSED "TRASH ENCLOSURE" WITH 6-CUBIC YARD VIP COMPACTOR, DRAIN TO GREASE INTERCEPTOR
- 23 INSTALL LIGHT POLE PER ELECTRICAL PLAN.
- 24 MOTORCYCLE PARKING (2 SPACES).
- 25 ELECTRIC VEHICLE PARKING (2 SPACES).
- 26 GREASE INTERCEPTOR PER UTILITY PLANS.
- 27 PROPOSED MONUMENT SIGN LOCATION.
- INSTALL MENU BOARD CANOPY PER ARCHITECTURAL PLAN
- PROPOSED "PEDESTRIAN WARNING + 15MPH SPEED" SIGN PER C.O.A. STD. DET. 2600-401 & 2600-404
- SIGHT LINE TRIANGLE.
- MOTORCYCLE PARKING ONLY SIGN.
- FUTURE CHARGING STATION LOCATION.
- CURB TRANSITION FROM 6" TO 0" PER CIVIL PLANS.
- PROPOSED 30" STOP SIGN AT DRIVEWAY. PER C.O.A. STD. DWG. 2600-601
- PROVIDE PAINTED ADA ACCESS AISLE SYMBOL PER DET.
- PROVIDE DIRECTIONAL LANE PAVEMENT MARKINGS PER DET. 11/C2.11.
- PROPOSED "ONE WAY" SIGN, PER C.O.A. STD. DET. 2600-603.

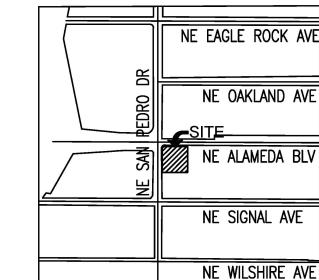

SCALE 1:800



#### SITE PLAN NOTES

- 1. DEVELOPMENT AND USE OF THIS SITE WILL CONFORM TO ALL APPLICABLE CODES AND ORDINANCES.
- 2. FIRE LANES SHALL BE ESTABLISHED AND PROPERLY DESIGNATED IN ACCORDANCE WITH THE LOCAL MUNICIPALITY AND LOCAL FIRE DEPARTMENT
- 3. ALL NEW OR RELOCATED UTILITIES WILL BE PLACED UNDERGROUND
- 4. ALL ROOFTOP EQUIPMENT AND SATELLITE DISHES SHALL BE SCREENED TO THE HEIGHT OF THE TALLEST EQUIPMENT 5. ALL SERVICE AREAS SHALL BE SCREENED TO CONCEAL TRASH

CONTAINERS, LOADING DOCKS, TRANSFORMERS, BACKFLOW PREVENTERS

- AND OTHER MECHANICAL OR ELECTRICAL EQUIPMENT FROM EYE LEVEL ADJACENT TO ALL PUBLIC STREETS. 6. IF APPLICABLE, PEDESTRIAN ACCESS ROUTES ARE PROVIDED IN COMPLIANCE WITH THE LATEST ADA STANDARDS. ALL RAMPS MUST MEET ADA ACCESSIBILITY GUIDELINES (ADAAG) STANDARDS, 2% MAX CROSS
- SLOPES, AND 5% MAXIMUM LONGITUDINAL SLOPES. TRUNCATED DOMES, AS DETECTABLE WARNINGS, ARE REQUIRED, AS SHOWN IN PLANS, ON ALL SITE RAMPS AND WALKS THAT CROSS A VEHICULAR WAY PER ADAAG '. PIPE BOLLARDS SHALL BE INSTALLED IN TRAFFIC AND LOADING AREAS AS
- REQUIRED TO PROTECT BUILDING CORNERS, RECEIVING AREAS, HYDRANTS, TRANSFORMERS, METERS, GENERATORS, COMPACTORS, STEPS, AND RAILINGS, AS NECESSARY.
- 8. ALL SIGNAGE REQUIRES SEPARATE APPROVAL AND PERMITS. 9. A MINIMUM 6-FOOT HORIZONTAL SEPARATION BETWEEN WATER AND SEWER
- PIPELINES WILL BE MAINTAINED. 10. OWNERS OF PROPERTY ADJACENT TO THE PUBLIC RIGHT-OF-WAY WILL HAVE THE RESPONSIBILITY FOR MAINTAINING ALL LANDSCAPING WITHIN THE RIGHT-OF-WAY IN ACCORDANCE WITH APPROVED PLANS.

#### SIGHT DISTANCE NOTE


LANDSCAPING, FENCING AND SIGNING WILL NOT INTERFERE WITH CLEAR SIGHT REQUIREMENTS. THEREFORE, SIGNS, WALLS, TREES, AND SHRUBBERY BETWEEN 3 AND 8 FEET TALL (AS MEASURED FROM THE GUTTER PAN) WILL NOT BE ACCEPTABLE IN THE CLEAR SIGHT TRIANGLE.

PR	OJECT ADDRESS:	6100 ALAN	MEDA BLVD	NE, ALBUQU	ERQUI	E, NM
PR	OJECT DESCRIPTION:	PROPOSE	D W HATABU	RGER W/DF	RIVE TH	-IRU
UP	°C:	•	101806 4281	34 810229		
ZO	NING:		NR-BP			
LO	T SIZE:		43,565	SF	1.00	AC
PR	OPOSED USE:		RESTAURAN	IT W/DRIVE	THRO	DUGH
BU	JILDING AREA:		2,999	SF		
M	AX BUILDING HEIGHT:		ALLOWED	PROPOSED		
	RESTAURANT BUILDIN	G:	50 FT.	22 FT.		
LO	TSTANDARDS		REQUIRED	PROPOSED		
	MIN LOT WIDTH:		100 FT.	± 186 FT.		
PΑ	RKING REQUIREMENT		REQUIRED	PROPOSED		
	VEHICLE (2,965 SF/1,00	0 SF x 8):	24			2 EV SPACES
	ADA SPACES:		2	33	INCL.	2 ADA SPACES
	EV SPACES:		2			Z ADA SFACES
	MOTORCYCLE (1 PER 2	SPACES):	2	2		
	BICYCLE SPACES:		3	4		
MI	NIMUM BUILDING SETBA	ACKS	REQUIRED	PROPOSED		
	FRONT (ALAMEDA BLV	D NE):	10 FT.	± 36 FT.		
	SIDE (SAN PEDRO ROA	D NE):	10 FT.	± 31 FT.		
	REAR (SOUTH SIDE):		10 FT.	± 119.5 FT.		
MI	NIMUM LANDSCAPE BU	FFER	REQUIRED	PROPOSED		
	FRONT (ALAMEDA BLV	D NE):	10 FT.	± 10 FT.		
	SIDE (SAN PEDRO ROA	D NE):	6 FT.	± 22 FT.		PARKING LOTIS INT TO LOT EDGE
	REAR (SOUTH SIDE):		6 FT.	±6FT.	ADJACE	INT TO LOT EDGE

PROPOSED "DO NOT ENTER" SIGN, PER C.O.A. STD. DET. 2600-603.

- PROPOSED "NO LEFT EXIT" SIGN PER C.O.A. STD. DET. 2600-701.
- PROVIDE "RIGHT TURN ONLY" PAVEMENT MARKING PER C.O.A. STD. DET. 2600–105.
- PROVIDE STOP LINE WITH 12" WIDE WHITE PAINT.
- PROVIDE DIVIDING LINE WITH 4" WIDE YELLOW PAINT.

#### PROPOSED LEGEND:

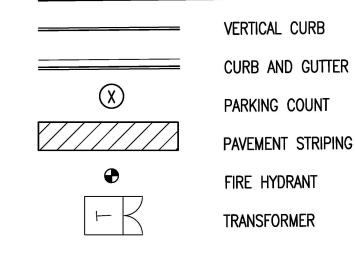

CONCRETE PAVEMENT/SIDEWALK HEAVY DUTY PAVEMENT

EXISTING PAVEMENT ACCESSIBLE PEDESTRIAN PATH

28'/48' FIRE ACCESS TURN RADIUS

RED PAINTED FIRE CURB

RE: DET. 6/C2.10

**PLAN** 



SUSTAINABILITY ENGINEERING GROUP







CALL NM ONE-CALL SYSTEM SEVER 7) DAYS PRIOR TO ANY EXCAVATION

빌교	岁
NM BLVD AVE N	BLVD
WHATABURGUER NM SEC ALAMEDA BLVD NE & SAN PEDRO AVE NE	LOCATION 6100 ALAMEDA BLVD NE ALBUQUERQUE, NM

PROJ. MGR. — AF 06/22/2022 ISSUED FOR: PR-2018-001346


SI-2022-00184 REVISION NO .:

210907

PRELIMINARY SITE

SHEET TITLE:

C2.00 1 OF 3

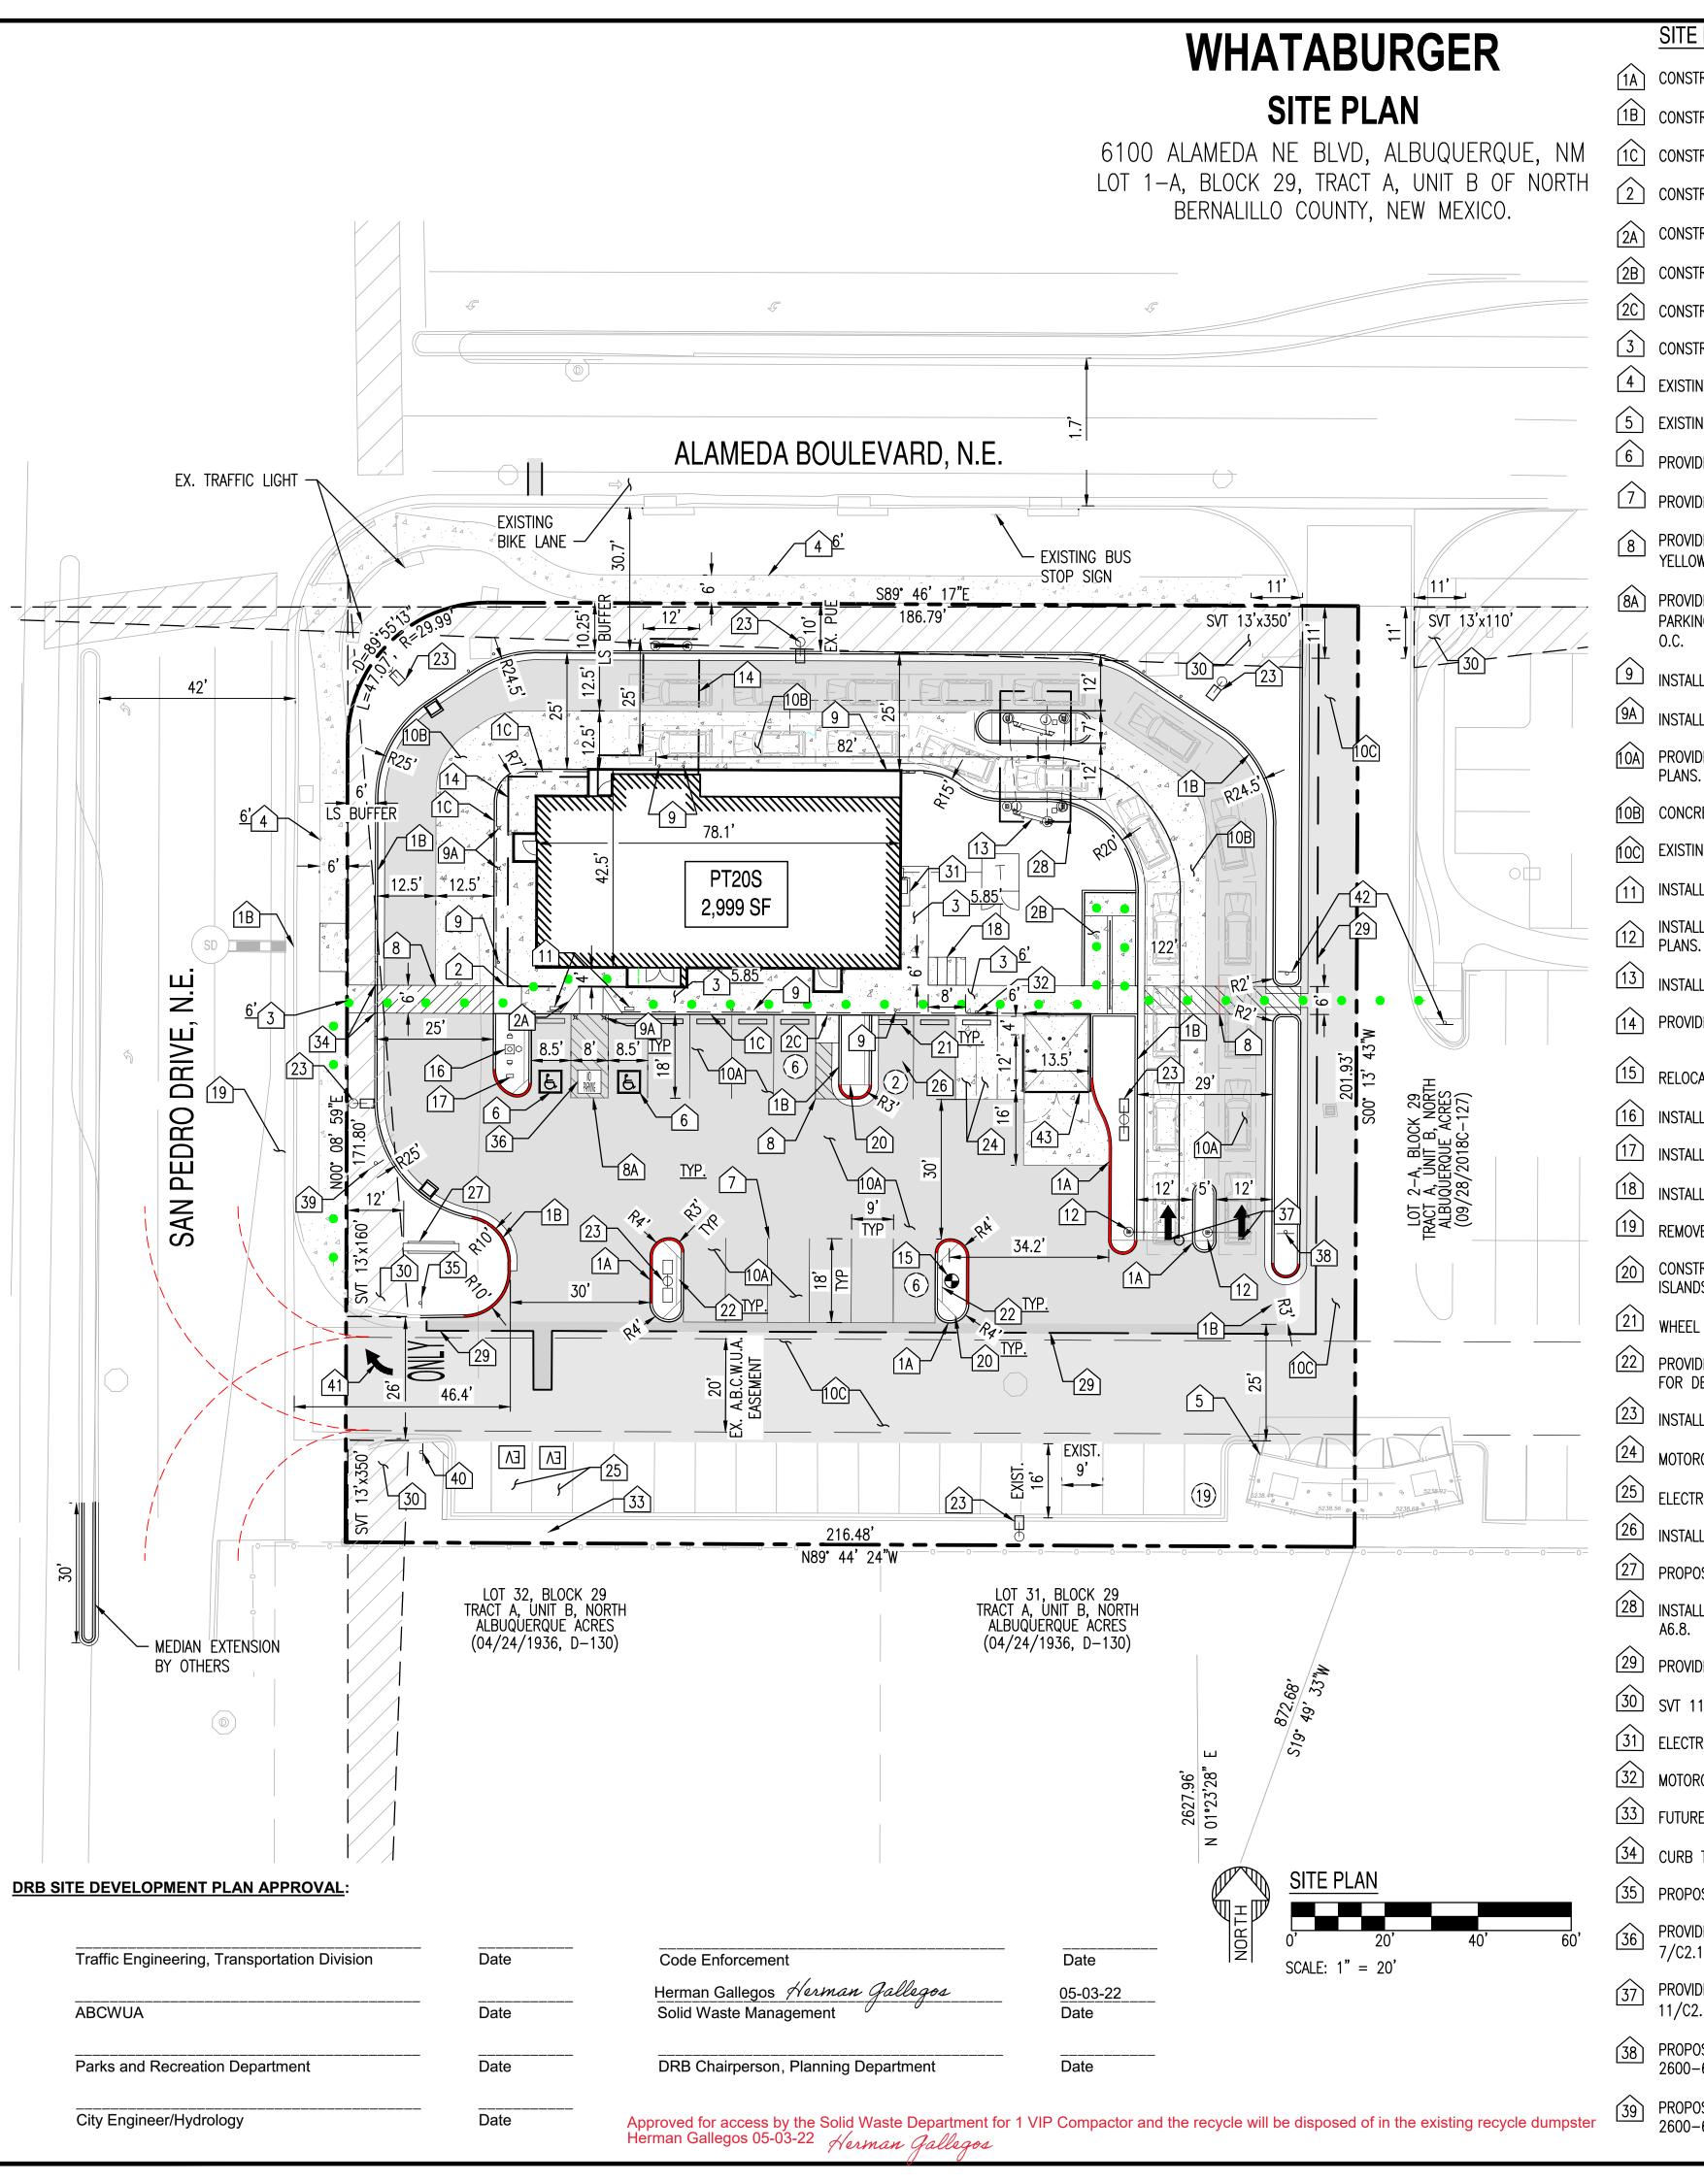


#### SITE PLAN KEYNOTES:

- (1A) CONSTRUCT 6" VERTICAL CURB PER GRADING PLANS.
- 1B CONSTRUCT 6" CURB AND GUTTER PER GRADING PLANS.
- (1C) CONSTRUCT TURNDOWN SIDEWALK PER GRADING PLANS.
- 2 CONSTRUCT ACCESSIBLE RAMP PER DET. 8/C2.11.
- (2A) CONSTRUCT ACCESSIBLE RAMP PER DET. 9/C2.11.
- (2B) CONSTRUCT ACCESSIBLE RAMP PER DET. 10/C2.11.
- 2C CONSTRUCT LOADING ZONE PER GRADING PLANS.
- 3 CONSTRUCT CONCRETE SIDEWALK, WIDTH PER PLAN.
- 4 EXISTING SIDEWALK TO REMAIN.
- 5 EXISTING TRASH ENCLOSURE.
- 6 PROVIDE PAINTED ADA SYMBOL PER DET. 1/C2.10.
- 7 PROVIDE 4" WIDE WHITE PAINTED STRIPING, TYP.
- PROVIDE 6' WIDE PEDESTRIAN PATHWAY WITH 4" WIDE YELLOW PAINT, AT 45° 2 FEET O.C PER DET. 13/C2.11.
- (8A) PROVIDE 8' WIDE PEDESTRIAN PATHWAY AT ACCESIBLE PARKING WITH 4" WIDE YELLOW PAINT. AT 45° 2 FEET
- 9 INSTALL 6" STEEL BOLLARDS PER DET. 3/C2.10.
- 9A INSTALL 6" LIT STEEL BOLLARDS PER DET. 3/C2.10.
- 10A PROVIDE HEAVY DUTY ASPHALT PAVEMENT PER CIVIL
- 10B CONCRETE PAVEMENT PER GRADING PLANS
- 10C EXISTING ASPHALT.
- 11 INSTALL ACCESSIBLE PARKING SIGN PER DET. 2/C2.10.
- INSTALL DRIVE-THRU CLEARANCE BAR PER ARCHITECTURAL PLANS.
- INSTALL DRIVE-THRU MENU BOARD. PER DET. 6/C2.10.
- 14) PROVIDE RESTAURANT CANOPY PER ARCHITECTURAL PLANS.
- (15) RELOCATED FIRE HYDRANT LOCATION.
- 16 INSTALL 28' HIGH FLAG POLE.
- 17 INSTALL FREE STANDING MAILBOX BY G.C.
- 18 INSTALL BIKE RACK (4 SPACES). PER DET. 5/C2.10.
- 19 REMOVE AND REPLACE SIDEWALK. WIDTH PER PLAN.
- 20 CONSTRUCT CONCRETE ISLANDS NOSE, TYPICAL AT
- wheel stop per det. 4/c2.10.
- 22 PROVIDE GRANITE STRIPS. REFER TO LANDSCAPE PLANS
- INSTALL LIGHT POLE PER PHOTOMETRIC PLAN.
- MOTORCYCLE PARKING (2 SPACES).
- ELECTRIC VEHICLE PARKING (2 SPACES).
- install grease interceptor per utility plans.
- 27 PROPOSED MONUMENT SIGN LOCATION.
- INSTALL MENU BOARD CANOPY PER ARCHITECTURAL PLAN
- 29 PROVIDE SAWCUT PER CIVIL PLANS.
- 30 SVT 11'X11'.
- 31 ELECTRICAL CABINET.
- MOTORCYCLE PARKING ONLY SIGN.
- 33 FUTURE CHARGING STATION LOCATION.
- 34 CURB TRANSITION FROM TO 0" PER CIVIL PLANS.
- PROPOSED STOP SIGN AT DRIVEWAY.
- PROVIDE PAINTED ADA ACCESS AISLE SYMBOL PER DET.
- PROVIDE DIRECTIONAL LANE PAVEMENT MARKINGS PER DET. 11/C2.11.
- PROPOSED "ONE WAY" SIGN, PER C.O.A. STD. DET.
- PROPOSED "DO NOT ENTER" SIGN, PER C.O.A. STD. DET.



## SCALE 1:800

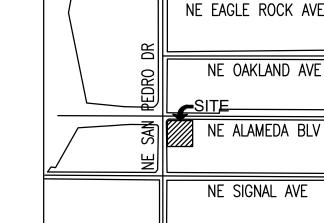

NE WILSHIRE AVE

#### SITE PLAN NOTES

- 1. DEVELOPMENT AND USE OF THIS SITE WILL CONFORM TO ALL APPLICABLE CODES AND ORDINANCES.
- 2. FIRE LANES SHALL BE ESTABLISHED AND PROPERLY DESIGNATED IN ACCORDANCE WITH THE LOCAL MUNICIPALITY AND LOCAL FIRE DEPARTMENT
- ALL NEW OR RELOCATED UTILITIES WILL BE PLACED UNDERGROUND.
- 4. ALL ROOFTOP EQUIPMENT AND SATELLITE DISHES SHALL BE SCREENED TO THE HEIGHT OF THE TALLEST EQUIPMENT ALL SERVICE AREAS SHALL BE SCREENED TO CONCEAL TRASH
- CONTAINERS, LOADING DOCKS, TRANSFORMERS, BACKFLOW PREVENTERS AND OTHER MECHANICAL OR ELECTRICAL EQUIPMENT FROM EYE LEVEL ADJACENT TO ALL PUBLIC STREETS. 6. IF APPLICABLE, PEDESTRIAN ACCESS ROUTES ARE PROVIDED IN
- COMPLIANCE WITH THE LATEST ADA STANDARDS. ALL RAMPS MUST MEET ADA ACCESSIBILITY GUIDELINES (ADAAG) STANDARDS, 2% MAX CROSS SLOPES, AND 5% MAXIMUM LONGITUDINAL SLOPES. TRUNCATED DOMES, AS DETECTABLE WARNINGS, ARE REQUIRED, AS SHOWN IN PLANS, ON ALL SITE RAMPS AND WALKS THAT CROSS A VEHICULAR WAY PER ADAAG
- . PIPE BOLLARDS SHALL BE INSTALLED IN TRAFFIC AND LOADING AREAS AS REQUIRED TO PROTECT BUILDING CORNERS, RECEIVING AREAS, HYDRANTS, TRANSFORMERS, METERS, GENERATORS, COMPACTORS, STEPS, AND RAILINGS, AS NECESSARY.
- ALL SIGNAGE REQUIRES SEPARATE APPROVAL AND PERMITS.
- . A MINIMUM 6-FOOT HORIZONTAL SEPARATION BETWEEN WATER AND SEWER PIPELINES WILL BE MAINTAINED.
- 10. OWNERS OF PROPERTY ADJACENT TO THE PUBLIC RIGHT-OF-WAY WILL HAVE THE RESPONSIBILITY FOR MAINTAINING ALL LANDSCAPING WITHIN THE RIGHT-OF-WAY IN ACCORDANCE WITH APPROVED PLANS.


#### SIGHT DISTANCE NOTE

LANDSCAPING, FENCING AND SIGNING WILL NOT INTERFERE WITH CLEAR SIGHT REQUIREMENTS. THEREFORE, SIGNS, WALLS, TREES, AND SHRUBBERY BETWEEN 3 AND 8 FEET TALL (AS MEASURED FROM THE GUTTER PAN) WILL NOT BE ACCEPTABLE IN THE CLEAR SIGHT TRIANGLE.

		7.11. 0.01.11				
DE	VELOPMENT SUN	<b>IMARY T</b>	ABLE:			
PRO	JECT ADDRESS:	6100 ALAN	/IEDA BLVD N	IE, ALBUQU	ERQUI	E, NM
PRO	JECT DESCRIPTION:	PROPOSE	D W HATABU	RGER W/DF	RIVE TH	-IRU
UPC	:		101806 4281	34 810229		
ZON	IING:		NR-BP			
LOT	SIZE:		43,565	SF	1.00	AC
PRO	POSED USE:		RESTAURAN	IT W/DRIVI	THRO	DUGH
BUIL	DING AREA:		2,999	SF		
MA)	K BUILDING HEIGHT:		ALLOWED	PROPOSED		
I	RESTAURANT BUILDIN	G:	50 FT.	22 FT.		
LOT	STANDARDS		REQUIRED	PROPOSED		
1	MIN LOT WIDTH:		100 FT.	± 186 FT.		
PAR	KING REQUIREMENT		REQUIRED	PROPOSED		
١	VEHICLE (2,965 SF/1,00	0 SF x 8):	24			2 FV CDACEC
1	ADA SPACES:		2	33	INCL.	2 EV SPACES
E	EV SPACES:		2			2 ADA SPACES
1	MOTORCYCLE (1 PER 25	SPACES):	2	2		
E	BICYCLE SPACES:		3	4		
MIN	IMUM BUILDING SETBA	ACKS	REQUIRED	PROPOSED		
I	FRONT (ALAMEDA BLV	D NE):	10 FT.	± 36 FT.		
9	SIDE (SAN PEDRO ROAL	D NE):	10 FT.	± 31 FT.		
I	REAR (SOUTH SIDE):	-	10 FT.	± 119.5 FT.		
MIN	IMUM LANDSCAPE BU	FFER	REQUIRED	PROPOSED		
I	FRONT (ALAMEDA BLV	D NE):	10 FT.	± 10 FT.		
9	SIDE (SAN PEDRO ROAI	D NE):	6 FT.	± 22 FT.		PARKING LOTIS
_ F	REAR (SOUTH SIDE):		6 FT.	±6FT.	ADJACE	NT TO LOT EDGE
/	ILAN (300 III 31DE).		UTI.	± UFI.		

- PROPOSED "NO LEFT EXIT" SIGN PER C.O.A. STD. DET.
- PROVIDE "RIGHT TURN ONLY" PAVEMENT MARKING PER C.O.A. STD. DET. 2600–105.
- PROPOSED "PEDESTRIAN WARNING + 15MPH SPEED" SIGN PER C.O.A. STD. DET.
- PROPOSED "TRASH ENCLOSURE" WITH 6-CUBIC YARD VIP COMPACTOR, DRAIN TO GREASE INTERCEPTOR

### PROPOSED LEGEND:

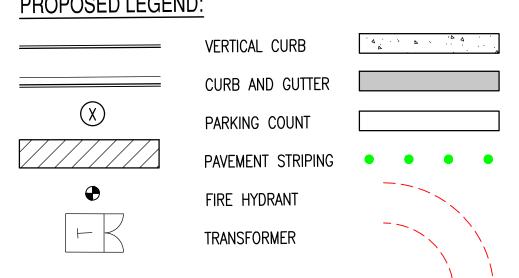

CONCRETE PAVEMENT/SIDEWALK HEAVY DUTY PAVEMENT EXISTING PAVEMENT

ACCESSIBLE PEDESTRIAN PATH

28'/48' FIRE ACCESS TURN RADIUS

RED PAINTED FIRE CURB RE: DET. 6/C2.10

SUSTAINABILITY ENGINEERING GROUP









**CALL NM ONE-CALI** SYSTEM SEVEN (7) DAYS PRIOR TO ANY EXCAVATION

DRAWN FINAL QC \_\_\_\_\_ PROJ. MGR. — AF 04/27/2022 04/29/2022

ISSUED FOR: PERMITS PR-2018-001346


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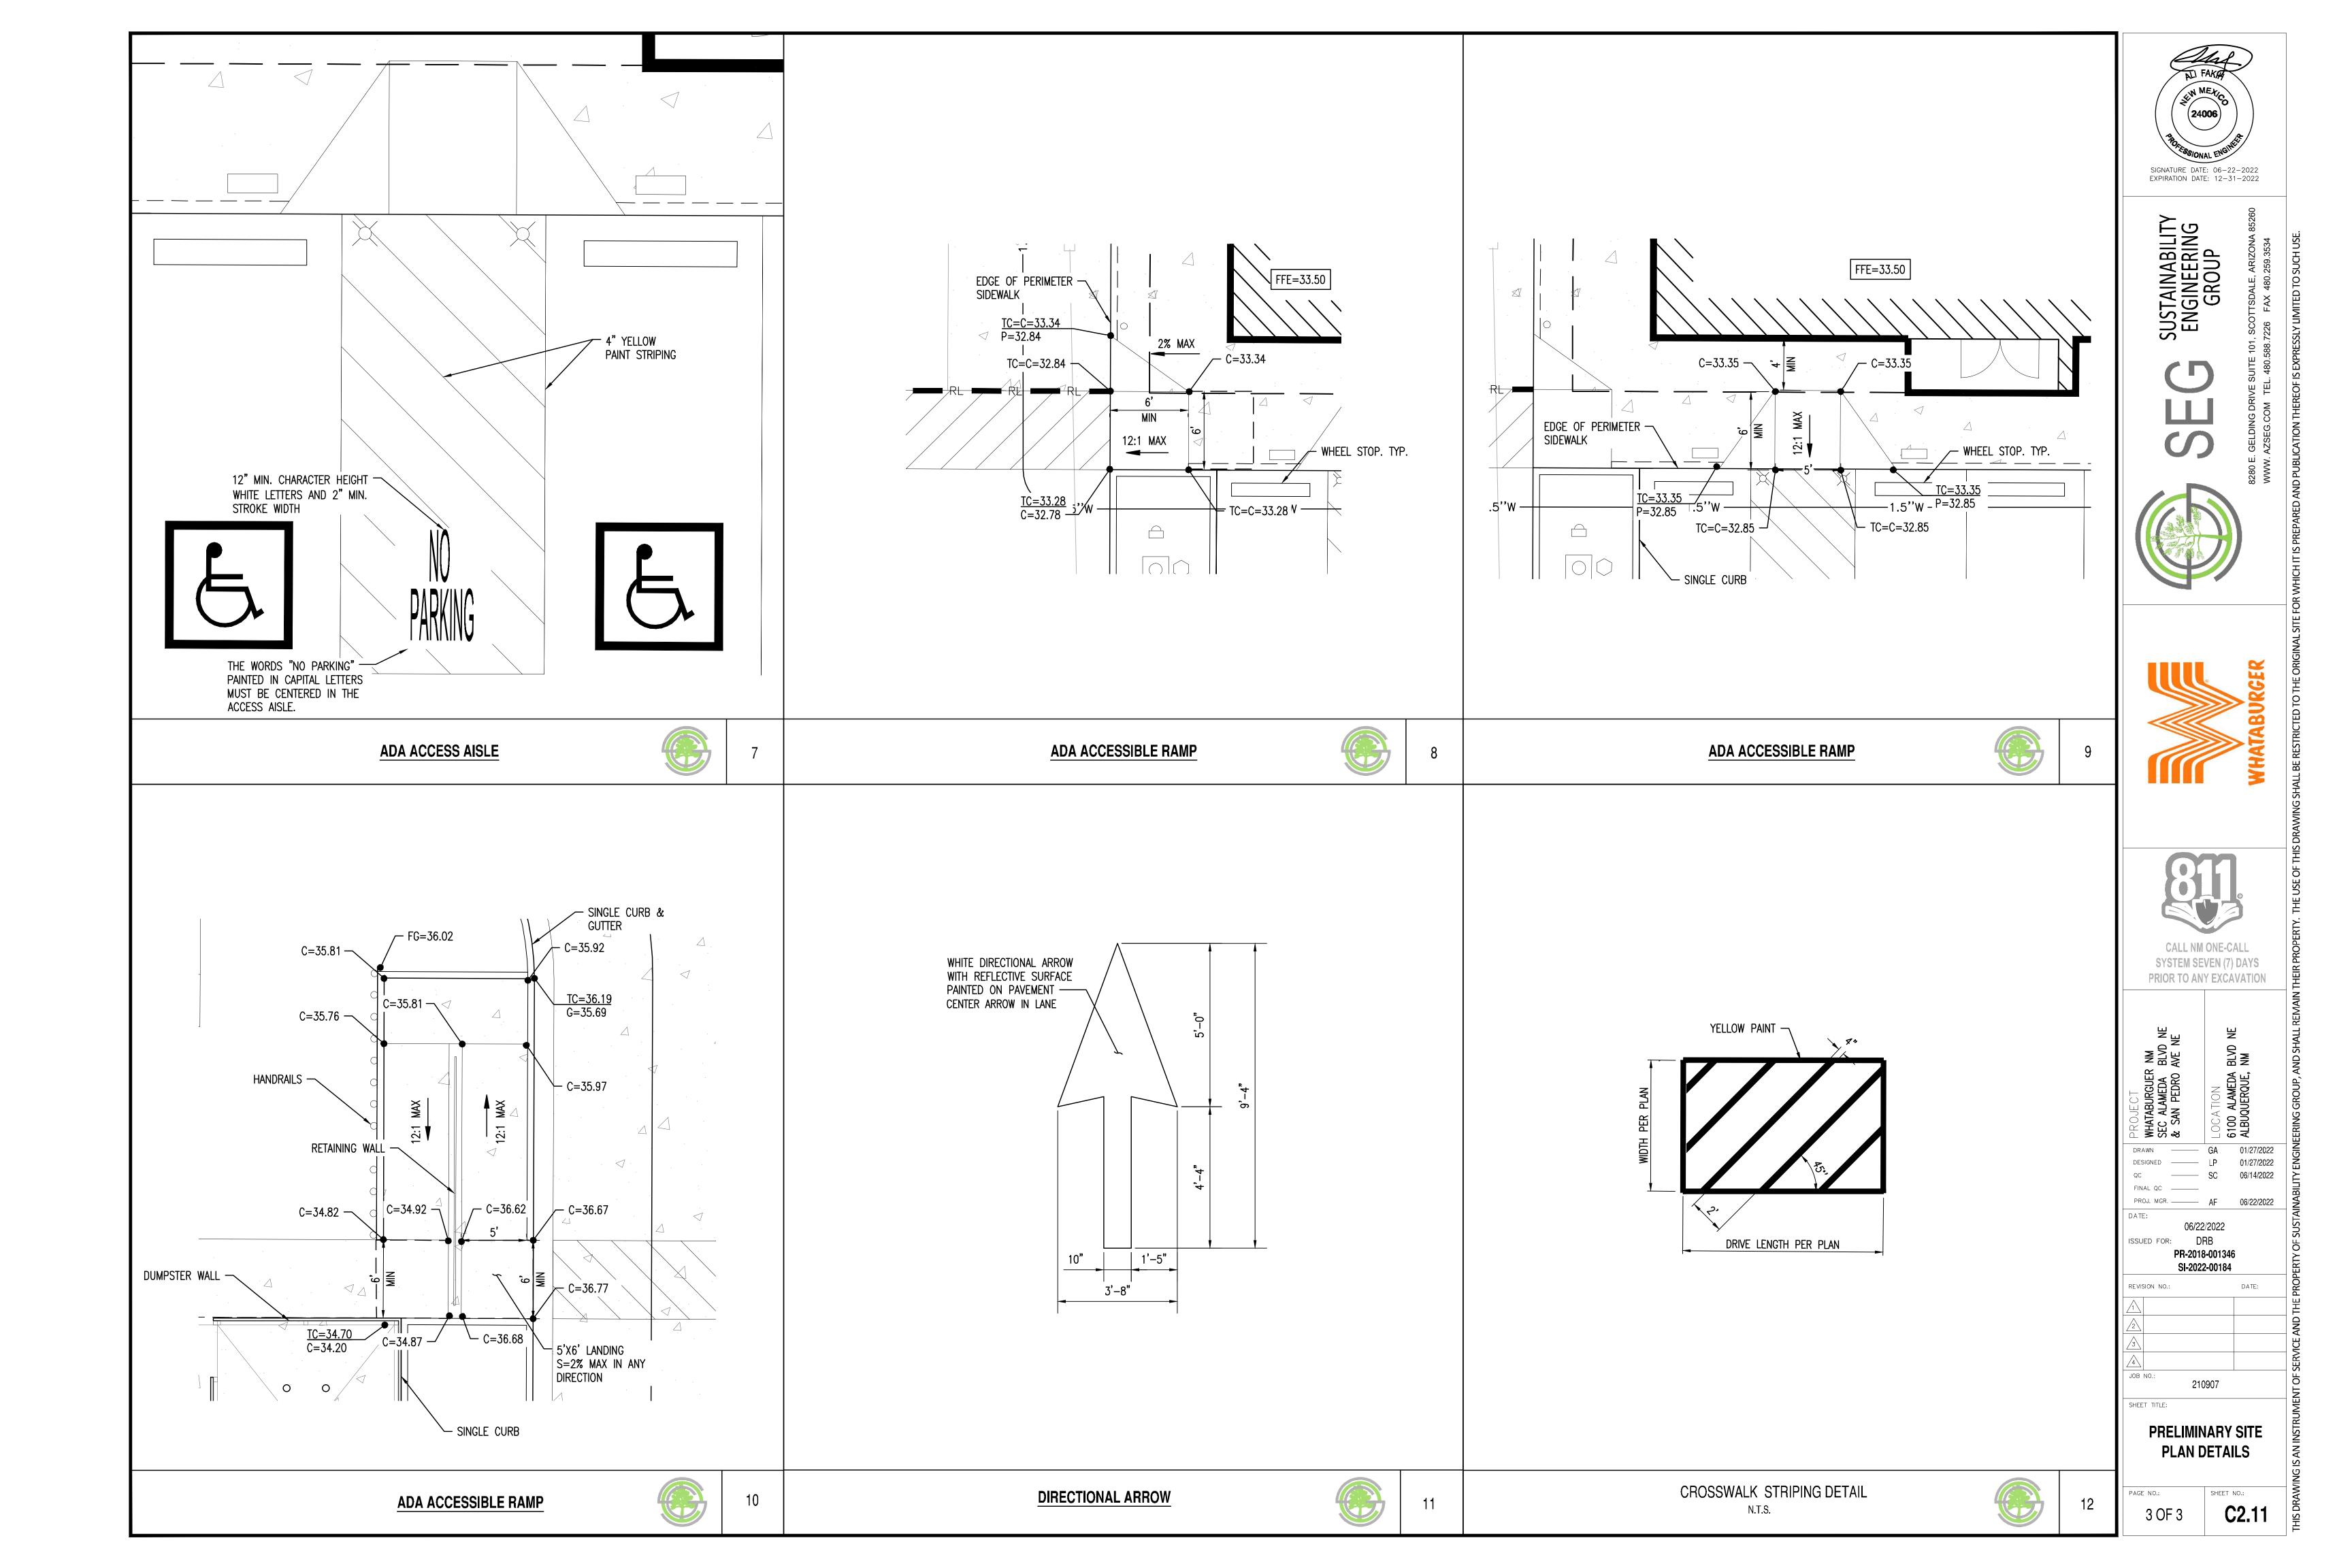
SITE PLAN

5 OF 14

SHEET TITLE:

C2.00




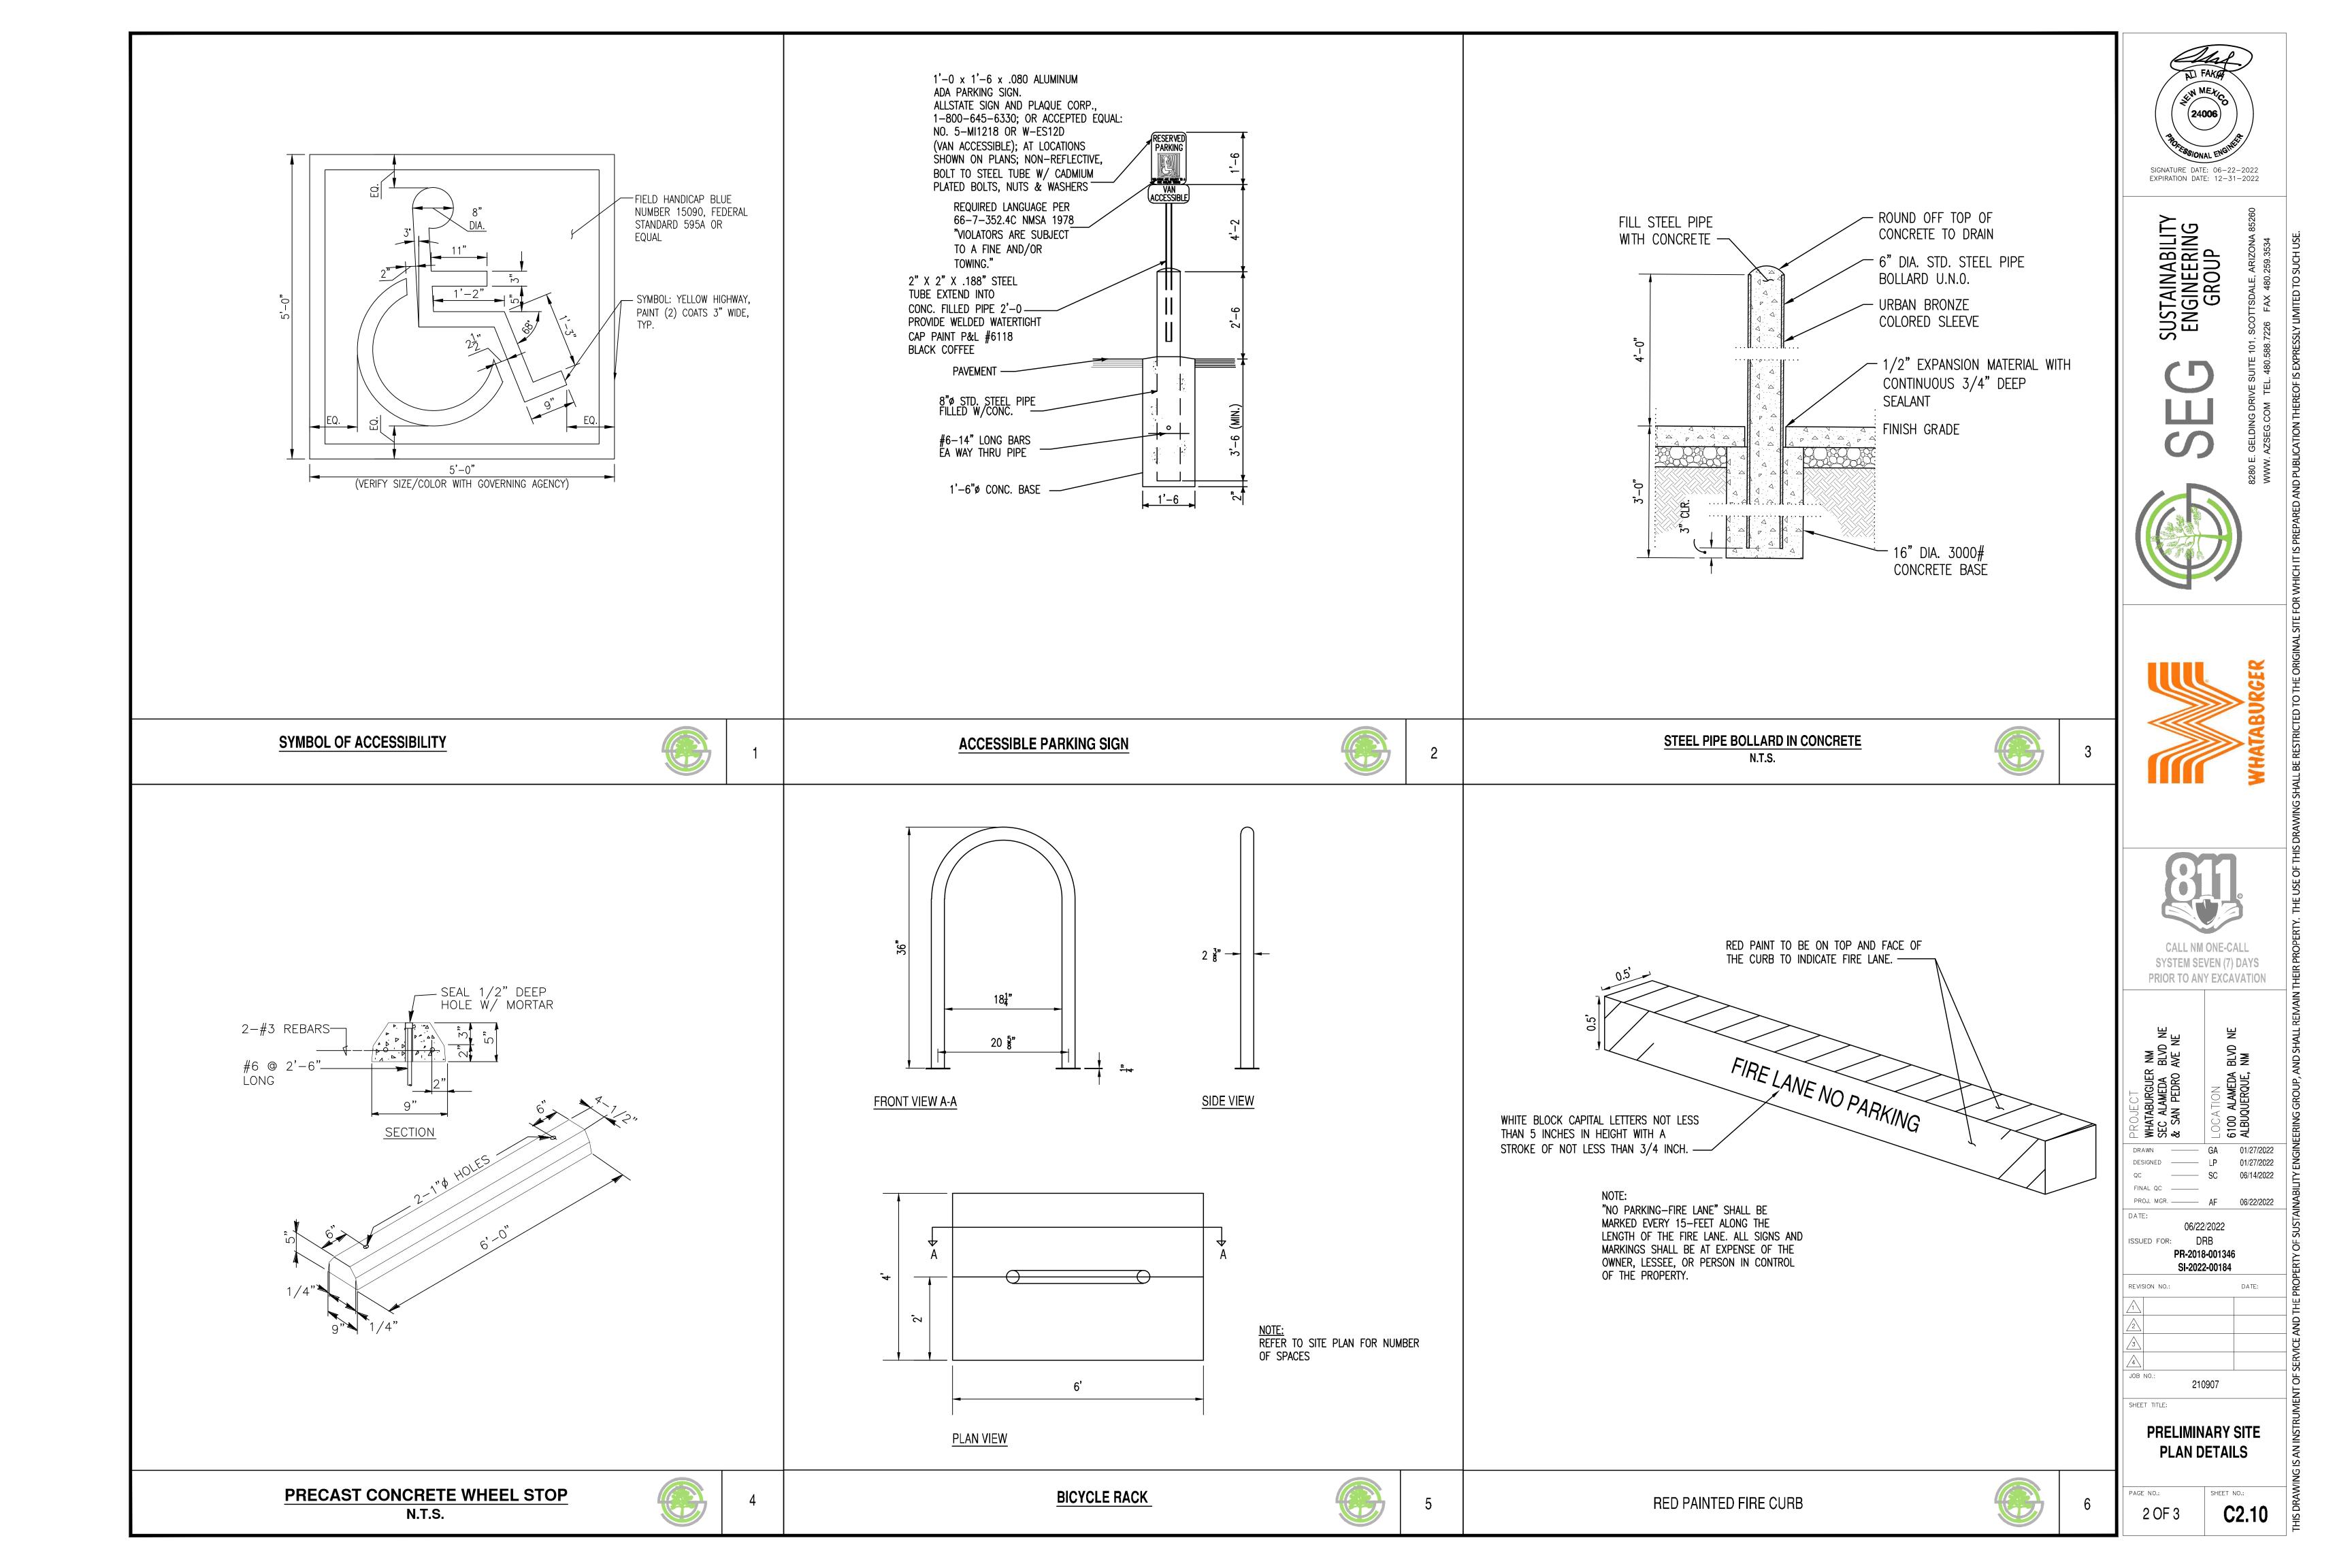


## WHATABURGER

## GRADING AND DRAINAGE PLAN

6100 ALAMEDA BLVD NE, ALBUQUERQUE, NM A PORTION OF SECTION 13, TOWNSHIP 11 NORTH, RANGE 3 EAST BERNALILLO COUNTY, NEW MEXICO.

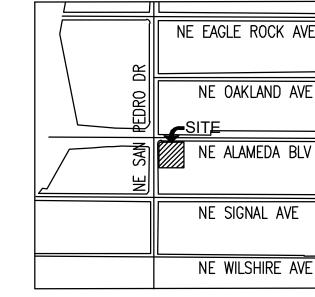

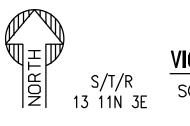

**VICINITY MAP** 

#### GRADING CONSTRUCTION KEY NOTES

- MATCH EXISTING GRADE; CONTRACTOR TO VERIFY IN FIELD ALL GRADES PRIOR TO CONSTRUCTION ACTIVITIES AND CONTACT ENGINEER IN CASE OF ANY DISCREPANCIES.
- (2) CONSTRUCT 6" HEADER CURB PER C.O.A. STD. DWG. 2415C
- (2A) CONSTRUCT 6" CURB AND GUTTER PER C.O.A. STD DWG 2415A.
- (3) CONSTRUCT ADA RAMP. PER SITE PLANS.
- (3B) CONSTRUCT DELIVERY RAMP PER DET. 2/C3.10.
- FURNISH AND INSTALL NYLOPLAST DRAIN BASIN WITH 30" RISER AND 2'X2' STEEL GRATE PER DET. 13/C3.11 & 14/C3.11.
- 5 FURNISH AND INSTALL HDPE DOUBLE WALL PIPE, CLASS 100; LENGTH, SIZE AND SLOPE PER
- FURNISH AND INSTALL REINFORCED CLASS III CONCRETE PIPE, LENGTH, SIZE AND SLOPE PER
- (7) CONSTRUCT HEAVY DUTY PAVEMENT PER DETAIL 5/C3.10.
- 8 FURNISH AND INSTALL 4' MANHOLE PER C.O.A. 2208.
- 9 CONSTRUCT CONCRETE SIDEWALK PER C.O.A. STD DWG 2430. WIDTH PER PLAN.
- CONSTRUCT PAVEMENT WITH 2% MAXIMUM SLOPE IN ANY DIRECTION AT ACCESSIBLE PARKING STALLS AND 2% MAXIMUM CROSS SLOPE AT ADA ACCESSIBLE ROUTE.
- (11) CONSTRUCT CONCRETE PAVEMENT PER DETAIL 6/C3.10.
- $\langle 12 \rangle$  caution! Protect existing gas and power utilities.
- 13 PAVING TRANSITION PER DET. 7/C3.10.
- 14 TRANSITION TO EXISTING PAVEMENT PER DET. 1/C3.10.
- (15) SAWCUT, REMOVE AND REPLACE EXISTING PAVEMENT.
- (16) CONSTRUCT 3' CURB OPENING PER DET. 3/C3.10.
- (17) TURN DOWN SIDEWALK. PER STRUCTURAL PLANS DET. A2/S3.1.
- (18) TURN DOWN SLAB. PER STRUCTURAL PLANS DET. C2/S3.1.
- (19) 5' CURB TRANSITION FROM 6" TO 0" REVEAL. PER DET. 9/C3.10.
- (20) CONSTRUCT TRASH ENCLOSURE WITH SANITARY SEWER DRAIN. REFER TO ARCHITECTURAL PLANS.

EXISTING CONDITIONS AND PROPOSED DEVELOPMENT

THE EXISTING SITE IS PARTIALLY DEVELOPED. THE SOUTHERN PORTION OF THE PROPERTY INCLUDES A PARKING LOT WITH LANDSCAPE ISLANDS WHILE THE NORTH AREA REMAINS UNDEVELOPED WITH AN EXISTING DRAINAGE POND, DIRT PILES AND STORAGE CONTAINER. DRAINAGE STRUCTURES, SEWER AND WATER LINES, AND DRY UTILITIES SUCH AS POWER, GAS AND ELECTRICITY EXIST WITHIN THE SITE. LOT ELEVATION DROP FROM 1,238' AT THE EAST PROPERTY LINE TO ABOUT 1,232' AT THE WEST PROPERTY LINE.


THE PROJECT WILL CONSIST IN THE DEMOLITION OF MOST OF THE EXISTING SOUTH PARKING LOT AND THE CONSTRUCTION OF A FAST FOOD RESTAURANT (2,999 SF) WITH A DRIVE-THRU, PARKING AREA, AND DESIGNATED

#### PRIVATE DRAINAGE FACILITIES WITHIN CITY RIGHT-OF-WAY

#### NOTICE TO CONTRACTOR

(SPECIAL ORDER 19  $\sim$  "SO-19")

- 1. BUILD SIDEWALK CULVERT PER COA STD DWG 2236. WORK IS PERMITTED AND INSPECTED BY DMD CONSTRUCTION SERVICES DIVISION.
- AN EXCAVATION PERMIT WILL BE REQUIRED BEFORE BEGINNING ANY WORK WITHIN CITY RIGHT-OF-WAY. ALL WORK ON THIS PROJECT SHALL BE PERFORMED IN ACCORDANCE WITH APPLICABLE FEDERAL, STATE AND LOCAL
- LAWS, RULES AND REGULATIONS CONCERNING CONSTRUCTION SAFETY AND HEALTH.
- 4. PRIOR TO ANY EXCAVATION, THE CONTRACTOR MUST CONTACT NEW MEXICO ONE CALL, DIAL "811" [OR (505) 260-1990 FOR THE LOCATION OF EXISTING UTILITIES.
- PRIOR TO CONSTRUCTION, THE CONTRACTOR SHALL EXCAVATE AND VERIFY THE LOCATIONS OF ALL OBSTRUCTIONS. SHOULD A CONFLICT EXIST, THE CONTRACTOR SHALL NOTIFY THE ENGINEER SO THAT THE CONFLICT CAN BE RESOLVED WITH A MINIMUM AMOUNT OF DELAY.
  - MAINTENANCE OF THE FACILITY SHALL BE THE RESPONSIBILITY OF THE OWNER OF THE PROPERTY BEING SERVED.
  - WORK ON ARTERIAL STREETS MAY BE REQUIRED ON A 24-HOUR BASIS.
- 9. FOR EXCAVATION AND BARRICADING INSPECTIONS, CONTACT DMD CONSTRUCTION SERVICES DIVISION.

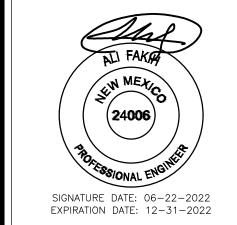

SUSTAINABILITY ENGINEERING GROUP





CALL NM ONE-CALL SYSTEM SEVEN (7) DAYS PRIOR TO ANY EXCAVATION


FINAL QC \_\_\_\_\_ PROJ. MGR. — AF 06/22/2022

06/22/2022 DRB ISSUED FOR: PR-2018-001346 SI-2022-00184

REVISION NO.: 210907

> **GRADING AND** DRAINAGE PLAN

C3.00 1 OF 5

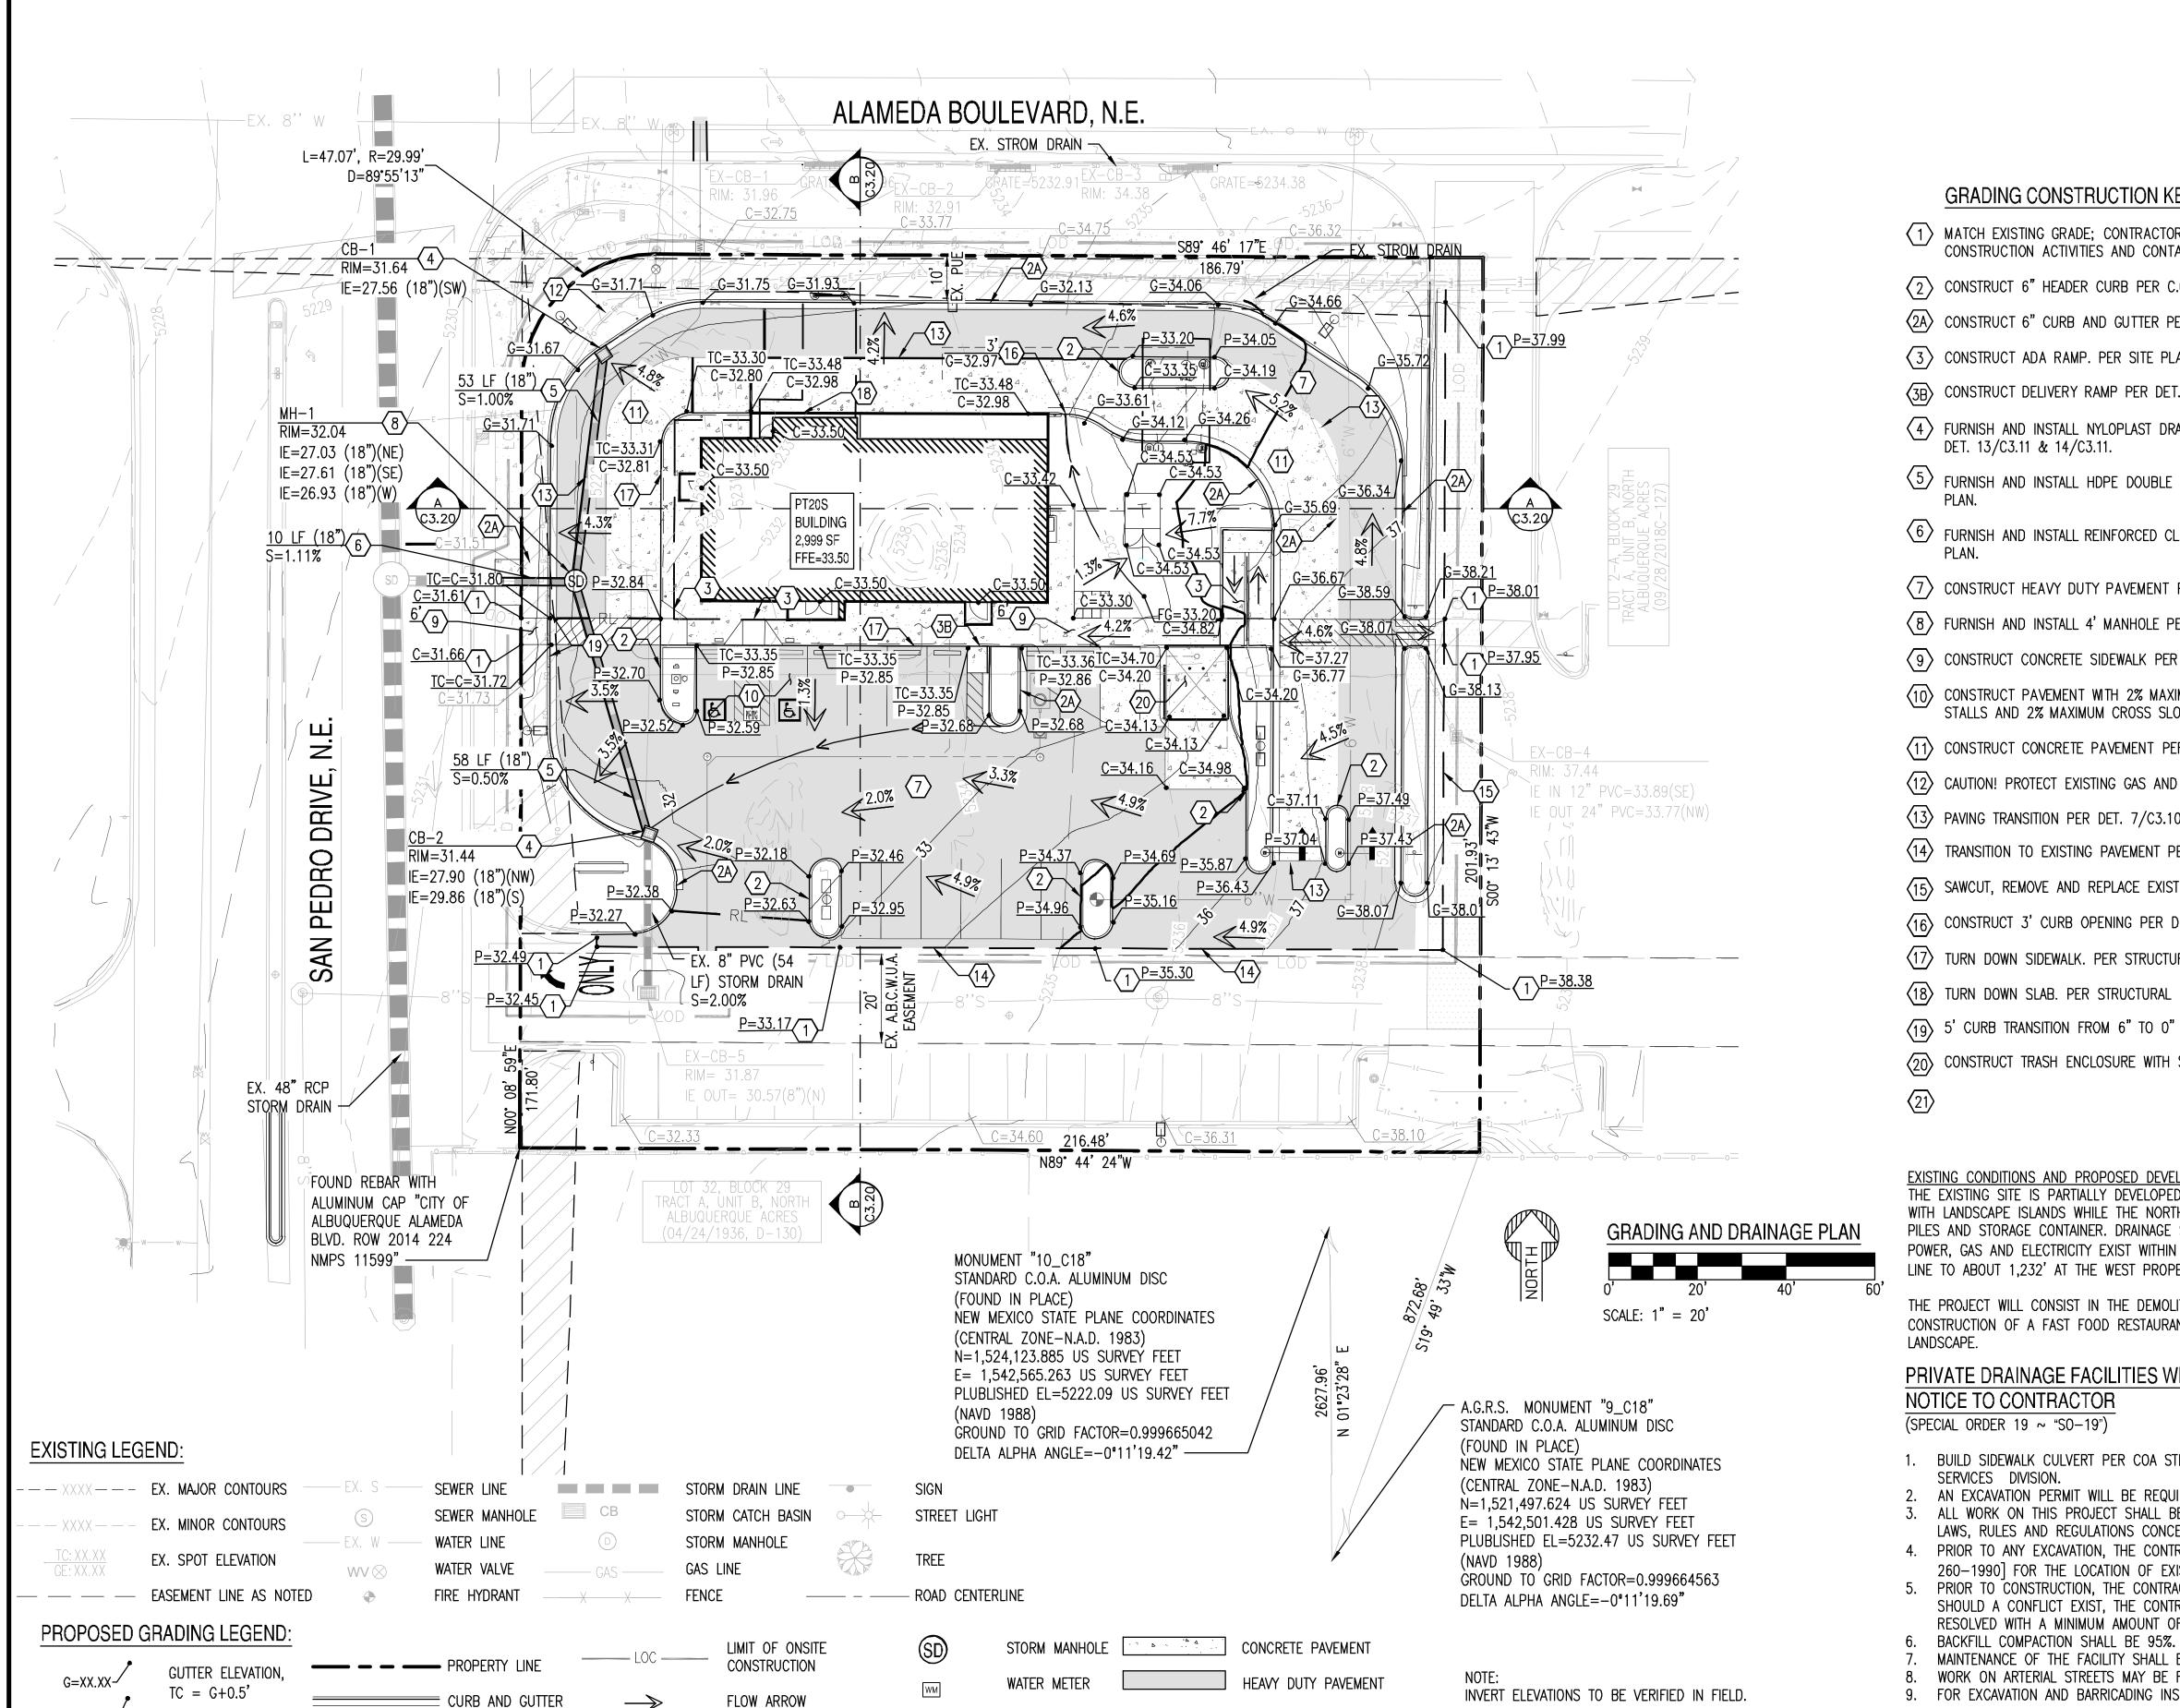

GATE VALVE

FIRE HYDRANT

CATCH BASIN

STORM PIPE

STORM INLET

P=XX.XX-

C=XX.XX-


PAVEMENT ELEVATION

CONCRETE ELEVATION

## WHATABURGER

## OFF-SITE GRADING AND DRAINAGE PLAN

6100 ALAMEDA BLVD NE, ALBUQUERQUE, NM A PORTION OF SECTION 13, TOWNSHIP 11 NORTH, RANGE 3 EAST BERNALILLO COUNTY, NEW MEXICO.

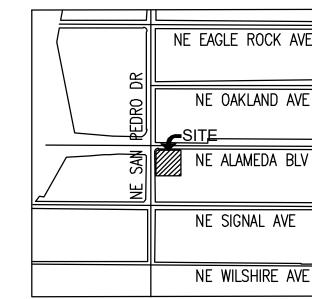




#### GRADING CONSTRUCTION KEY NOTES

- MATCH EXISTING GRADE; CONTRACTOR TO VERIFY IN FIELD ALL GRADES PRIOR TO CONSTRUCTION ACTIVITIES AND CONTACT ENGINEER IN CASE OF ANY DISCREPANCIES.
- REMOVE AND REPLACE EXISTING SIDEWALK AS REQUIRED FOR UTILITY CONSTRUCTION. REMOVE TO NEAREST JOINT.
- FURNISH AND INSTALL REINFORCED CLASS III CONCRETE PIPE, LENGTH, SIZE AND SLOPE PER PLAN.
- (4) CONNECT PIPE TO EXISTING PUBLIC STORM INLET.
- (5) EXISTING PUBLIC 8' DIA MANHOLE

INVERT ELEVATIONS TO BE VERIFIED IN FIELD.

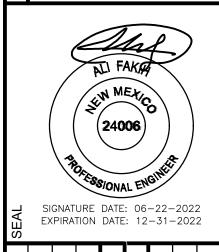


SUSTAINABILITY | ENGINEERING | GROUP

DESIGNED BY: SO

CALL NM ONE-CALL SYSTEM SEVEN (7) DAYS PRIOR TO ANY EXCAVATION

DRAWN BY: ER CHECKED BY: SC 06/2022

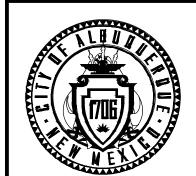


CITY OF ALBUQUERQUE DEPARTMENT OF MUNICIPAL DEVELOPMENT ENGINEERING DIVISION

OFF-SITE GRADING & DRAINAGE

PLAN

DESIGN REVIEW COMMITTEE CITY ENGINEER APPROVAL ZONE MAP NO. **Z-99** 


> CITY PROJECT NO. PR-2018-001346 C3.01

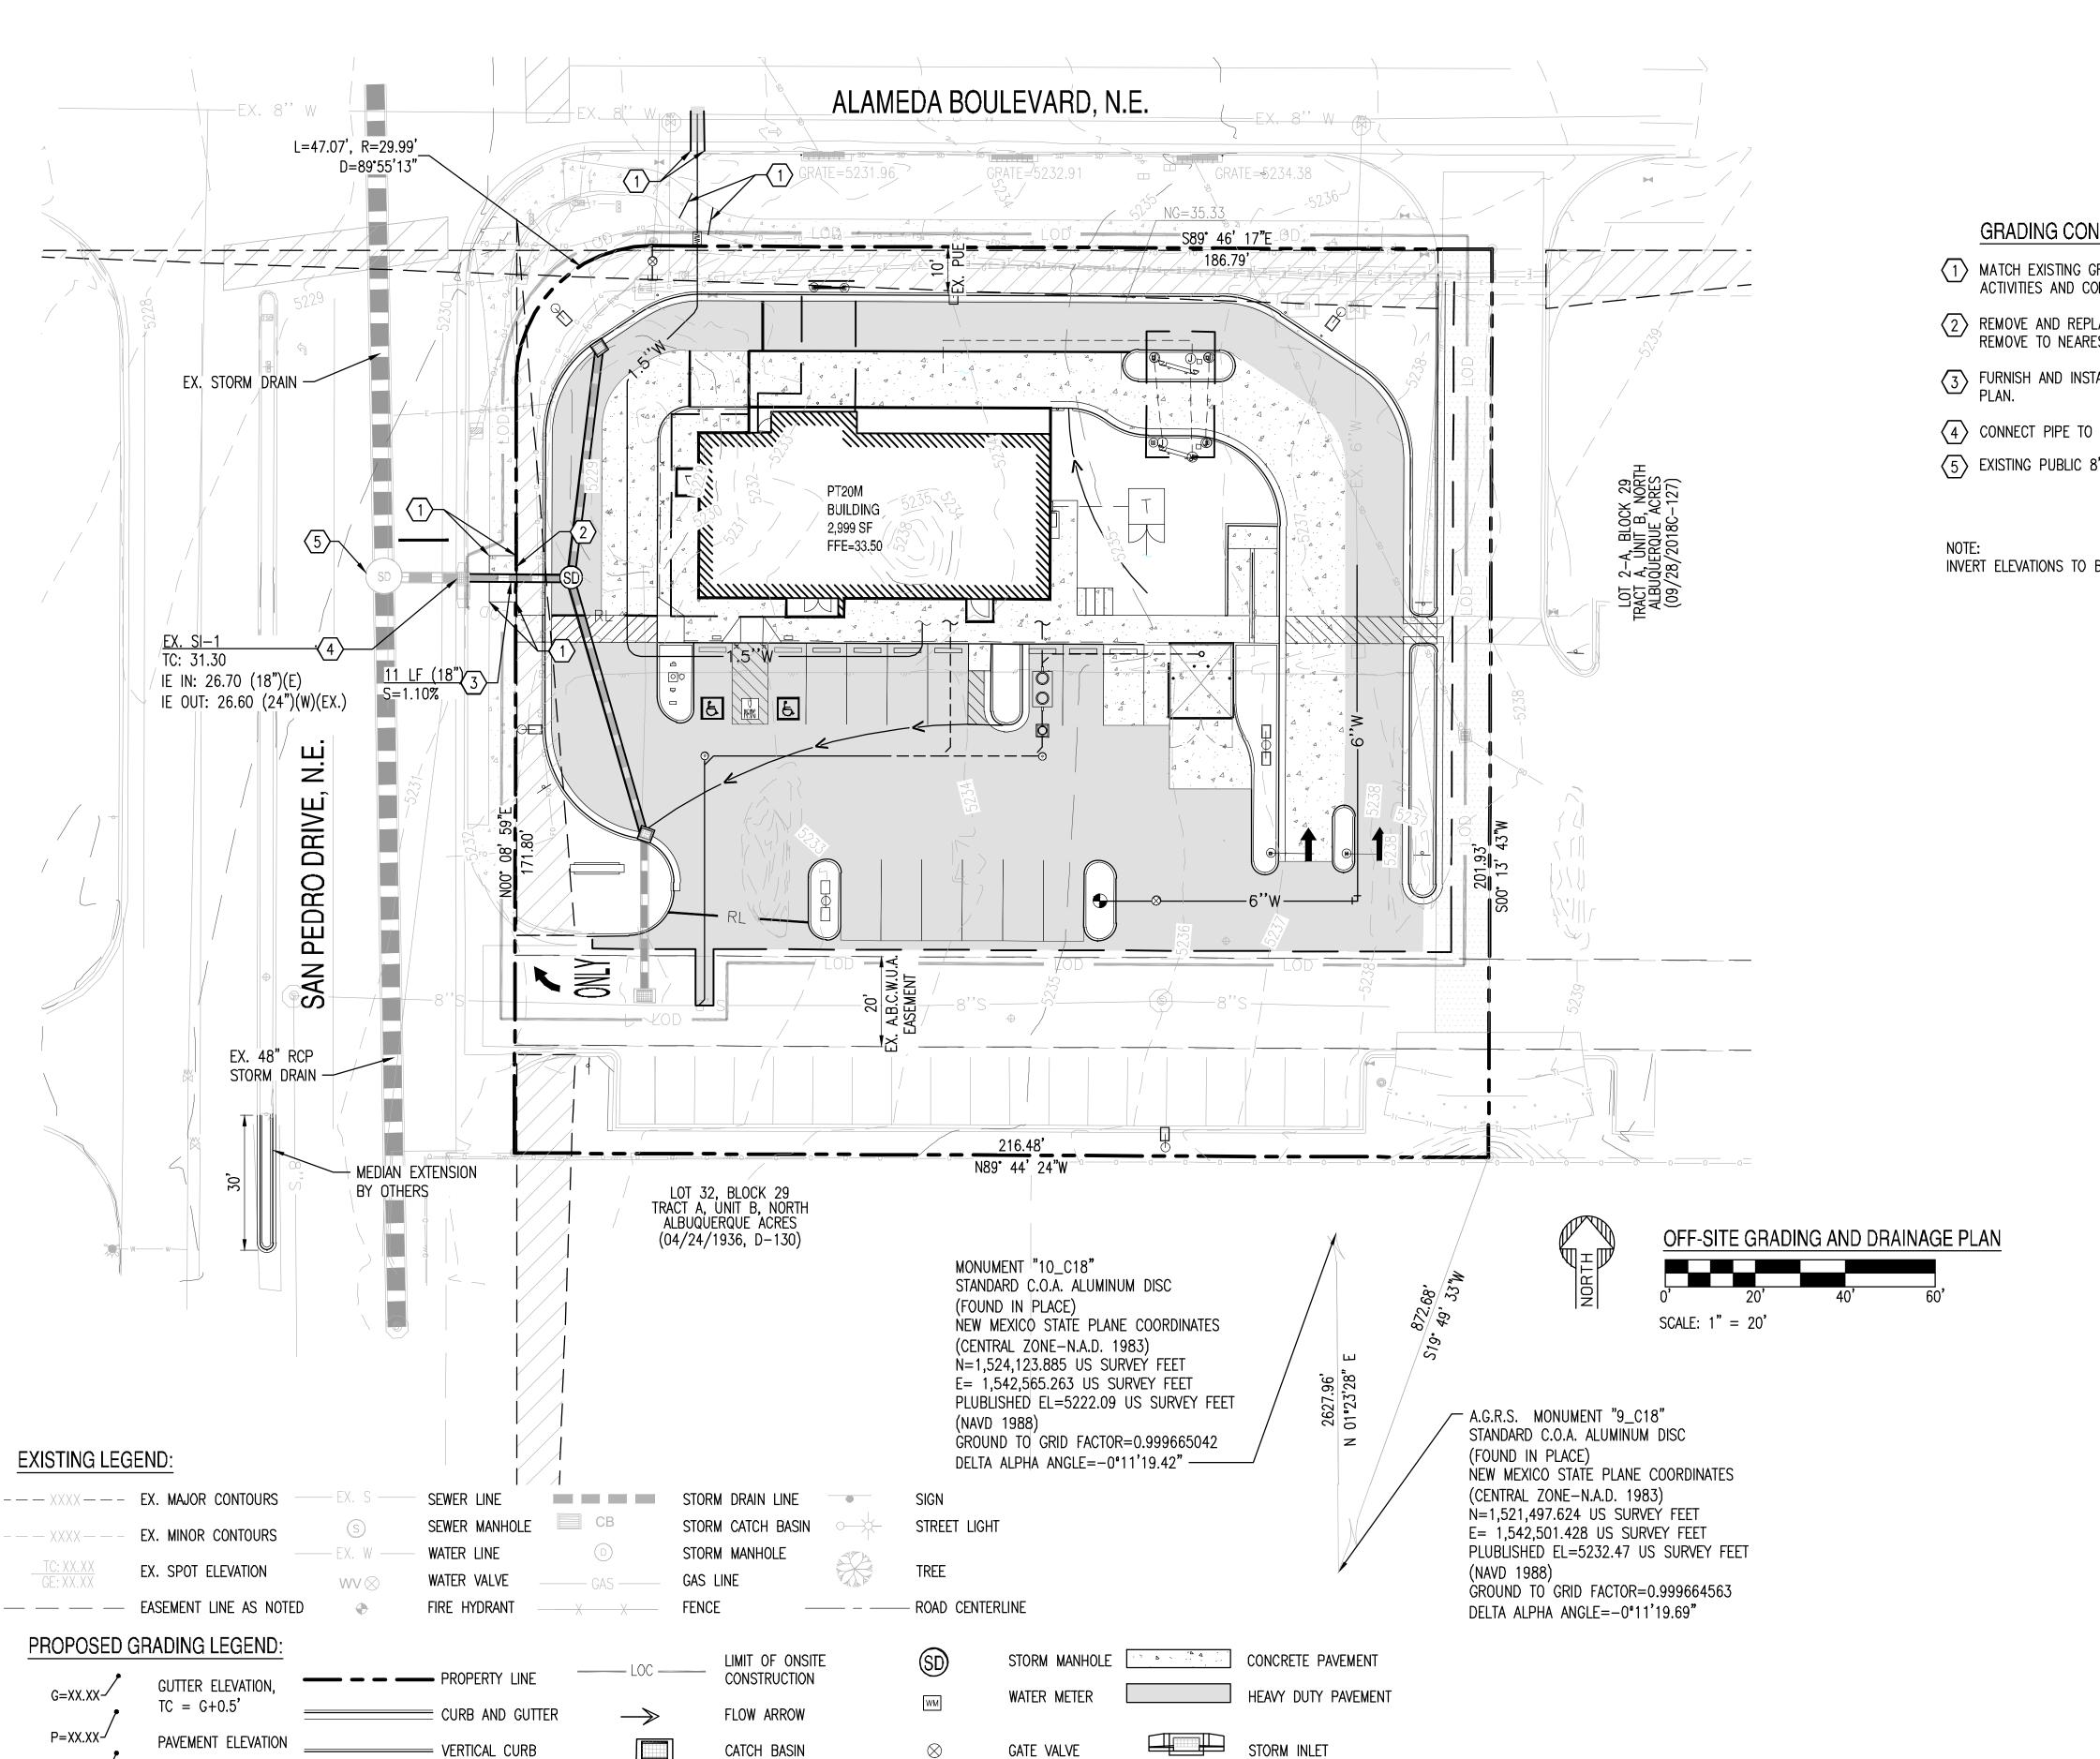


FIRE HYDRANT


C=XX.XX-


STORM PIPE

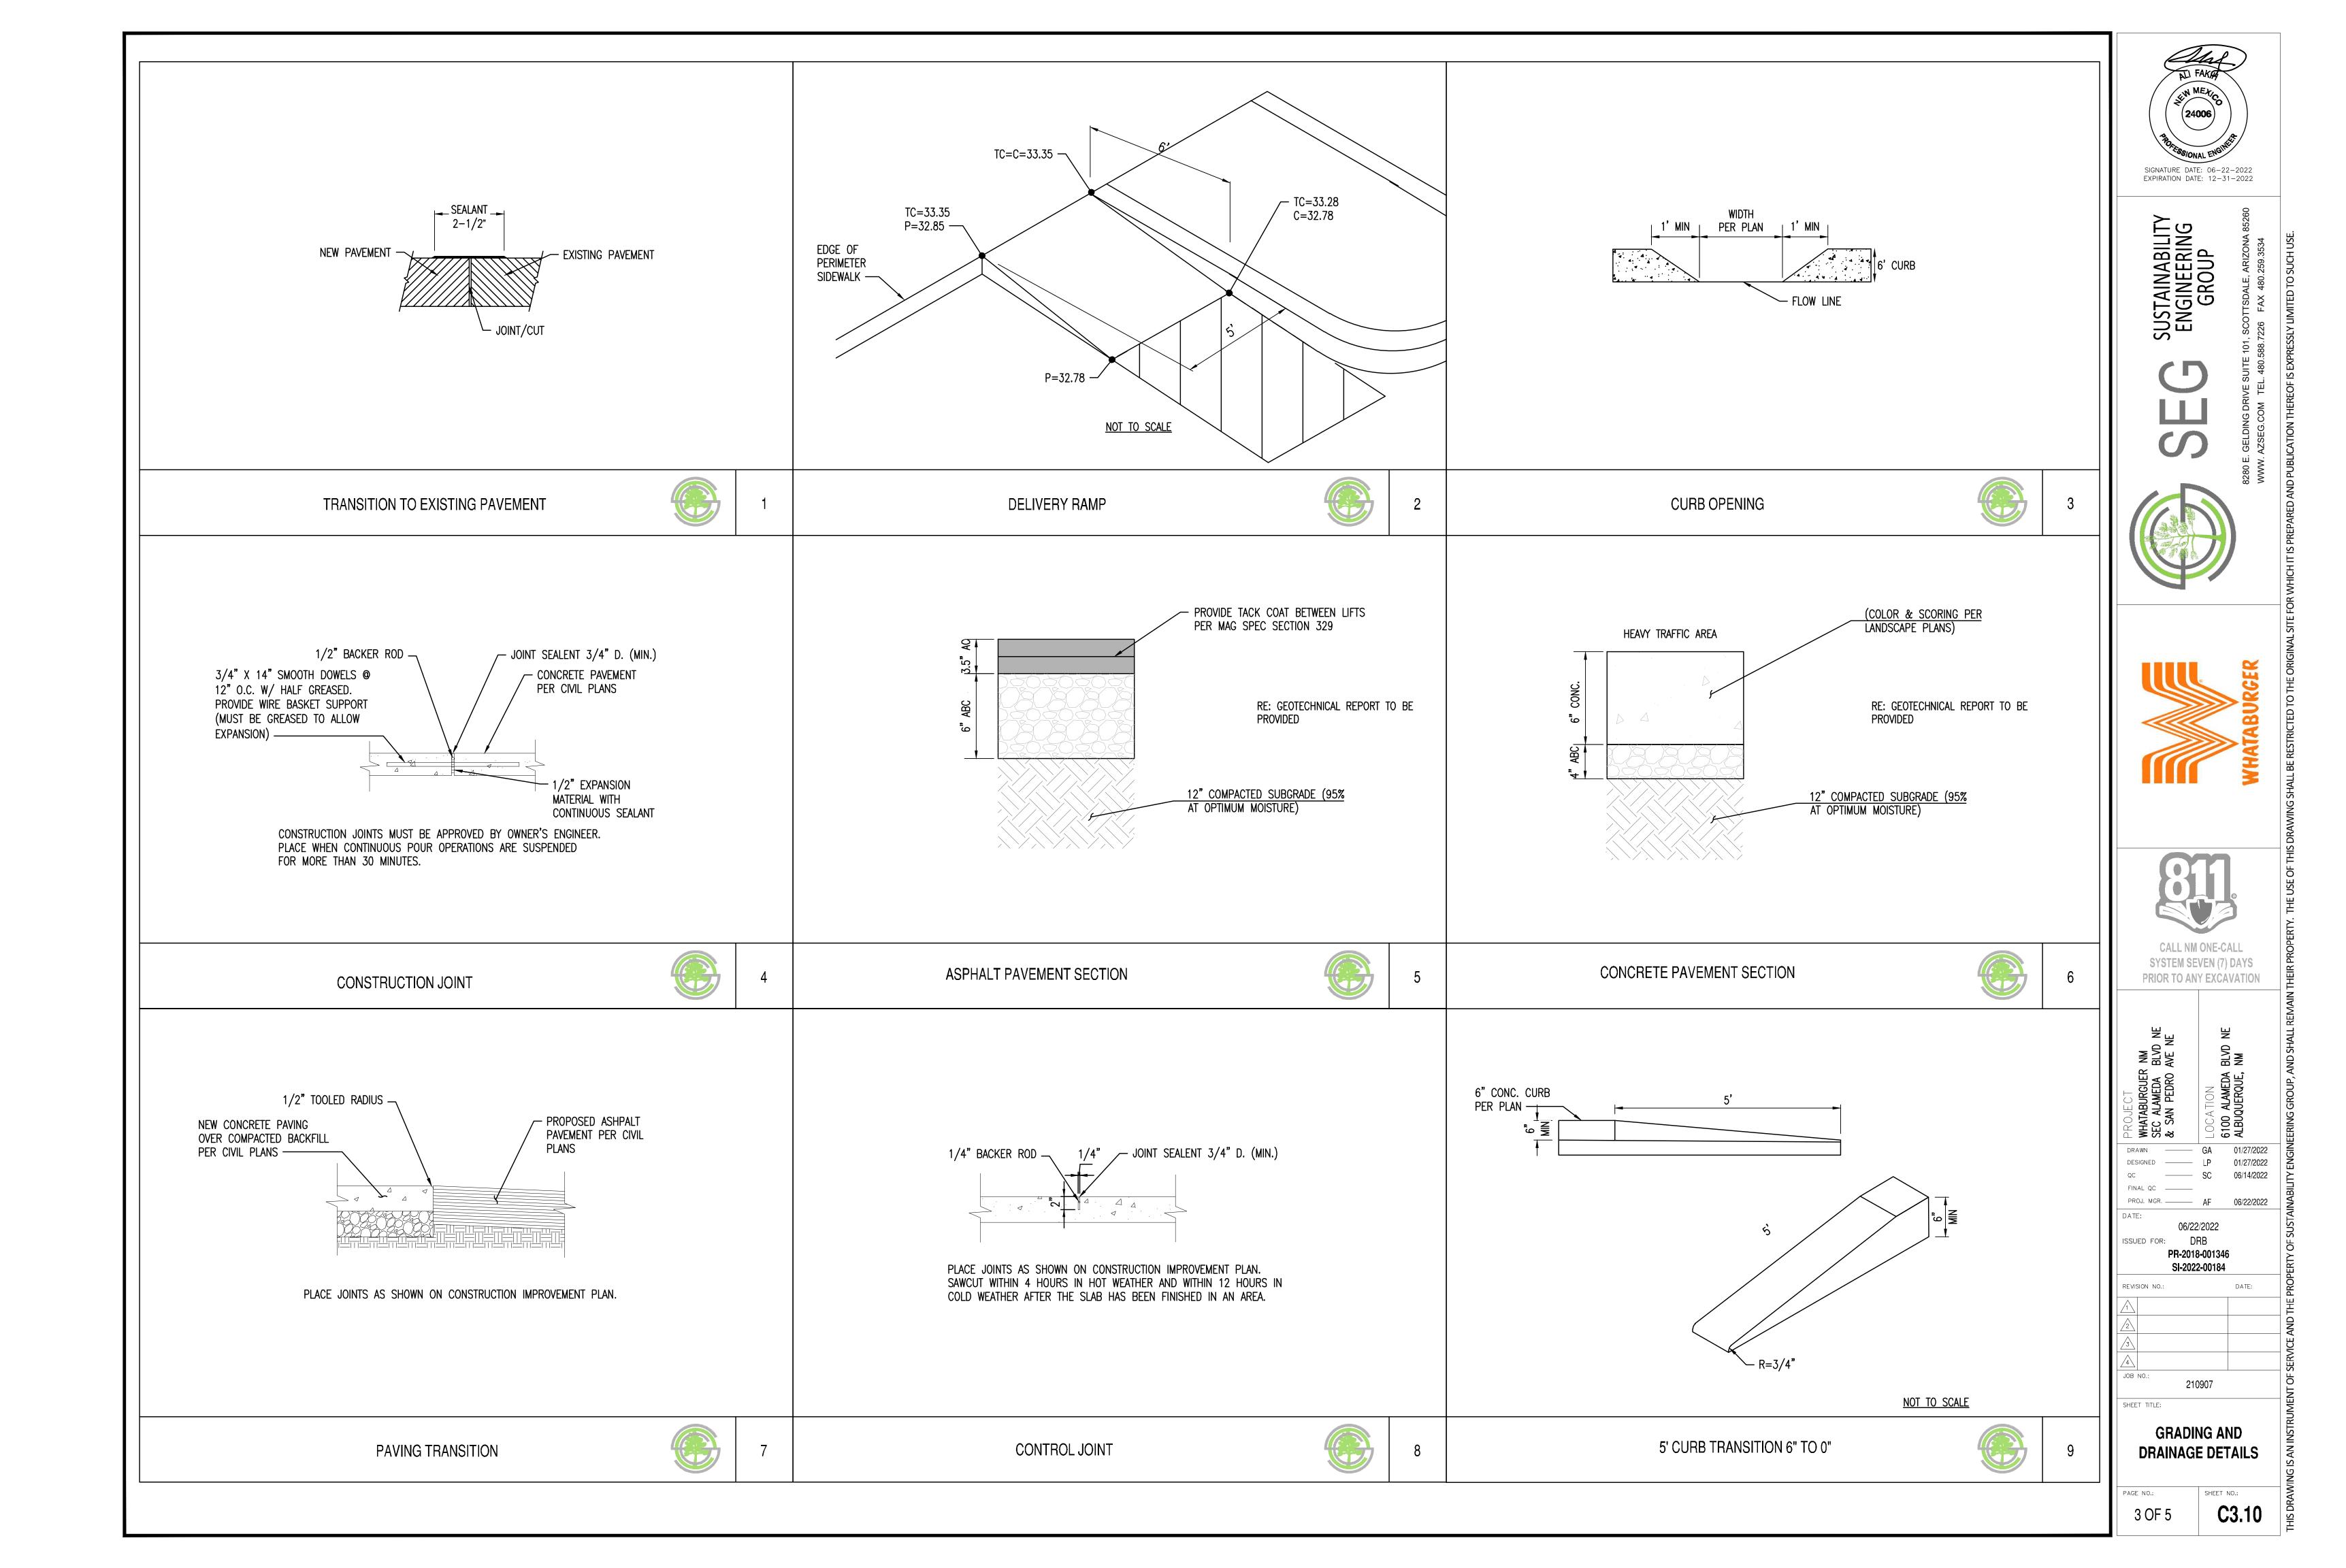

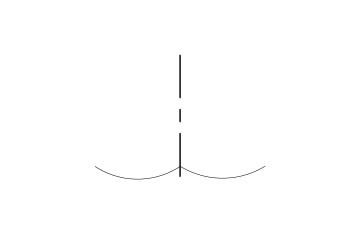

	RE	EINFO	RCING TABLE	
Ø CMP RISER	А	ØВ	REINFORCING	**BEARING PRESSURE (PSF)
24"	Ø 4' 4'x4'	26"	#5 @ 10" OCEW #5 @ 10" OCEW	2,540 1,900
30"	Ø 4'-6" 4'-6" x 4'-6"	32"	#5 @ 10" OCEW #5 @ 9" OCEW	2,260 1,670
36"	Ø 5' 5' x 5'	38"	#5 @ 9" OCEW #5 @ 8" OCEW	2,060 1,500
42"	Ø 5'-6" 5'-6" x 5'-6"	44"	#5 @ 8" OCEW #5 @ 8" OCEW	1,490 1,370
48"	Ø 6' 6' x 6'	50"	#5 @ 7" OCEW #5 @ 7" OCEW	1,210 1,270

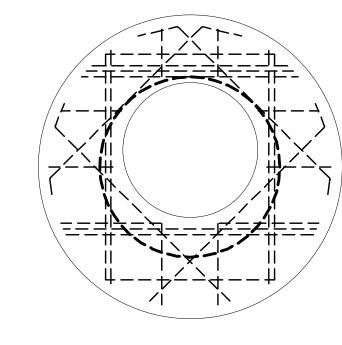

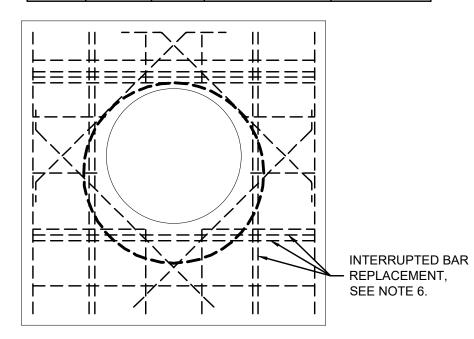

#### NOTES:

CUSTOM LOGO -

1/2" SAN SERIF BOLD FLAT FACE LETTERS

- 1. DESIGN IN ACCORDANCE WITH AASHTO, 17th EDITION AND ACI 350.
- 2. DESIGN LOAD HS25.
- 3. EARTH COVER = 1' MAX.
- 4. CONCRETE STRENGTH = 4,000 psi
- 5. REINFORCING STEEL = ASTM A615, GRADE 60.

26 9/16"

**COVER SECTION** 

FRAME SECTION


- 6. PROVIDE ADDITIONAL REINFORCING AROUND OPENINGS EQUAL TO THE BARS INTERRUPTED, HALF EACH SIDE. ADDITIONAL BARS TO BE IN THE SAME
- 7. TRIM OPENING WITH DIAGONAL #4 BARS, EXTEND BARS A MINIMUM OF 12" BEYOND OPENING, BEND BAR'S AS REQUIRED TO MAINTAIN BAR COVER.
- 8. PROTECTION SLAB AND ALL MATERIALS TO BE PROVIDED AND INSTALLED BY CONTRACTOR.
- 9. DETAIL DESIGN BY DELTA ENGINEERS, ARCHITECTS AND LAND SURVEYORS, ENDWELL, NY.


#### 30"x4" REVERSIBLE FRAME & SOLID COVER


←BLANK TAG AREA


-7/8" DIA HANDLING HOLE

-(2) CLOSED PIČKHOLES

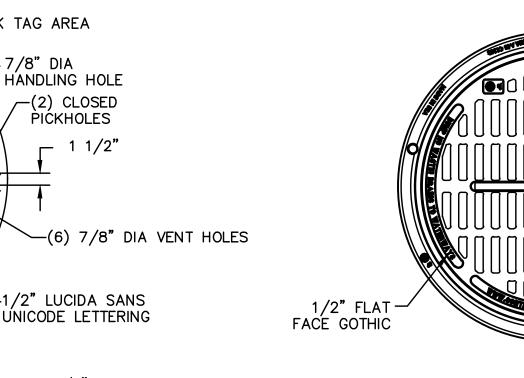

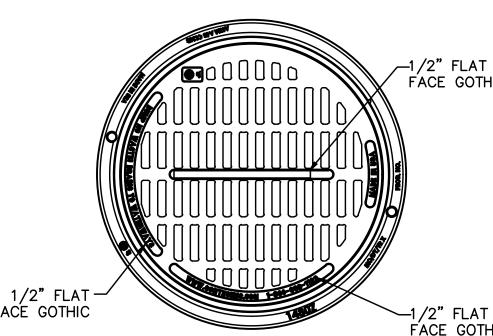


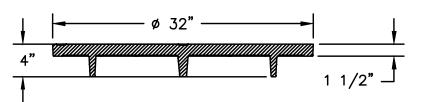

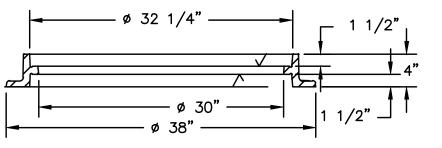

#### 30"x4" REVERSIBLE FRAME & GRATE NYLOPLAST DRAIN BASIN

N-12 HP, & PVC SEWER (4" - 24").

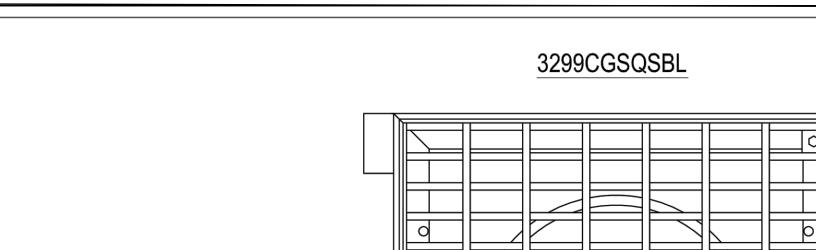

(1) INTEGRATED DUCTILE IRON BASE PLATE TO MATCH BASIN O.D.

> MINIMUM PIPE BURIAL DEPTH PER PIPE

MANUFACTURER

RECOMMENDATION

(MIN. MANUFACTURING

REQ. SAME AS MIN. SUMP)

(CORRUGATED HDPE SHOWN)

(3) VARIABLE INVERT HEIGHTS AVAILABLE (ACCORDING TO PLANS/TAKE OFF)

(4) VARIOUS TYPES OF INLET & OUTLET ADAPTERS AVAILABLE:

4" - 30" FOR CORRUGATED HDPE (ADS N-12/HANCOR DUAL WALL,

ADS/HANCOR SINGLE WALL), N-12 HP, PVC SEWER (EX: SDR 35),

PVC DWV (EX: SCH 40), PVC C900/C905, CORRUGATED & RIBBED PVC

1 - 12" - 30" BASE PLATES SHALL BE DUCTILE IRON PER ASTM A536 GRADE 70-50-05.

- DRAIN BASIN TO BE CUSTOM MANUFACTURED ACCORDING TO PLAN DETAILS.

- DRAINAGE CONNECTION STUB JOINT TIGHTNESS SHALL CONFORM TO

ASTM D3212 FOR CORRUGATED HDPE (ADS N-12/HANCOR DUAL WALL),

- ADAPTERS CAN BE MOUNTED ON ANY ANGLE 0° TO 360°. TO DETERMINE

MINIMUM ANGLE BETWEEN ADAPTERS SEE DRAWING NO. 7001-110-012.

NOTE: LOCATION OF LOCKING DEVICE MAY VARY

- FRAME & GRATE SHALL BE STEEL PER ASTM A36.

6 - STEEL BAR GRATE SHALL MEET H-20 LOAD RATING.

NYLOPLAST DRAIN BASIN WITH 2 FT X 2FT STEEL BAR GRATE

ANGLES

VARIABLE 0° - 360°

ACCORDING TO

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(2) STEEL BAR FRAME & GRATE

18" MIN WIDTH GUIDELINE

8" MIN THICKNESS GUIDELINE

TRAFFIC LOADS: CONCRETE SLAB DIMENSIONS ARE FOR GUIDELINE

THE BACKFILL MATERIAL SHALL BE CRUSHED STONE OR OTHER GRANULAR MATERIAL MEETING THE REQUIREMENTS OF CLASS I,

BEDDING & BACKFILL FOR SURFACE DRAINAGE INLETS SHALL BE PLACED & COMPACTED UNIFORMLY IN ACCORDANCE WITH ASTM D2321.

CLASS II, OR CLASS III MATERIAL AS DEFINED IN ASTM D2321.

(3) VARIABLE SUMP DEPTH ACCORDING TO PLANS (6" MIN ON 12" - 24", 10" MIN ON 30"

BASED ON MANUFACTURING REQ.)

Nyloplast FAX (770) 932-2490 www.nyloplast-us.com

DRAIN BASIN WITH 2 FT X 2 FT STEEL BAR GRATE

QUICK SPEC INSTALLATION DETAIL

7001-110-394

**BUFORD, GA 30518** 

PHN (770) 932-2443

PURPOSES ONLY. ACTUAL CONCRETE SLAB MUST BE DESIGNED


TAKING INTO CONSIDERATION LOCAL SOIL CONDITIONS, TRAFFIC

LOADING, & OTHER APPLICABLE DESIGN FACTORS.

4" MIN ON 12" - 24"


6" MIN ON 30"


©2013 NYLOPLAST DWG SIZE A SCALE 1:40 SHEET 1 OF 1 DWG NO.

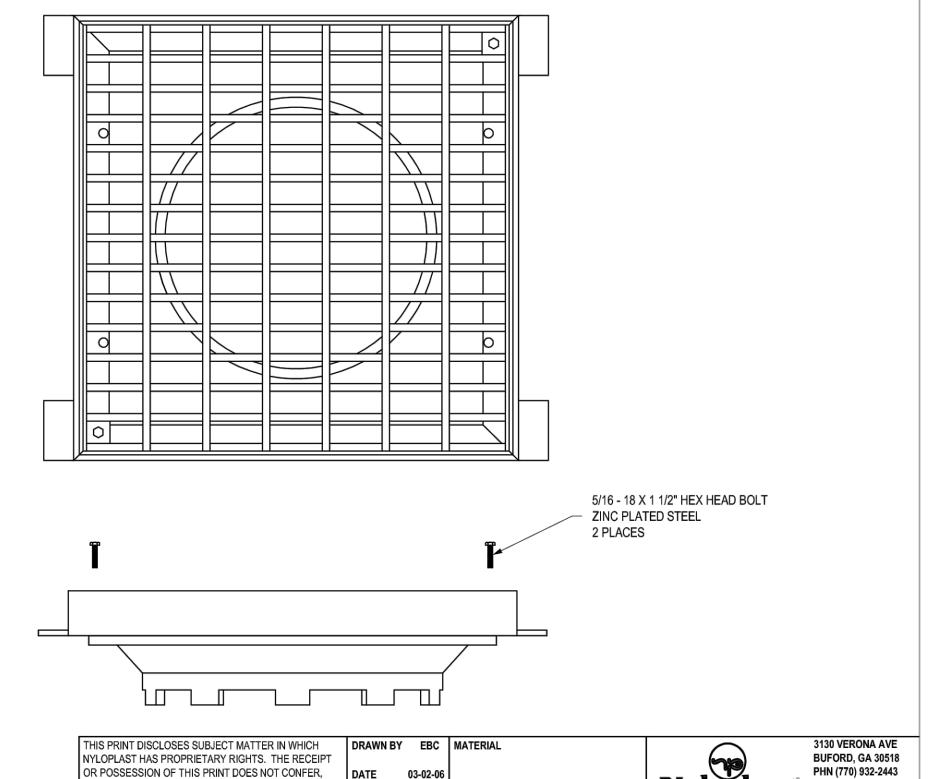

REVISED BY CCA PROJECT NO./NAME

DWG SIZE A SCALE 1:8 SHEET 1 OF 1 DWG NO.

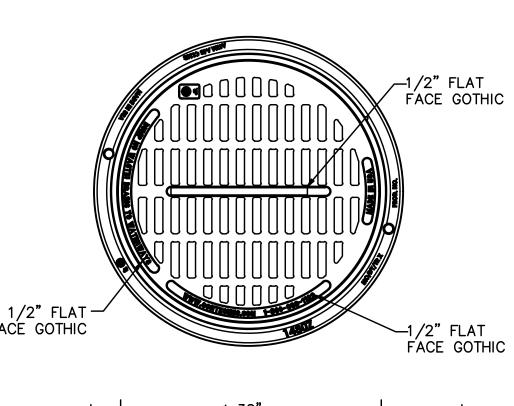

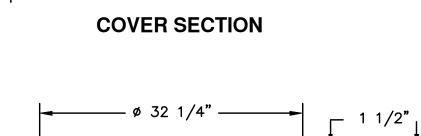

FRAME SECTION

NYLOPLAST GRATE

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REV D

Nyloplast FAX (770) 932-2490 www.nyloplast-us.com

2 FT X 2 FT STEEL BAR LOCKING GRATE ASSEMBLY

7001-110-236

SIGNATURE DATE: 06-22-2022 EXPIRATION DATE: 12-31-2022

SUSTAINABILITY ENGINEERING GROUP

SYSTEM SEVEN (7) DAYS PRIOR TO ANY EXCAVATION

----- SC 06/14/2022 FINAL QC \_\_\_\_\_ PROJ. MGR. — AF 06/22/2022

ISSUED FOR: DRB PR-2018-001346 SI-2022-00184 REVISION NO .:


JOB NO.: 210907

**GRADING AND** DRAINAGE DETAILS

C3.11


SHEET TITLE:

RISER DETAIL

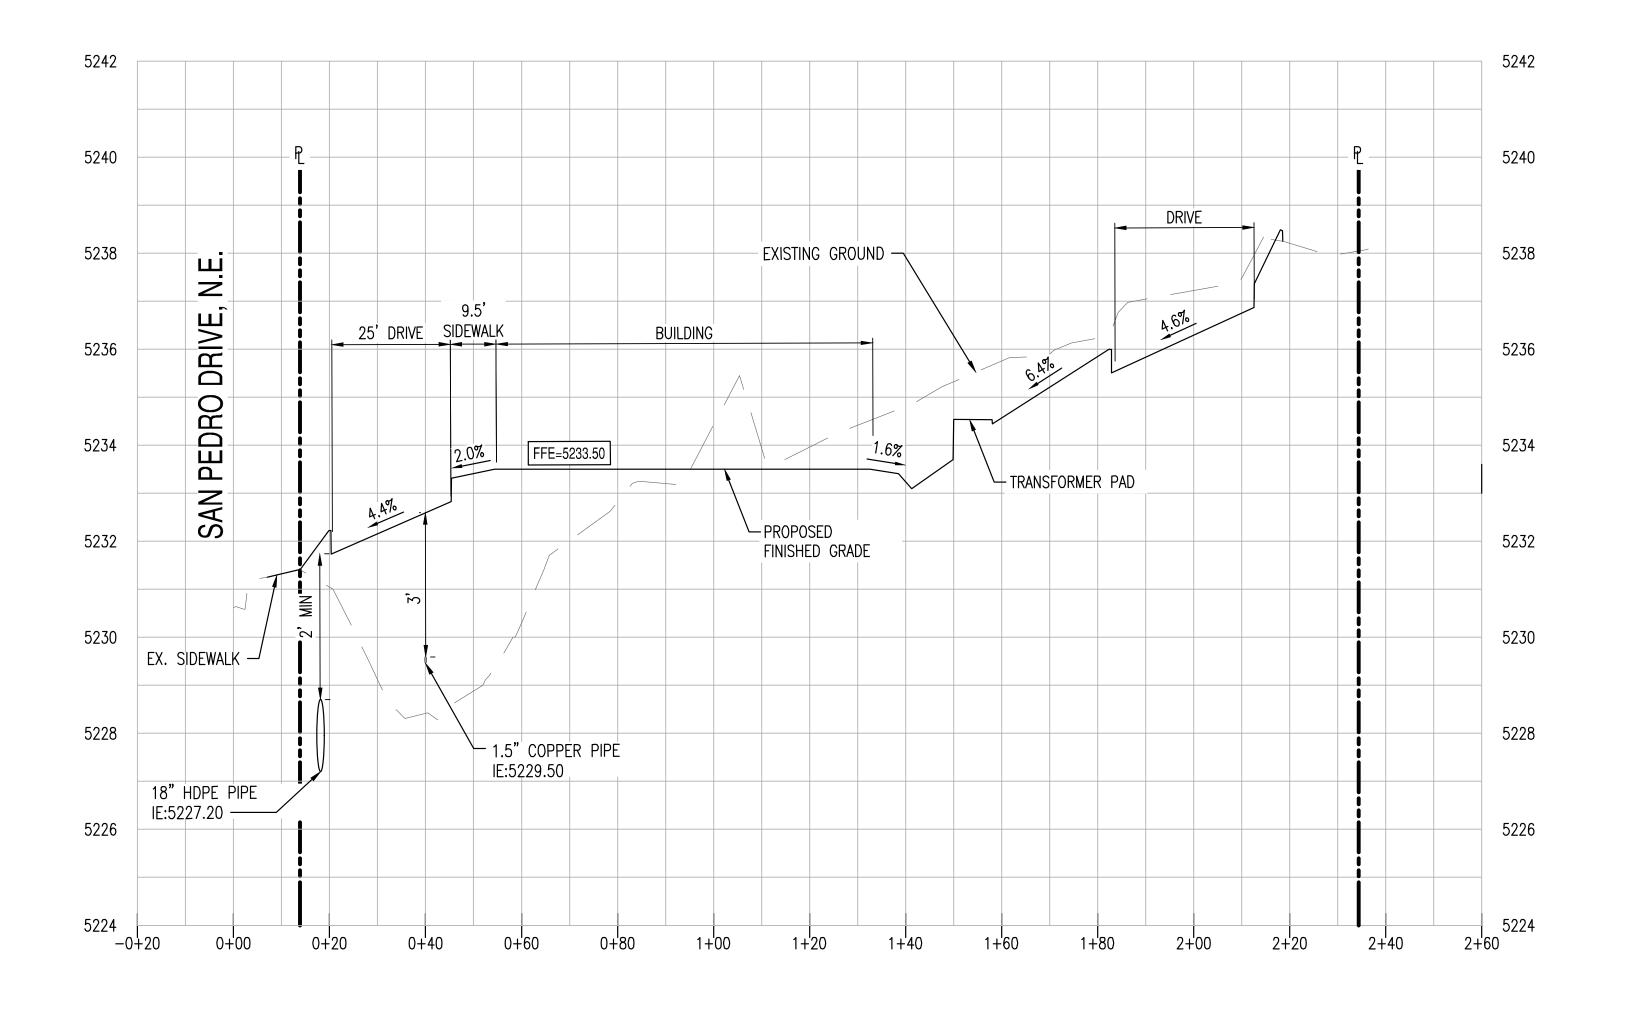

SECTION A-A C3.00

HORIZONTAL SCALE: 1" = 20'
VERTICAL SCALE: 1" = 2'

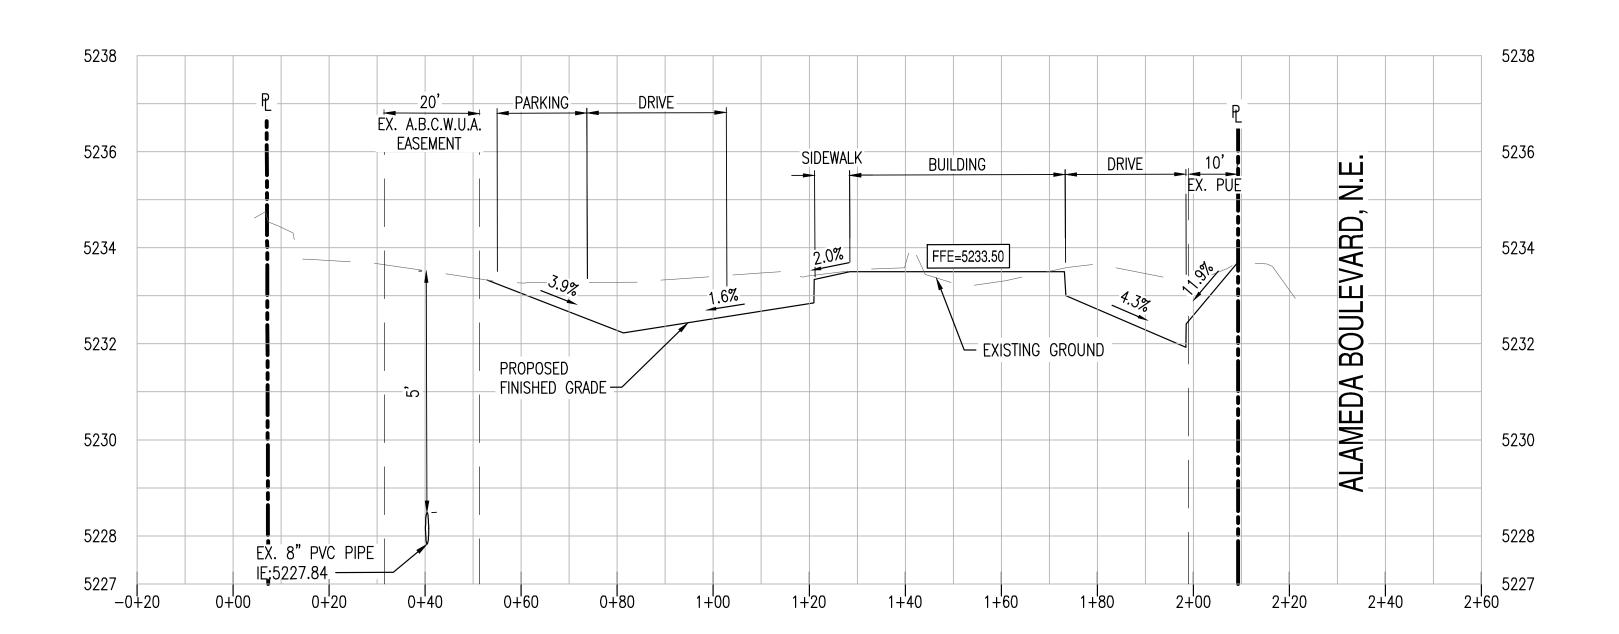

SECTION B-B C3.00

HORIZONTAL SCALE: 1" = 20'
VERTICAL SCALE: 1" = 2'



SUSTAINABILITY ENGINEERING GROUP









MEDA BLVD NE
EDRO AVE NE
NA
NA
NA
ROUE, NM

G1/22/10

G100 ALAMEI

ALBUQUERQU

DESIGNED — LP 01/27/2022
QC — SC 06/14/2022
FINAL QC — PROJ. MGR. — AF 06/22/2022

DATE:

06/22/2022
ISSUED FOR: DRB
PR-2018-001346
SI-2022-00184

REVIS	SION NO.:			DATE:	
1					
2					
3					
4					
JOB	NO.:	,	210907		
SHEE	T TITLE:				

SITE CROSS SECTIONS

5 OF 5

C3.20

PLUMBING
FAISAL ELHALIS
35080 W LAREDO ST WAY
CHANDLER, AZ 85226
PHONE: 602-492-7944
CONTACT: FAISAL ELHALIS
EMAIL: ELHALISF@GMAIL.COM
LATEST PLAN COORDINATION: 05/12/22

PROPOSED UTILITY LEGEND:

PROPERTY LINE

- 8\*W ----- WATER LINE

— — EASEMENT LINE AS NOTED

CHAINLINKE FENCE

— — — EASEMENT LINE

—— – CENTERLINE

EXISTING LEGEND:

FIRE HYDRANT

WATER METER

SEWER LINE

WATER LINE

WATER VALVE

FIRE HYDRANT

SEWER MANHOLE

BACK FLOW PREVENTER

BUILDING CONNECTION

STORM DRAIN LINE

STORM MANHOLE

IRRIGATION LINE

GAS LINE

STORM CATCH BASIN

SEWER CLEAN OUT

FDC

—— EX. S —

LANDSCAPE
HARRINGTON PLANNING AND DESIGN
1921 S. ALMA SCHOOL RD, STE. 204
SCOTTSDALE, AZ 85251
PHONE: 480-250-0116
CONTACT: JASON HARRINGTON
EMAIL: JASON@HARRINGTONPLANNINGDESIGN.COM
LATEST PLAN COORDINATION: 05/04/22

ELECTRICAL
OMID ARDEBILI
7328 E STETSON DR
SCOTTSDALE, AZ 85251
PHONE: 480-626-7072
CONTACT: OMID ARDEBILI P.E.
EMAIL: OMID@ARDEBILIENG.COM
LATEST PLAN COORDINATION: 05/11/22

# WHATABURGER UTILITY PLAN

6100 NE ALAMEDA BLVD, ALBUQUERQUE, NM A PORTION OF SECTION 13, TOWNSHIP 11 NORTH, RANGE 3 EAST, BERNALILLO COUNTY, NEW MEXICO.

STANDAR C.O.A. ALUMINUM DISC

(CENTRAL ZONE-N.A.D. 1983)

N=1,521,497.624 US SURVEY FEET E= 1,542,501.428 US SURVEY FEET

DELTA ALPHA ANGLE=-0°11'19.69"


NEW MEXICO STATE PLANE COORDINATES


PLUBLISHED EL=5232.47 US SURVEY FEET

GROUND TO GRID FACTOR=0.999664563

(FOUND IN PLACE)

(NAVD 1988)

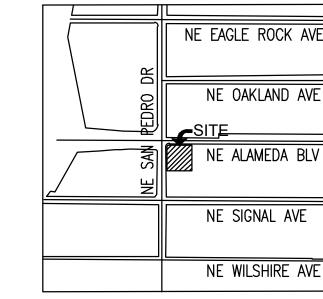

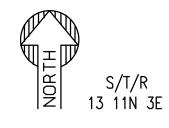

VICINITY MAP


SCALE 1:800

#### WATER CONSTRUCTION KEY NOTES

- CONTRACTOR TO VERIFY SIZE AND LOCATION OF EXISTING WATER LINE PRIOR TO CONSTRUCTION.
- (2) CONNECT TO EXISTING SERVICE MAIN.
- 3 DOMESTIC CONNECTION TO BUILDING, REFER TO MEP PLAN FOR CONTINUATION.
- FURNISH AND INSTALL TYPE "K" COPPER SWEEP, SIZE TO MATCH WATER LINE. ANGLE PER PLAN.
- FURNISH AND INSTALL FITTING, SIZE & ANGLE PER PLAN. WITH RESTRAINED JOINTS PER AWWA C110.
- FURNISH AND INSTALL 6" DUCTILE IRON PIPE, CLASS 350, CEMENT MORTAR LINED, MAINTAIN 3' MINIMUM COVER. PROVIDE POLY WRAP. LENGTH PER PLAN.
- FURNISH AND INSTALL TYPE "K" 1  $\frac{1}{2}$ " COPPER PIPE, LENGTH PER PLAN.
- (8) INSTALL RELOCATED FIRE HYDRANT, PER C.O.A, STD. DWG. 2340.
- 9 FURNISH AND INSTALL REDUCED PRESSURE PRINCIPLE BACKFLOW PREVENTION ASSEMBLY PER C.O.A. STD. DWG. 2385, SIZE PER PLAN.
- FURNISH AND INSTALL 1" PRESSURE VACUUM BREAKER PER C.O.A, STD. DWG. 2388.

#### SEWER CONSTRUCTION KEY NOTES

- 1 CONTRACTOR SHALL VERIFY THE LOCATION OF THE EXISTING SANITARY SEWER LINE BEFORE PROCEEDING WITH TRENCHING. CONTRACTOR SHALL CONTACT ENGINEER IF EXISTING SEWER ELEVATION IS HIGHER THAN PROPOSED TIE—IN INVERT PRIOR TO ANY CONSTRUCTION ACTIVITY.
- 2 TRASH ENCLOSURE SANITARY DRAIN BY BUILDING CONTRACTOR.
- 3 FURNISH AND INSTALL SEWER CLEAN-OUT
- FURNISH AND INSTALL PVC SCH-40 SEWER LINE. S= 2.00% MINIMUM. SIZE, LENGTH AND SLOPE PER PLAN. MAINTAIN 4' MINIMUM COVER.
- REFER TO MEP PLANS FOR CONTINUATION.
- 6 PROVIDE PLUG AND MARKER FOR SEWER STUB
- 7 GREASE INTERCEPTOR BY BUILDING CONTRACTOR.
- 8 SAMPLE WELL BY BUILDING CONTRACTOR.
- 9 FURNISH AND INSTALL WYE. MATCH SIZE WITH PLAN.
- SAWCUT, REMOVE AND REPLACE EXISTING PAVEMENT.

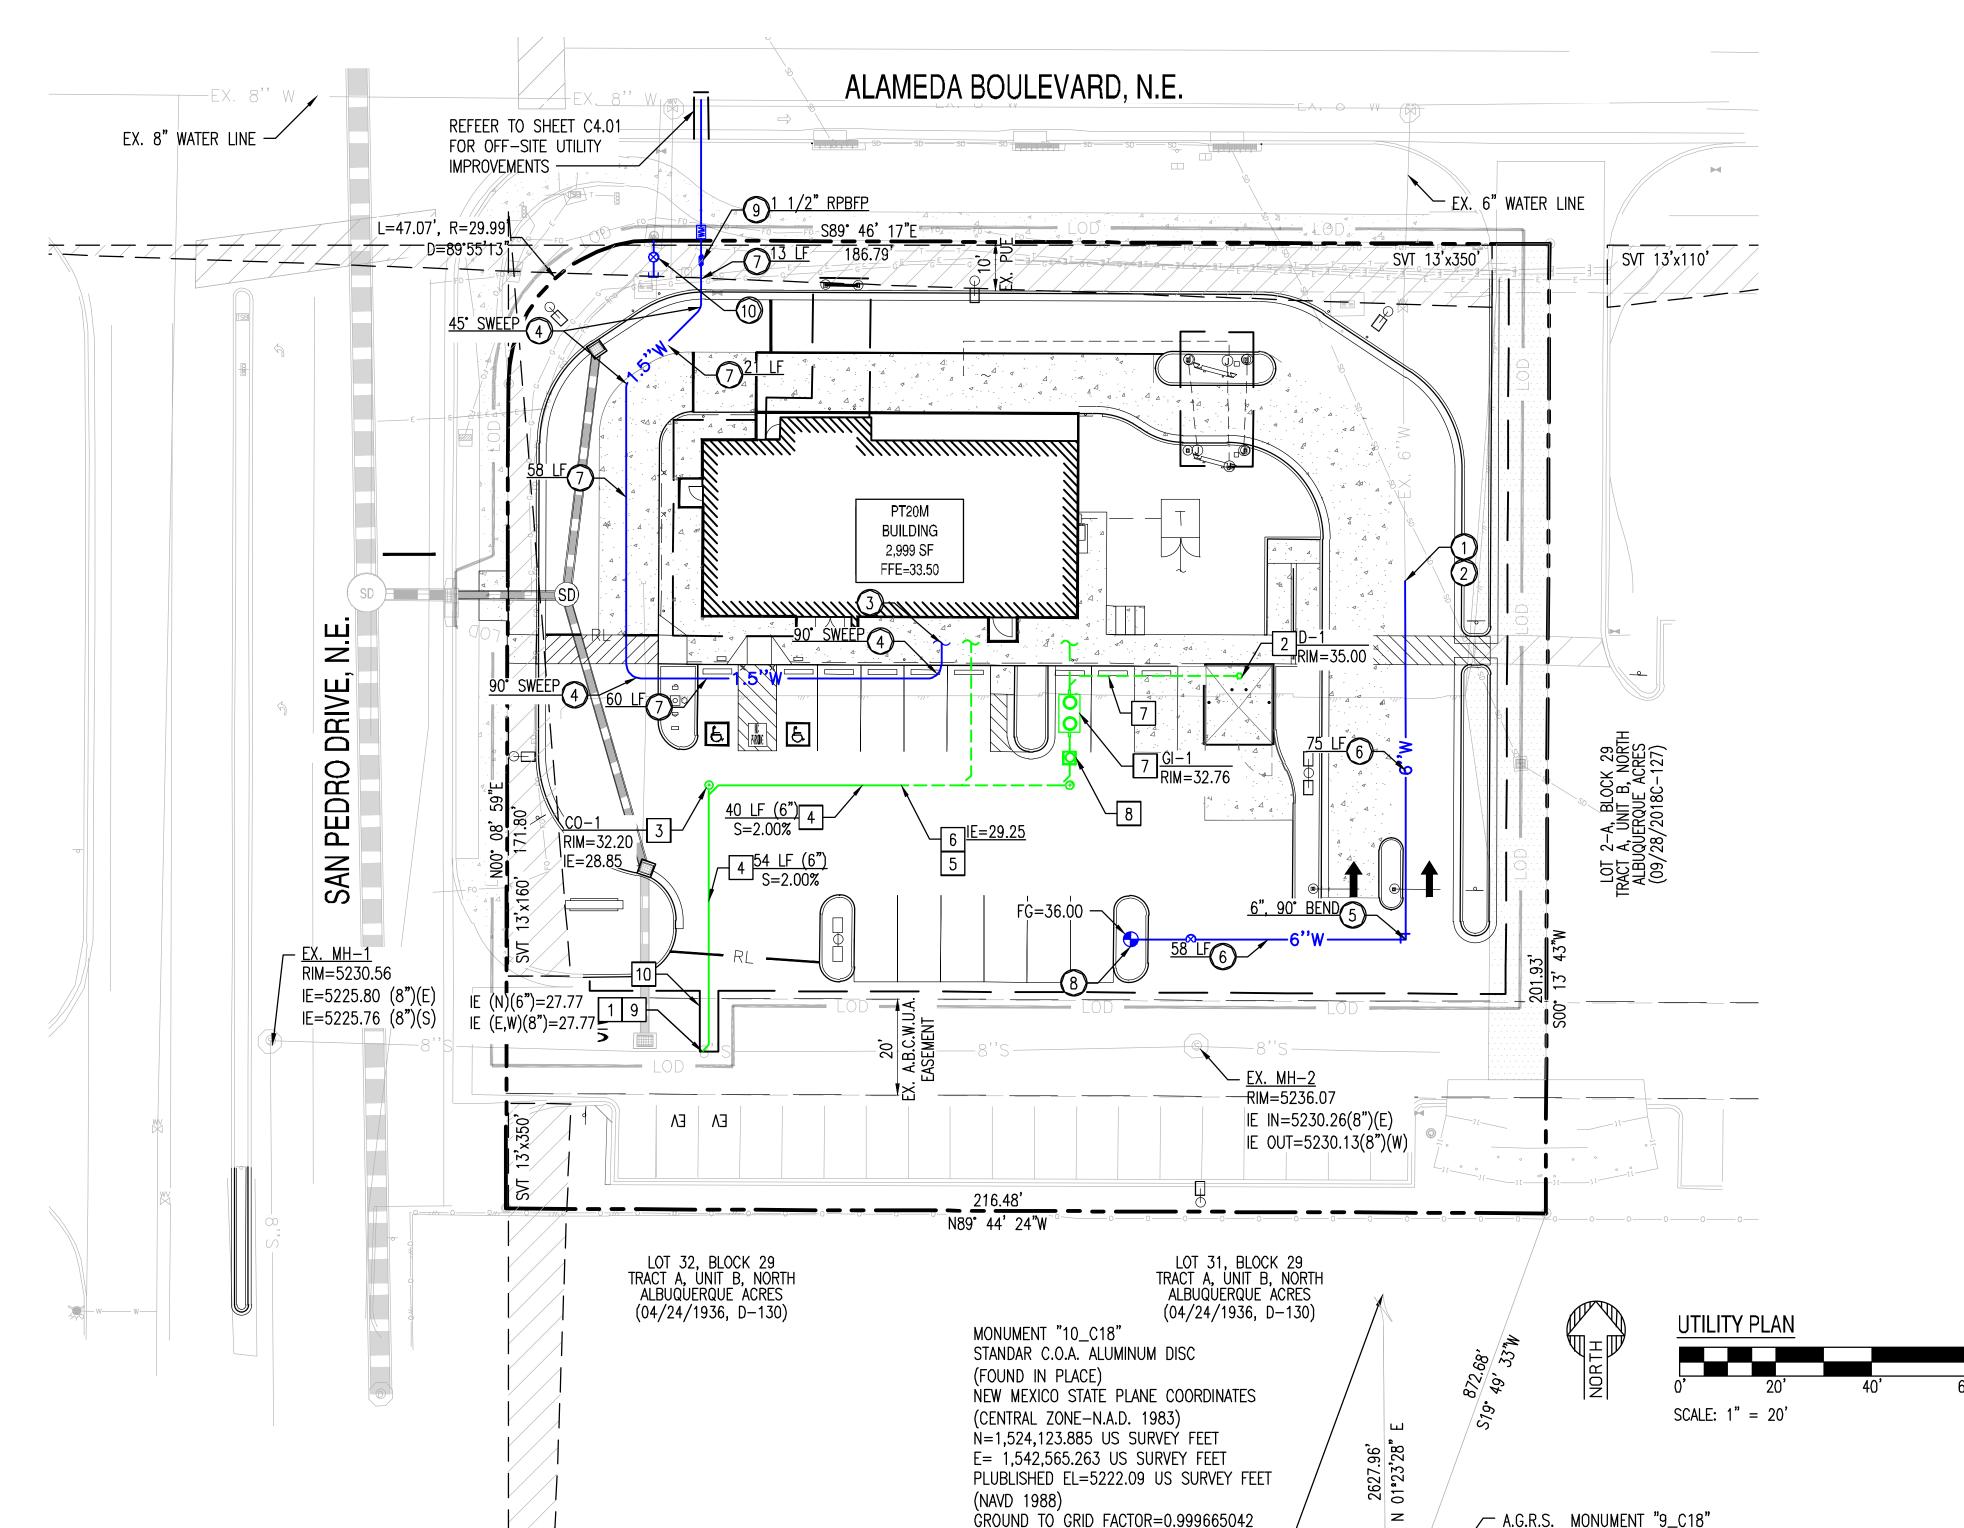

DELTA ALPHA ANGLE=-0°11'19.42" ----

SIGN

STREET LIGHT

- FIBER OPTIC LINE



SUSTAINABILITY ENGINEERING GROUP

S E

8280 E. GELDING







CALL NM ONE-CALL
SYSTEM SEVEN (7) DAYS
PRIOR TO ANY EXCAVATION

PROJECT WHATABURGUER NM SEC ALAMEDA BLVD NE	'N PEDRO AVE N	LOCATION	6100 ALAMEDA BLVD NE ALBUQUERQUE, NM
DRAWN		GA	01/27/2022
DESIGNED		LP	01/27/2022
QC		SC	06/14/2022

PROJ. MGR. — AF 06/22/2022

DATE: 06/22/2022

ISSUED FOR: DRB
PR-2018-001346

FINAL QC \_\_\_\_\_

ı		SI	-2022-00184	
	REVIS	SION NO.:		DATE:
I	1			
I	2			
I	3			
I	4			
	JOB	NO.:	210907	

UTILITY PLAN


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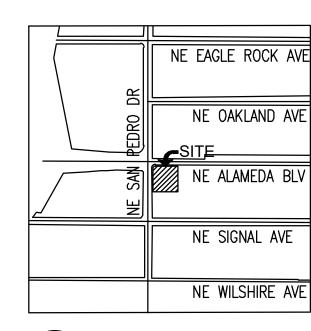
PAGE NO.: SHEET

C4.00


# WHATABURGER OFF-SITE UTILITY PLAN

6100 NE ALAMEDA BLVD, ALBUQUERQUE, NM A PORTION OF SECTION 13, TOWNSHIP 11 NORTH, RANGE 3 EAST, BERNALILLO COUNTY, NEW MEXICO.



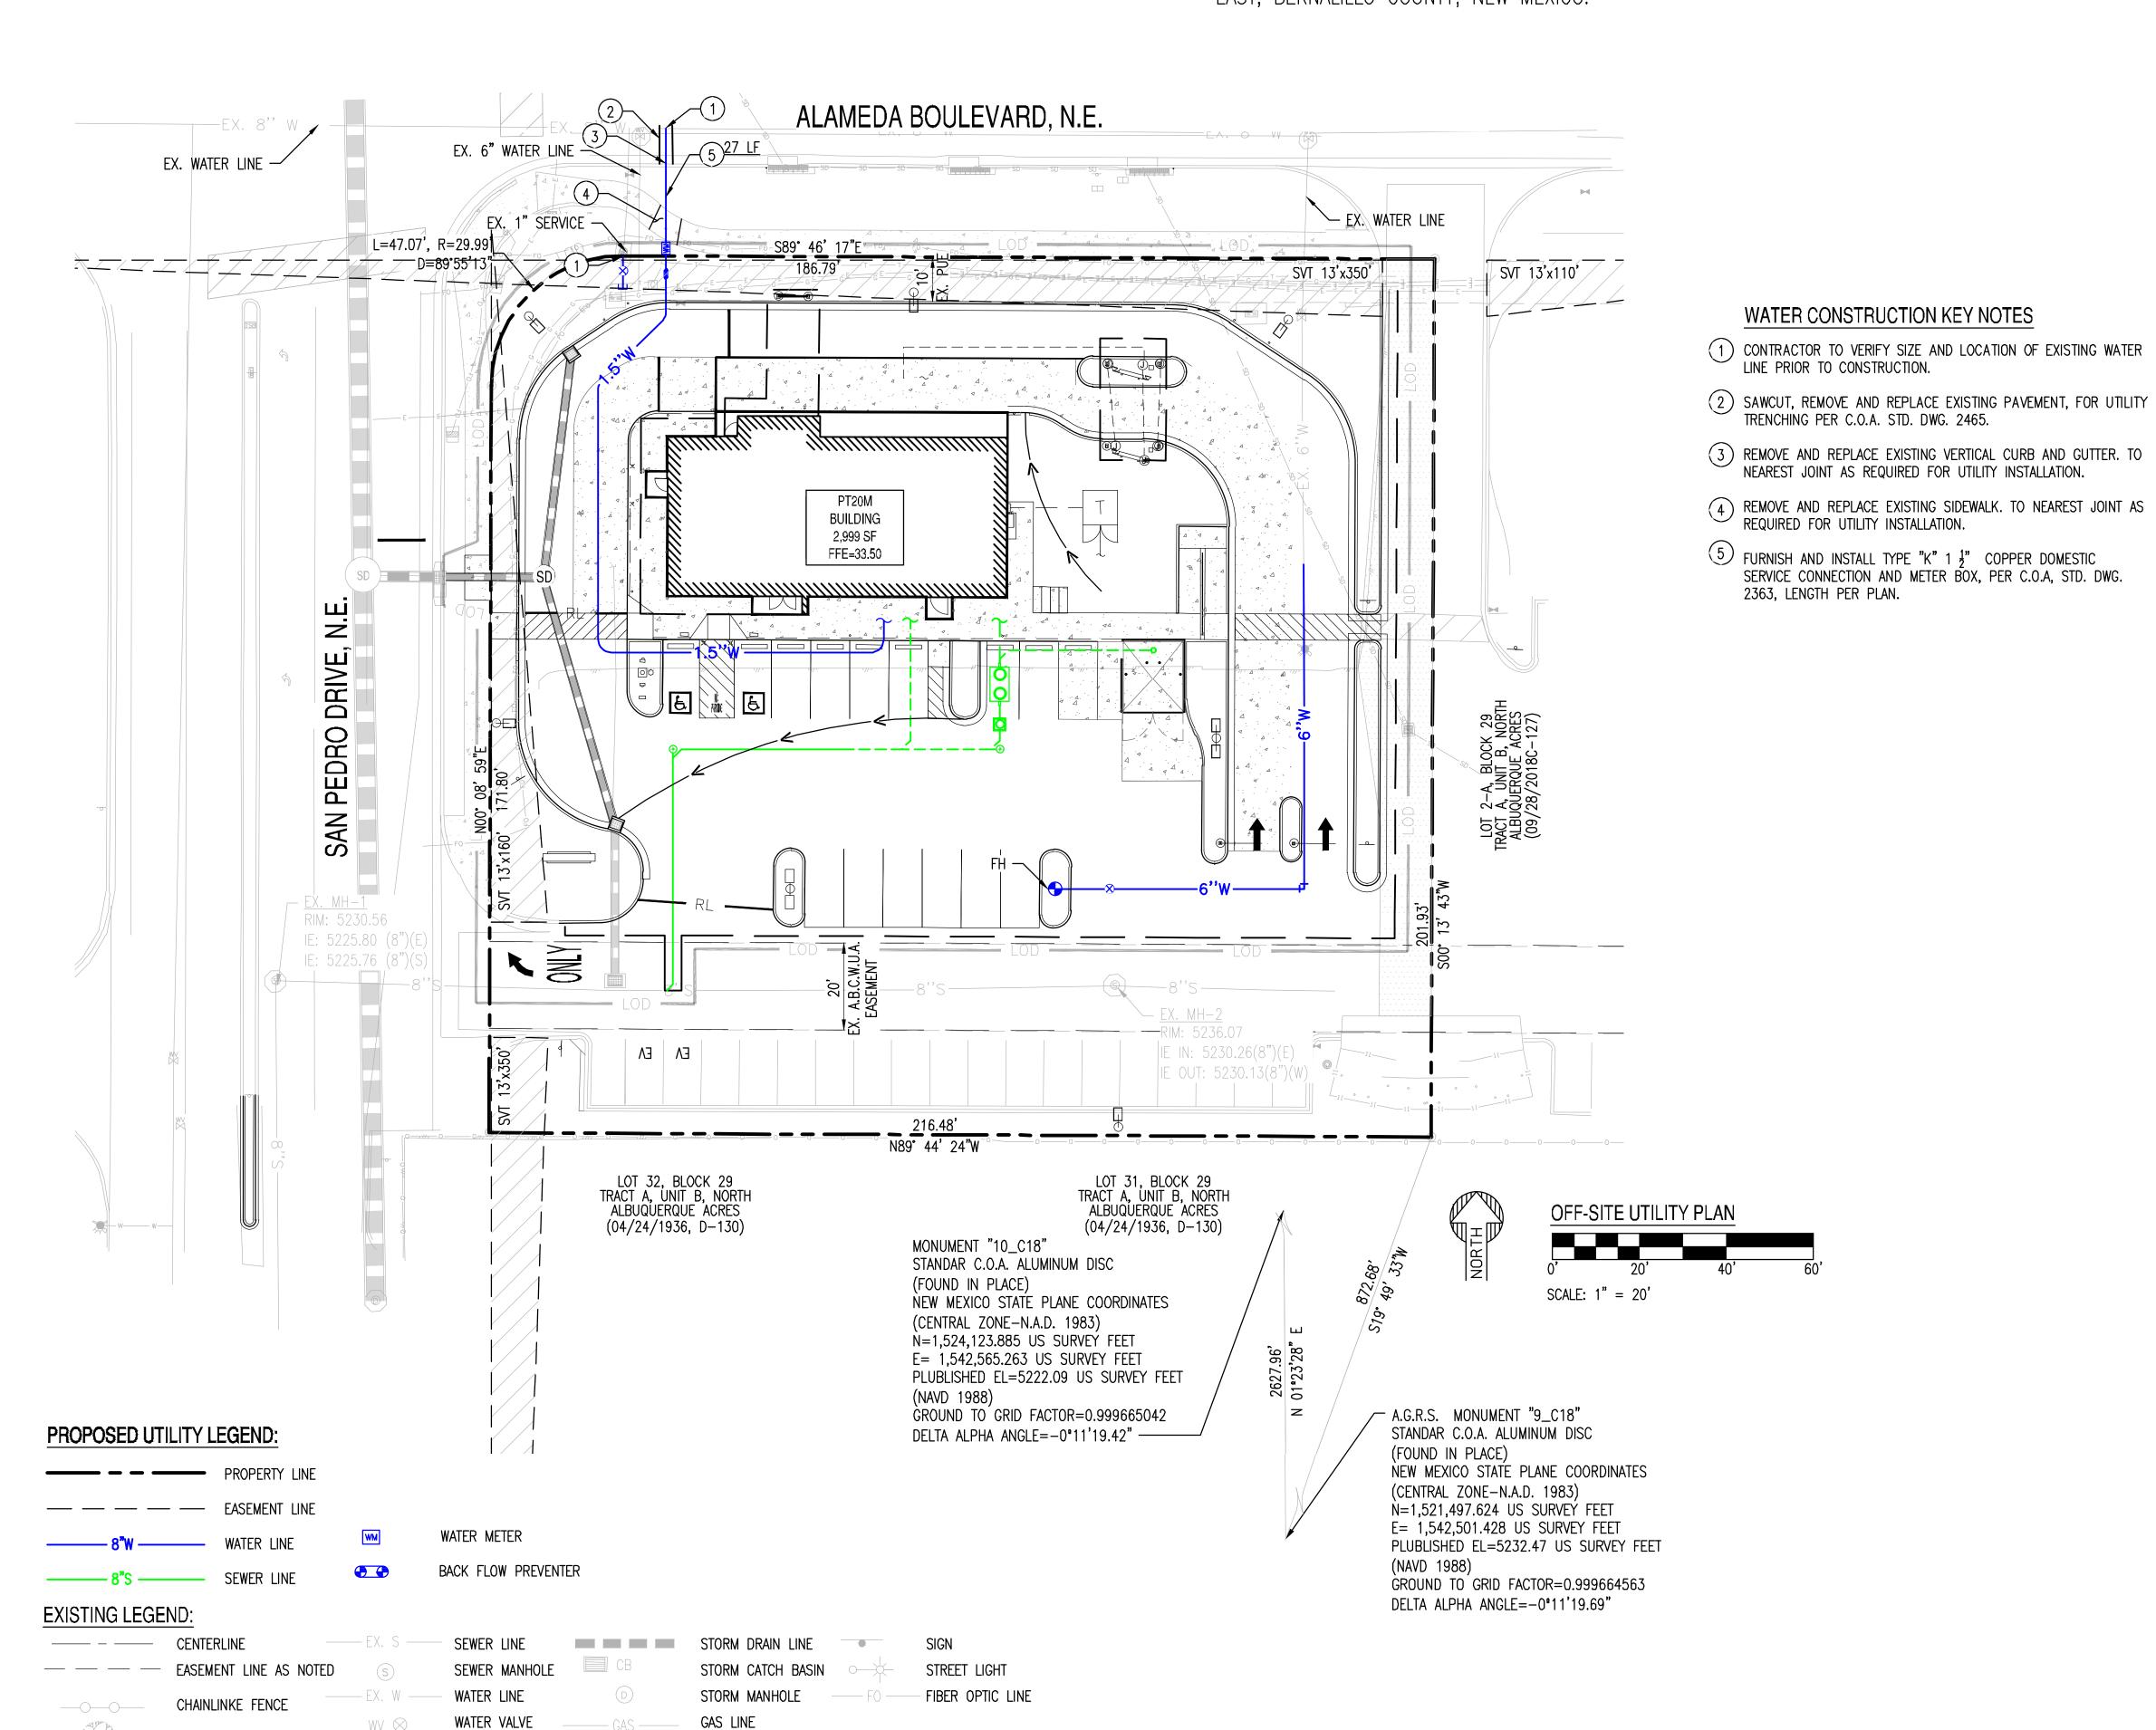



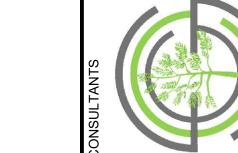

BENCH MARKS

SUSTAINABILITY ENGINEERING GROUP



SIGNATURE DATE: 06-22-2022 EXPIRATION DATE: 12-31-2022

DESCRIPTION
CONTRACTOR:
DATE

DATE TINFORMATION

DESIGNED BY: SO

DRAWN BY: ER

CALL NM ONE-CALL
SYSTEM SEVEN (7) DAYS
PRIOR TO ANY EXCAVATION

DRAWN BY: ER

N (7) DAYS
CHECKED BY: SC

XCAVATION
DATE
06/2022



CITY OF ALBUQUERQUE
DEPARTMENT OF MUNICIPAL DEVELOPMENT
ENGINEERING DIVISION

OFF-SITE UTILITY PLAN


DESIGN REVIEW COMMITTEE CITY ENGINEER APPROVAL ZONE MAP NO.

Z-99
CITY PROJECT NO.
PR-2018-001346
SHEET NO.

C4.01


FIRE HYDRANT

IRRIGATION LINE

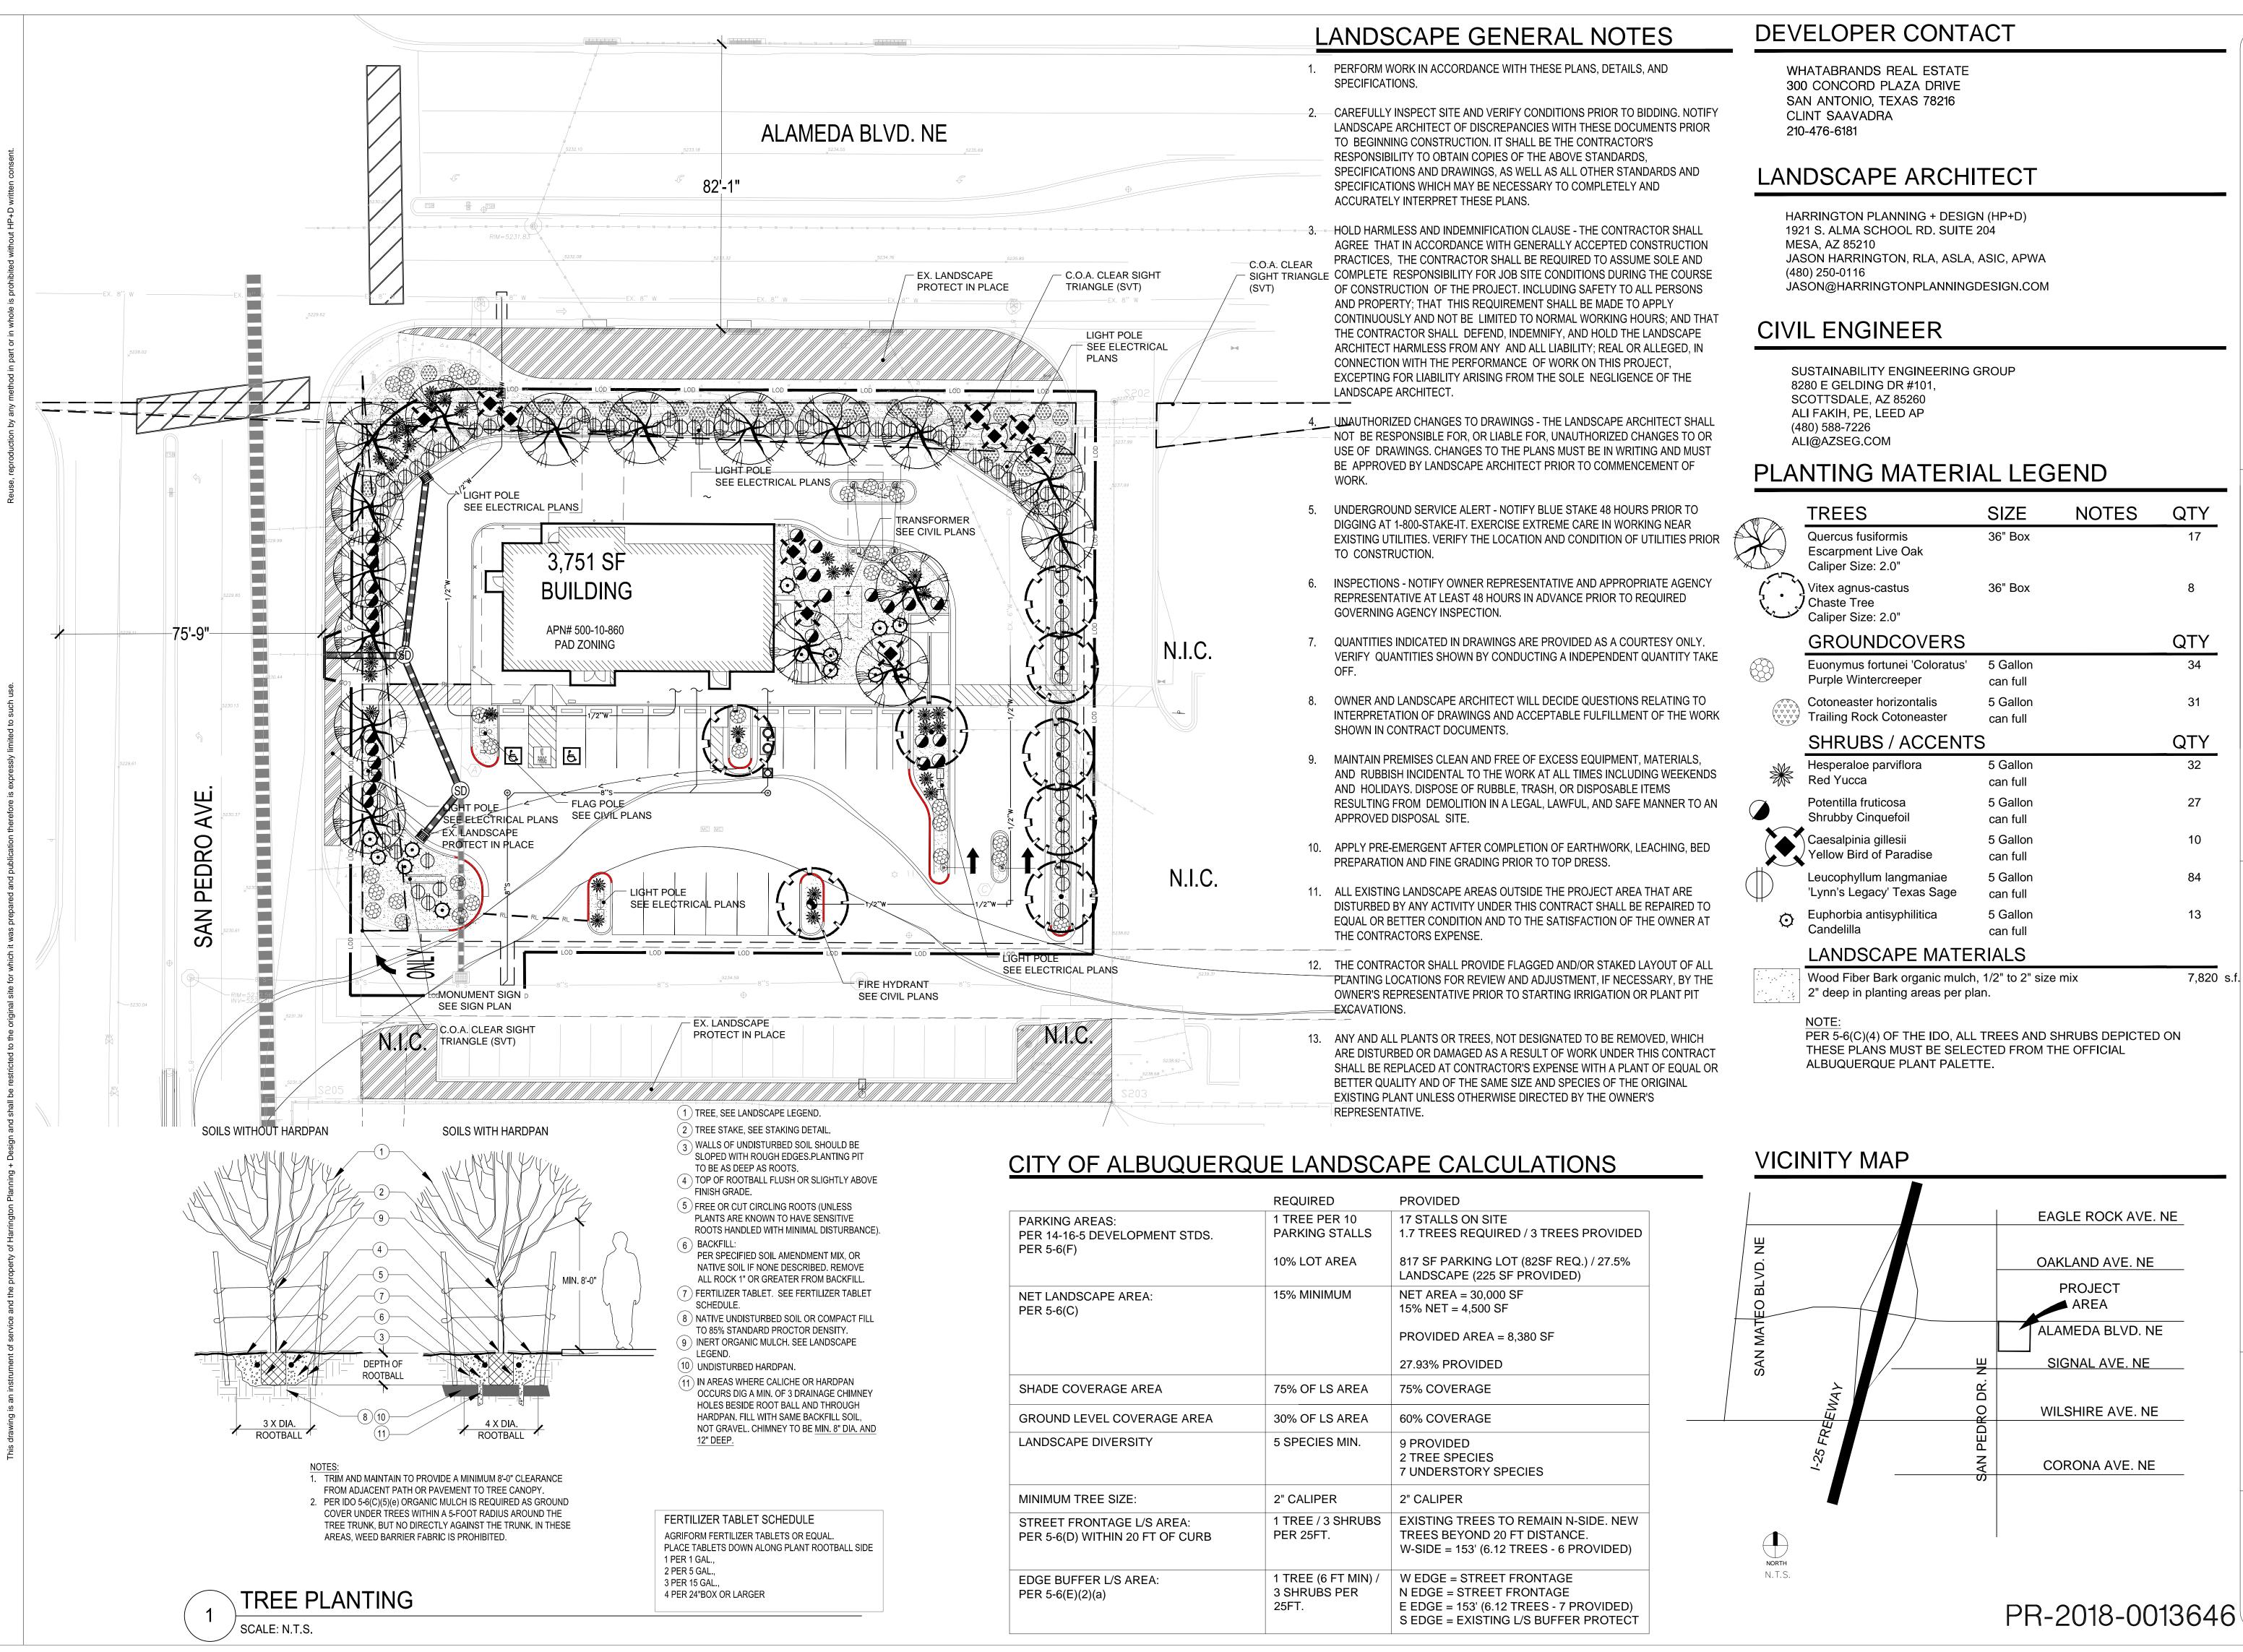

	TREES	SIZE	NOTES	QTY
2	Quercus fusiformis Escarpment Live Oak Caliper Size: 2.0"	36" Box		17
	Vitex agnus-castus Chaste Tree Caliper Size: 2.0"	36" Box		8

	Purple Wintercreeper	can full	
	Cotoneaster horizontalis Trailing Rock Cotoneaster	5 Gallon can full	31
	SHRUBS / ACCEN	TS	QTY
*	Hesperaloe parviflora Red Yucca	5 Gallon can full	32
	Potentilla fruticosa Shrubby Cinquefoil	5 Gallon can full	27
	Caesalpinia gillesii Yellow Bird of Paradise	5 Gallon can full	10
,	l eucophyllum langmaniae	5 Gallon	84

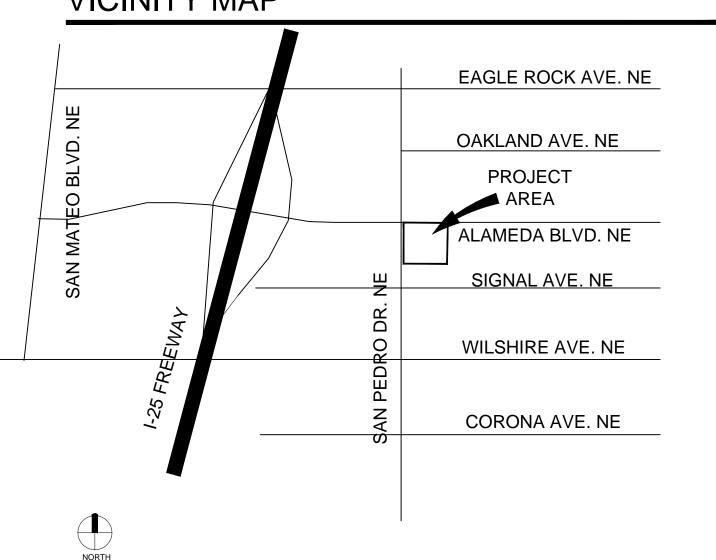

PLANNING + DESIGN

1921 S Alma School Rd, Suite 204

Tel: 480-250-0116

Mesa, Arizona 85210

www.HarringtonPlanningDesign.com



AGE! ABUR

REV. COMMENT Permit CD Submittal 04.27.22 Preliminary Re-Submittal 01.21.22 Preliminary Submittal 10.08.21

PR-2018-001346 LANDSCAPE PACKAGE

APRIL 27, 2022 DRAWN BY: TKW CHECK BY: JEH PROJ. NO.: 2021-056

CASE NO.: TBD

NORTH 0 10 20 LANDSCAPE

PLAN

2 of 6

MANUFACTURER: SHERWIN

COLOR: SW 7048 URBAN

WILLIAMS

**BRONZE** 

MP-01 MP-02 MP-03 **BRICK VENEER** 

METAL PANELS

BERRIDGE STYLE: BR-12 PANEL

COLOR: LEAD-COTE

0.040 ALUMINUM

MANUFACTURER:

SHERWIN WILLIAMS

COLOR: SW 6277 SPECIAL

STOREFRONT SYSTEM


FINISH: CLEAR ANODIZED

OLDCASTLE STYLE: FG-3000


ACME, PARK AVENUE

HERITAGE TEXTURE

BLEND: DTP114

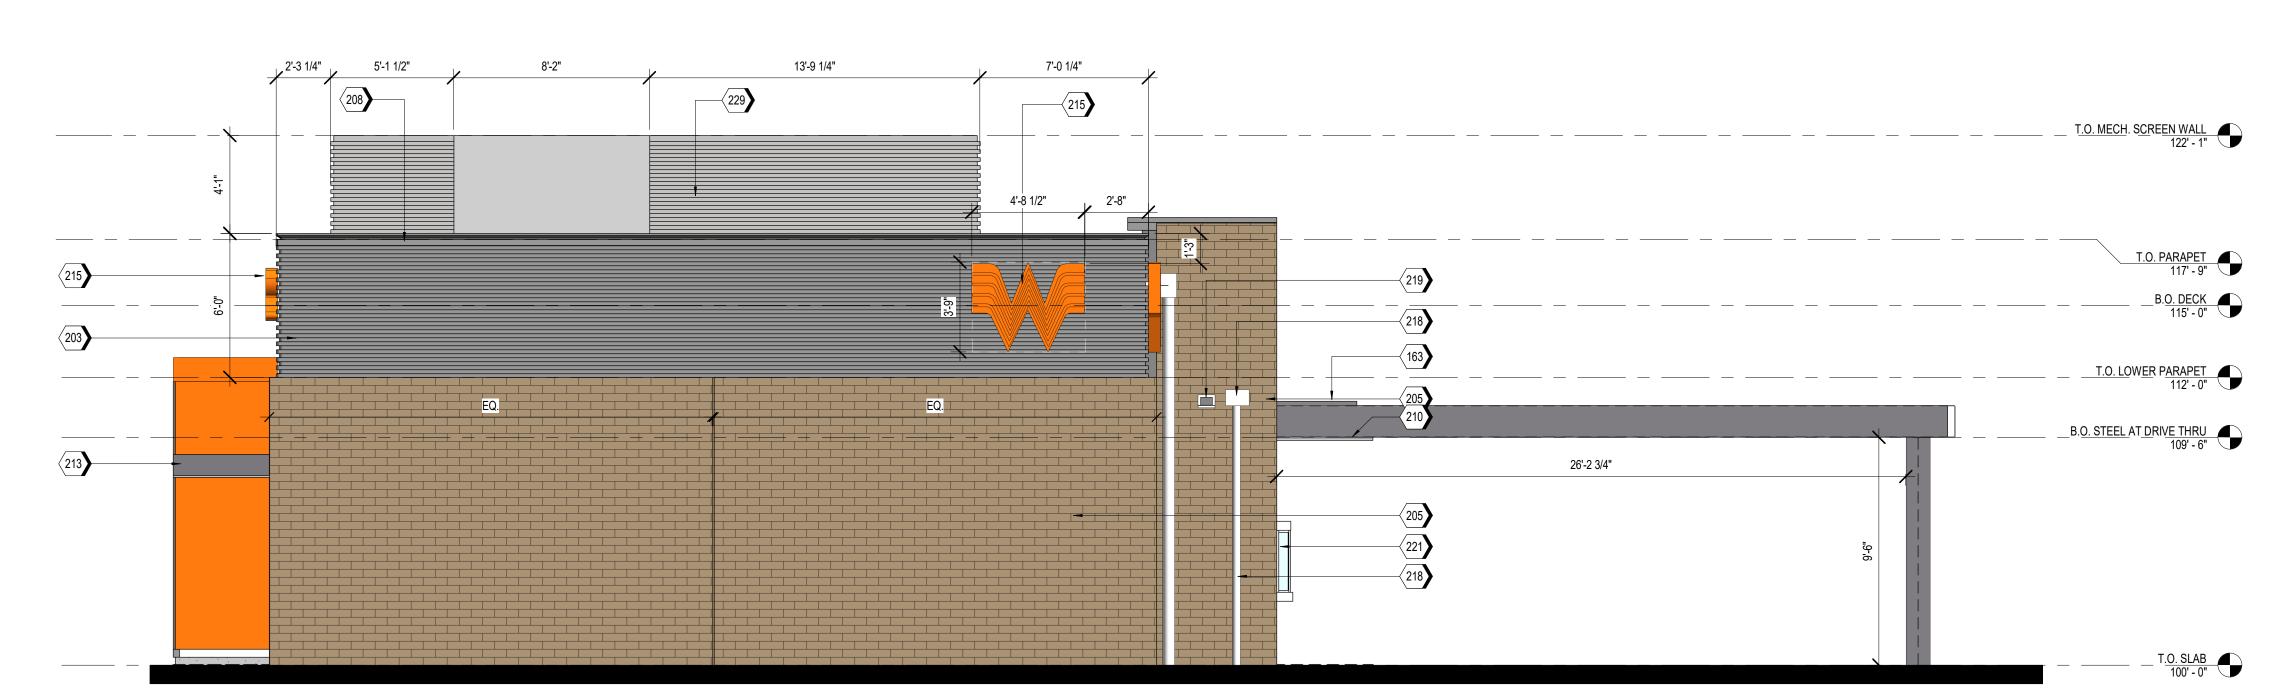

EAST ELEVATION - COLORED SCALE 1/4" = 1'-0" SIGN: 17 SF FACADE: 867 SF RATIO: 2%

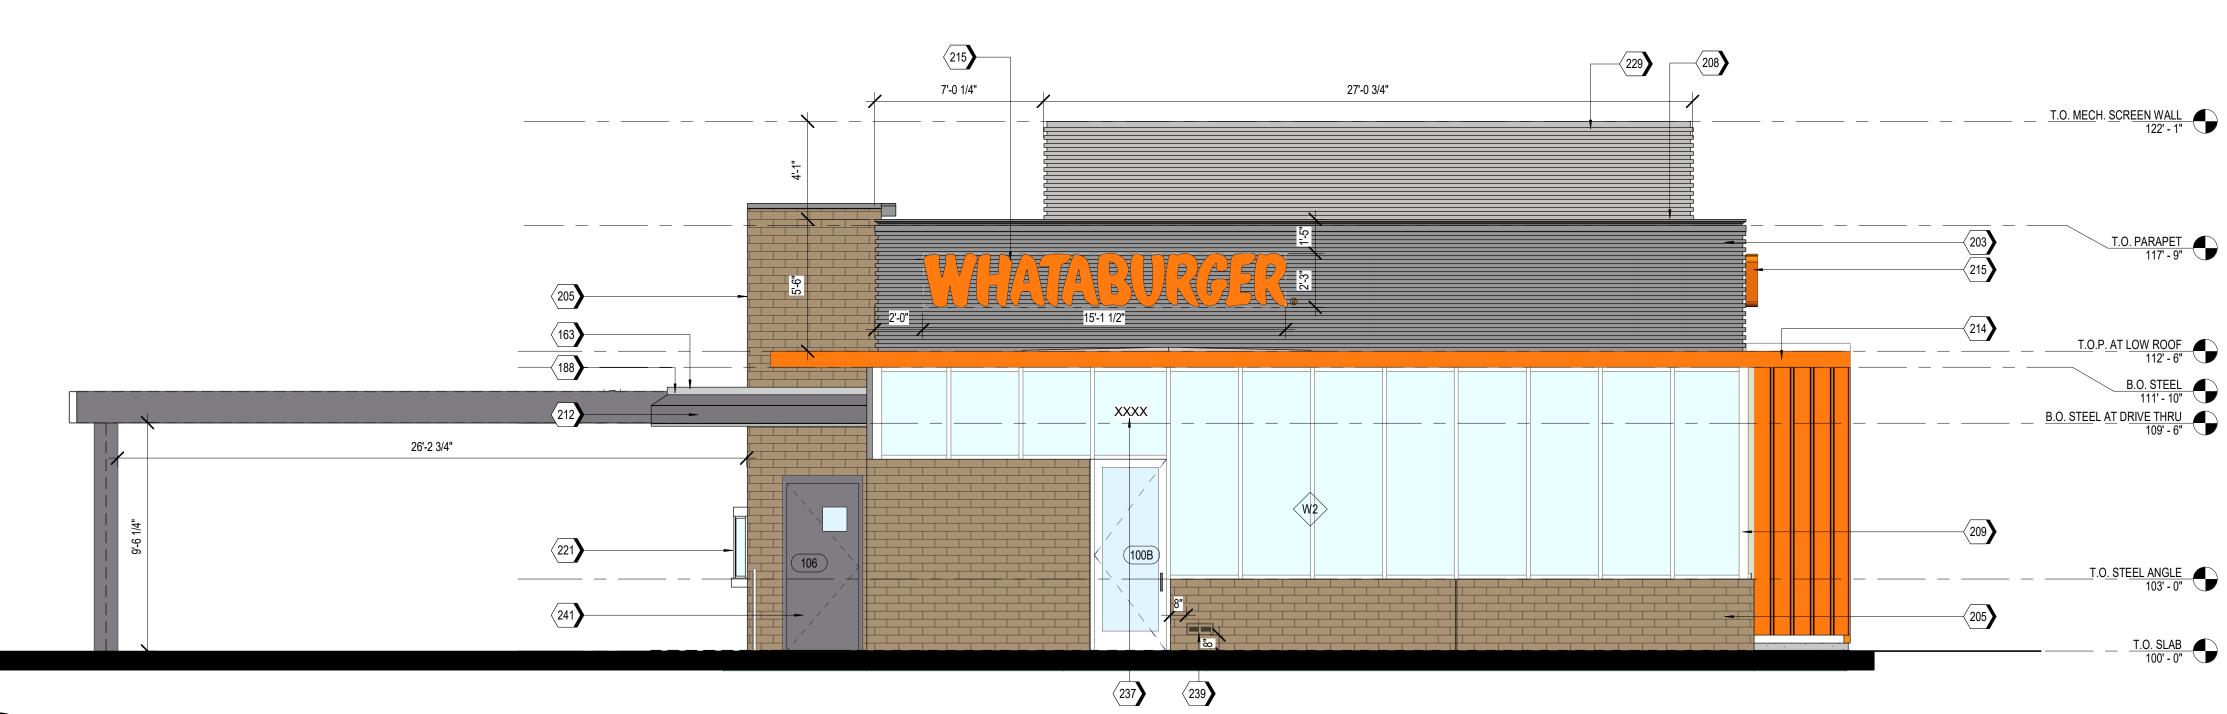

## **KEYNOTES**

163	TPO MEMBRANE ROOFING SYSTEM; RE: A1/A5.3.
188	PRE-FINISHED METAL TRIM
203	MP-01; PRE-FINISHED CORRUGATED METAL PANEL
205	BR-01; BRICK VENEER
208	MC-01; PRE-FINISHED METAL COPING
209	SS-01; ALUMINUM STOREFRONT SYSTEM
210	PRE-FINISHED DRIVE-THRU CANOPY
212	DRIVE-THRU DOOR CANOPY, PAINT PT-5
213	SERVICE DOOR CANOPY, PAINT PT-5
214	SUN SHADE CANOPY, SEE A6.9
215	ILLUMINATED SIGNAGE BY OTHERS, G.C. TO PROVIDE PLYWOOD BLOCKING AS NEEDED TO ATTACH SIGNAGE.
218	PREFINISHED CONDUCTOR HEAD AND DOWNSPOUT, COLOR TO MATCH PAINT PT-5. COORDINATE SIZE WITH REGIONAL RAINFALL DATA. RE:B3/A5.4.
219	OVERFLOW SCUPPER
224	DRIVE TURLI WINDOW

## **EXTERIOR MATERIAL SCHEDULE**

MP-03; ROOF SCREEN WALL, RE: STRUCTURAL

EMERGENCY STEP LIGHT. RE: ELECTRICAL

BUILDING ADDRESS 6"HIGH WHITE VINYL NUMBERS WITH 1" STROKE, 10' A.F.G.

GL-01 VISION GLASS BASIS OF DESIGN: VIRACON VUE1-30 SHADING COEFFICIENT (SC): .20 EXTERIOR REFLECTION: 19% SOLAR HEAT GAIN COEFFICIENT (SHGC): .18 U-FACTOR: .26

241 PAINT (PT-5) EXTERIOR DOORS.

GL-02 NOT USED

239

GL-03 OPAQUE GLASS BASIS OF DESIGN: VIRACON V948

SIMULATED ACID ETCHED VIRACON V1085

STOREFRONT SYSTEM BASIS OF DESIGN: OLDCASTLE STYLE: FG-3000 FINISH: CLEAR ANODIZED

METAL PANEL MANUFACTURER: BERRIDGE STYLE: BR-12 PANEL 0.040 ALUMINUM COLOR: LEAD-COTE

PREFINISHED METAL FLASHING 0.050" THICK COLOR: LEAD-COTE TO MATCH MP-01

MP-03 METAL PANEL MANUFACTURER: BERRIDGE STYLE: BR-12 PANEL 0.040 ALUMINUM COLOR: LEAD-COTE

> BRICK MANUFACTURER: ACME STYLE: UTILITY SIZE: 4" x 4" x 12" COLOR: PARK AVENUE

MORTAR MANUFACTURER: AHI COLOR: VANILLA -N

METAL COPING MANUFACTURER: BERRIDGE STYLE: SHADOWLINE COPING **REVEAL COPING** COLOR: LEADCOTE

PT-5 PAINT BASIS OF DESIGN: MANUFACTURER: SHERWIN WILLIAMS STYLE: SW 6277 SPECIAL GRAY SHEEN: FLAT

MS-01 METAL SOFFIT MANUFACTURER: BERRIDGE STYLE: HS-8 FINISH: PRE-FINISHED TO MATCH PT-5

	S)	SYM.	DATE	ш
120S				
CANIDEDEO				

WHATABURGER F SWC ALAMEDA BLVD & ALAMEDA BLVD. ALBUQUERQUE, NM.



8280 E. GELDING DR #101, SCOTTSDALE, AZ 85280 WW.AZSEG.COM TEL. 480.588.7228

## WHATABURGER

300 CONCORD PLAZA DR. SAN ANTONIO, TEXAS. 210-476-6000 ZIP 78216.

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SHEET TITLE: **EXTERIOR ELEVATIONS** -COLORED ISSUED FOR: DRB PR-2018-001346

UNIT NO.

DATE: 03/18/2022 SCALE: As indicated DRAWN BY: EG

CHECKED BY: BH

SHEET NO:

A2.3



WEST ELEVATION - COLORED SCALE 1/4" = 1'-0" SIGN: 34 SF FACADE: 871 SF

RATIO: 4%

**BRICK VENEER** 

BLEND: DTP114

ACME, PARK AVENUE

HERITAGE TEXTURE

MP-02

MP-03

**RATIO: 2%** 

RATIO: 1%

**METAL PANELS** 

STYLE: BR-12 PANEL

COLOR: LEAD-COTE

0.040 ALUMINUM

MANUFACTURER:

SHERWIN WILLIAMS

COLOR: SW 6277 SPECIAL

BERRIDGE

STOREFRONT SYSTEM

FINISH: CLEAR ANODIZED


OLDCASTLE

STYLE: FG-3000

1. EXTERIOR SIGNAGE TO BE PERMITED UNDER A SEPARATE SIGN PERMIT SET.

170 GUARDRAIL RE:D6/A6.8 MP-01; PRE-FINISHED CORRUGATED METAL PANEL 205 BR-01; BRICK VENEER 208 MC-01; PRE-FINISHED METAL COPING 209 SS-01; ALUMINUM STOREFRONT SYSTEM DRIVE-THRU DOOR CANOPY, PAINT PT-5 SERVICE DOOR CANOPY, PAINT PT-5 SUN SHADE CANOPY, SEE A6.9 ILLUMINATED SIGNAGE BY OTHERS, G.C. TO PROVIDE PLYWOOD BLOCKING AS NEEDED TO ATTACH SIGNAGE. PREFINISHED CONDUCTOR HEAD AND DOWNSPOUT, COLOR TO MATCH PAINT PT-5. COORDINATE SIZE WITH REGIONAL RAINFALL DATA. RE:B3/A5.4. OVERFLOW SCUPPER STAINLESS STEEL GREASE SHIELD W/ 2 1/2" HOLE THROUGH WALL FOR GREASE TANK 229 MP-03; ROOF SCREEN WALL, RE: STRUCTURAL MASONRY EXPANSION JOINT 233 EXTERIOR LIGHT FIXTURE, RE: EL
239 EMERGENCY STEP LIGHT. RE: ELE
241 PAINT (PT-5) EXTERIOR DOORS. EXTERIOR LIGHT FIXTURE, RE: ELECTRICAL EMERGENCY STEP LIGHT. RE: ELECTRICAL

**KEYNOTES** 

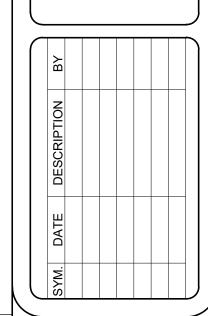

### **EXTERIOR MATERIAL SCHEDULE**

VISION GLASS BASIS OF DESIGN: VIRACON VUE1-30 SHADING COEFFICIENT (SC): .20 EXTERIOR REFLECTION: 19% SOLAR HEAT GAIN COEFFICIENT (SHGC): .18

BASIS OF DESIGN: VIRACON V948

STOREFRONT SYSTEM BASIS OF DESIGN: OLDCASTLE STYLE: FG-3000

METAL PANEL STYLE: BR-12 PANEL

PREFINISHED METAL FLASHING 0.050" THICK

METAL PANEL STYLE: BR-12 PANEL

MORTAR MANUFACTURER: AHI COLOR: VANILLA -N

METAL COPING MANUFACTURER: BERRIDGE STYLE: SHADOWLINE COPING REVEAL COPING

PAINT BASIS OF DESIGN: MANUFACTURER: SHERWIN WILLIAMS STYLE: SW 6277 SPECIAL GRAY

METAL SOFFIT MANUFACTURER: BERRIDGE STYLE: HS-8 FINISH: PRE-FINISHED TO MATCH PT-5

U-FACTOR: .26

GL-02 NOT USED

GL-03 OPAQUE GLASS

SIMULATED ACID ETCHED VIRACON V1085

FINISH: CLEAR ANODIZED

MANUFACTURER: BERRIDGE 0.040 ALUMINUM COLOR: LEAD-COTE

COLOR: LEAD-COTE TO MATCH MP-01

MP-03 MANUFACTURER: BERRIDGE 0.040 ALUMINUM COLOR: LEAD-COTE

BRICK MANUFACTURER: ACME STYLE: UTILITY SIZE: 4" x 4" x 12" COLOR: PARK AVENUE

COLOR: LEADCOTE

SHEEN: FLAT

WHATABURGER PT20S
SWC ALAMEDA BLVD & SAN PED
ALAMEDA BLVD.
ALBUQUERQUE, NM.



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UNIT NO.


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A2.4






MANUFACTURER: SHERWIN

COLOR: SW 7048 URBAN

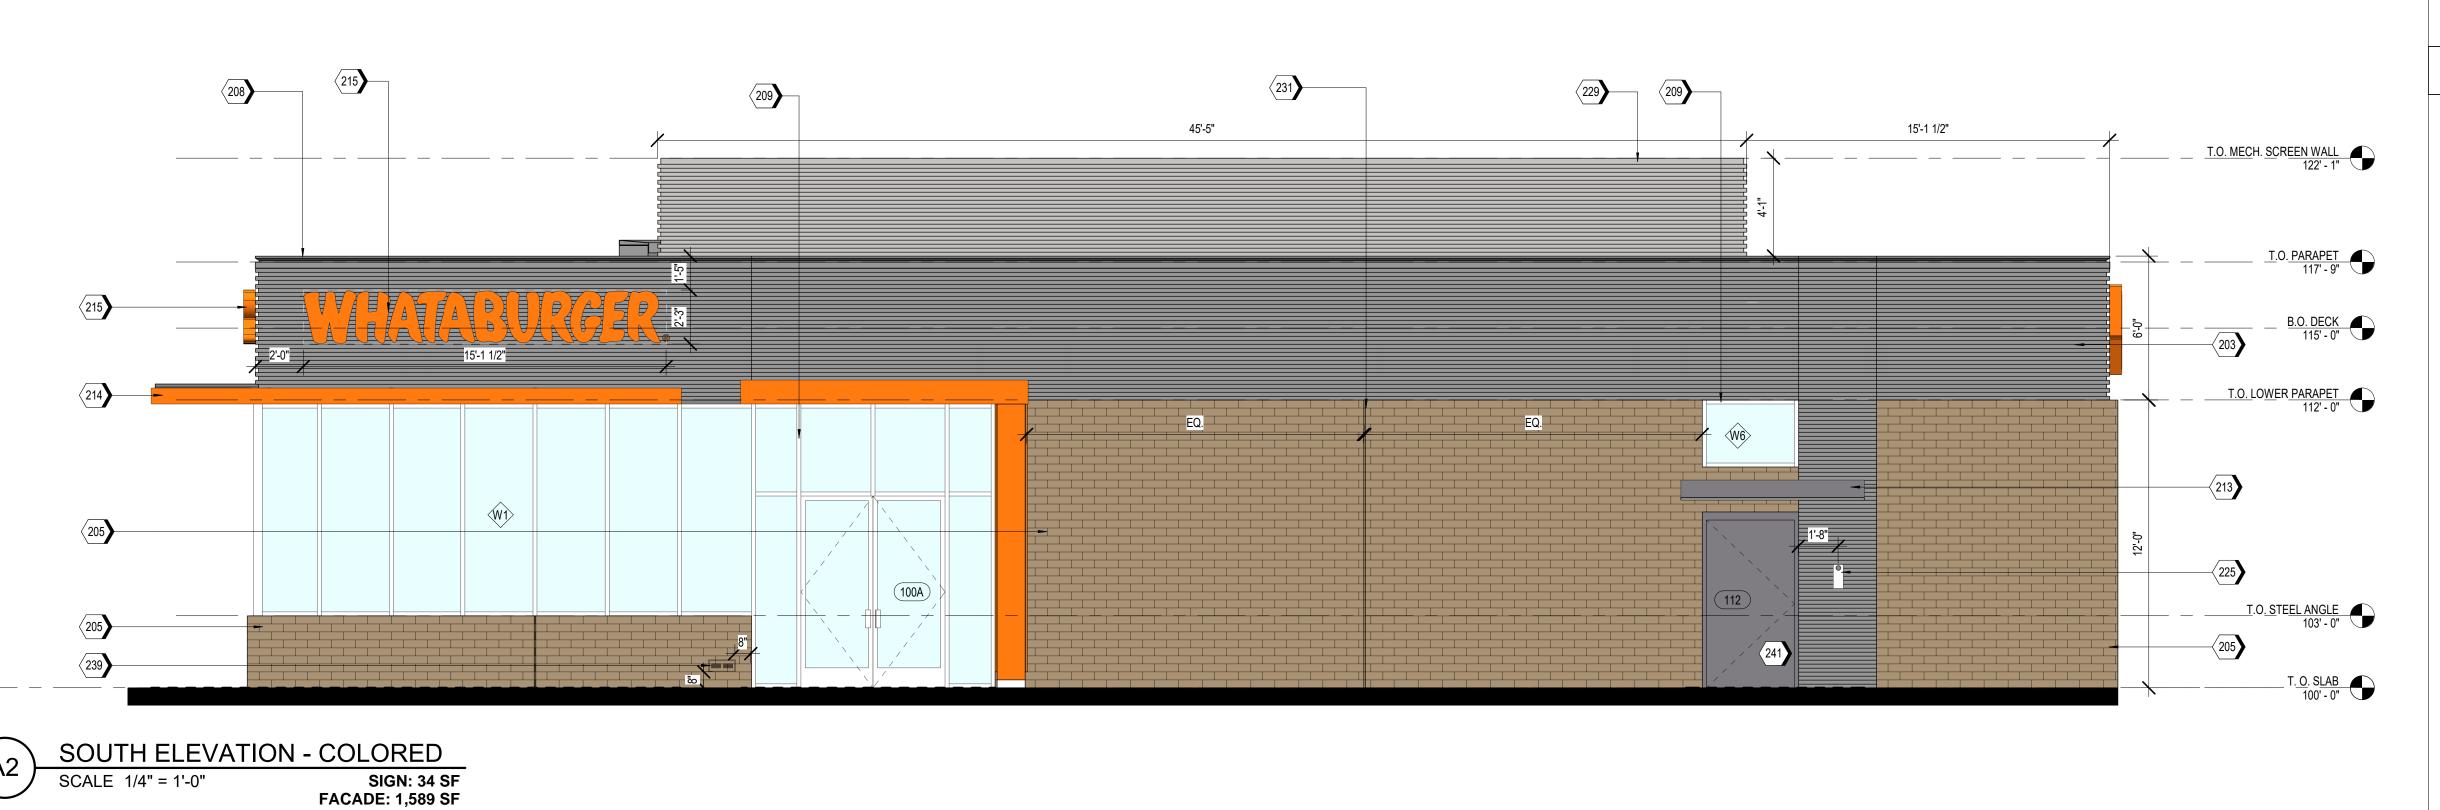WILLIAMS

BRONZE

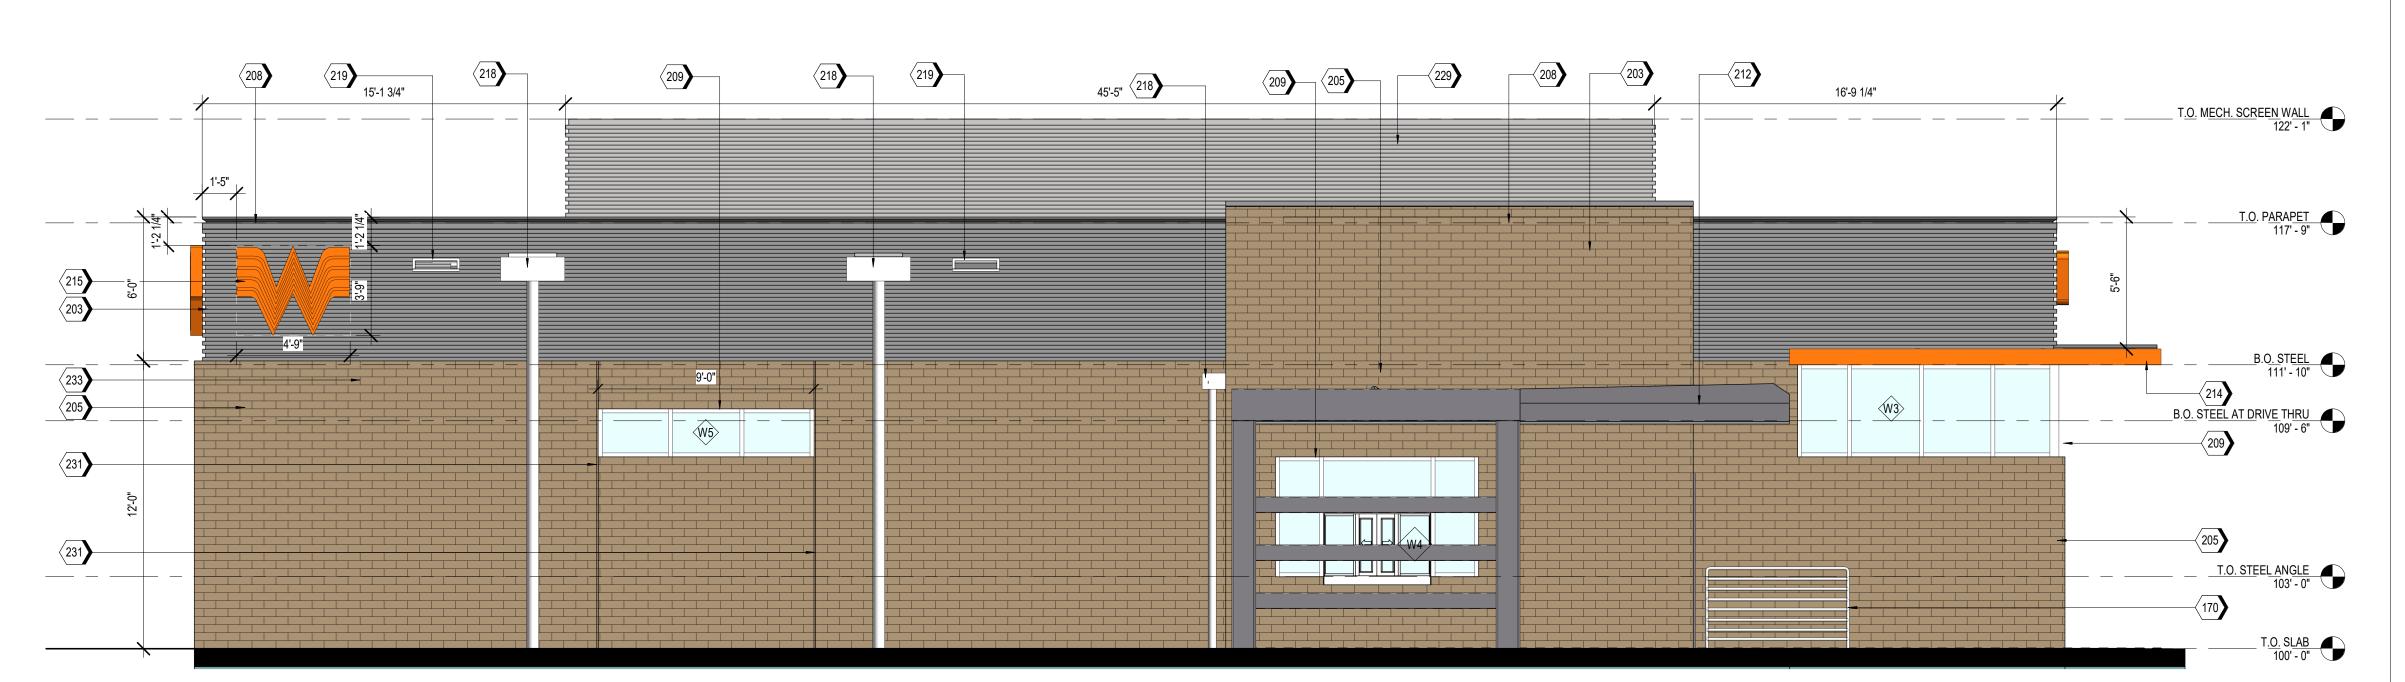

NORTH ELEVATION - COLORED

SCALE 1/4" = 1'-0" SIGN: 17 SF FACADE: 1,592 SF

# PR-2018-001346\_SI-2022-00184\_Site\_Plan\_Am endment\_Approved\_5-4-22\_Sheet\_1

Interim Agreement Report

2022-08-22

Created: 2022-08-04

By: Jay Rodenbeck (jrodenbeck@cabq.gov)

Status: Out for Signature

Transaction ID: CBJCHBCAABAAZkITOu76TZ0qa4TymJCZCzSDuMJqK3M8

#### Agreement History

Agreement history is the list of the events that have impacted the status of the agreement prior to the final signature. A final audit report will be generated when the agreement is complete.

## "PR-2018-001346\_SI-2022-00184\_Site\_Plan\_Amendment\_Approved\_5-4-22\_Sheet\_1" History

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2022-08-09 - 7:06:12 PM GMT- IP address: 142.202.67.2

Signer bcarter@abcwua.org entered name at signing as Blaine Carter

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