**DEVELOPER** 

WHATABRANDS REAL ESTATE CONTACT: CINDY ESPINOZA 300 CONCORD PLAZA DRIVE SAN ANTONIO, TX 78216 PHONE: 210-476-6180 EMAIL: CESPINOZA@WBHQ.COM

**GUTTER ELEVATION** 

PAVEMENT ELEVATION

CONCRETE ELEVATION

TC = G+0.5'

G=XX.XX-

P=XX.XX-


C=XX.XX-


**CIVIL ENGINEER** SUSTAINABILITY ENGINEERING GROUP 8280 E. GELDING DR, SUITE 101 SCOTTSDALE, ARIZONA 85260 PHONE: 480-237-2507 ATTN. ALI FAKIH

**OWNER** GREEN JEANS WEST, LLC 2929 MONTE VISTA NE ALBUQUERQUE, NM 87106

# WHATABURGER **GRADING AND DRAINAGE PLAN**

6100 ALAMEDA BLVD NE, ALBUQUERQUE, NM A PORTION OF SECTION 13, TOWNSHIP 11 NORTH, RANGE 3 EAST BERNALILLO COUNTY, NEW MEXICO.

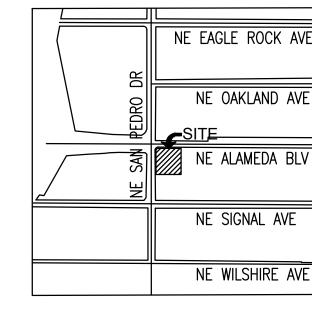

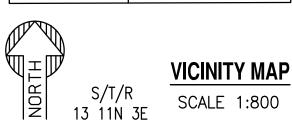

#### GRADING CONSTRUCTION KEY NOTES

- MATCH EXISTING GRADE; CONTRACTOR TO VERIFY IN FIELD ALL GRADES PRIOR TO CONSTRUCTION ACTIVITIES AND CONTACT ENGINEER IN CASE OF ANY DISCREPANCIES.
- (2) CONSTRUCT 6" HEADER CURB PER COA STD. DET. 2415C
- (2A) CONSTRUCT 6" VERTICAL CURB AND GUTTER PER COA STD DWG 2415-A.
- (3) CONSTRUCT ADA RAMP. PER SITE PLANS.
- (3B) CONSTRUCT DELIVERY RAMP PER DET. 2/C3.10.
- 4 FURNISH AND INSTALL NYLOPLAST DRAIN BASIN WITH 30" RISER AND 2'X3' STEEL GRATE PER
- 5 FURNISH AND INSTALL HDPE DOUBLE WALL PIPE, CLASS 100; LENGTH, SIZE AND SLOPE PER
- 5A FURNISH AND INSTALL REINFORCED CLASS III CONCRETE PIPE, LENGTH, SIZE AND SLOPE PER
- 6 FURNISH AND INSTALL 30" NYLOPLAST DRAIN BASIN WITH SOLID LID. PER DET. 13/C3.12.
- 7 CONSTRUCT HEAVY DUTY PAVEMENT PER DETAIL 5/C3.10.
- (8) FURNISH AND INSTALL 4' MANHOLE PER COA DETAIL 2208.
- 9 CONSTRUCT CONCRETE SIDEWALK PER COA STD DWG 2430. WIDTH PER PLAN.
- CONSTRUCT PAVEMENT WITH 2% MAXIMUM SLOPE IN ANY DIRECTION AT ACCESSIBLE PARKING STALLS AND 2% MAXIMUM CROSS SLOPE AT ADA ACCESSIBLE ROUTE.
- (11) CONSTRUCT CONCRETE PAVEMENT PER DETAIL 6/C3.10.
- (12) CAUTION! PROTECT EXISTING GAS AND POWER UTILITIES.
- \$\langle 13 \rangle PAVING TRANSITION PER DET. 7/C3.10.
- (14) TRANSITION TO EXISTING PAVEMENT PER DET. 1/C3.10.
- (15) SAWCUT, REMOVE AND REPLACE EXISTING PAVEMENT.
- (16) CONSTRUCT 3' CURB OPENING. PER DET. 3/C3.10.
- (17) TURN DOWN SIDEWALK. PER DET. 9/C3.10.
- (18) TURN DOWN SIDEWALK. PER DET. 16/C3.11.
- (19) 5' CURB TRANSITION FROM 6" TO 0" REVEAL.

## EXISTING CONDITIONS AND PROPOSED DEVELOPMENT:

THE EXISTING SITE IS PARTIALLY DEVELOPED. THE SOUTHERN PORTION OF THE PROPERTY INCLUDES A PARKING LOT WITH LANDSCAPE ISLANDS WHILE THE NORTH AREA REMAINS UNDEVELOPED WITH AN EXISTING DRAINAGE POND, DIRT PILES AND STORAGE CONTAINER. DRAINAGE STRUCTURES, SEWER AND WATER LINES, AND DRY UTILITIES SUCH AS POWER, GAS AND ELECTRICITY EXIST WITHIN THE SITE. LOT ELEVATION DROP FROM 1,238' AT THE EAST PROPERTY LINE TO ABOUT 1,232' AT THE WEST PROPERTY LINE.

THE PROJECT WILL CONSIST IN THE DEMOLITION OF MOST OF THE EXISTING SOUTH PARKING LOT AND THE CONSTRUCTION OF A FAST FOOD RESTAURANT (2,999 SF) WITH A DRIVE-THRU, PARKING AREA, AND DESIGNATED

### PRIVATE DRAINAGE FACILITIES WITHIN CITY RIGHT-OF-WAY NOTICE TO CONTRACTOR

#### (SPECIAL ORDER 19 $\sim$ "SO-19")

- 1. BUILD SIDEWALK CULVERT PER COA STD DWG 2236. WORK IS PERMITTED AND INSPECTED BY DMD CONSTRUCTION SERVICES DIVISION.
- AN EXCAVATION PERMIT WILL BE REQUIRED BEFORE BEGINNING ANY WORK WITHIN CITY RIGHT-OF-WAY. ALL WORK ON THIS PROJECT SHALL BE PERFORMED IN ACCORDANCE WITH APPLICABLE FEDERAL, STATE AND LOCAL
- LAWS, RULES AND REGULATIONS CONCERNING CONSTRUCTION SAFETY AND HEALTH.
- 4. PRIOR TO ANY EXCAVATION, THE CONTRACTOR MUST CONTACT NEW MEXICO ONE CALL, DIAL "811" [OR (505) 260-1990 FOR THE LOCATION OF EXISTING UTILITIES.
- PRIOR TO CONSTRUCTION, THE CONTRACTOR SHALL EXCAVATE AND VERIFY THE LOCATIONS OF ALL OBSTRUCTIONS. SHOULD A CONFLICT EXIST, THE CONTRACTOR SHALL NOTIFY THE ENGINEER SO THAT THE CONFLICT CAN BE RESOLVED WITH A MINIMUM AMOUNT OF DELAY.
- BACKFILL COMPACTION SHALL BE 95%. MAINTENANCE OF THE FACILITY SHALL BE THE RESPONSIBILITY OF THE OWNER OF THE PROPERTY BEING SERVED.
- WORK ON ARTERIAL STREETS MAY BE REQUIRED ON A 24-HOUR BASIS.
- 9. FOR EXCAVATION AND BARRICADING INSPECTIONS, CONTACT DMD CONSTRUCTION SERVICES DIVISION.



SUSTAINABILITY ENGINEERING GROUP










CALL NM ONE-CALL SYSTEM SEVEN (7) DAYS PRIOR TO ANY EXCAVATION

PROJECT WHATABURGUER NM SEC ALAMEDA BLVD NE & SAN PEDRO AVE NE	OCATION	6100 ALAMEDA BLVD NE ALBUQUERQUE, NM
DRAWN	GA	01/27/202
DESIGNED	LP	01/27/202
QC ———	AF	03/23/202
FINAL QC	SO	03/25/202
PROJ. MGR. ———	AF	04/18/202
DATE: 04/18	/2022	1
ISSUED FOR:		
DRB		
DEVICION NO		DATE

REVISION NO.: DATE: 210907

> **GRADING AND** DRAINAGE PLAN

C3.00

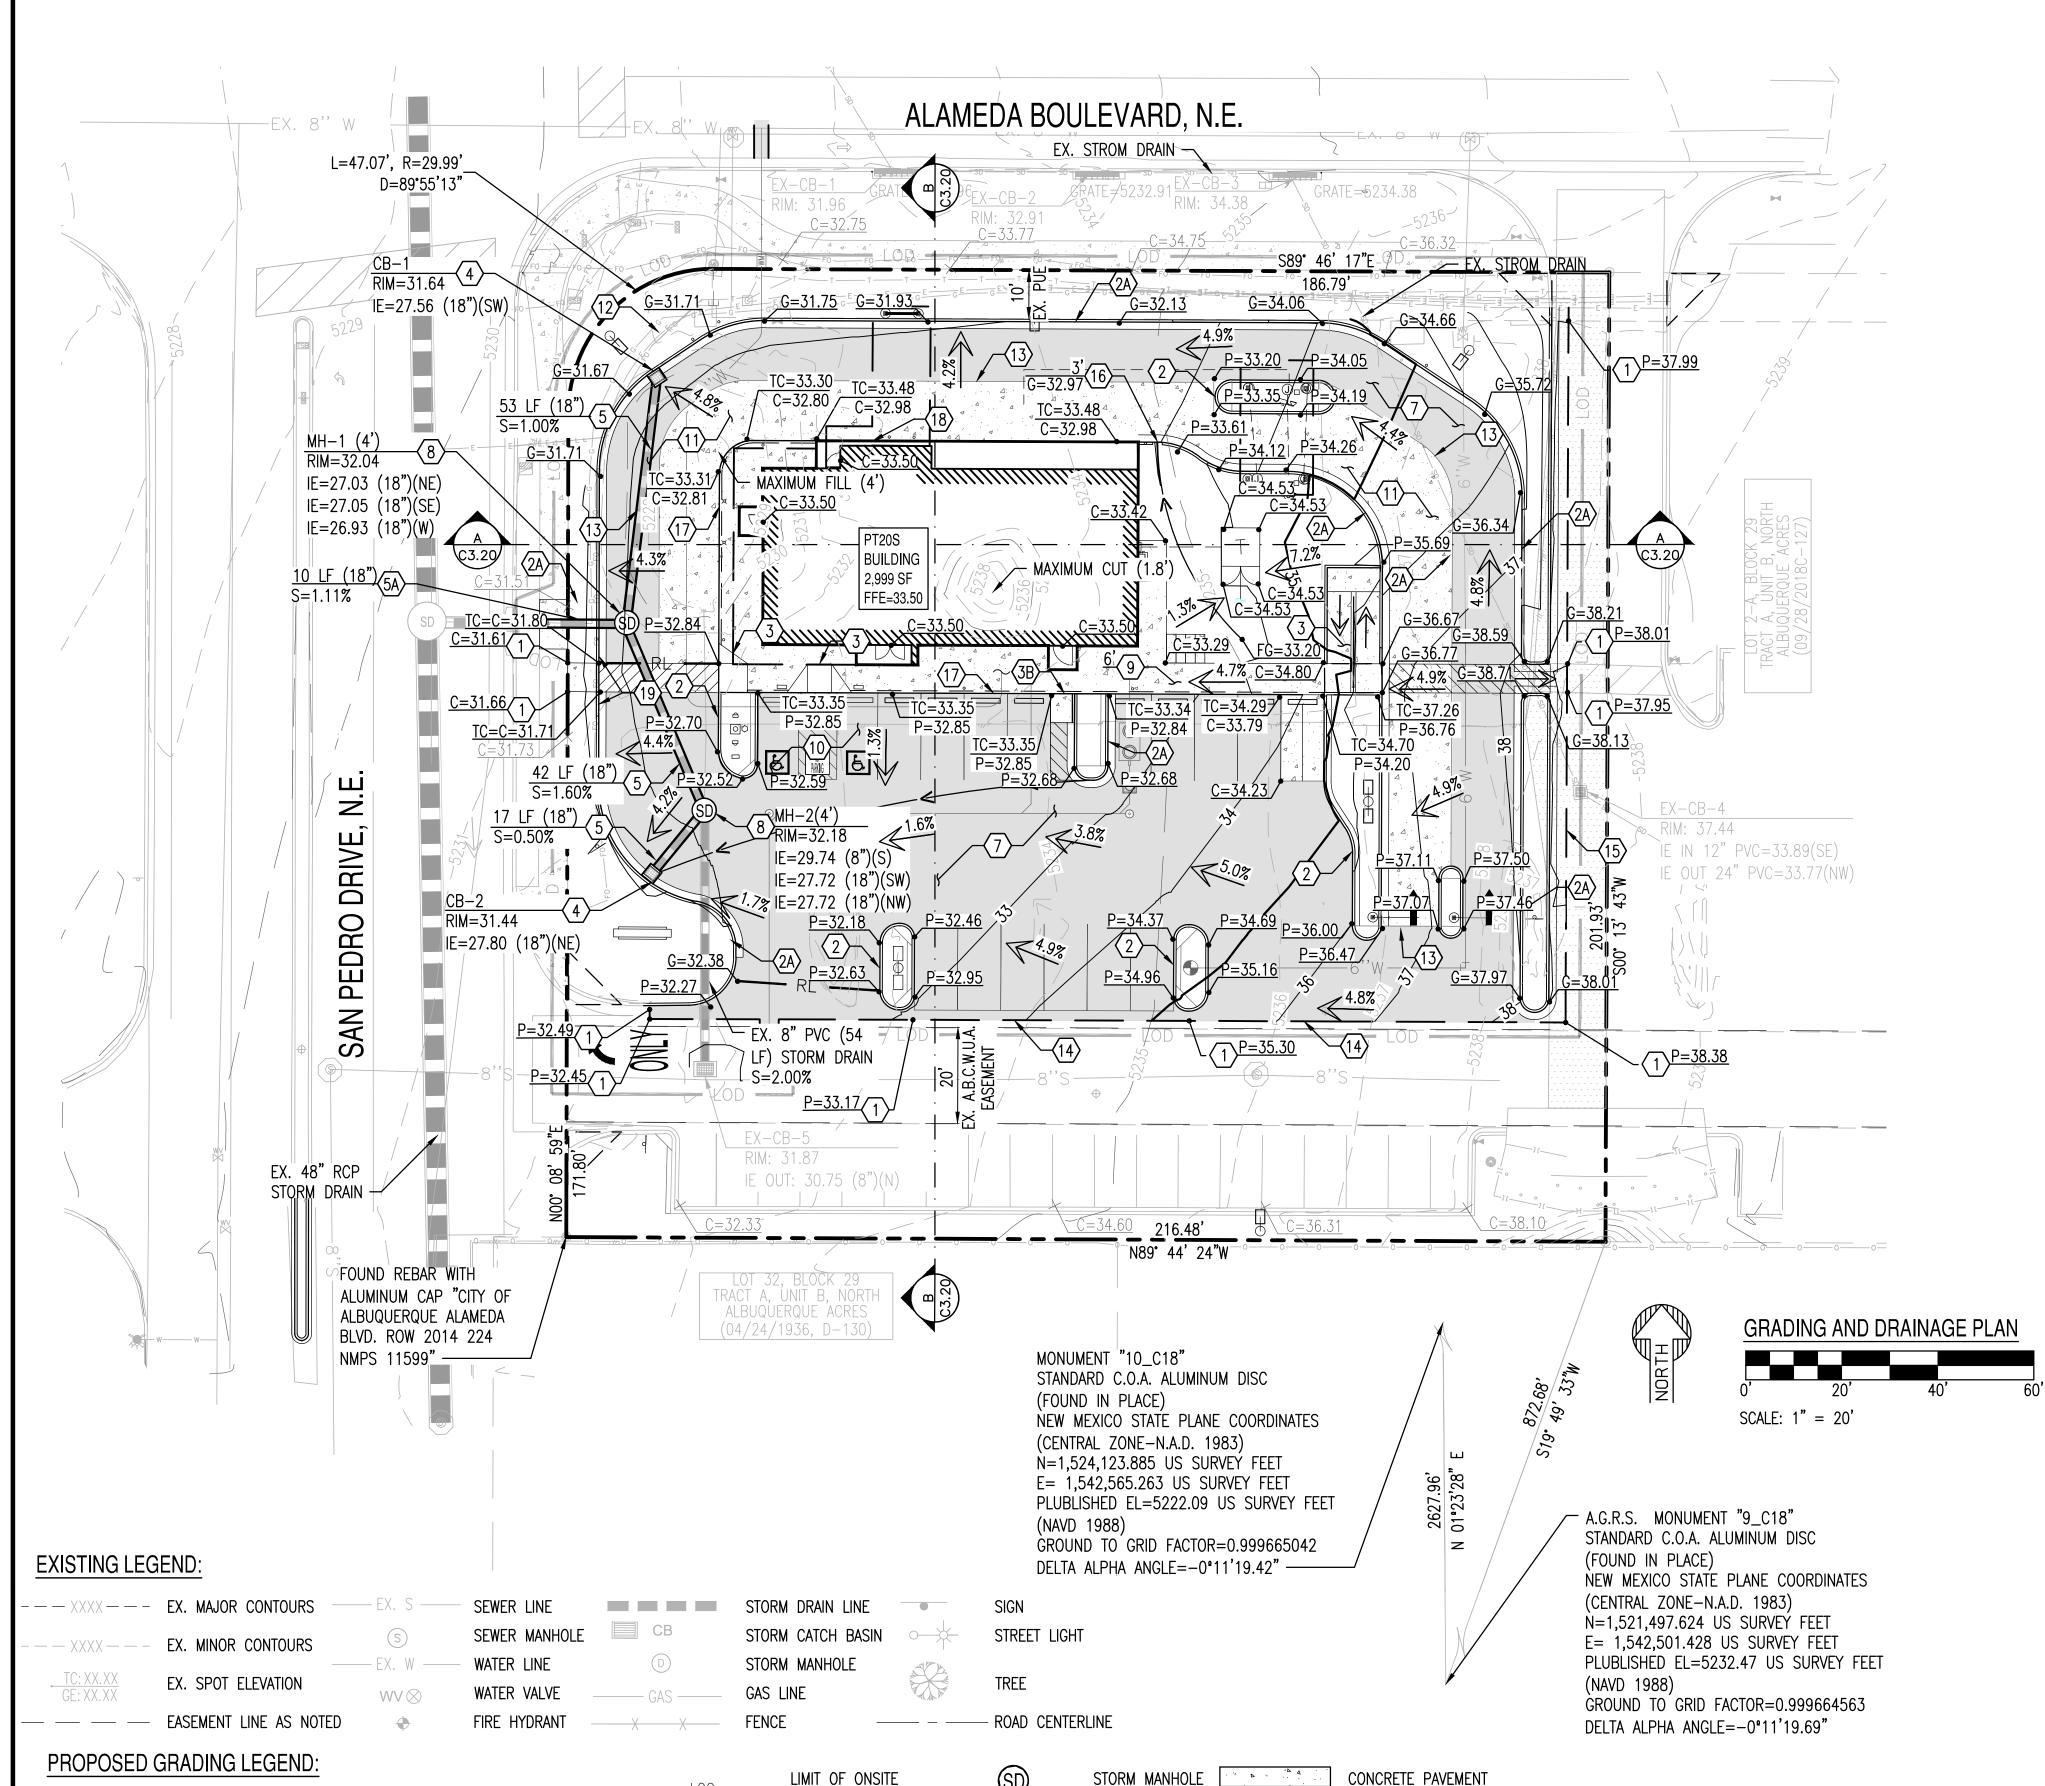

HEAVY DUTY PAVEMENT

STORM INLET

INVERT ELEVATIONS TO BE VERIFIED IN FIELD.

WATER METER

GATE VALVE

FIRE HYDRANT

CONSTRUCTION

FLOW ARROW

CATCH BASIN

STORM PIPE

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EMAIL: CESPINOZA@WBHQ.COM

CONCRETE ELEVATION

C=XX.XX-


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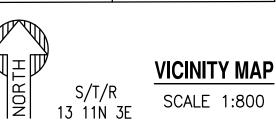
**OWNER** GREEN JEANS WEST, LLC 2929 MONTE VISTA NE ALBUQUERQUE, NM 87106

# WHATABURGER

# OFF-SITE GRADING AND DRAINAGE PLAN

6100 ALAMEDA BLVD NE, ALBUQUERQUE, NM A PORTION OF SECTION 13, TOWNSHIP 11 NORTH, RANGE 3 EAST BERNALILLO COUNTY, NEW MEXICO.




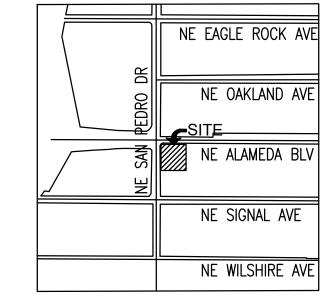

### GRADING CONSTRUCTION KEY NOTES

- MATCH EXISTING GRADE; CONTRACTOR TO VERIFY IN FIELD ALL GRADES PRIOR TO CONSTRUCTION ACTIVITIES AND CONTACT ENGINEER IN CASE OF ANY DISCREPANCIES.
- REMOVE AND REPLACE EXISTING SIDEWALK AS REQUIRED FOR UTILITY CONSTRUCTION. REMOVE TO NEAREST JOINT.
- FURNISH AND INSTALL REINFORCED CLASS III CONCRETE PIPE, LENGTH, SIZE AND SLOPE PER
- (4) CONNECT PIPE TO EXISTING PUBLIC STORM INLET.
- (5) EXISTING PUBLIC 8' DIA MANHOLE
- (6) CONSTRUCT MOUNTABLE MEDIAN CURB PER COA STD. DWG 2415A.

INVERT ELEVATIONS TO BE VERIFIED IN FIELD.

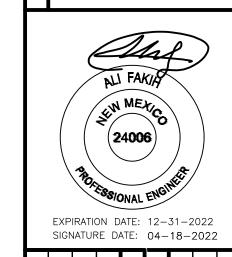

SUSTAINABILITY | ENGINEERING | GROUP

DESIGNED BY: SO CALL NM ONE-CALL DRAWN BY: ER SYSTEM SEVEN (7) DAYS CHECKED BY: SC

PRIOR TO ANY EXCAVATION 04/2022




CITY OF ALBUQUERQUE DEPARTMENT OF MUNICIPAL DEVELOPMENT ENGINEERING DIVISION

OFF-SITE GRADING & DRAINAGE

PLAN

**Z-99** CITY PROJECT NO. 000000 SHEET NO. C3.01

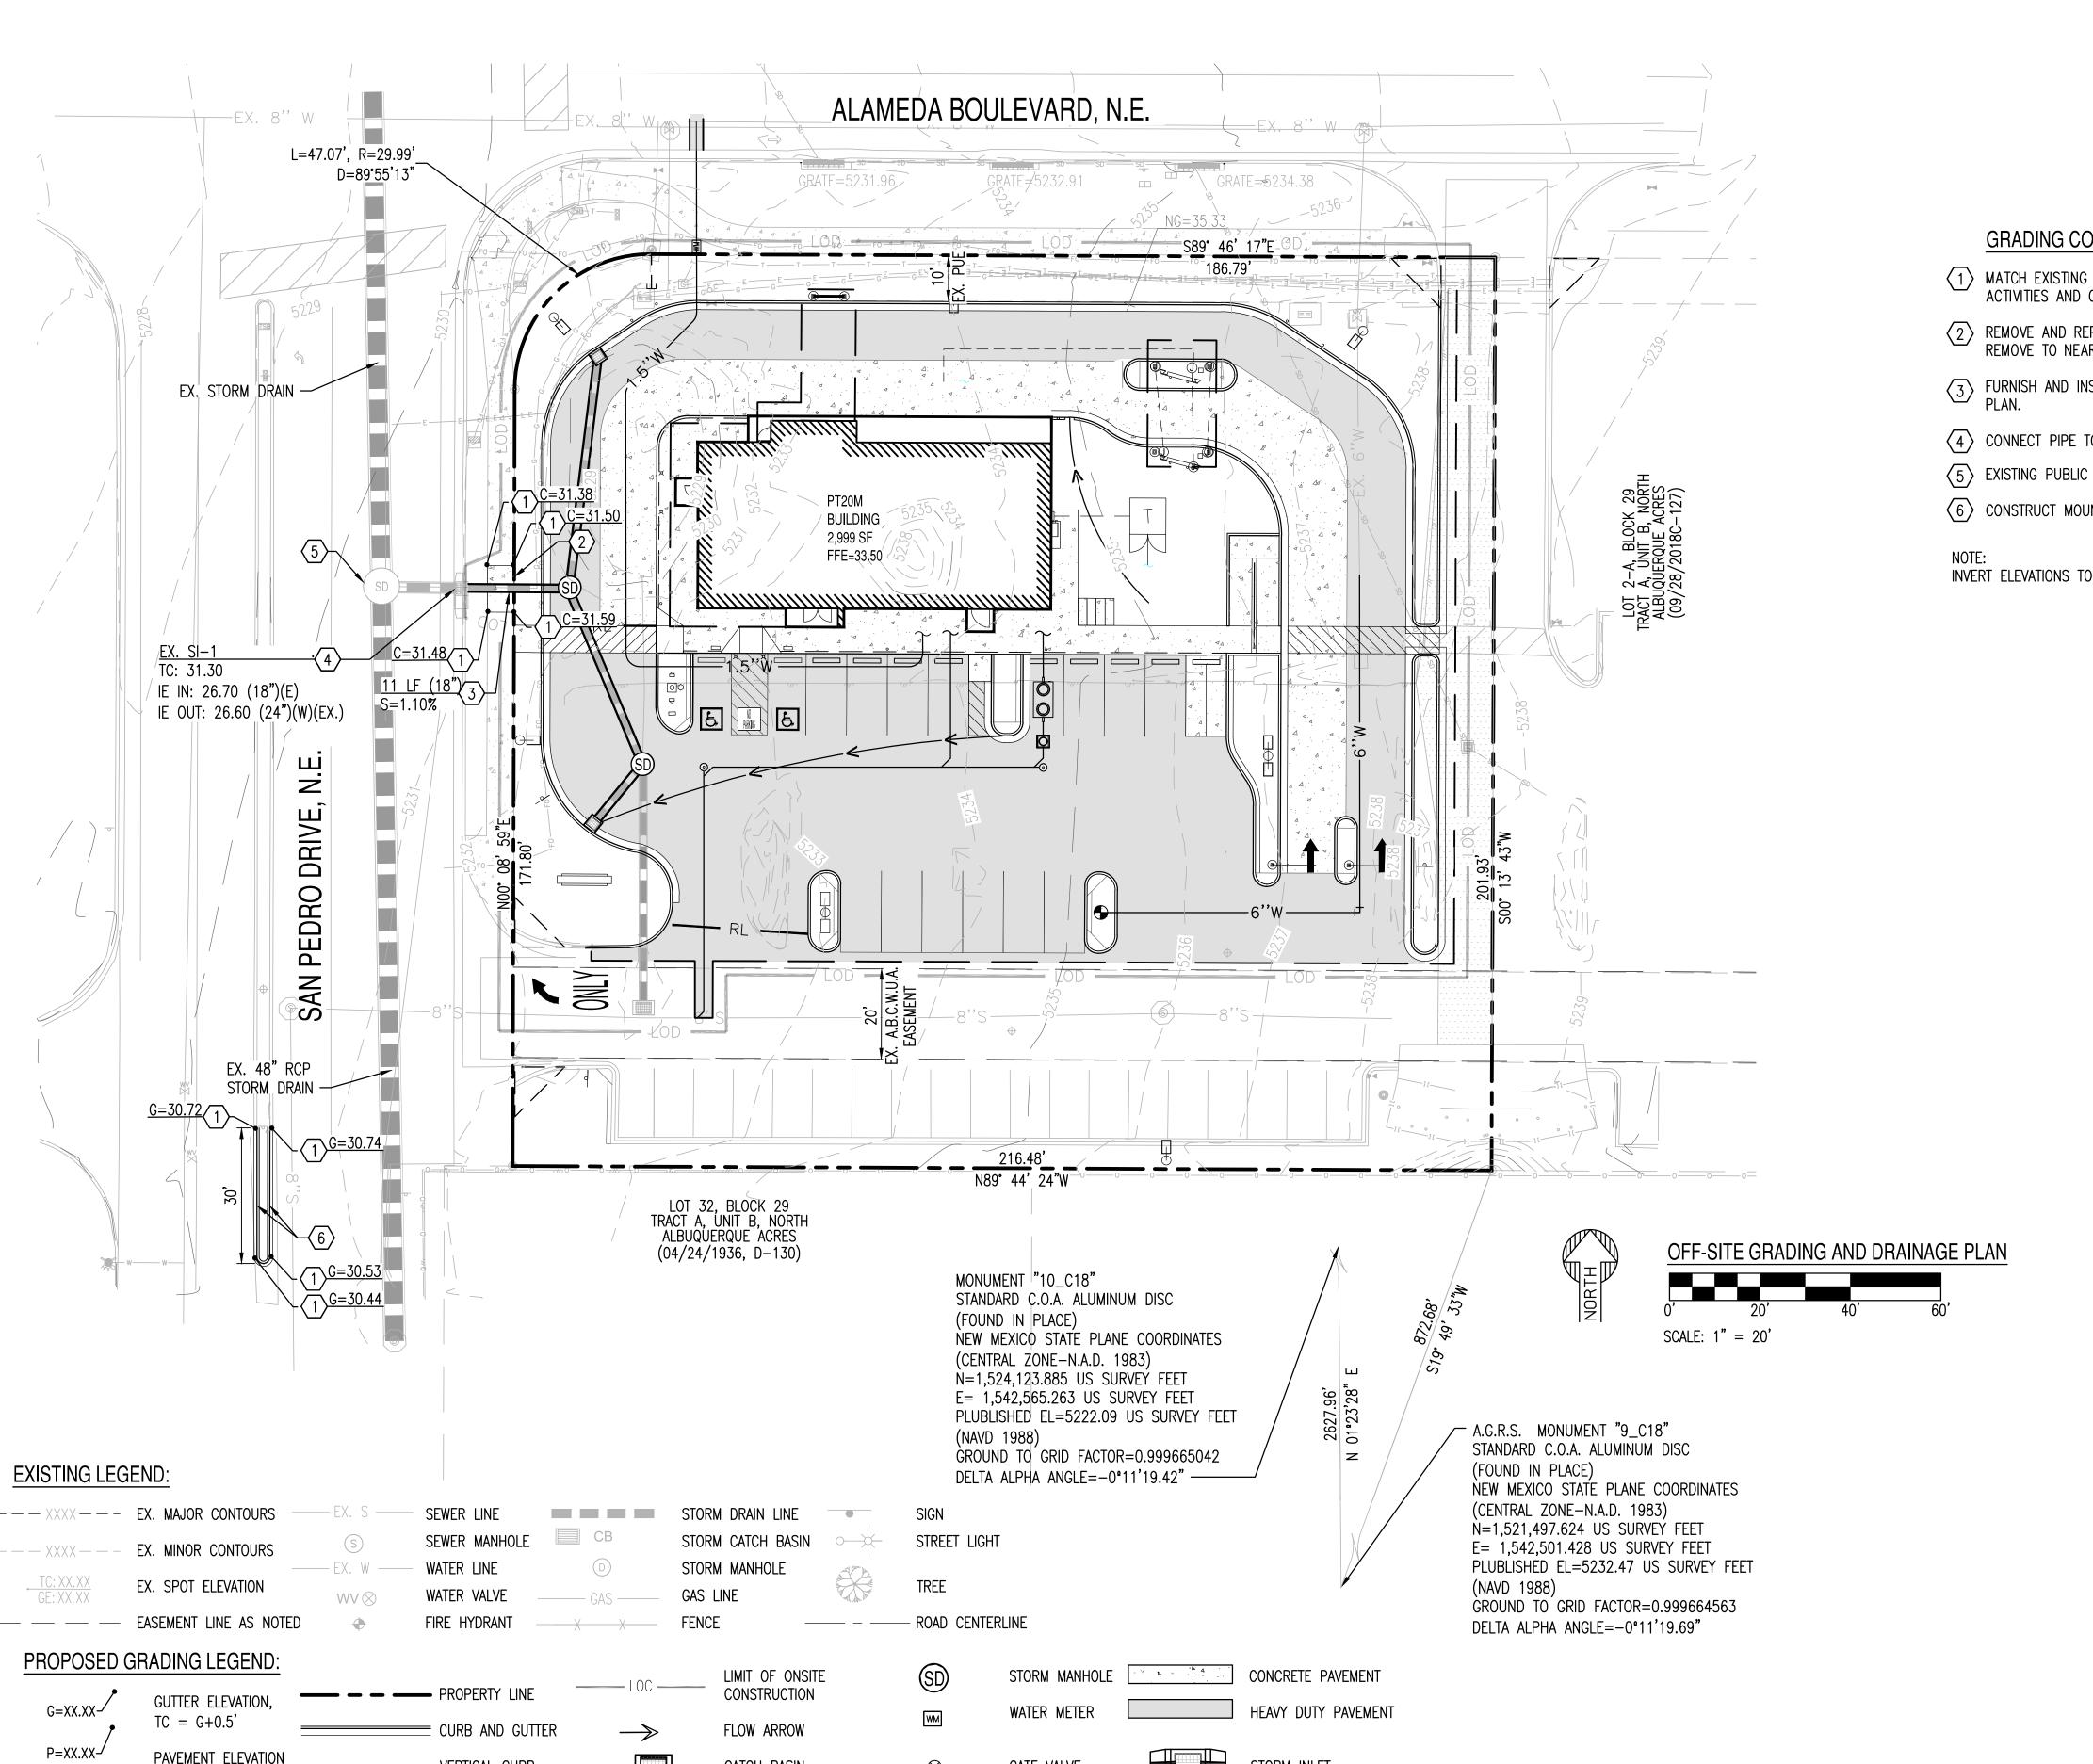


GATE VALVE


FIRE HYDRANT


CATCH BASIN


STORM PIPE

STORM INLET

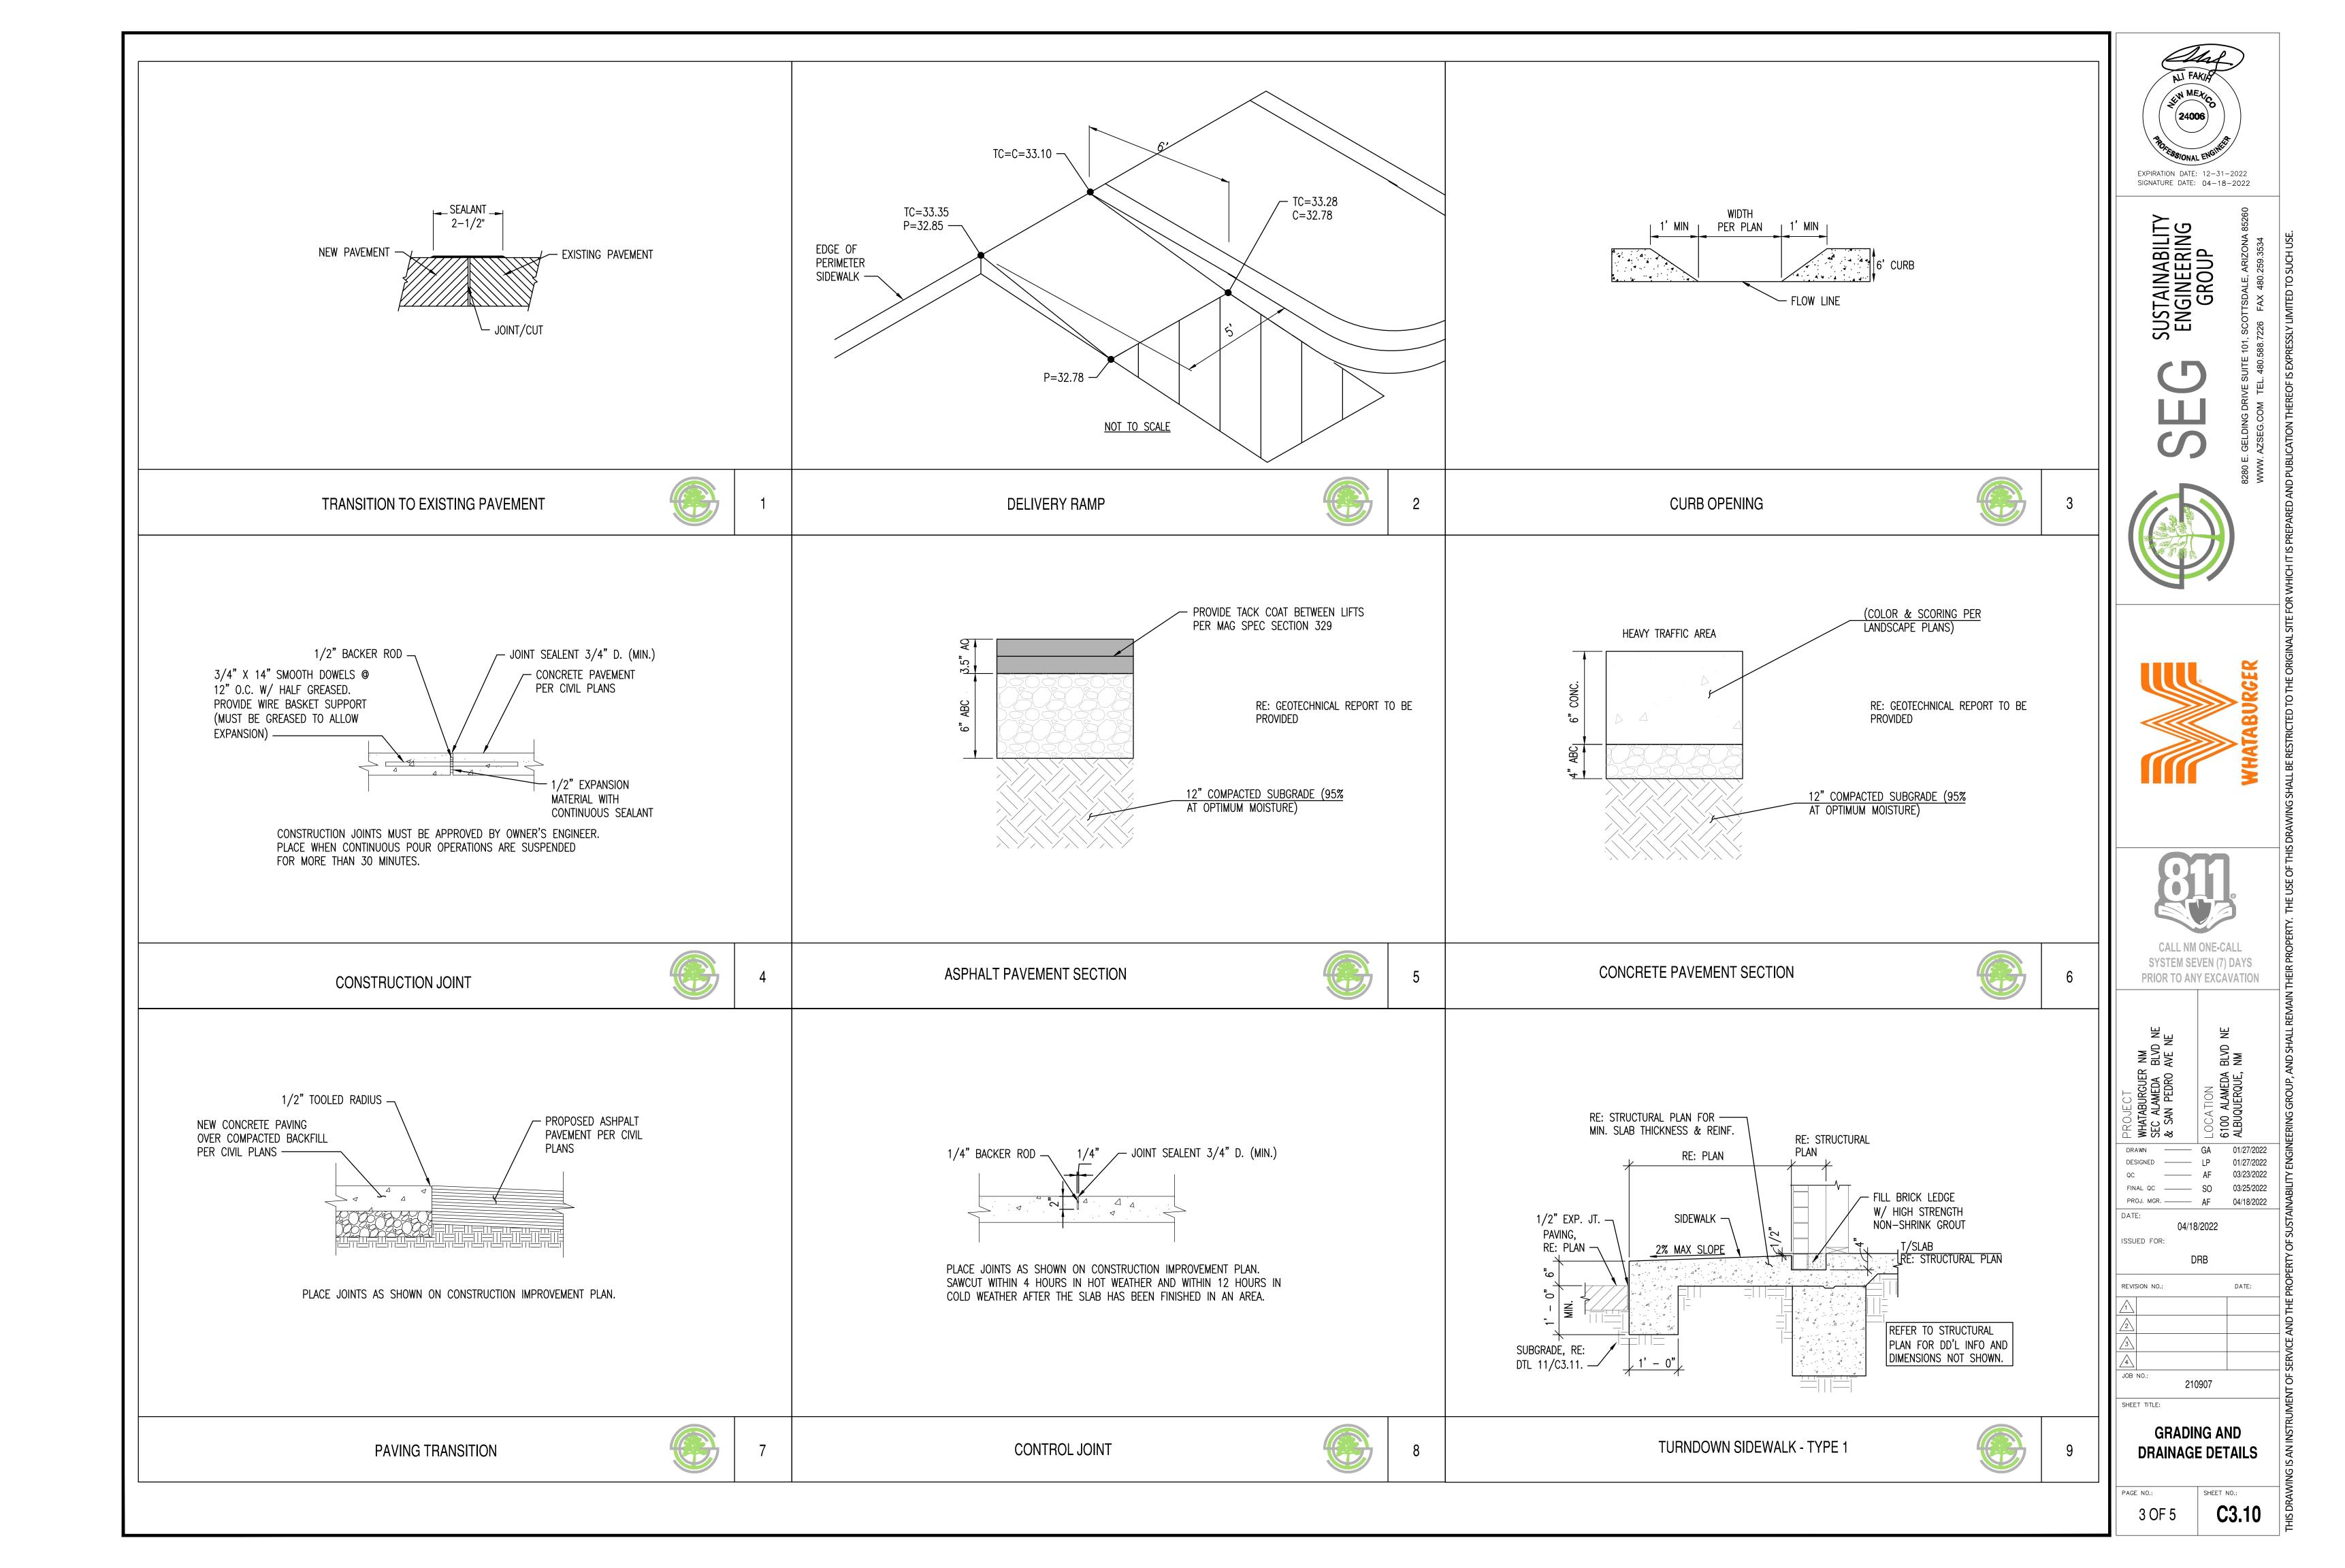

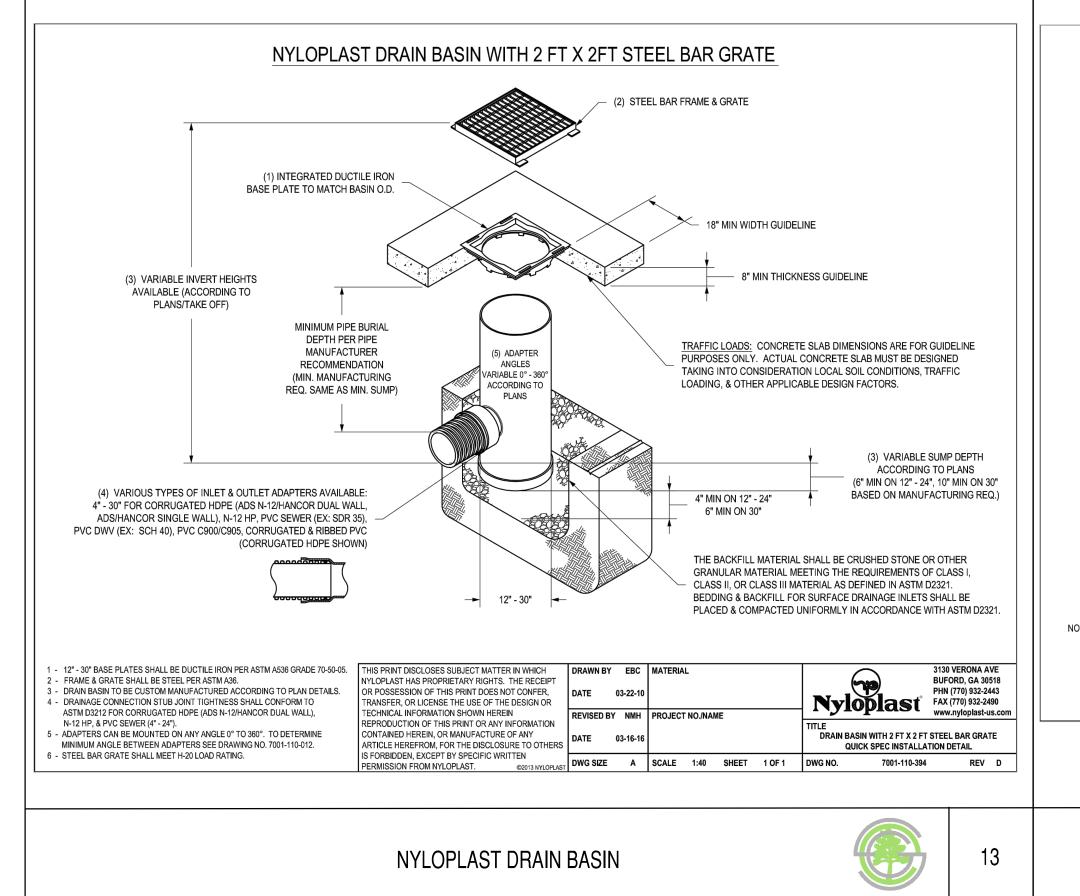

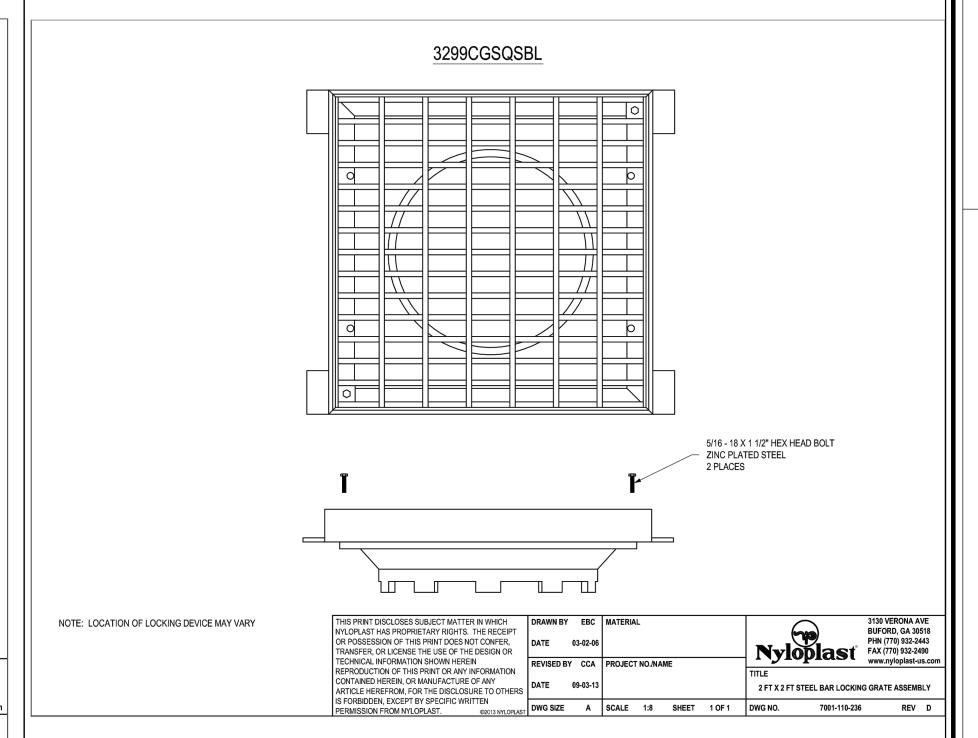

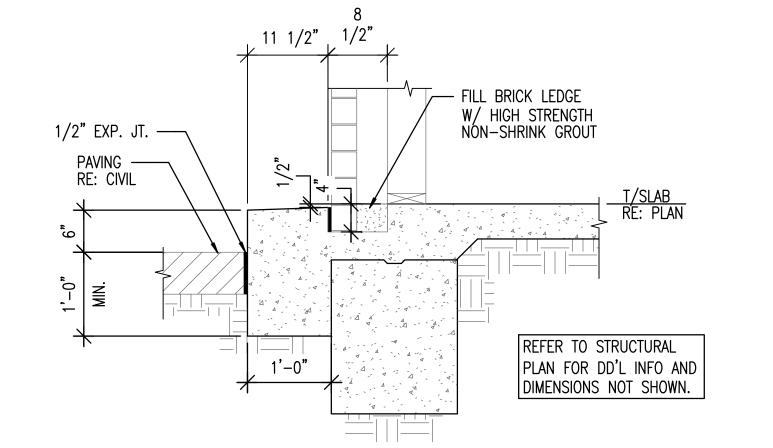

**NYLOPLAST GRATE** 

TURNDOWN SIDEWALK - TYPE 2



16

——— AF 03/23/2022 FINAL QC \_\_\_\_\_ SO 03/25/2022 PROJ. MGR. — AF 04/18/2022

04/18/2022 ISSUED FOR:


DRB


REVISION NO.: DATE: JOB NO.: 210907


> **GRADING AND DRAINAGE DETAILS**

4 OF 5

C3.11

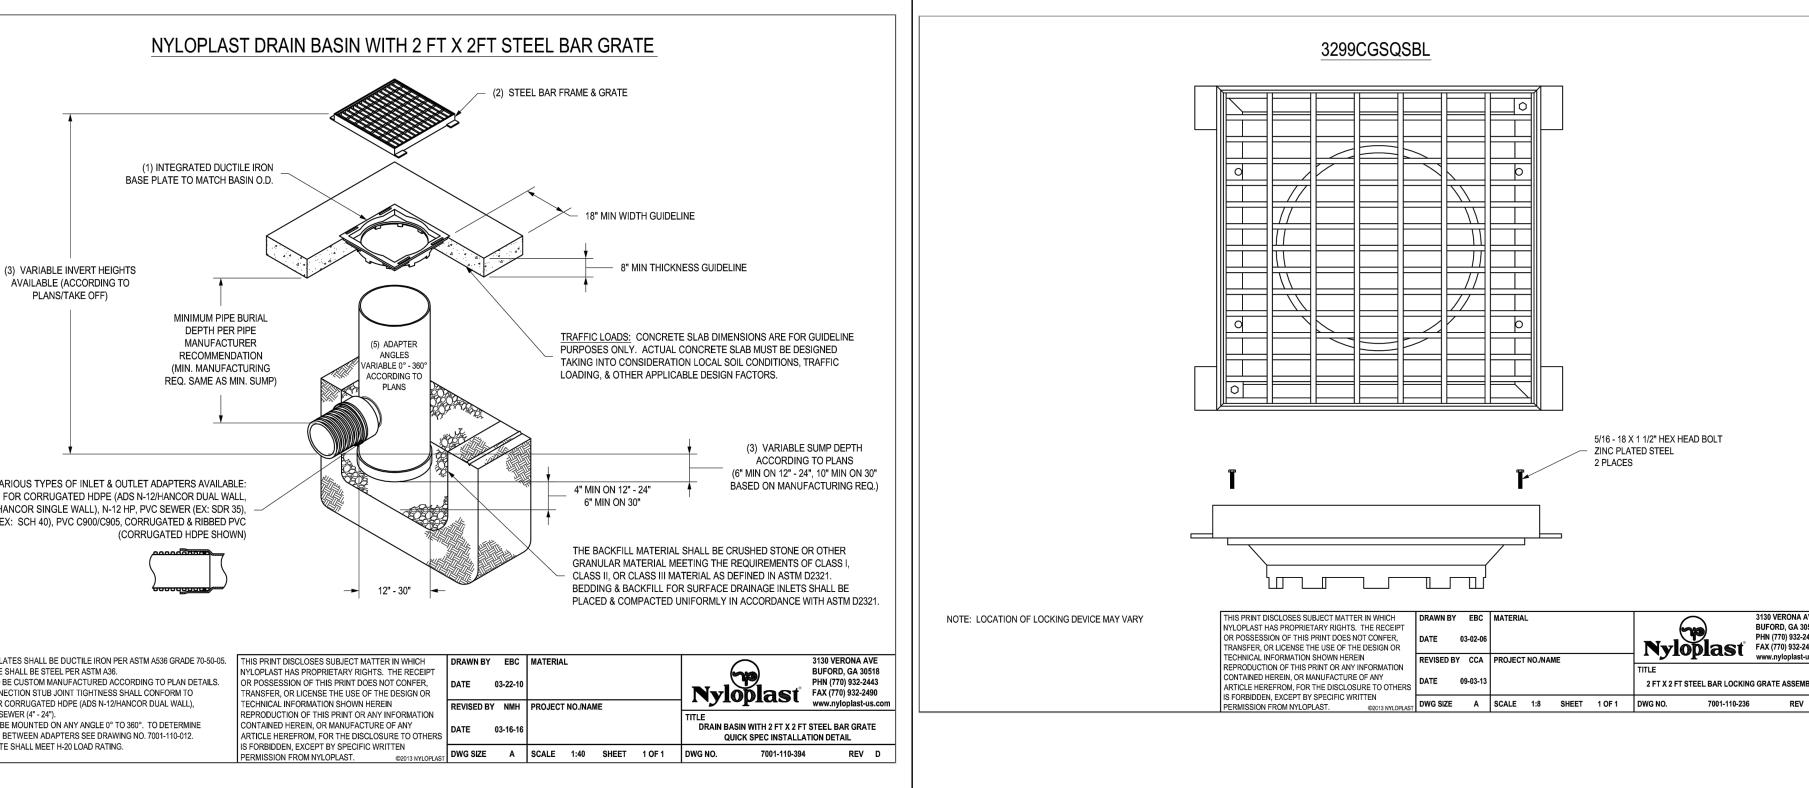

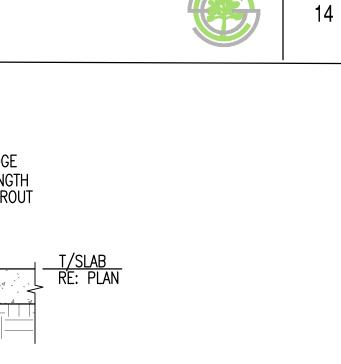


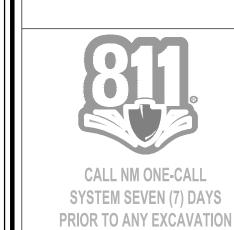

EXPIRATION DATE: 12-31-2022


SIGNATURE DATE: 04-18-2022

SUSTAINABILITY ENGINEERING GROUP

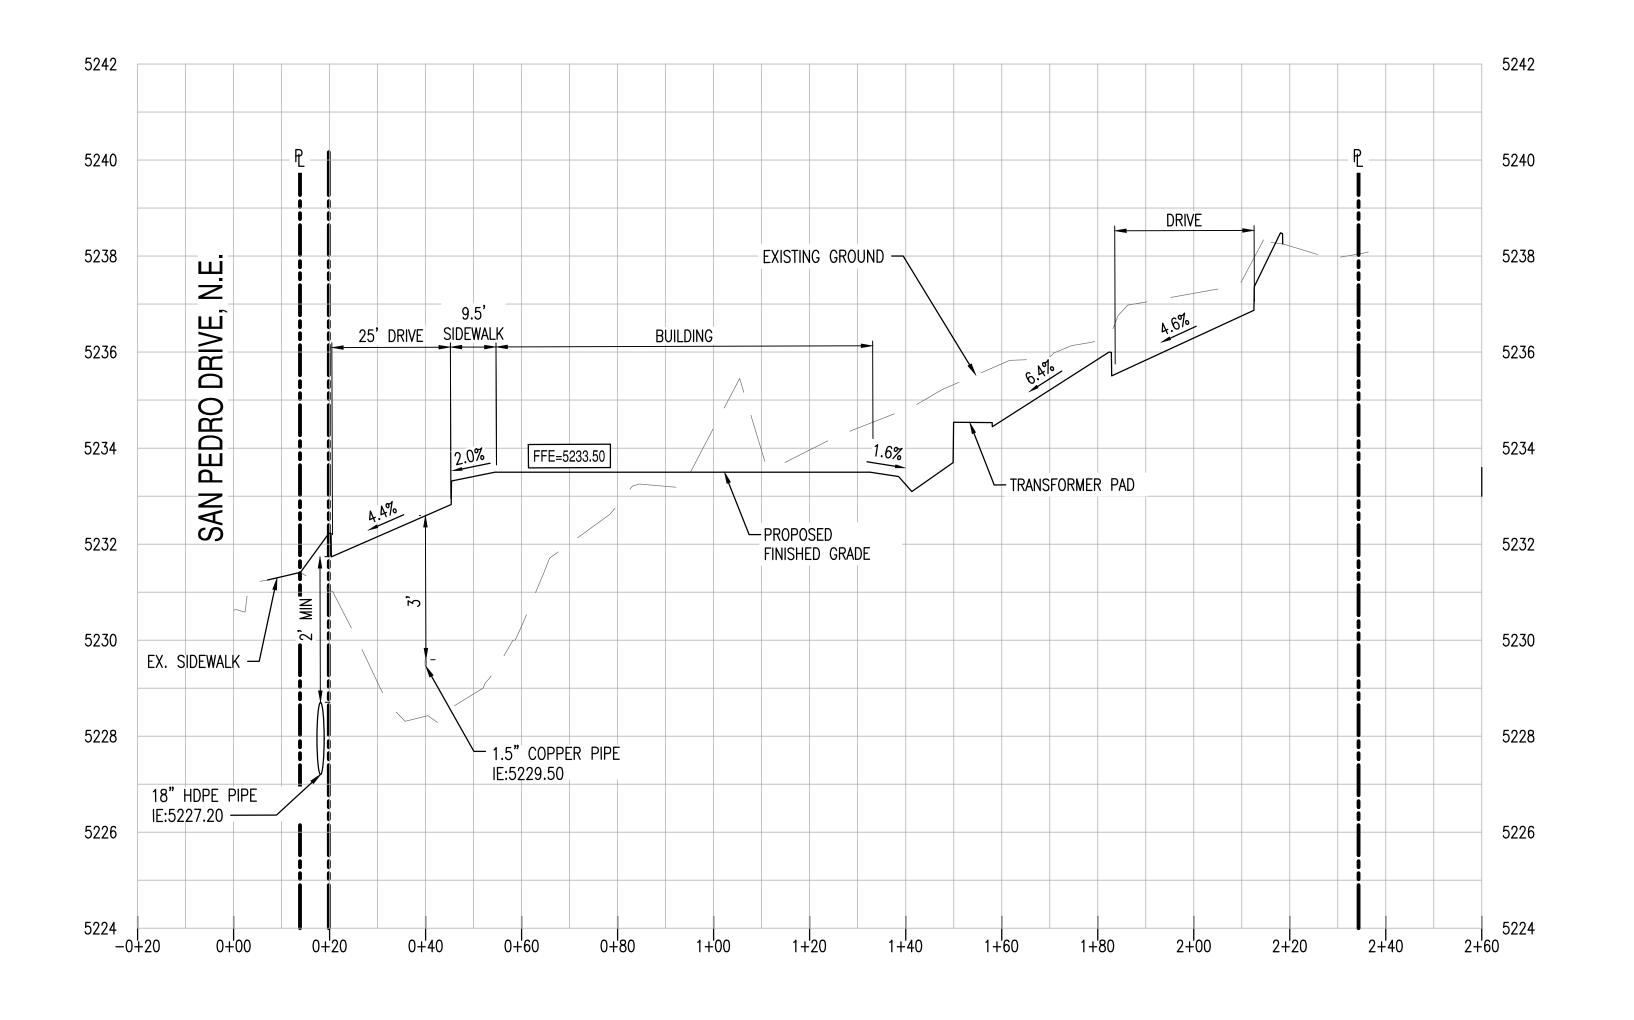

SECTION A-A C3.00

HORIZONTAL SCALE: 1" = 20'
VERTICAL SCALE: 1" = 2'

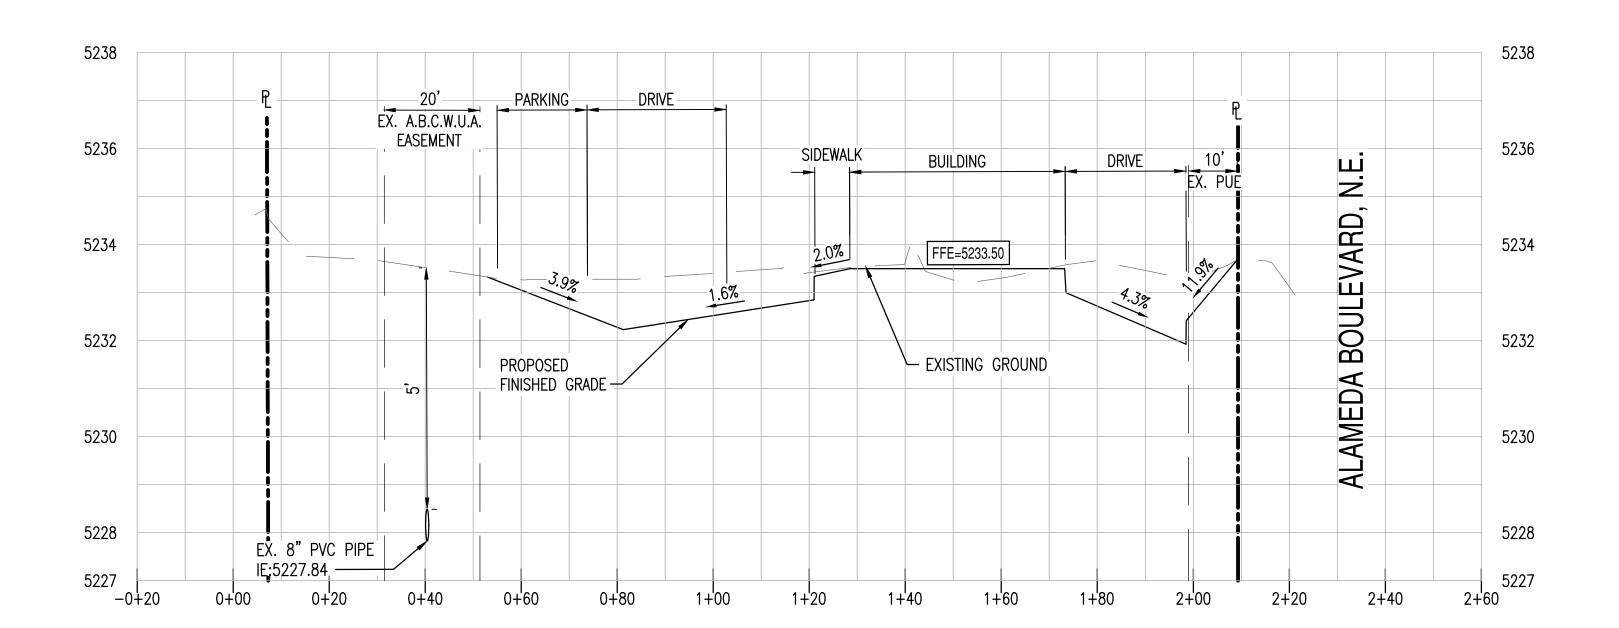

SECTION B-B C3.00

HORIZONTAL SCALE: 1" = 20'
VERTICAL SCALE: 1" = 2'



SUSTAINABILITY ENGINEERING GROUP









IEDA BLVD NE
EDRO AVE NE
NA

04/18/2022 ISSUED FOR: DRB

REVISION NO.: DATE:

JOB NO.: 210907

SHEET TITLE:

SITE CROSS SECTIONS

5 OF 5

C3.20