


### PRELIMINARY SITE PLAN KEYNOTES:

- (1A) 6" VERTICAL CURB PER GRADING PLANS.
- 1B 6" CURB AND GUTTER PER GRADING PLANS.
- 1C TURNDOWN SIDEWALK PER GRADING PLANS.
- (1D) MEDIAN CURB PER GRADING PLANS.
- 2 ACCESSIBLE RAMP PER DET. 8/C2.11.
- ACCESSIBLE RAMP PER DET. 9/C2.11.
- 2B ACCESSIBLE RAMP PER DET. 10/C2.11.
- 2C LOADING ZONE PER GRADING PLANS.
- CONCRETE SIDEWALK PER DET. 12/C2.11, WIDTH PER
- 4 EXISTING SIDEWALK TO REMAIN.
- 5 EXISTING TRASH ENCLOSURE.
- 6 PAINTED ADA SYMBOL PER DET. 1/C2.10.
- 7 4" WIDE WHITE PAINTED STRIPING, TYP.
- 5' WIDE PEDESTRIAN PATHWAY WITH 4" WIDE YELLOW
- 8 8' WIDE PEDESTRIAN PATHWAY AT ACCESIBLE PARKING WITH 4" WIDE YELLOW PAINT, AT 45° 2 FEET O.C.
- 9 6" STEEL BOLLARDS PER DET. 3/C2.10.
- 9A 6" LIT STEEL BOLLARDS PER DET. 3/C2.10.
- 10A) HEAVY DUTY ASPHALT PAVEMENT PER CIVIL PLANS.
- INTEGRAL BLACK CONCRETE PAVEMENT PER GRADING PLANS.
- 10C EXISTING ASPHALT.
- (11) ACCESSIBLE PARKING SIGN PER DET. 2/C2.10.
- 12 DRIVE-THRU CLEARANCE BAR PER ARCHITECTURAL PLANS.
- 13 DRIVE-THRU MENU BOARD. PER DETAIL 6/C2.10.
- 14 RESTAURANT CANOPY PER ARCHITECTURAL PLANS.
- [15] RELOCATED FIRE HYDRANT LOCATION.
- 17) FREE STANDING MAILBOX BY G.C.
- [18] BIKE RACK (4 SPACES). PER DET. 5/C2.10.
- (19) REMOVE AND REPLACE SIDEWALK. WIDTH PER PLAN.
- (20) CONCRETE ISLANDS NOSE, TYPICAL AT ISLANDS.
- (21) WHEEL STOP PER DET. 4/C2.10.
- 22 GRANITE STRIPS. REFER TO LANDSCAPE PLANS FOR
- 23 LIGHT POLE PER PHOTOMETRIC PLAN.
- [24] MOTORCYCLE PARKING (2 SPACES).
- [25] ELECTRIC VEHICLE PARKING (2 SPACES).
- 26 GREASE INTERCEPTOR PER UTILITY PLANS.
- PROPOSED MONUMENT SIGN LOCATION.
- [28] MENU BOARD CANOPY PER ARCHITECTURAL PLAN A6.8.
- 29 SAWCUT PER CIVIL PLANS.
- 30 SVT 11'X11'.
- 31 ELECTRICAL CABINET.
- [32] MOTORCYCLE PARKING ONLY SIGN.
- 33 FUTURE CHARGING STATION LOCATION.
- 34 CURB TRANSITION FROM TO 0" PER CIVIL PLANS.
- 35 PROPOSED STOP SIGN AT DRIVEWAY.
- (36) PAINTED ADA ACCESS AISLE SYMBOL PER DET. 7/C2.11.
- (37) DIRECTIONAL LANE PAVEMENT MARKINGS PER DET. 11/C2.11.
- PROPOSED "ONE WAY" SIGN, PER C.O.A. STD. DET.
- PROPOSED "DO NOT ENTER" SIGN, PER C.O.A. STD. DET.

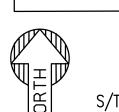



**VICINITY MAP** 13 11N 3E

NE SIGNAL AVE

NE WILSHIRE AVE

### SITE PLAN NOTES

- 1. DEVELOPMENT AND USE OF THIS SITE WILL CONFORM TO ALL APPLICABLE
- 2. FIRE LANES SHALL BE ESTABLISHED AND PROPERLY DESIGNATED IN ACCORDANCE WITH THE LOCAL MUNICIPALITY AND LOCAL FIRE DEPARTMENT REQUIREMENTS.
- . ALL NEW OR RELOCATED UTILITIES WILL BE PLACED UNDERGROUND.
- 4. ALL ROOFTOP EQUIPMENT AND SATELLITE DISHES SHALL BE SCREENED TO THE HEIGHT OF THE TALLEST EQUIPMENT
- 5. ALL SERVICE AREAS SHALL BE SCREENED TO CONCEAL TRASH CONTAINERS, LOADING DOCKS, TRANSFORMERS, BACKFLOW PREVENTERS AND OTHER MECHANICAL OR ELECTRICAL EQUIPMENT FROM EYE LEVEL ADJACENT TO ALL PUBLIC STREETS.
- 6. IF APPLICABLE, PEDESTRIAN ACCESS ROUTES ARE PROVIDED IN DETECTABLE WARNINGS, ARE REQUIRED, AS SHOWN IN PLANS, ON ALL SITE RAMPS AND WALKS THAT CROSS A VEHICULAR WAY PER ADAAG
- 7. PIPE BOLLARDS SHALL BE INSTALLED IN TRAFFIC AND LOADING AREAS AS REQUIRED TO PROTECT BUILDING CORNERS, RECEIVING AREAS, HYDRANTS, TRANSFORMERS, METERS, GENERATORS, COMPACTORS, STEPS. AND RAILINGS, AS NECESSARY.
- ALL SIGNAGE REQUIRES SEPARATE APPROVAL AND PERMITS.
- 9. A MINIMUM 6-FOOT HORIZONTAL SEPARATION BETWEEN WATER AND SEWER PIPELINES WILL BE MAINTAINED.
- 10. OWNERS OF PROPERTY ADJACENT TO THE PUBLIC RIGHT-OF-WAY WILL HAVE THE RESPONSIBILITY FOR MAINTAINING ALL LANDSCAPING WITHIN THE RIGHT-OF-WAY IN ACCORDANCE WITH APPROVED PLANS.

#### SIGHT DISTANCE NOTE

LANDSCAPING, FENCING AND SIGNING WILL NOT INTERFERE WITH CLEAR SIGHT REQUIREMENTS. THEREFORE, SIGNS, WALLS, TREES, AND SHRUBBERY BETWEEN 3 AND 8 FEET TALL (AS MEASURED FROM THE GUTTER PAN) WILL NOT BE ACCEPTABLE IN THE CLEAR SIGHT TRIANGLE.

PROJECT ADDRESS:	6100 ALAMEDA BLVD NE, ALBUQUERQUE, NM				
		O WHATABURGER W/ DRIVE THRU			
UPC:		101806 428134 810229			
ZONING:		NR-BP			
LOT SIZE:		43,565	SF	1.00	AC
PROPOSED USE:		RESTAURANT W/ DRIVE THROUGH			
BUILDING AREA:		2,999	SF		
MAX BUILDING HEIGHT:		ALLOWED	PROPOSED		
RESTAURANT BUILDING	G:	50 FT.	22 FT.		
LOT STANDARDS		REQUIRED	PROPOSED		
MIN LOT WIDTH:		100 FT.	± 186 FT.		
PARKING REQUIREMENT		REQUIRED	PROPOSED		
VEHICLE (2,965 SF/1,000 SF x 8): ADA SPACES: EV SPACES:		24	35	INCL.	2 EV SPACES
		2			2 ADA SPACES
		2			Z ADA SPACE
MOTORCYCLE (1 PER 25 SPACES):		2	2		
BICYCLE SPACES:		3	4		
MINIMUM BUILDING SETBA	ACKS	REQUIRED	PROPOSED		
FRONT (ALAMEDA BLV	D NE):	10 FT.	± 36 FT.		
SIDE (SAN PEDRO ROAD NE):		10 FT.	± 31 FT.		
REAR (SOUTH SIDE):		10 FT.	± 119.5 FT.		
MINIMUM LANDSCAPE BUFFER		REQUIRED	PROPOSED		
FRONT (ALAMEDA BLVD NE):		10 FT.	± 10 FT.		
SIDE (SAN PEDRO ROAD NE):		6 FT.	± 22 FT.		PARKING LOTIS INT TO LOTEDGE
REAR (SOUTH SIDE):	<u></u>	6 FT.	± 6 FT.	ADJACE	INT TO LOT EDGE

### PROPOSED LEGEND:

VERTICAL CURB CURB AND GUTTER PARKING COUNT PAVEMENT STRIPING FIRE HYDRANT

TRANSFORMER

CONCRETE PAVEMENT/SIDEWALK


HEAVY DUTY PAVEMENT

EXISTING PAVEMENT

ACCESSIBLE PEDESTRIAN PATH

28'/48' FIRE ACCESS TURN RADIUS

RED PAINTED FIRE CURB RE: DET. 6/C2.10

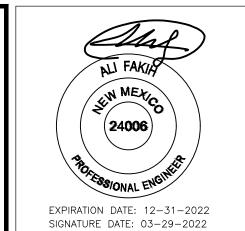

SUSTAINABILITY ENGINEERING GROUP







CALL NM ONE-CALL SYSTEM SEVEN (7) DAYS PRIOR TO ANY EXCAVATION

FINAL QC \_\_\_\_\_ PROJ. MGR. — AF 03/23/2022

03/23/2022 ISSUED FOR:


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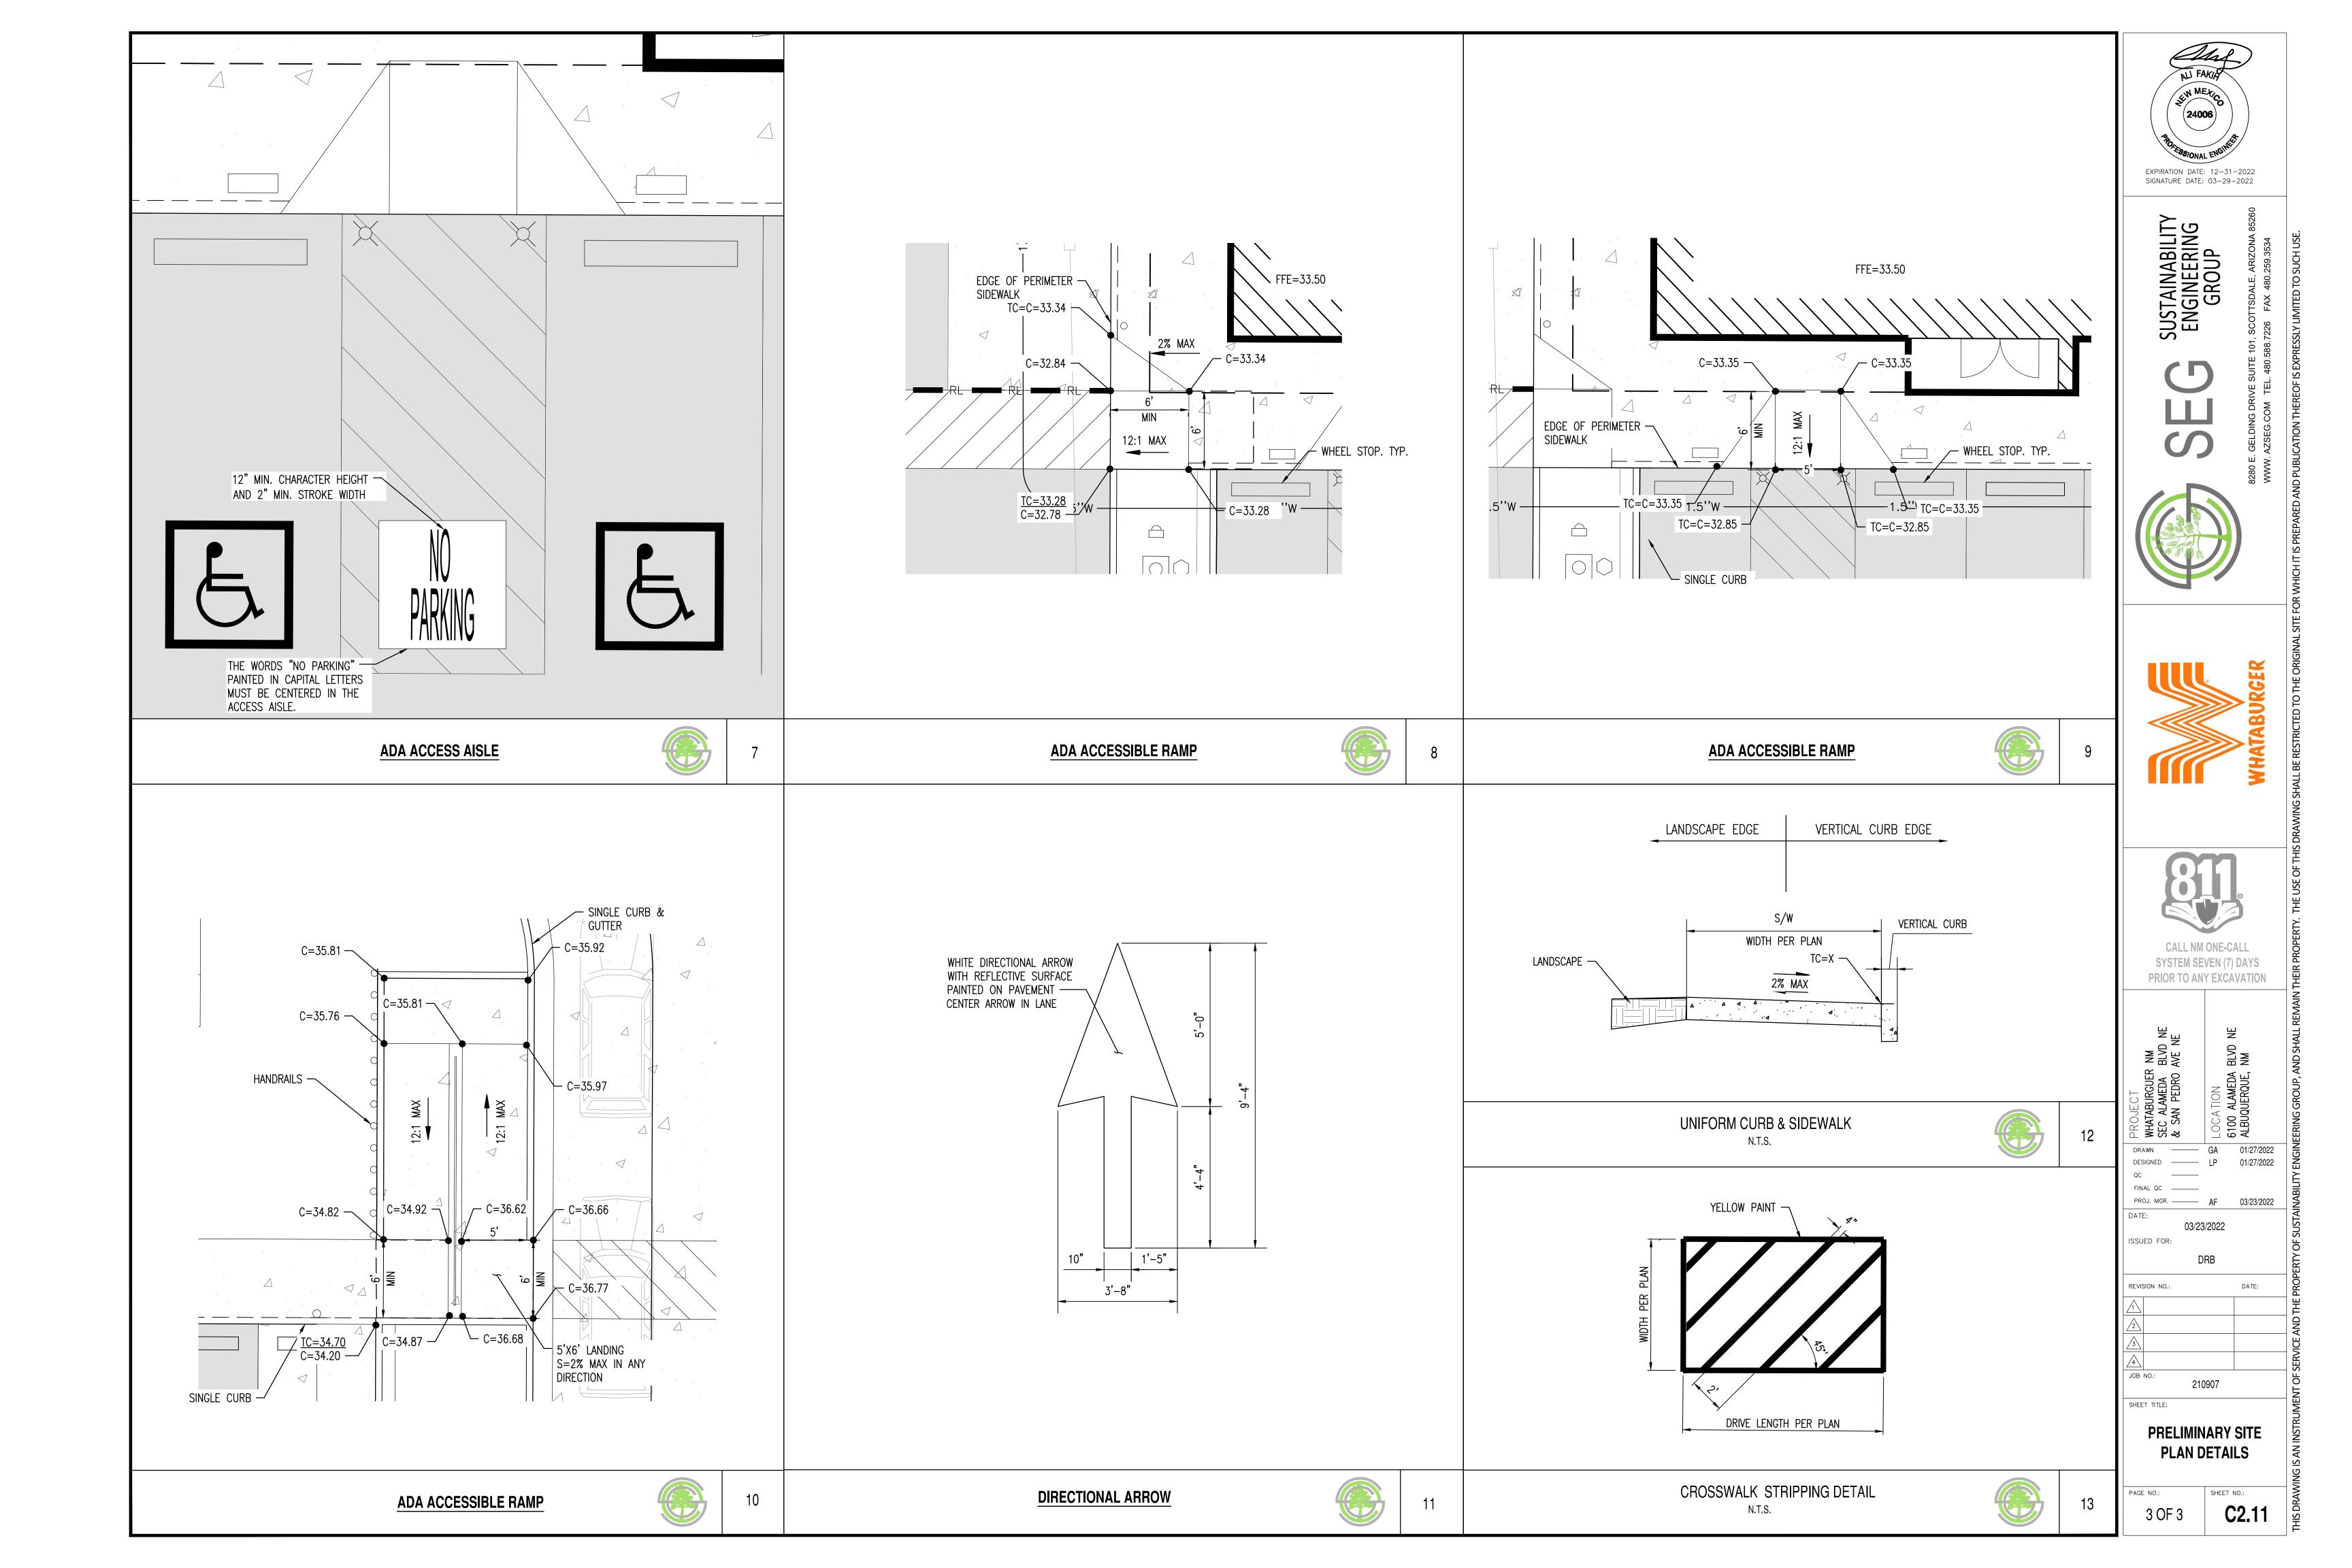
210907


PRELIMINARY SITE

1 OF 3

C2.00



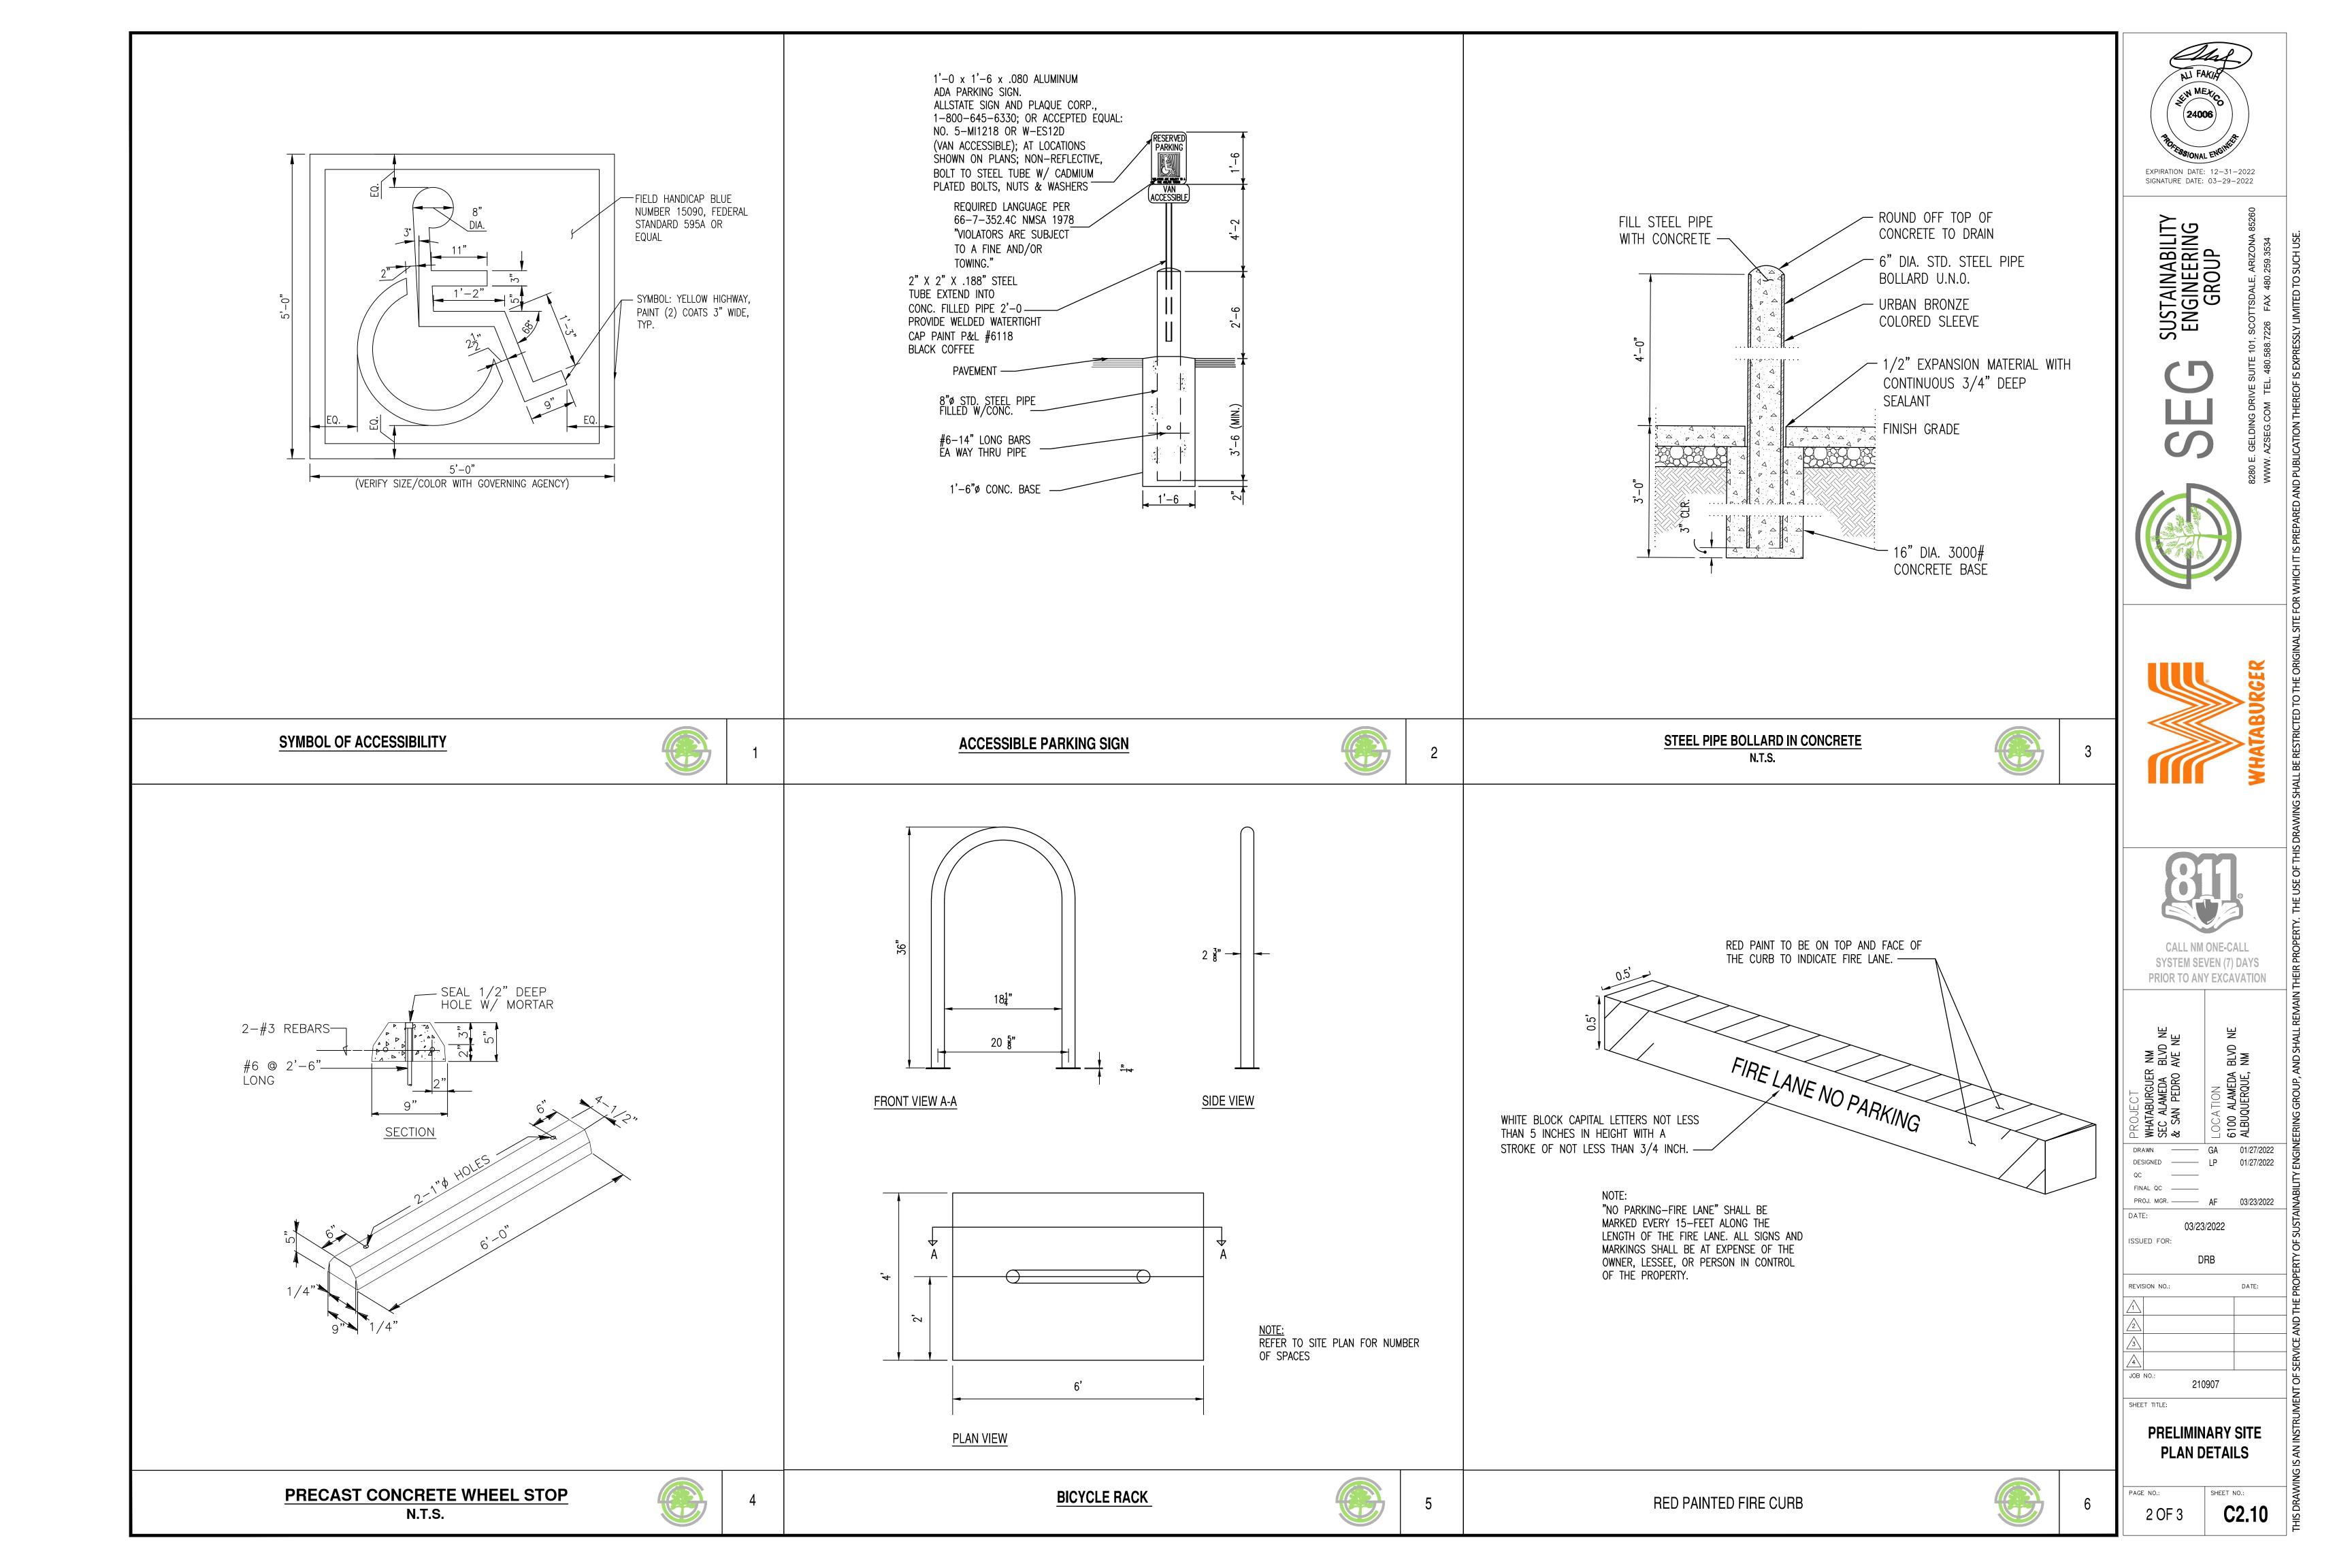

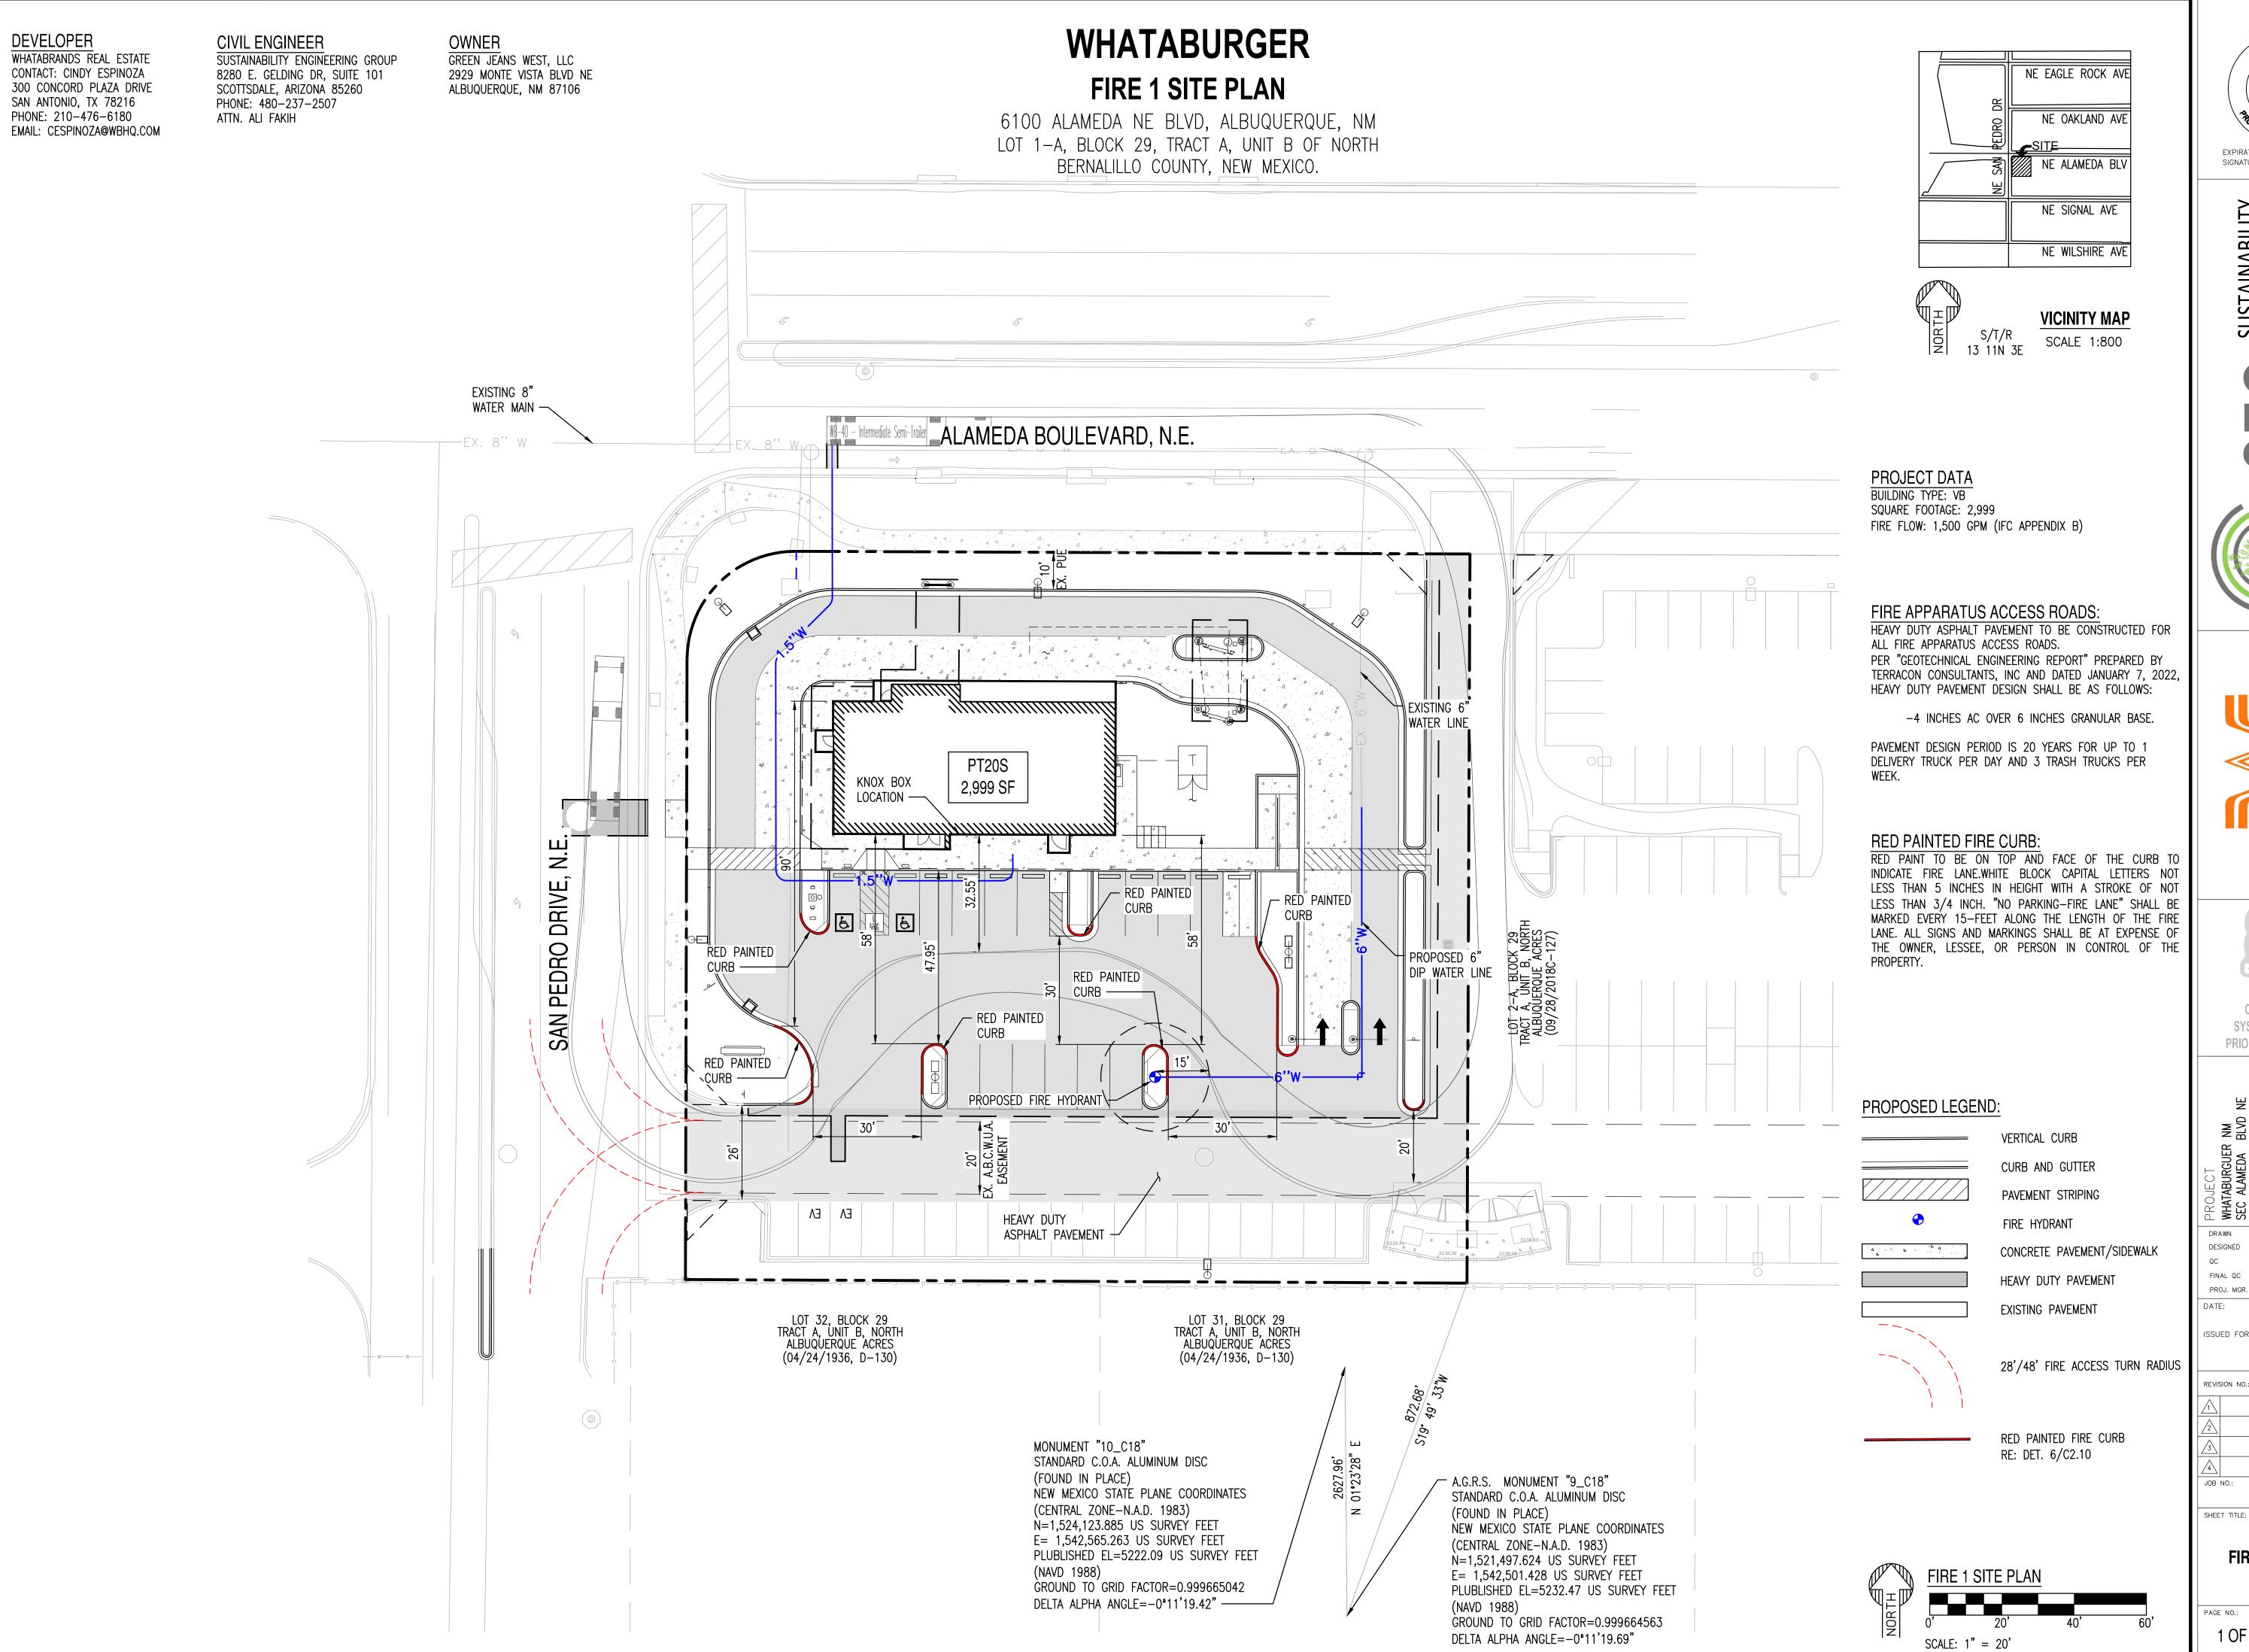



SUSTAINABILITY ENGINEERING GROUP







CALL NM ONE-CALL SYSTEM SEVEN (7) DAYS PRIOR TO ANY EXCAVATION

drawn — GA 01/27/2022 FINAL QC \_\_\_\_\_ PROJ. MGR. — AF 03/23/2022

03/23/2022 ISSUED FOR:

DRB

DATE:

210907

FIRE 1 SITE PLAN

C2.30

**DEVELOPER** 

WHATABRANDS REAL ESTATE CONTACT: CINDY ESPINOZA 300 CONCORD PLAZA DRIVE SAN ANTONIO, TX 78216 PHONE: 210-476-6180 EMAIL: CESPINOZA@WBHQ.COM **CIVIL ENGINEER** SUSTAINABILITY ENGINEERING GROUP 8280 E. GELDING DR, SUITE 101 SCOTTSDALE, ARIZONA 85260 PHONE: 480-237-2507 ATTN. ALI FAKIH

L=47.07', R=29.99'

IE=27.03 (18")(NE)

IE=27.05 (18")(SE) IE=26.93 (18")(W)

D=89°55'13"


 $\sqrt{\frac{35}{RIM}} = 31.64$ 


TE=27.56 (18")(SW

**OWNER** GREEN JEANS WEST, LLC 2929 MONTE VISTA NE ALBUQUERQUE, NM 87106

# WHATABURGER **GRADING AND DRAINAGE PLAN**

6100 ALAMEDA BLVD NE, ALBUQUERQUE, NM A PORTION OF SECTION 13, TOWNSHIP 11 NORTH, RANGE 3 EAST BERNALILLO COUNTY, NEW MEXICO.

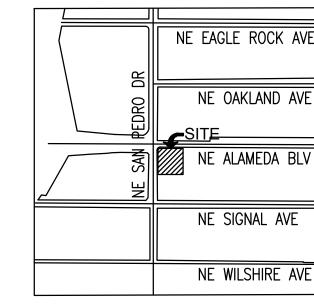

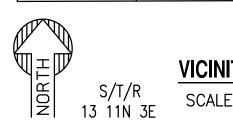



### GRADING CONSTRUCTION KEY NOTES

- MATCH EXISTING GRADE; CONTRACTOR TO VERIFY IN FIELD ALL GRADES PRIOR TO CONSTRUCTION ACTIVITIES AND CONTACT ENGINEER IN CASE OF ANY DISCREPANCIES.
- (2) CONSTRUCT 6" HEADER CURB PER COA STD. DET. 2415C
- (2A) CONSTRUCT 6" VERTICAL CURB AND GUTTER PER COA STD DWG 2415-A.
- (3) CONSTRUCT ADA RAMP. PER SITE PLANS.
- (3B) CONSTRUCT DELIVERY RAMP PER DET. 2/C3.10.
- 4 FURNISH AND INSTALL NYLOPLAST DRAIN BASIN WITH 30" RISER AND 2'X3' STEEL GRATE PER
- 5 FURNISH AND INSTALL HDPE DOUBLE WALL PIPE, CLASS 100; LENGTH, SIZE AND SLOPE PER
- 5A FURNISH AND INSTALL REINFORCED CLASS III CONCRETE PIPE, LENGTH, SIZE AND SLOPE PER
- 6 FURNISH AND INSTALL 30" NYLOPLAST DRAIN BASIN WITH SOLID LID. PER DET. 13/C3.12.
- 7 CONSTRUCT HEAVY DUTY PAVEMENT PER DETAIL 5/C3.10.
- 8 FURNISH AND INSTALL 4' MANHOLE PER COA DETAIL 2208.
- 9 CONSTRUCT CONCRETE SIDEWALK PER COA STD DWG 2430. WIDTH PER PLAN.
- CONSTRUCT PAVEMENT WITH 2% MAXIMUM SLOPE IN ANY DIRECTION AT ACCESSIBLE PARKING STALLS AND 2% MAXIMUM CROSS SLOPE AT ADA ACCESSIBLE ROUTE.
- (11) CONSTRUCT CONCRETE PAVEMENT PER DETAIL 6/C3.10.
- (12) CAUTION! PROTECT EXISTING GAS AND POWER UTILITIES.
- \$\langle 13 \text{PAVING TRANSITION PER DET. 7/C3.10.}
- (14) TRANSITION TO EXISTING PAVEMENT PER DET. 1/C3.10.
- (15) SAWCUT, REMOVE AND REPLACE EXISTING PAVEMENT.
- (16) CONSTRUCT 3' CURB OPENING. PER DET. 3/C3.10.
- (17) TURN DOWN SIDEWALK. PER DET. 9/C3.10.
- (18) TURN DOWN SIDEWALK. PER DET. 16/C3.11.
- (19) 5' CURB TRANSITION FROM 6" TO 0" REVEAL.

INVERT ELEVATIONS TO BE VERIFIED IN FIELD.

EXISTING CONDITIONS AND PROPOSED DEVELOPMENT: THE EXISTING SITE IS PARTIALLY DEVELOPED. THE SOUTHERN PORTION OF THE PROPERTY INCLUDES A PARKING LOT WITH LANDSCAPE ISLANDS WHILE THE NORTH AREA REMAINS UNDEVELOPED WITH AN EXISTING DRAINAGE POND, DIRT PILES AND STORAGE CONTAINER. DRAINAGE STRUCTURES, SEWER AND WATER LINES, AND DRY UTILITIES SUCH AS POWER, GAS AND ELECTRICITY EXIST WITHIN THE SITE. LOT ELEVATION DROP FROM 1,238' AT THE EAST PROPERTY LINE TO ABOUT 1,232' AT THE WEST PROPERTY LINE.

THE PROJECT WILL CONSIST IN THE DEMOLITION OF MOST OF THE EXISTING SOUTH PARKING LOT AND THE CONSTRUCTION OF A FAST FOOD RESTAURANT (2,999 SF) WITH A DRIVE-THRU, PARKING AREA, AND DESIGNATED LANDSCAPE.



EXPIRATION DATE: 12-31-2022

SIGNATURE DATE: 03-29-2022

SUSTAINABILITY ENGINEERING GROUP



CALL NM ONE-CALL SYSTEM SEVEN (7) DAYS PRIOR TO ANY EXCAVATION


PROJECT WHATABURGUER NM SEC ALAMEDA BLVD NE	& SAN PEDRO AVE NE	LOCATION	6100 ALAMEDA BLVD NE ALBIDITERDIF NM
DRAWN		GA	01 01
DESIGNED		LP	01
	DRAWN	DRAWN	DRAWN GA

01/27/2022 1/27/2022 FINAL QC \_\_\_\_\_ PROJ. MGR. — AF 03/23/2022 03/23/2022 ISSUED FOR: DRB

REVISION NO .: DATE: JOB NO.: 210907

> **GRADING AND** DRAINAGE PLAN

C3.00

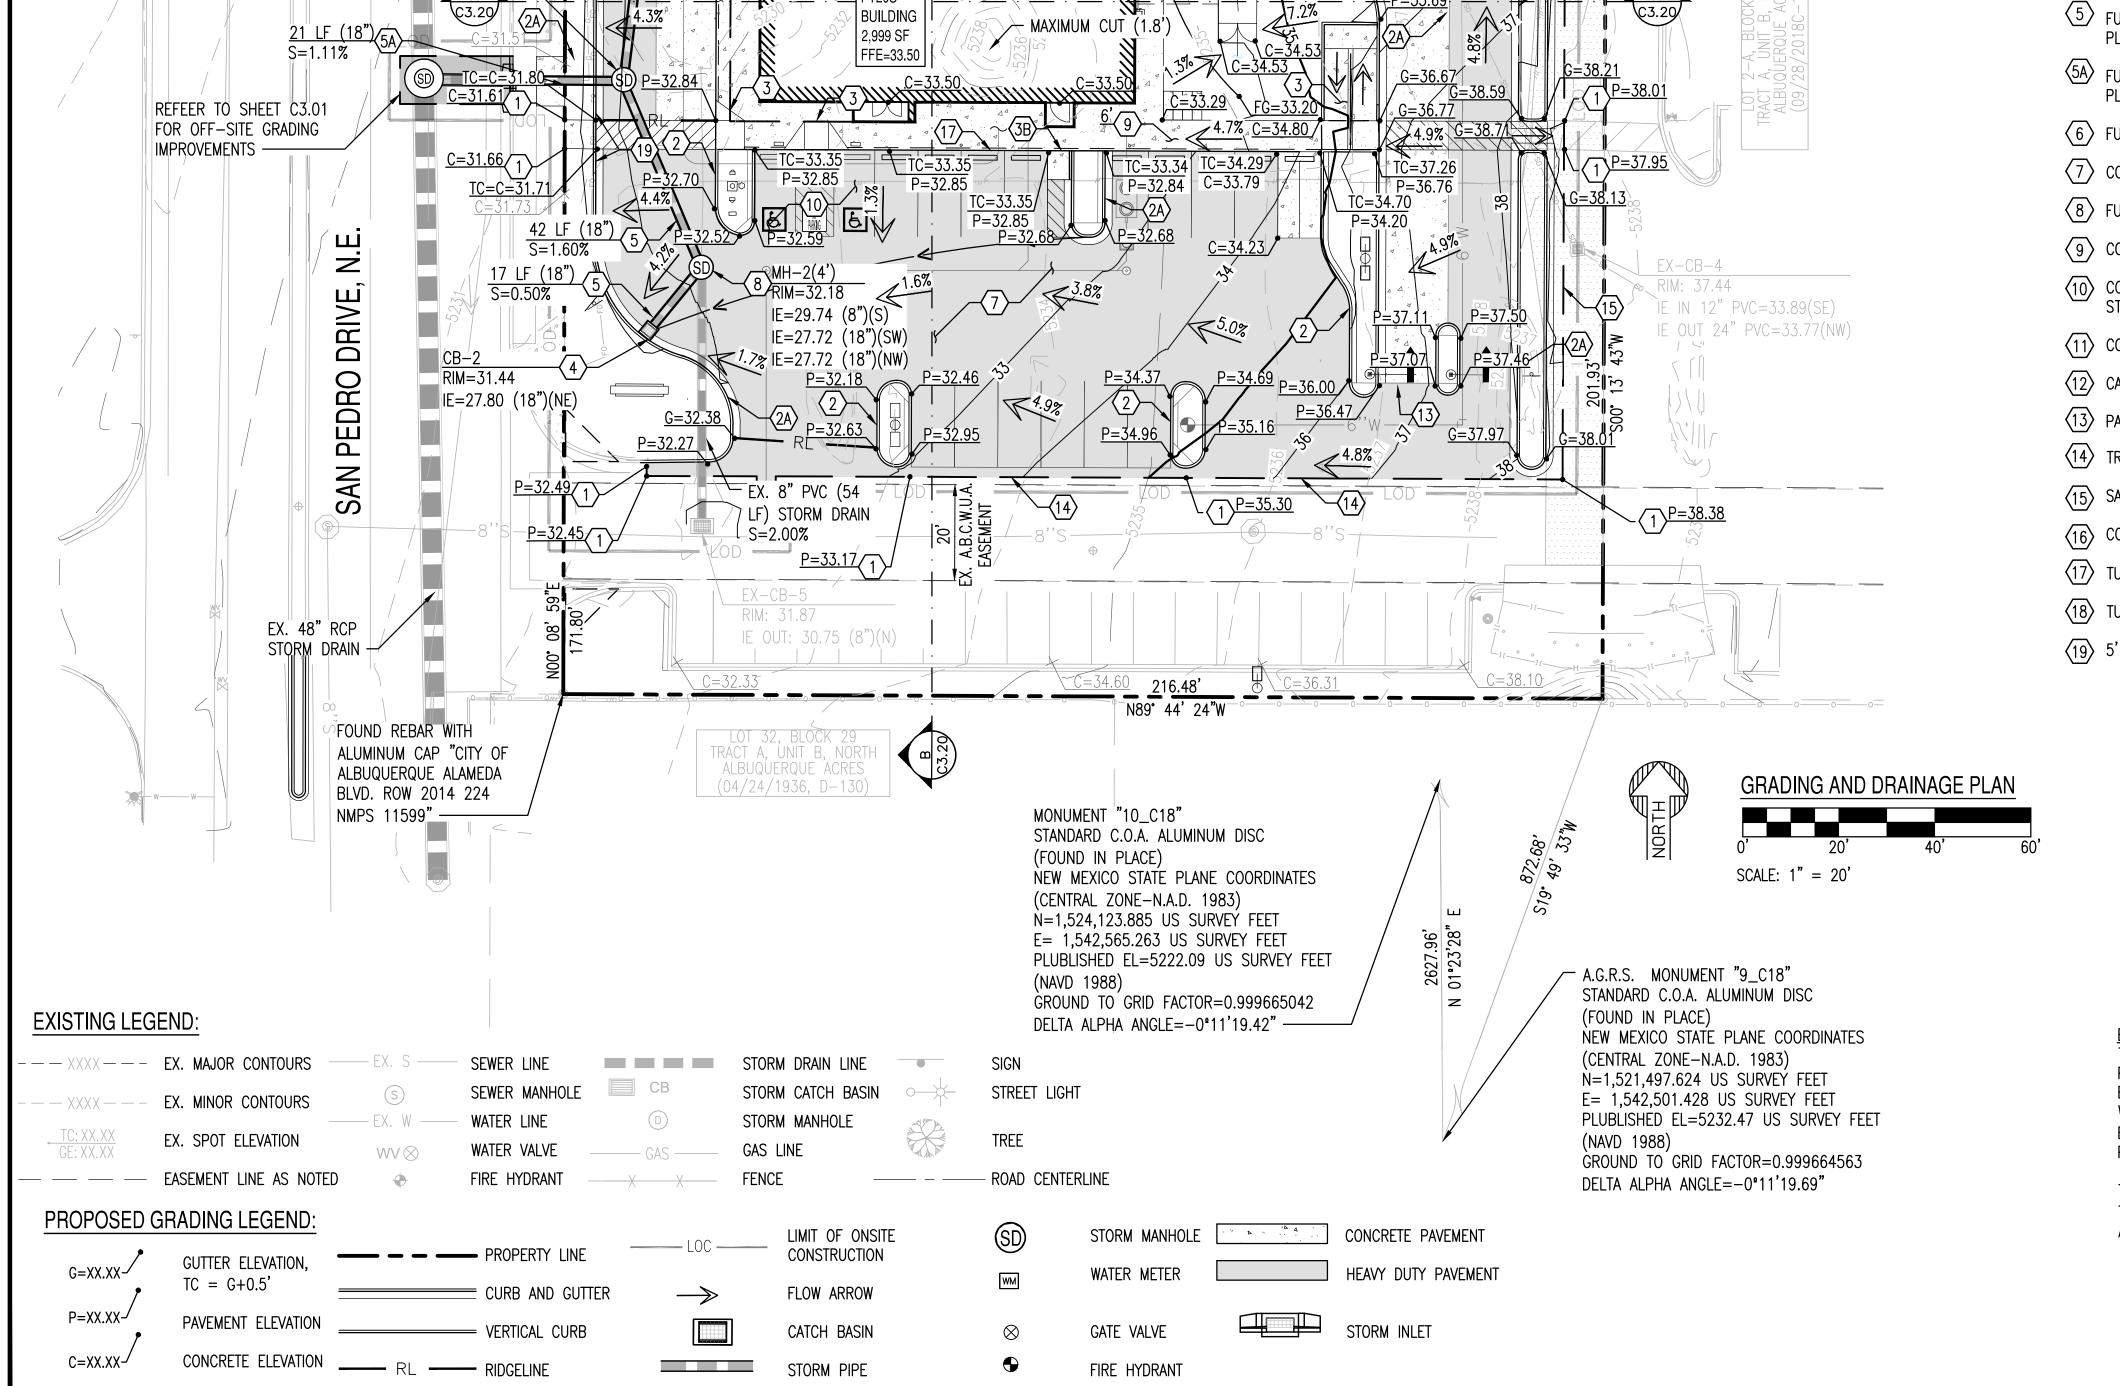

ALAMEDA BOULEVARD, N.E.

 $\frac{TC=33.48}{C=32.98}$ 

DEVELOPER WHATABRANDS REAL ESTATE CONTACT: CINDY ESPINOZA 300 CONCORD PLAZA DRIVE SAN ANTONIO, TX 78216 PHONE: 210-476-6180

EMAIL: CESPINOZA@WBHQ.COM

CONCRETE ELEVATION

STORM PIPE

C=XX.XX-


**CIVIL ENGINEER** SUSTAINABILITY ENGINEERING GROUP 8280 E. GELDING DR, SUITE 101 SCOTTSDALE, ARIZONA 85260 PHONE: 480-237-2507 ATTN. ALI FAKIH


**OWNER** GREEN JEANS WEST, LLC 2929 MONTE VISTA NE ALBUQUERQUE, NM 87106

# WHATABURGER

### OFF-SITE GRADING AND DRAINAGE PLAN

6100 ALAMEDA BLVD NE, ALBUQUERQUE, NM A PORTION OF SECTION 13, TOWNSHIP 11 NORTH, RANGE 3 EAST BERNALILLO COUNTY, NEW MEXICO.

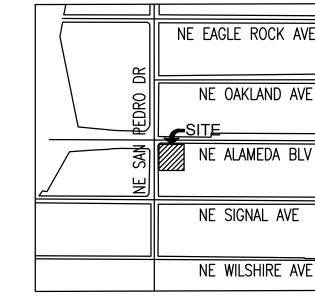


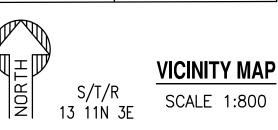

### GRADING CONSTRUCTION KEY NOTES

- MATCH EXISTING GRADE; CONTRACTOR TO VERIFY IN FIELD ALL GRADES PRIOR TO CONSTRUCTION ACTIVITIES AND CONTACT ENGINEER IN CASE OF ANY DISCREPANCIES.
- (2) REMOVE AND REPLACE 6" VERTICAL CURB AND GUTTER PER COA STD DWG 2415-A.
- REMOVE AND REPLACE EXISTING SIDEWALK AS REQUIRED FOR UTILITY CONSTRUCTION. REMOVE TO NEAREST JOINT.
- 4 FURNISH AND INSTALL REINFORCED CLASS III CONCRETE PIPE, LENGTH, SIZE AND SLOPE PER
- (5) SAWCUT, REMOVE AND REPLACE ASPHALT AS NEEDED. PAVEMENT TO MATCH EXISTING SECTION.
- (6) CONSTRUCT CONCRETE SIDEWALK PER COA STD DWG 2430. WIDTH PER PLAN.
- (7) INSTALL PUBLIC STORM INLET TYPE DBL A-SGL WING. PER COA STD. DWG 2201.
- 8 PUBLIC 8' DIA MANHOLE
- (9) CONSTRUCT MOUNTABLE MEDIAN CURB PER COA STD. DWG 2415A.

INVERT ELEVATIONS TO BE VERIFIED IN FIELD.

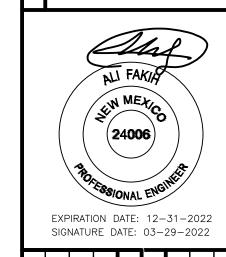

SUSTAINABILITY | ENGINEERING GROUP

DRAWN BY: ER CHECKED BY: SC

03/2022

CITY OF ALBUQUERQUE DEPARTMENT OF MUNICIPAL DEVELOPMENT ENGINEERING DIVISION

OFF-SITE GRADING & DRAINAGE


PLAN

DESIGN REVIEW COMMITTEE CITY ENGINEER APPROVAL ZONE MAP NO. **Z-99** CITY PROJECT NO. 000000 SHEET NO. C3.01


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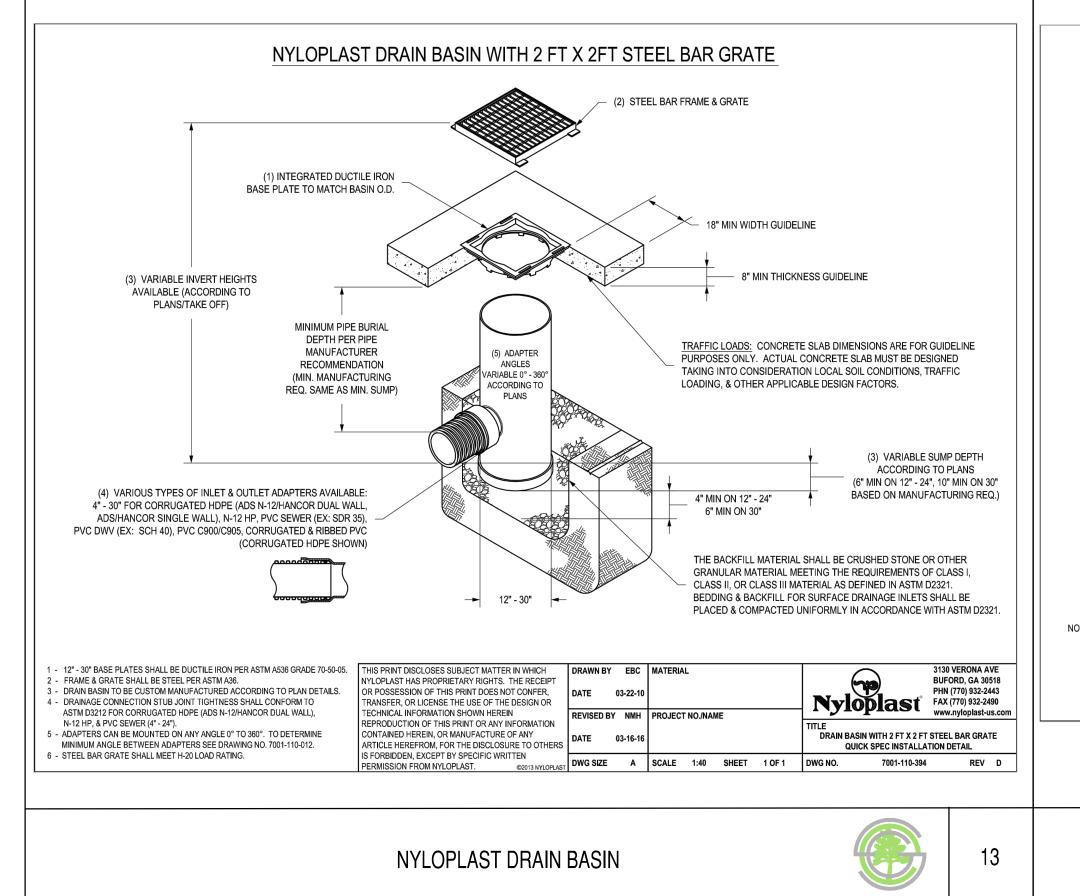
SYSTEM SEVEN (7) DAYS


PRIOR TO ANY EXCAVATION

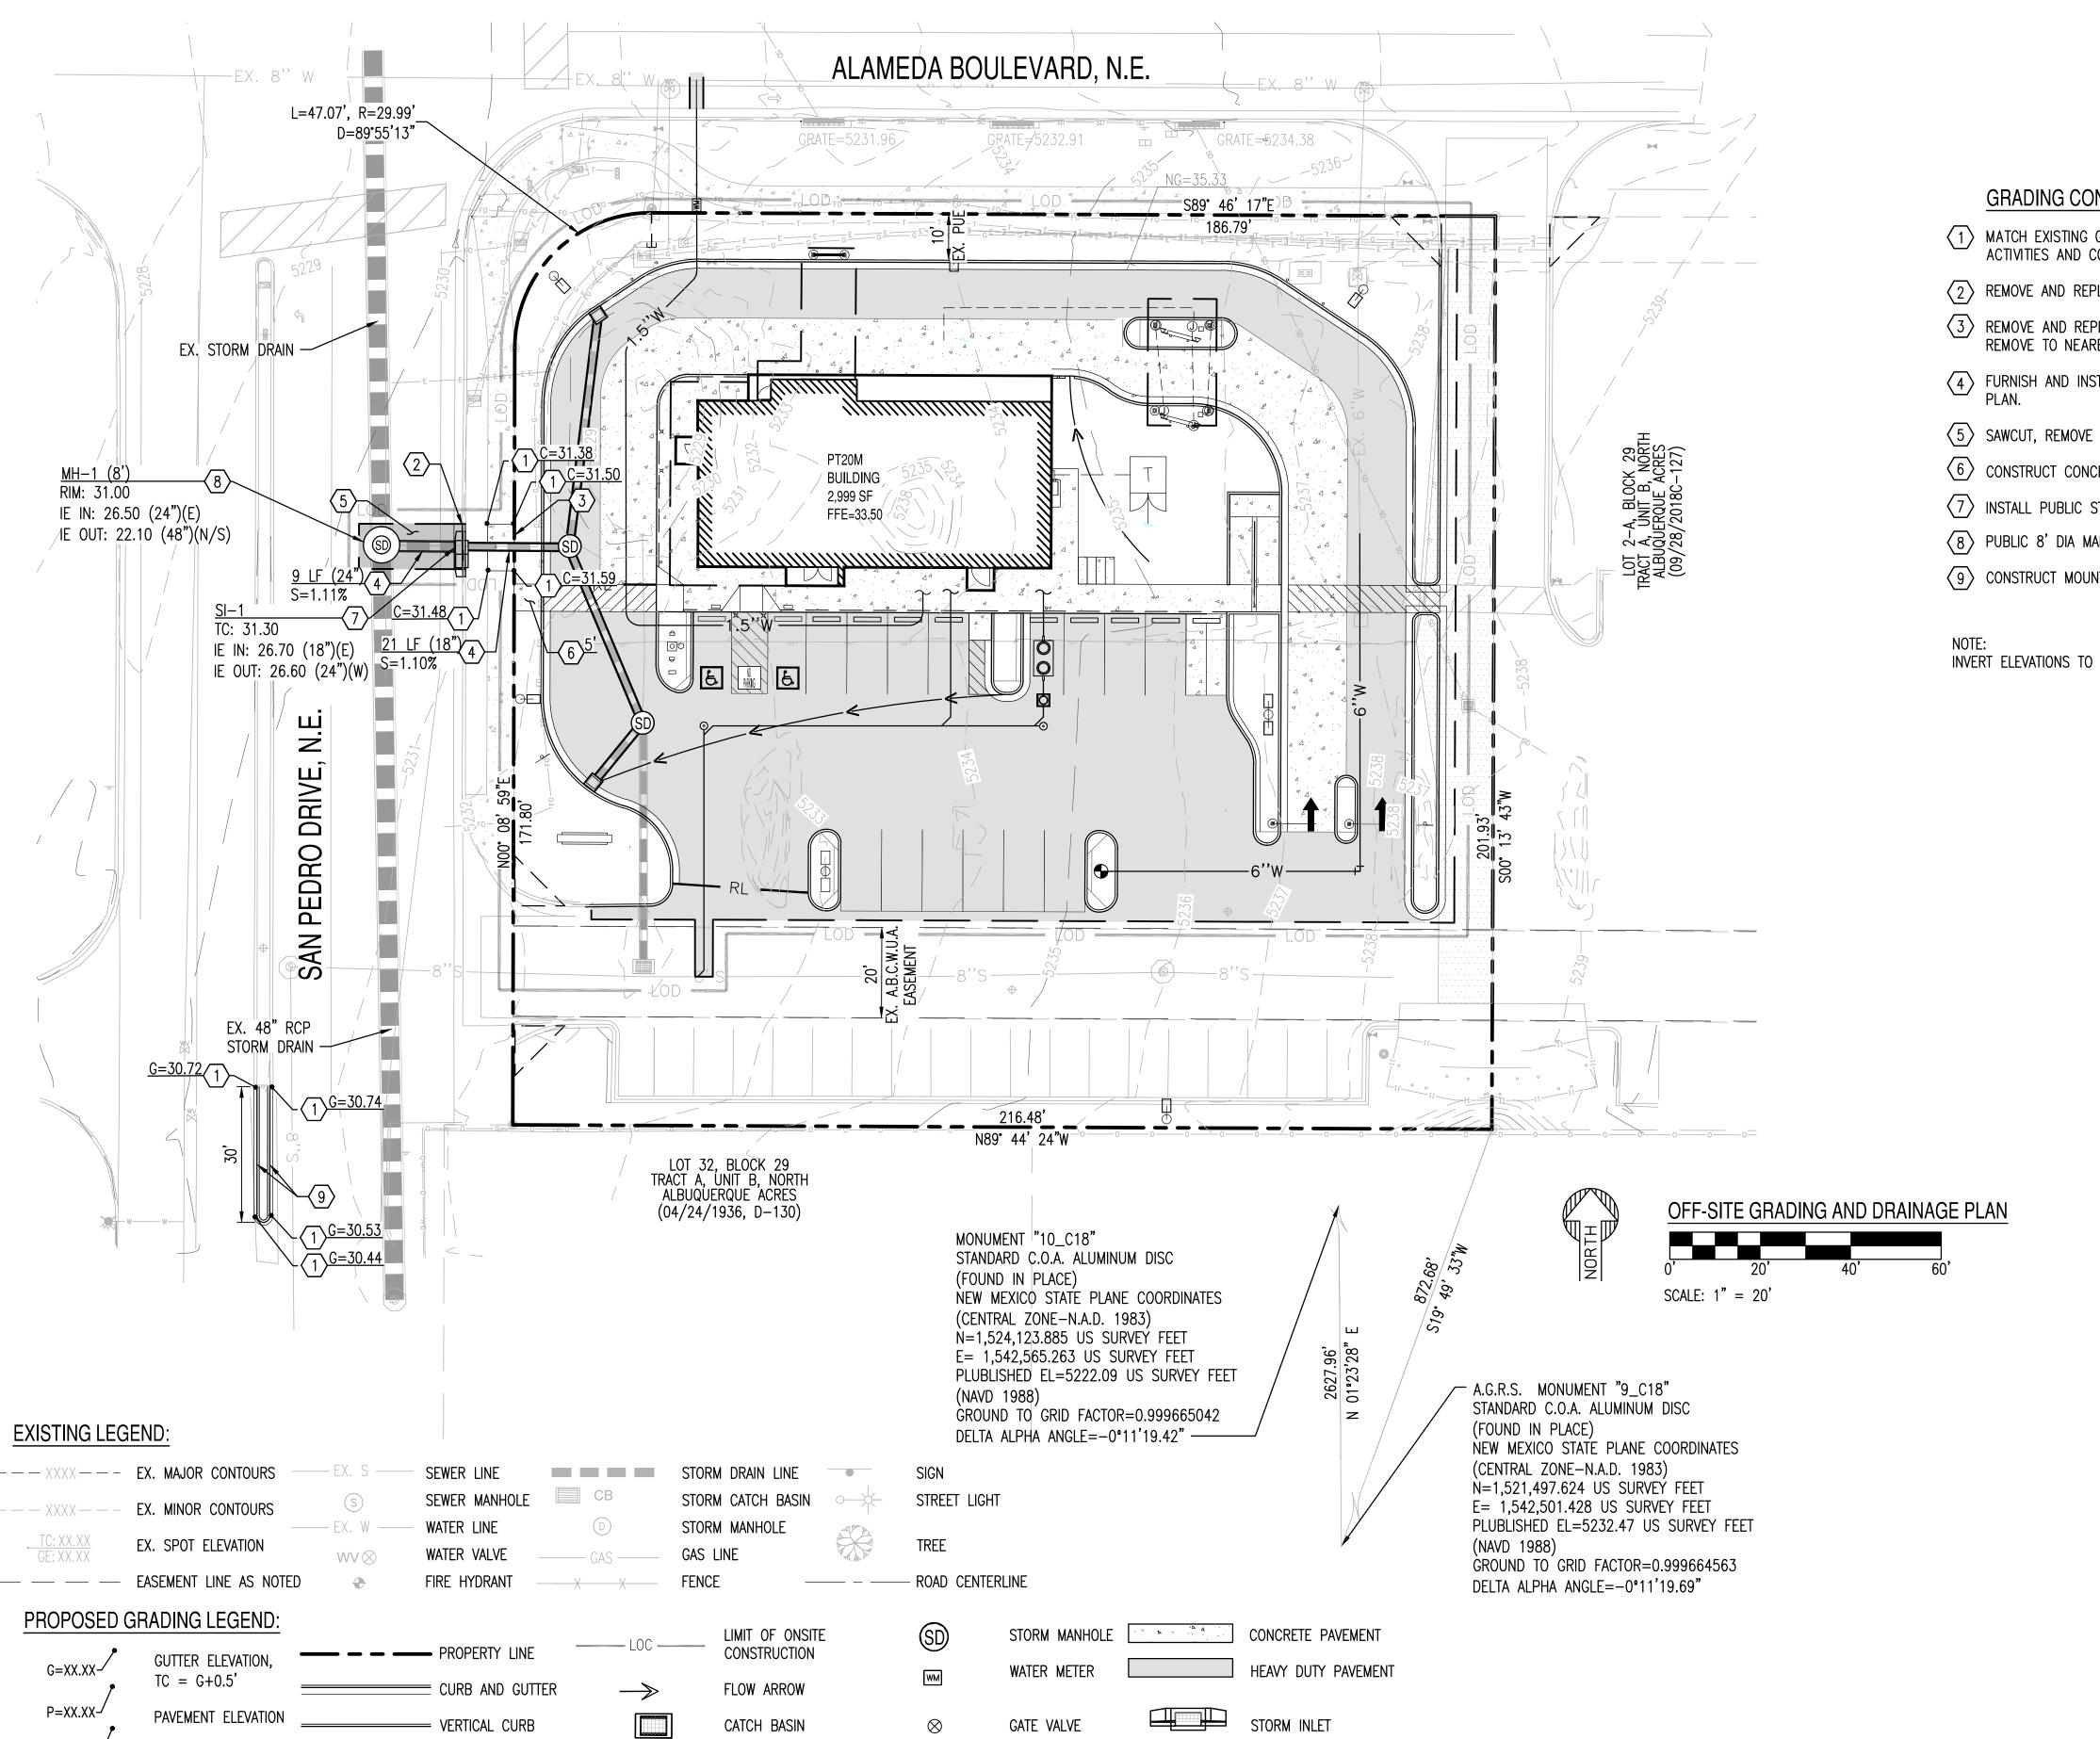


FIRE HYDRANT



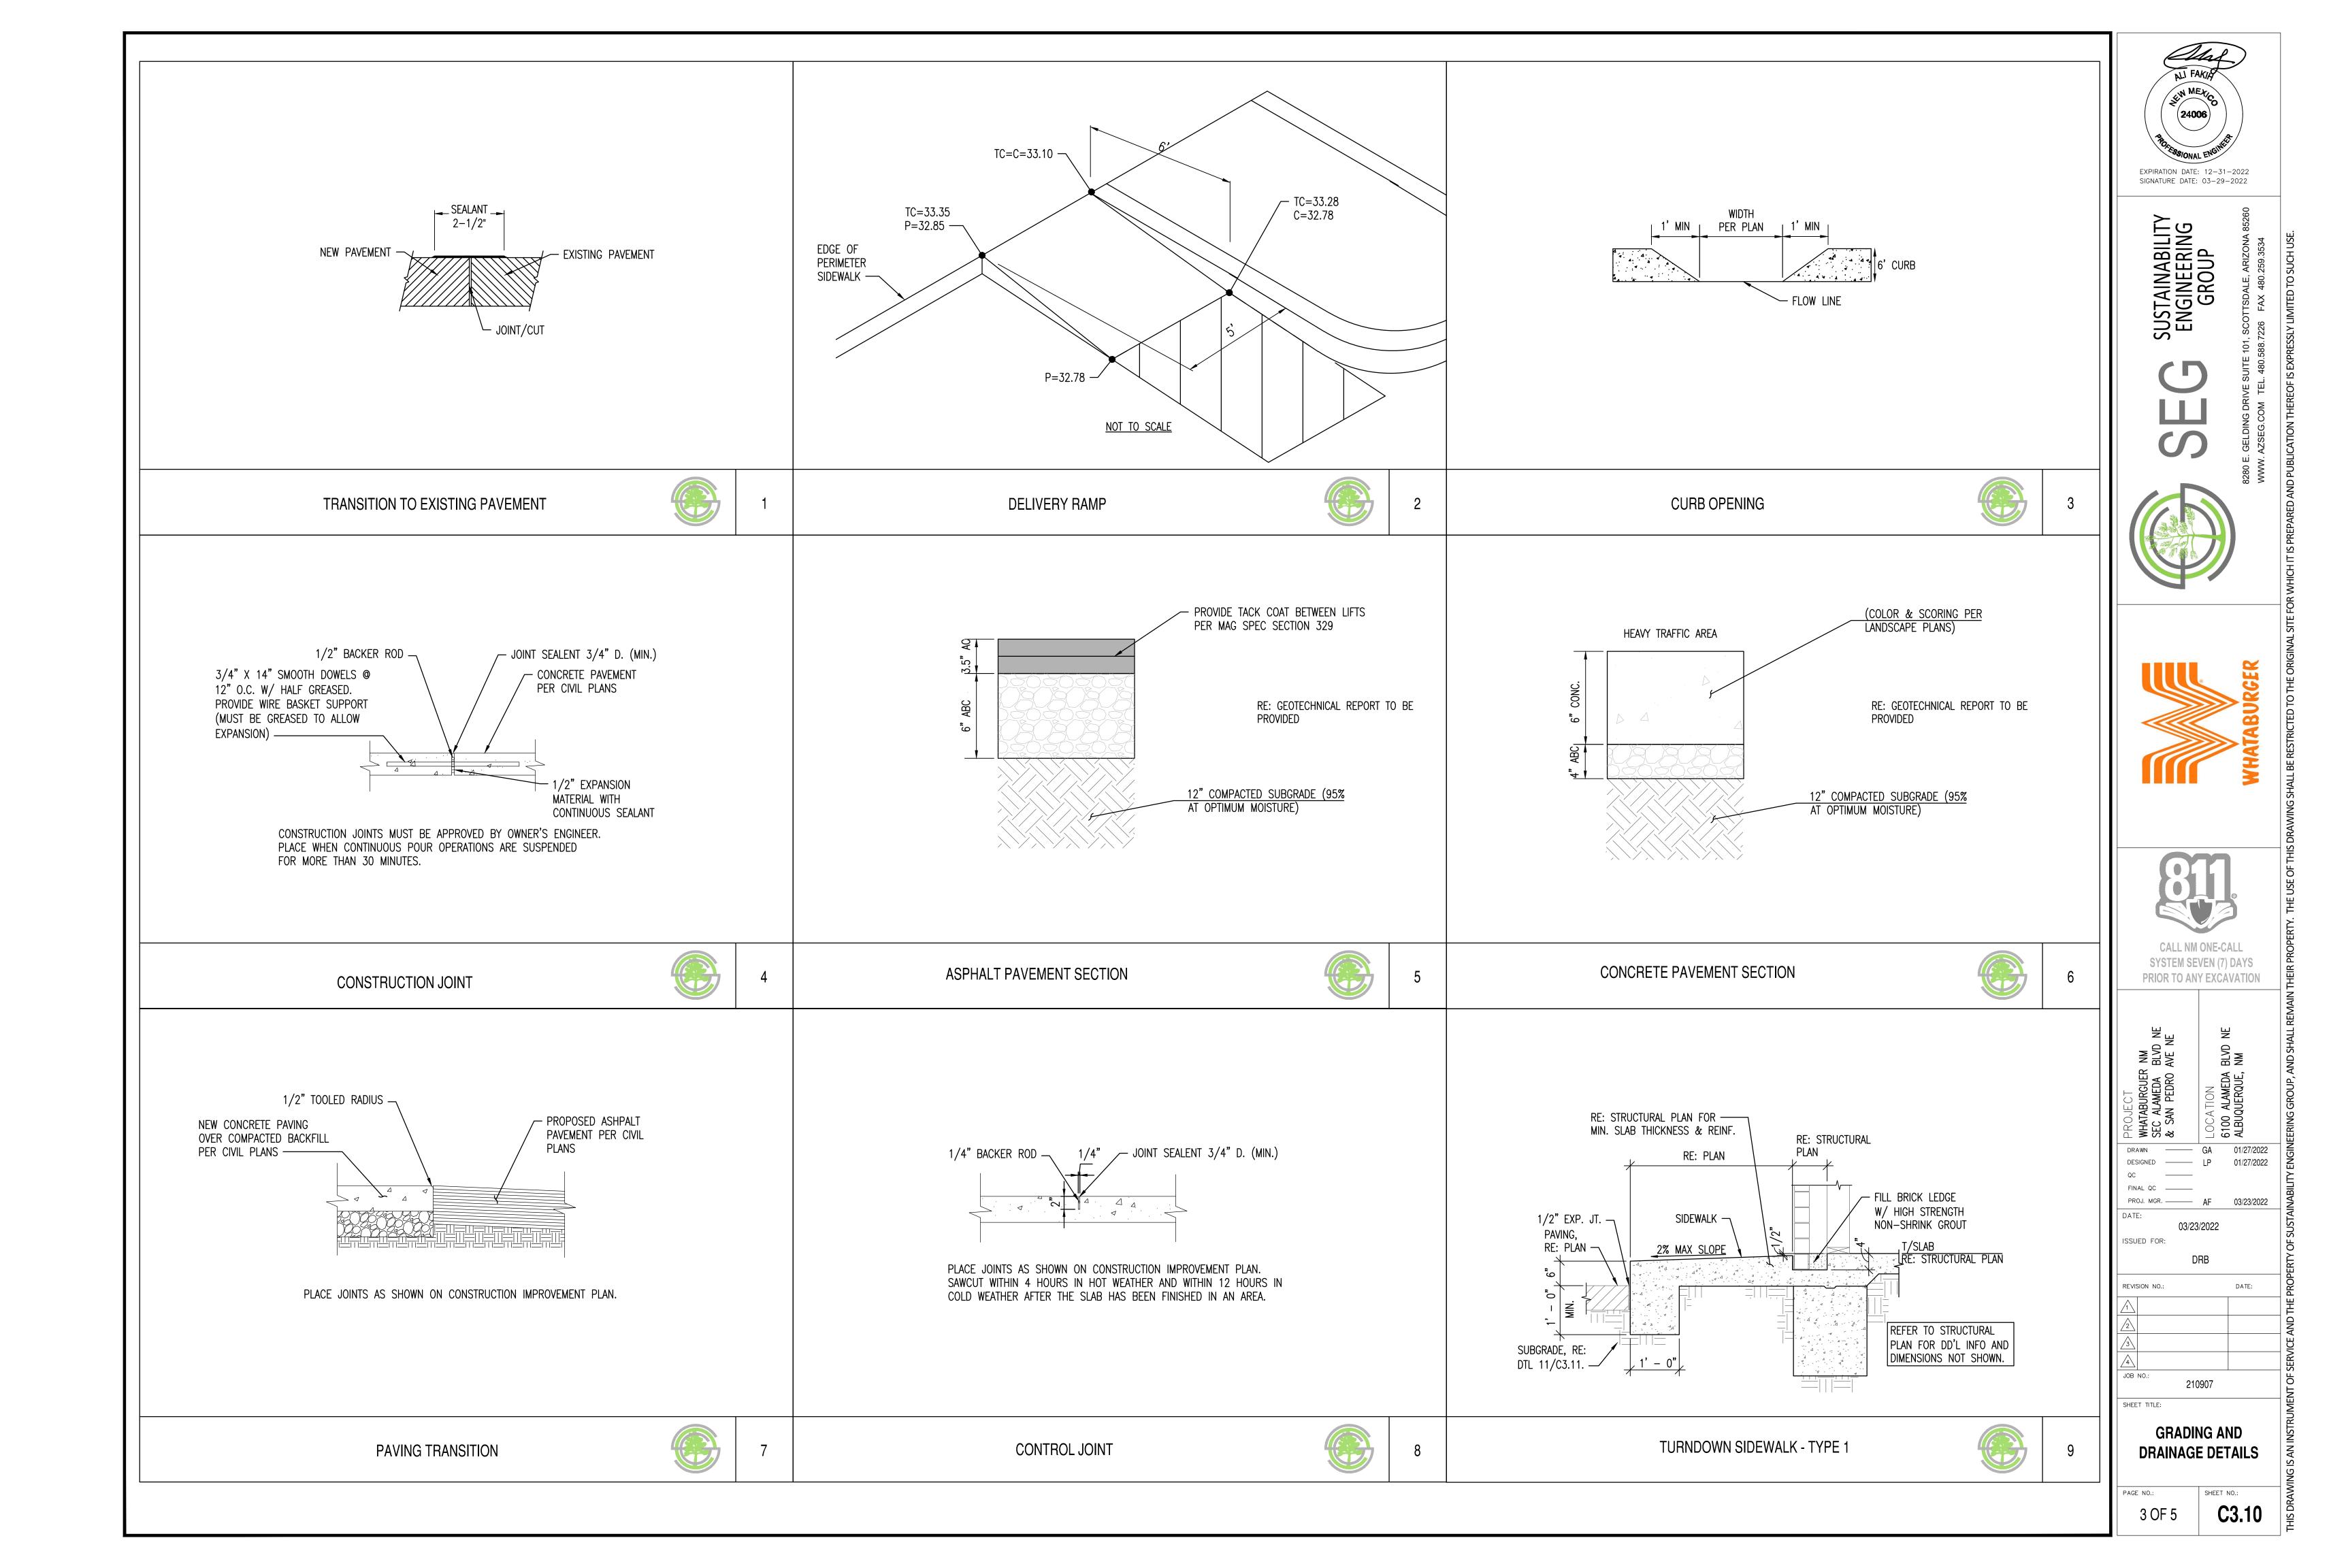

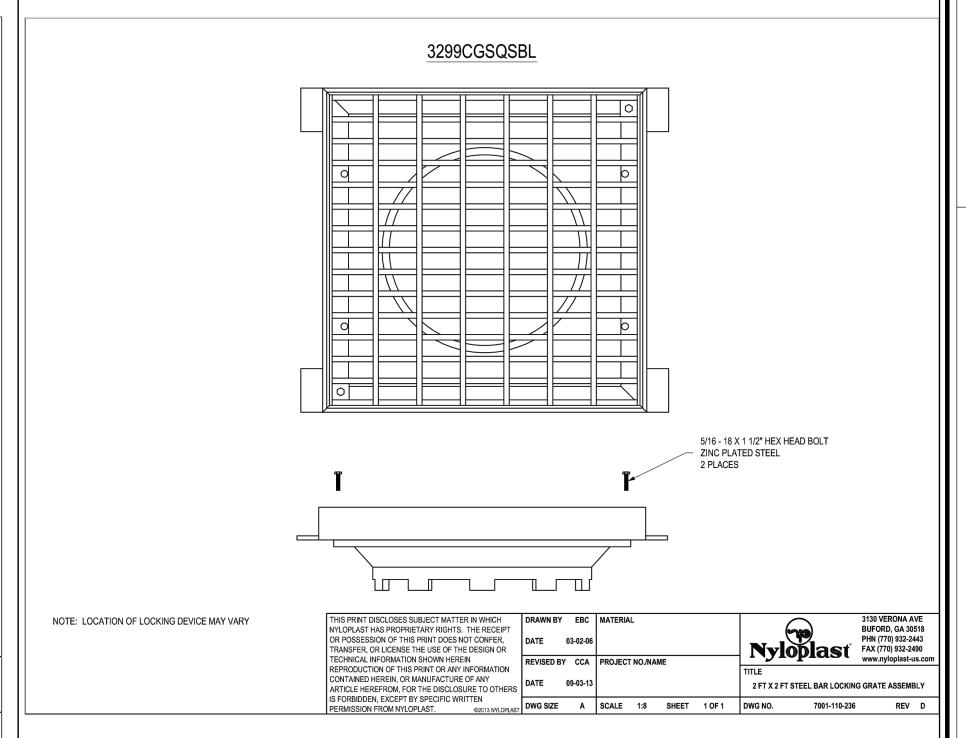

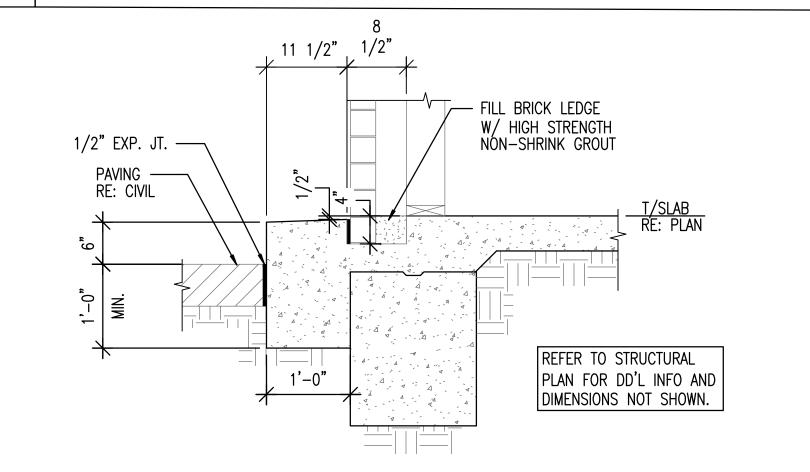

**NYLOPLAST GRATE** 

TURNDOWN SIDEWALK - TYPE 2



16

EXPIRATION DATE: 12-31-2022
SIGNATURE DATE: 03-29-2022


SUSTAINABILITY ENGINEERING GROUP

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14



AMEDA BLVD NE
PEDRO AVE NE
TON
LAMEDA BLVD NE

DRAWN AHATABURG

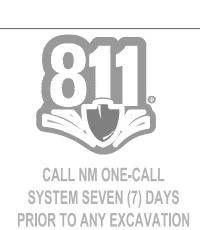DRAWN WHATABURG

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FINAL QC

PROJ. MGR. — AF 03/23/2022

DATE: 03/23/2022

ISSUED FOR:

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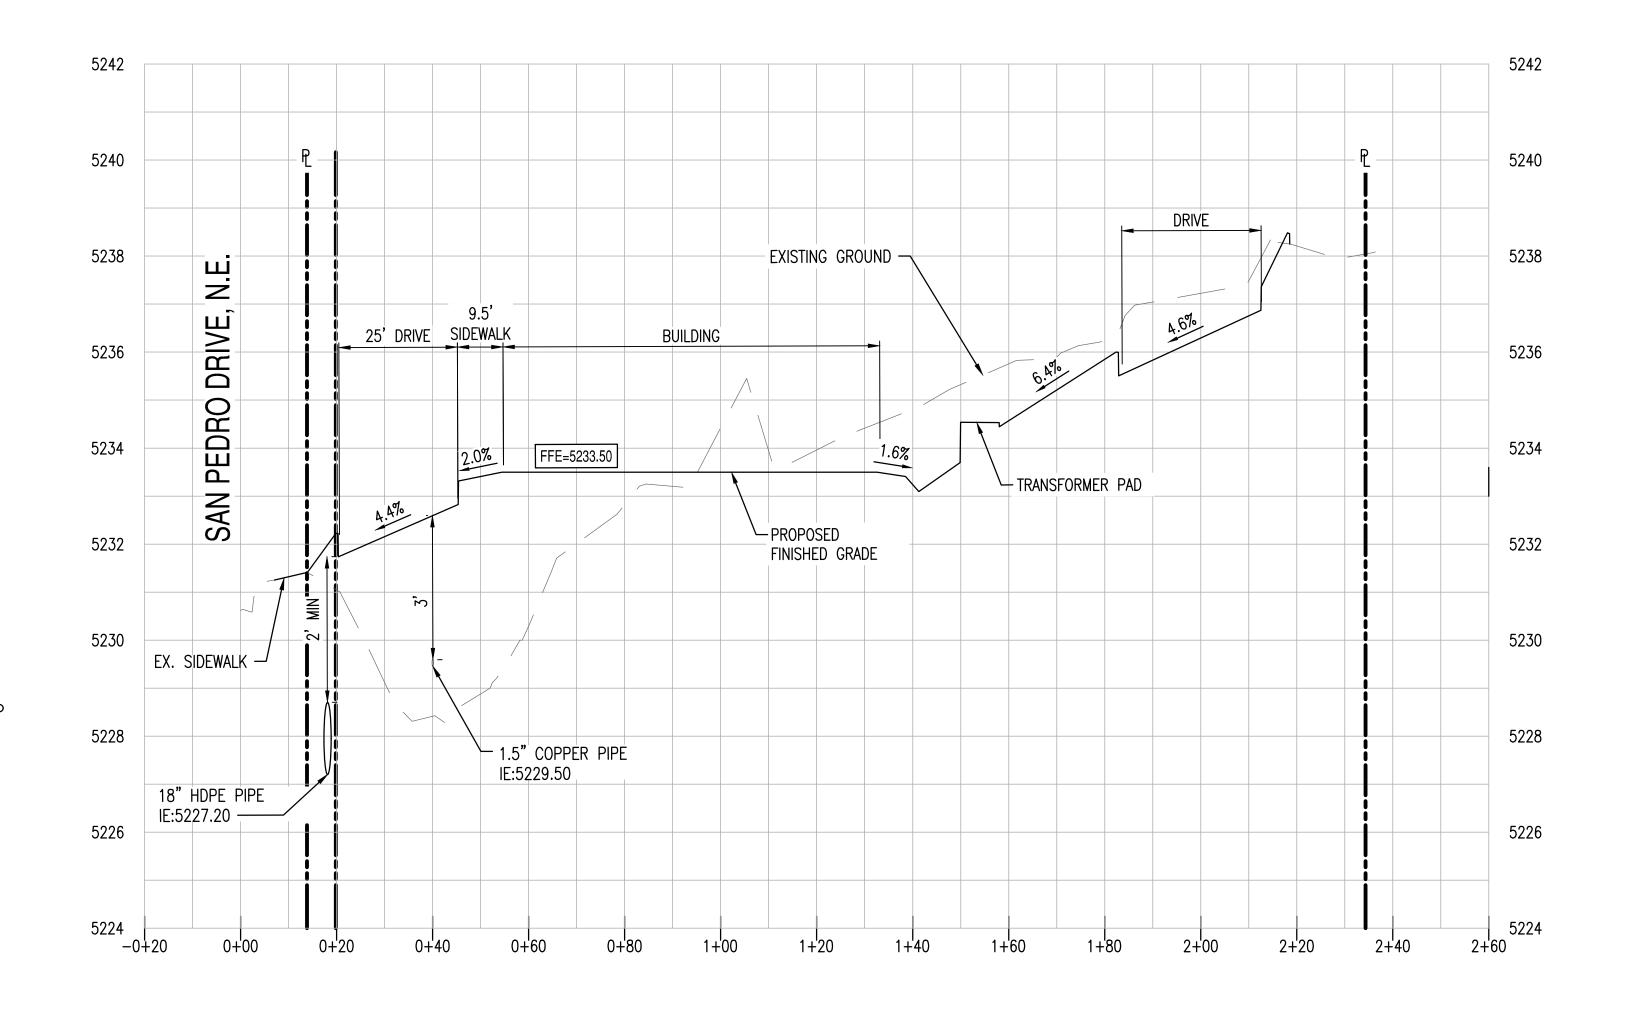
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REVISION NO.: DATE:

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JOB NO.:
210907


GRADING AND DRAINAGE DETAILS

4 OF 5 **C3.11** 



SECTION A-A C3.00

HORIZONTAL SCALE: 1" = 20'
VERTICAL SCALE: 1" = 2'

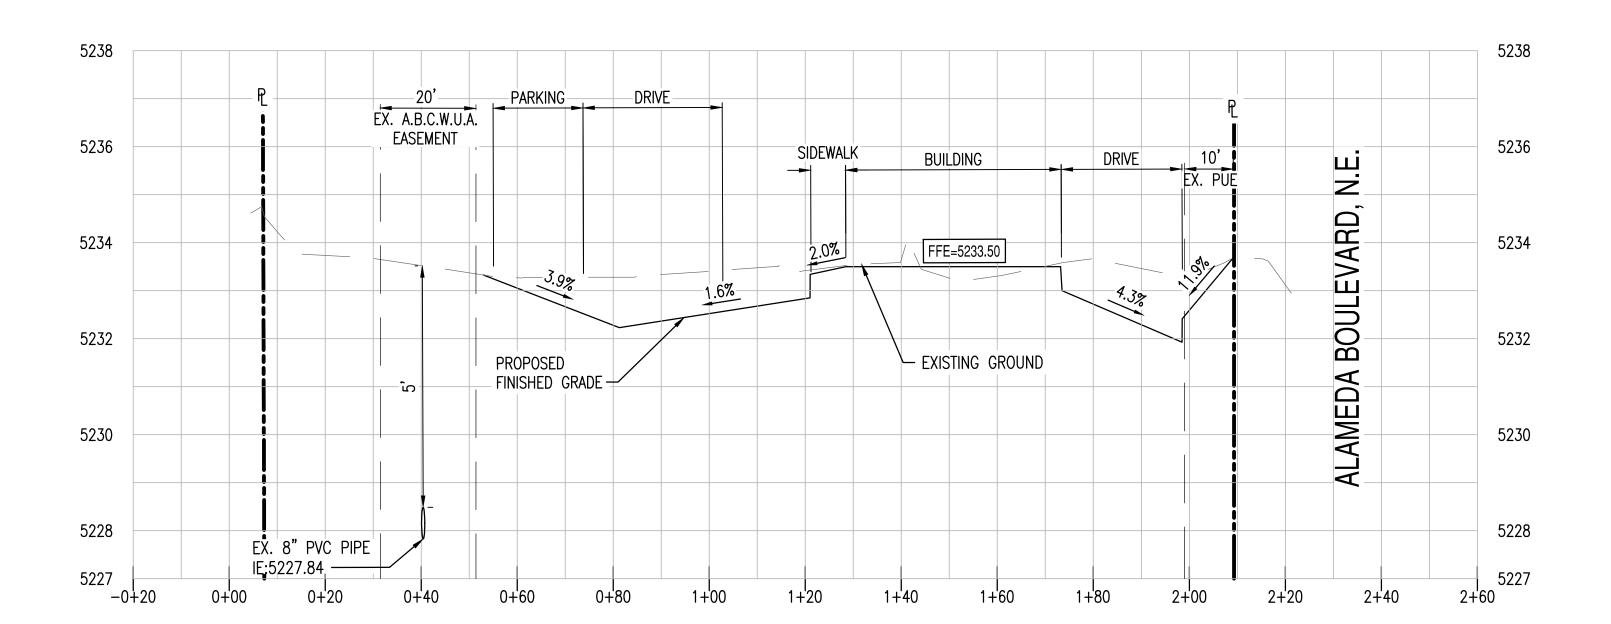

SECTION B-B C3.00

HORIZONTAL SCALE: 1" = 20'
VERTICAL SCALE: 1" = 2'



SUSTAINABILITY ENGINEERING GROUP









CALL NM ONE-CALL
SYSTEM SEVEN (7) DAYS
PRIOR TO ANY EXCAVATION

岁	뮏	
NM BLVD N AVE NE	BLVD NE	Σ
WHATABURGUER NM SEC ALAMEDA BLVD NE & SAN PEDRO AVE NE	LOCATION 6100 ALAMEDA	ALBUQUERQUE,
DRAWN ———	GA	01/27/
DESIGNED	LP	01/27/

DRAWN — GA 01/27/2022

DESIGNED — LP 01/27/2022

QC — FINAL QC — AF 03/23/2022

DATE: 03/23/2022 ISSUED FOR:

SUED FOR:

DRB

	REVISION NO.:		DATE:		
I	1				
I	2				
I	3				
I	4				
	JOB	NO.: <b>210907</b>			

SITE CROSS SECTIONS

SHEET TITLE:

5 OF 5 **C3.20** 

**DEVELOPER** 

WHATABRANDS REAL ESTATE CONTACT: CINDY ESPINOZA 300 CONCORD PLAZA DRIVE SAN ANTONIO, TX 78216 ATTN: CINDY ESPINOZA PHONE: 210-476-6180 EMAIL: CESPINOZA@WBHQ.COM

EXISTING LEGEND

—— – CENTERLINE

— — — EASEMENT LINE AS NOTED

CHAINLINKE FENCE

—— EX. S —

SEWER LINE

WATER LINE

WATER VALVE

FIRE HYDRANT

STORM DRAIN LINE

STORM MANHOLE

IRRIGATION LINE

GAS LINE

STORM CATCH BASIN

STREET LIGHT

—— FO —— FIBER OPTIC LINE

**CIVIL ENGINEER** SUSTAINABILITY ENGINEERING GROUP 8280 E. GELDING DR, SUITE 101 SCOTTSDALE, ARIZONA 85260 PHONE: 480-237-2507 ATTN. ALI FAKIH


**OWNER** GREEN JEANS WEST, LLC 2929 MONTE VISTA NE ALBUQUERQUE, NM 87106

# WHATABURGER PRELIMINARY UTILITY PLAN


6100 NE ALAMEDA BLVD, ALBUQUERQUE, NM A PORTION OF SECTION 13, TOWNSHIP 11 NORTH, RANGE 3 EAST, BERNALILLO COUNTY, NEW MEXICO.


GROUND TO GRID FACTOR=0.999664563

DELTA ALPHA ANGLE=-0°11'19.69"

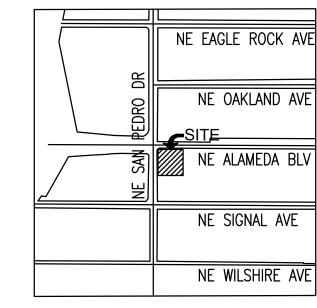



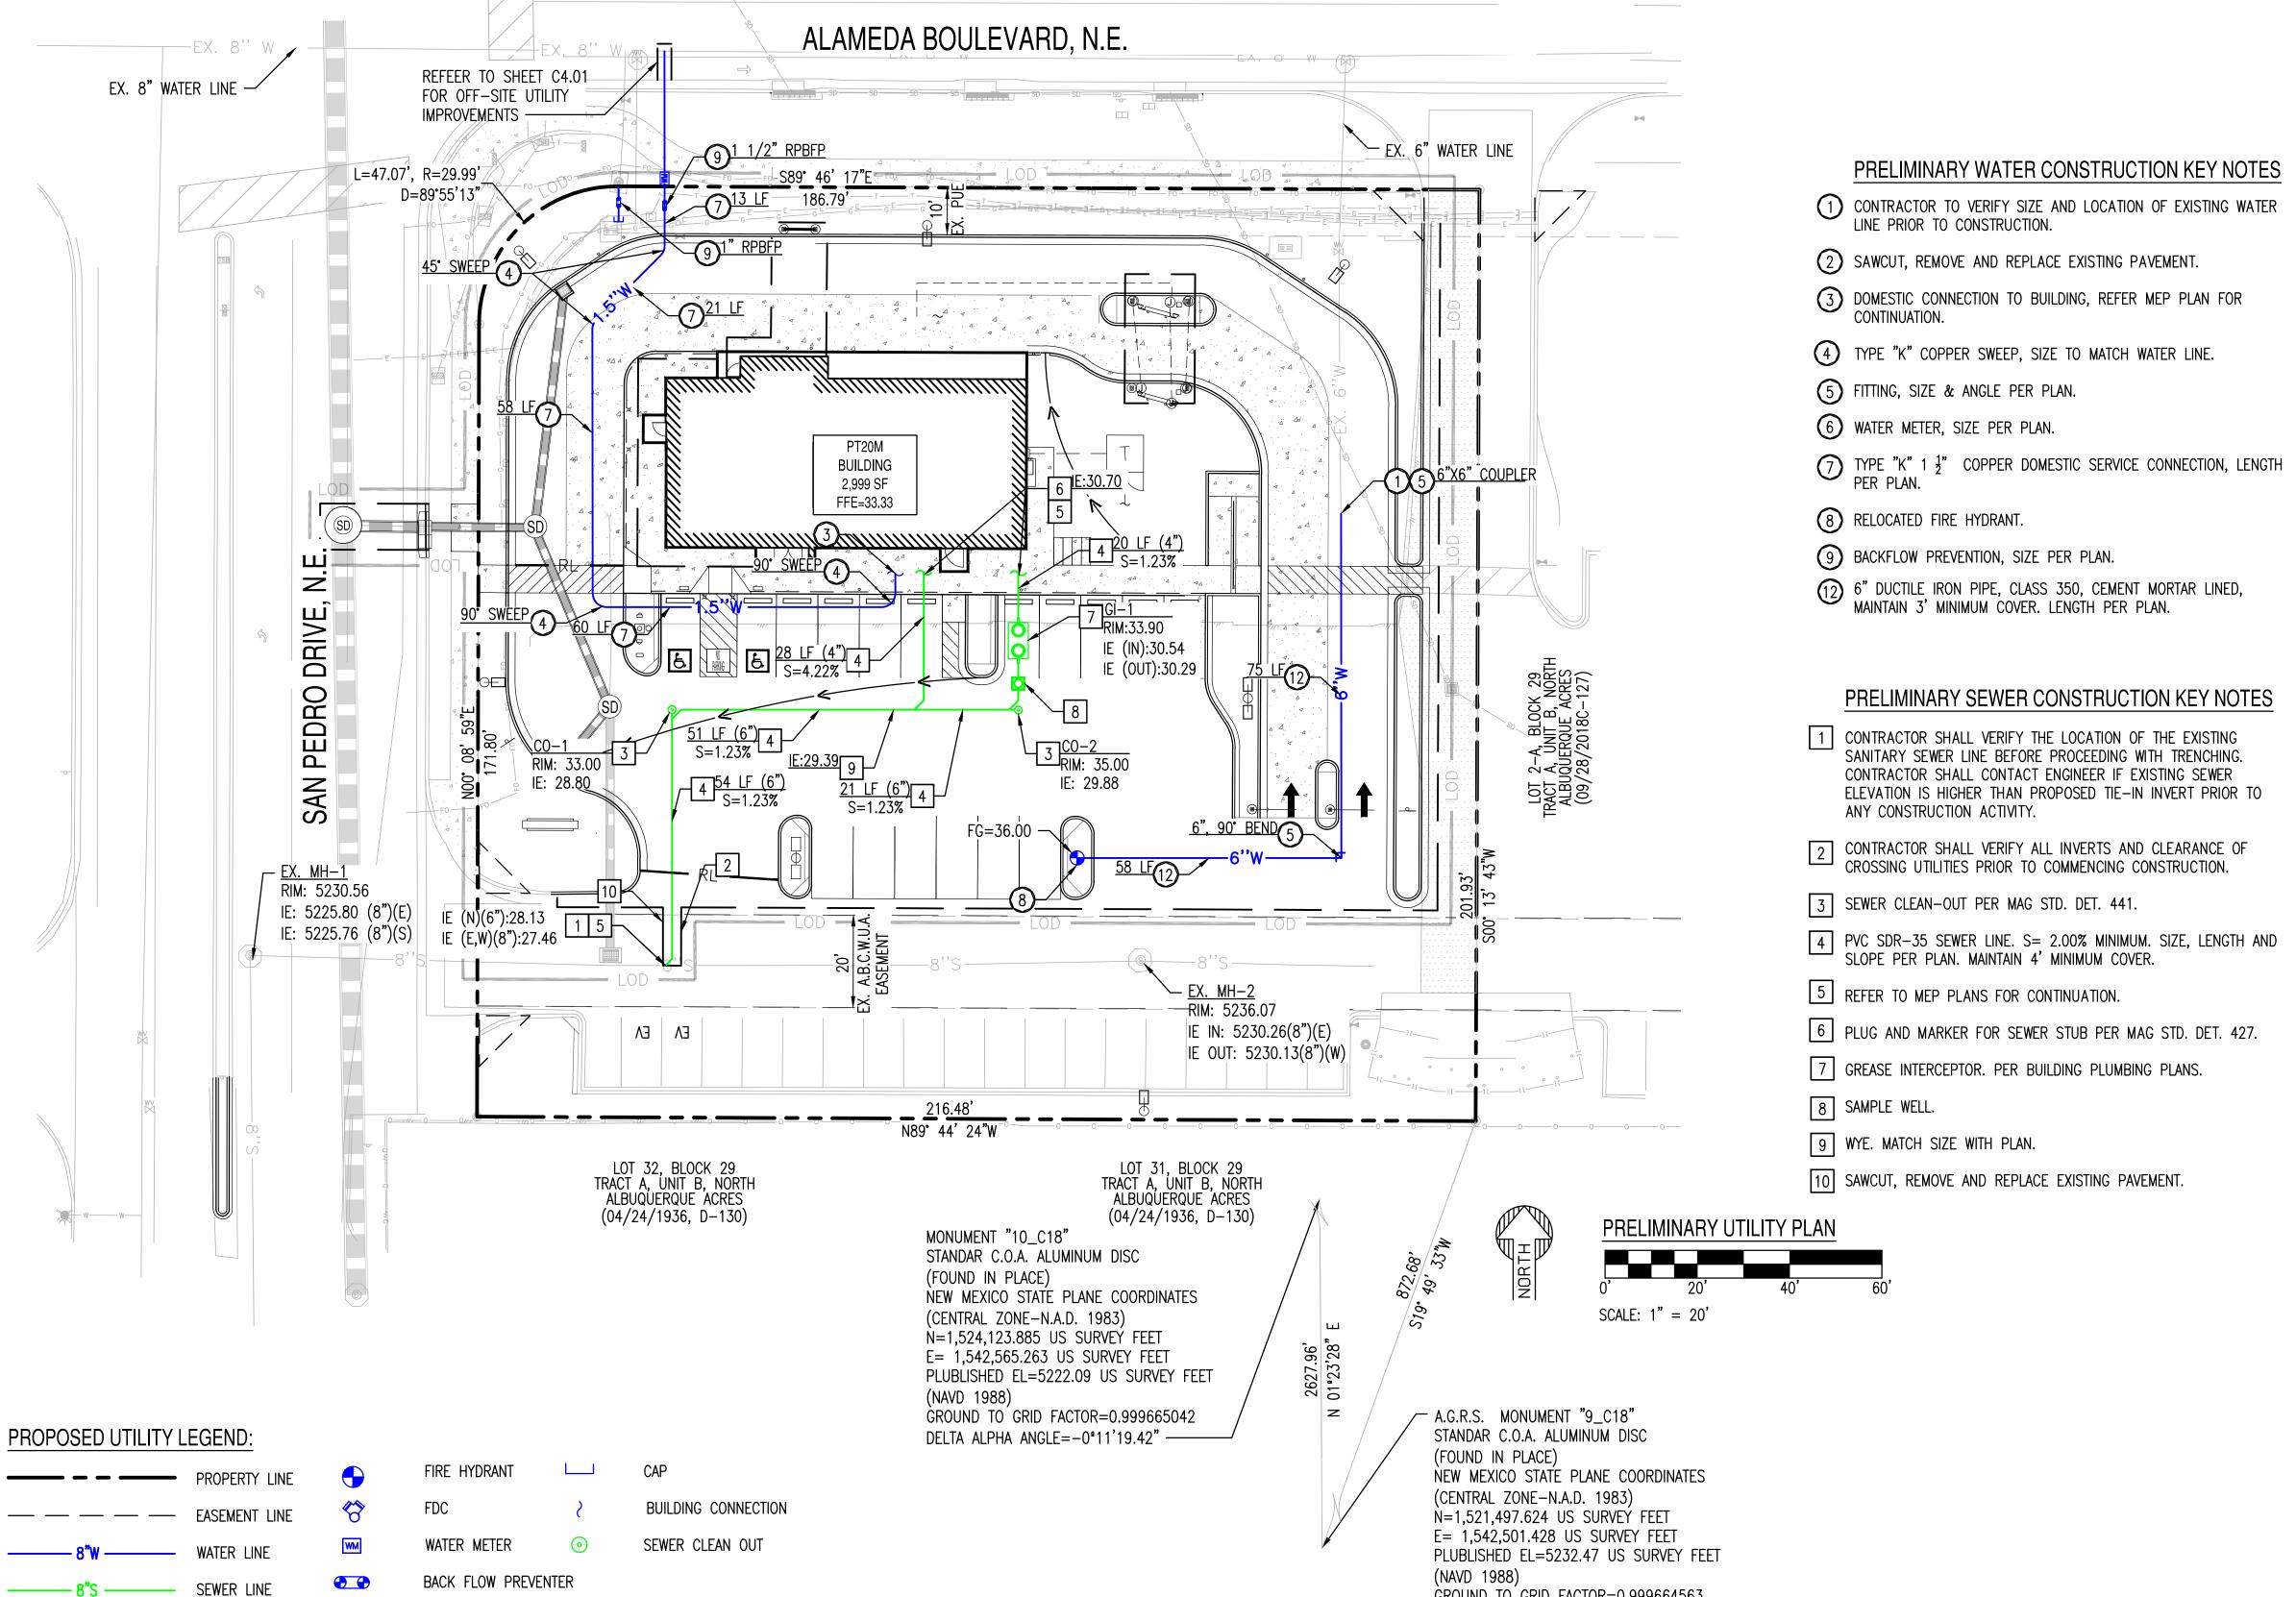

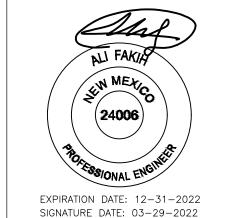

SUSTAINABILITY ENGINEERING GROUP







CALL NM ONE-CALL SYSTEM SEVEN (7) DAYS PRIOR TO ANY EXCAVATION

PROJECT WHATABURGUER NM SEC ALAMEDA BLVI & SAN PEDRO AVE	LOCATION 6100 ALAMEDA BLVI	$\boldsymbol{\sigma}$
DRAWN	GA	01/27/2022
DESIGNED	LP	01/27/2022
QC		
FINAL QC		
PROJ. MGR. ———	AF	03/23/2022
DATE:		
03/23	/2022	

ISSUED FOR:

REVISION NO.:	DATE:
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2	
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JOB NO.: 21090	 7

PRELIMINARY UTILITY

C4.00

EMAIL: CESPINOZA@WBHQ.COM


**OWNER** GREEN JEANS WEST, LLC 2929 MONTE VISTA NE ALBUQUERQUE, NM 87106


# WHATABURGER PRELIMINARY OFF-SITE UTILITY PLAN

6100 NE ALAMEDA BLVD, ALBUQUERQUE, NM A PORTION OF SECTION 13, TOWNSHIP 11 NORTH, RANGE 3 EAST, BERNALILLO COUNTY, NEW MEXICO.

GROUND TO GRID FACTOR=0.999664563


DELTA ALPHA ANGLE=-0°11'19.69"

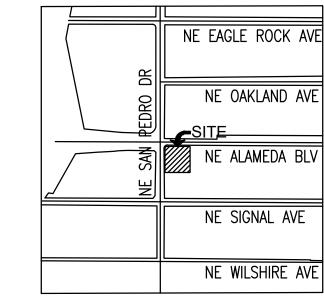

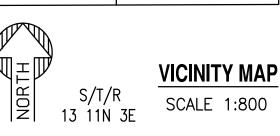

### PRELIMINARY WATER CONSTRUCTION KEY NOTES

- 1 CONTRACTOR TO VERIFY SIZE AND LOCATION OF EXISTING WATER LINE PRIOR TO CONSTRUCTION.
- 2 SAWCUT, REMOVE AND REPLACE EXISTING PAVEMENT.
- (6) WATER METER, SIZE PER PLAN.
- TYPE "K" 1  $\frac{1}{2}$ " COPPER DOMESTIC SERVICE CONNECTION, LENGTH PER PLAN.
- (10) REMOVE AND REPLACE EXISTING VERTICAL CURB AND GUTTER.
- (11) REMOVE AND REPLACE EXISTING SIDEWALK.

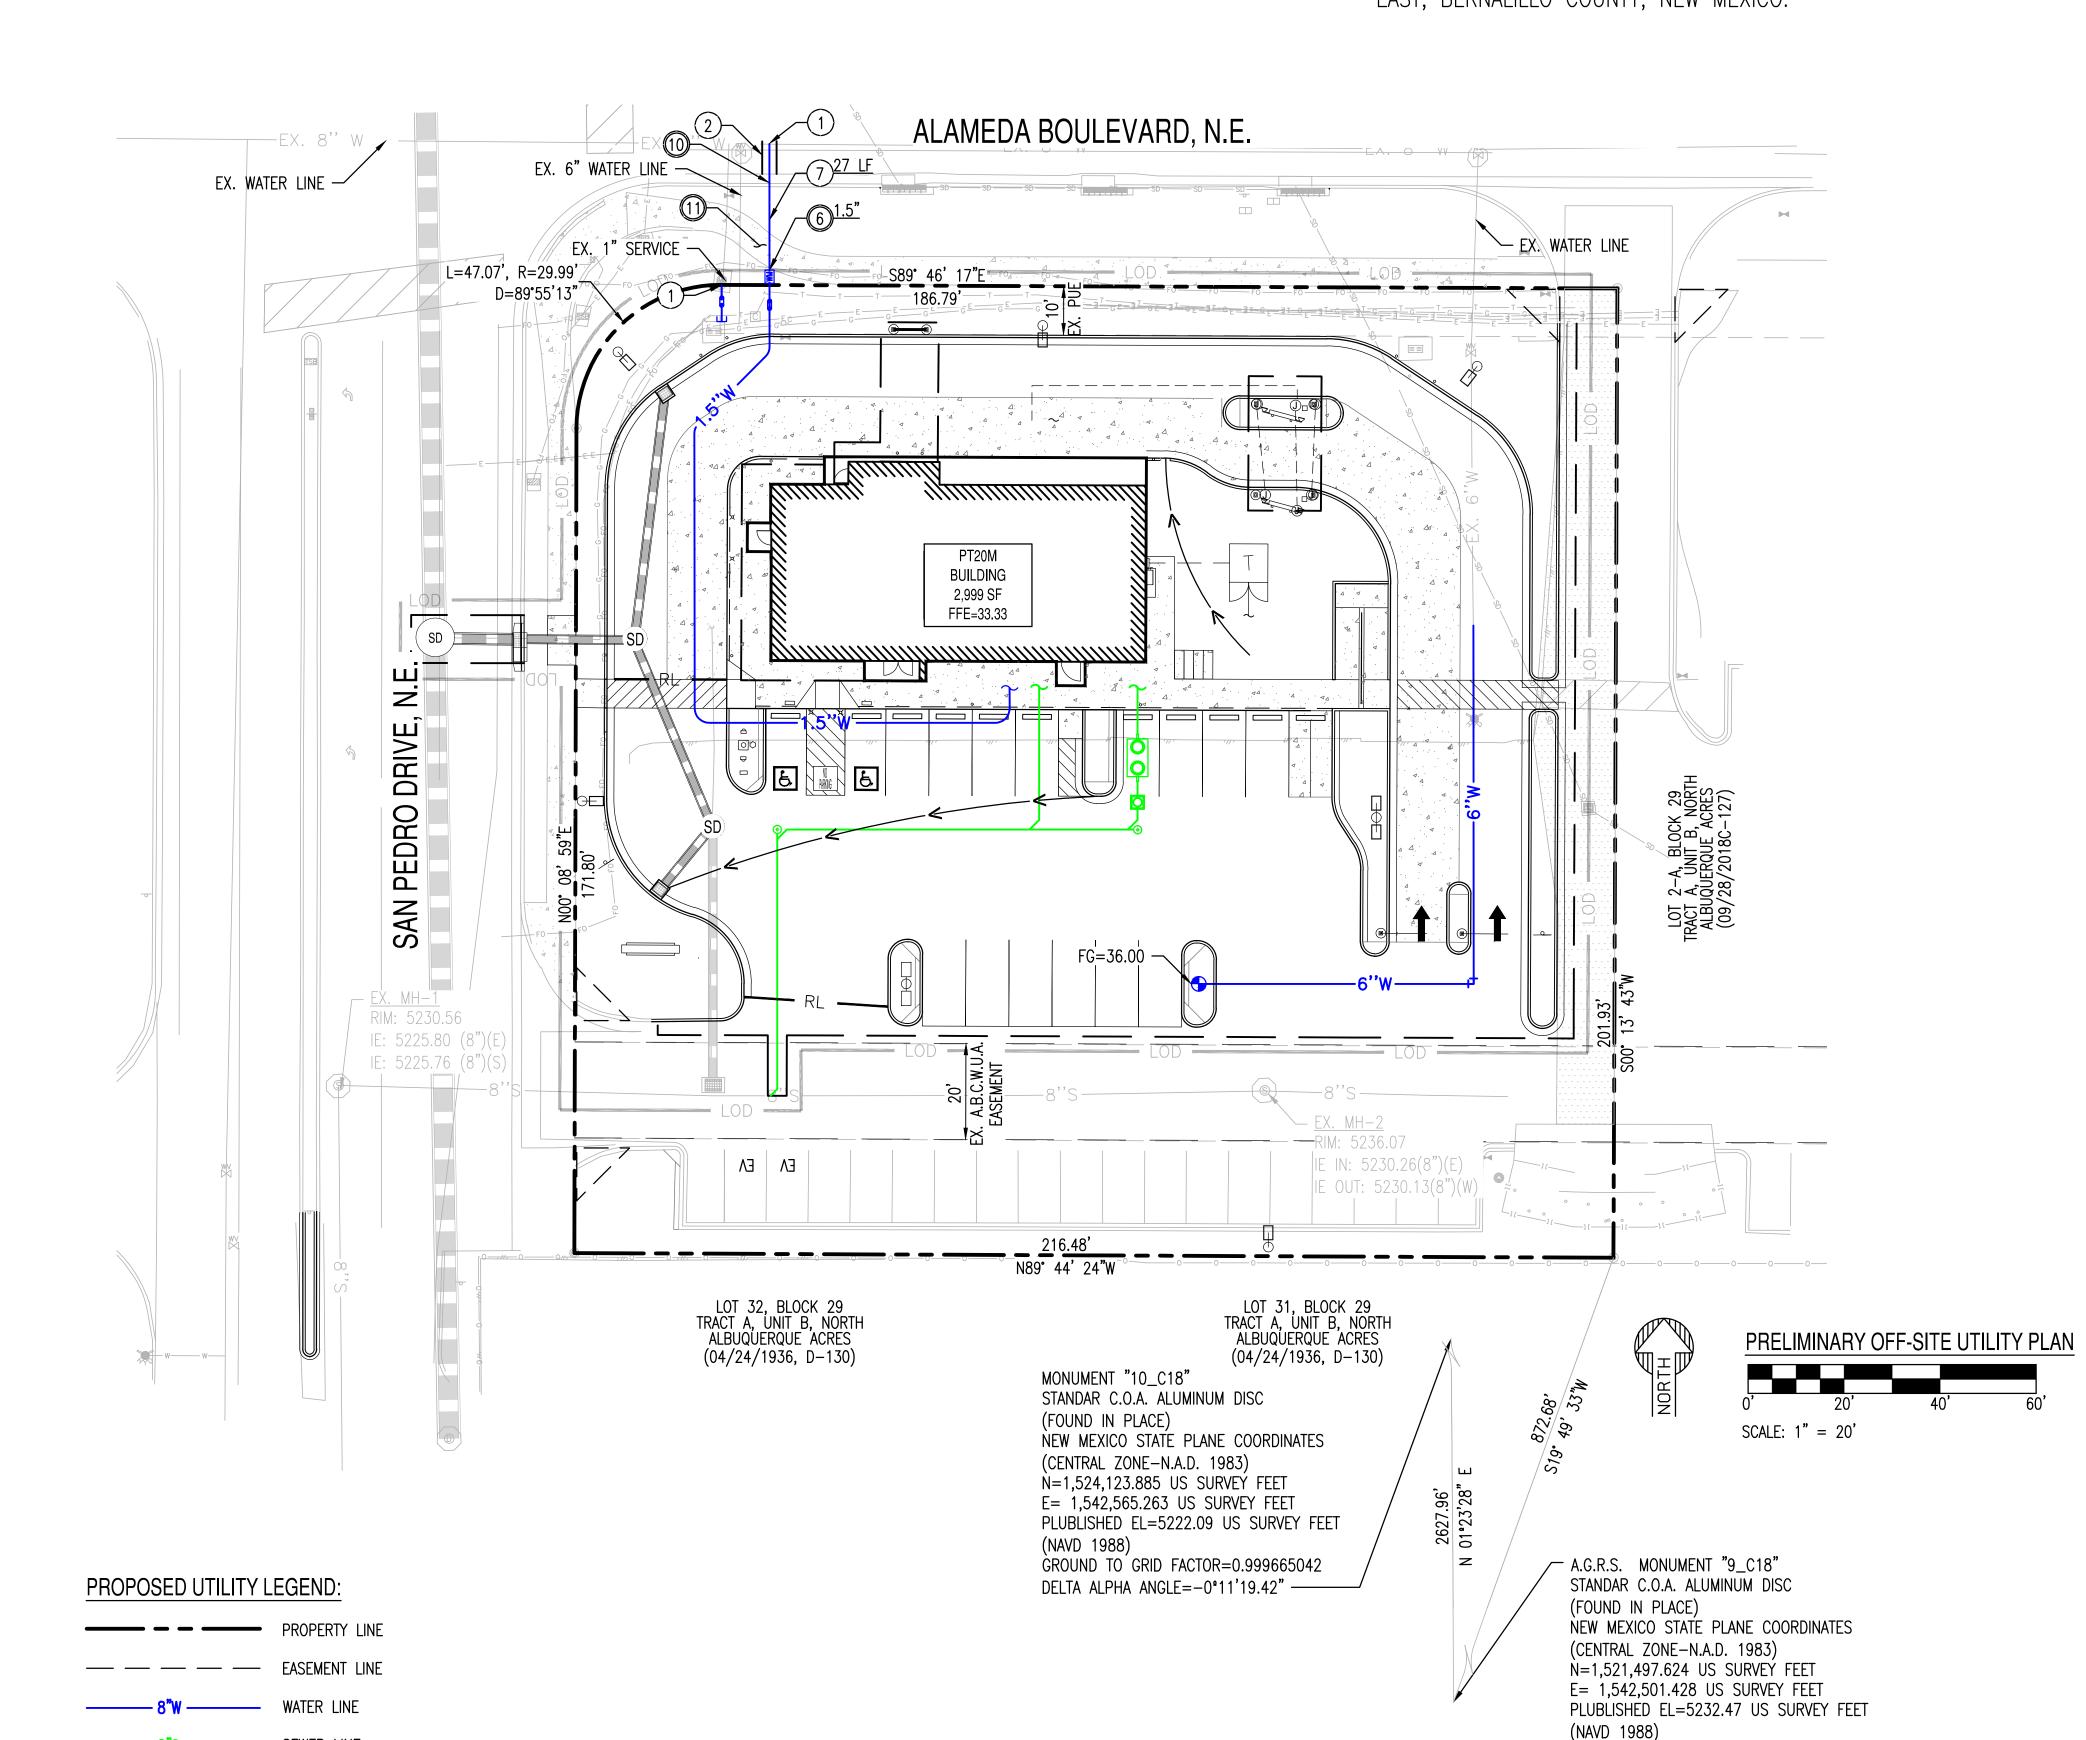

CALL NM ONE-CALL SYSTEM SEVEN (7) DAYS PRIOR TO ANY EXCAVATION

DESIGNED BY: SO DRAWN BY: ER CHECKED BY: SC 03/2022

EXPIRATION DATE: 12-31-2022

SIGNATURE DATE: 03-29-2022



CITY OF ALBUQUERQUE DEPARTMENT OF MUNICIPAL DEVELOPMENT ENGINEERING DIVISION

SHEET NO.

C4.01

PRELIMINARY OFF-SITE

DESIGN REVIEW COMMITTEE | CITY ENGINEER APPROVAL | ZONE MAP NO. **Z-99** CITY PROJECT NO. 000000

UTILITY PLAN

8"S — SEWER LINE

— — — EASEMENT LINE AS NOTED

CHAINLINKE FENCE

----- CENTERLINE

—— EX. S ——

SEWER LINE

WATER LINE

WATER VALVE

FIRE HYDRANT

STORM DRAIN LINE

STORM MANHOLE

IRRIGATION LINE

GAS LINE

STORM CATCH BASIN

STREET LIGHT

—— FO —— FIBER OPTIC LINE

**EXISTING LEGEND:**