







MENAUL BLVD

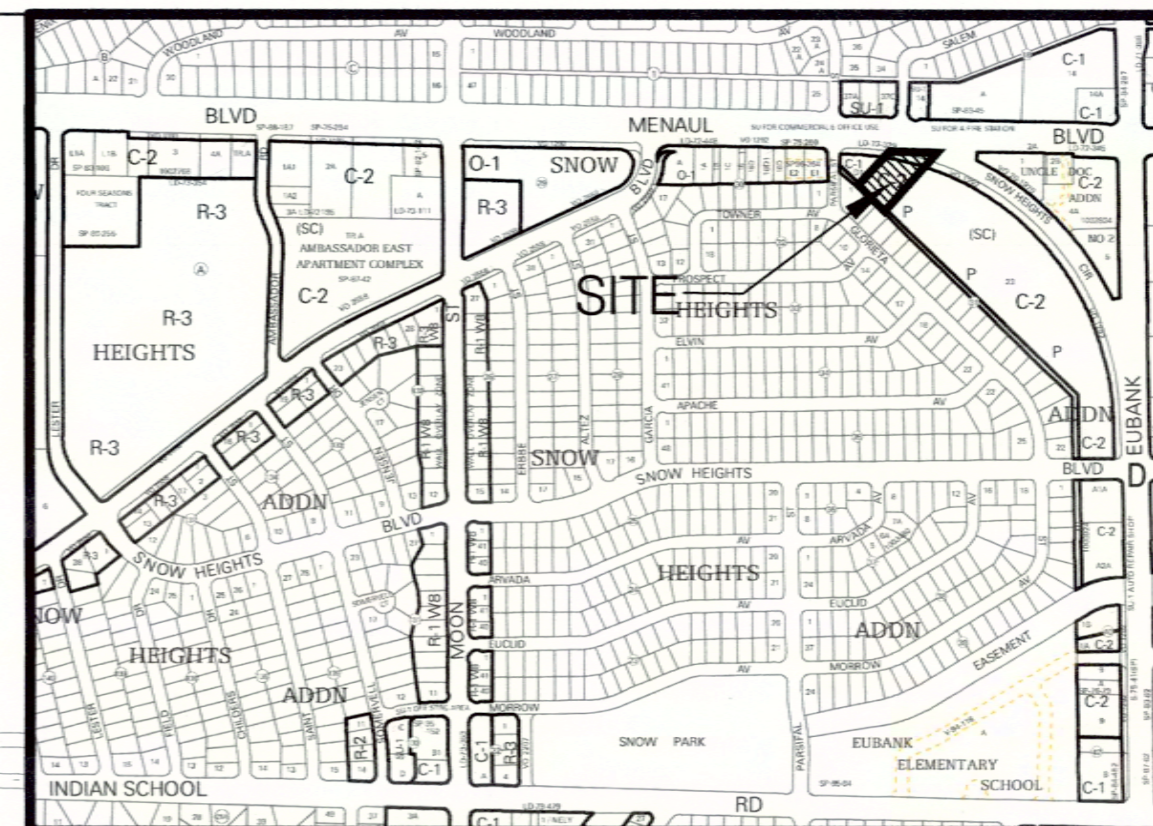


VICINITY MAP

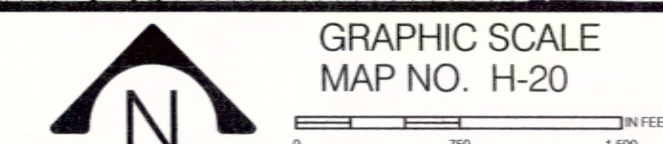

DRB SUBMITTAL

SITE PLAN

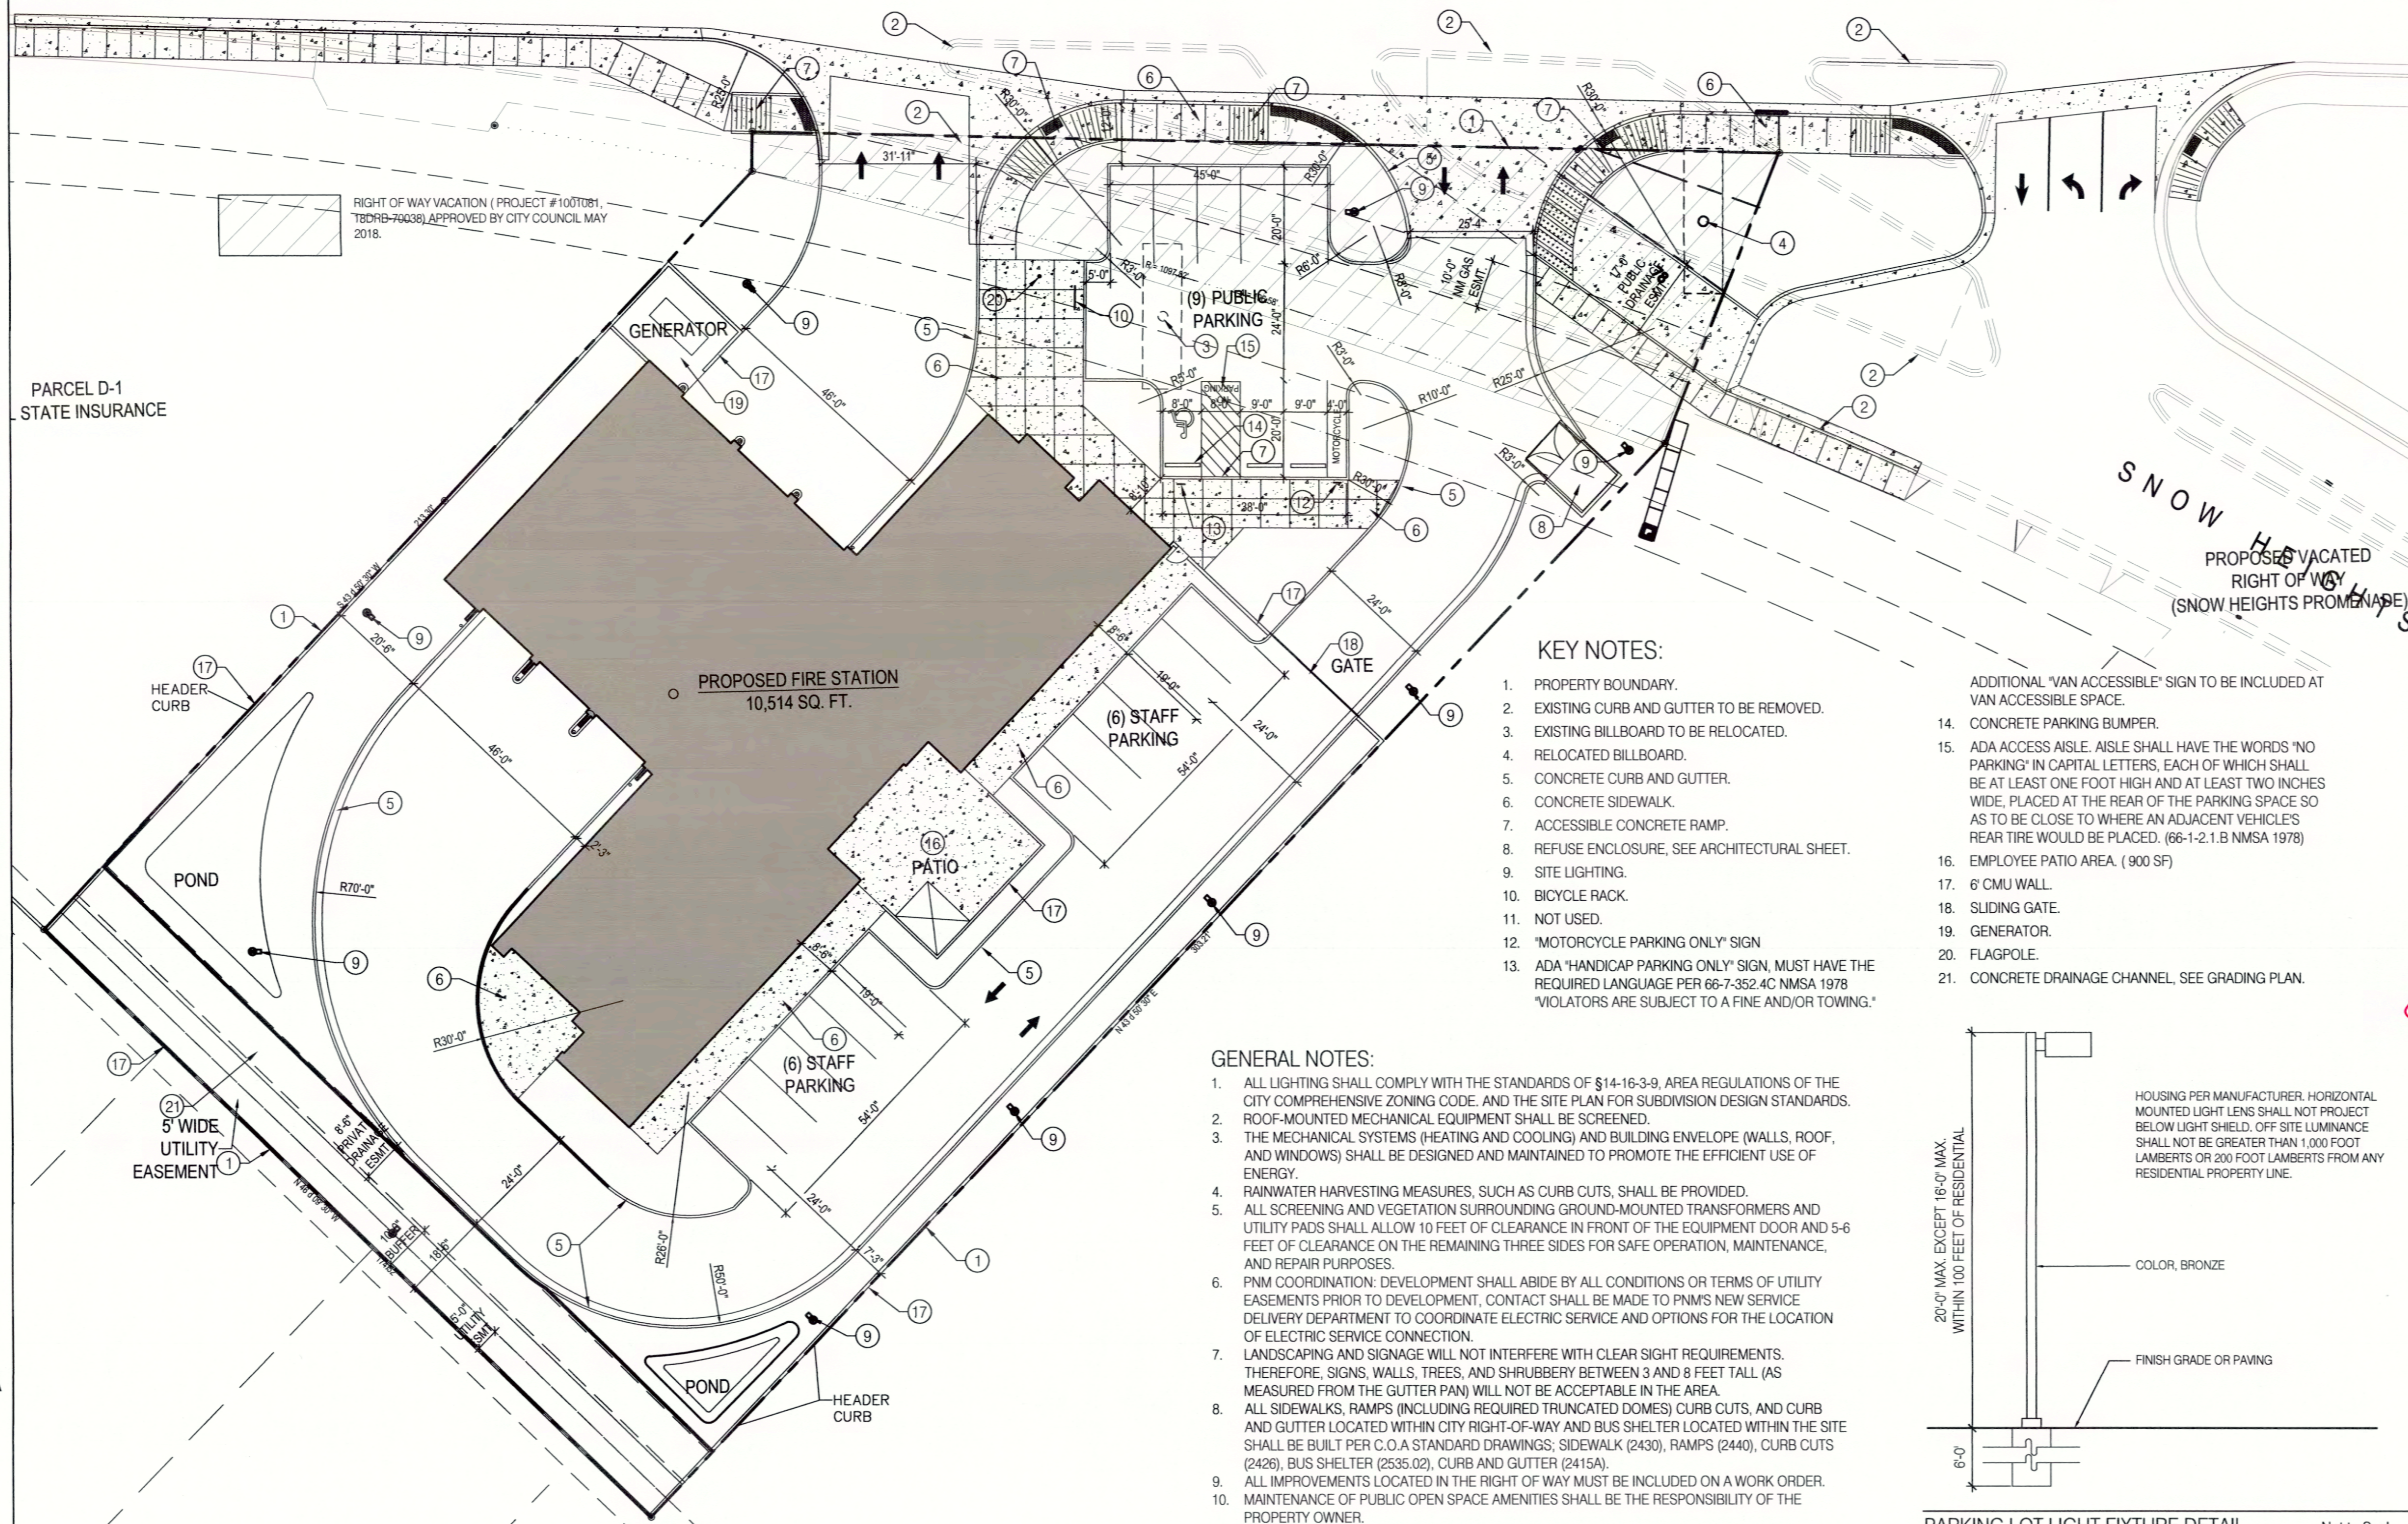

SITE DATA:

LEGAL DESCRIPTION: PORTION OF PARCEL D WITHIN LOT 23 BLOCK 31 SNOW HEIGHTS ADDITION  
 ADDRESS: 9500 SNOW HEIGHTS CIRCLE NE  
 TOTAL SITE AREA: 1.24 ACRES (INCLUDES VACATED R-O-W)  
 EXISTING ZONING: C-2 PROPOSED ZONING: SU-1 FOR FIRE STATION  
 LAND USE: COA FIRE STATION #9  
 BUILDING AREA: 10,731 S.F.  
 PARKING: PUBLIC PARKING REQUIREMENT CALCULATED AT 1 SPACE PER EVERY 4 SEATS IN THE PUBLIC MEETING ROOM.

PUBLIC PARKING SPACES REQUIRED/PROVIDED:	8/8
STAFF PARKING SPACES:	12
HANDICAPPED REQUIRED/PROVIDED:	1/1
TOTAL PROVIDED PARKING:	21
MOTORCYCLE REQUIRED/PROVIDED:	1/1
BICYCLE REQUIRED/PROVIDED:	1/3

PROJECT NUMBER: 1001081  
 Application Number: 18EPC-40037

This Plan is consistent with the specific Site Development Plan approved by the Environmental Planning Commission (EPC), dated October 11, 2018 and the Findings and Conditions in the Official Notification of Decision are satisfied.

Is an Infrastructure List required? (X) Yes ( ) No If yes, then a set of approved DRC plans with a work order is required for any construction within Public Right-of-Way or for construction of public improvements.

DRB SITE DEVELOPMENT PLAN SIGNOFF APPROVAL:

Traffic Engineering, Transportation Division	Date
ABCWUA	Date
Parks and Recreation Department	Date
City Engineer	Date
Solid Waste Management	Date
Code Enforcement	Date
DRB Chairperson, Planning Department	Date


*[Signature]* 2-25-19  
 Solid Waste Management Date

KEY NOTES:

- PROPERTY BOUNDARY.
- EXISTING CURB AND GUTTER TO BE REMOVED.
- EXISTING BILLBOARD TO BE RELOCATED.
- RELOCATED BILLBOARD.
- CONCRETE CURB AND GUTTER.
- CONCRETE SIDEWALK.
- ACCESSIBLE CONCRETE RAMP.
- REFUSE ENCLOSURE, SEE ARCHITECTURAL SHEET.
- SITE LIGHTING.
- BICYCLE RACK.
- NOT USED.
- "MOTORCYCLE PARKING ONLY" SIGN
- ADA "HANDICAP PARKING ONLY" SIGN. MUST HAVE THE REQUIRED LANGUAGE PER 66-7-352.4C NMSA 1978 "VIOLATORS ARE SUBJECT TO A FINE AND/OR TOWING."
- CONCRETE PARKING BUMPER.
- ADA ACCESS AISLE. AISLE SHALL HAVE THE WORDS "NO PARKING" IN CAPITAL LETTERS, EACH OF WHICH SHALL BE AT LEAST ONE FOOT HIGH AND AT LEAST TWO INCHES WIDE, PLACED AT THE REAR OF THE PARKING SPACE SO AS TO BE CLOSE TO WHERE AN ADJACENT VEHICLE'S REAR TIRE WOULD BE PLACED. (66-1-2.1.B NMSA 1978)
- EMPLOYEE PATIO AREA. (900 SF)
- 6 CMU WALL.
- SLIDING GATE.
- GENERATOR.
- FLAGPOLE.
- CONCRETE DRAINAGE CHANNEL, SEE GRADING PLAN.

GENERAL NOTES:


- ALL LIGHTING SHALL COMPLY WITH THE STANDARDS OF §14-16-3-9, AREA REGULATIONS OF THE CITY COMPREHENSIVE ZONING CODE, AND THE SITE PLAN FOR SUBDIVISION DESIGN STANDARDS.
- ROOF-MOUNTED MECHANICAL EQUIPMENT SHALL BE SCREENED.
- THE MECHANICAL SYSTEMS (HEATING AND COOLING) AND BUILDING ENVELOPE (WALLS, ROOF, AND WINDOWS) SHALL BE DESIGNED AND MAINTAINED TO PROMOTE THE EFFICIENT USE OF ENERGY.
- RAINWATER HARVESTING MEASURES, SUCH AS CURB CUTS, SHALL BE PROVIDED.
- ALL SCREENING AND VEGETATION SURROUNDING GROUND-MOUNTED TRANSFORMERS AND UTILITY PADS SHALL ALLOW 10 FEET OF CLEARANCE IN FRONT OF THE EQUIPMENT DOOR AND 5-6 FEET OF CLEARANCE ON THE REMAINING THREE SIDES FOR SAFE OPERATION, MAINTENANCE, AND REPAIR PURPOSES.
- PNM COORDINATION: DEVELOPMENT SHALL ABIDE BY ALL CONDITIONS OR TERMS OF UTILITY EASEMENTS PRIOR TO DEVELOPMENT, CONTACT SHALL BE MADE TO PNM'S NEW SERVICE DELIVERY DEPARTMENT TO COORDINATE ELECTRIC SERVICE AND OPTIONS FOR THE LOCATION OF ELECTRIC SERVICE CONNECTION.
- LANDSCAPING AND SIGNAGE WILL NOT INTERFERE WITH CLEAR SIGHT REQUIREMENTS. THEREFORE, SIGNS, WALLS, TREES, AND SHRUBBERY BETWEEN 3 AND 8 FEET TALL (AS MEASURED FROM THE GUTTER PAN) WILL NOT BE ACCEPTABLE IN THE AREA.
- ALL SIDEWALKS, RAMPS (INCLUDING REQUIRED TRUNCATED DOMES), CURB CUTS, AND CURB AND GUTTER LOCATED WITHIN CITY RIGHT-OF-WAY AND BUS SHELTER LOCATED WITHIN THE SITE SHALL BE BUILT PER C.O.A STANDARD DRAWINGS, SIDEWALK (2430), RAMPS (2440), CURB CUTS (2426), BUS SHELTER (2535.02), CURB AND GUTTER (2415A).
- ALL IMPROVEMENTS LOCATED IN THE RIGHT OF WAY MUST BE INCLUDED ON A WORK ORDER. MAINTENANCE OF PUBLIC OPEN SPACE AMENITIES SHALL BE THE RESPONSIBILITY OF THE PROPERTY OWNER.
- ALL OUTDOOR LIGHT FIXTURES WITHIN COMMERCIAL OR OFFICE ZONES SHALL REMAIN OFF BETWEEN 11:00 PM AND SUNRISE EXCEPT FOR SECURITY PURPOSES OR TO ILLUMINATE WALKWAYS, DRIVEWAYS, EQUIPMENT YARDS AND PARKING LOTS.
- ALL OUTDOOR LIGHTING SYSTEMS SHALL BE DESIGNED AND OPERATE SO THAT THE AREA 10 FEET BEYOND THE PROPERTY LINE OF THE PREMISES RECEIVES NO MORE THAN 0.25 (ONE-QUARTER) OF A FOOT CANDLE OF LIGHT FROM THE PREMISES LIGHTING SYSTEM.

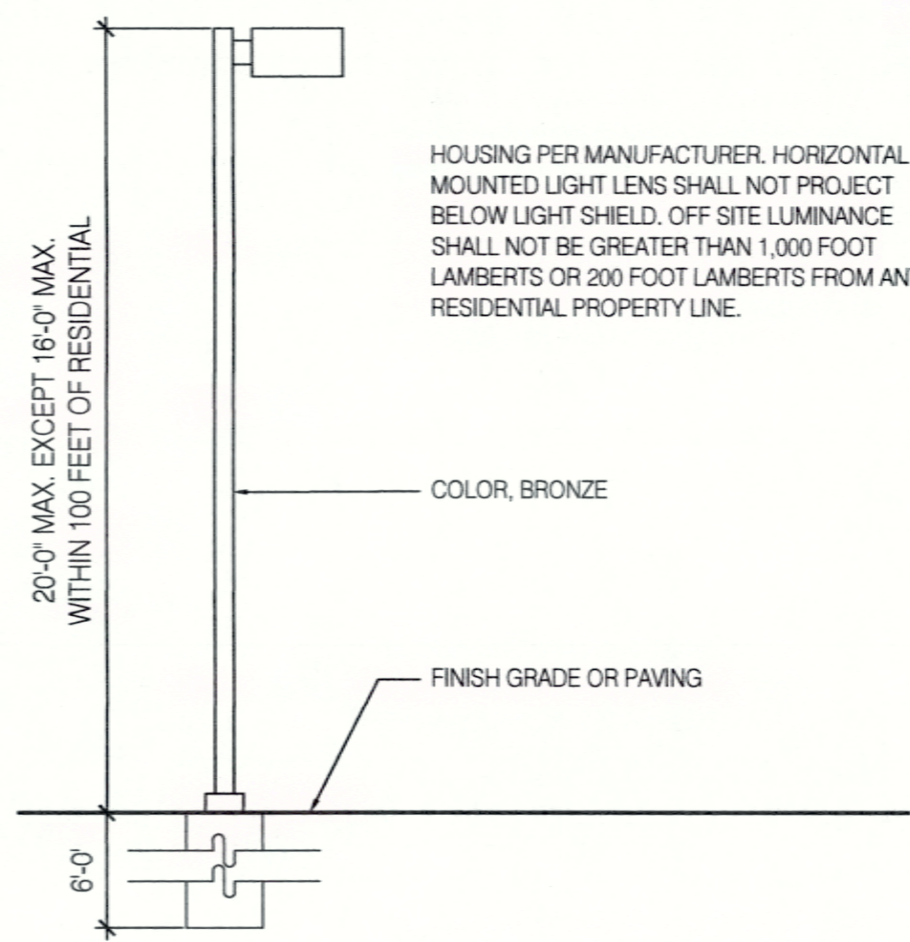

PARKING LOT LIGHT FIXTURE DETAIL Not to Scale

A1 SITE DEVELOPMENT PLAN

SCALE: 1" = 20'-0"

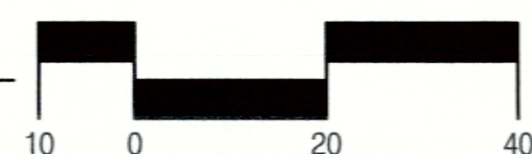

date: FEBRUARY 22, 2019

drawn by:


checked by:

revisions:





# MENAU BLVD (R.O.W. Vaires)

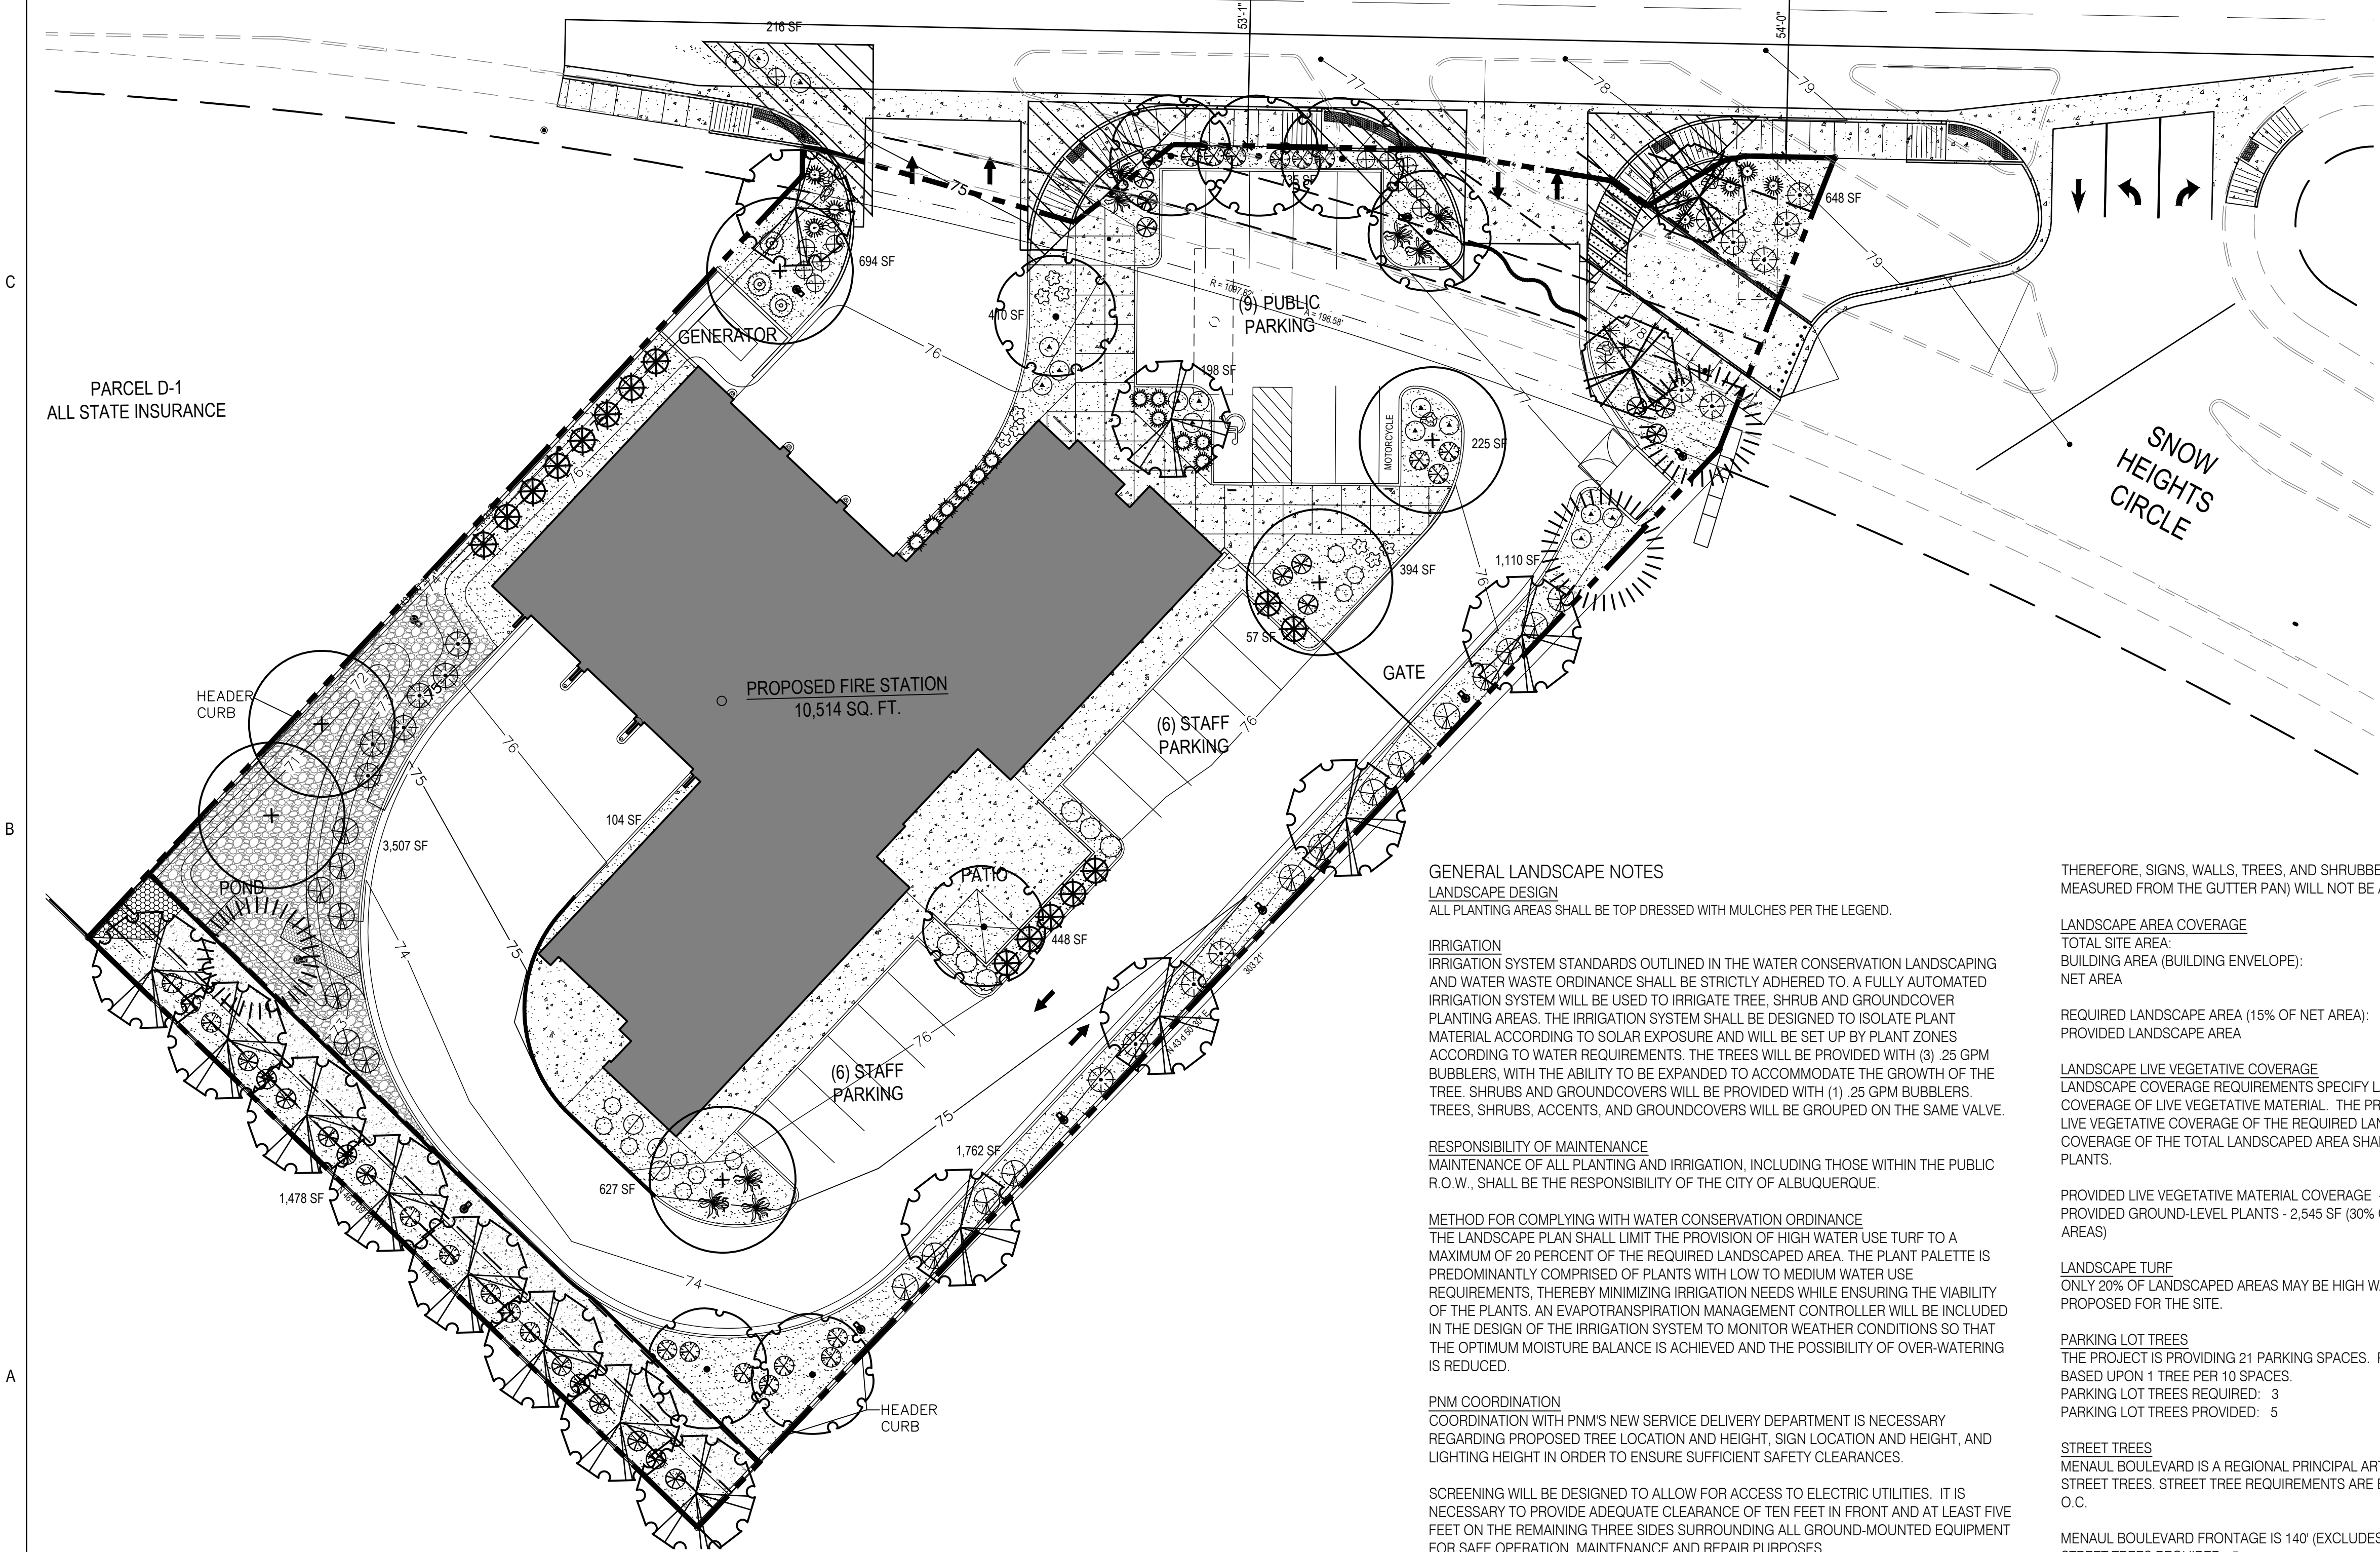

**GENERAL LANDSCAPE NOTES**  
**LANDSCAPE DESIGN**  
 ALL PLANTING AREAS SHALL BE TOP DRESSED WITH MULCHES PER THE LEGEND.

**IRRIGATION**  
 IRRIGATION SYSTEM STANDARDS OUTLINED IN THE WATER CONSERVATION LANDSCAPING AND WATER WASTE ORDINANCE SHALL BE STRICTLY ADHERED TO. A FULLY AUTOMATED IRRIGATION SYSTEM WILL BE USED TO IRRIGATE TREE, SHRUB AND GROUND COVER PLANTING AREAS. THE IRRIGATION SYSTEM SHALL BE DESIGNED TO ISOLATE PLANT MATERIAL ACCORDING TO SOLAR EXPOSURE AND WILL BE SET UP BY PLANT ZONES ACCORDING TO WATER REQUIREMENTS. THE TREES WILL BE PROVIDED WITH (3) 25 GPM BUBBLERS, WITH THE ABILITY TO BE EXPANDED TO ACCOMMODATE THE GROWTH OF THE TREE. SHRUBS AND GROUNDCOVERS WILL BE PROVIDED WITH (1) 25 GPM BUBBLERS. TREES, SHRUBS, ACCENTS, AND GROUNDCOVERS WILL BE GROUPED ON THE SAME VALVE.

**RESPONSIBILITY OF MAINTENANCE**  
 MAINTENANCE OF ALL PLANTING AND IRRIGATION, INCLUDING THOSE WITHIN THE PUBLIC R.O.W., SHALL BE THE RESPONSIBILITY OF THE CITY OF ALBUQUERQUE.

**METHOD FOR COMPLYING WITH WATER CONSERVATION ORDINANCE**  
 THE LANDSCAPE PLAN SHALL LIMIT THE PROVISION OF HIGH WATER USE TURF TO A MAXIMUM OF 20 PERCENT OF THE REQUIRED LANDSCAPED AREA. THE PLANT PALETTE IS PREDOMINANTLY COMPRISED OF PLANTS WITH LOW TO MEDIUM WATER USE REQUIREMENTS, THEREBY MINIMIZING IRRIGATION NEEDS WHILE ENSURING THE VIABILITY OF THE PLANTS. AN EVAPOTRANSPIRATION MANAGEMENT CONTROLLER WILL BE INCLUDED IN THE DESIGN OF THE IRRIGATION SYSTEM TO MONITOR WEATHER CONDITIONS SO THAT THE OPTIMUM MOISTURE BALANCE IS ACHIEVED AND THE POSSIBILITY OF OVER-WATERING IS REDUCED.

**PNM COORDINATION**  
 COORDINATION WITH PNM'S NEW SERVICE DELIVERY DEPARTMENT IS NECESSARY REGARDING PROPOSED TREE LOCATION AND HEIGHT, SIGN LOCATION AND HEIGHT, AND LIGHTING HEIGHT IN ORDER TO ENSURE SUFFICIENT SAFETY CLEARANCES.

SCREENING WILL BE DESIGNED TO ALLOW FOR ACCESS TO ELECTRIC UTILITIES. IT IS NECESSARY TO PROVIDE ADEQUATE CLEARANCE OF TEN FEET IN FRONT AND AT LEAST FIVE FEET ON THE REMAINING THREE SIDES SURROUNDING ALL GROUND-MOUNTED EQUIPMENT FOR SAFE OPERATION, MAINTENANCE AND REPAIR PURPOSES.

**CLEAR SIGHT DISTANCE:**  
 LANDSCAPING AND SIGNAGE WILL NOT INTERFERE WITH CLEAR SIGHT REQUIREMENTS.

THEREFORE, SIGNS, WALLS, TREES, AND SHRUBBERY BETWEEN 3 AND 8 FEET TALL (AS MEASURED FROM THE GUTTER PAN) WILL NOT BE ACCEPTABLE IN THE AREA.

LANDSCAPE AREA COVERAGE	
TOTAL SITE AREA:	52,732 SF (1.21 AC)
BUILDING AREA (BUILDING ENVELOPE):	-10,541 SF
NET AREA:	42,191 SF
REQUIRED LANDSCAPE AREA (15% OF NET AREA):	6,329 SF
PROVIDED LANDSCAPE AREA:	12,472 SF (30%)

**LANDSCAPE LIVE VEGETATIVE COVERAGE**  
 LANDSCAPE COVERAGE REQUIREMENTS SPECIFY LANDSCAPE AREAS TO HAVE A 75% COVERAGE OF LIVE VEGETATIVE MATERIAL. THE PROJECT WILL PROVIDE A MINIMUM OF 75% LIVE VEGETATIVE COVERAGE OF THE REQUIRED LANDSCAPE AREA. A MINIMUM OF 30% COVERAGE OF THE TOTAL LANDSCAPED AREA SHALL BE ACHIEVED BY GROUND-LEVEL PLANTS.

PROVIDED LIVE VEGETATIVE MATERIAL COVERAGE - 21,377 SF (185% OF LANDSCAPE AREA)  
 PROVIDED GROUND-LEVEL PLANTS - 2,545 SF (30% OF LANDSCAPE AREA MINUS POND AREAS)

**LANDSCAPE TURF**  
 ONLY 20% OF LANDSCAPED AREAS MAY BE HIGH WATER USE TURF. NO HIGH WATER TURF IS PROPOSED FOR THE SITE.

**PARKING LOT TREES**  
 THE PROJECT IS PROVIDING 21 PARKING SPACES. PARKING LOT TREE REQUIREMENTS ARE BASED UPON 1 TREE PER 10 SPACES.  
 PARKING LOT TREES REQUIRED: 3  
 PARKING LOT TREES PROVIDED: 5

**STREET TREES**  
 MENAUL BOULEVARD IS A REGIONAL PRINCIPAL ARTERIAL AND THEREFORE REQUIRES STREET TREES. STREET TREE REQUIREMENTS ARE BASED ON AN AVERAGE SPACING OF 30' O.C.

MENAUL BOULEVARD FRONTAGE IS 140' (EXCLUDES DRIVEWAYS).  
 STREET TREES REQUIRED: 5  
 STREET TREES PROVIDED: 5

PLANT LEGEND				
QTY.	SYMBOL	SCIENTIFIC NAME COMMON NAME (WATER USE)	SIZE	INSTALLED SIZE MATURE SIZE
<b>TREES</b>				
14		ACER TATARICUM 'GAR ANN' HOT WINGS MAPLE (M+)	2' B&B	20' HT. X 24' SPR.
2		CHILOPSIS LINEARIS 'BUBBA' BUBBA DESERT WILLOW (L+)	8' MS	20' HT. X 20' SPR.
6		FRAXINUS PENNSYLVANICA 'URBANITE' URBANITE ASH (M+)	2.5' B&B	40' HT. X 30' SPR.
15		JUNIPERUS SCOPULORUM 'SKYROCKET' SKYROCKET JUNIPER (L+)	15 GAL	12' HT. X 5' SPR.
3		PINUS NIGRA AUSTRIAN PINE (M)	8' HT. B&B	35' HT. X 25' SPR.
8		ULMUS PROPINQUA 'JFS-BIEBERICH' EMERALD SUNSHINE ELM (M+)	2.5' B&B	35' HT. X 25' SPR.
<b>SHRUBS AND GROUNDCOVERS</b>				
9		ACHILLEA MOONSHINE MOONSHINE YARROW (M)	1-GAL	2' HT. X 2' SPR.
3		BUDDLEIA DAVIDII 'NANHOENSIS' DWARF BLUE BUTTERFLY BUSH (M)	5-GAL	4' HT. X 4' SPR.
25		CARYOPTERIS CLAN 'DARK KNIGHT' DARK KNIGHT SPIREA (L)	5-GAL	4' HT. X 4' SPR.
22		CYTISUS SCOPARIUS 'ALL GOLD' ALL GOLD SCOTCH BROOM (L)	5-GAL	4' HT. X 4' SPR.
20		FALLUGIA PARADOXA APACHE PLUME (L)	5-GAL	5' HT. X 5' SPR.
8		JUNIPERUS HORIZ. 'BLUE CHIP' BLUE CHIP JUNIPER (M)	5-GAL	1' HT. X 7' SPR.
16		NANDINA DOMESTICA 'GULFSTREAM' HEAVENLY BAMBOO (M+)	5-GAL	4' HT. X 4' SPR.
3		PINUS MUGO 'PUMILIO' DWARF MUGO PINE (M)	5-GAL	4' HT. X 6' SPR.
17		PRUNUS OSTENIA PURPLELEAF SAND CHERRY (M)	5-GAL	6' HT. X 5' SPR.
15		RHUS AROMATICA 'GRO-LOW' PROSTRATE SUMAC (L+)	5-GAL	2' HT. X 4' SPR. C
12		SALVIA GREGGII 'FURMAN'S RED' FURMAN'S RED CHERRY SAGE (M)	3-GAL	30' HT. X 3' SPR.
<b>DESERT ACCENTS</b>				
8		DASYLIRION WHEELERI DESERT SPOON (L)	5-GAL	4' HT. X 4' SPR.
3		HESPERALOE PARVIFLORA 'BRAKELIGHTS' BRAKELIGHTS RED YUCCA (L)	3-GAL	3' HT. X 3' SPR.
<b>ORNAMENTAL GRASSES</b>				
12		CALAMAGROSTIS A. 'KARL FOERSTER' KARL FOERSTER FEATHER REED GRASS (M)	5-GAL	30' HT. X 3' SPR.
<b>MULCHES AND BOULDERS</b>				
7		MOSS ROCK BOULDERS (27 OF MIN)		
8,632 SF		1" MOUNTAINAIR BROWN ROCK MULCH (3" DEPTH OVER FILTER FABRIC, DEWITT PRO-5 WEED CONTROL OR EQUAL)		
3,452 SF		2"-4" MOUNTAINAIR BLUSH COBBLE (6" DEPTH OVER FILTER FABRIC, DEWITT PRO-5 WEED CONTROL OR EQUAL)		

# CITY OF ALBUQUERQUE, N. M. FIRE STATION #9 VIGIL & ASSOCIATES

date:	FEBRUARY 22, 2019
drawn by:	
checked by:	
revisions:	

**CONSENSUS PLANNING, INC.**  
 Planning / Landscape Architecture  
 302 Eighth Street NW  
 Albuquerque, NM 87102  
 (505) 764-9801 Fax 842-5495


**VIGIL & ASSOCIATES**  
 ARCHITECTURAL GROUP, P.C.  
 WWW.VA-ARCHITECTS.COM

DRB SUBMITTAL


LANDSCAPE PLAN

project no. 17-019

**A1 LANDSCAPE PLAN**  
 SCALE: 1" = 20'-0"

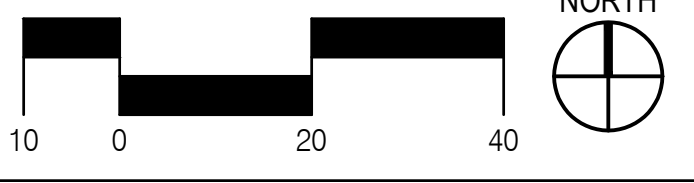



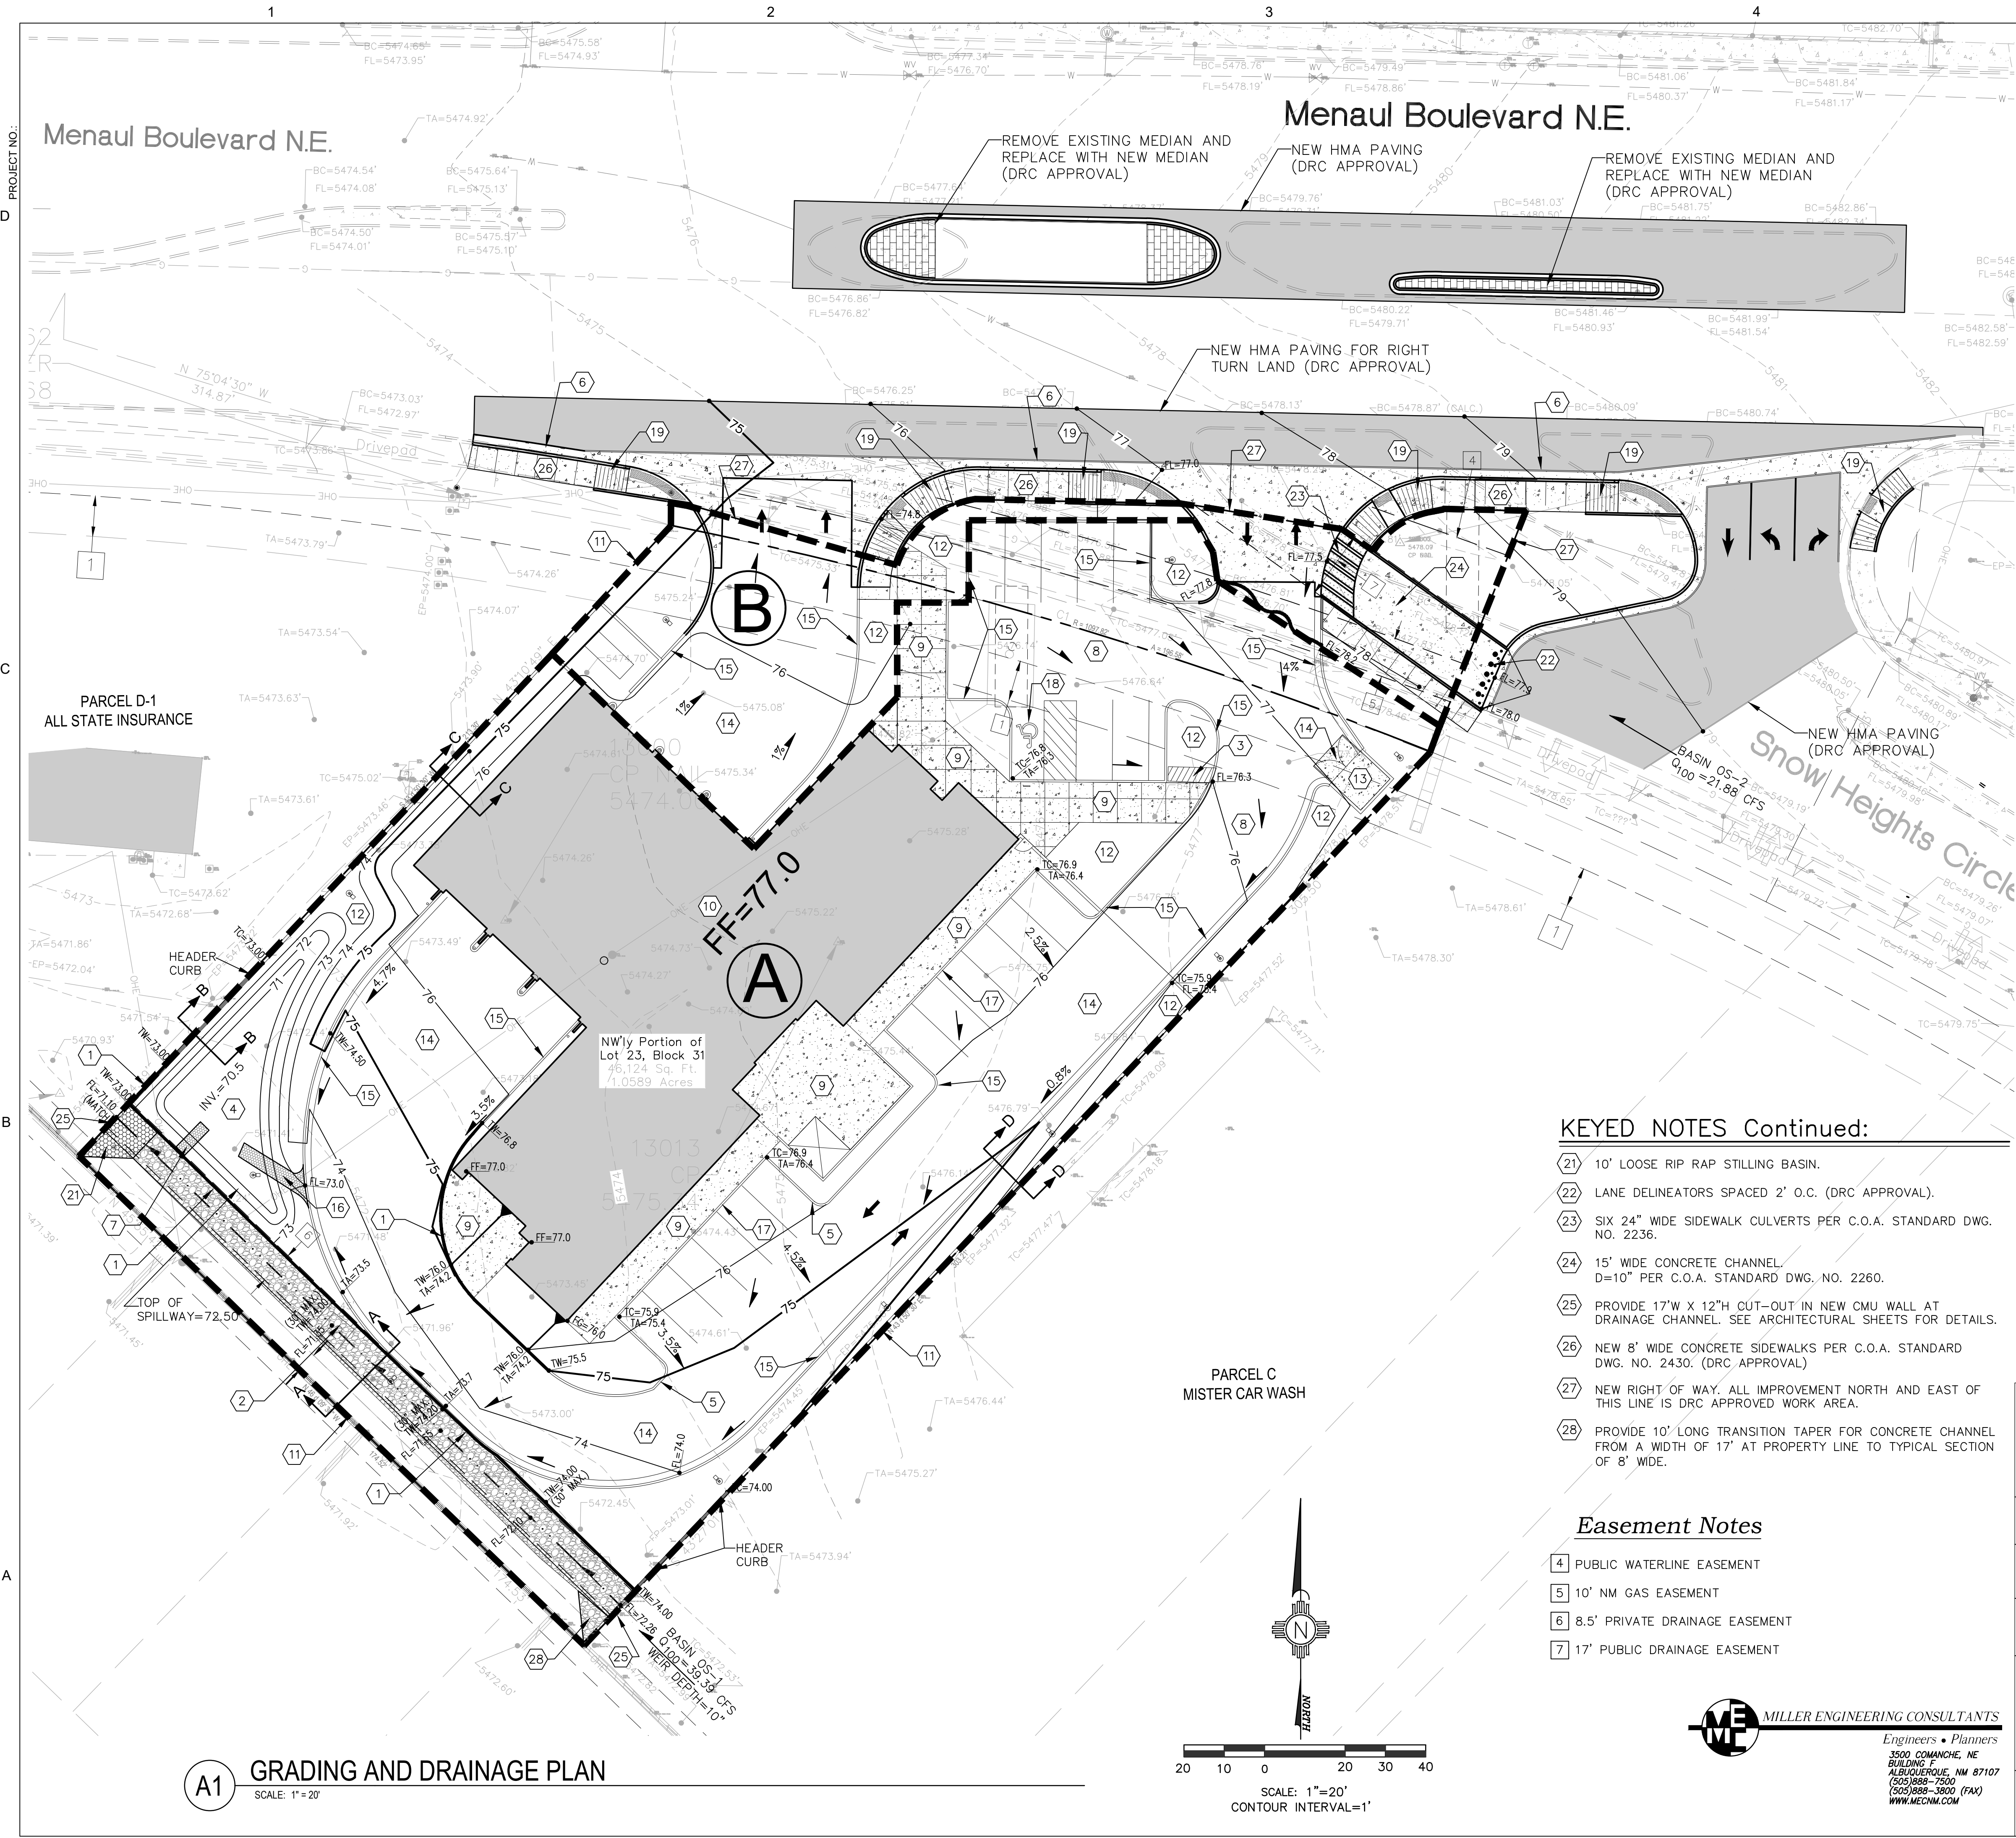

**LEGEND:**

38.00	PROPOSED SPOT ELEVATIONS (FINISHED GRADE)		
95.19	MATCH EXISTING ELEVATIONS		
TC ON	TOP OF CONCRETE	TBC	TOP OF BASE COURSE
FL	FLOW LINE, CURB	TC	TOP OF CURB
INV	INVERT	TG	TOP OF GRATE
FG	FINISH GRADE	TA	TOP OF ASPHALT
			FLOW ARROW
=====	GRADE BREAK-HIGH POINT		
---	SWALE		
---	STORM DRAIN LINE		
---	PROPOSED MAJOR CONTOUR		
---	PROPOSED MINOR CONTOUR		
---	EXISTING MAJOR CONTOUR		
---	EXISTING MINOR CONTOUR		
---	TOP OF CUT SLOPE		

- KEYED NOTES:**
- NEW RETAINING WALL SEE DETAIL SHEET C-501
  - NEW CONCRETE CHANNEL. SEE SECTION A-A SHEET C-501. S=0.4%, W=8', D=18". PER C.O.A. STANDARD DWG. NO. 2260.
  - 24" WIDE SIDEWALK CULVERT PER C.O.A. STANDARD DETAIL DWG. NO. 2236.
  - FIRST FLUSH POND #1 SEE DETAIL SHEET C-501. INV=70.5 SPILLWAY=72.5, VOL=2200CF, D=24".
  - NEW ROLLOVER CURB AND GUTTER. SEE DETAIL SHEET C-501.
  - NEW CURB AND GUTTER. SEE C.O.A. STANDARD DWG. NO. 2415. (DRC APPROVAL)
  - PROVIDE 3' WIDE X 6" DEEP CUT-OUT IN TOP OF WALL FOR OVERFLOW EMERGENCY SPILLWAY. SEE DETAIL SHEET C-501.
  - NEW HEAVY DUTY HOT MIX ASPHALT PAVEMENT SECTION. SEE SECTION DETAILS ON SHEET C-501.
  - NEW CONCRETE SIDEWALK/FLATWORK. SEE ARCHITECTURAL PLANS FOR DETAILS. CONTRACTOR SHALL SUBMIT A JOINT PATTERN TO THE PROJECT ARCHITECT FOR REVIEW AND APPROVAL PRIOR TO CONSTRUCTION.
  - NEW BUILDING SEE ARCHITECTURAL PLANS FOR DETAILS.
  - LOCATION OF PROPERTY LINE.
  - LANDSCAPE AREA SEE ARCHITECTURAL PLANS FOR DETAILS.
  - NEW TRASH ENCLOSURE SEE ARCHITECTURAL PLANS FOR DETAILS.
  - NEW HEAVY DUTY CONCRETE PAVING SEE DETAIL SHEET C-501.
  - NEW STANDARD CURB AND GUTTER. SEE DETAIL SHEET C-501.
  - NEW 3' WIDE RIP RAP RUNDOWN SEE DETAIL SHEET C-501.
  - NEW THICKENED EDGE ON CONCRETE SIDEWALK. SEE DETAIL SHEET C-501.
  - NEW HANDICAPPED PARKING SPACES 2% MINIMUM SLOPE IN EACH DIRECTION.
  - NEW HANDICAP RAMP SEE C.O.A. STANDARD DWG. NO. 2418. (DRC APPROVAL)
  - NEW ROLL OVER CURB SEE DETAL SHEET C-501.

- KEYED NOTES Continued:**
- 10' LOOSE RIP RAP STILLING BASIN.
  - LANE DELINEATORS SPACED 2' O.C. (DRC APPROVAL).
  - SIX 24" WIDE SIDEWALK CULVERTS PER C.O.A. STANDARD DWG. NO. 2236.
  - 15' WIDE CONCRETE CHANNEL. D=10" PER C.O.A. STANDARD DWG. NO. 2260.
  - PROVIDE 17"W X 12"H CUT-OUT IN NEW CMU WALL AT DRAINAGE CHANNEL. SEE ARCHITECTURAL SHEETS FOR DETAILS.
  - NEW 8' WIDE CONCRETE SIDEWALKS PER C.O.A. STANDARD DWG. NO. 2430. (DRC APPROVAL)
  - NEW RIGHT OF WAY. ALL IMPROVEMENT NORTH AND EAST OF THIS LINE IS DRC APPROVED WORK AREA.
  - PROVIDE 10' LONG TRANSITION TAPER FOR CONCRETE CHANNEL FROM A WIDTH OF 17' AT PROPERTY LINE TO TYPICAL SECTION OF 8' WIDE.

- Easement Notes**
- PUBLIC WATERLINE EASEMENT
  - 10' NM GAS EASEMENT
  - 8.5' PRIVATE DRAINAGE EASEMENT
  - 17' PUBLIC DRAINAGE EASEMENT

AS-BUILT INFORMATION		BENCH MARKS		SURVEY INFORMATION		FIELD NOTES	
CONTRACTOR	DATE			NO.	DATE		
WORK BY	DATE						
SUPERVISOR	DATE						
ACCEPTANCE BY	DATE						
FIELD CHECK BY	DATE						
DESIGNED BY	DATE						
CHECKED BY	DATE						
RECORDED BY	DATE						



**NOT FOR CONSTRUCTION**



NO.	DATE	REMARKS	BY	DATE



**CITY OF ALBUQUERQUE**  
**CAPITAL IMPLEMENTATION PROGRAM**  
**AFD FIRE STATION 9**  
 9500 SNOW HEIGHTS CIRCLE NE,  
 ALBUQUERQUE, NM 87112

Drawing Title		CONCEPTUAL GRADING AND DRAINAGE PLAN	
Design Review Committee	City Engineer Approval	Mo./Day/Yr.	Mo./Day/Yr.
		7/10/18	
Issue Date:	City Project No.	Sheet	
<b>MARCH 20, 2019</b>	<b>5476.91</b>	<b>C-101</b>	

**A1 GRADING AND DRAINAGE PLAN**  
 SCALE: 1"=20'

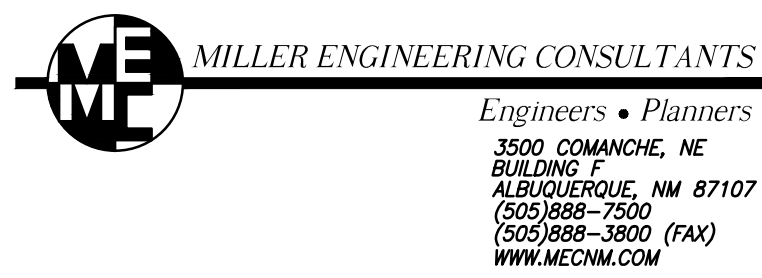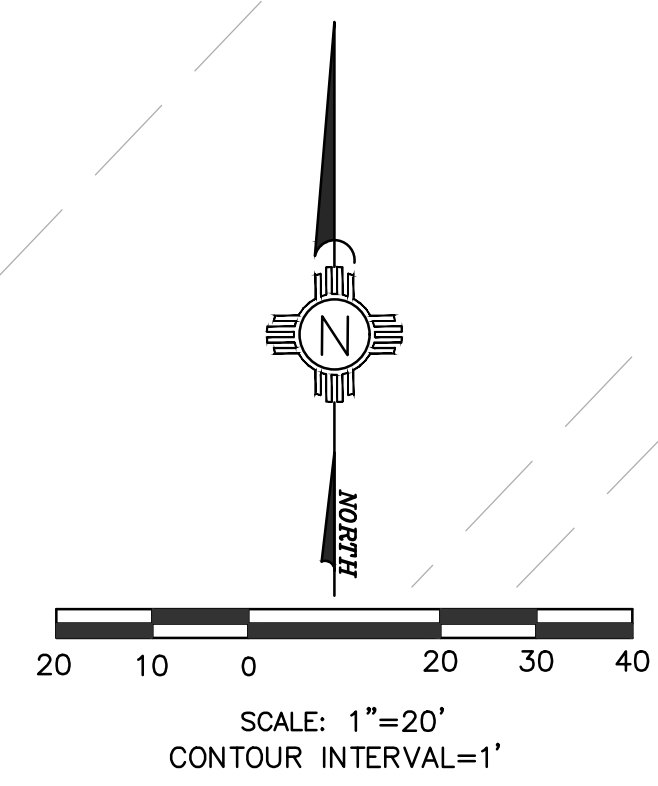

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