CONSTRUCTION NOTES GRAVEL PAVEMENT SPECIFICATION: A. TWO WORKING DAYS PRIOR TO ANY EXCAVATION, THE CONTRACTOR SHALL CALL FOR MATERIALS: LOCATION OF EXISTING UTILITIES. EXISTING MATERIAL MAY BE USED FOR PARKING AND VEHICLE ACCESS AREAS IF IT MEETS THE LIMITS SPECIFIED BELOW. OTHERWISE USE ONLY B. ALL WORK WITHIN THE CITY RIGHT-OF-WAY SHALL BE PERFORMED IN ACCORDANCE WITH APPROVED MATERIALS FROM OFF-SITE BORROW AREAS. PROVIDE TESTING THE APPLICABLE CITY OF ALBUQUERQUE STANDARDS AND PROCEDURES. OF EXCAVATED MATERIAL TO SHOW COMPLIANCE: C. ALL WORK SHALL BE PERFORMED IN ACCORDANCE WITH THE APPLICABLE FEDERAL, STATE, SIEVE SIZE: AND LOCAL REGULATIONS, LAWS, AND RULES CONCERNING SAFETY AND HEALTH. (SQUARE OPENING:) D. PRIOR TO CONSTRUCTION THE CONTRACTOR SHALL VERITY THE EXISTING SITE CONDITIONS 1 INCH AND INFORM THE ARCHITECT/ ENGINEER OF ANY DISCREPANCY BETWEEN THE NO. 4 INFORMATION SHOWN ON THE PLANS AND THOSE OF THE EXISTING SITE. NO. 200 E. THE CONTRACTOR SHALL PROVIDE THE ARCHITECT / ENGINEER WITH AN AS BUILT SURVEY A. COMPACTION OF THE SUBGRADE SHALL BE 90% OF MAXIMUM DENSITY. FOR ENGINEER'S CERTIFICATION AT PROJECT COMPLETION. B. INSTALL BASE COURSE TO A COMPACTED THICKNESS OF 2" MINIMUM . THE CONTRACTOR SHALL MAINTAIN A RECORD DRAWING SET OF PLANS AND PROMPTLY AT ALL PAVED AREAS. LOCATE EXISTING AND NEW ELEVATIONS (FINISH FLOORS, TOPS OF CURBS AND ASPHALT, C. SPREAD AND COMPACT THE BASE COURSE IN LAYERS WHICH WILL PERMIT FLOW LINE, PIPE INVERTS, ETC.), ON THE RECORD SET. THE RECORD SET SHALL BE THE REQUIRED DENSITY TO BE OBTAINED. (95%) MAINTAINED ON THE PROJECT SITE AND SHALL BE AVAILABLE TO THE OWNER AND ARCHITECT AT ANY TIME DURING CONSTRUCTION. UPON COMPLETION OF THE PROJECT, THE ARCHAEOLOGICAL SURVEY RECORD SET SHALL BE TURNED OVER TO THE OWNER. AN ARCHAEOLOGICAL SURVEY OF THE SITE WAS COMPLETED IN 2007 BY TRC, INC. IN ALBUQUERQUE. THE SURVEY REPORT IS AVAILABLE FROM THE G. THE OWNER / CONTRACTOR SHALL SUBMIT A NOTICE OF INTENT (NOI) TO THE EPA PRIOR OWNER, AT THE CONTRACTOR'S REQUEST. THE SAN JOSE CHURCH IS THE TO BEGINNING OF CONSTRUCTION. MOST NOTABLE FEATURE OF THE REPORT AND HAS HISTORIC VALUE. THE H. THE CONTRACTOR SHALL PROVIDE AND COMPLY WITH STORM WATER POLLUTION CONTRACTOR SHALL TAKE PRECAUTIONS TO NOT DAMAGE THE STRUCTURE PREVENTION PLAN (SWPPP) SPECIFIC TO THIS PROJECT. OR ADJACENT GROUND WHICH WOULD DISTURB THE BUILDING. CONTRACTOR SHALL INCLUDE FENCING AROUND THE BUILDING DURING THE ENTIRE FACILITY ACCESSIBILITY CONSTRUCTION PERIOD. ALL SURFACES ALONG THE ACCESSIBLE ROUTE SHALL COMPLY WITH ANSI A117-1998. WALKING SURFACES SHALL BE STABLE, FIRM, AND SLIP RESISTANT. THE RUNNING SLOPE OF WALKING SURFACES SHALL NOT BE STEEPER THAN 1:20 WITH A CROSS SLOPE NOT STEEPER CURB RAMP AND RAMP RUNS SHALL HAVE A RUNNING SLOPE NOT STEEPER THAN 1:12 WITH A CROSS SLOPE NOT STEEPER THAN 1:48. COUNTER SLOPES OF ADJOINING GUTTERS AND ROAD SURFACES IMMEDIATELY ADJACENT TO THE CURB RAMP OR ACCESSIBLE ROUTE SHALL NOT BE STEEPER THAN 1:20. TRANSITIONS FROM RAMPS TO WALKS, GUTTERS OR STREETS SHALL BE AT THE SAME LEVEL. WHERE PEDESTRIANS MUST WALK ACROSS A CURB RAMP, THE RAMP SHALL HAVE FLARED SIDES WITH SLOPES NOT STEEPER THAN 1:10: WHERE THE TOP OF THE RAMP PARALLEL TO THE RUN OF THE RAMP IS LESS THAN 48 INCHES WIDE, THE FLARED SIDES SHALL HAVE A SLOPE NOT STEEPER THAN 1:12. HANDICAP PARKING SPACES AND ACCESS AISLES SHALL HAVE SURFACE SLOPES NOT STEEPER THAN 1:48. ACCESS AISLES SHALL BE AT THE SAME LEVEL AS THE PARKING SPACES THEY SERVE. TRAFFIC CONTROL THE CONTRACTOR SHALL PROVIDE ALL REQUIRED TRAFFIC CONTROL PLANS AND DEVICES. ALL SIGNS, BARRICADES, CHANNELIZATION DEVICES, SIGN FRAMES AND ERECTION OF SUCH DEVICES SHALL CONFORM THE THE REQUIREMENTS OF THE "MANUAL OF UNIFORM TRAFFIC CONTROL DEVICES FOR STREETS AND HIGHWAYS" LATEST EDITION. PRIOR TO CONSTRUCTION PRIOR TO CONSTRUCTION, THE TRAFFIC CONTROL PLAN SHALL BE SUBMITTED AND APPROVED BY THE GOVERNING AUTHORITY.

EXISTING CLASSROOM BUILDING 10.305 SF EXISTING CHURCH BUILDING UNUSED 5,130 SF GROSS SITE AREA: 294,035 SF

PROJECT DATA

ZONING CLASSIFICATION: R1-B

EXISTING OFFICE BUILDING

EXISTING RECTORY BUILDING

EXISTING CHURCH BUILDING

GROSS SQUARE FOOTAGE

PARKING CALCULATIONS

EXISTING CHURCH 1 SPACE OR EVERY 4 SEATS IN MAIN ROOM 628 /4 = 157 PARKING REDUCTIONS WITHIN 300 FT OF TRANSIT ROUTE 10% (-15) REQUIRED PARKING 157 - 15 = 142 SPACES

1 SPACE OR EVERY 4 SEATS IN MAIN ROOM 238 /4 = 60 SPACES

25 COMPACT PARKING SPACES 8 HANDICAP PARKING SPACES 166 TOTAL EXISTING PARKING SPACES

36 TOTAL PROPOSED PARKING SPACES MOTORCYCLE PARKING SPACES

SU-2 HM BROADWAY INDUSTRIAL CENTER 3 SU-2 MR LANDS 4 (UNIT 1) 2 PU 2 NR 3 7 2 7 VICINTY MAP - M-14-Z ADDRESS: 2401 BROADWAY SE ALBUQUERQUE NM

TRACT A SAN JOSE PARISH

AND NORTH BY RESIDENTIAL.

LEGEND:

PROPERTY: THE SITE IS A DEVELOPED SU-2 NEIGHBORHOOD ZONE,

PROPOSED CONCRETE WALKS

PROPOSED CONCRETE PAVING

LOCATED WITHIN THE CITY OF ALBUQUERQUE, VICINITY MAP M-14. THE SITE

IS BOUND ON EAST BY BROADWAY BOULEVARD, AND TO THE WEST, SOUTH.

○ KEYNOTES

EXISTING BUILDING TO BE REMOVED BY OWNER.

EXISTING BICYCLE RACK - 8 SPACES.

GROUND MOUNTED MAKE-UP AIR UNIT. 4. HANDICAPPED PARKING SPACES WITH BUMPER AND SIGNS.

EXISTING PARKING AND ASPHALT PAVEMENT. 6. EXISTING GRAVEL

7. NEW WHEEL STOP TYPICAL OF 34 8. 3000 PSI CONCRETE WALK (4" THICK W/ WWF 6x6, 10x10) 9. 3000 PSI CONCRETE PAVING (4" THICK W/ WWF 6x6, 10x10) OVER 4" BASECOURSE (COMPACT TO 95% PER ASTM D1557)

10. NEW BICYCLE RACK FOR 3 BIKES. 11. 3 MOTORCYCLE SPACES EACH WITH 12"x18" SIGN. SEE B5 THIS SHEET. 12. "NO PARKING" LETTERS 12" HIGH, 2" WIDE.

OVER COMPACTED SUBGRACE (COMPACT TO 95% PER ASTM D-1557)

13. VAN ACCESSIBLE SIGN, SIMILAR TO C5 THIS SHEET. 14. HANDICAPPED SIGN LOCATION, TYPICAL. 15. 8'-0" LONG PRECAST CONCRETE VEHICLE STOP.

16. HANDICAPPED SYMBOL PAINTED ONTO CONCRETE.

17. 4" WIDE PAVEMENT STRIPPING, TYPICAL,

BALCIAR

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PROFESSIONAL SEAL

Albuquerque, NM 87192

Conscious Design for the Environment

Original drawings remain the property of the Architect and as such the Architect retains

total ownership and control. The design represented by these drawings is sold to the client for a one time use, unless otherwise agreed upon in writing by the Architect.

CONSULTANT

TE OF NEW MOUS

Interior Design Engineering


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PROJECT NAME SAN JOSE CATHOLIC CHURCH

PARISH HALL

SAN JOSE CATHOLIC CHURCH 2401 BROADWAY BLVD SE ALBUQUERQUE, NM 87102

HANDICAP PARKING SIGN 12"x18". ACCESSIBLE PARKING WOLATORS ARE SUBJECT TO A FINE AND/OR TOWING 3 1/2" WIDE GALVANIZED RIB BACK, STEEL CHANNEL SIGN POST EXTEND 1'-6" INTO CONCRETE BASE 12" DIA x 2'-6" 3000 PSI CONCRETE BASE PROVIDE 3" COVER -BETWEEN BOTTOM OF HOLE AND END OF POST HANDICAP PARKING SIGN

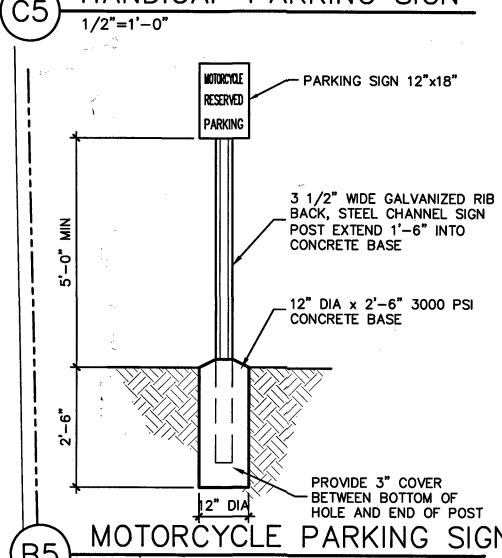

BETWEEN BOTTOM OF HOLE AND END OF POST MOTORCYCLE PARKING SIGN PROJECT NUMBER: PR-2018-001576 APPLICATION NUMBER: 51-2018-00185

10/24/18

10/24/18

10-24-18

SHEET NAME

PROJECT NUMBER

CHECKED BY

ISSUE DATE

TCL SITE PLAN

FILE NAME: 1724_AS101_SITE-PLAN.DWG

10-10-18

10.10.18 | DRB REVISIONS

DATE DESCRIPTION

C-101

3,036 SF

6,222 SF

12,481 SF

PROPOSED PARISH HALL REQUIRED PARKING: 142 + 60 = 202 SPACES

133 STANDARD PARKING SPACES

PROPOSED PARKING:

33 STANDARD PARKING SPACES 3 HANDICAP PARKING SPACES

BICYCLE SPACES TOTAL PARKING: 166 + 36 = 202 SPACES

PERCENT PASSING


(BY DRY WEIGHT

60-100

15-45

ACCESSIBLE PARKING DETAIL

SCALE: 1" = 20' - 0"

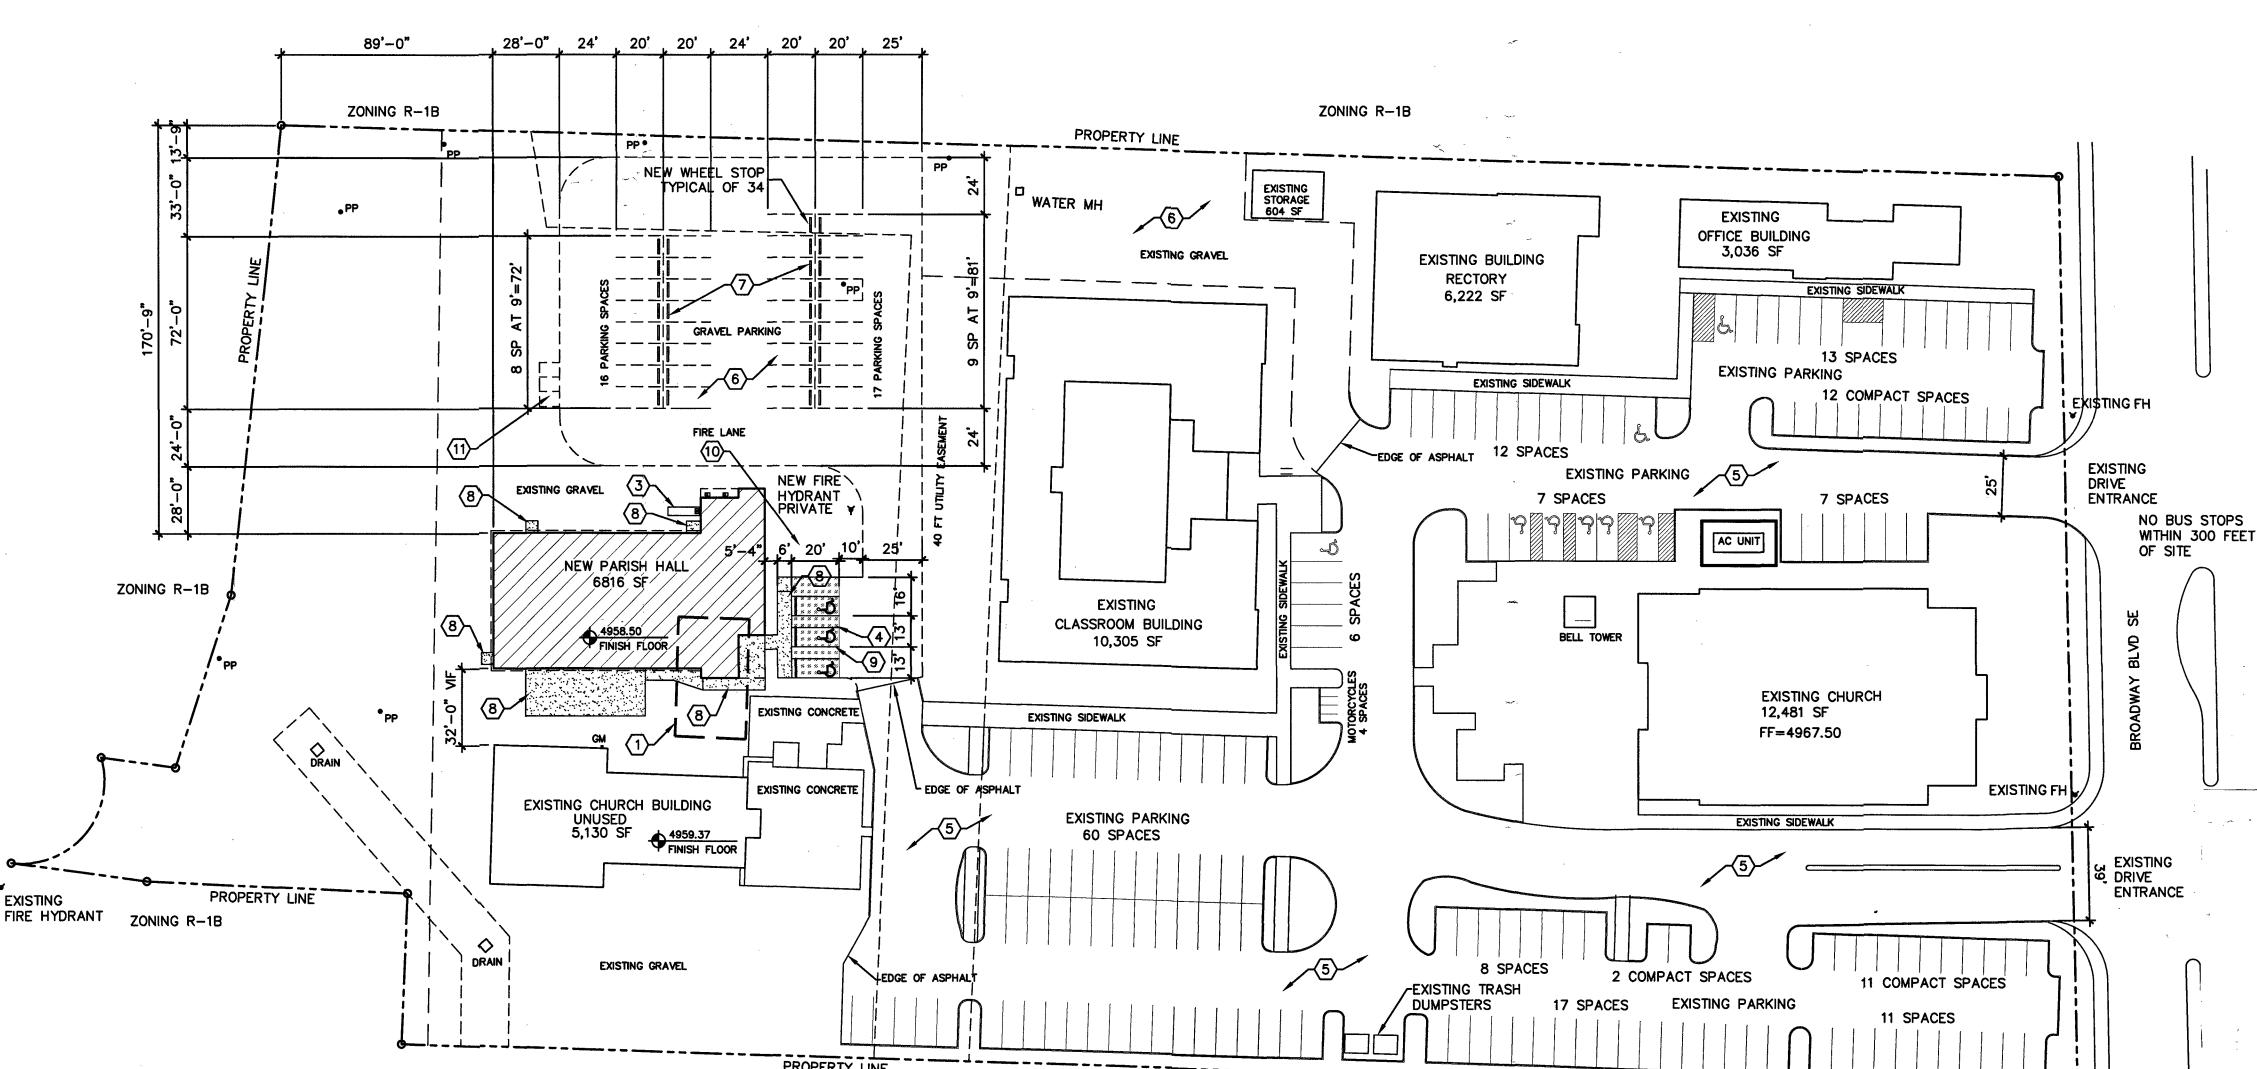

NO BUS STOPS WITHIN 300 FEET

DRB, SITE DEVELOPMENT APPROVAL. raguest M Must Traffic Engineering, Transportation Division Parks and Recreation Department

Code Enforcement

* Environmental Health Department (conditional)

Solid Waste Management DRB/Chairperson, Planning Departmen

SITE PLAN

10.24.18

SHEET NUMBER