


		—
	1. INSTALL NEW STORM DRAIN.	DEKKER
ghted SW Quality	2. INSTALL NEW STORM DRAIN INLET.	
rve # (CF)	3. CONNECT TO EXISTING STORM DRAIN.	PERICH
97 N/A 0	4. INSTALL CURB OPENING, DEPRESS LANDSCAPING ISLAND.	SABATINI
97 1236	*NOTE: ROOF DRAINS TO CONNECT TO NEW ONSITE STORM DRAIN SYSTEM	
1236		ARCHITECTURE Design
		INSPIRATION
		ARCHITECT
	DRAINAGE NARRATIVE	
	INTRODUCTION: THE PRESNOW UPTOWN IS LOCATED ON THE SOUTHEAST CORNER OF LOUISIANA BOULEVARD	
PARCEL A–1–A–2 (10/31/2012, 2012C–130)	AND AMERICA'S PARKWAY IN THE ALBUQUERQUE UPTOWN DISTRICT. THE SITE IS THE FORMER LOCATION OF MACARONI GRILL. FOR THE PURPOSE OF THIS SUBMITTAL, THE ENTIRE SITE WAS	ST THEW H. SAICH
	ANALYZED AS ONE BASIN. FUTURE SUBMITTALS WILL FURTHER DELINEATE BASINS, AND PROVIDE INLET / STORM DRAIN CALCULATIONS.	REG 24572
	EXISTING CONDITIONS: THE PROPOSED SITE IS CURRENTLY DEVELOPED. APPROXIMATELY HALF OF THE SITE SLOPE	PROFESSIONAL
	SOUTH AND EAST TO AN EXISTING INLET IN THE SOUTHEAST CORNER OF THE EXISTING PARKING LOT. THIS INLET CONNECTS TO THE EXISTING 84" STORM DRAIN EAST OF THE SITE. THE	NOT FOR CONSTRUCTION
	NORTHERN HALF OF THE SITE SLOPES NORTH AND WEST TO AN EXISTING INLET IN THE NORTHWEST CORNER OF THE EXISTING PARKING LOT. THIS INLET ALSO CONNECTS TO THE	PROJECT
	EXISTING 84" STORM DRAIN EAST OF THE SITE. THIS 84" STORM DRAIN IS WITHIN A PUBLIC EASEMENT THAT SKIRTS THE SITE AND DISCHARGES INTO THE ARROYO WITHIN INTERSTATE 40.	
	EXISTING RUNOFF FLOWRATE IS APPROXIMATELY 6.43 CFS. PROPOSED CONDITIONS:	
	THE PROPOSED CONDITIONS WILL MIMIC EXISTING CONDITIONS. THE PROPOSED SITE WILL HAVE TWO MAIN DISCHARGE LOCATIONS SIMILAR TO EXISTING CONDITIONS. THE NORTHERN PORTION	
	OF THE SITE WILL DISCHARGE INTO A NEW STORM DRAIN INLET THAT CONNECTS TO THE EXISTING STORM DRAIN EAST OF THE SITE. THE SOUTHERN PORTION OF THE SITE WILL DISCHARGE INTO A	
	NEW STORM DRAIN INLET IN THE SOUTHEAST CORNER OF THE SITE THAT CONNECTS TO THE EXISTING 84" STORM DRAIN. BUILDING ROOF DRAINAGE WILL DISCHARGE BELOW GRADE AND	
	CONNECT TO THE NEW ONSITE STORM DRAIN SYSTEM. THE PROPOSED RUNOFF FLOWRATE IS APPROXIMATELY 6.39 CFS, ESSENTIALLY THE SAME AS EXISTING CONDITIONS.	
	LANDSCAPED AREAS THROUGHOUT THE SITE WILL BE DEPRESSED FOR STORMWATER QUALITY HARVESTING PURPOSES. THE REMAINING VOLUME THAT ISN'T CAPTURED BY THESE AREAS WILL	Ъ Ш П Ц
	BE PAID FOR VIA CASH IN LIEU.	OV ERQL
	CONCLUSION: BASED ON THE INFORMATION PROVIDED ABOVE. THE PROPOSED RUNOFF FLOWRATES ARE SLIGHTLY SMALLER THAN EXISTING CONDITIONS AND MAINTAIN EXISTING HISTORIC DISCHARGE	
	LOCATIONS. THEREFORE, WE ARE IN CONFORMANCE WITH THE CITY OF ALBUQUERQUE HYDROLOGY REQUIREMENTS AND REQUEST SITE PLAN FOR BUILDING PERMIT APPROVAL.	
		PresNow 2100 Louisiana Albuquerq
	LEGEND	5 5 1
	- 4925 - EXISTING INDEX CONTOUR	
	- 4924 - EXISTING INTERMEDIATE CONTOUR	
	EXISTING GROUND SPOT ELEVATION	REVISIONS
	4925 PROPOSED INDEX CONTOUR	\land
	4924 PROPOSED INTERMEDIATE CONTOUR	Δ
	•XX.XX PROPOSED GRADE SPOT ELEVATION FL=FLOW LINE	\bigtriangleup
	TC=TOP OF CURB TS=TOP OF SIDEWALK	
	DIRECTION OF FLOW	DRAWN BY
		DATE 12/11/2020
		PROJECT NO. 20-0161.001 DRAWING NAME
		GRADING PLAN
	1"=20'	SHEET NO.
	Bohannan A Huston	C-100
	www.bhinc.com 800.877.5332	OF

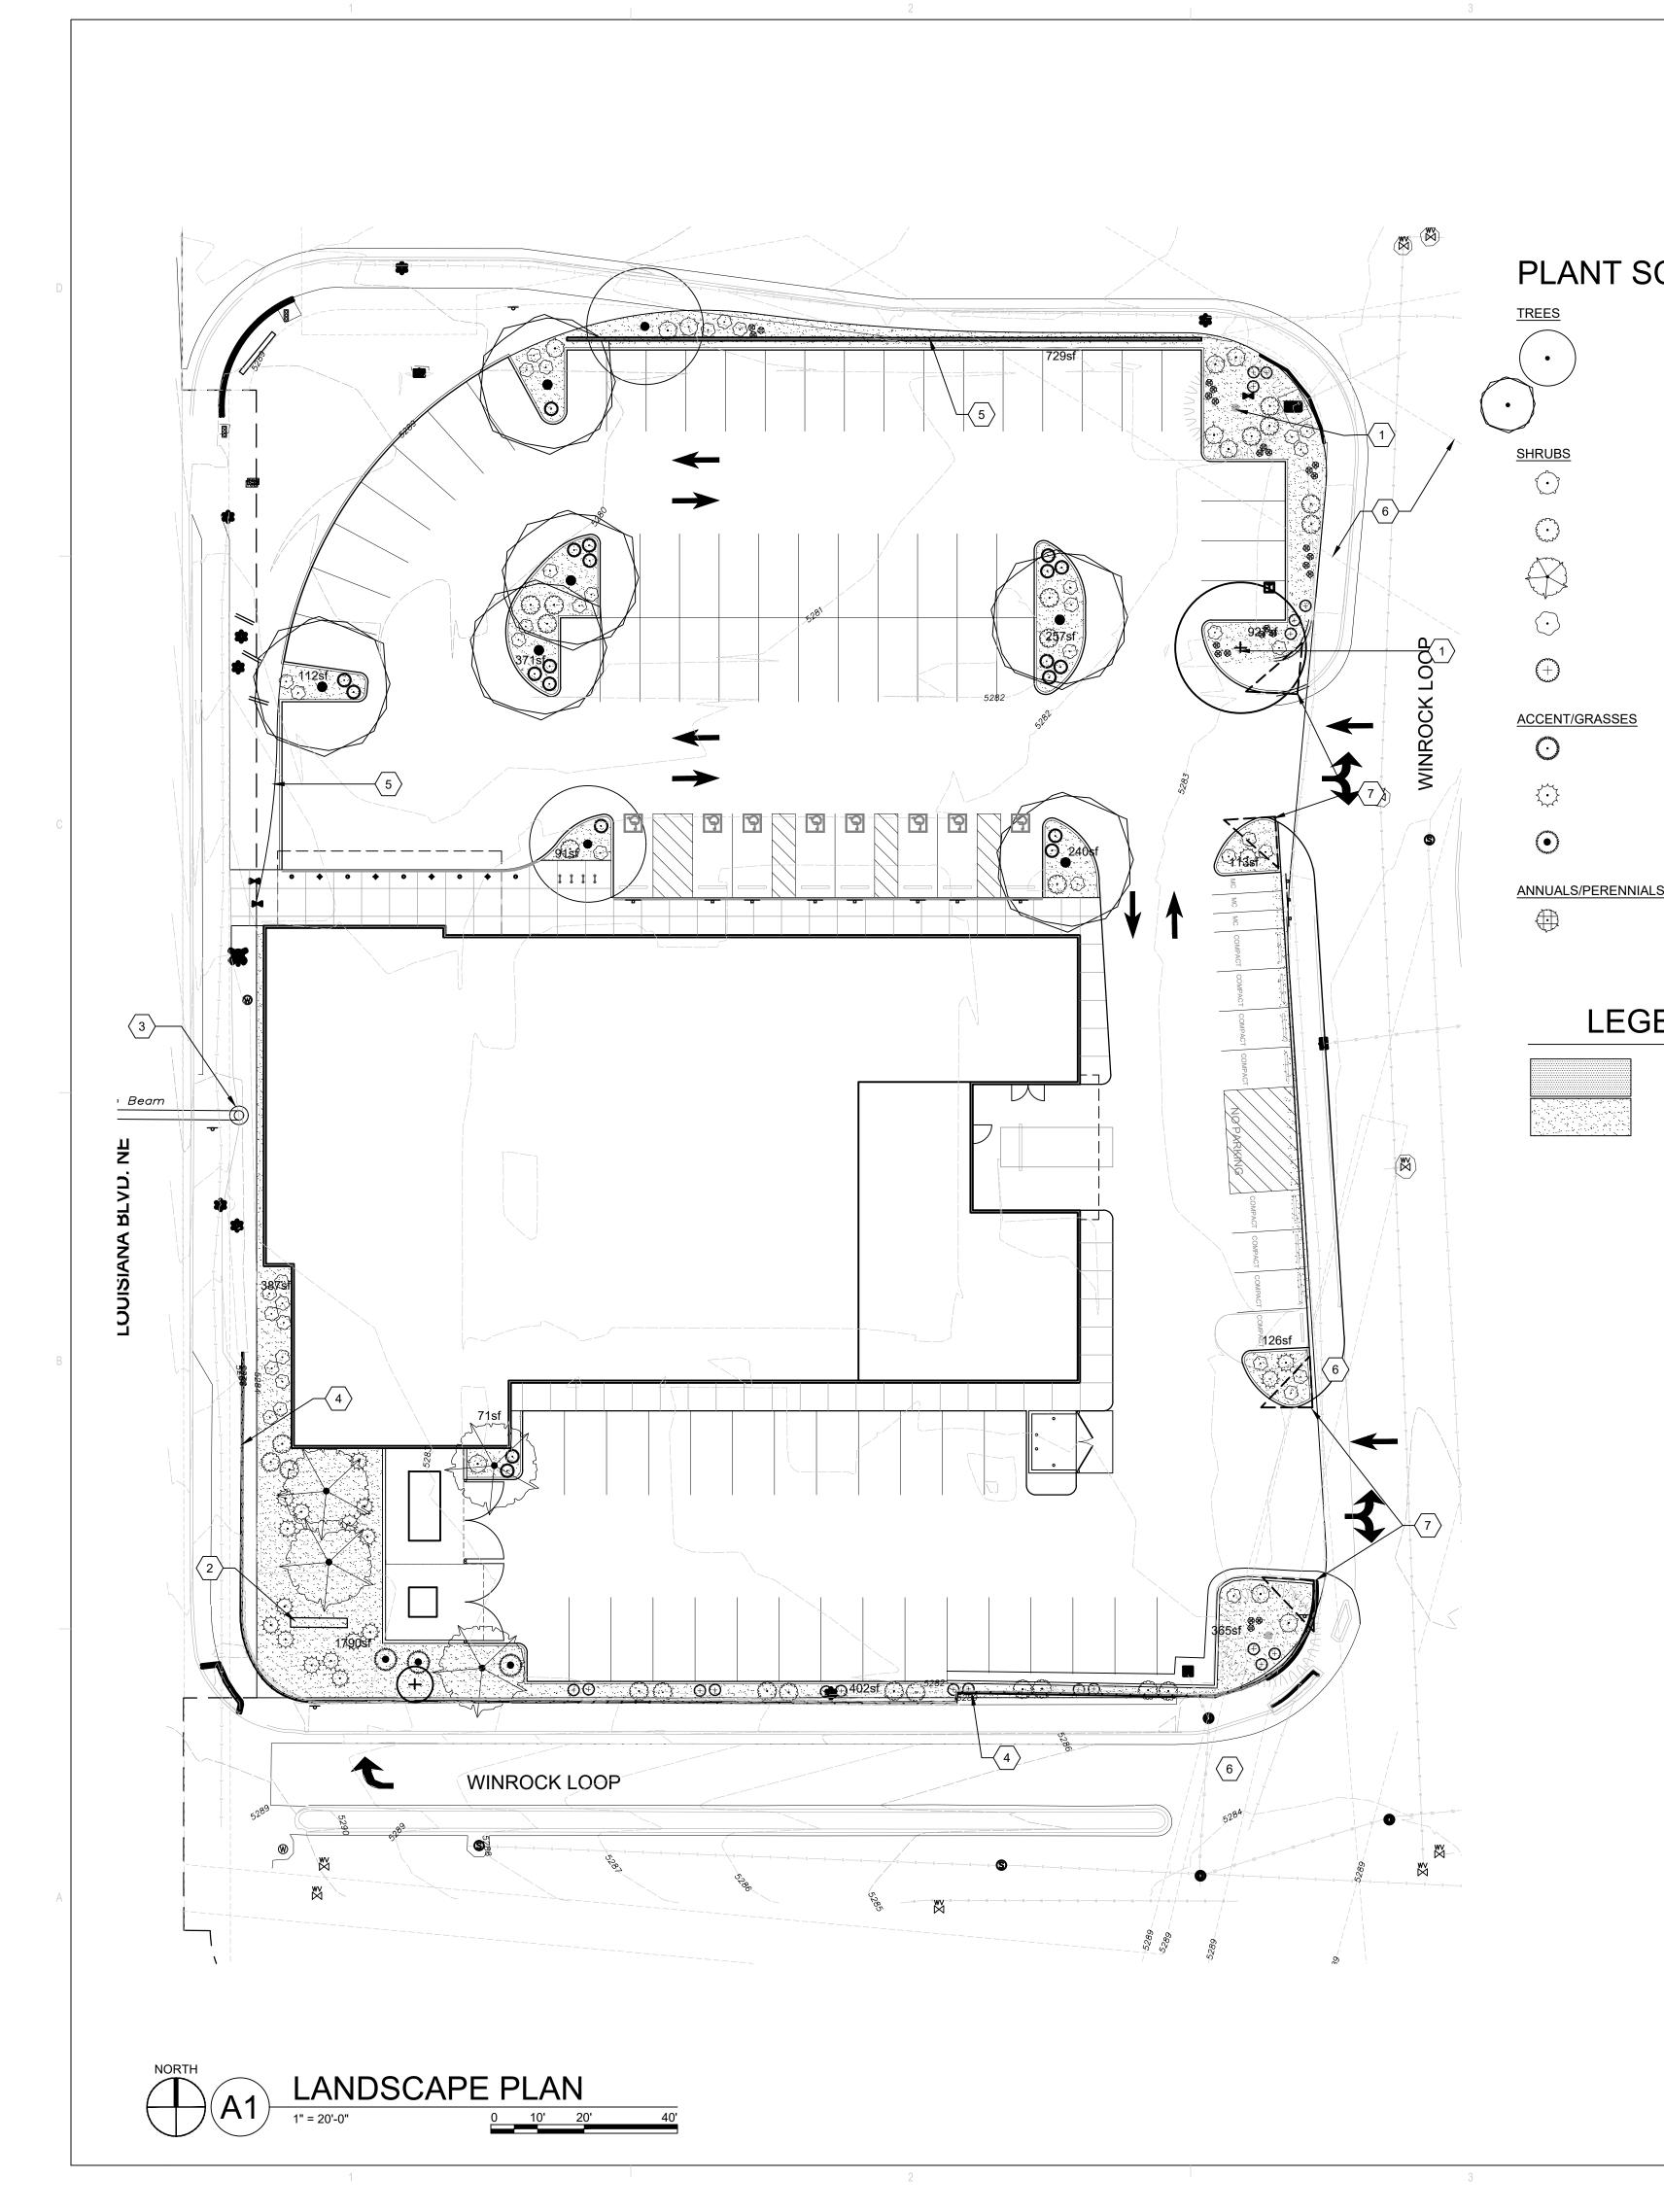

PLANT SCHEDULE

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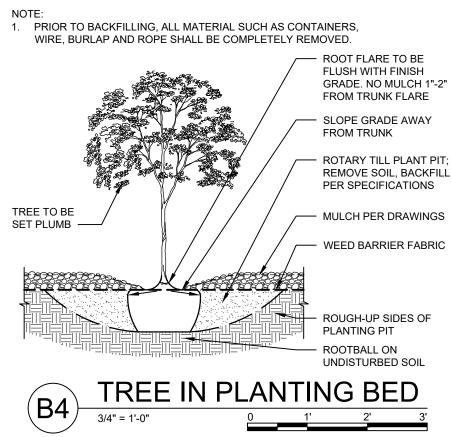
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<u>QTY</u>	BOTANICAL NAME	COMMON NAME
2	CHILOPSIS LINEARIS `ARTS SEEDLESS`	DESERT WILLOW
6	FRAXINUS PENNSYLVANICA `URBANITE`	URBANITE ASH
<u>QTY</u>	BOTANICAL NAME	COMMON NAME
10	CHAMAEBATIARIA MILLEFOLIUM	FERNBUSH
25	CISTUS X PURPUREUS	PURPLE ROCK ROSE
4	FORESTIERA NEOMEXICANA	NEW MEXICO PRIVET
40	PRUNUS BESSEYI	SAND CHERRY
19	SALVIA GREGGII `ULTRA VIOLET`	ULTRA VIOLET SAGE
<u>QTY</u>	BOTANICAL NAME	COMMON NAME
20	BOUTELOUA GRACILIS `BLONDE AMBITION`	BLONDE AMBITION BLU
18	DASYLIRION WHEELERI	DESERT SPOON
3	NOLINA MICROCARPA	BEARGRASS
<u>QTY</u>	BOTANICAL NAME	COMMON NAME
26	NEPETA `WALKER`S LOW`	WALKERS LOW CATMI


LEGEND

3" DEPTH ROCK MULCH WITH FILTER FABRIC

3" DEPTH ORGANIC MULCH WITH FILTER FABRIC



NOTES: 1. SEE TREE PROTECTION SPECIFICATION SECTION 01 5639.

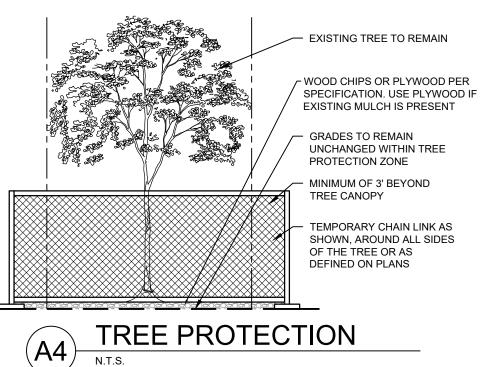

GENERAL SHEET NOTES A. LANDSCAPE MAINTENANCE SHALL BE THE RESPONSIBILITY OF THE PROPERTY OWNFR. B. THE LANDSCAPING SHALL COMPLY WITH THE CITY OF ALBUQUERQUE ZONING CODE INCLUDING, BUT NOT LIMITED TO, GENERAL LANDSCAPING REGULATIONS, WATER CONSERVATION LANDSCAPING AND WATER WASTE REGULATIONS. POLLEN-RELATED REGULATIONS, AND STREET TREE REGULATIONS. C. THE PROPERTY OWNER SHALL MAINTAIN RIGHT-OF-WAY (ROW) LANDSCAPING IN A NEAT AND HEALTHY CONDITION. THE PROPERTY OWNER ACKNOWLEDGES THAT APPROVED LANDSCAPING AND TREES IN THE RIGHT-OF-WAY MAY BE REMOVED WITHOUT COMPENSATION. D. LANDSCAPING WILL BE WATERED WITH AN AUTOMATED IRRIGATION SYSTEM THAT INCLUDES DRIP ZONES FOR ALL PLANT MATERIALS. . WATER MANAGEMENT IS THE RESPONSIBILITY OF THE PROPERTY OWNER. F. LANDSCAPE AREAS SHALL ACHIEVE 75% VEGETATIVE COVERAGE AT MATURITY. GROUND LEVEL PLANTS SHALL ACHIEVE 30% VEGETATIVE COVERAGE AT MATURITY. G. TREES ARE NOT REQUIRED TO BE STAKED, BUT TREES THAT BLOW OVER, SETTLE OR TIP WILL BE REQUIRED TO BE REPLACED OR RESET BY THE CONTRACTOR AT NO COST TO THE OWNER. H. RESPONSIBILITY FOR MAINTENANCE: THE CONTRACTOR WILL BE RESPONSIBLE FOR MAINTENANCE OF THE LANDSCAPE DURING CONSTRUCTION AND DURING A 90 DAY-MAINTENANCE PERIOD FOLLOWING SUBSTANTIAL COMPLETION. THE OWNER WILL BE RESPONSIBLE FOR MAINTENANCE FOLLOWING THE 90-DAY MAINTENANCE PERIOD. TIMING OF LANDSCAPE INSTALLATION: INSTALLATION OF THE LANDSCAPING SHALL BE COMPLETE WITHIN 60 DAYS OF THE RELATED BUILDING'S OCCUPANCY. ARCHITECT J. MINIMUM PLANT SIZES ARE AS PER CITY OF ALBUQUERQUE STANDARDS: 2" CALIPER TREES, 6' HEIGHT CONIFERS, AND 1 GALLON SHRUBS. K. ALL AREAS DISTURBED DURING CONSTRUCTION, INCLUDING AREAS NOT WITHIN THE PROPERTY LINE, WILL BE STABILIZED. L. ALL VEGETATIVE SCREENING SURROUNDING GROUND-MOUNTED

TRANSFORMERS AND UTILITY PADS SHALL ALLOW 10' OF CLEARANCE IN

N. LANDSCAPE MULCH AREAS ADJACENT TO SIDEWALKS SHALL BE A MAXIMUM

O. LANDSCAPING AND SIGNAGE WILL NOT INTERFERE WITH CLEAR SIGHT

REQUIREMENTS. THEREFORE SIGNS, WALL, TREES, AND SHRUBBERY BETWEEN 3 AND 8 FEET TALL (AS MEASURED FROM THE GUTTER PAN) WILL

FRONT OF THE EQUIPMENT DOOR AND 5' OF CLEARANCE ON THE

REMAINING SIDES FOR SAFE OPERATION AND MAINTENANCE. M. CONTRACTOR IS TO VERIFY ALL EXISTING UTILITY LOCATIONS BEFORE

EXCAVATION AND PLANTING.

OF $\frac{1}{4}$ " BELOW ADJACENT SIDEWALK GRADE.

1. EXISTING TREE TO REMAIN. SEE A4/LP101.

4. EXISTING RETAINING WALL AND GUARDRAIL

5. PROPOSED PARKING SCREENING WALL.

7. CLEAR SIGHT TRIANGLE. SEE NOTE O.

6. EXISTING UTILITY EASEMENT

CONSTRUCTION.

CONSTRUCTION.

PARKING

+

NOT BE ACCEPTABLE IN THE CLEAR SIGHT TRIANGLE.

SHEET KEYED NOTES

2. EXISTING MARQUEE SIGN TO REMAIN AND BE PROTECTED DURING

3. EXISTING PUBLIC INFRASTRUCTURE TO RETAIN AND BE PROTECTED DURING

RIVET

TION BLUE GRAMA

CATMINT

LEGEND EXISTING DECIDUOUS TREES TO REMAIN. SEE A4/LP101.



PROPERTY LINE

PARKING SCREENING NOTES

PARKING SCREENING ALONG WINROCK LOOP ROAD NORTH: ACCOMPLISHED WITH 3'-4' CMU WALLS IN FRONT OF

PARKING BUFFER ALONG LOUISIANA BOULEVARD: ACCOMPLISHED WITH THE EXISTING 8'-0" RETAINING WALL FROM SOUTH AND LANDSCAPE BUFFER ON NORTHWEST CORNER.

LANDSCAPE CALCULATIONS

GROSS LOT AREA = 1.47 AC = 64,091 SF AREA OF LOT COVERED BY BUILDINGS = 17,100 SF NET LOT AREA= 46,991 SF

REQUIRED LANDSCAPE REQUIRED LANDSCAPE AREA = 4,699 SF (10% OF NET LOT AREA) PROVIDED LANDSCAPE AREA = 5,896 SF (12.5% OF NET LOT AREA) REQUIRED TREES TREES PER PARKING SPACES: REQUIRED= 1 TREE / 6 PARKING SPACES

TOTAL NUMBER OF PARKING = 99 SPACES REQUIRED NUMBER OF PARKING LOT TREES = 17 TREES PROVIDED NUMBER OF PARKING LOT TREES = 10 TREES (including existing trees to remain) REQUIRED STREET TREES = 1 TREE PER 30' LINEAR FEET OF STREET FRONTAGE STREET TREES = LOUISIANANA BOULEVARD FRONTAGE = 268' REQUIRED / PROVIDED STREET TREES = 9 / 1

- AMERICAS PARKWAY FRONTAGE = 193' REQUIRED / PROVIDED STREET TREES = 6 / 3
- EXISTING TREE CREDITS • 2 EXISTING PINES AT 8" CALIPER = 4 TREES
- 1 TREE AT 12" CALIPER = 4 TREES
- 1 TREE AT 4" CALIPER = 1 TREE • TOTAL NUMBER OF EXISTING TREES CREDITED =9 TREES

<u>REQUIRED VEGETATIVE COVERAGE</u> TOTAL VEGETATIVE COVER REQUIRED = 3,524 SF (75% OF LANDSCAPE AREA)

TOTAL VEGETATIVE COVER PROVIDED =8,620 SF (146% OF LANDSCAPE AREA) TOTAL GROUND-LEVEL PLANT COVER REQUIRED = 1,249 SF (25% OF LANDSCAPE

AREA) TOTAL GROUND-LEVEL PLANT COVER PROVIDED = 1,316 SF (28% OF LANDSCAPE AREA)

ROCK MULCH COVERAGE


TOTAL ROCK MULCH COVER ALLOWED = 3,524 SF (75% OF LANDSCAPE AREA) TOTAL ROCK MULCH COVER PROVIDED = 2,968 SF (46% OF LANDSCAPE AREA)

DEKKER PERICH SABATINI

ARCHITECTURE DESIGN INSPIRATION

PROJECT



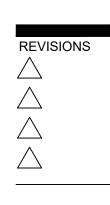

DRAWN BY

DATE


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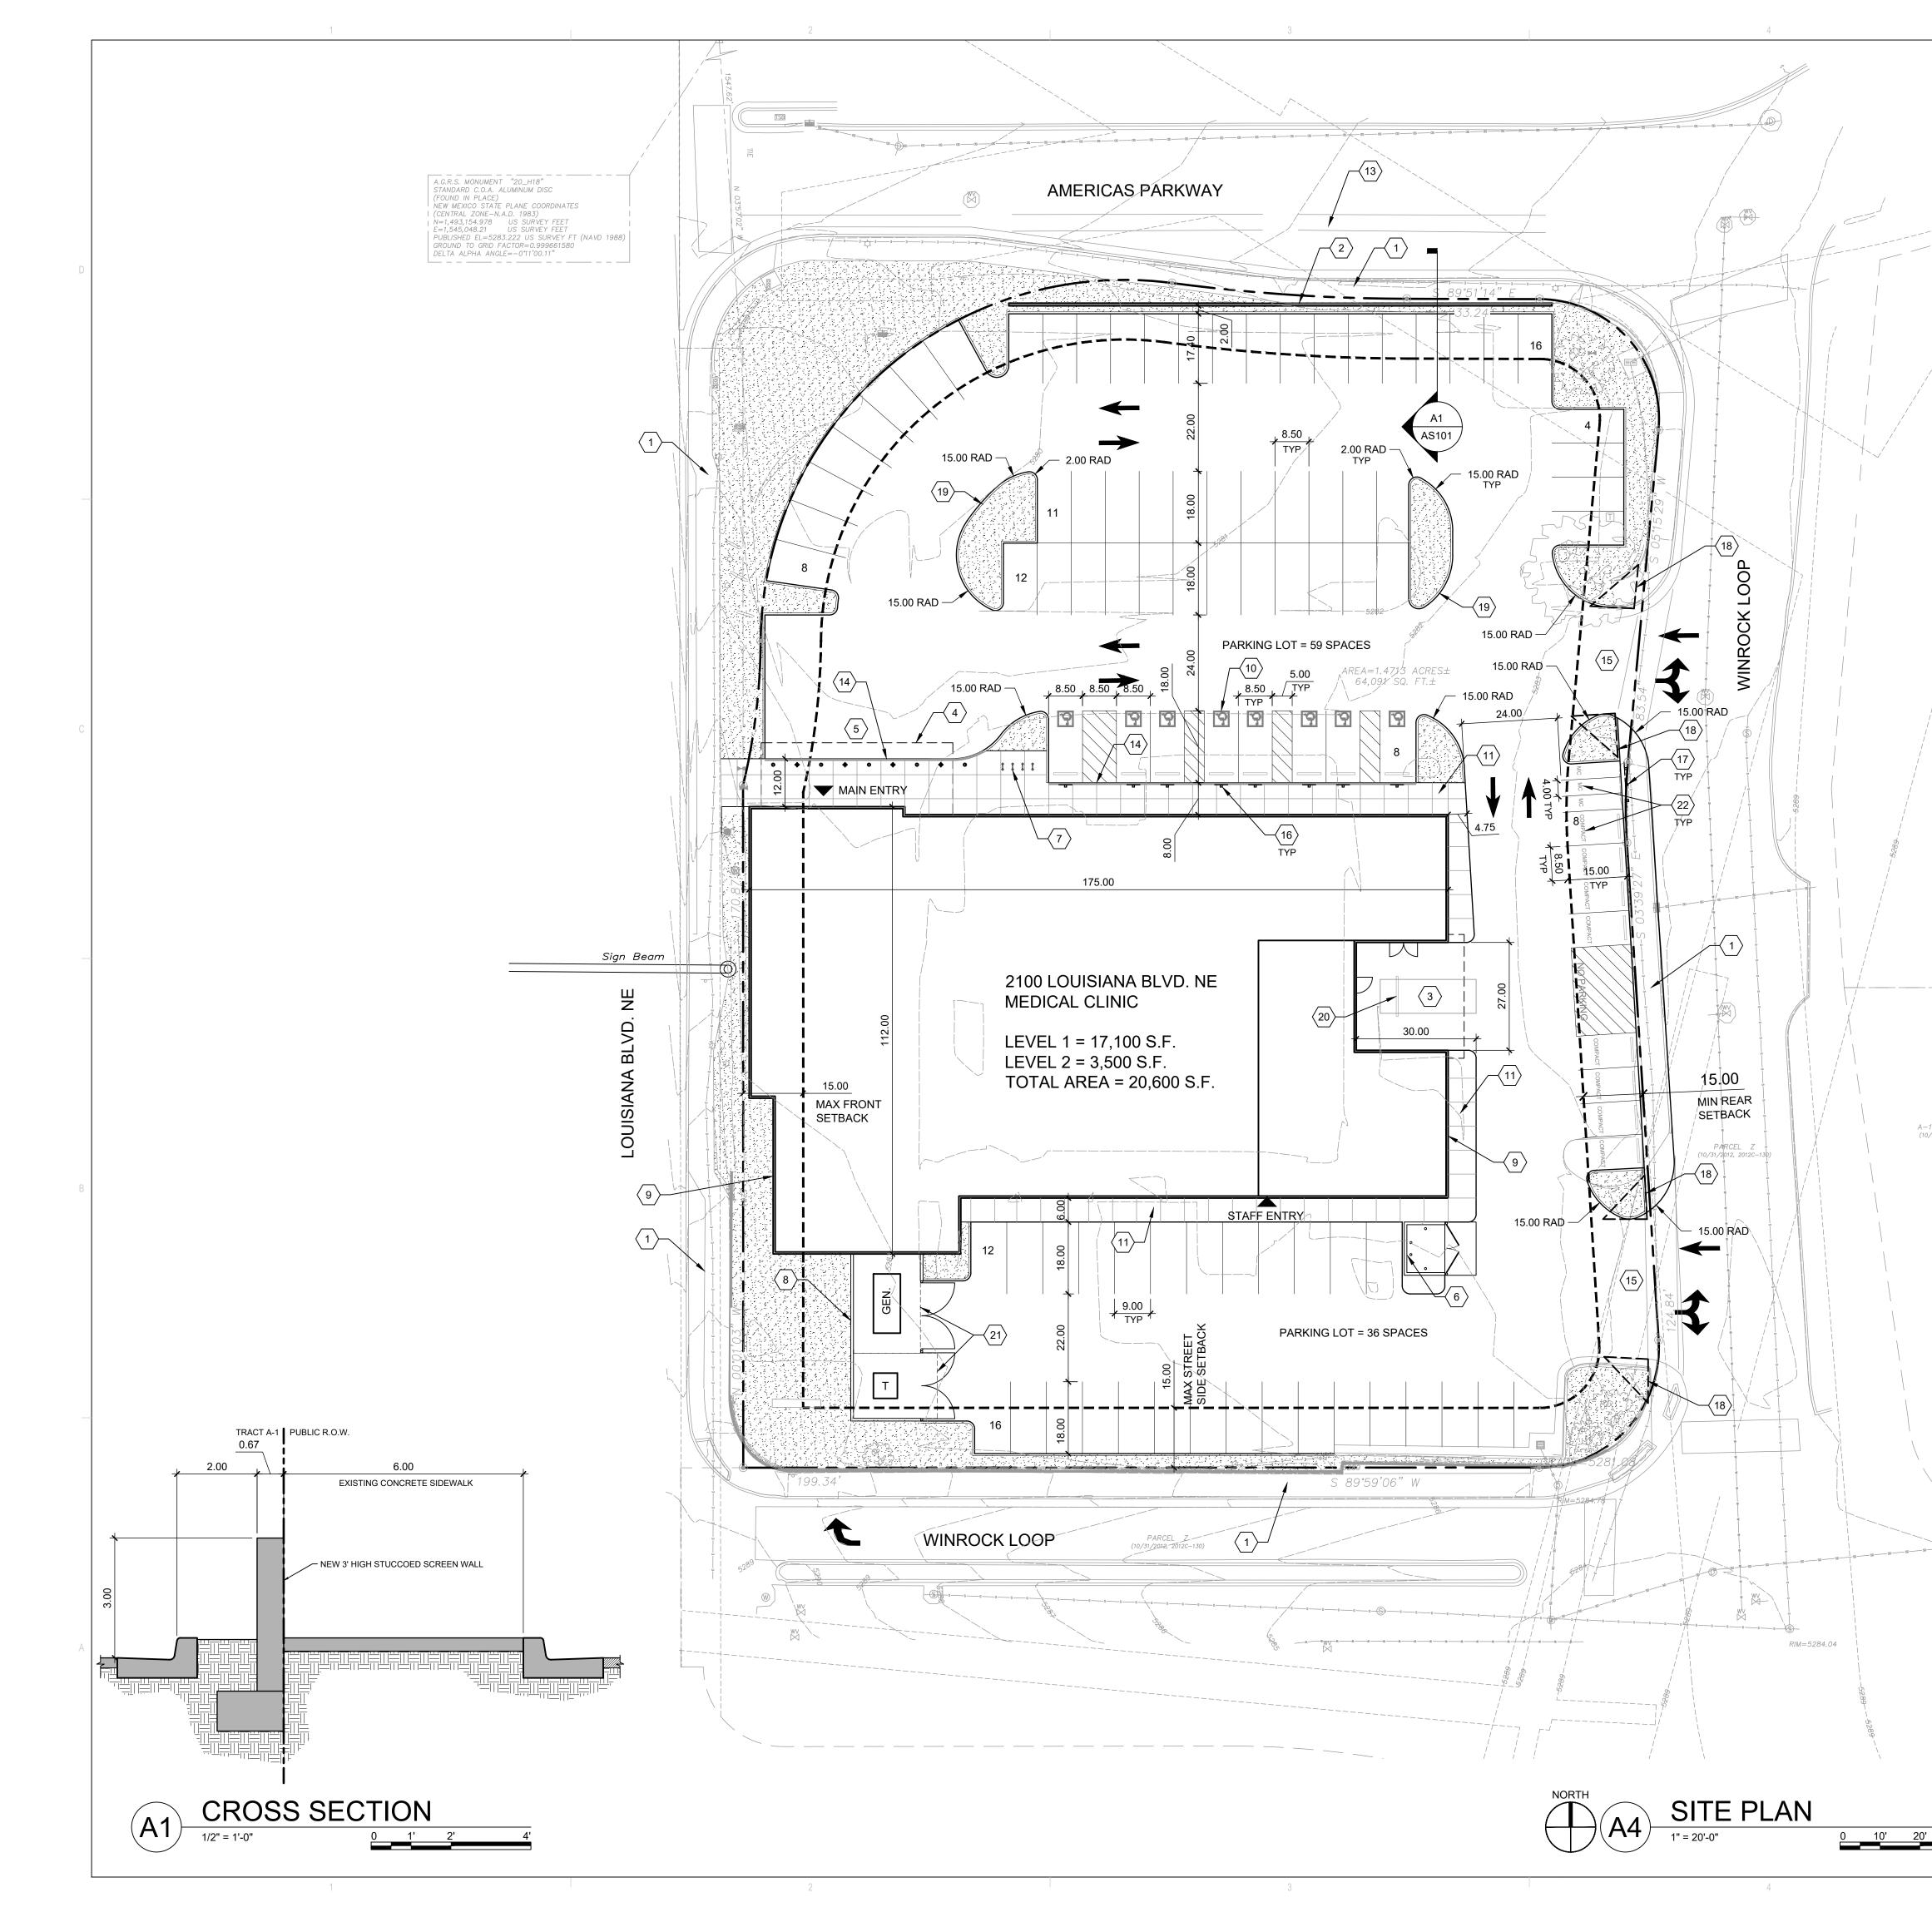
PROJECT NO.

DRAWING NAME

KR KR 12/11/2020 20-0161.001

LANDSCAPE PLAN



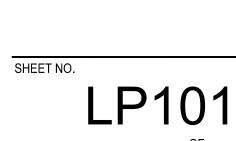

GENERAL SHEET NOTES

1. ALL PARKING AREAS DRIVE AISLES AND AUTOMOTIVE CIRCULATION PATHS TO BE ASPHALT PAVING. 2. ALL SIDEWALKS AND RAMPS TO BE CONCRETE.

PROJECT DATA

BUILDING AREA: 18,000 SQ. FT.

CONSTRUCTION TYPE: IIB OCCUPANCY TYPE: B

AN AUTOMATIC SPRINKLER AND SMOKE DETECTION SYSTEM SHALL BE INSTALLED THROUGHOUT THE BUILDING. SPRINKLER CONTRACTOR TO SUBMIT SHOP DRAWINGS TO THE AUTHORITY HAVING JURISDICTION. FIRE ALARM SYSTEM TO BE PROVIDED.

REQUIRED

1

FIRE FLOW: IFC TABLE b105.1(2) MEDICAL OFFICE 2,750/2 = 1,375 GPM

FIRE HYDRANTS: MEDICAL OFFICE = PROVIDED 1 (500' SPACING)

PARKING CALCULATIONS

MEDICAL OFFICE REQUIRED PROVIDED 20,600 S.F. @ 3 SPACES PER 1,000 S.F. = 62 SPACES 95 SPACES ACCESSIBLE PARKING REQUIRED PROVIDED 51-100 SPACES 4 8 6 ACCESSIBLE, 2 VAN ACCESSIBLE MOTORCYCLE SPACES 51-100 SPACES REQUIRED PROVIDED 3 3 BICYCLE PARKING 10% OF REQUIRED OFF-STREET PARKING REQUIRED PROVIDED

○ SHEET KEYED NOTES

- EXISTING 6' WIDE PUBLIC SIDEWALK.
- NEW 3' HIGH SITE WALL TO SCREEN THE HEADLIGHTS OF PARKED VEHICLES. AMBULANCE/LOADING AREA
- CANOPY OVERHEAD PATIENT PICK-UP / DROP-OFF
- 6. DUMPSTER ENCLOSURE. SEE DETAIL D5/AS501
- BIKE RACK (8 SPACES). SEE DETAIL A4/AS501
- 8' HIGH CMU SCREEN WALL. SEE DETAIL A3/AS501 9. BUILDING MOUNTED SIGN (TYPE A). SEE ELEVATIONS AND DETAIL D1/AS501
- 10. HC PARKING. SEE DETAIL D4/AS501
- 11. NEW CONCRETE SIDEWALK. 12. LANDSCAPING AND SIGNAGE WILL NOT INTERFERE WITH CLEAR SIGHT REQUIREMENTS. THEREFORE SIGNS, WALL, TREES, AND SHRUBBERY BETWEEN 3 AND 8 FEET TALL (AS MEASURED FROM THE GUTTER PAN) WILL NOT BE ACCEPTABLE IN THE CLEAR SIGHT TRIANGLE.
- 13. EXISTING BIKE LANE 14. GRAY LINE INDICATES FLUSH CONCRETE SIDEWALK. SEE DETAIL D3/AS501
- 15. EXISTING DRIVEWAY
- 16. HC PARKING SIGN, SEE B4/AS501
- 17. MOTORCYCLE PARKING ONLY SIGN, SEE B4/AS501 18. LANDSCAPING AND SIGNAGE WILL NOT INTERFERE WITH CLEAR SIGHT REQUIREMENTS. THEREFORE SIGNS, WALL, TREES, AND SHRUBBERY BETWEEN 3 AND 8 FEET TALL (AS MEASURED FROM THE GUTTER PAN) WILL NOT BE ACCEPTABLE IN THE CLEAR SIGHT TRIANGLE 19. 6" CONCRETE CURB AND GUTTER, SEE A2/AS501
- 20. 8' CONCRETE PARKING BUMPER. CONFIRM EXACT LOCATION WITH PHS AMBULANCE REQUIREMENTS. SEE C1/AS501
- 21. REQUIRED EQUIPMENT CLEARANCE 22. LABEL "MC" AT THE BACK OF MOTORCYCLE SPACES AND "COMPACT" AT THE BACK OF COMPACT SPACES.

LEGEND

PARCEL A—1—A—1—A—1—A—2 (10/31/2012, 2012C–130)

PROPERTY LINE ____

BUILDING SETBACK

FIRE HYDRANT

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LANDSCAPE AREA

POLE LIGHT (20' MAX HEIGHT), SEE DETAIL A5/AS501


SIDEWALK RAMP (ARROW POINTS DOWN)

\mathcal{C} M/C C/C GEN.

MOTORCYCLE SPACE, 4' X 8' MINIMUM, UNLESS NOTED OTHERWISE COMPACT CAR SPACE, 7.5' X 15' MINIMUM, UNLESS NOTED OTHERWISE EMERGENCY BACK-UP GENERATOR

ELECTRICAL TRANSFORMER

KEYPLAN

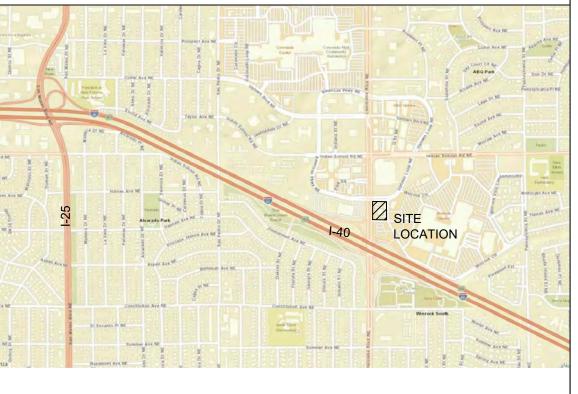





DATE

DRAWING NAME

DEKKER PERICH SABATINI

ARCHITECTURE DESIGN INSPIRATION

ARCHITECT

Project	SITE DEVELOPMENT PLAN 2100 LOUISIANA BLVD. NE ALBUQUERQUE, NM	


REVISIONS 12/10/2020 MINOR AMENDMENT \triangle DRAWN BY


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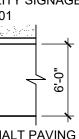
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ARCHITECTURAL SITE PLAN








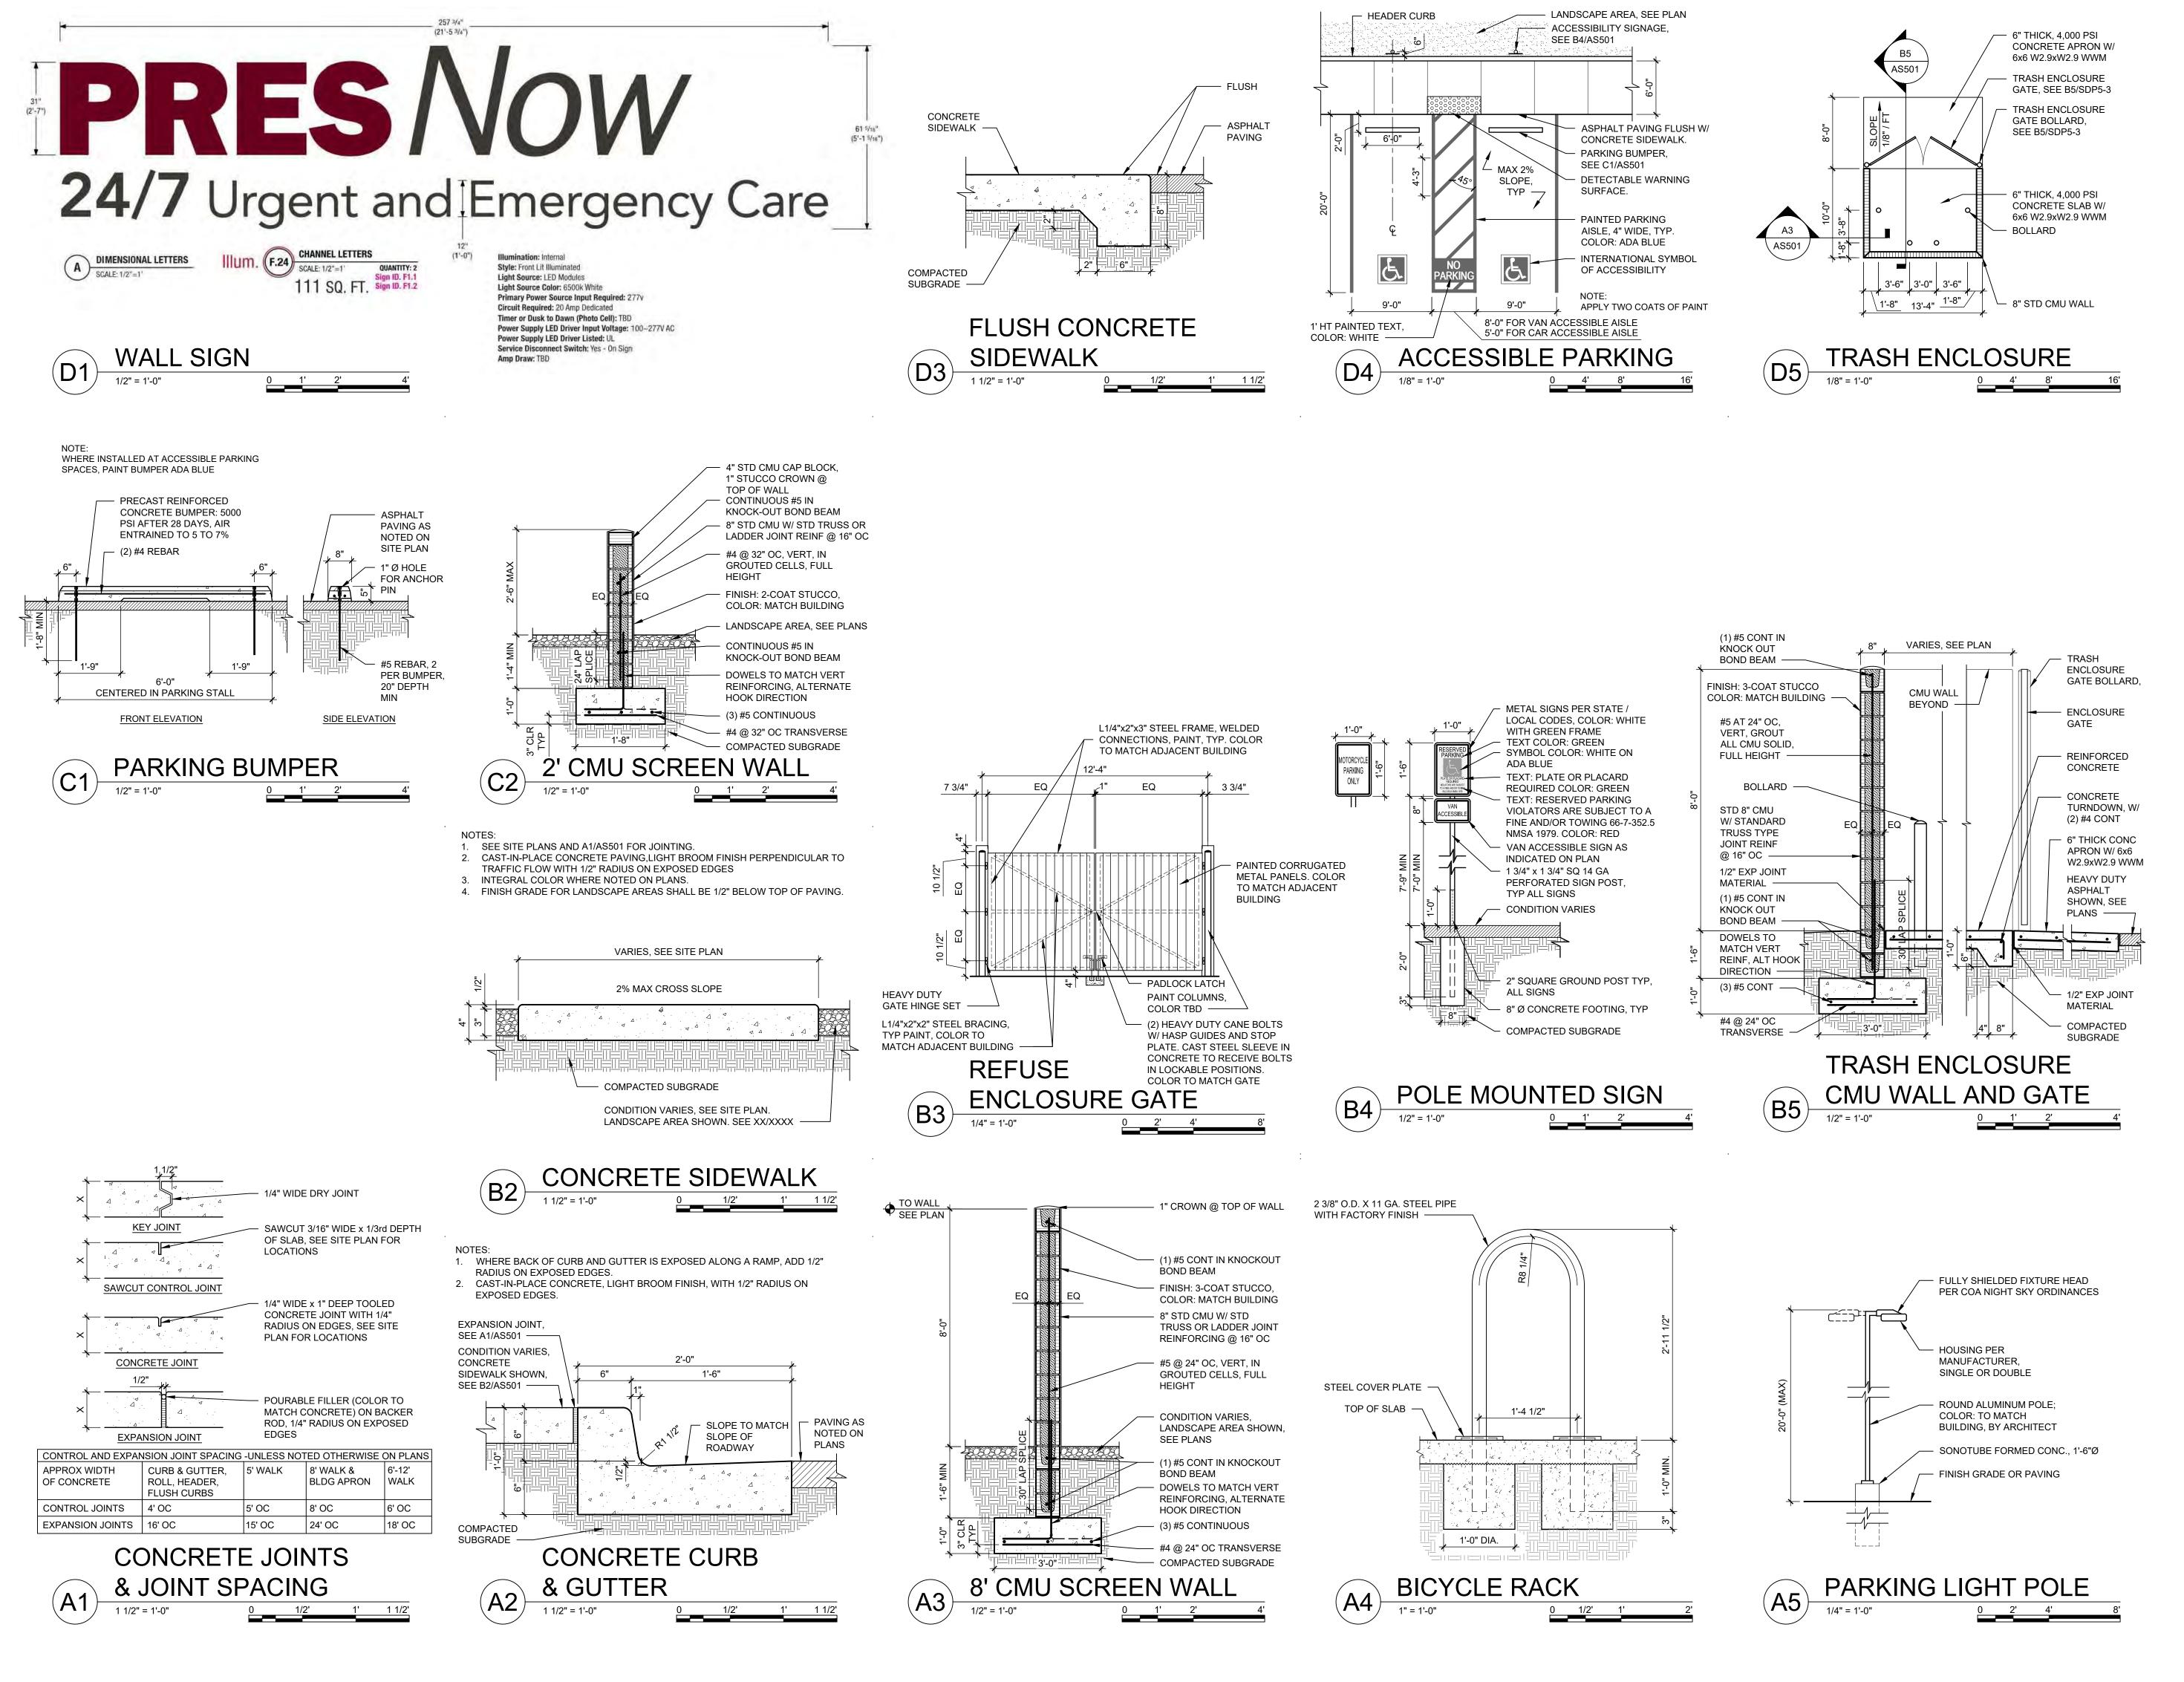

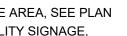

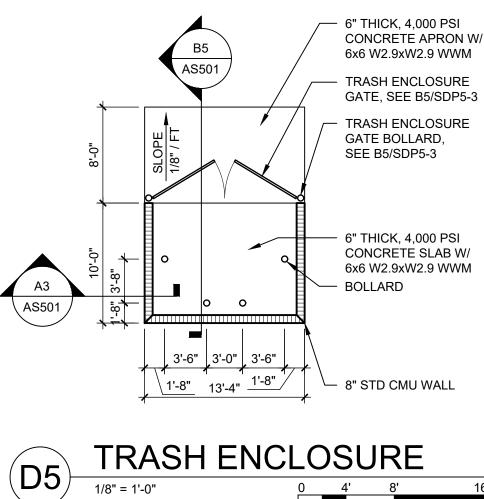

SITE DETAILS

AS501



DEKKER PERICH SABATINI ARCHITECTURE DESIGN

INSPIRATION

SEAL PROJECT VD NE NM 2100 LOUISIANA BL' ALBUQUERQUE, 5 PresNow 24 REVISIONS \triangle \triangle $\overline{\bigtriangleup}$ DRAWN BY J. MEDRANO **REVIEWED BY** J. MEDRANO 12/11/2020 DATE PROJECT NO: 20-0161.001 DRAWING NAME EXTERIOR ELEVATIONS

SHEET NO

