

ARCHITECTURE / DESIGN / INSPIRATION

DEKKER PERICH SABATINI

7601 JEFFERSON NE, SUITE 100 ALBUQUERQUE, NM 87109

505.761.9700 / DPSDESIGN.ORG

ARCHITECT

ENGINEER

PROJECT

REVISIONS

DRAWN BY ARS **REVIEWED BY** DATE

1/15/2019 PROJECT NO. 18-0103.001 DRAWING NAME

SITE PLAN

GENERAL SHEET NOTES

DASYLIRION WHEELERI

ELAEAGNUS PUNGENS

ERICAMERIA LARICIFOLIA

- A. RESPONSIBILITY FOR MAINTENANCE: THE CONTRACTOR WILL BE RESPONSIBLE FOR MAINTENANCE OF THE LANDSCAPE DURING CONSTRUCTION AND DURING A 90 DAY-MAINTENANCE PERIOD FOLLOWING SUBSTANTIAL COMPLETION. THE OWNER WILL BE RESPONSIBLE FOR MAINTENANCE FOLLOWING THE 90-DAY MAINTENANCE PERIOD.
- B. STATEMENT OF COMPLIANCE WITH CITY OF ALBUQUERQUE: THE LANDSCAPE DESIGN WILL COMPLY WITH THE CITY OF ALBUQUERQUE'S GENERAL LANDSCAPING REGULATIONS AND WATER CONSERVATION ORDINANCES.

CHAMAEBATIARIA MILLEFOLIUM

- C. TIMING OF LANDSCAPE INSTALLATION: INSTALLATION OF THE LANDSCAPING SHALL BE COMPLETE WITHIN 60 DAYS OF THE RELATED BUILDING'S OCCUPANCY. D. SURFACE TREATMENT: ALL LANDSCAPE AREAS SHALL BE COVERED WITH
- SEEDING, VEGETATION OR MULCH. E. LANDSCAPE, FENCING, AND SIGNING WILL NOT INTERFERE WITH CLEAR SIGHT REQUIREMENTS. THEREFORE, SIGNS, WALLS, TREES, AND SHRUBBERY BETWEEN
- 3' AND 8' (AS MEASURED FROM THE GUTTER PAN) WILL NOT BE ACCEPTABLE IN THIS AREA. F. MINIMUM PLANT SIZES ARE AS PER CITY OF ALBUQUERQUE STANDARDS: 2"
- CALIPER TREES, 6' HEIGHT CONIFERS, AND 1 GALLON SHRUBS. G. ALL AREAS DISTURBED DURING CONSTRUCTION, INCLUDING AREAS NOT WITHIN THE PROPERTY LINE, WILL BE STABILIZED. H. ROOF DRAINS: SURFACE DRAINAGE OFF DOWNSPOUTS SHALL BE DIRECTED
- AWAY FROM BUILDINGS INTO LANDSCAPE AREAS OR ENGINEERED DRAINAGE SYSTEM. REFER TO CIVIL. I. ALL VEGETATIVE SCREENING SURROUNDING GROUND-MOUNTED TRANSFORMERS AND UTILITY PADS SHALL ALLOW 10' OF CLEARANCE IN FRONT OF THE EQUIPMENT DOOR AND 5' OF CLEARANCE ON THE REMAINING SIDES FOR
- SAFE OPERATION AND MAINTENANCE. J. CONTRACTOR IS TO VERIFY ALL EXISTING UTILITY LOCATIONS BEFORE EXCAVATION AND PLANTING.
- K. PHASING: THE PROPERTY WILL BE DEVELOPED IN TWO PHASES. L. THERE IS NO EXISTING VEGETATION THAT WILL BE PRESERVED ON THE SITE.

IRRIGATION NOTES

5 GAL

5 GAL

5 GAL

1. ALL PLANTINGS SHALL BE IRRIGATED BY AN AUTOMATED IRRIGATION SYSTEM, WITH PROGRAMMABLE SETTINGS, AUTOMATED IRRIGATION CONTROLLER, AND MOISTURE SENSOR TO AVOID OVERWATERING.

LOW

LOW

MED

LOW

118

- 2. THE IRRIGATION SYSTEM SHALL BE DESIGNED TO MINIMIZE THE USE OF WATER. 3. THE IRRIGATION SYSTEM SHALL NOT IRRIGATE IMPERVIOUS SURFACES, INCLUDING SIDEWALKS, DRIVEWAYS, STREETS AND PARKING OR LOADING
- 4. IRRIGATION POINT OF CONNECTION TO THE CITY WATER WILL BE LOCATED WITHIN PROPERTY LIMITS AND SHALL COMPLY WITH THE CITY OF ALBUQUERQUE REDUCED PRESSURE BACKFLOW PREVENTER STANDARDS AND
- SPECIFICATIONS. 5. RUN TIMES AND IRRIGATION ZONES SHALL BE BASED UPON PLANT SPECIES AND THEIR ESTABLISHMENT. RUN TIMES SHALL BE REGULARLY ADJUSTED ACCORDING TO PLANT MATURITY, SEASON, LOCATION AND PERFORMANCE.

○ SHEET KEYED NOTES

- 1. CLEAR SIGHT TRIANGLE. 2. PONDING AREA, SEE CIVIL.
- 4. PHASE LINE.

FERNBUSH

SILVERBERRY

TURPENTINE BUSH

GREY DESERT SPOON

- PROPERTY LINE. 5. PARKING LOT BUFFER PER COA IDO, SEE PARKING BUFFER CALCULATIONS.
- 6. 96"x24"x12" RAISED PLANTERS WITH SURFACE PLANTED TO ACHIEVE A MINIMUM OF 75% VEGETATIVE COVERAGE AT MATURITY.

PERVIOUS AREA LEGEND

BOUTELOUA GRACILIS 'BLONDE AMBITION'

CALAMAGROSTIS X ACUTIFLORA 'KARL FOERSTER'

HELICTOTRICHON SEMPERVIRENS 'SAPPHIRE'

MUHLENBERGIA RIGIDA 'NASHVILLE' TM

BLUE GRAMA

FEATHER REED GRASS

CANOPY

DRIPLINE -

BLUE OAT GRASS

PURPLE MUHLY

EST QTY SYMBOL **NOTES** 7/8"Ø GRAVEL MULCH 60,511 SF 3" DEPTH OVER FILTER FABRIC MOUNTAINAIR BROWN

14,254 SF 7/8"Ø GRAVEL MULCH 3" DEPTH OVER FILTER FABRIC MOUNTAINAIR BROWN IN RIGHT-OF-WAY, NOT INCLUDED IN LANDSCAPE AREA CALCULATIONS

SHREDDED SCREENED WOOD MULCH 14,980 SF 3" DEPTH

IRRIGATED NATIVE SEED MIX 5,045 SF

TREE PLANTING DETAIL

1 GAL

1 GAL

1 GAL

1. PRIOR TO BACKFILLING, ALL MATERIAL SUCH AS CONTAINERS, WIRE, BURLAP AND ROPE SHALL BE COMPLETELY REMOVED. 2. ALL PLANT MATERIAL SHALL BE PLANTED IN UNCOMPACTED SOIL.

3 TIMES ROOTBALL DIAMETER

MULCH 1"-2" FROM TRUNK - SHREDDED BARK MULCH TO TREE TO BE COVER THE EXTENT OF DRIPLINE SET PLUMB TO SATISFY 14-16-5-6(C)(5) IDO REQUIREMENT SLOPE GRADE AWAY FROM TRUNK - ROTARY TILL PLANT PIT;

REMOVE SOIL, BACKFILL PER SPECIFICATIONS MULCH PER DRAWINGS

205

47

- WEED BARRIER FABRIC, SEE SPECS

ROUGH-UP SIDES OF PLANTING PIT ROOTBALL ON UNDISTURBED SOIL

ROOT FLARE TO BE FLUSH

WITH FINISH GRADE. NO

LANDSCAPE CALCULATIONS

GROSS LOT AREA = 6.8388 AC = 297,898 SF AREA OF LOT COVERED BY BUILDINGS = 51,000 SF **NET LOT AREA= 246,898 SF**

(see hatch legend for exclusions from landscape areas)

REQUIRED LANDSCAPE AREA = 37,035 SF (15% OF NET LOT AREA) PROVIDED LANDSCAPE AREA = 80,872 SF (33% OF NET LOT AREA)

TREES PER PARKING SPACES: REQUIRED= 1 TREE / 6 PARKING SPACES TOTAL NUMBER OF PARKING = 255 SPACES REQUIRED NUMBER OF PARKING LOT TREES = 43 TREES PROVIDED NUMBER OF PARKING LOT TREES = 43 TREES REQUIRED STREET TREES = 1 TREE PER 30' LINEAR FEET OF STREET FRONTAGE STREET TREES =

WESTERN TRAIL FRONTAGE = 302' REQUIRED / PROVIDED STREET TREES = 10 / 10 COORS BLVD FRONTAGE = 1,131' REQUIRED / PROVIDED STREET TREES = 38 / 38 MILNE RD FRONTAGE = 345' REQUIRED / PROVIDED STREET TREES = 12 / 12

REQUIRED VEGETATIVE COVERAGE TOTAL VEGETATIVE COVER REQUIRED = 60,656 SF (75% OF LANDSCAPE AREA)

TOTAL VEGETATIVE COVER PROVIDED = 60,721 SF (75% OF LANDSCAPE AREA) TOTAL GROUND-LEVEL PLANT COVER REQUIRED = 20,219 SF (25% OF LANDSCAPE AREA) TOTAL GROUND-LEVEL PLANT COVER PROVIDED = 20,509 SF (25% OF LANDSCAPE AREA)

TOTAL ROCK MULCH COVER ALLOWED = 60,656 SF (75% OF LANDSCAPE AREA) TOTAL ROCK MULCH COVER PROVIDED = 60,654 SF (75% OF LANDSCAPE AREA) SABATIN

PERICH

505.761.9700 / DPSDESIGN.ORG

PROJECT

BLVD. ERQUE TORY COORS BU


REVISIONS

DRAWN BY **REVIEWED BY** MB 1/15/2019 PROJECT NO. 18-0103.001

LANDSCAPE PLAN

SHEET NO.

DRAWING NAME

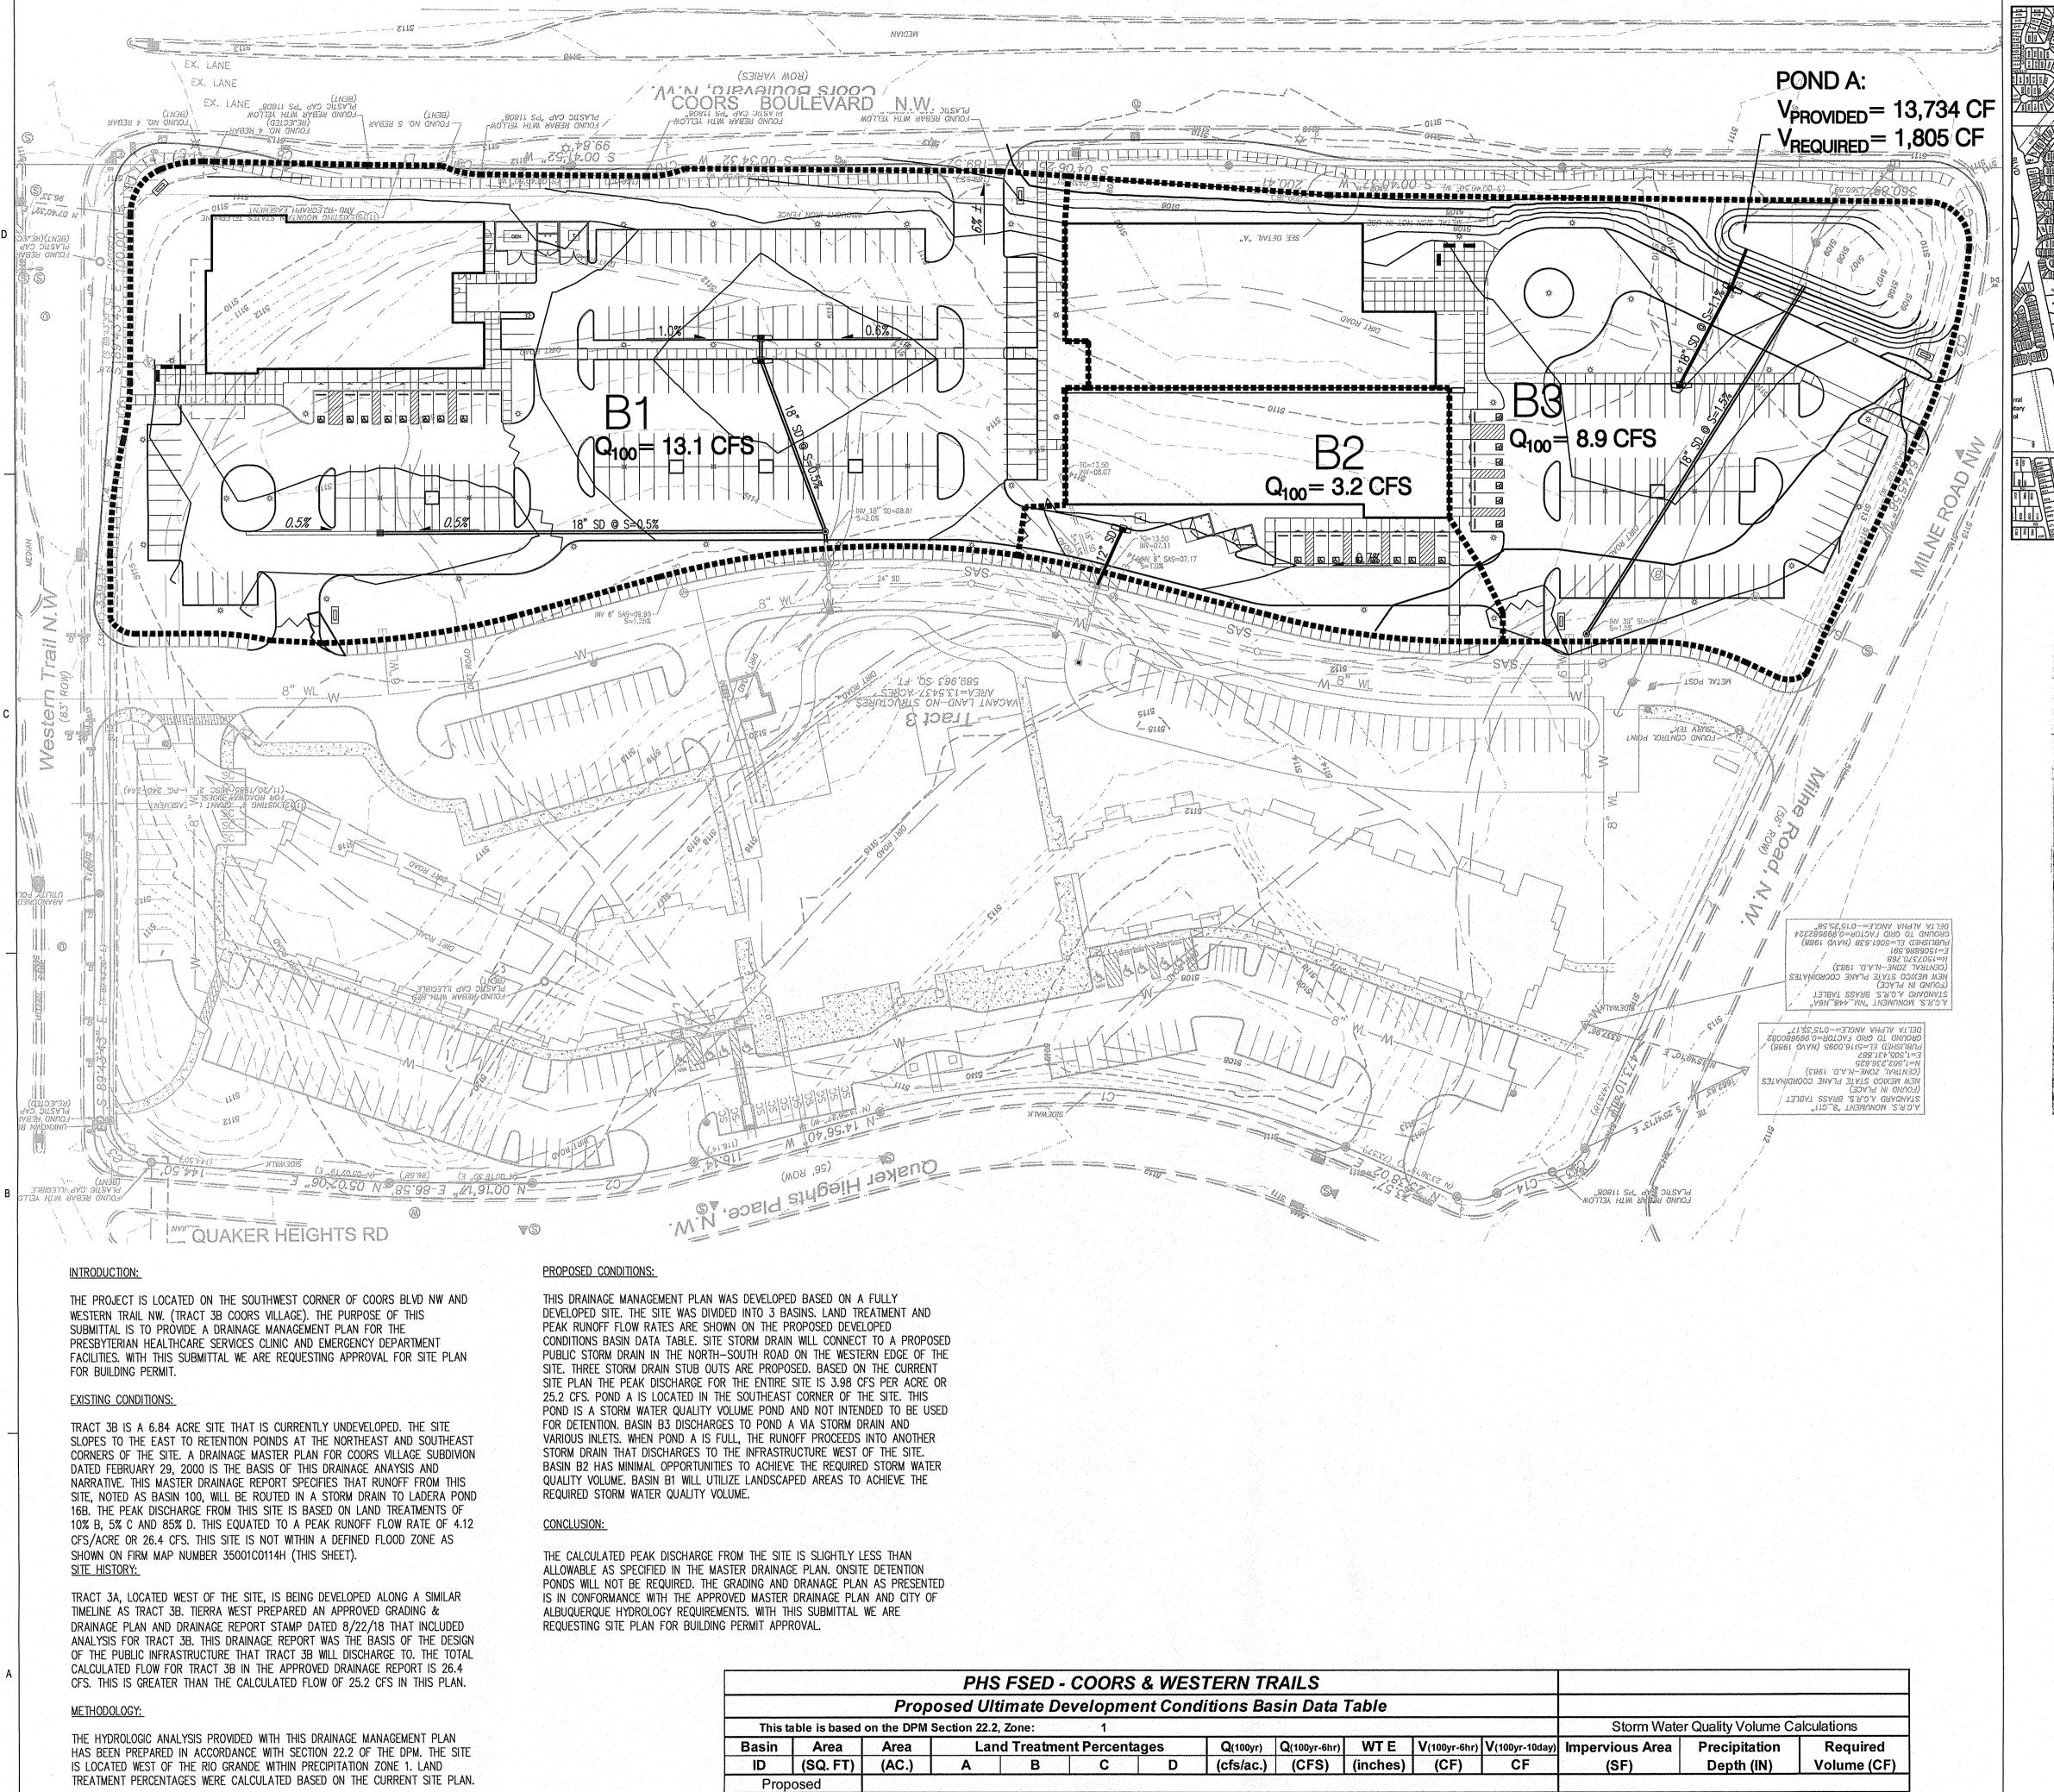

1 | 144338 | 3.31 | 0.0% | 0.0% | 27.0% | 73.0% | 3.97 | 13.1 | 1.71 | 20513 | 33420

4.15 3.2 1.82 5041

8.9

25.2

3.82

1.61 | 13544

0.0% | 0.0% | 15.0% | 85.0% |

0.0% | 0.0% | 37.0% | 63.0%


33183 0.76

101112 2.32

TOTAL | 278633 | 6.40


P:\20190250\CDP\Hydro\20190250 Proposed DMP.dwg Wed, 16-Jan-2019 - 9:38:am, Plotted by: MSATCHES ARCHITECT

VICINITY MAP

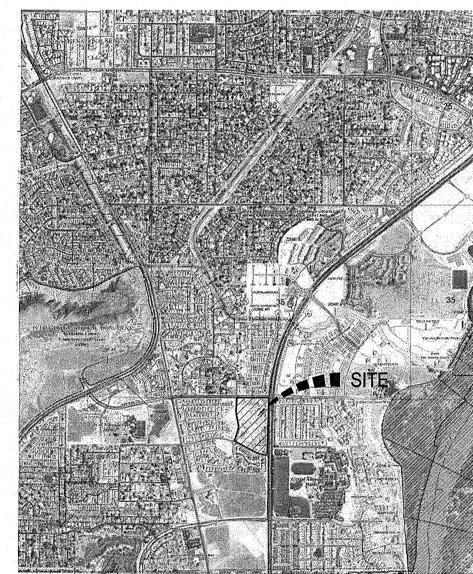

FEMA FIRM MAP # 35001C114H

LEGEND PROPOSED DRAINAGE BASIN PROPERTY LINE EXISTING CONTOURS PROPOSED SPOT ELEVATION TC=TOP OF CURB, FL=FLOW LINE TS=TOP OF SIDEWALK, TA=TOP OF ASPHALT EX=EXISTING, FG=FINISHED GRADE TG=TOP OF GRATE, INV=INVERT S=2.0% PROPOSED DIRECTION OF FLOW WATER BLOCK / RIDGE OR HIGH POINT PROPOSED INTER CONTOURS PROPOSED STORM DRAIN LINE PROPOSED STORM DRAIN MANHOLE

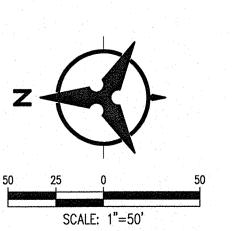

PROPOSED STORM DRAIN INLET

0.34

0.34

0.34

2985

799

1805

5589

105367

28206

63701

8496

21347

63264

Bohannan A Huston www.bhinc.com 800.877.5332

PERICH SABATINI

505.761.9700 / DPSDESIGN.ORG

NOT FOR CONSTRUCTION

COORS BLVD. NW ALBUQUERQUE, NI ATORY


REVISIONS

DRAWN BY во **REVIEWED BY** GSB DATE 1/15/2019 PROJECT NO. 18-0103.001

DRAWING NAME **PROPOSED** DRAINAGE **MANAGEMENT**

SHEET NO.

PLAN

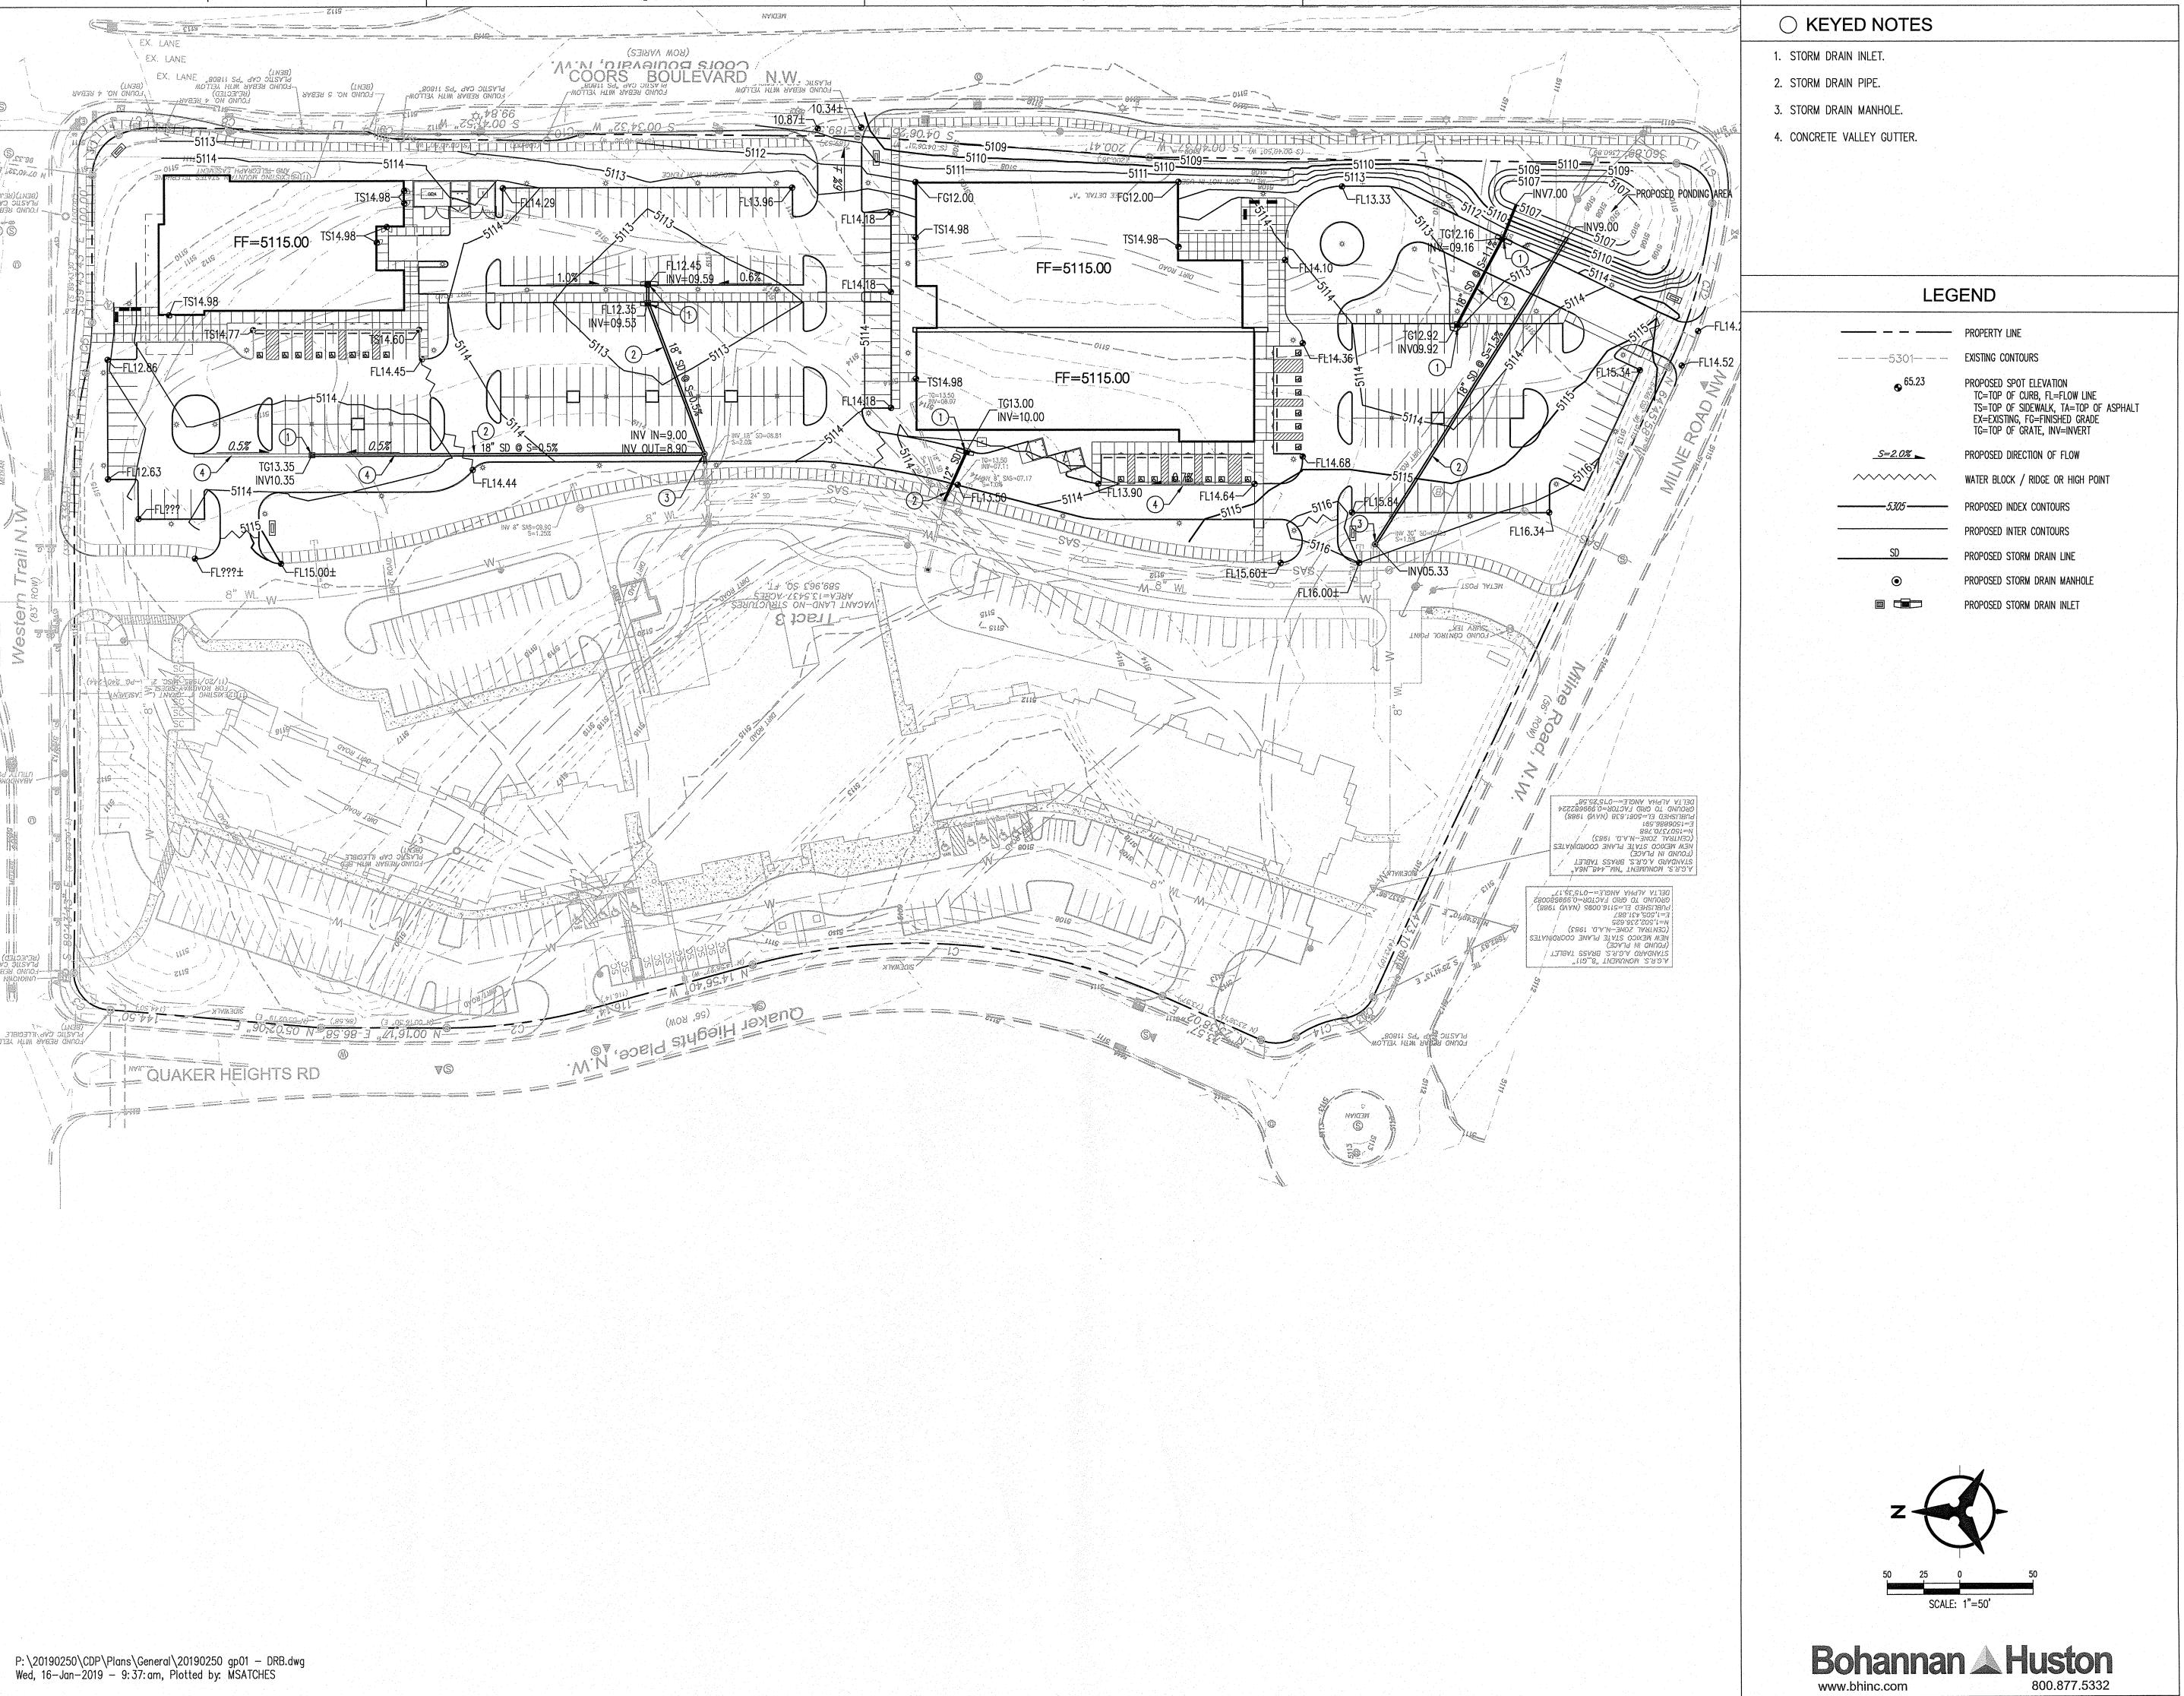

ARCHITECTURE / DESIGN / INSPIRATION

DEKKER
PERICH
SABATINI

7601 JEFFERSON NE, SUITE 100 ALBUQUERQUE, NM 87109

505.761.9700 / DPSDESIGN.ORG

ARCHITECT

ENGINEER

THEW H. SAICH
MEN AND COMMENTS OF THE WORLD

OT FOR CONSTRUCTION

NOT FOR CONSTRUCTION

PROJECT

PHS AMBULATORY CARE FACILI'S COORS BLVD. NW ALBUQUERQUE, NM


REVISIONS

DRAWN BY BO
REVIEWED BY GSB
DATE 1/15/2019
PROJECT NO. 18-0103.001
DRAWING NAME

CONCEPTUAL
GRADING &
DRAINAGE PLAN

SHEET NO.

C-100

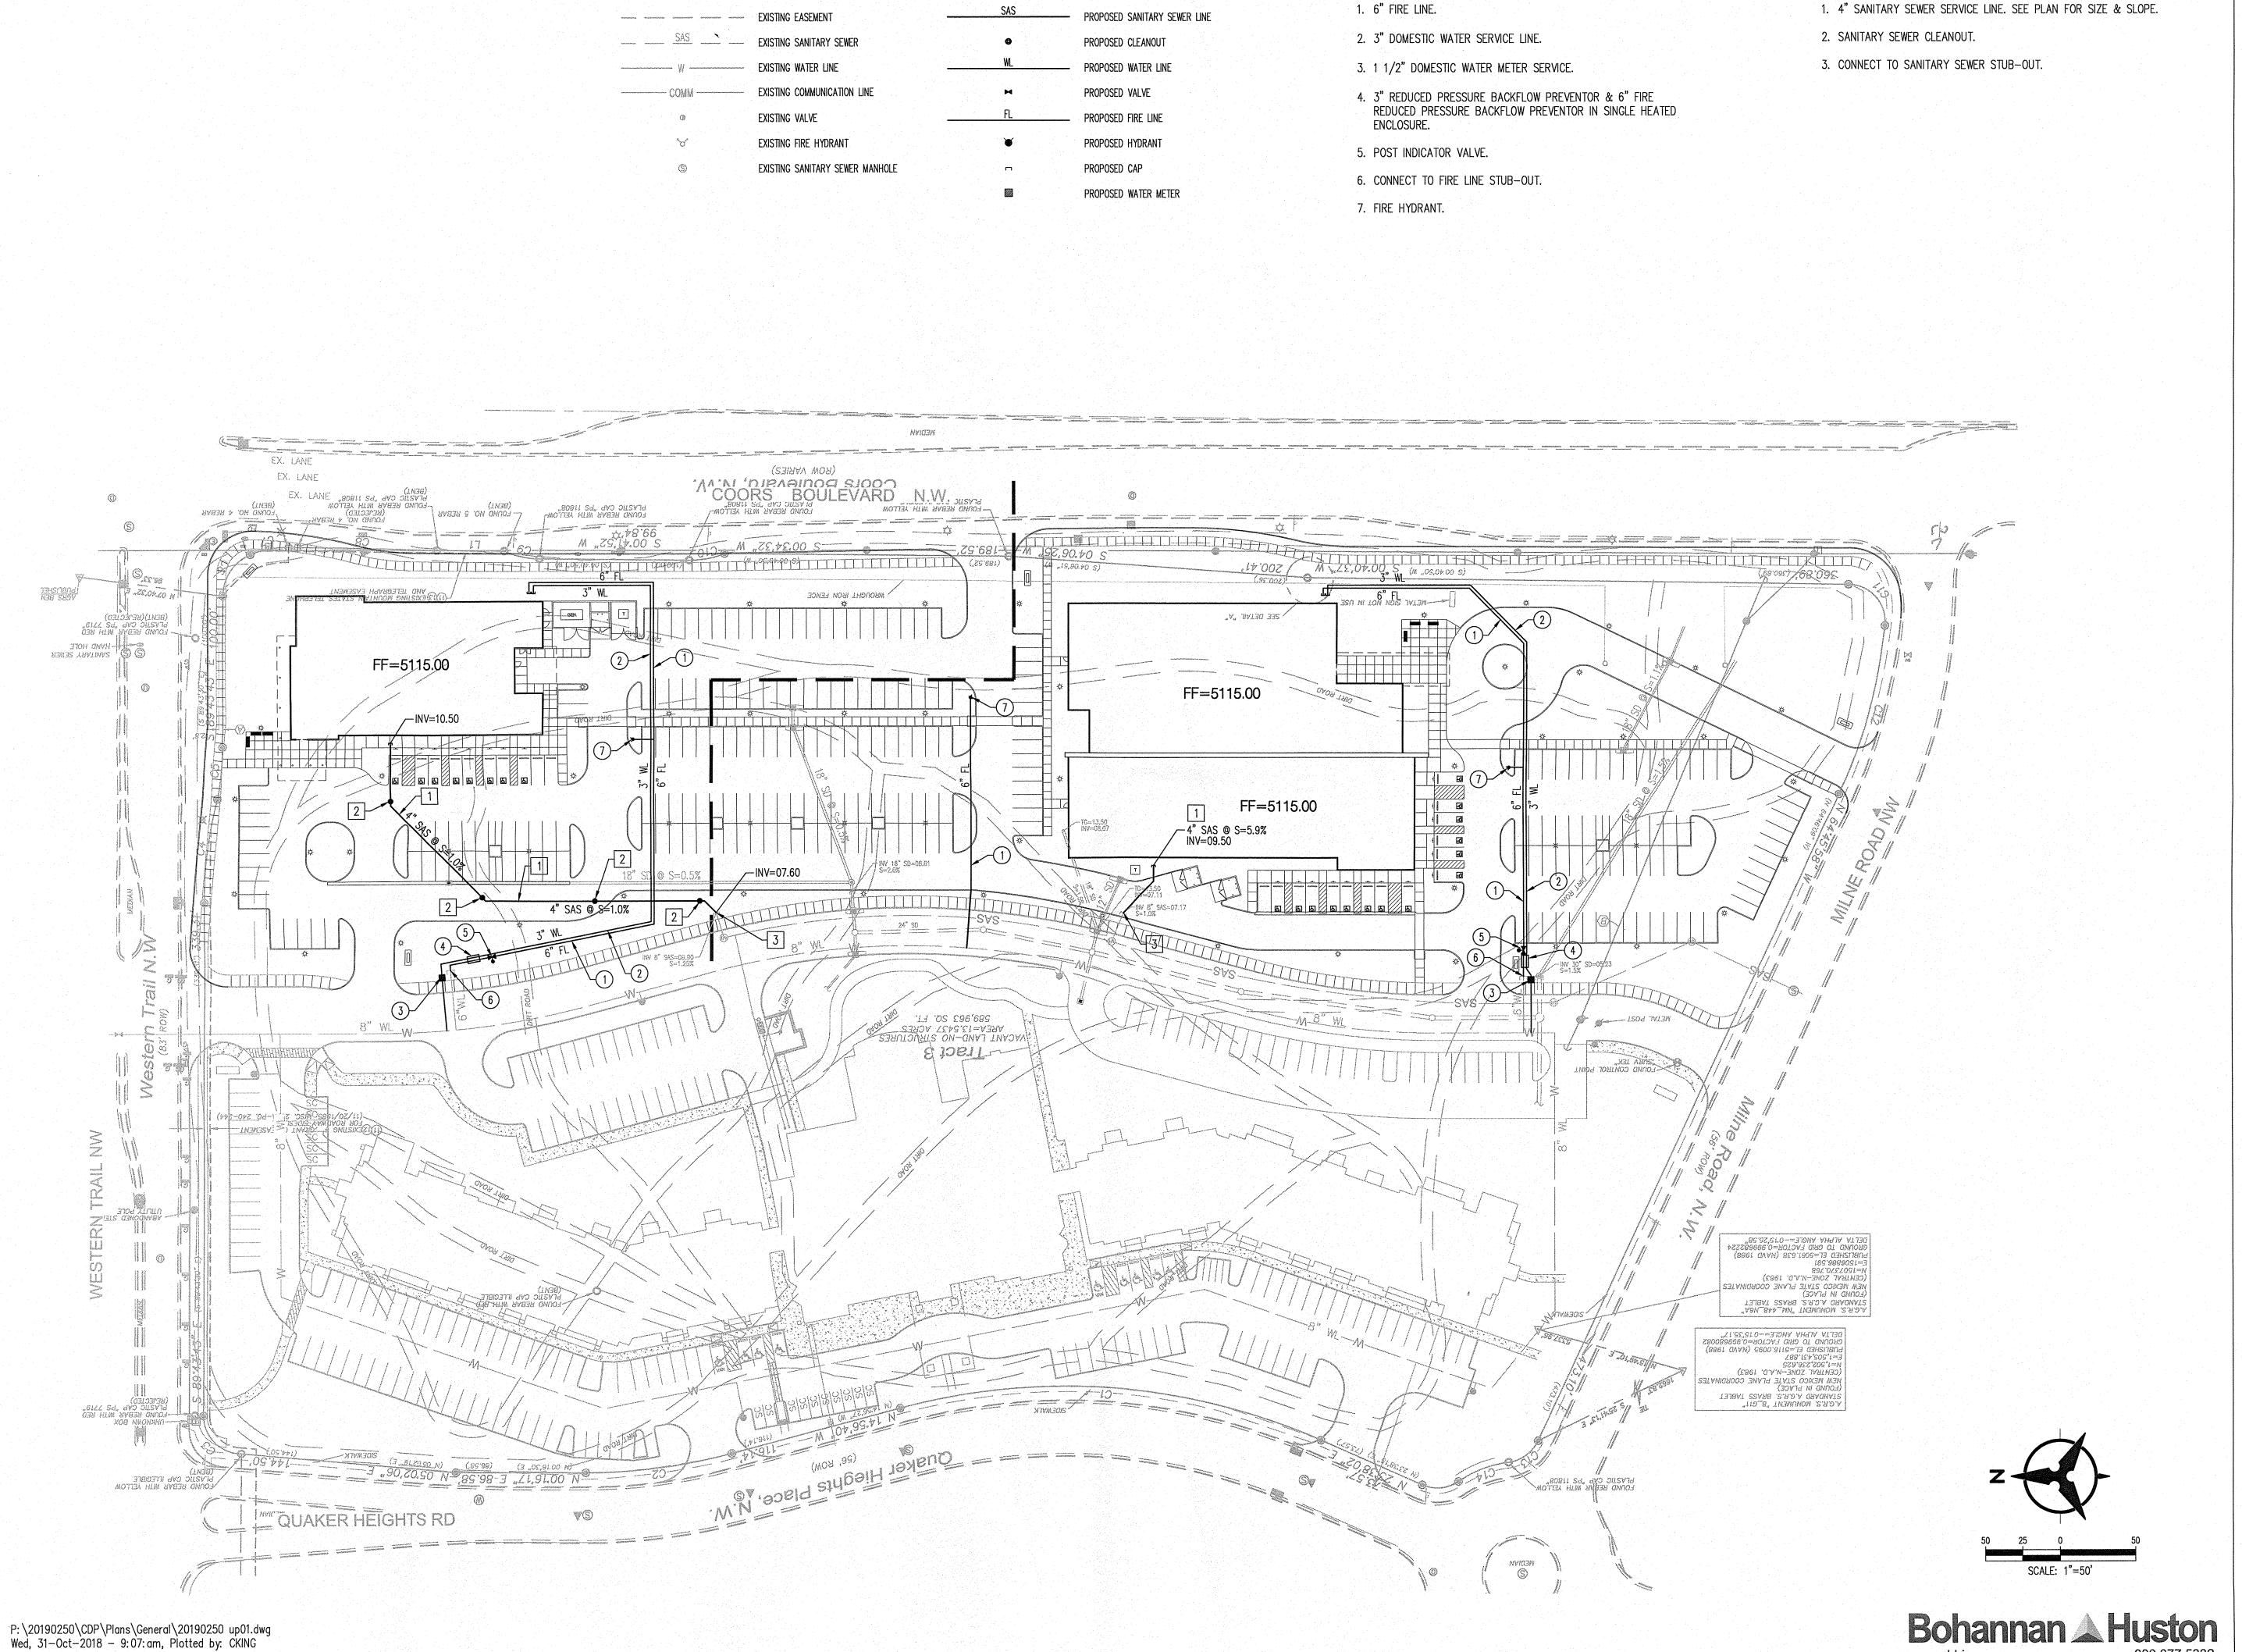

LEGEND

O WATER KEYED NOTES

ARCHITECTURE / DESIGN / INSPIRATION

SANITARY SEWER KEYED NOTES

DEKKER
PERICH
SABATINI

7601 JEFFERSON NE, SUITE 100 ALBUQUERQUE, NM 87109

505.761.9700 / DPSDESIGN.ORG

ENGINEER

ARCHITECT

PROJECT

COORS BLVD. NW ALBUQUERQUE, NM

DRAWN BY	ВО
REVIEWED BY	GSB
DATE	9/27/2018
PROJECT NO.	18-0103.001
DRAWING NAME	


CONCEPTUAL UTILITY PLAN

SHEET NO.

800.877.5332

www.bhinc.com

C-201

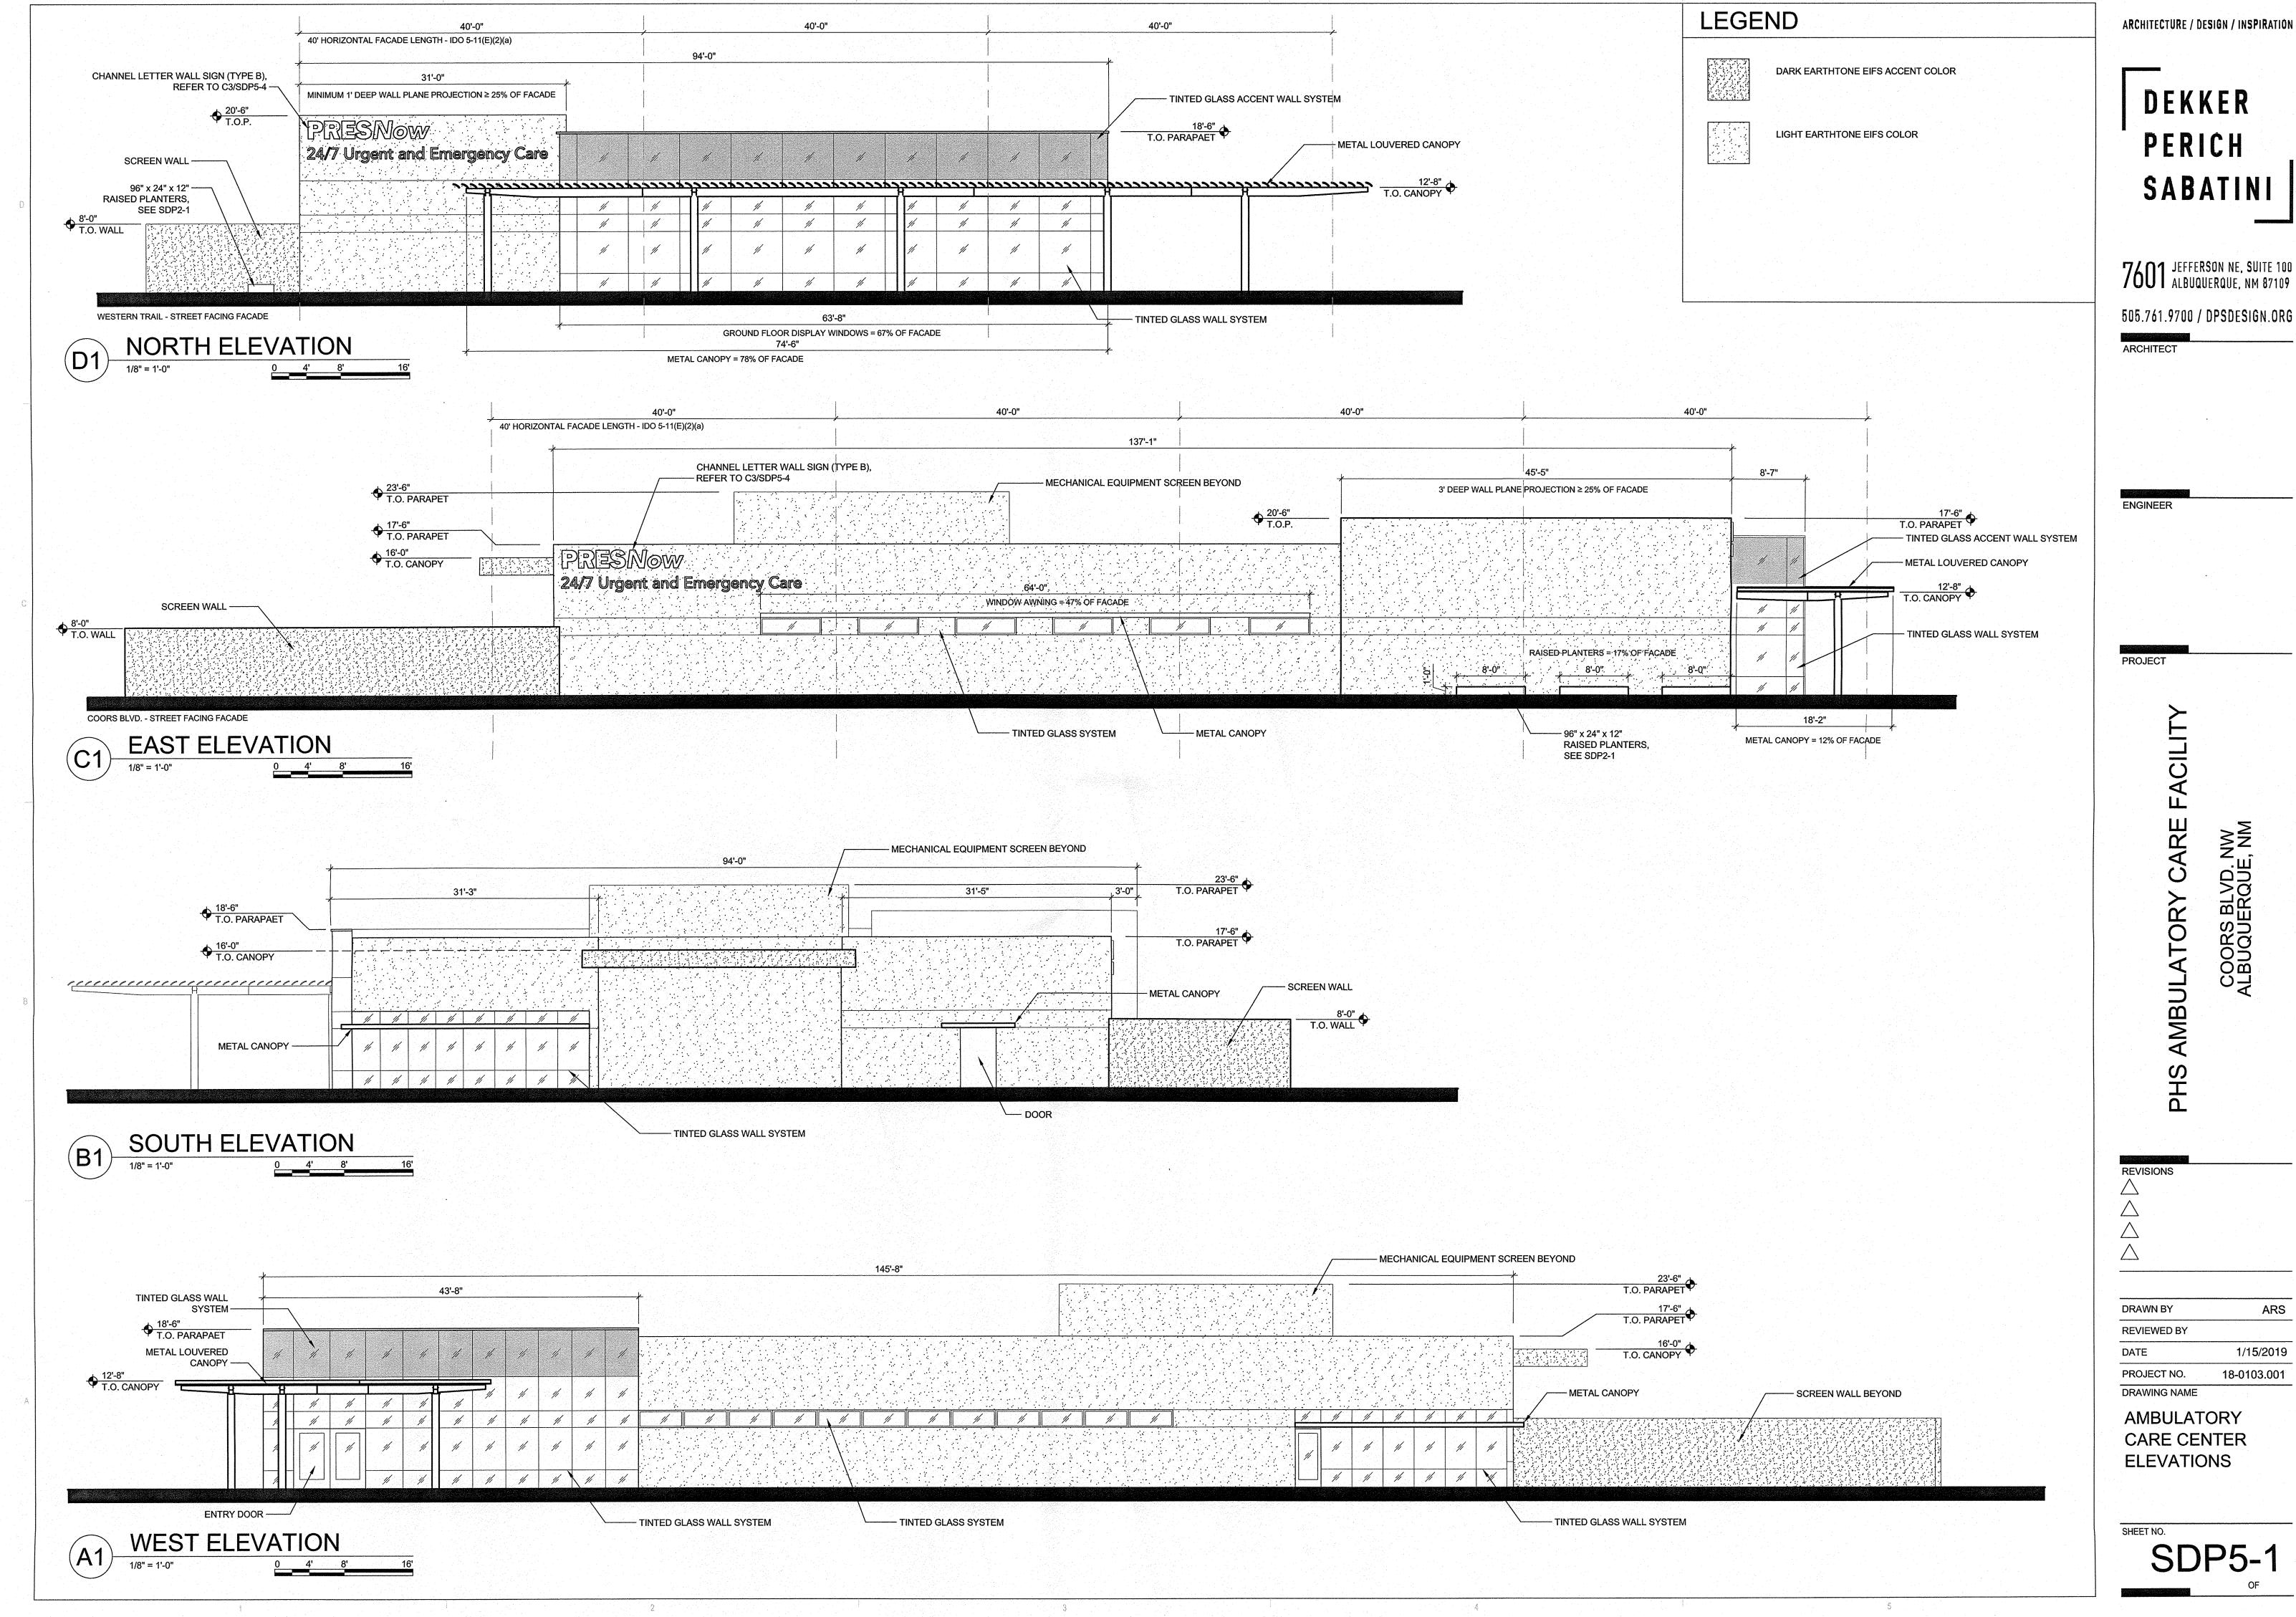

ARCHITECTURE / DESIGN / INSPIRATION

SABATINI

ARS 1/15/2019

WEST ELEVATION

DEKKER PERICH SABATINI

ARCHITECTURE / DESIGN / INSPIRATION

7601 JEFFERSON NE, SUITE 100 ALBUQUERQUE, NM 87109

505.761.9700 / DPSDESIGN.ORG

ARCHITECT

ENGINEER

PROJECT


DRAWN BY **REVIEWED BY** 1/15/2019 18-0103.001

PROJECT NO.

DRAWING NAME

MEDICAL CLINIC **ELEVATIONS**

SHEET NO.

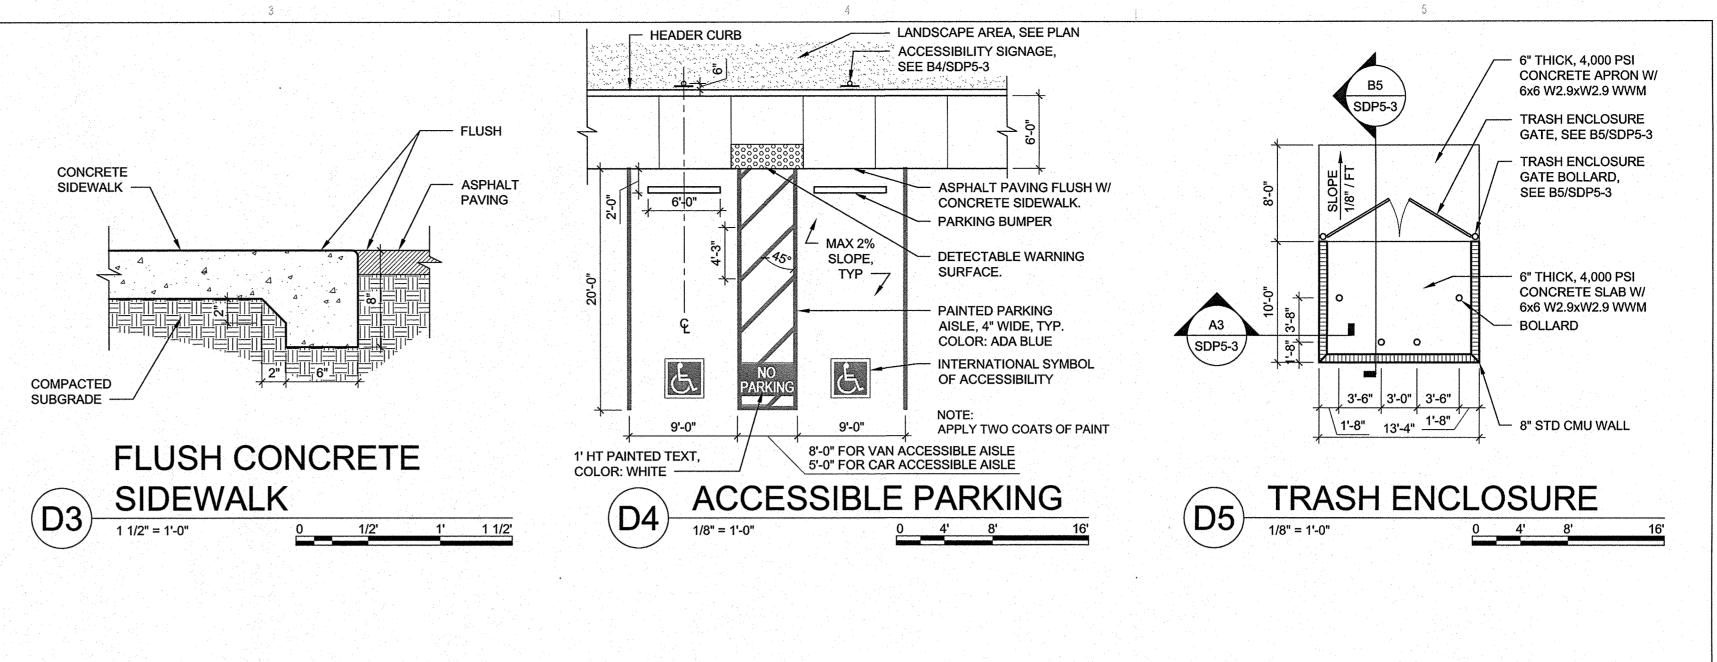


(1) #5 CONT IN

FINISH: 3-COAT STUCCO

COLOR: MATCH BUILDING

KNOCK OUT BOND BEAM VARIES, SEE PLAN

CMU WALL

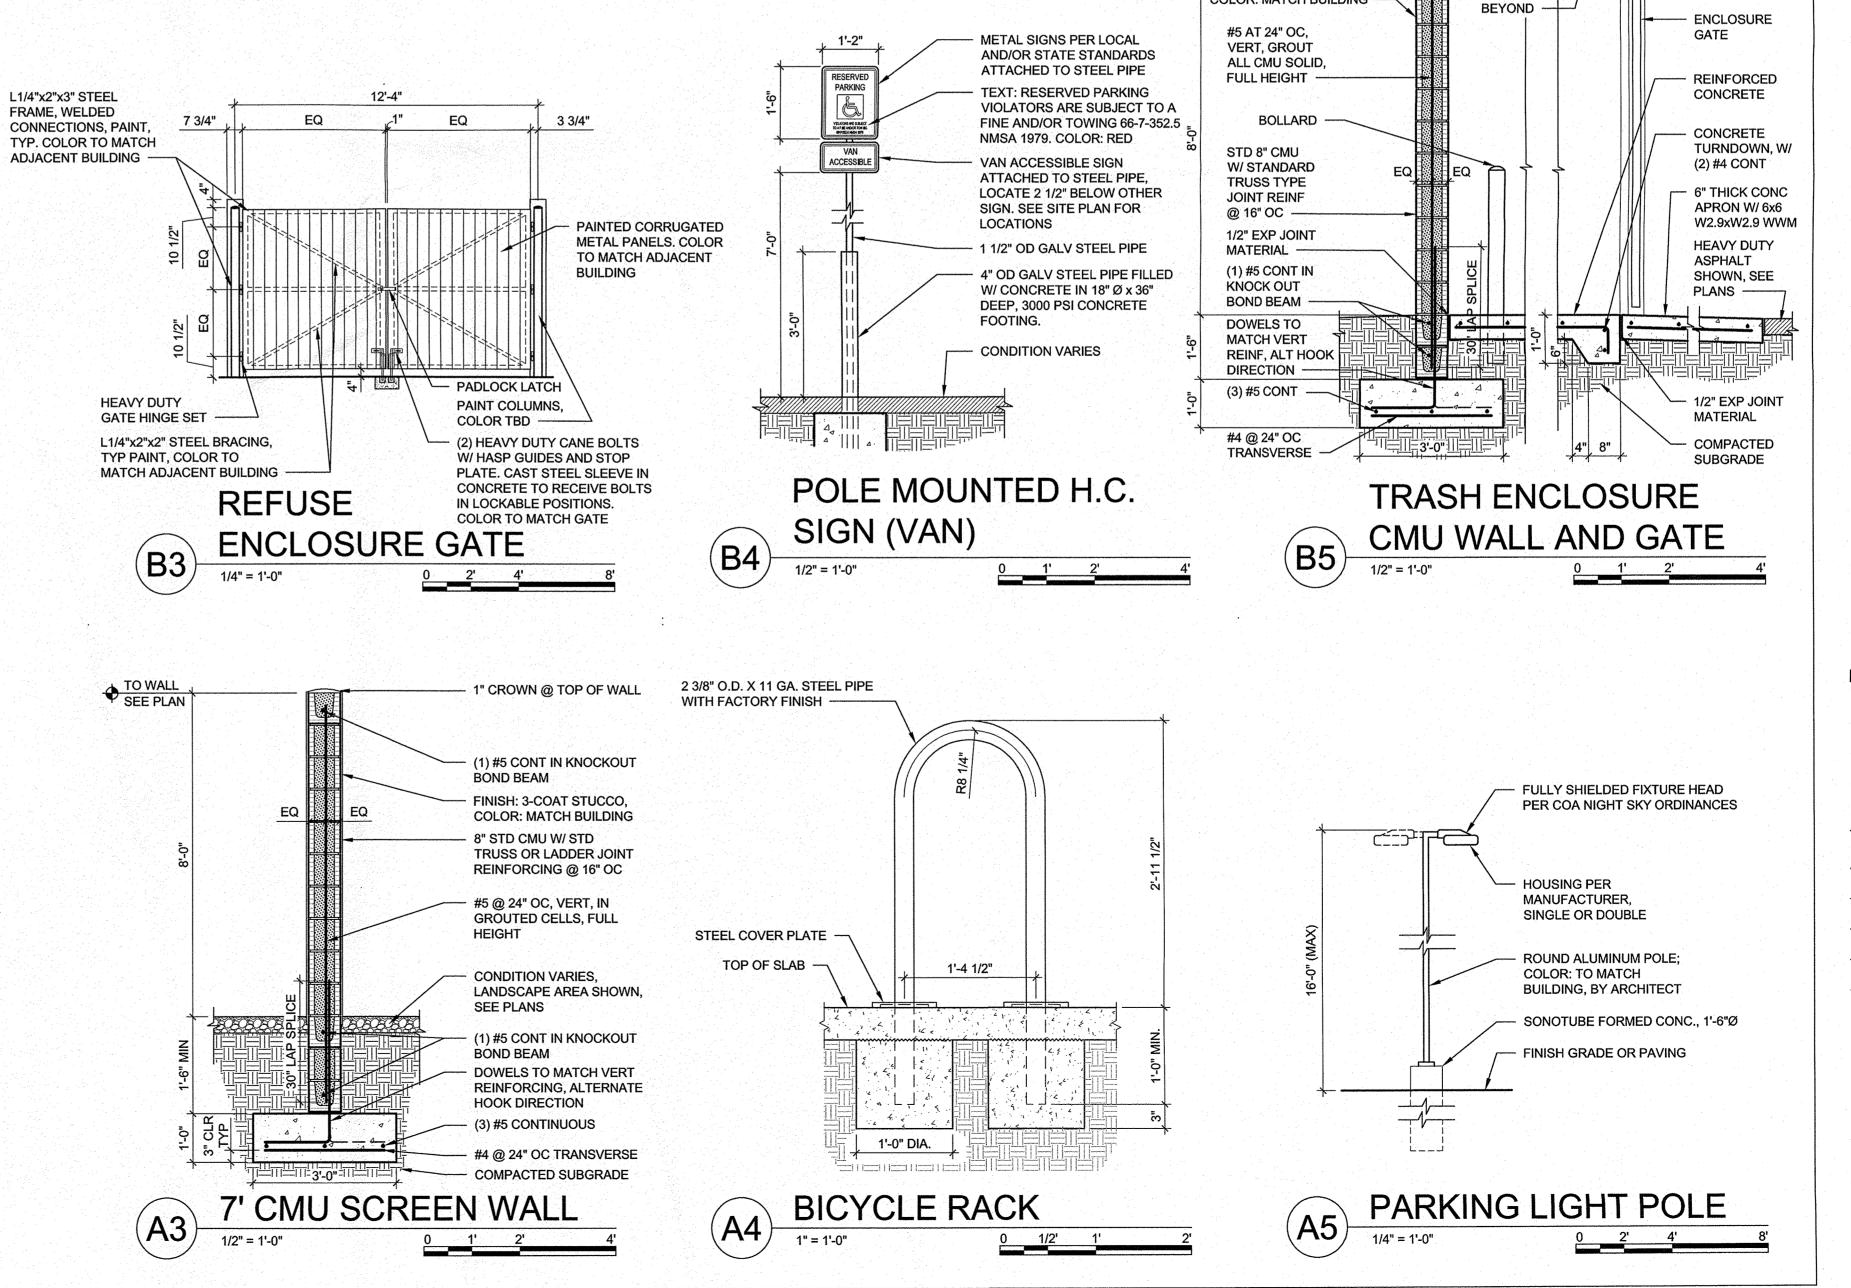

ARCHITECTURE / DESIGN / INSPIRATION

DEKKER PERICH SABATINI

7601 JEFFERSON NE, SUITE 100 ALBUQUERQUE, NM 87109

505.761.9700 / DPSDESIGN.ORG

ARCHITECT

ENGINEER

PROJECT

ENCLOSURE GATE BOLLARD,

COORS BLVD. NW ALBUQUERQUE, NM **ATORY**

REVISIONS

DRAWN BY REVIEWED BY

1/15/2019 DATE 18-0103.001 PROJECT NO. DRAWING NAME

SITE DETAILS

SHEET NO.

SDP5-3

Illumination: Internal Style: Reverse Channel Halo Lit Light Source: LED Modules Light Source Color: 6500k White Primary Power Source Input Required: 277v Circuit Required: 20 Amp Dedicated Timer or Dusk to Dawn (Photo Cell): TBD Power Supply LED Driver Input Voltage: 100~277V AC Power Supply LED Driver Listed: UL Service Disconnect Switch: Yes - On Sign Amp Draw: TBD LUMINANCE NOT TO EXCEED 200 FOOT LAMBERTS OR 685 NITS AT NIGHT


CHANNEL LETTER WALL SIGN (TYPE A) 1/2" = 1'-0"

167 13/16" (13'-11 3/4") 24/7 Urgent and Emergency Care (8")

45 SQ. FT.

CHANNEL LETTER WALL SIGN (TYPE B)

Illumination: Internal Style: Reverse Channel Halo Lit Light Source: LED Modules Light Source Color: 6500k White Primary Power Source Input Required : 277v Circuit Required : 20 Amp Dedicated Timer or Dusk to Dawn (Photo Cell) : TBD Power Supply LED Driver Input Voltage: 100~277V AC Power Supply LED Driver Listed: UL Service Disconnect Switch: Yes - On Sign Amp Draw: TBD LUMINANCE NOT TO EXCEED 200 FOOT LAMBERTS OR 685 NITS AT NIGHT

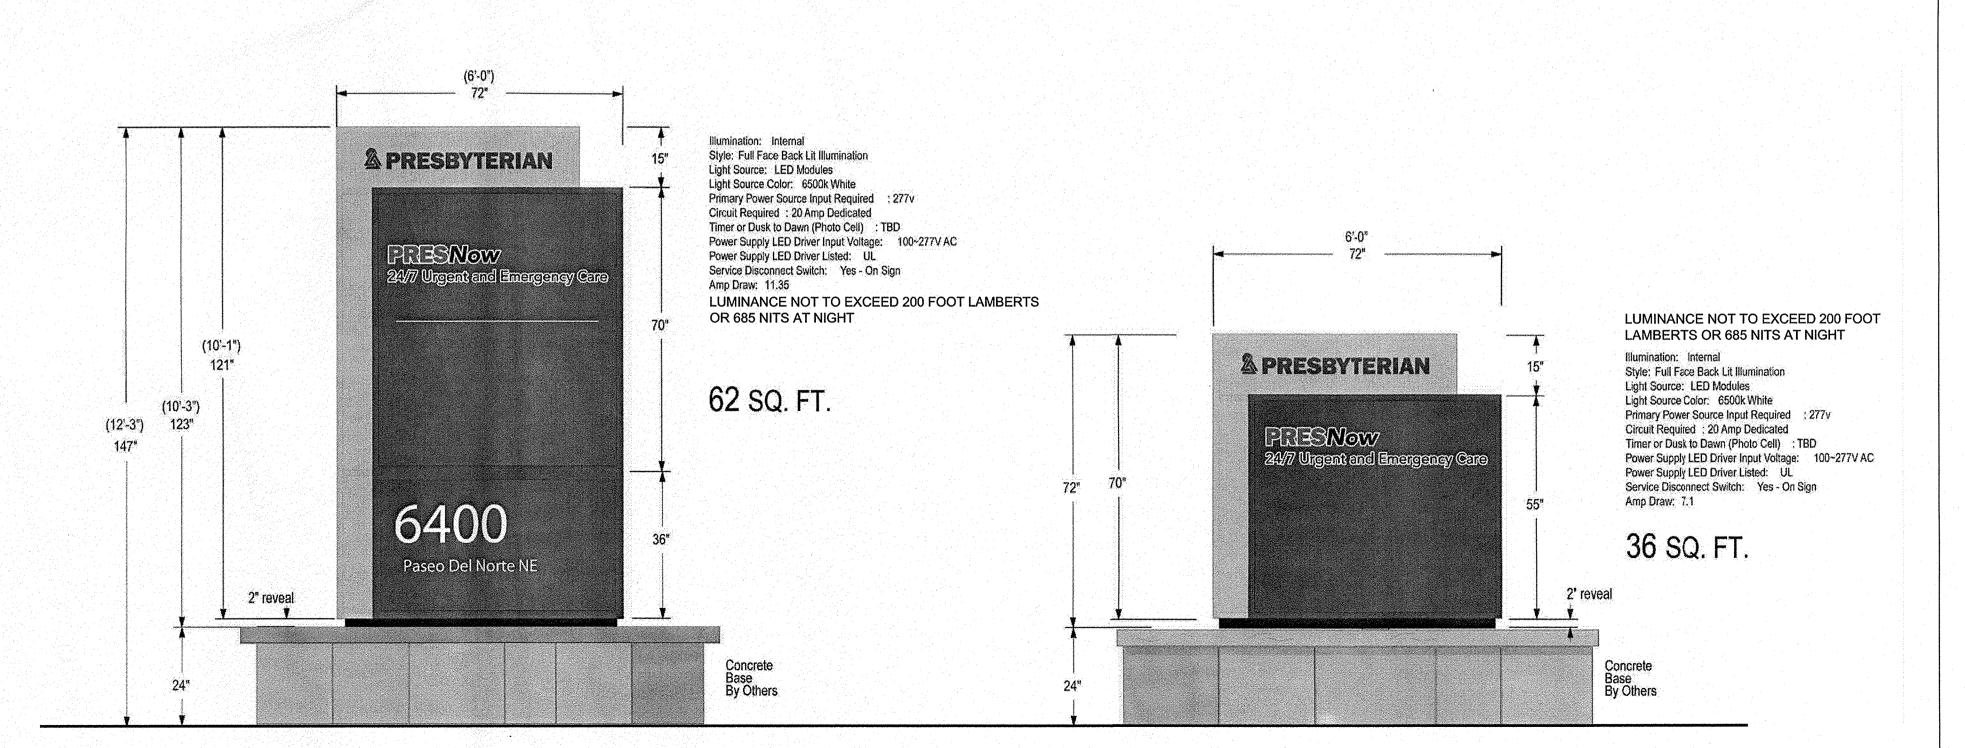

MONUMENT SIGN (TYPE C)

MONUMENT SIGN (TYPE D) 1/2" = 1'-0"

DEKKER PERICH SABATINI

ARCHITECTURE / DESIGN / INSPIRATION

7601 JEFFERSON NE. SUITE 100 ALBUQUERQUE, NM 87109

505.761.9700 / DPSDESIGN.ORG

ARCHITECT

ENGINEER

PROJECT

COORS BLVD. NW ALBUQUERQUE, NM ATORY

REVISIONS

DRAWN BY

DRAWING NAME

REVIEWED BY 1/15/2019 PROJECT NO. 18-0103.001

SIGN ELEVATIONS

SHEET NO.

SDP5-4