ROLLY SERIOR

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FIRE ONE

DEKKER
PERICH
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ARCHITECTURE / DESIGN / INSPIRATION


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505.761.9700 / DPSDESIGN.ORG

ARCHITECT

ENGINEER

VICINITY MAP

SDP 6-1

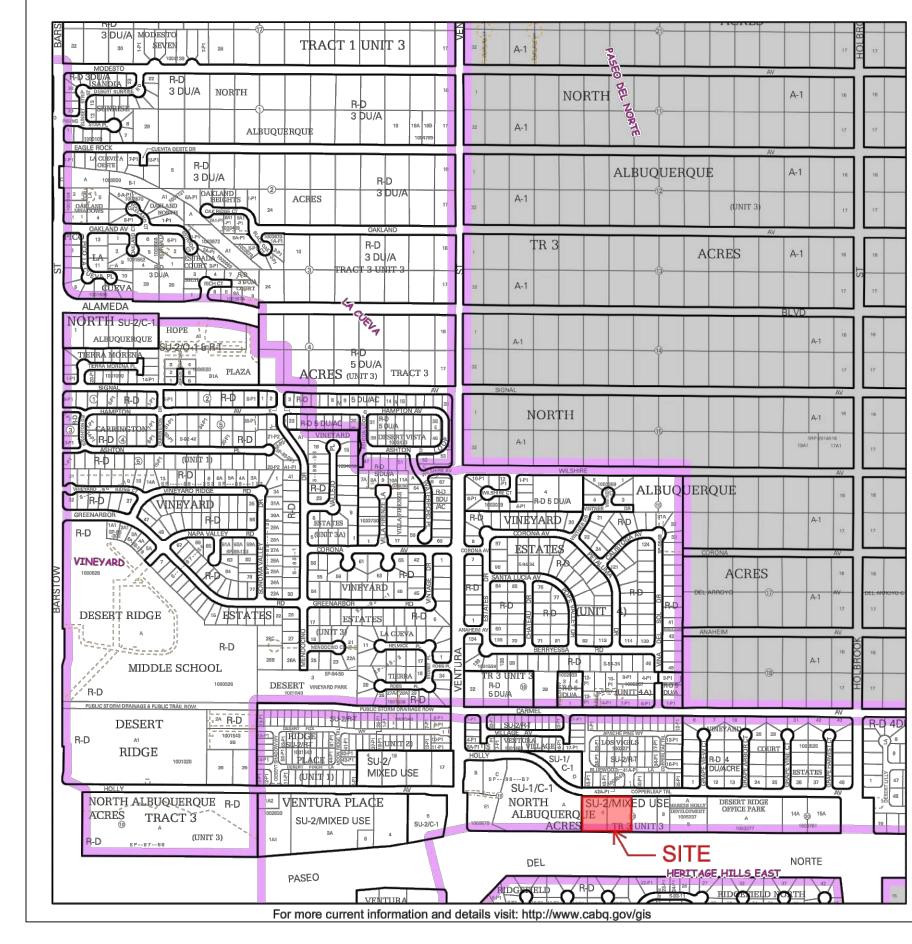

PROJECT

HOLLY AVENUE SENIOR LIVING

PROJECT TEAM

OWNER/BUILDER

MARK 3S,INC. 6501 WYOMING BLVD. NE ALBUQUERQUE, NM 87109 PHONE: 505.220.7625 ARCHITECTURAL/STRUCTURAL


DEKKER/PERICH/SABATINI, LTD. 7601 JEFFERSON ST. NE, SUITE 100 ALBUQUERQUE, NM 87109 PHONE: 505.761.9700 CIVIL

HIGH MESA CONSULTING GROUP 6010-B MIDWAY PARK BLVD.NE ALBUQUERQUE, NM 87109 PHONE: 505.345.4250 MECHANICAL /PLUMBING


ARSED ENGINEERING GROUP,LLC 4700 LINCOLN ROAD NE ALBUQUQUERQUE,NM 87109 PHONE: 505.761.3100 ELECTRICAL

AC ENGINEERING ENTERPRISES, LLC. 120 ALISO DR.SE ALBUQUERQUE, NM 87108 PHONE: 505.842.5787

SDP APPLICATION

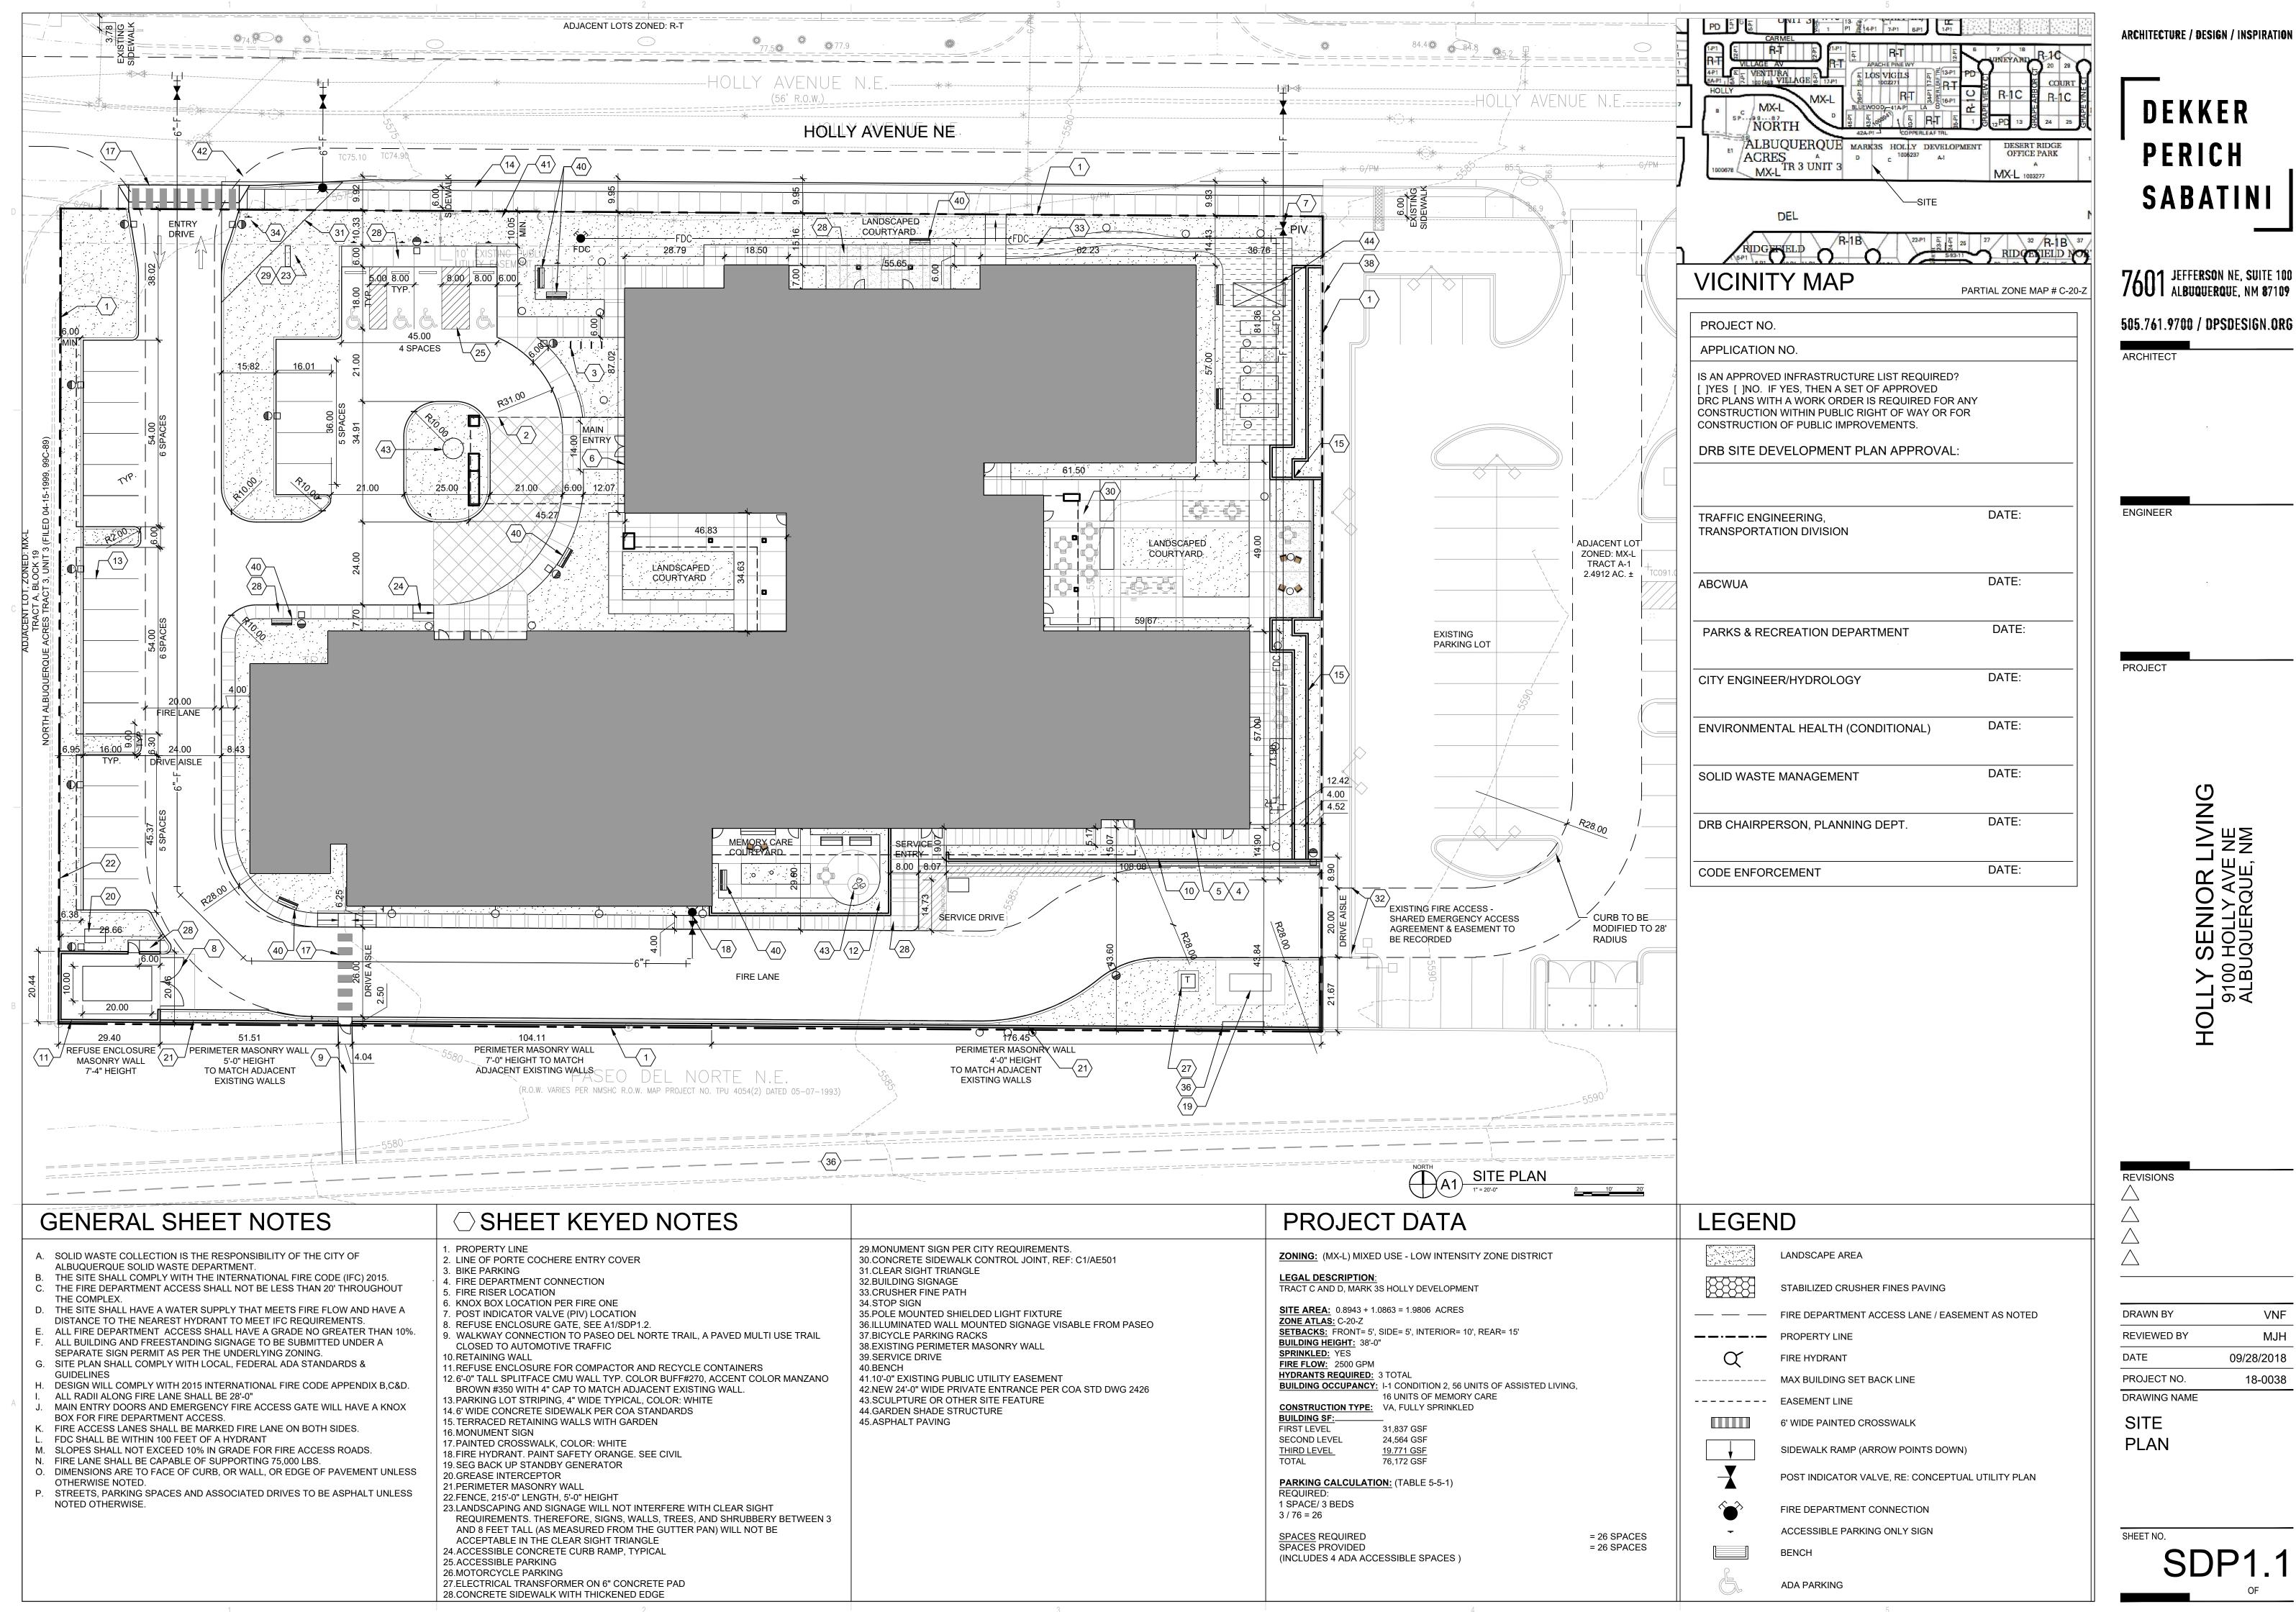

VNF MJH 09/28/2018

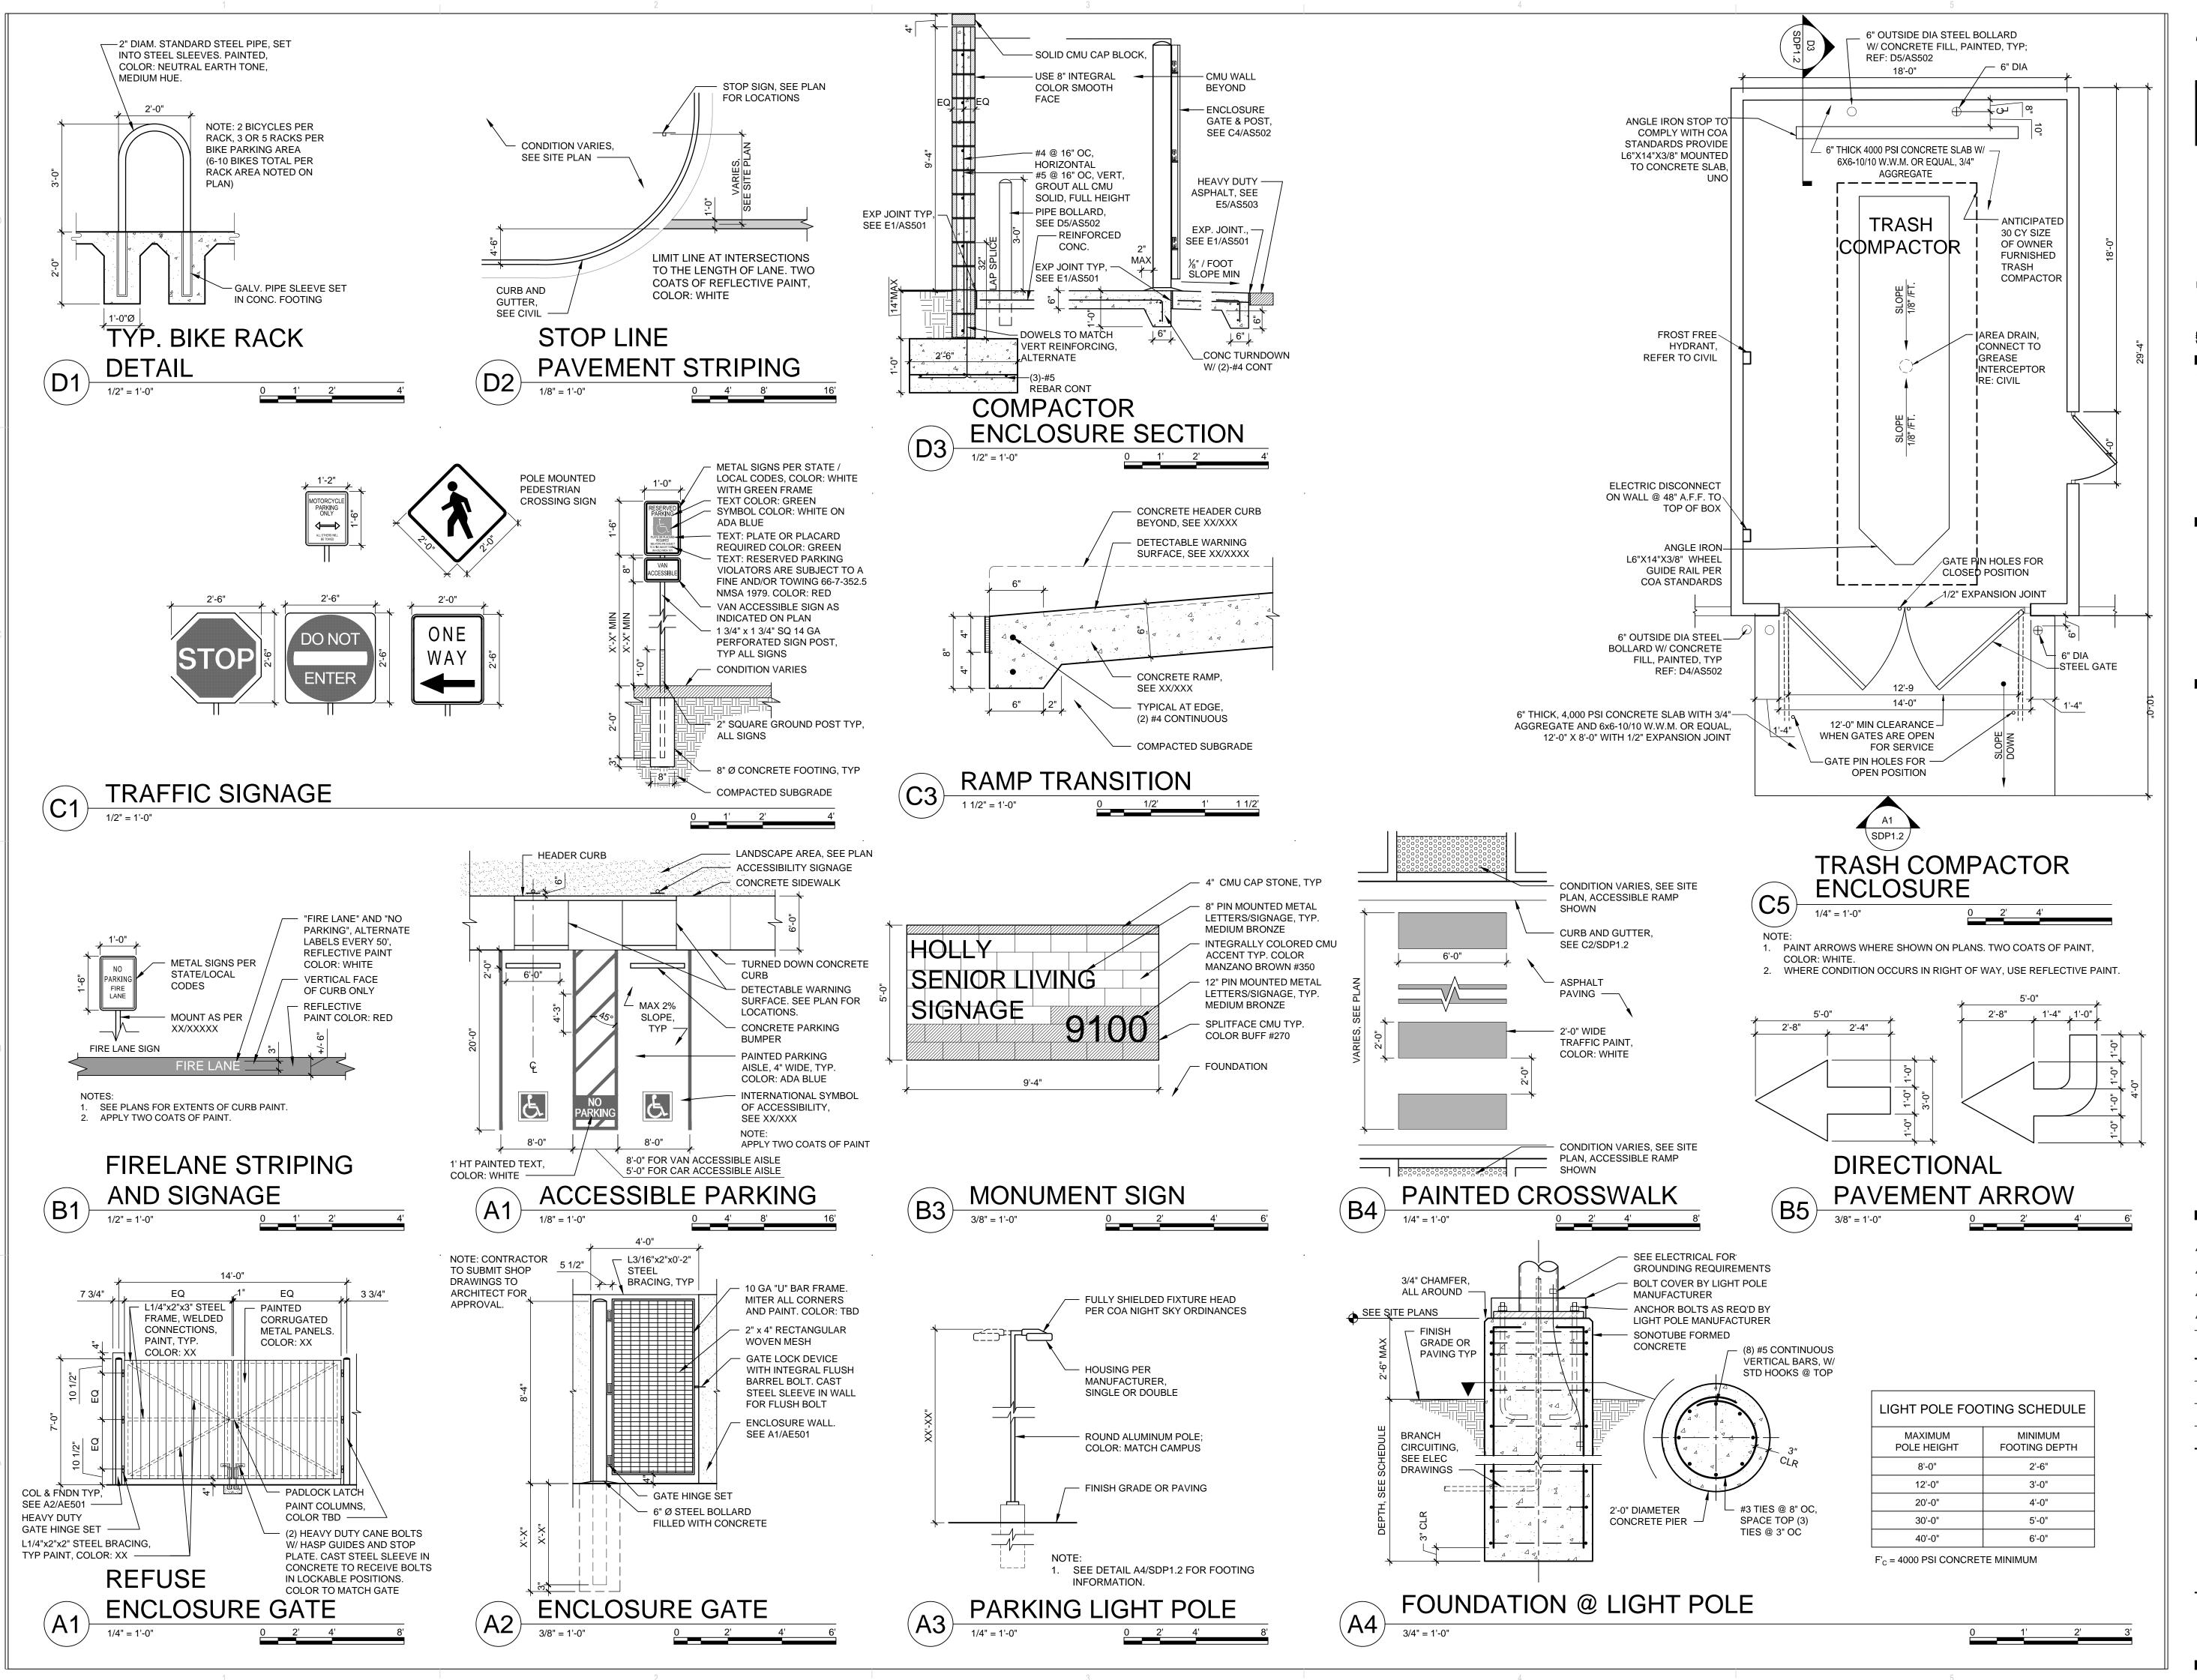

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ARCHITECT

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PROJECT

OLLY AVENUE SENIOR LIVING 9300 HOLLY AVENUE NORTHEAST ALBUQUERQUE, NEW MEXICO 87122

DRAWN BY
VNF
REVIEWED BY
DATE
09-28-2018
PROJECT NO. 18-0038

PROJECT NO.

DRAWING NAME

SITE

DETAILS

SDP1.2

PASEO DEL NORTE NE

(C1) ELECTRICAL SITE LIGHTING PLAN

FIXTURE SCHEDULE										
TYPE	MANUFACTURER	CATALOG NUMBER	DESCRIPTION/ LOCATION	TYPE	LAMPS WATTS	LUMENS	MOUNTING INSTRUCTIONS	REMARKS		
А	PORTFOLIO	#	RECESSED DOWN LIGHT IN SOFFIT	LED	35	4,725	RECESSED			
S1	INVUE	MSA-E06-LED-E1-T3-BZ	LED SITE LUMINAIRE TYPE III DISTRIBUTION ON 12' POLE WITH DARK BRONZE FINISH	LED	150	14,911	12' POLE - SEE DETAIL THIS SHEET			
S3			LED BOLLARD LOW LEVEL ILLUMINATION							
S4			LED ARCHITECTURAL WALL SCONCE				MOUNT ON BLDG AT 15' AFG			
S5			LED SIGN LIGHT							
S6			LED SIGN LIGHT				MOUNTAT PORTE COCHERE AT 9' AFG			


GENERAL SHEET NOTES

S5 S5 S5


- SITE LIGHTING POLE AND LUMINAIRE SHALL COMPLY WITH NEW MEXICO DARK SKIES ENFORCEMENT ACT AND THE CITY OF ALBUQUERQUE LIGHTING ORDINANCE.
- B. PARKING LOTS SHALL BE ILLUMINATED TO 1 FOOTCANDLE AVERAGE MAINTAINED AND SHALL NOT EXCEED 4 FOOTCANDLES AVERAGE MAINTAINED.
- SITE LIGHTING SHALL BE PEDESTRIAN STYLE AND SHALL NOT EXCEED 15' IN HEIGHT FROM THE GROUND LEVEL THE TOP OF THE LUMINAIRE.


REFERENCE KEYNOTES \bigcirc

SITE LIGHTING POLE AND LUMINAIRE. REFER TO THE FIXTURE SCHEDULE AND MOUNTING DETAIL THIS SHEET.

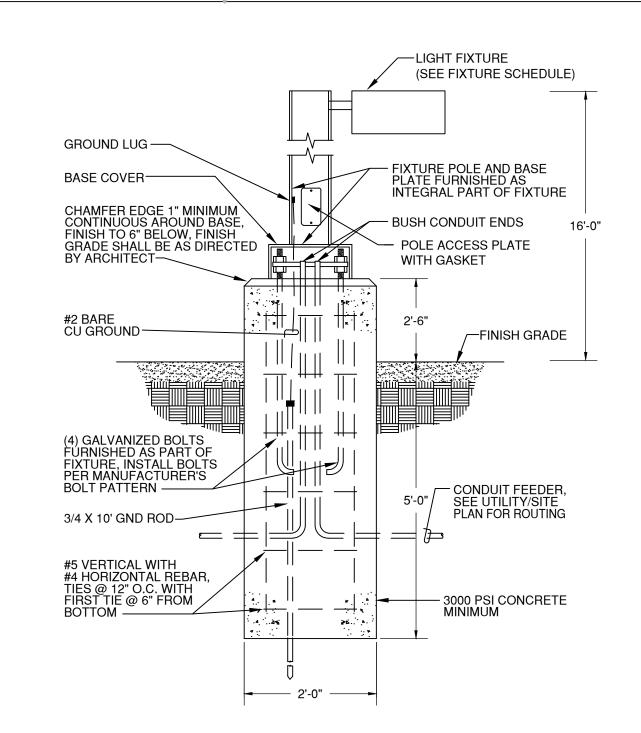

POLE BASE DETAIL FOR PARKING LUMINAIRES

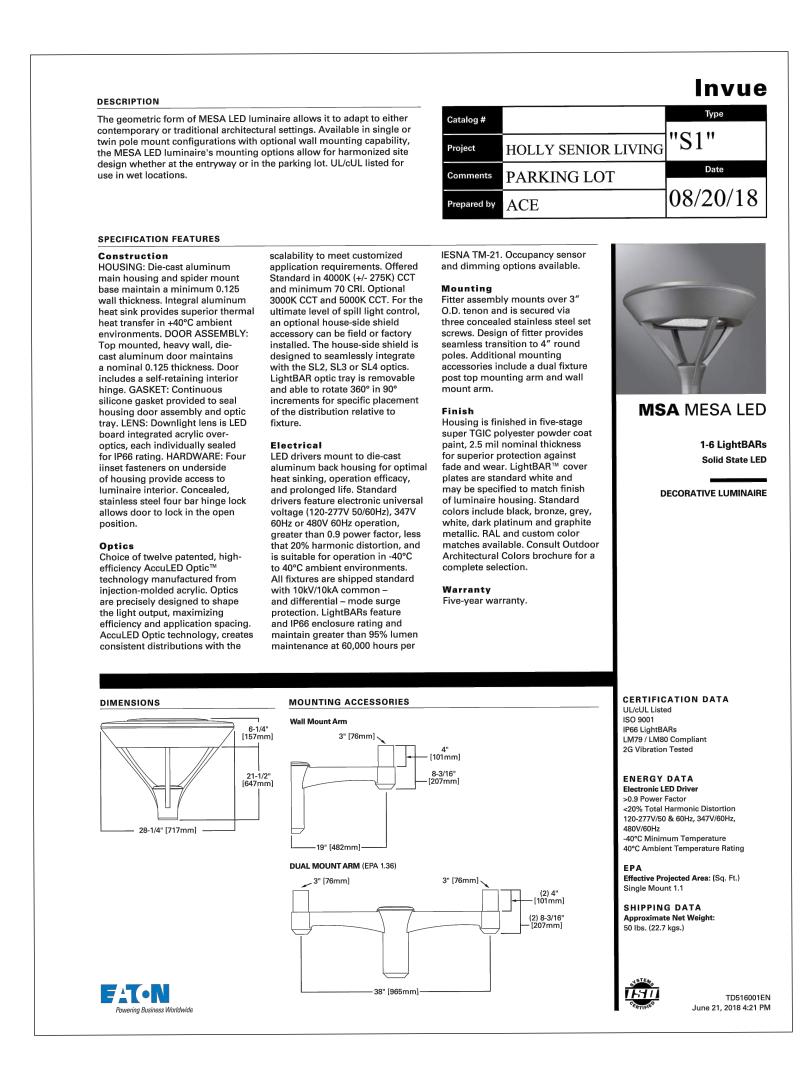

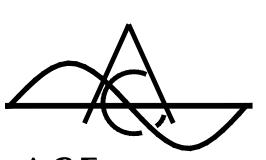

A C Engineering Enterprises, LLC

120 Aliso Drive, SE Albuquerque, New Mexico 87108 Phone 505.842.5787 Facsimile 505.842.5797

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ARCHITECT

ENGINEER



PROJECT

SENIOR LIVING 9300 HOLLY AVENUE NORTHEAST ALBUQUERQUE, NEW MEXICO 87122 AVENUE

REVISIONS

DRAWN BY

7-30-2018


18-0038

REVIEWED BY DATE

PROJECT NO. DRAWING NAME

ELECTRICAL SITE LIGHTING PLAN

SHEET NO.

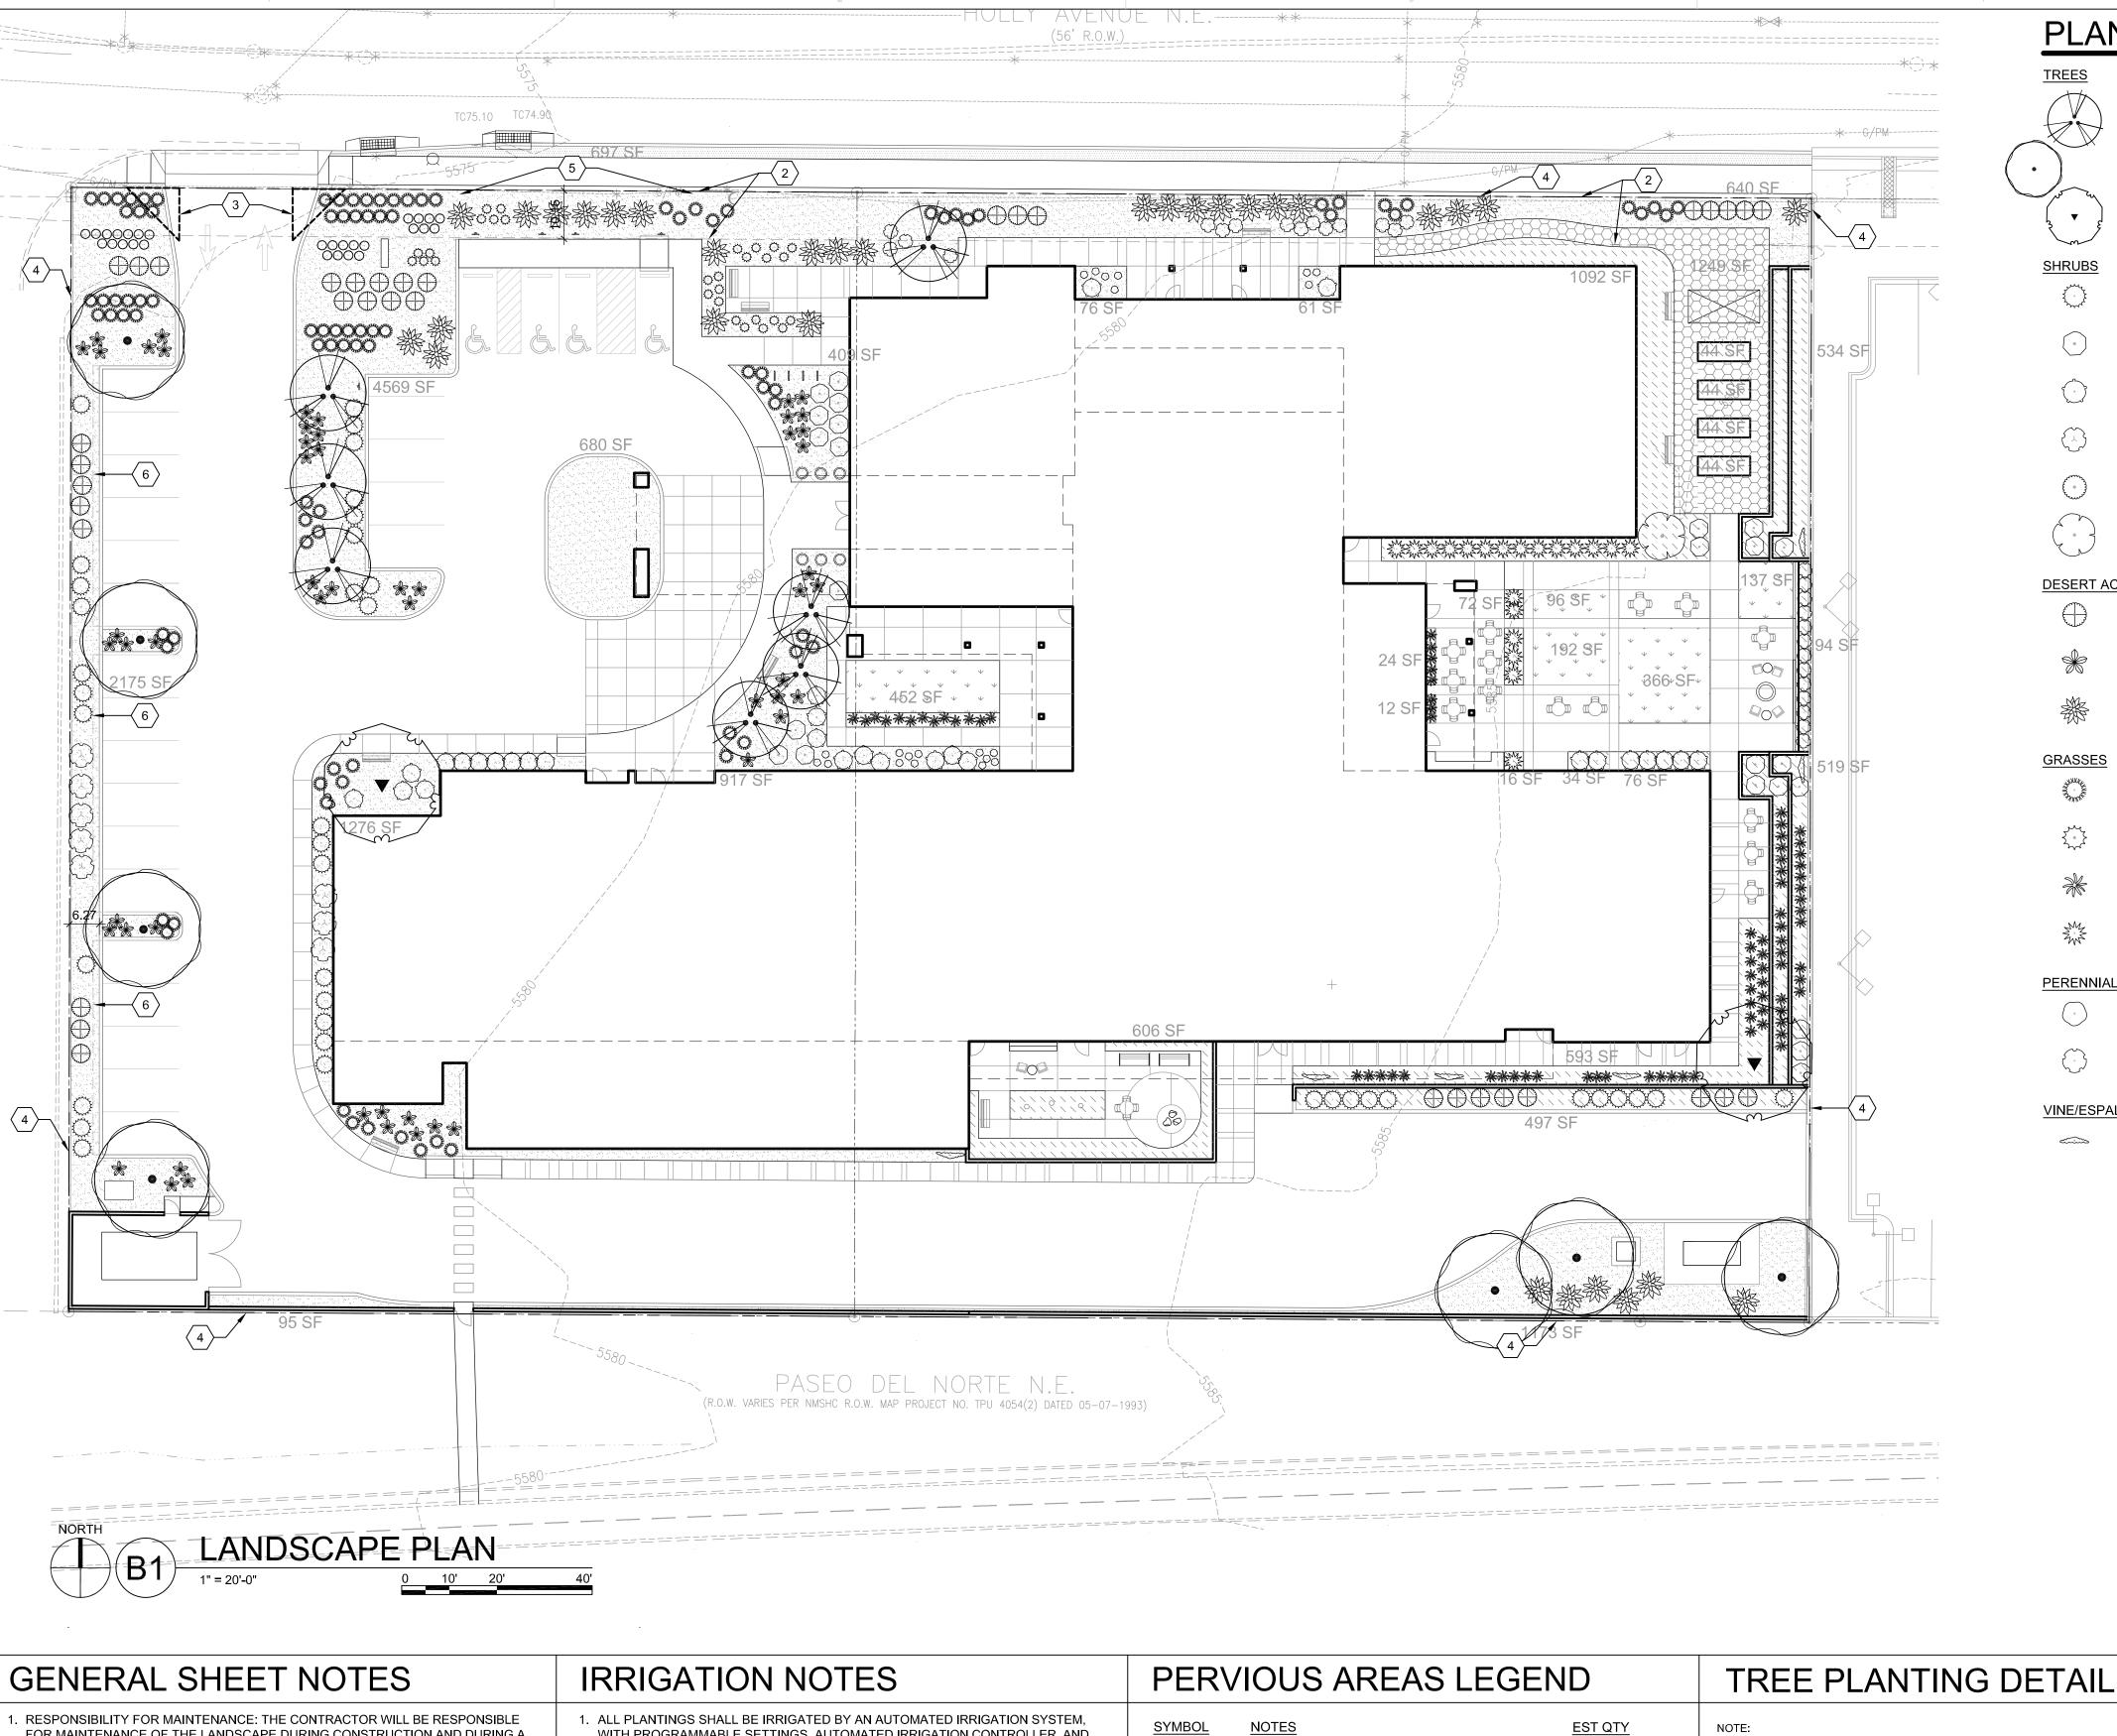

PLANT SCHEDULE **BOTANICAL NAME COMMON NAME** CHILOPSIS LINEARIS 'BUBBA' **'BUBBA' DESERT WILLOW** QUERCUS VIRGINIANA SP. FUSIFORMIS **ESCARPMENT LIVE OAK ULMUS X `FRONTIER** FRONTIER ELM **BOTANICAL NAME** COMMON NAME BACCHARIS X 'STARN' THOMPSON BROOM DWARF BLUE BUTTERLFY BUSH BUDDLEIA DAVIDII NANHOENSIS 'NANHO PURPLE' **BUXUS JAPONICA 'WINTER GEM'** WINTER GEM BOXWOOD FALLUGIA PARADOXA APACHE PLUME LAVANDULA X INTERMEDIA 'PROVENCE' PROVENCE LAVENDER PUNICA GRANATUM POMEGRANATE COMMON NAME DASYLIRION WHEELERI SOTOL HESPERALOE PARVIFLORA 'YELLOW YELLOW YUCCA NOLINA MICROCARPA **BEARGRASS** <u>GRASSES</u> COMMON NAME **BOTANICAL NAME** BOUTELOUA GRACILIS 'BLONDE AMBITION' 'BLONDE AMBITION' BLUE GRAMA CALAMAGROSTIS X ACUTIFLORA 'KARL FOERSTER' 'KARL FOERSTER' FEATHER REED GRASS MUHLENBERGIA EMERSLEYI EL TORO EL TORO MUHLY GRASS MUHLENBERGIA RIGENS DEER GRASS PERENNIALS **BOTANICAL NAME COMMON NAME ROCKY MOUNTAIN COLUMBINE** AQUILEGIA CAERULEA GAURA LINDHEIMERI WHITE GAURA **COMMON NAME**

LANDSCAPE CALCULATIONS

TRUMPET VINE

TOTAL SITE AREA = 1.9806 AC = 86,275 SF AREA OF LOT COVERED BY BUILDINGS = 31,837 SF NET LOT AREA= 54,438 SF

CAMPIS RADICANS

REQUIRED LANDSCAPE
REQUIRED LANDSCAPE AREA (15% OF NET LOT AREA) = 8,166 SF PROVIDED LANDSCAPE AREA = 17,717 SF = 33% (see hatch legend for exclusions from landscape areas)

TREES PER PARKING SPACES: REQUIRED= 1 TREE / 10 PARKING SPACES

TOTAL NUMBER OF PARKING = 25 SPACES REQUIRED NUMBER OF TREES = 3 TREES

PROVIDED NUMBER OF TREES = 3 TREES NO PARKING SPACE MAY BE MORE THAN 100 FEET AWAY FROM A TREE TRUNK REQUIRED STREET TREES = 15 placed at 25' on center (365' of street frontage) PROVIDED STREET TREES = 0

(Proposed landscape along Holly Avenue frontage is consistent with adjacent development, showing no street trees between the curb and the sidewalk due to site constraints, public utility easement and

REQUIRED GROUND COVERAGE = 13,288 SF = 75% OF PROVIDED LANDSCAPE AREA A MINIMUM 25% OF TOTAL LANDSCAPE COVERAGE BY GROUND PLANTS PROVIDED TOTAL GROUND COVERAGE = xx SF = xx%

TREE CANOPY COVERAGE = xx SF = xx% OF PROVIDED COVERAGE GROUND PLANT COVERAGE = xx SF = xx% OF PROVIDED COVERAGE Calculation assumes an average of 300 sf per tree and 20 sf per ground plant as an average of mature spread and canopy. PROPOSED TURF AREA = 692 SF = 8% OF REQUIRED LANDSCAPE AREA

NO MORE THAN 10 % OF REQUIRED LANDSCAPE AREAS SHALL BE TURF

ROCK MULCH GROUND COVER = 12,072 SF = 68% OF PROVIDED LANDSCAPE AREA

ORGANIC MULCH GROUND COVER = 5,645 SF = 32% OF PROVIDED LANDSCAPE AREA A MAXIMUM OF 75% OF GRAVEL OR CRUSHER FINES IS PERMITTED

PARKING LOT EDGE LANDSCAPE - 165 LF OR PARKING LOT EDGE
REQUIRED PARKING LOT EDGE = 2 TREES AND 6 SHRUBS PER 25' OF PARKING LOT REQUIRED BUFFER = 13 TREES AND 40 SHRUBS PROVIDED BUFFER = XX TREES AND XX SHRUBS

DEKKER PERICH SABATINI

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DRAWN BY JD/TC **REVIEWED BY** MB DATE 09-21-2018 PROJECT NO. 18-0038 DRAWING NAME

LANDSCAPE PLAN PROGRESS DRAFT

- FOR MAINTENANCE OF THE LANDSCAPE DURING CONSTRUCTION AND DURING A 90 DAY-MAINTENANCE PERIOD FOLLOWING SUBSTANTIAL COMPLETION. THE OWNER WILL BE RESPONSIBLE FOR MAINTENANCE FOLLOWING THE 90-DAY
- MAINTENANCE PERIOD. 2. STATEMENT OF COMPLIANCE WITH CITY OF ALBUQUERQUE: THE LANDSCAPE DESIGN WILL COMPLY WITH THE CITY OF ALBUQUERQUE'S GENERAL LANDSCAPING, BUFFERING, AND SCREENING REGULATIONS AND WATER
- CONSERVATION ORDINANCE. 3. TIMING OF LANDSCAPE INSTALLATION: INSTALLATION OF THE LANDSCAPING SHALL BE COMPLETE WITHIN 60 DAYS OF THE RELATED BUILDING'S OCCUPANCY. 4. SURFACE TREATMENT: ALL LANDSCAPE AREAS SHALL BE COVERED WITH VEGETATION AND MULCH. ORGANIC MULCH IS REQUIRED AT EACH TREE ROOTBALL AREA/DRIPLINE.
- 5. LANDSCAPE, FENCING, AND SIGNING WILL NOT INTERFERE WITH CLEAR SIGHT REQUIREMENTS. THEREFORE, SIGNS, WALLS, TREES, AND SHRUBBERY BETWEEN 3' AND 8' (AS MEASURED FROM THE GUTTER PAN) WILL NOT BE ACCEPTABLE IN THIS AREA.
- 6. MINIMUM PLANT SIZES ARE AS PER CITY OF ALBUQUERQUE STANDARDS: 2" CALIPER TREES, 6' HEIGHT CONIFERS, AND 1 GALLON SHRUBS. 7. ALL AREAS DISTURBED DURING CONSTRUCTION, INCLUDING AREAS NOT WITHIN
- THE PROPERTY LINE, WILL BE STABILIZED. 8. ROOF DRAINS: SURFACE DRAINAGE OFF DOWNSPOUTS SHALL BE DIRECTED AWAY FROM BUILDINGS INTO LANDSCAPE AREAS OR ENGINEERED DRAINAGE
- SYSTEM. REFER TO CIVIL. 9. ALL VEGETATIVE SCREENING SURROUNDING GROUND-MOUNTED TRANSFORMERS AND UTILITY PADS SHALL ALLOW 10' OF CLEARANCE IN FRONT OF THE EQUIPMENT DOOR AND 5' OF CLEARANCE ON THE REMAINING SIDES FOR
- SAFE OPERATION AND MAINTENANCE. 10. CONTRACTOR IS TO VERIFY ALL EXISTING UTILITY LOCATIONS BEFORE EXCAVATION AND PLANTING.

- WITH PROGRAMMABLE SETTINGS, AUTOMATED IRRIGATION CONTROLLER, AND MOISTURE SENSOR TO AVOID OVERWATERING.
- 2. THE IRRIGATION SYSTEM SHALL BE DESIGNED TO MINIMIZE THE USE OF WATER. 3. THE IRRIGATION SYSTEM SHALL NOT IRRIGATE IMPERVIOUS SURFACES, INCLUDING SIDEWALKS, DRIVEWAYS, STREETS AND PARKING OR LOADING
- 4. IRRIGATION POINT OF CONNECTION TO THE CITY WATER WILL BE LOCATED WITHIN PROPERTY LIMITS AND SHALL COMPLY WITH THE CITY OF ALBUQUERQUE REDUCED PRESSURE BACKFLOW PREVENTER STANDARDS AND
- 5. RUN TIMES AND IRRIGATION ZONES SHALL BE BASED UPON PLANT SPECIES AND THEIR ESTABLISHMENT. RUN TIMES SHALL BE REGULARLY ADJUSTED ACCORDING TO PLANT MATURITY, SEASON, LOCATION AND PERFORMANCE.

○ SHEET KEYED NOTES

- 1. DRAINAGE SWALE, SEE CIVIL.
- 2. PUBLIC UTILITY EASEMENT.
- 3. CLEAR SIGHT TRIANGLE.

SPECIFICATIONS.

- 4. PROPERTY LINE.
- 5. PARKING LOT FRONT LANDSCAPE BUFFER. 6. PARKING OVERHANG.

EST QTY GRAVEL MULCH LANDSCAPE AREA 12,072 SF ORGANIC MULCH LANDSCAPE AREA 4,953 SF


GRAVEL MULCH LANDSCAPE AREA in R.O.W excluded from landscape area calculations

692 SF STABILIZED CRUSHER FINES 1,249 SF excluded from landscape area calculations

WIRE, BURLAP AND ROPE SHALL BE COMPLETELY REMOVED. . ALL PLANT MATERIAL SHALL BE PLANTED IN UNCOMPACTED

1. PRIOR TO BACKFILLING, ALL MATERIAL SUCH AS CONTAINERS,

3 TIMES ROOTBALL DIAMETER

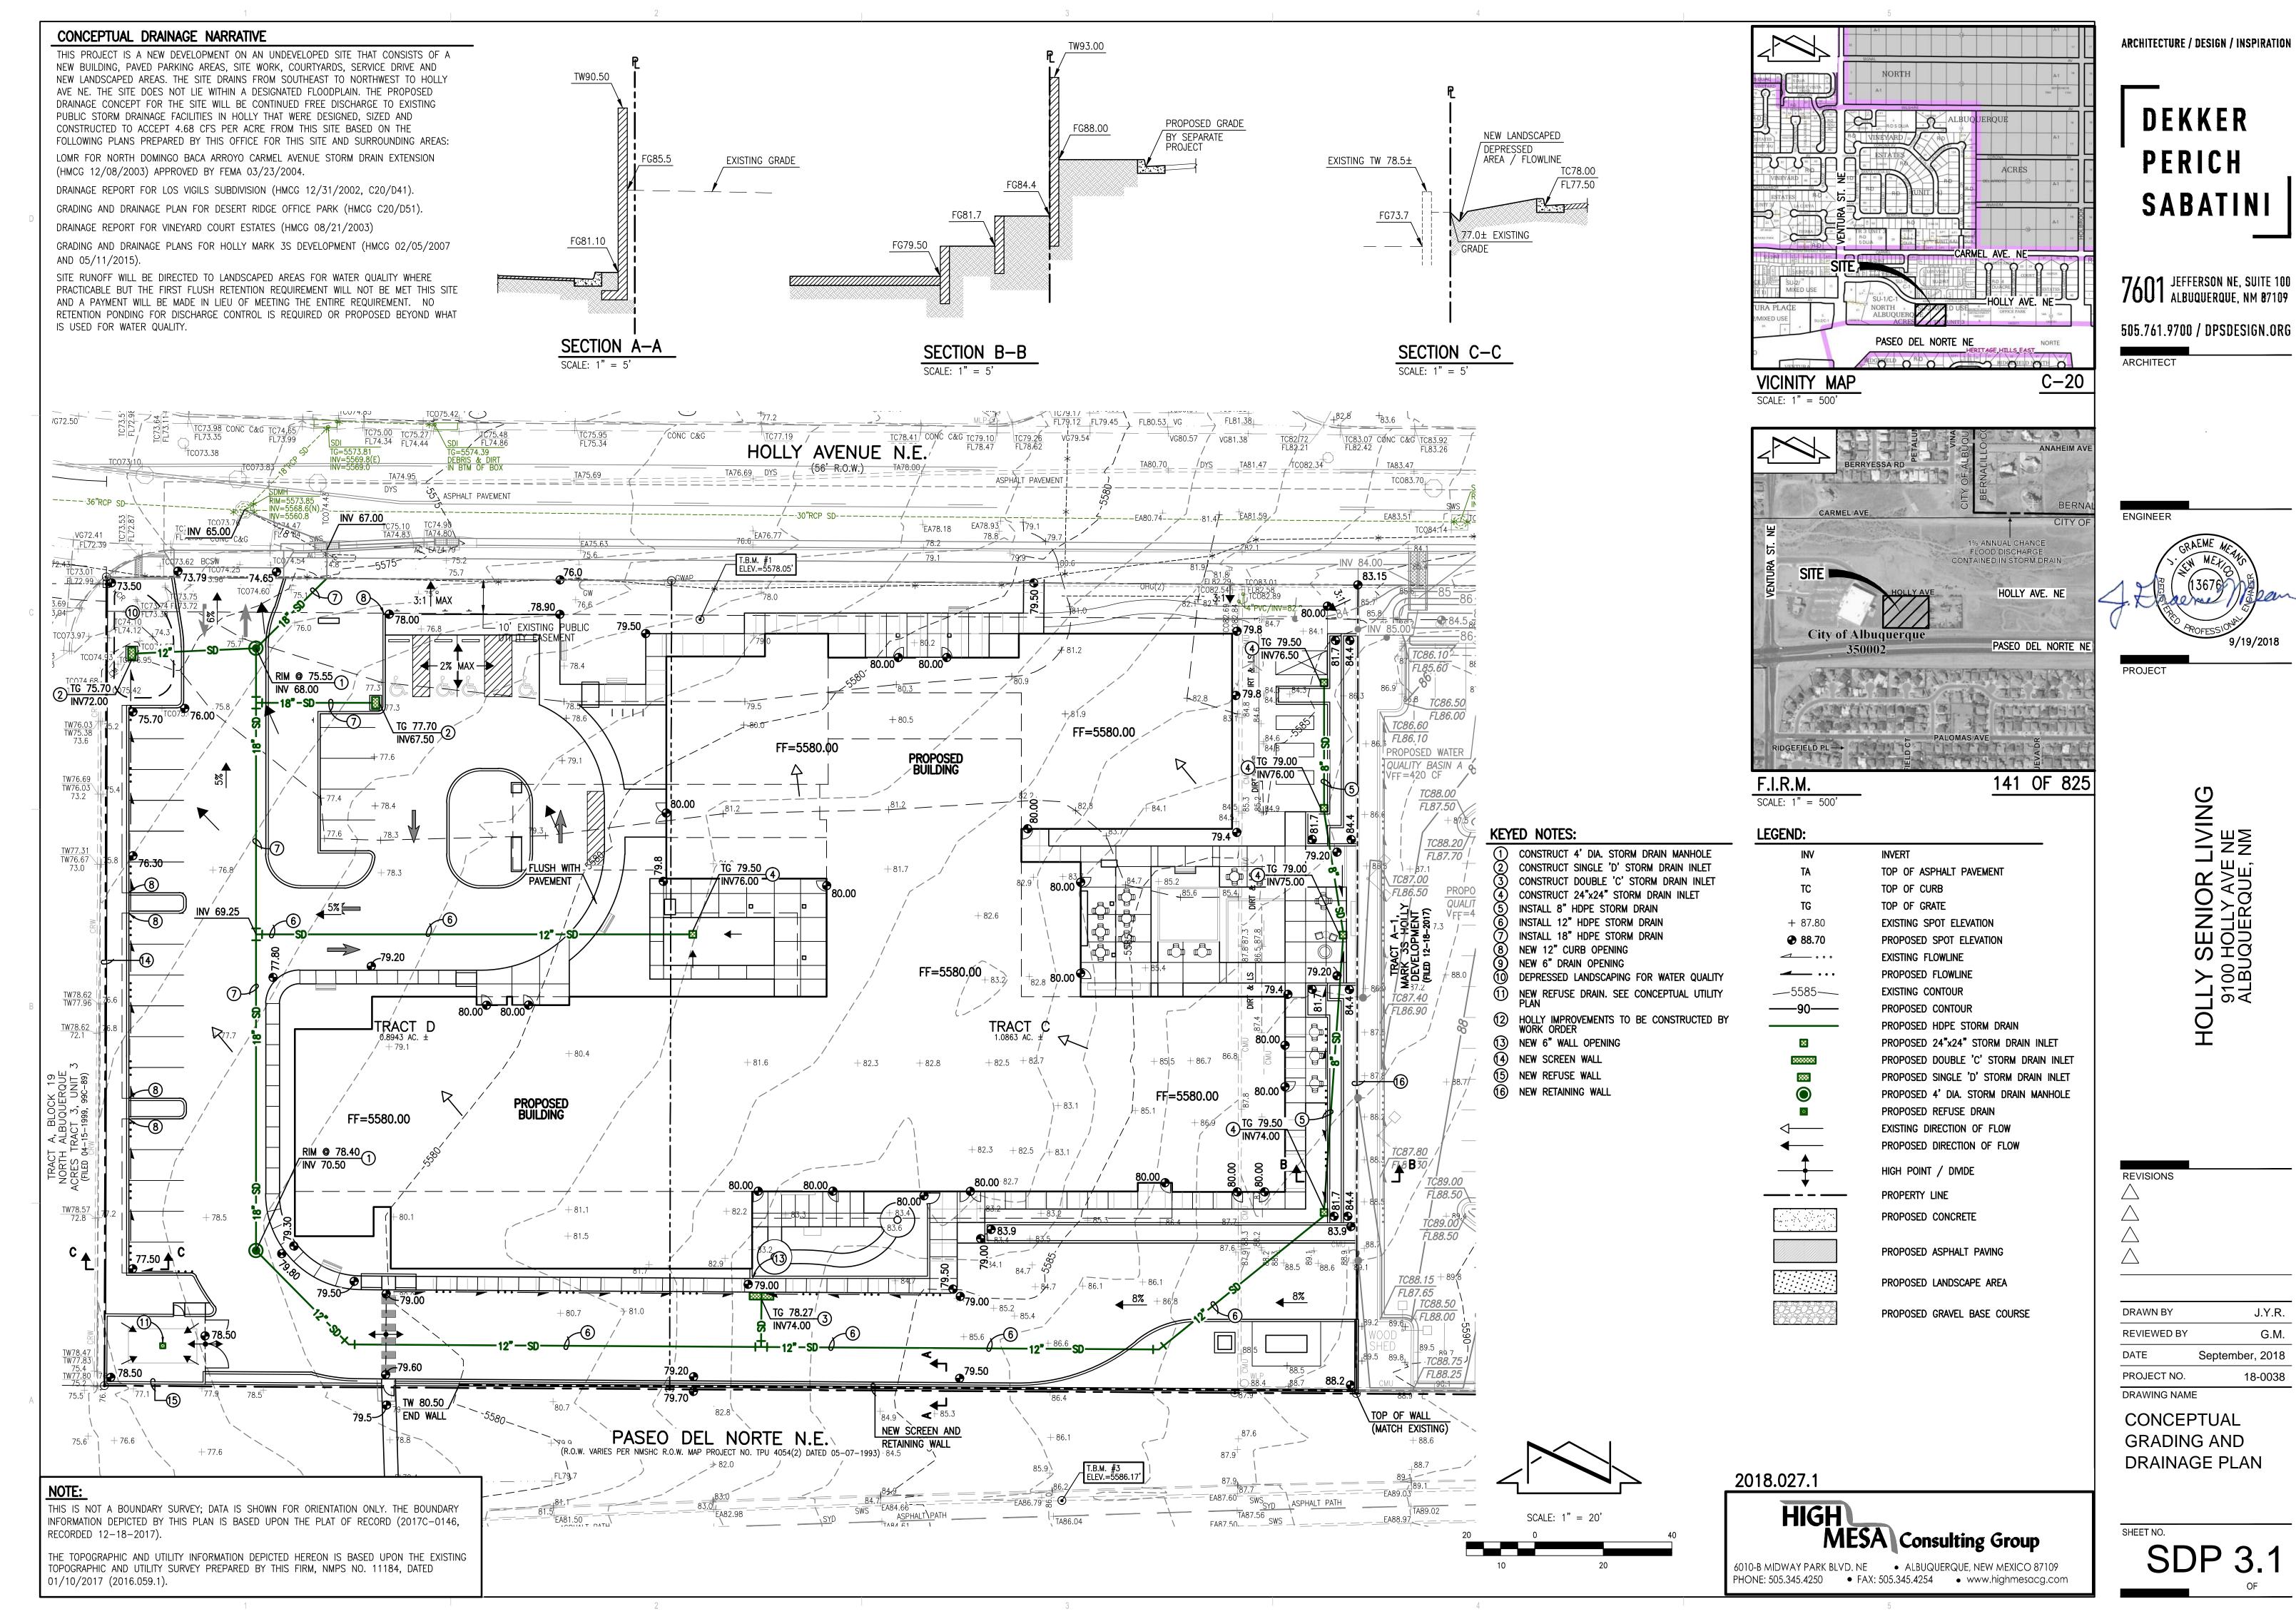

SHEET NO.


J.Y.R.

G.M.

18-0038

September, 2018

HOLLY SENIOR LI 9100 HOLLY AVE N ALBUQUERQUE, N

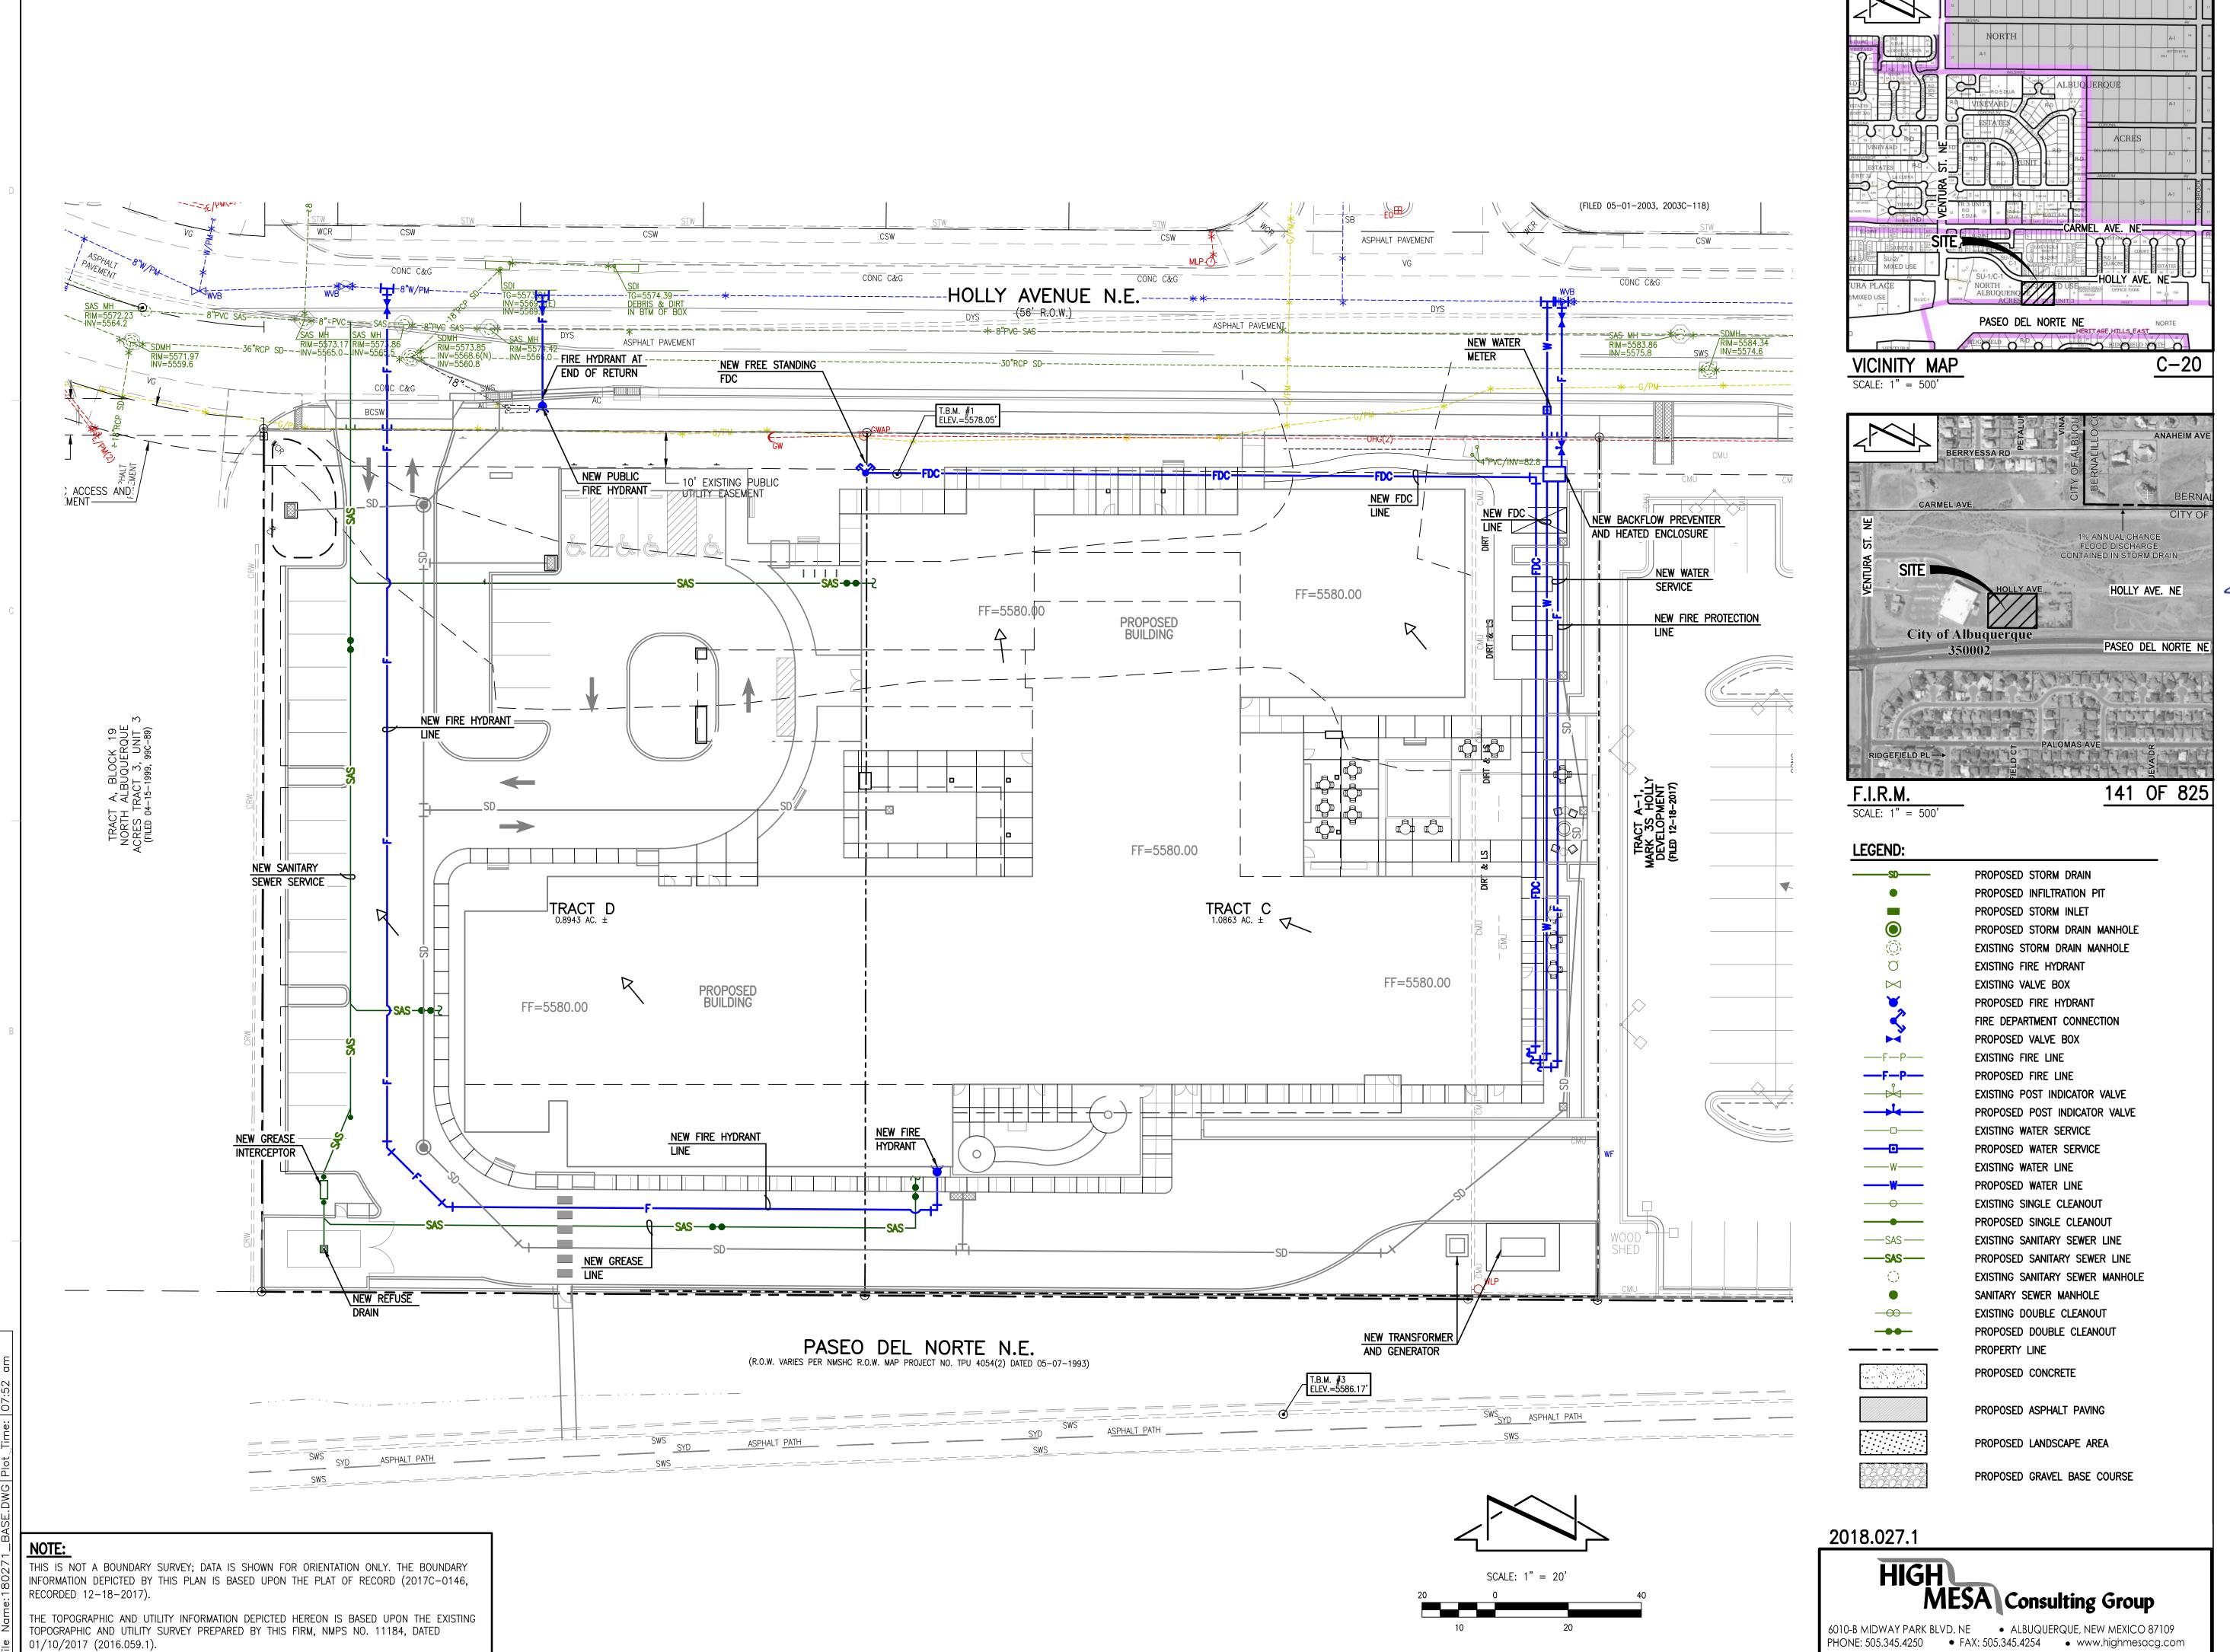

ARCHITECTURE / DESIGN / INSPIRATION

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DATE

REVIEWED BY

PROJECT NO.

DRAWING NAME

CONCEPTUAL

UTILITY PLAN

J.Y.R.

G.M.

18-0038

September, 2018

SHEET NO.

DEKKER PERICH SABATINI

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DRAWN BY **REVIEWED BY** MJH DATE 09/20/2018 18-0038 PROJECT NO.

DRAWING NAME **EXTERIOR**

BUILDING **ELEVATION**

SHEET NO.

Scale: 1" = 12' - 0"

SDP5.1

