

HOLLY AVENUE SENIOR LIVING

PROJECT TEAM

OWNER/BUILDER

MARK 3S, INC. 6501 WYOMING BLVD. NE ALBUQUERQUE, NM 87109 PHONE: 505.220.7625


ARCHITECTURAL/STRUCTURAL

DEKKER/PERICH/SABATINI, LTD. 7601 JEFFERSON ST. NE, SUITE 100 ALBUQUERQUE, NM 87109 PHONE: 505.761.9700



- SDP 1.1 SDP 1.2
- SDP 1.3
- SDP 1.4 SDP 2.1
- SDP 3.1
- SDP 3.2 SDP 4.1
- SDP 5.1
- SDP 6.1



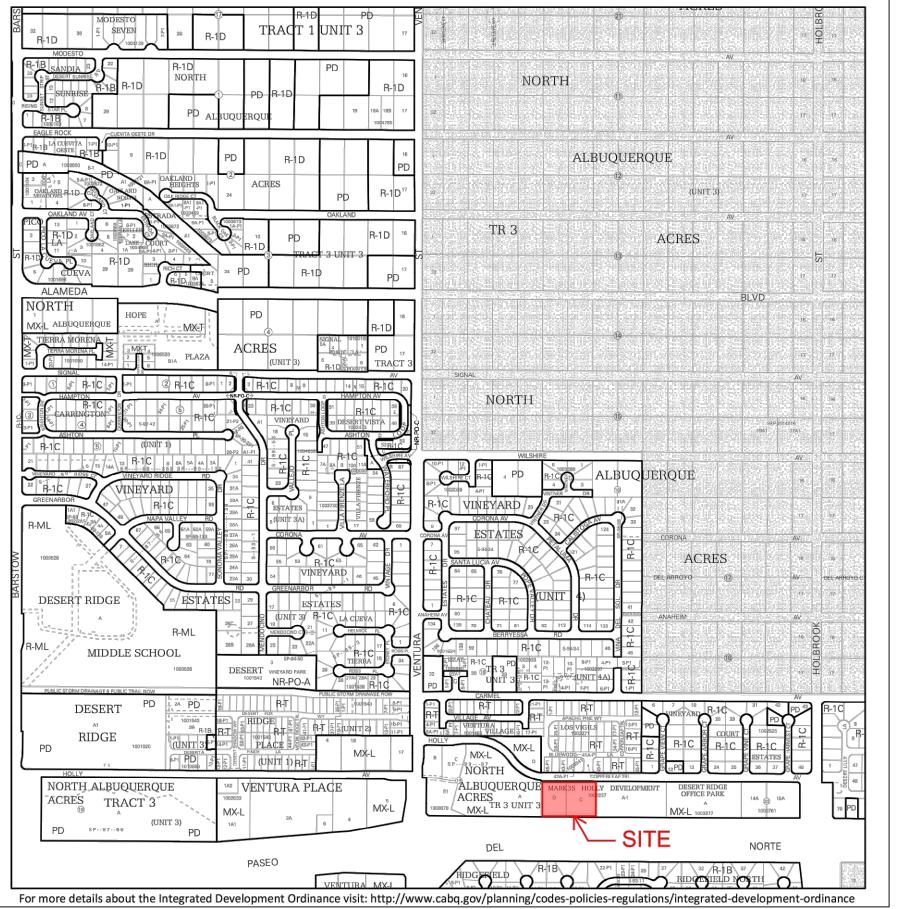

CIVIL

HIGH MESA CONSULTING GROUP 6010-B MIDWAY PARK BLVD.NE ALBUQUERQUE, NM 87109 PHONE: 505.345.4250

MECHANICAL /PLUMBING

ARSED ENGINEERING GROUP, LLC 4700 LINCOLN ROAD NE ALBUQUQUERQUE,NM 87109 PHONE: 505.761.3100

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DEKKER PERICH SABATINI

7601 JEFFERSON NE, SUITE 100 ALBUQUERQUE, NM 87109

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ARCHITECT

VICINITY MAP

ENGINEER PROJECT


ELECTRICAL

AC ENGINEERING ENTERPRISES, LLC. 120 ALISO DR.SE ALBUQUERQUE, NM 87108 PHONE: 505.842.5787

DATE	10-19-2018
PROJECT NO.	18-0038

ISSUE PURPOSE

SDP APPLICATION

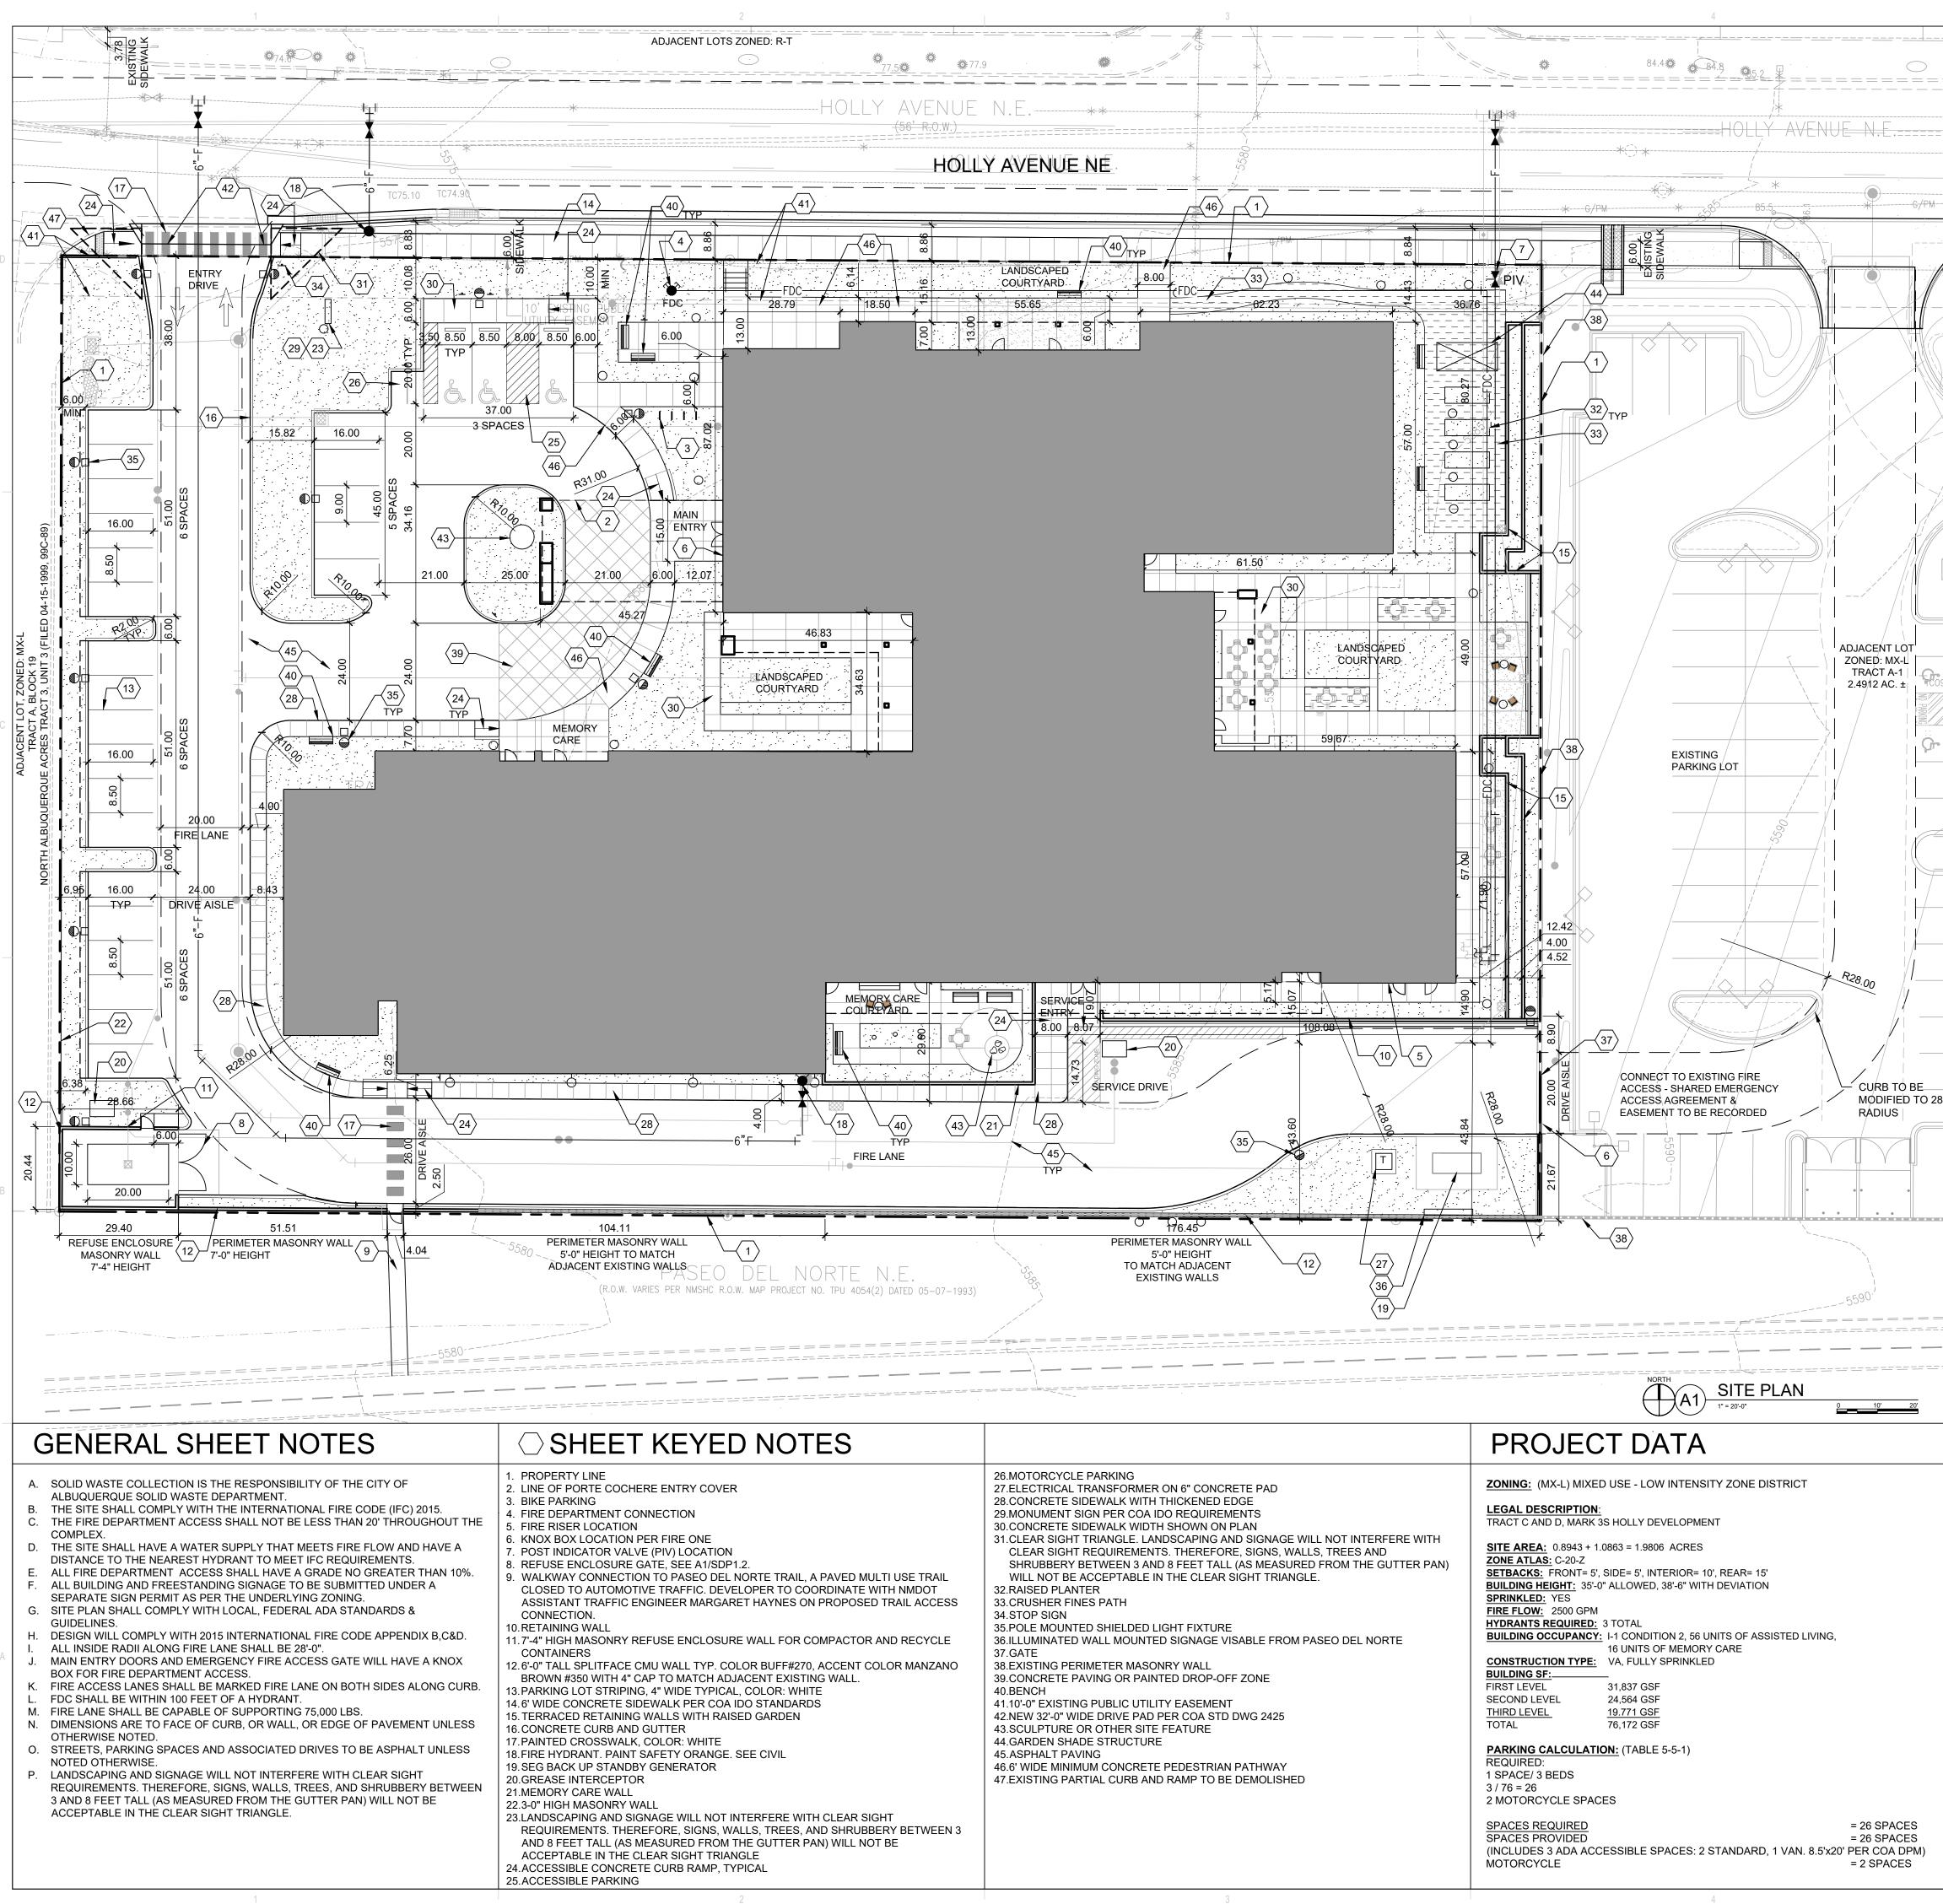

ARCHITECTURE / DESIGN / INSPIRATION

DEKKER PERICH SABATINI

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ARCHITECT


DESERT RIDGE OFFICE PARK

A MX-L 1003277

ENGINEER

PROJECT



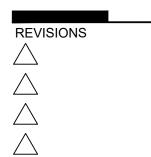

DRAWN BY	VNF
REVIEWED BY	MJH
DATE	10-19-2018
PROJECT NO.	18-0038
DRAWING NAME	

SITE PLAN



۱	RIDGERELD R-1B	25 27 32 R-1B RIDGENELD N
	VICINITY MAP	PARTIAL ZONE MAP # C-2
	PROJECT NO.	
	APPLICATION NO.	
	IS AN APPROVED INFRASTRUCTURE LIST REQUIRED? []YES []NO. IF YES, THEN A SET OF APPROVED DRC PLANS WITH A WORK ORDER IS REQUIRED FOR A CONSTRUCTION WITHIN PUBLIC RIGHT OF WAY OR FO CONSTRUCTION OF PUBLIC IMPROVEMENTS.	
	DRB SITE DEVELOPMENT PLAN APPROVAL:	
	TRAFFIC ENGINEERING, TRANSPORTATION DIVISION	DATE:
	ABCWUA	DATE:
	PARKS & RECREATION DEPARTMENT	DATE:
	CITY ENGINEER/HYDROLOGY	DATE:
	ENVIRONMENTAL HEALTH (CONDITIONAL)	DATE:
	SOLID WASTE MANAGEMENT	DATE:
	DRB CHAIRPERSON, PLANNING DEPT.	DATE:
	CODE ENFORCEMENT	DATE:

PD - 5 - 6 1 PI # 44P1 7-P1 6-P1 1-P1

ALBUQUERQUE MARK3S HOLLY DEVELOPMENT

NORT

ACRES A MX-L TR 3 UNIT 3

DEL

CURB TO BE

RADIUS

0 10' 20'

= 26 SPACES

= 26 SPACES

= 2 SPACES

MØDIFIED TO 28'


ADJACENT LOT ZONED: MX-L TRACT A-1

2.4912 AC. ±

LEGEND

	LANDSCAPE AREA
	STABILIZED CRUSHER FINES PAVING
	FIRE DEPARTMENT ACCESS LANE / EASEMENT AS NOTED
	PROPERTY LINE
Q	FIRE HYDRANT
	MAX BUILDING SET BACK LINE
	EASEMENT LINE
	6' WIDE PAINTED CROSSWALK
	SIDEWALK RAMP (ARROW POINTS DOWN)
	POST INDICATOR VALVE, RE: CONCEPTUAL UTILITY PLAN
	FIRE DEPARTMENT CONNECTION
-	ACCESSIBLE PARKING ONLY SIGN
	BENCH

ADA PARKING

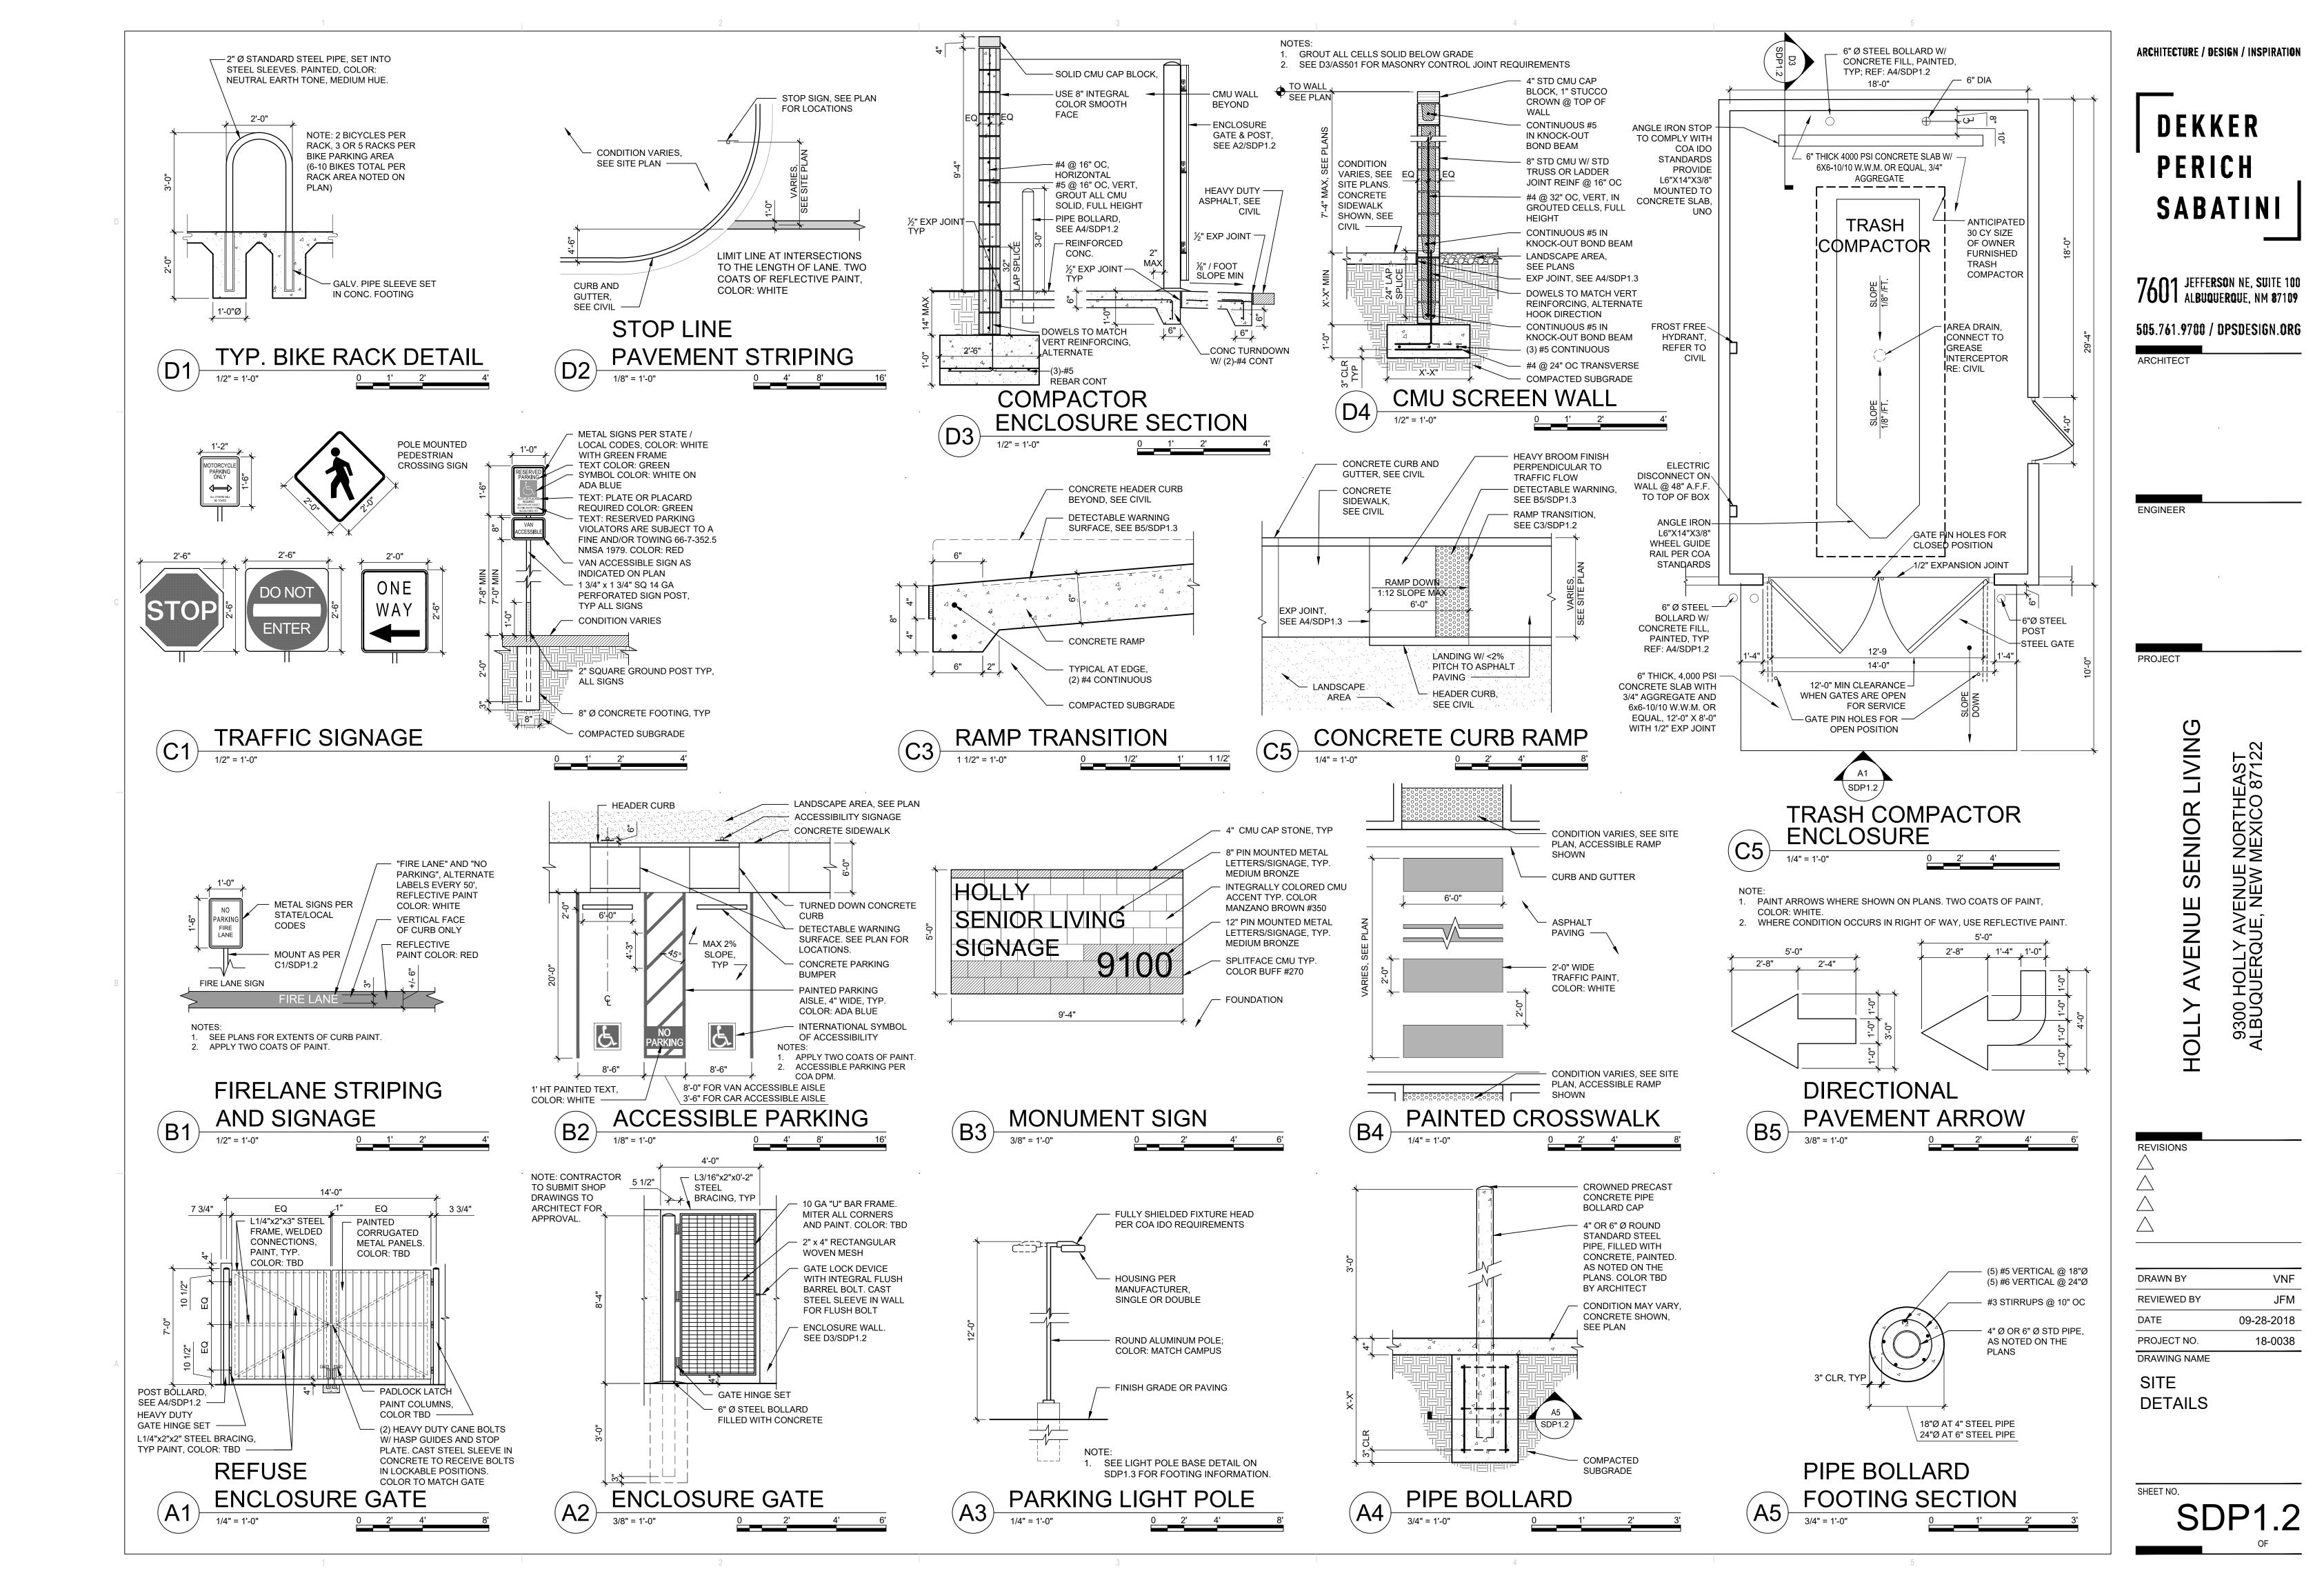

2

CONC	RETE JOINT				
	2" 4 NSION JOINT	MATCH C	LE FILLER (COLOF CONCRETE) ON BA RADIUS ON EXPO	ACKER	
CONTROL AND EXPAN	ISION JOINT SPACING	-UNLESS NOT	ED OTHERWISE	ON PLANS	
APPROX WIDTH OF CONCRETE	CURB & GUTTER, ROLL, HEADER, FLUSH CURBS	5' WALK	8' WALK & BLDG APRON	6'-12' WALK	
CONTROL JOINTS	4' OC	5' OC 8' OC		6' OC	
EXPANSION JOINTS	16' OC	15' OC	24' OC	18' OC	
CONCRETE JOINTS & JOINT SPACING 1 1/2" = 1'-0" 0 1/2' 1' 1 1/2'					

4

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SAWCUT CONTROL JOINT

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ARCHITECT


ENGINEER

PROJECT

9300 HOLLY AVENUE NORTHEAST ALBUQUERQUE, NEW MEXICO 87122

SENIOR LIVING AVENUE

ΗΟΓΓΥ REVISIONS \bigtriangleup \triangle \triangle

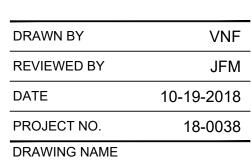

SDP1.3

OF

DRAWING NAME

DETAILS

SITE

SHEET NO.

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- COMPACTED SUBGRADE CONDITION VARIES, LANDSCAPE AREA SHOWN. SEE SITE PLAN.

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_____ ⊲___

1 1/2'

A5 CONCRETE SIDEWALK

OF SLAB, SEE SITE PLAN FOR LOCATIONS

1/4" WIDE x 1" DEEP TOOLED CONCRETE JOINT WITH 1/4" RADIUS ON EDGES, SEE SITE PLAN FOR LOCATIONS


DETECTABLE
 WARNING SURFACE

 1" = 1'-0"
 (**B5**) SAWCUT 3/16" WIDE x 1/3rd DEPTH NOTES: 1. SEE SITE PLANS AND A4/SDP1.3 FOR JOINTING. 2. CAST-IN-PLACE CONCRETE PAVING, LIGHT BROOM FINISH PERPENDICULAR TO TRAFFIC FLOW WITH 1/2" RADIUS ON EXPOSED EDGES 3. INTEGRAL COLOR WHERE NOTED ON PLANS. 4. FINISH GRADE FOR LANDSCAPE AREAS SHALL BE 1/2" BELOW TOP OF PAVING. VARIES, SEE SITE PLAN

4 4 5 7 Ç 6

WIDTH VARIES. SEE SITE PLAN DOMES @ 1.670" O/C


NOTES: 1. MANUFACTURER: XXXX 2. COLOR: XXXX 3. INSTALL PER MANUFACTURER'S DETAILS AND SPECIFICATIONS

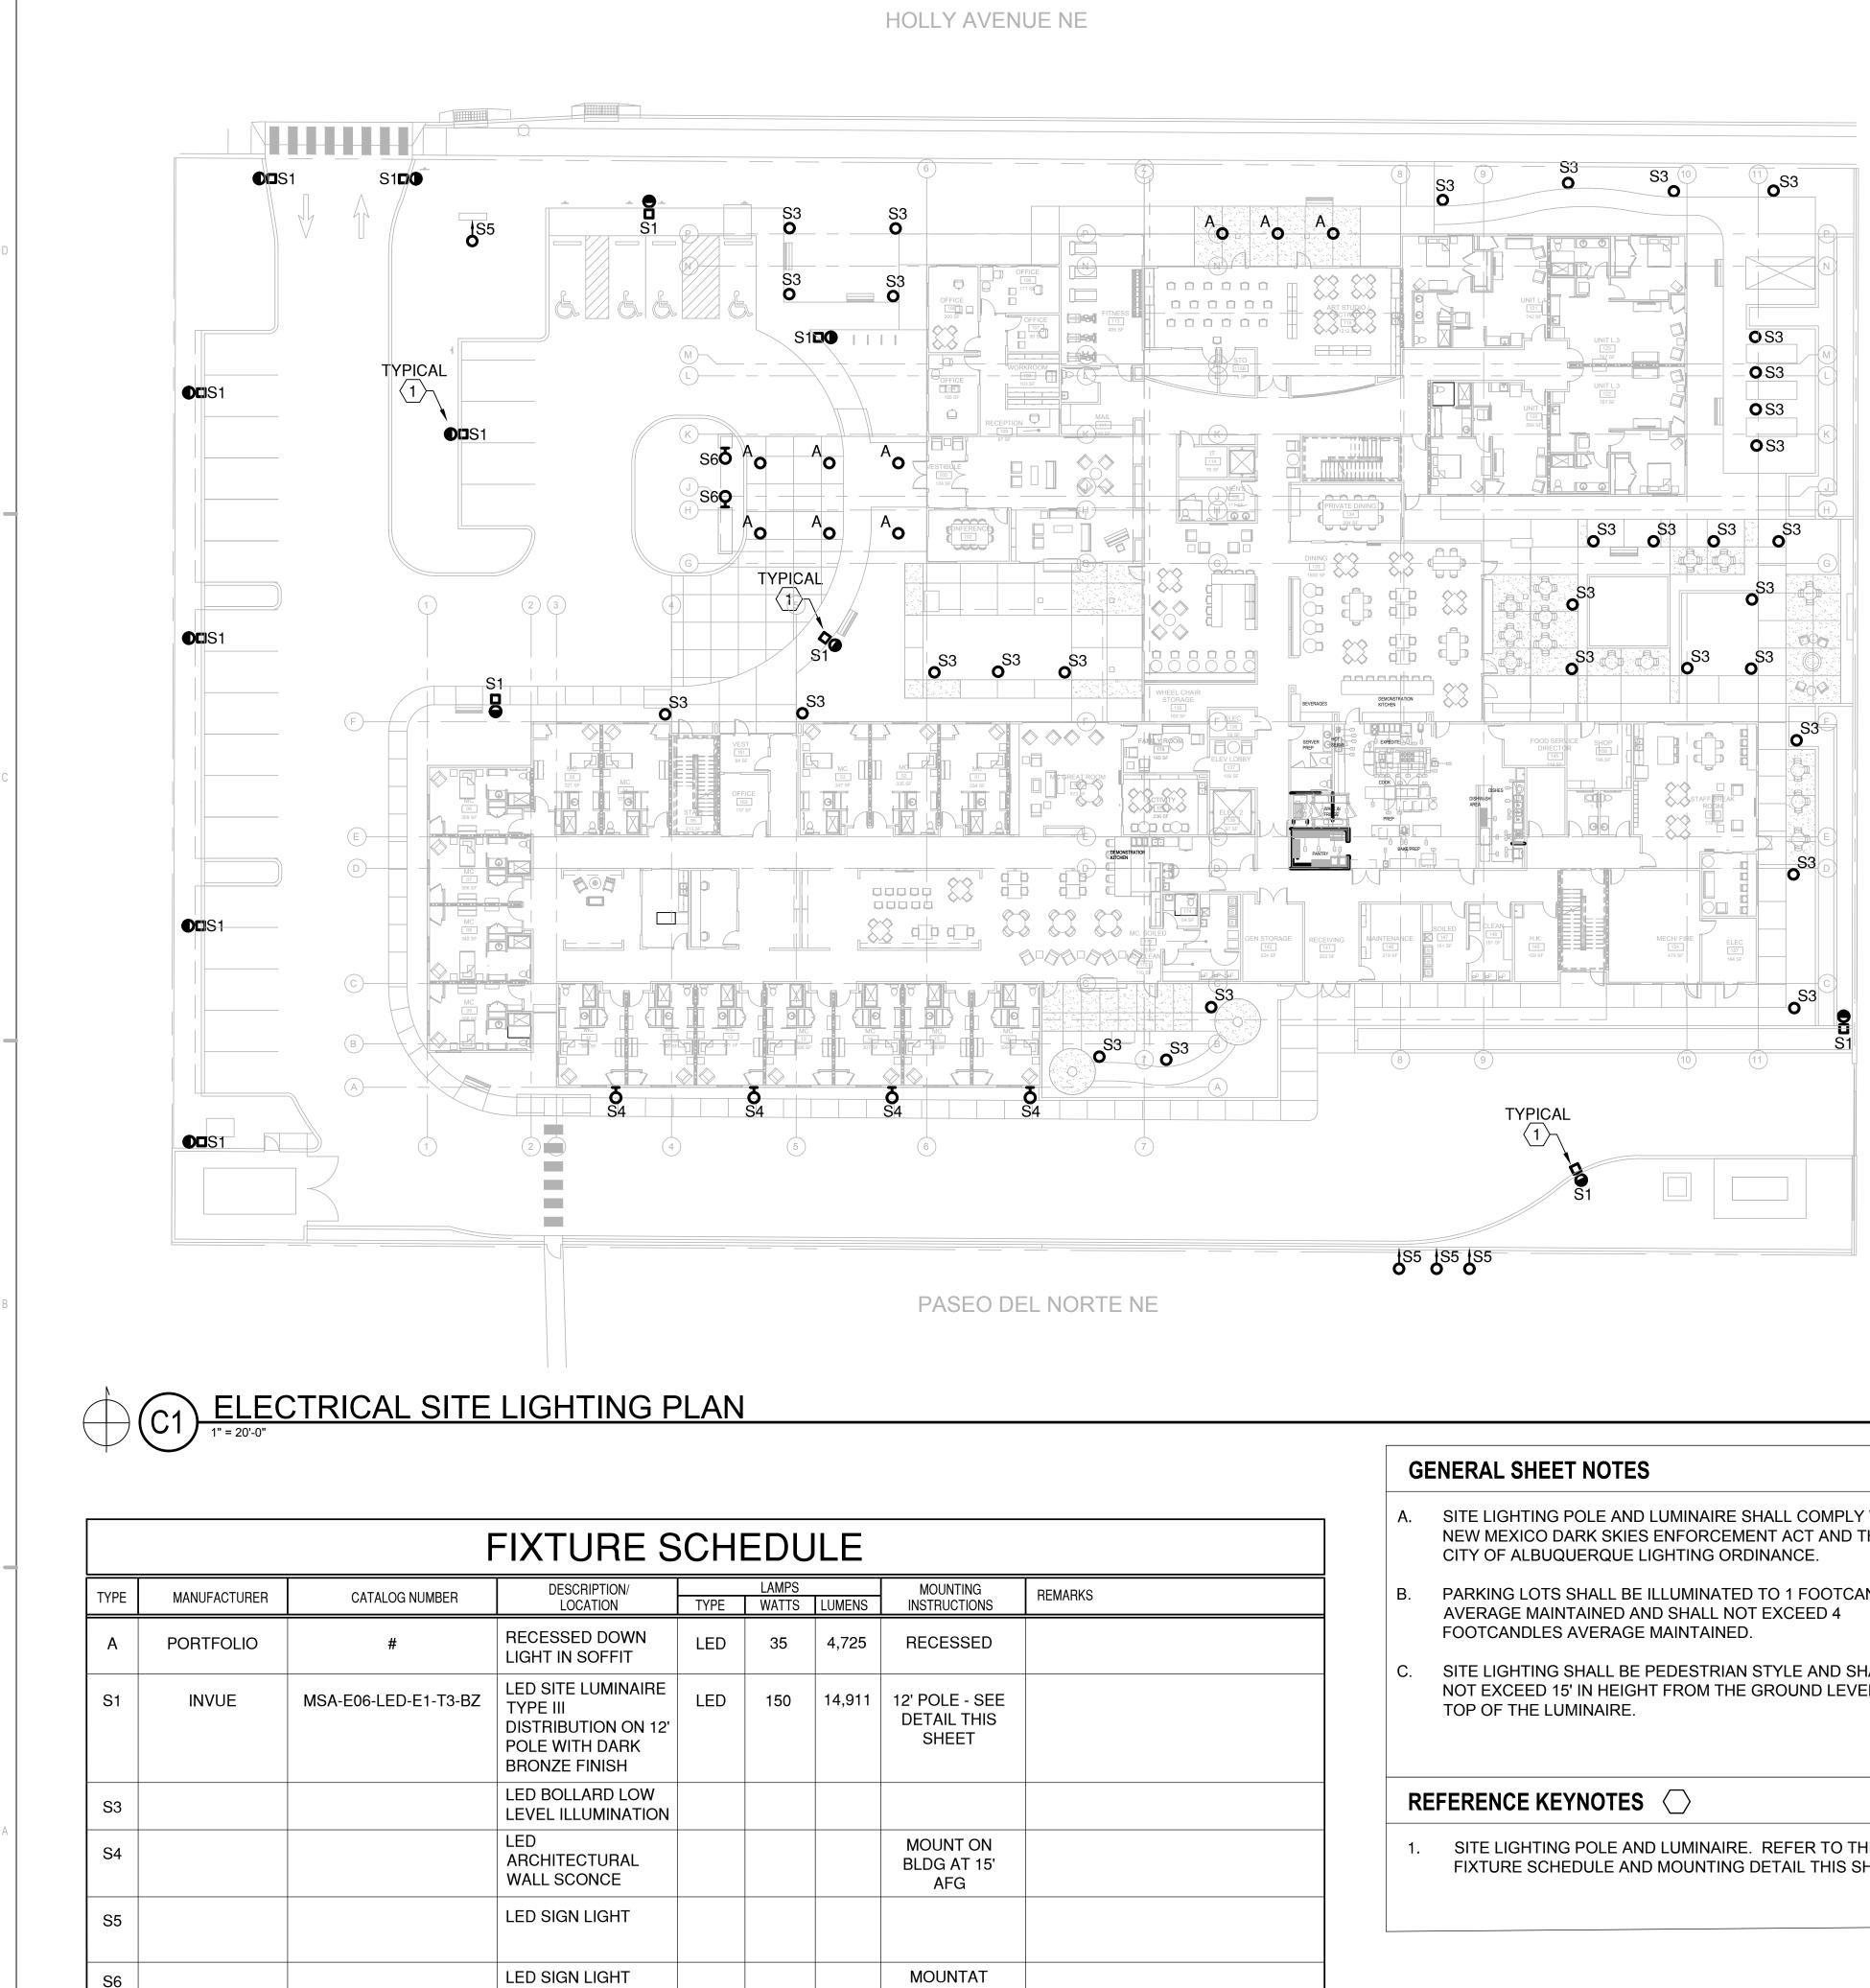


MOUNTING INSTRUCTIONS	REMARKS
RECESSED	
12' POLE - SEE DETAIL THIS SHEET	
MOUNT ON BLDG AT 15' AFG	
MOUNTAT PORTE COCHERE AT 9' AFG	


- SITE LIGHTING POLE AND LUMINAIRE SHALL COMPLY WITH NEW MEXICO DARK SKIES ENFORCEMENT ACT AND THE
- PARKING LOTS SHALL BE ILLUMINATED TO 1 FOOTCANDLE
- SITE LIGHTING SHALL BE PEDESTRIAN STYLE AND SHALL NOT EXCEED 15' IN HEIGHT FROM THE GROUND LEVEL THE

SITE LIGHTING POLE AND LUMINAIRE. REFER TO THE FIXTURE SCHEDULE AND MOUNTING DETAIL THIS SHEET.

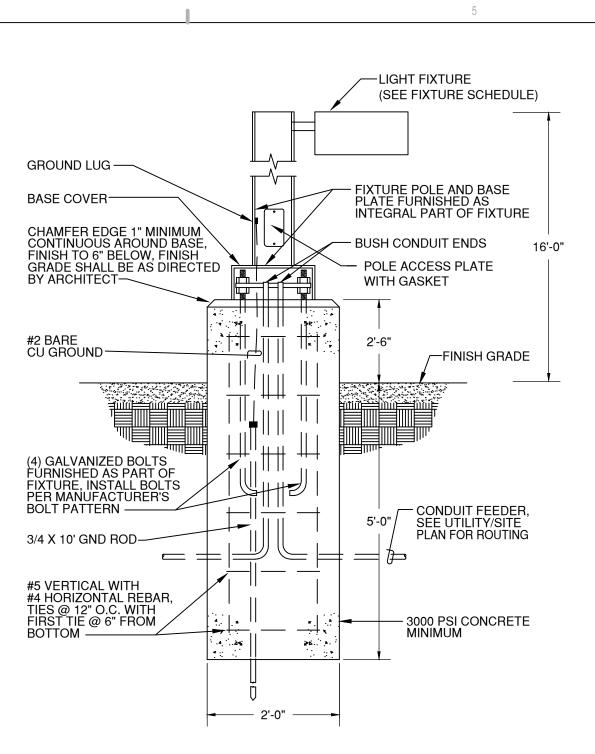

POLE BASE DETAIL FOR PARKING LUMINAIRES NO SCALE

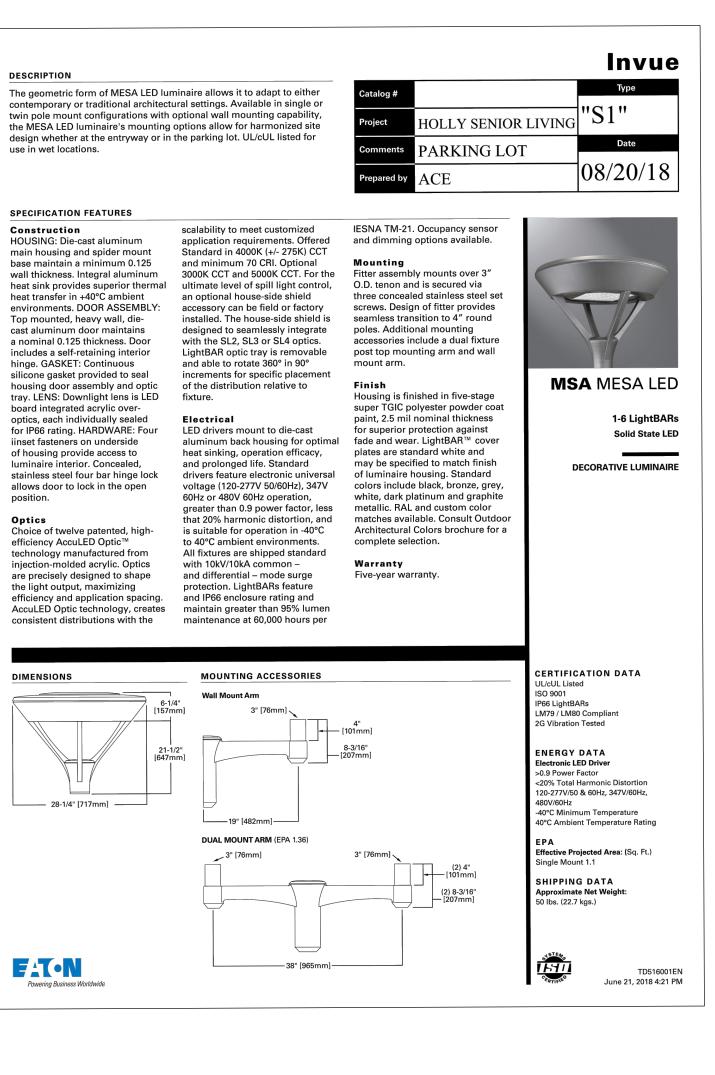

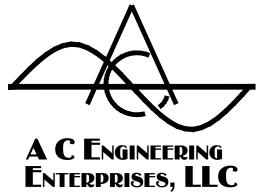

120 Aliso Drive, SE Albuquerque, New Mexico 87108 Phone 505.842.5787 Facsimile 505.842.5797


ARCHITECTURE / DESIGN / INSPIRATION



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ARCHITECT

FOR REFERENCE ONLY



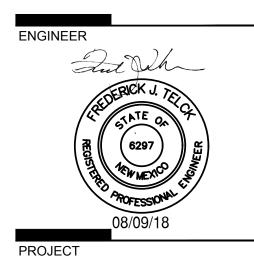


REVISIONS \bigtriangleup \bigtriangleup \triangle \triangle DRAWN BY **REVIEWED BY** DATE 7-30-2018

PROJECT NO. 18-0038 DRAWING NAME

ELECTRICAL SITE LIGHTING PLAN



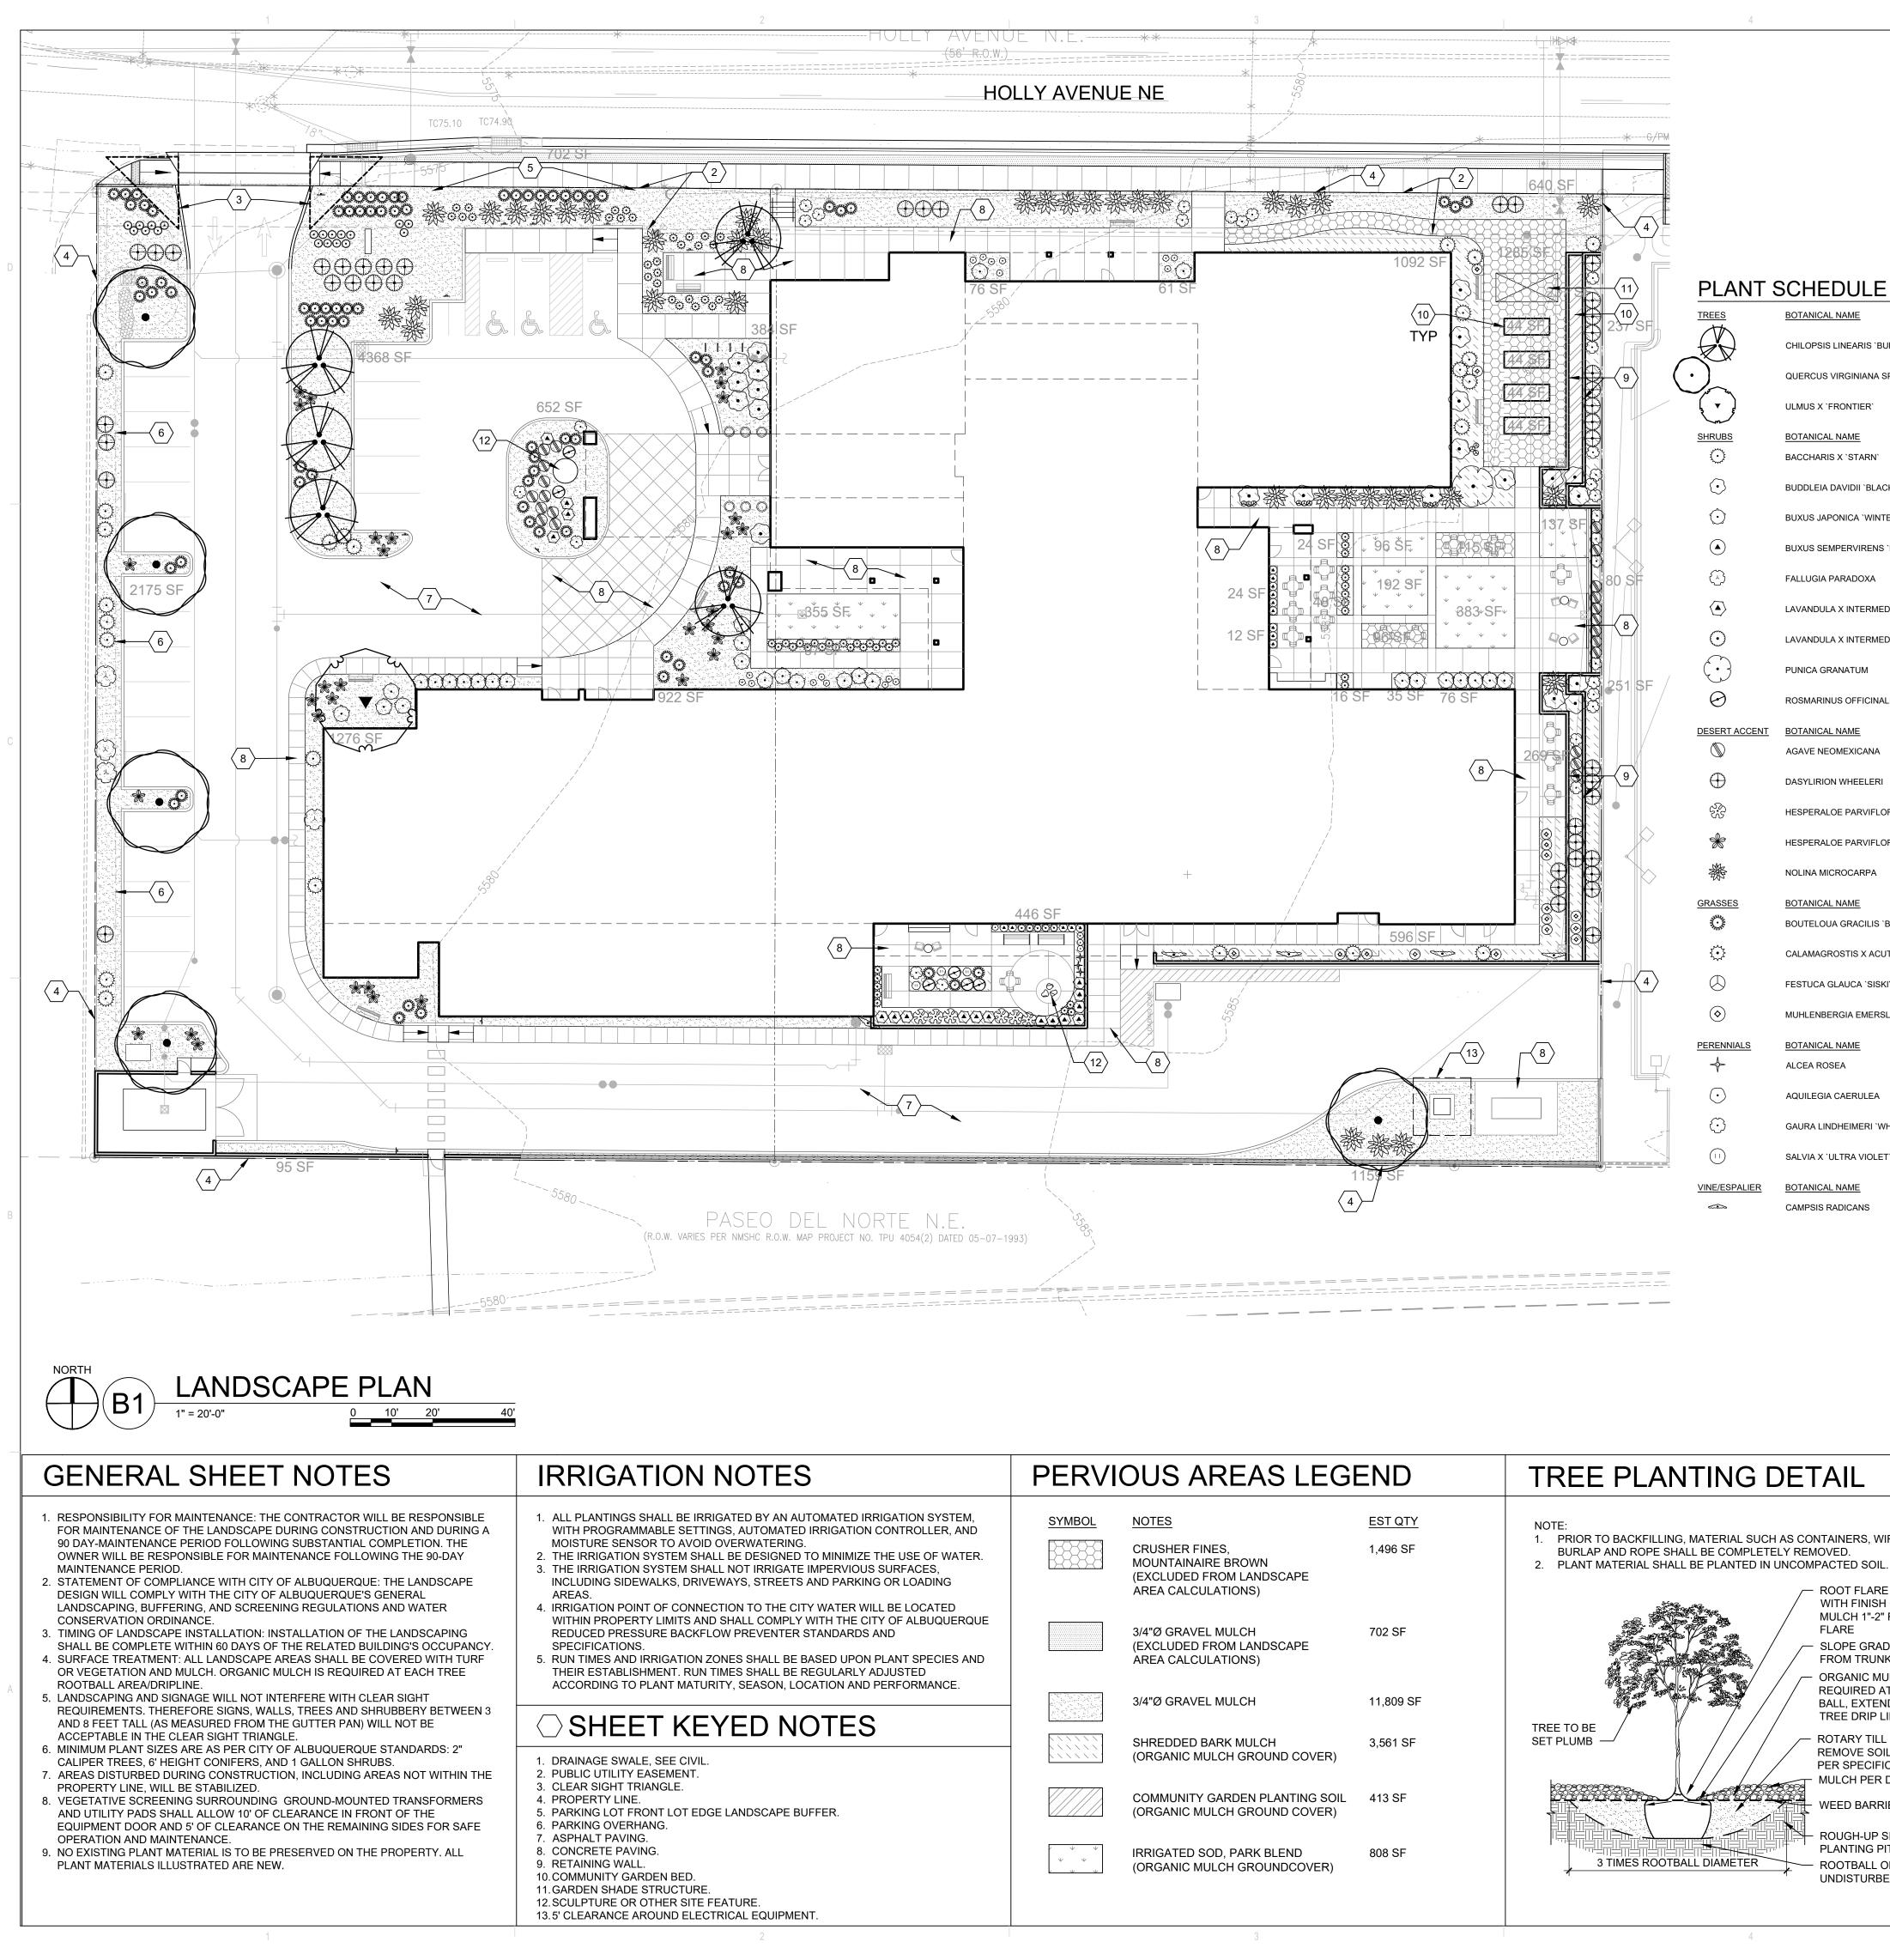

DEKKER PERICH SABATINI

7601 JEFFERSON NE, SUITE 100 ALBUQUERQUE, NM 87109

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ARCHITECT

ENGINEER

PROJECT

ENIOR LIVING E NORTHEAST MEXICO 87122 9300 HOLLY AVENUE ALBUQUERQUE, NEW


S

AVENUE

ΗΟΓΓΥ

	LANDSCAPE CALCULATIONS
	TOTAL SITE AREA = 1.9806 AC = 86,275 SF AREA OF LOT COVERED BY BUILDINGS = 31,837 SF NET LOT AREA= 54,438 SF
_	REQUIRED LANDSCAPE REQUIRED LANDSCAPE AREA (15% OF NET LOT AREA) = 8,166 SF PROVIDED LANDSCAPE AREA = 16,591 SF = 31% (see hatch legend for exclusions from landscape areas)
RS, WIRE,	REQUIRED TREES
) SOIL.	TREES PER PARKING SPACES: REQUIRED= 1 TREE / 10 PARKING SPACES TOTAL NUMBER OF PARKING = 26 SPACES
FLARE TO BE FLUSH FINISH GRADE. NO I 1"-2" FROM TRUNK	REQUIRED NUMBER OF PARKING LOT TREES = 3 TREES PROVIDED NUMBER OF PARKING LOT TREES = 7 TREES NO PARKING SPACE MAY BE MORE THAN 100 FEET AWAY FROM A TREE TRUNK
GRADE AWAY TRUNK	REQUIRED STREET TREES = 15 placed at 25' on center (365' of street frontage) PROVIDED STREET TREES = 0 (Proposed landscape along Holly Avenue frontage is consistent with adjacent development showing no street trees between the curb and the sidewalk due to site
NIC MULCH IS RED AT THE ROOT EXTENDING TO THE DRIP LINE	constraints, public utility easement and overhead utility lines.) <u>REQUIRED VEGETATIVE COVERAGE</u> REQUIRED GROUND COVERAGE = 12,443 SF = 75% OF PROVIDED LANDSCAPE AREA <i>A MINIMUM 25% OF TOTAL LANDSCAPE COVERAGE BY GROUND PLANTS</i>
Y TILL PLANT PIT; /E SOIL, BACKFILL /ECIFICATIONS I PER DRAWINGS	PROVIDED TOTAL GROUND COVERAGE = 12,493 SF = 75% TREE CANOPY COVERAGE = 6,872 SF = 41% OF PROVIDED COVERAGE GROUND PLANT COVERAGE = 4,813 SF = 29% OF PROVIDED COVERAGE PROPOSED TURF AREA = 808 SF = 5% OF REQUIRED LANDSCAPE AREA NO MORE THAN 10 % OF REQUIRED LANDSCAPE AREAS SHALL BE TURF
BARRIER FABRIC	GROUND COVER MATERIAL
H-UP SIDES OF ING PIT	ROCK MULCH GROUND COVER = 11,809 SF = 71% OF PROVIDED LANDSCAPE AREA ORGANIC MULCH GROUND COVER = 4,782 SF = 29% OF PROVIDED LANDSCAPE AREA A MAXIMUM OF 75% OF GRAVEL OR CRUSHER FINES IS PERMITTED

PARKING LOT EDGE LANDSCAPE - 90 LF OF PARKING LOT EDGE REQUIRED PARKING LOT EDGE = 2 TREES AND 6 SHRUBS PER 25' OF PARKING LOT REQUIRED BUFFER = 13 TREES AND 40 SHRUBS PROVIDED BUFFER = 0 TREES AND 25 SHRUBS (no trees included due to utility easement)

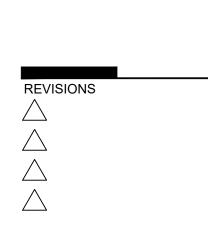


DRAWN BY	JD/TC
REVIEWED BY	MB
DATE	10-19-2018
PROJECT NO.	18-0038
DRAWING NAME	

LANDSCAPE PLAN


SHEET NO. **SDP2.1**


AME	COMMON NAME	SIZE	MAT. HT.	MAT. DIA.	WATER USE	EST QTY
IEARIS `BUBBA`	'BUBBA' DESERT WILLOW	24"BOX	20.00	20.00	LOW	5
GINIANA SP. FUSIFORMIS	ESCARPMENT LIVE OAK	2" CAL	35.00	35.00	LOW	5
NTIER'	FRONTIER ELM	2"CAL B&B	30.00	25.00	MED	1
AME_	COMMON NAME	<u>SIZE</u>	MAT. HT.	MAT. DIA.	WATER USE	<u>EST QTY</u>
`STARN`	THOMPSON BROOM	5 GAL	4.00	4.00	LOW	24
/IDII `BLACK KNIGHT`	BLACK KNIGHT BUTTERFLY BUSH	5 GAL	6.00	5.00	MED	22
ICA `WINTER GEM`	WINTER GEM BOXWOOD	5 GAL	4.00	4.00	MED	26
RVIRENS 'MON ALEX'	PETITE PILLAR BOXWOOD	5 GAL	2.00	2.00	MED	14
ADOXA	APACHE PLUME	5 GAL	4.00	5.00	LOW	4
INTERMEDIA 'GROSSO'	GROSSO LAVENDER	1 GAL	3.00	3.00	MED	17
INTERMEDIA 'PROVENCE'	PROVENCE LAVENDER	1 GAL	2.00	2.00	LOW	19
ATUM	POMEGRANATE	15 GAL	10.00	10.00	LOW	1
OFFICINALIS `ARP`	ARP ROSEMARY	1 GAL	3.00	3.00	LOW	6
AME_	COMMON NAME	SIZE	<u>MAT. HT.</u>	MAT. DIA.	WATER USE	<u>EST QTY</u>
EXICANA	NEW MEXICO CENTURY PLANT	1 GAL	2.00	3.00	LOW	22
/HEELERI	SOTOL	5 GAL	4.00	4.00	LOW	43
PARVIFLORA	RED YUCCA	5 GAL	3.00	3.50	LOW	6
PARVIFLORA `YELLOW`	YELLOW YUCCA	5 GAL	3.00	3.50	LOW	39
DCARPA	BEARGRASS	5 GAL	5.00	6.00	LOW	38
AME	COMMON NAME	SIZE	MAT. HT.	MAT. DIA.	WATER USE	<u>EST QTY</u>
RACILIS 'BLONDE AMBITION'	`BLONDE AMBITION` BLUE GRAMA	1 GAL	3.00	3.00	LOW	81
TIS X ACUTIFLORA `KARL FOERSTER`	`KARL FOERSTER` FEATHER REED GRASS	5 GAL	3.00	2.00	MED	72
UCA `SISKIYOU BLUE`	IDAHO BLUE FESCUE	1 GAL	1.25	1.25	MED	12
IA EMERSLEYI EL TORO	EL TORO MUHLY GRASS	5 GAL	2.50	2.50	MED	16
AME_	COMMON NAME	SIZE	MAT. HT.	MAT. DIA.	WATER USE	<u>EST QTY</u>
	HOLLYHOCK	1 GAL	7.00	2.00	MED	3
ERULEA	ROCKY MOUNTAIN COLUMBINE	5 GAL	1.50	1.00	LOW	21
EIMERI `WHIRLING BUTTERFLIES`	WHIRLING BUTTERFLIES GAURA	1 GAL	3.00	3.00	MED	28
RA VIOLET`	ULTRA VIOLET SAGE	1 GAL	2.00	2.00	LOW	3
AME_	COMMON NAME	SIZE	MAT. HT.	MAT. DIA.	WATER USE	<u>EST QTY</u>
ICANS	TRUMPET VINE	5 GAL	VINE	VINE	LOW	5

- ROOTBALL ON UNDISTURBED SOIL

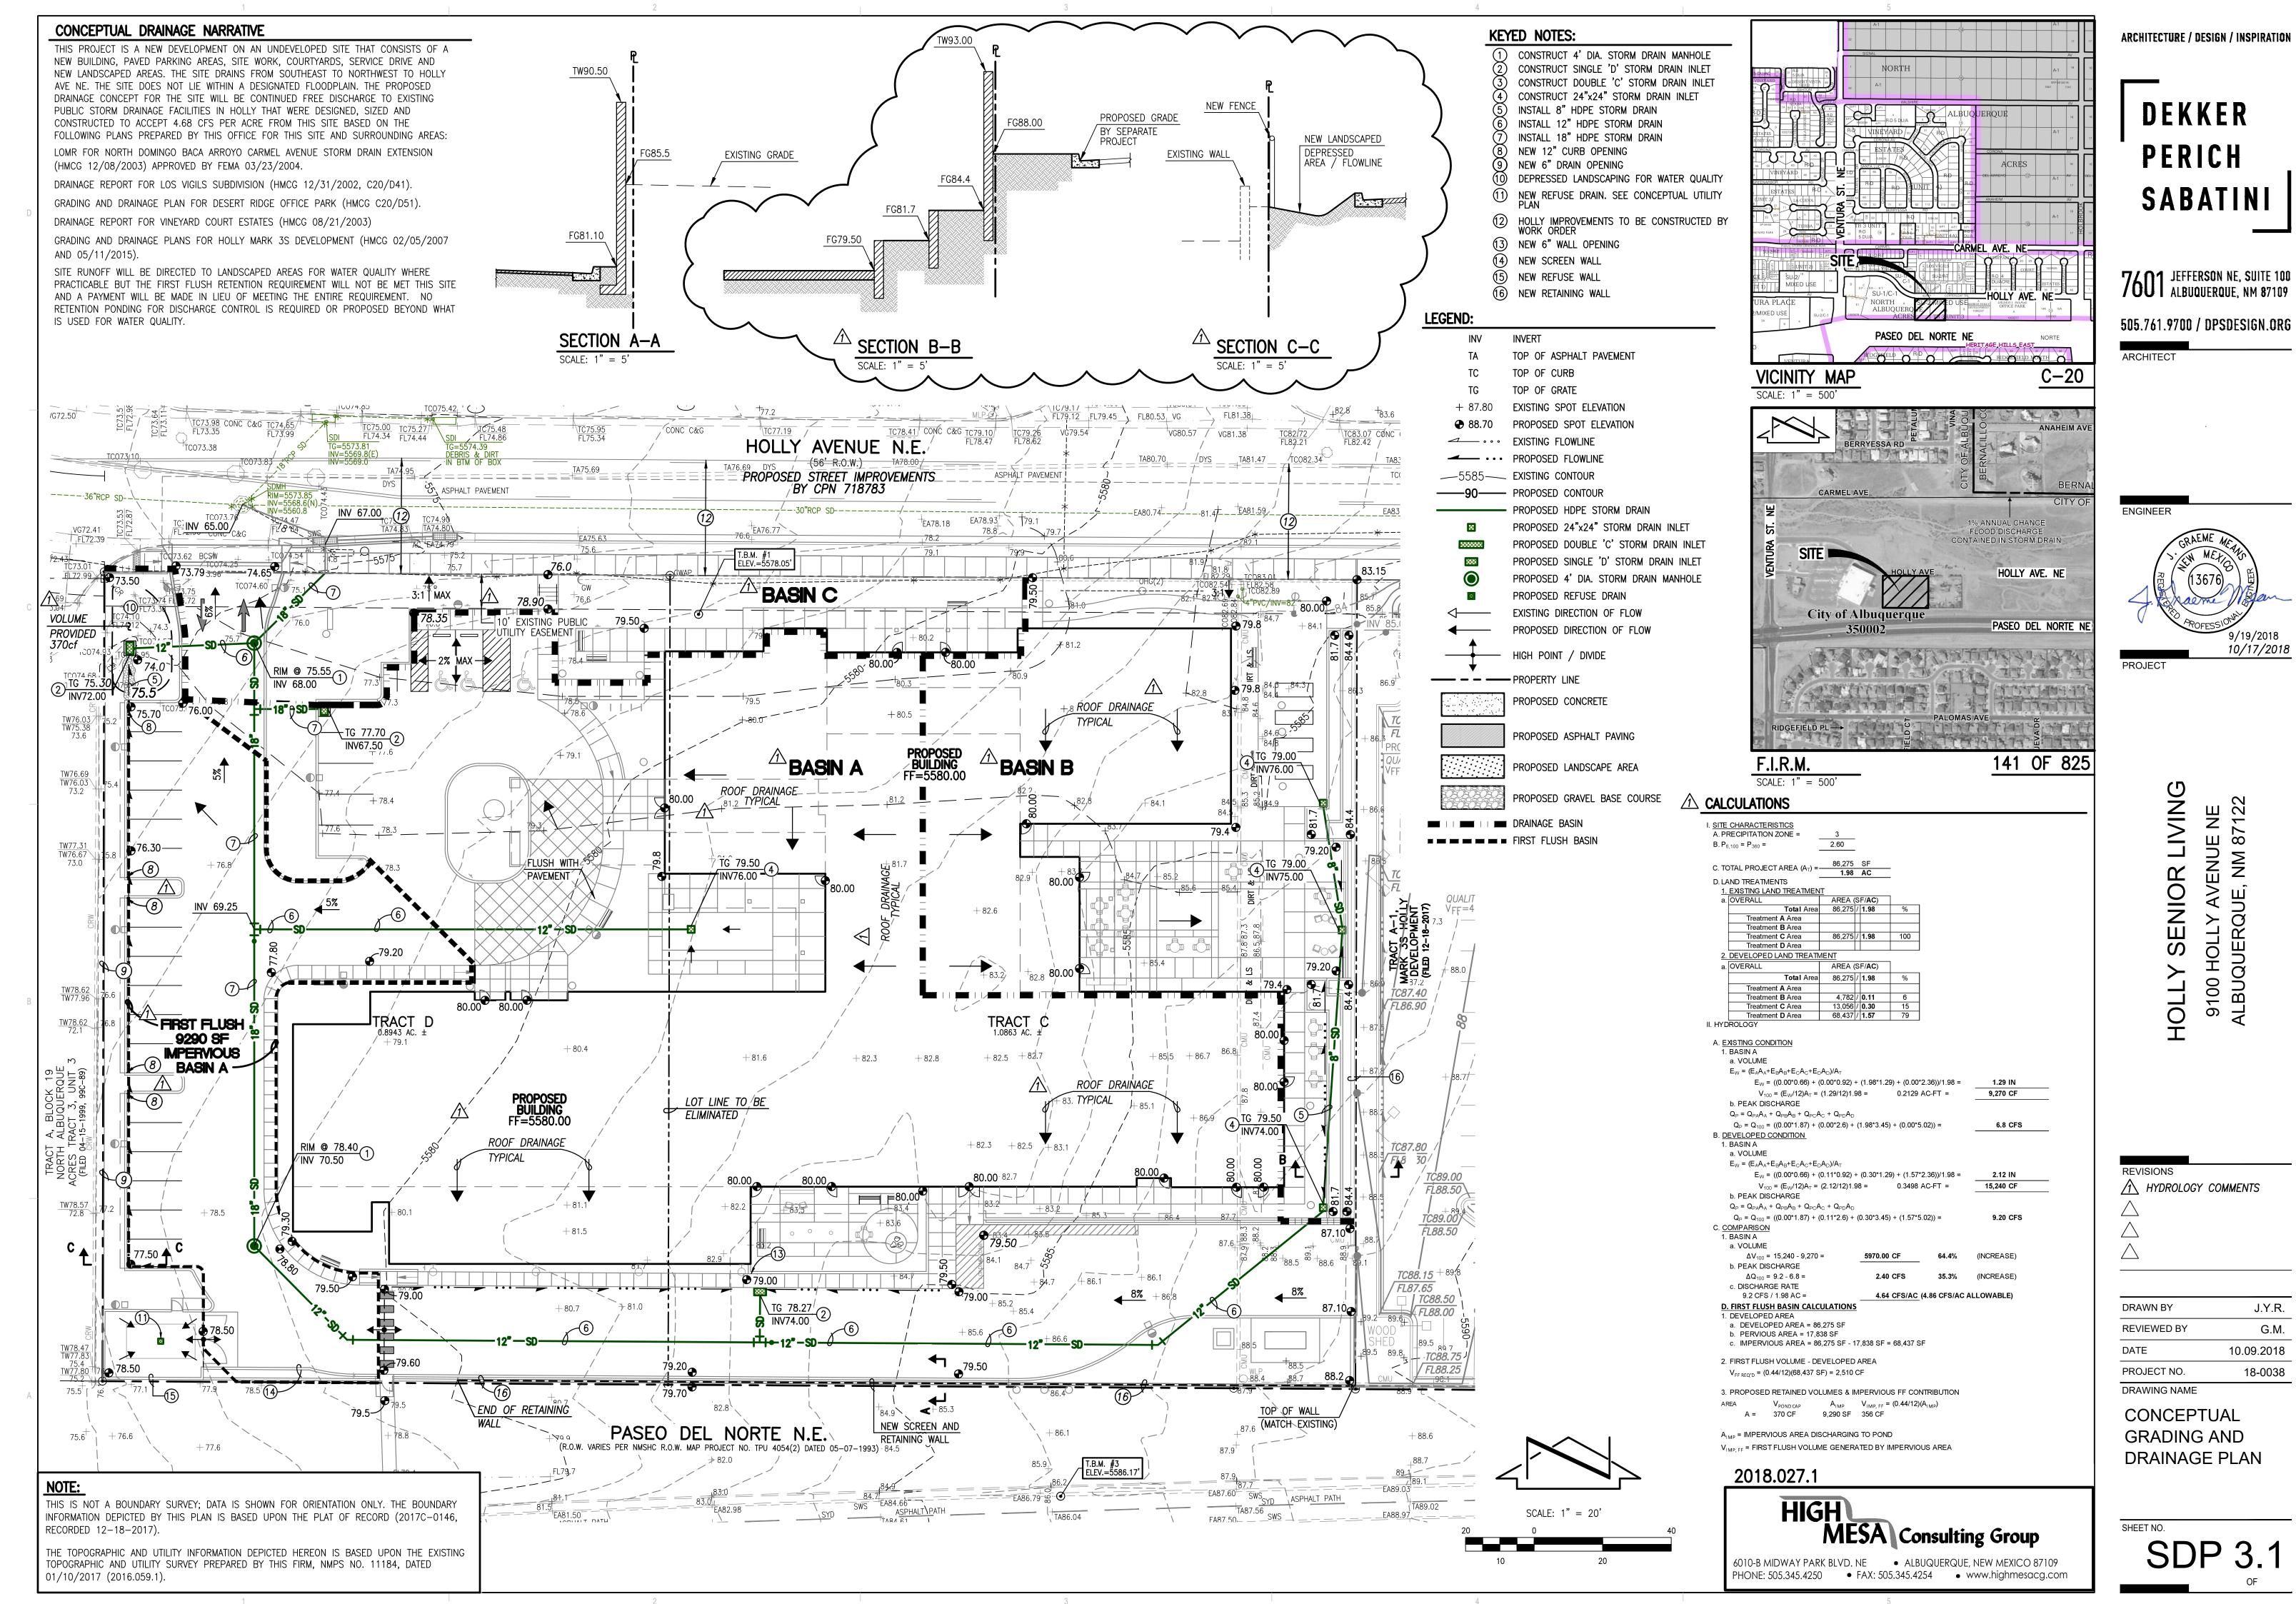

2018 NG/

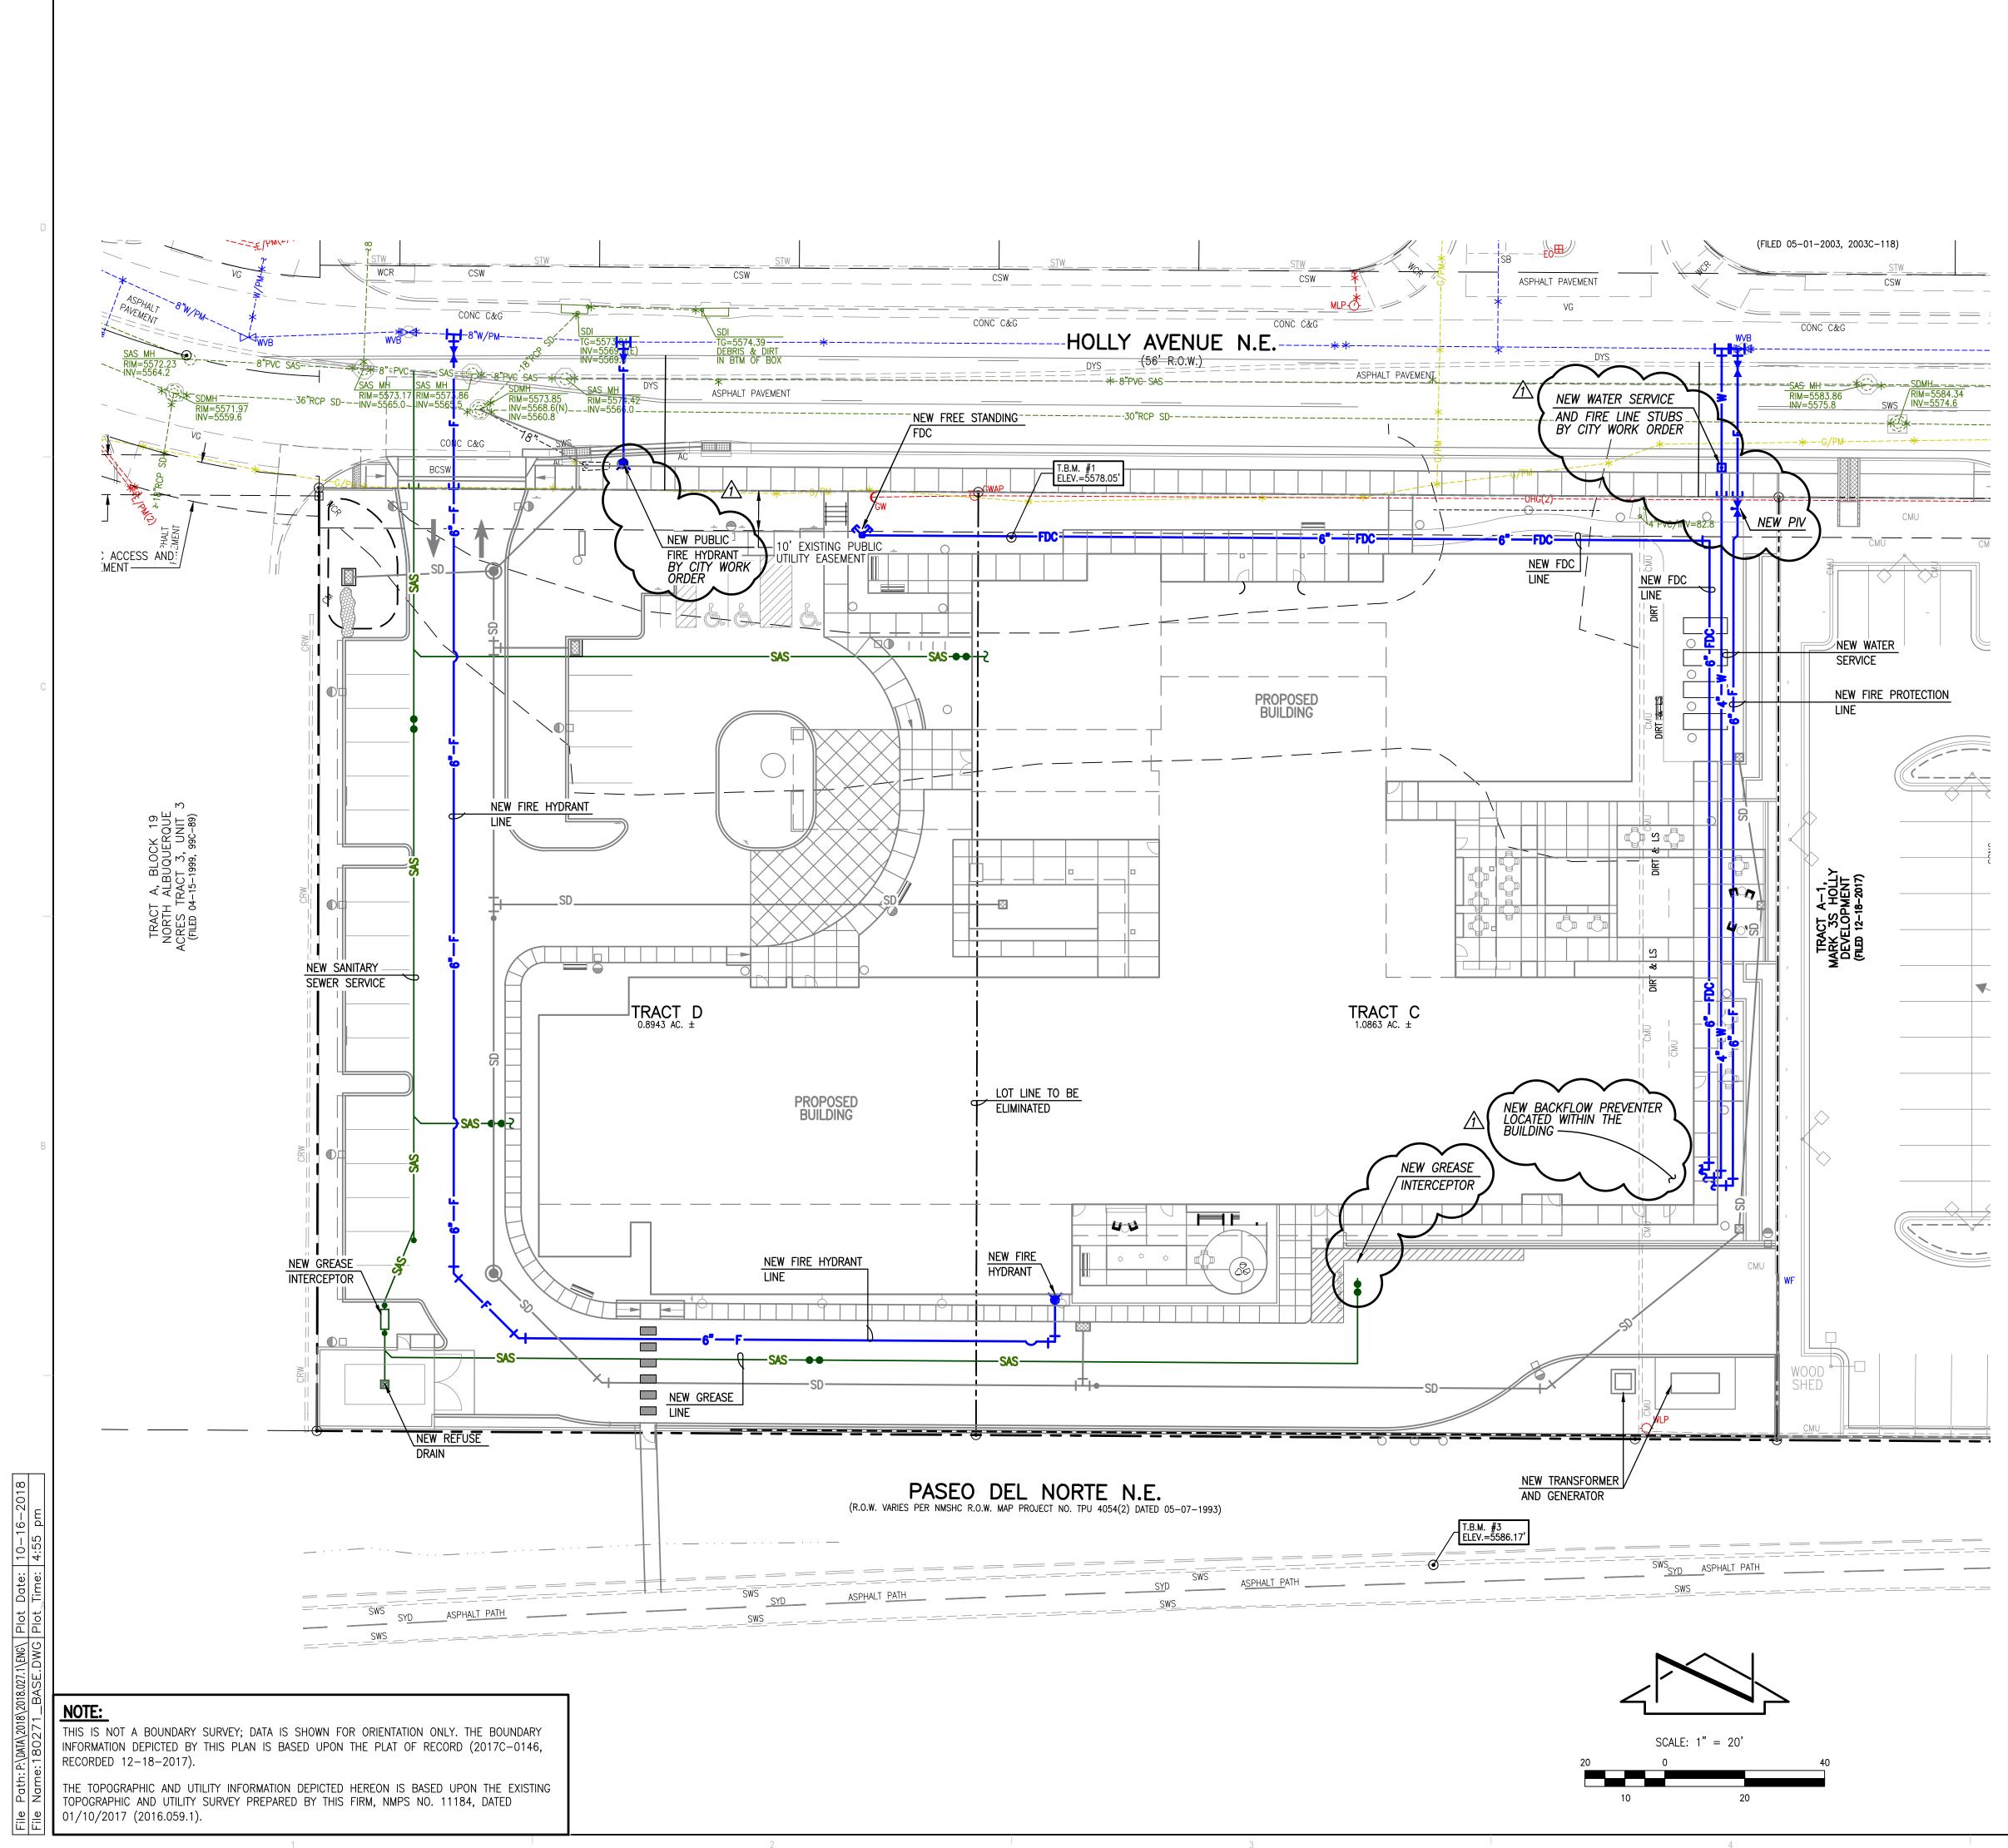

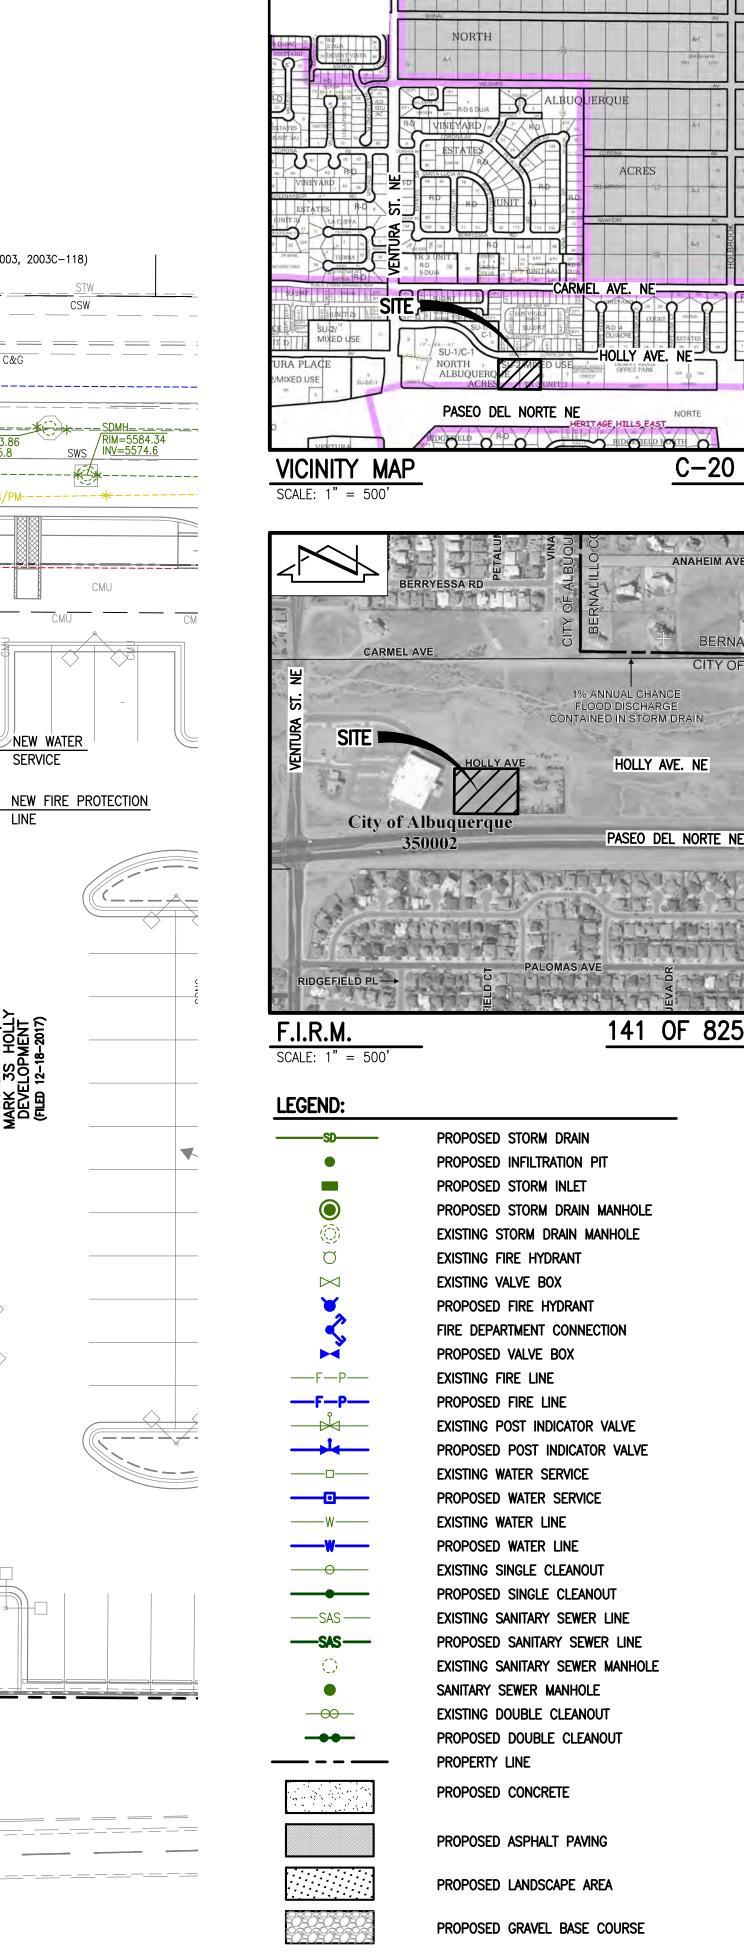

2018.027.1

HIGH


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SHEET NO. **SDP 4.1**

ARCHITECTURE / DESIGN / INSPIRATION

DEKKER PERICH SABATINI

7601 JEFFERSON NE, SUITE 100 ALBUQUERQUE, NM 87109

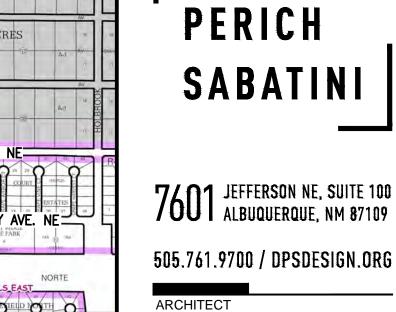

C-20

BERN



PROJECT


Z \sim _____ SENIOR 9100 HOLLY AVE ALBUQUERQUE, ΗΟΓΓΥ

REVISIONS A REVISED BFP LOCATION \triangle \triangle \triangle

DRAWN BY J.Y.R. **REVIEWED BY** G.M. DATE 10.09.2018 PROJECT NO. 18-0038 DRAWING NAME

CONCEPTUAL UTILITY PLAN

MESA Consulting Group 6010-B MIDWAY PARK BLVD. NE• ALBUQUERQUE, NEW MEXICO 87109PHONE: 505.345.4250• FAX: 505.345.4254• www.highmesacg.com

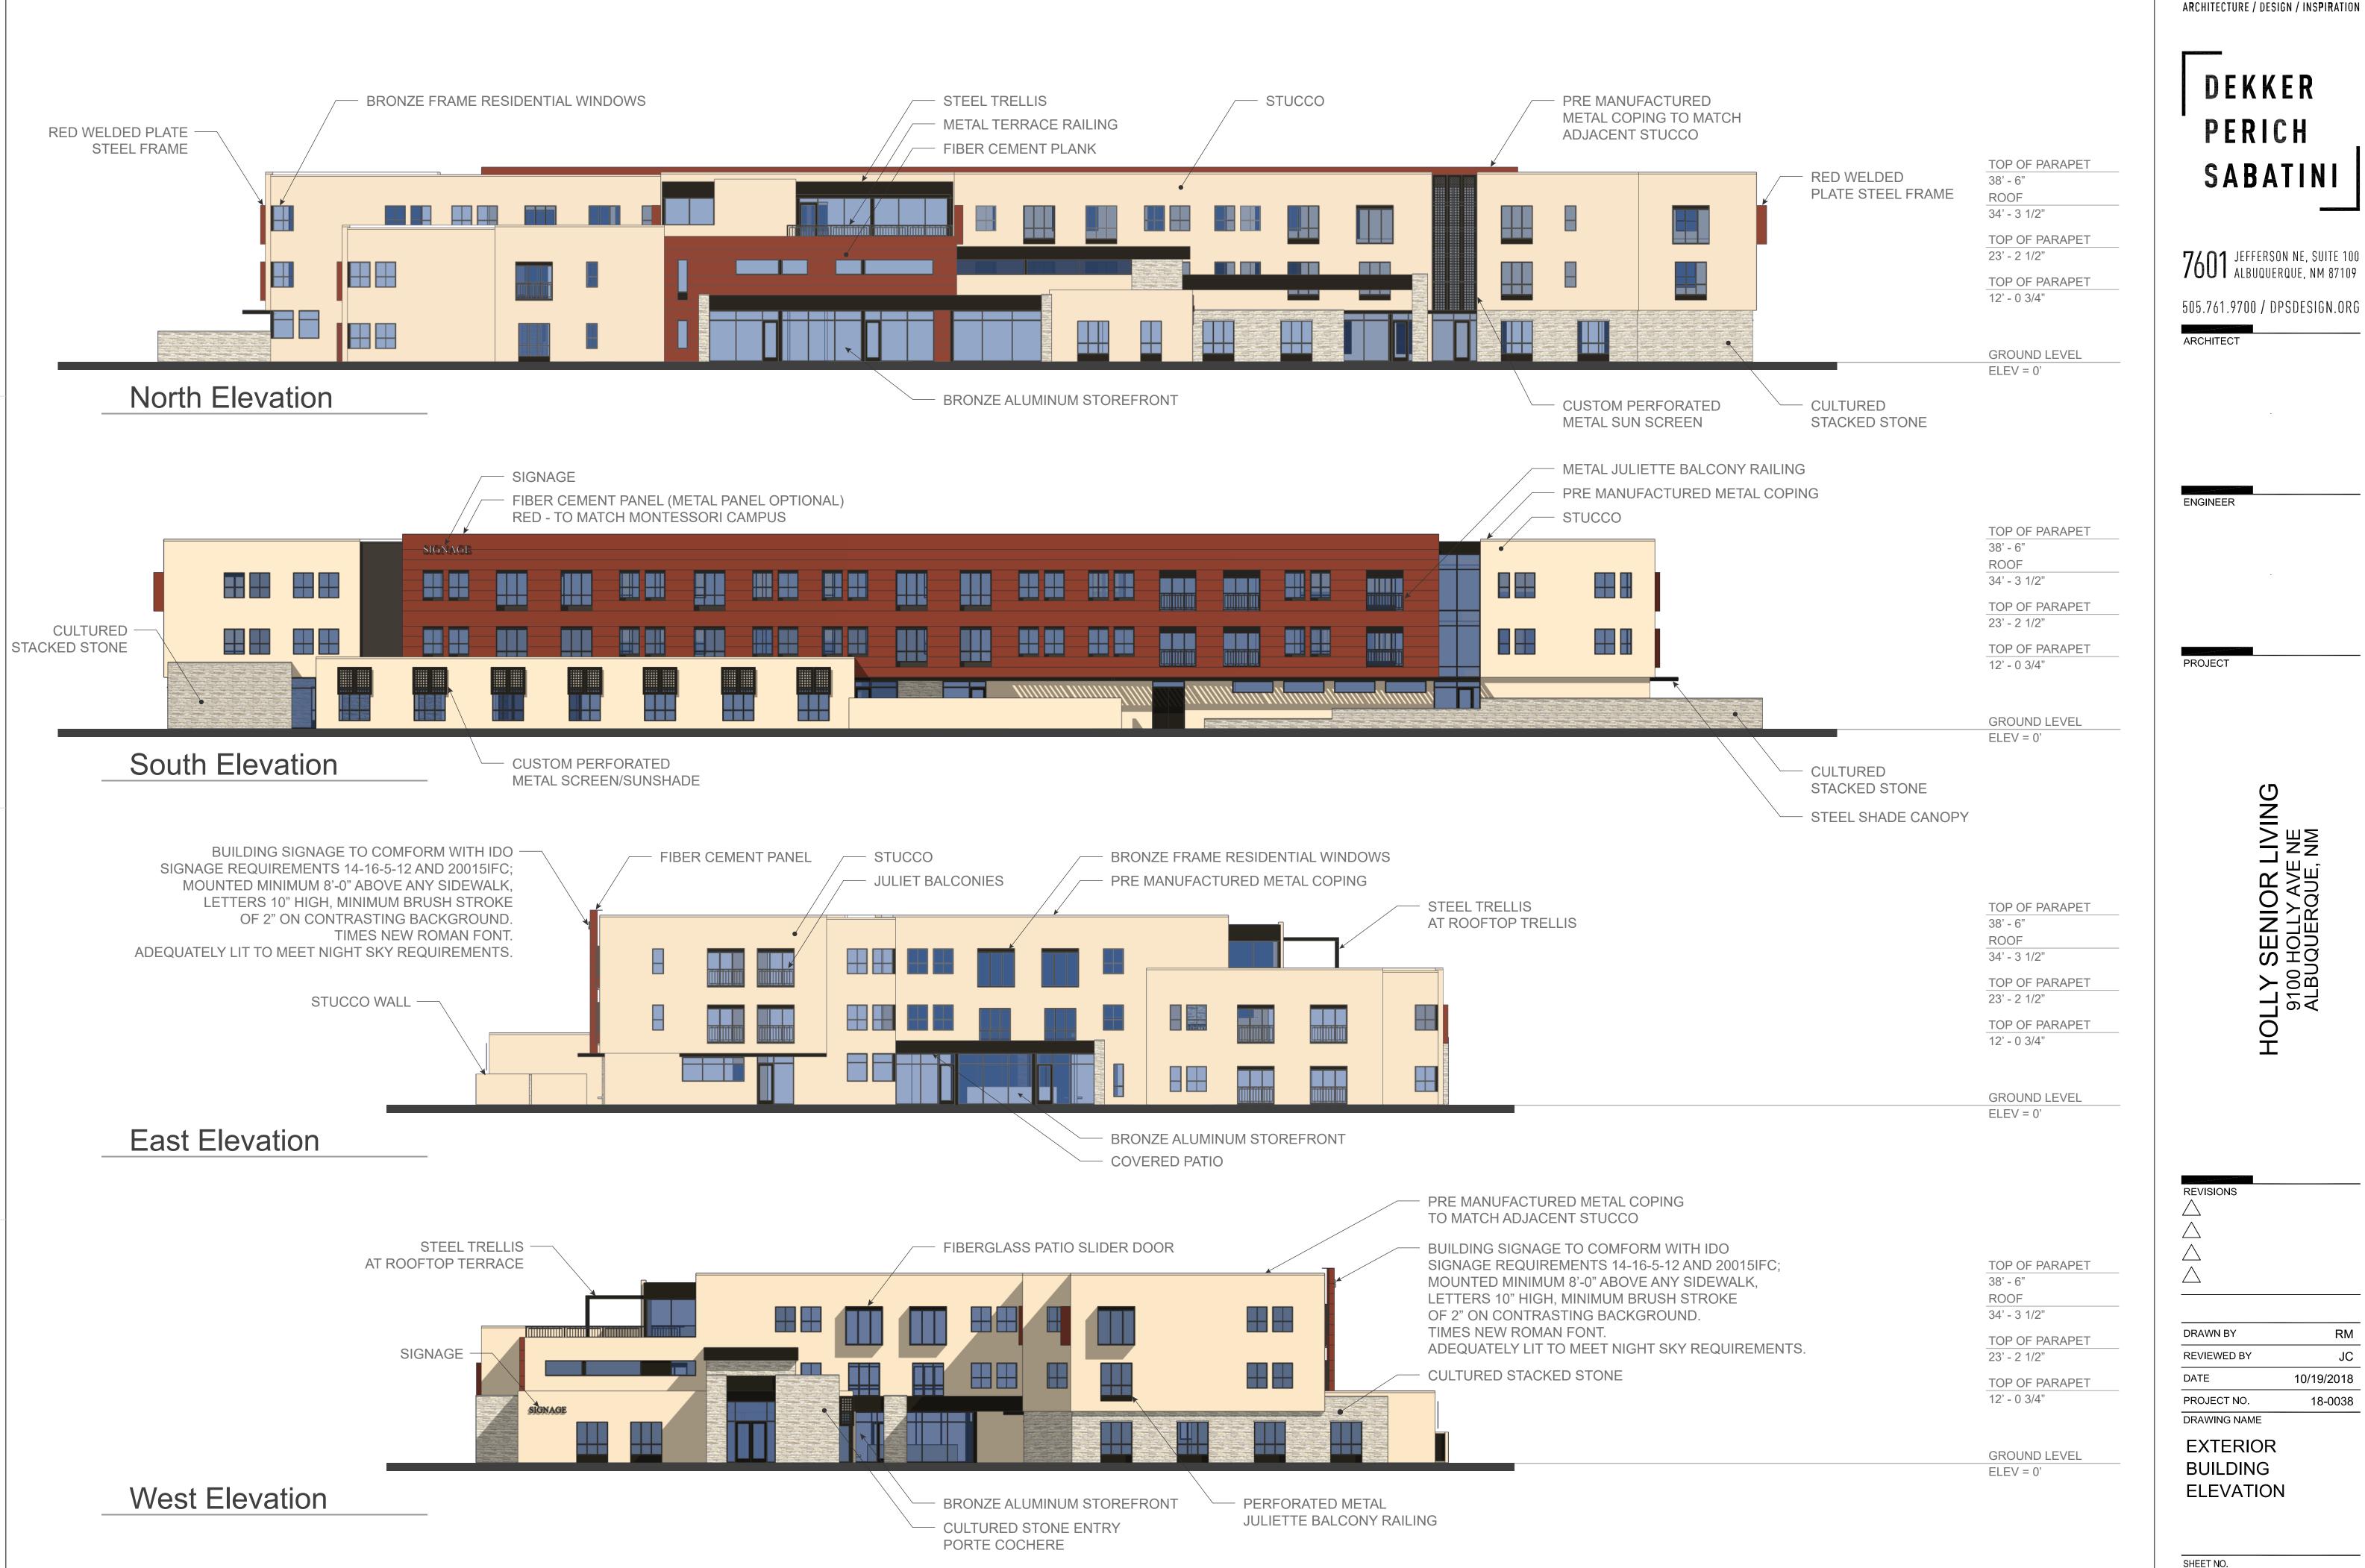

Scale: 1" = 12' - 0"

SDP5.1

