



DEVELOPMENT REVIEW APPLICATION

Effective 5/17/18

Please check the appropriate box and refer to supplemental forms for submittal requirements. All fees must be paid at the time of application.				
Administrative Decisions	☐ Historic Certificate of Appropriateness – Major (Form L)		☐ Wireless Telecommunications Facility Waiver (Form W2)	
☐ Archaeological Certificate (Form P3)	☐ Historic Design Standard	ds and Guidelines (Form L)	Policy Decisions	
☐ Historic Certificate of Appropriateness – Minor (Form L)	☐ Master Development Plan (Form P1)		☐ Adoption or Amendment of Comprehensive Plan or Facility Plan (Form Z)	
☐ Alternative Signage Plan (Form P3)	☐ Site Plan – EPC includin (Form P1)	g any Variances – EPC	☐ Adoption or Amendment of Historic Designation (Form L)	
☐ WTF Approval (Form W1)	☐ Site Plan – DRB (Form F	P2)	☐ Amendment of IDO Text (Form Z)	
☐ Minor Amendment to Site Plan (Form P3)	Subdivision of Land – Mi	nor (Form S2)	☐ Annexation of Land (Form Z)	
Decisions Requiring a Public Meeting or Hearing	☐ Subdivision of Land – Ma	ajor (Form S1)	☐ Amendment to Zoning Map – EPC (Form Z)	
☐ Conditional Use Approval (Form ZHE)	☐ Vacation of Easement or	Right-of-way (Form V)	☐ Amendment to Zoning Map – Council (Form Z)	
☐ Demolition Outside of HPO (Form L)	☐ Variance – DRB (Form \	/)	Appeals	
☐ Expansion of Nonconforming Use or Structure (Form ZHE)	☐ Variance – ZHE (Form Z	ZHE)	☐ Decision by EPC, LC, DRB, ZHE, or City Staff (Form A)	
APPLICATION INFORMATION				
Applicant: Clearbrook Investments.	Inc.		Phone:	
Address: 8801 Jefferson St. N.E.,			Email: scotth@stillbrooke.com	
City: Albuquerque		State: NM	^{Zip:} 87113	
Professional/Agent (if any): Ron Hensley /	THE Group		Phone:505-410-1622	
Address: 300 Branding I			Email: ron@thegroup.cc	
City: Rio Rancho, N	M	State: NM	^{Zip:} 87124	
Proprietary Interest in Site:		List <u>all</u> owners:		
BRIEF DESCRIPTION OF REQUEST				
1. Tract split to complete 2	Zone Change.			
Plat of residential tract a	after zone change.			
SITE INFORMATION (Accuracy of the existing le	egal description is crucial!	Attach a separate sheet if	necessary.)	
Lot or Tract No.: Tract 4		Block:	Unit:	
Subdivision/Addition IHS Acquisition No 1		MRGCD Map No.:	UPC Code: 101706403945020230	
Zone Atlas Page(s): C-17-Z	Existing Zoning:NR-L	.M	Proposed Zoning: MX-M / R-ML	
# of Existing Lots: 1	# of Proposed Lots:	31	Total Area of Site (acres): 5.91	
LOCATION OF PROPERTY BY STREETS				
Site Address/Street: Horizon Blvd. N.E.	Between: Alan	neda Blvd.	and: Balloon Museum Drive	
CASE HISTORY (List any current or prior project	ct and case number(s) that	may be relevant to your re	quest.)	
RZ-2018-00055 9 / <i>C</i> /// /				
Signature: KM (/ WILL)			Date: 3/11/19	
Printed Name: Ron E. Hensley / THE Group			☐ Applicant or ■ Agent	
FOR OFFICIAL USE ONLY				
Case Numbers		Action	Fees	
-				
-				
-				
Meeting/Hearing Date:			Fee Total:	
Staff Signature:		Date:	Project #	

FORM S2: SUBDIVISION OF LAND - MINOR ACTIONS


Please refer to the DRB minor case schedule for meeting dates and deadlines. Bring original Mylar of plat with property owner's and City Surveyor's signatures on it to the meeting. Your attendance is required.

A single PDF file of the complete application including all plans and documents being submitted must be emailed to PLNDRS@cabq.gov
prior to making a submittal. Zipped files or those over 9 MB cannot be delivered via email, in which case the PDF must be provided on a CD.

A Variance – DRB for the Bulk Transfer of Land requires application on Form V in addition to this FORM S2.

⊻	INFORMATION REQUIRED FOR ALL MINOR SUBDIVISION APPLICATIONS Interpreter Needed for Hearing? if yes, indicate language: Zone Atlas map with the entire site clearly outlined and labeled
Y	SKETCH PLAT REVIEW AND COMMENT Scale drawing of the proposed subdivision plat (7 copies, folded) Site sketch with measurements showing structures, parking, building setbacks, adjacent rights-of-way and street improvements, if there is any existing land use (7 copies, folded) Letter describing, explaining, and justifying the request
	MAJOR SUBDIVISION FINAL PLAT APPROVAL Proposed Final Plat (7 copies, 24" x 36" folded) Design elevations & cross sections of perimeter walls (3 copies) Copy of recorded IIA DXF file and hard copy of final plat data for AGIS submitted and approved Landfill disclosure and EHD signature line on the Mylar if property is within a landfill buffer
	MINOR SUBDIVISION PRELIMINARY/FINAL PLAT APPROVAL Sites 5 acres or greater: Archaeological Certificate in accordance with IDO Section 14-16-6-5(A) Proposed Preliminary / Final Plat with property owner's and City Surveyor's signatures on the plat prior to submittal. (7 copies, folded) Cross sections of proposed streets (3 copies, 11" by 17" maximum) Site sketch with measurements showing structures, parking, building setbacks, adjacent rights-of-way and street improvements (to include sidewalk, curb & gutter with distance to property line noted) if there is any existing land use (7 copies, folded) Letter describing, explaining, and justifying the request per the criteria in IDO Section 14-16-6-6(I) Form DRWS Drainage Report, Grading and Drainage Plan, and Water & Sewer Availability Statement submittal information Proposed Infrastructure List, if applicable Landfill disclosure and EHD signature line on the Mylar if property is within a landfill buffer DXF file and hard copy of final plat data for AGIS submitted and approved
	MINOR AMENDMENT TO PRELIMINARY PLAT Proposed Amended Preliminary Plat, Infrastructure List, and/or Grading Plan (7 copies, folded) Original Preliminary Plat, Infrastructure List, and/or Grading Plan (7 copies, folded) Infrastructure List, if applicable Letter describing, explaining, and justifying the request per the criteria in IDO Section 14-16-6-4(X)(2)
	Note: Any application that does not qualify as a Minor Amendment in IDO Section 14-16-6-4(X) must be processed as a Major Amendment. See Form S1.

I, the applicant or agent, acknowledge that if any required information is not submitted with this application, the application will not be scheduled for a public meeting or hearing, if required, or otherwise processed until it is complete.				
Signature: Son Conslay		Date: 3/11/19_		
Printed Name: Ron E. Hensley / THE Group		☐ Applicant or ▼ Agent		
FOR OFFICIAL USE ONLY				
Project Number:	Case Numbers	11 8 11		
	-			
	-			
	-	[17/16]		
Staff Signature:	MEXICA			
Date:		AAAAAA		

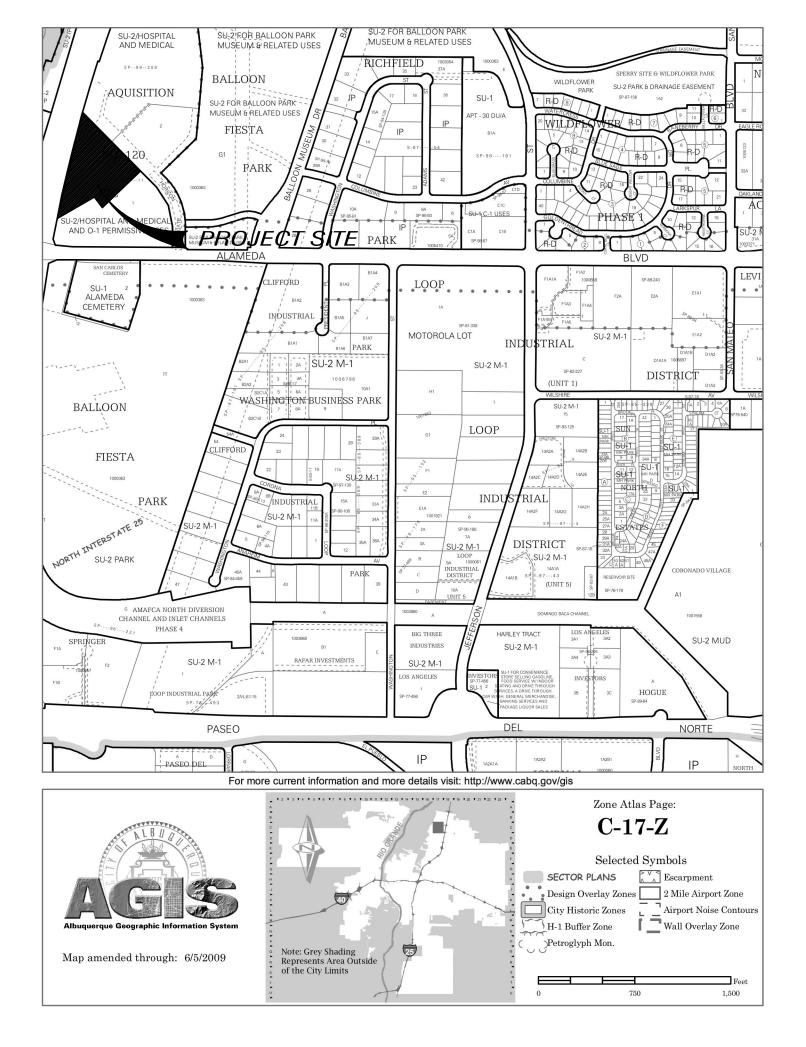



March 11, 2019

DRB Chair City of Albuquerque PO Box 1293 Albuquerque, NM 87103

Re: Horizon Village Subdivision - Sketch Plat

Attached Sketch Plat submittal for a subdivision located within zone atlas page C-17.

The subdivision is a replat of "Tract 4 Land of HIS Acquisition No 120" and is located on Horizon Boulevard near Alamead Blvd. The plat would create 30 lots and 2 tracts from the existing Tract.

The site is within the boundaries of North I-25 Sector Development Plan,

Overview and Summary of Request


- Create 2 tracts from the existing to complete Zone Change.
- Plat of 30 lots and HOA Tract from one of the created tracts.
- Front yards of each lot will be landscaped by the developer, and there will be a homeowners association to enforce landscaping and other site regulations through neighborhood covenants..

As agent for the owners, we are requesting comment on the City requirements to approve the proposed subdivision. Please contact me at 410-1622 or via email if you have any questions or comments.

Sincerely,

Ron E. Hensley P.E

ron@thegroup.cc

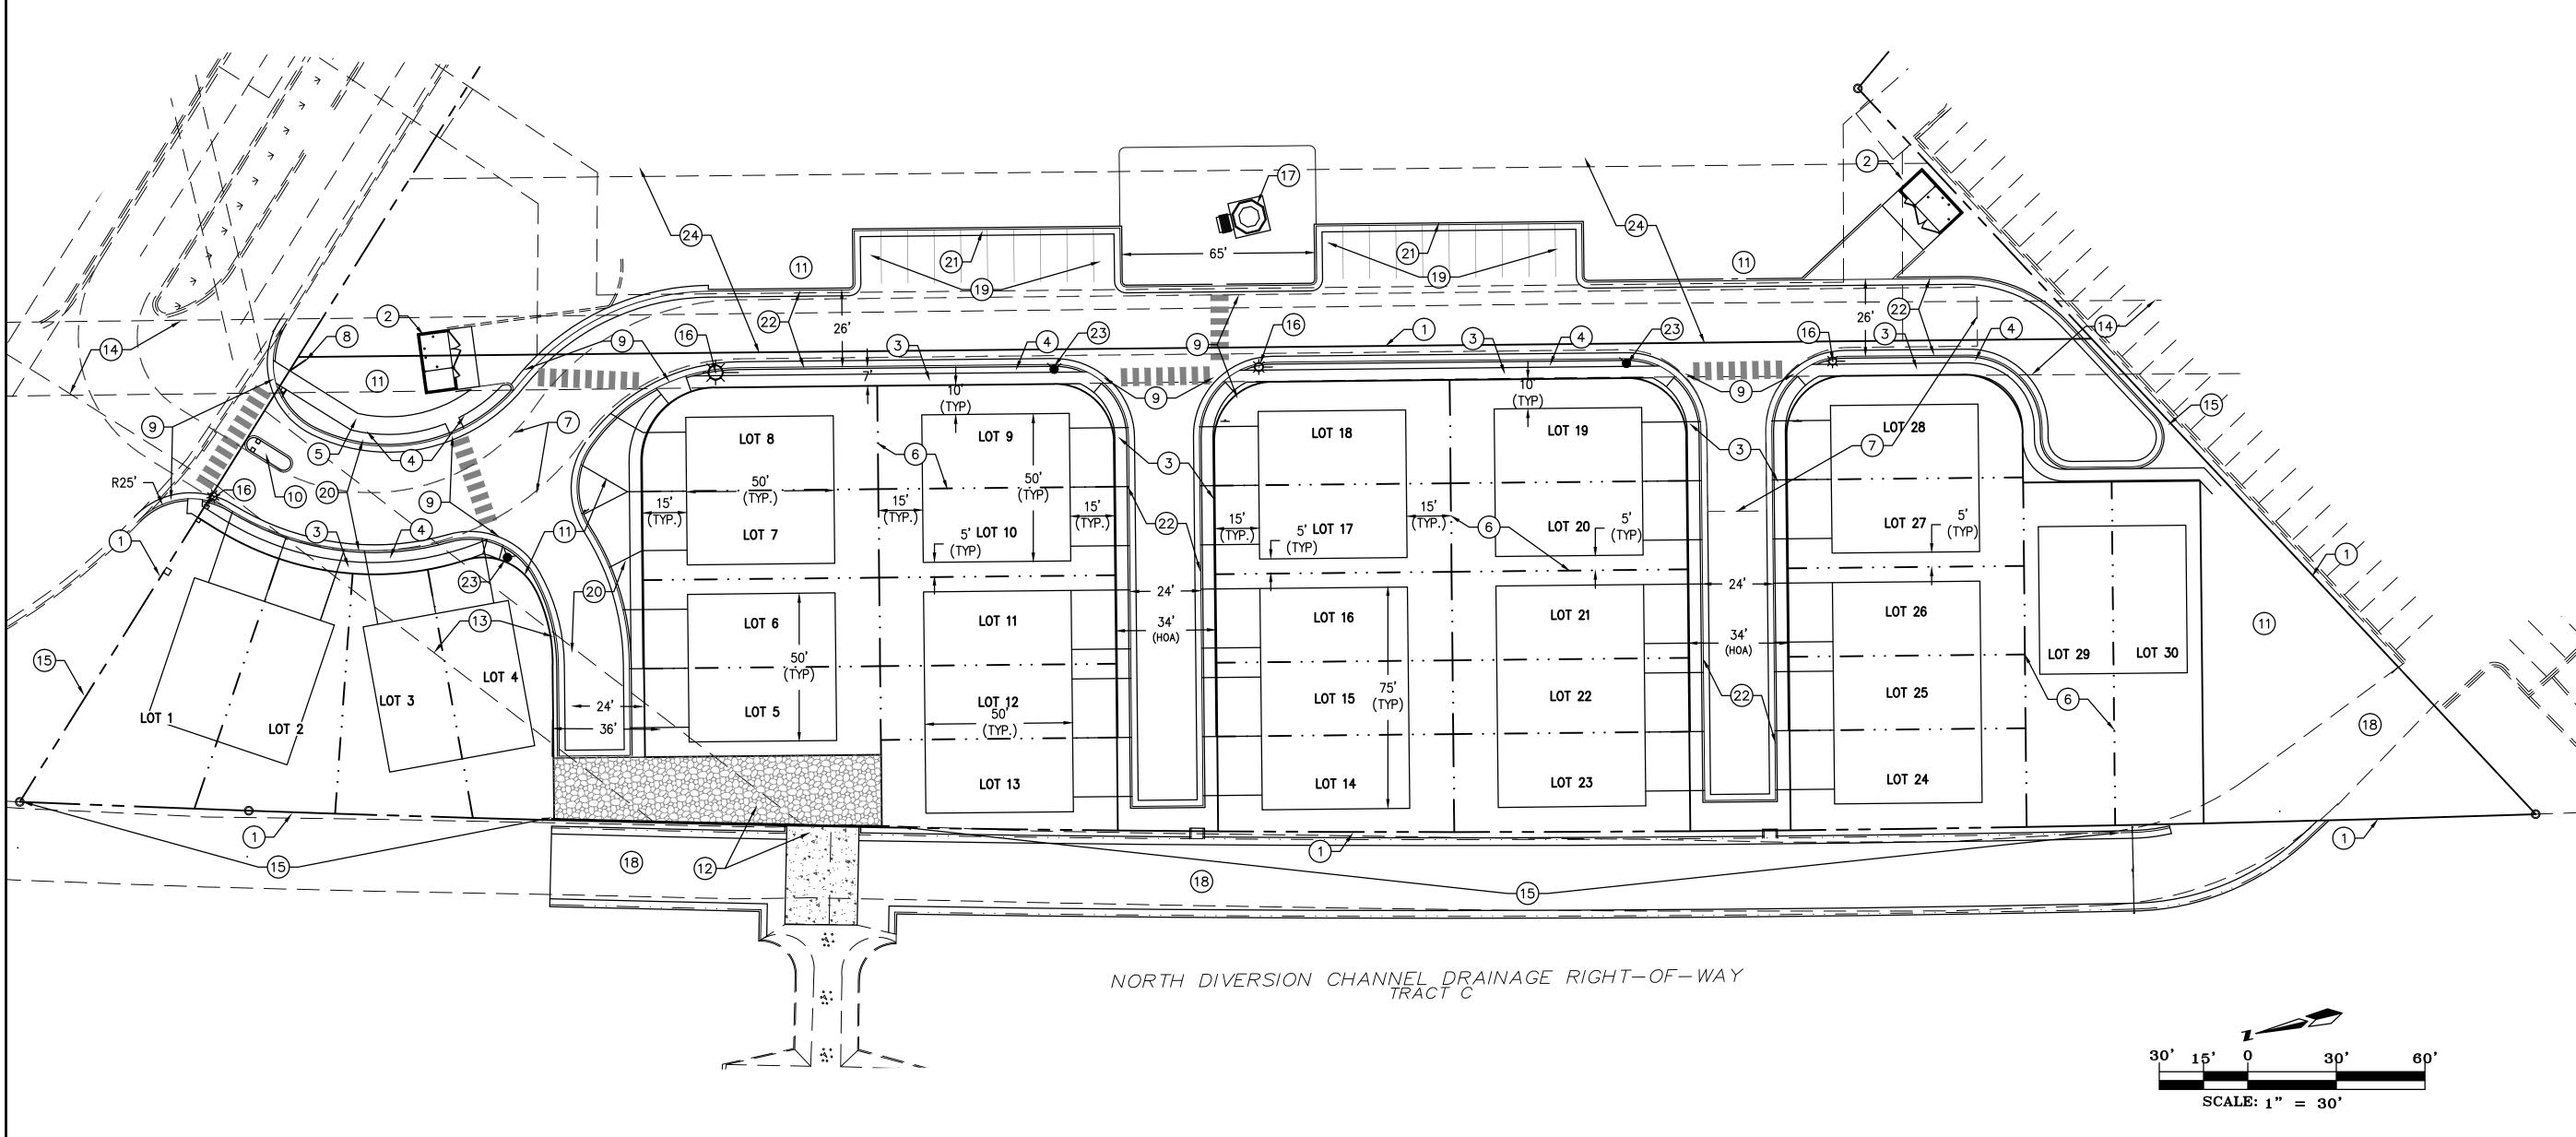

PROJECT SUMMARY AND SITE DESIGN

INTRODUCTION
THE PROPOSED DEVELOPMENT SHALL COMPLY WITH THE REQUIREMENTS OF THE MX-L ZONE AND THE GENERAL REGULATIONS OF THE INTEGRATED DEVELOPMENT ORDINANCE.

SITE DESIGN OVERALL LAYOUT OF SITE

THE SITE WILL CREATE THRITY (30) TOWNHOUSE LOTS. THE RESIDENTIAL BUILDINGS SHALL BE ARRAYED ALONG PRIVATE DRIVES WITH A VEHICULAR ACCESS TO HORIZON BLVD. THE RESIDENTIAL BUILDINGS SHALL BE SITUATED WITH FRONT ENTRANCES FACING THE PRIVATE DRIVE. 4' PEDESTRIAN WALKWAYS TRAVERSE BOTH SIDES OF THE PRIVATE DRIVE TO PROVIDE PEDESTRIAN ACCESS TO THE RESIDENCES. THE PEDESTRIAN WALKWAYS ALSO CONNECT TO THE HORIZON BLVD. PRIVATE DRIVE. THE RESIDENCES SHALL BE TWO STORY WITH GARAGES FACING THE PRIVATE WAY.

BUILDING PLACEMENT, ORIENTATION, SETBACKS

THE RESIDENTIAL GARAGE DOORS SHALL FACE THE SUBDIVISION PRIVATE DRIVE. A CONCRETE DRIVEWAY (20' LENGTH TO CURB) SHALL PROVIDE ACCESS TO THE TWO CAR GARAGES. FRONT YARD SETBACK SHALL FIFTEEN FEET (15'). SIDE YARD SETBACK SHALL BE FIVE FEET (5'). REAR YARD SETBACK SHALL BE FIFTEEN FEET (15'). BUILDING HEIGHTS SHALL RISE TO 28' AT TWO STORY PEAK.

PEDESTRIAN AND VEHICULAR CONNECTIVITY (INTERNAL & EXTERNAL)

THE SITE IS CONNECTED TO THE SURROUNDINGS VIA HORZON BLVD. PUBLIC TRANSIT ACCESS IS TO THE SOUTH IN ALAMEDA BLVD. PEDESTRIAN AND BIKEWAY ACCESS IS LOCATED ALONG ALAMEDA BLVD.. INTERNAL TO THE SITE, 4' SIDEWALKS ALONG THE PRIVATE DRIVES CONNECT EACH RESIDENCE WITH ITS NEIGHBOR, AND THE CENTRALLY LOCATED PARK. ADA RAMPS AT CORNERS PROVIDE HANDICAP ACCESSIBILITY TO THE DEVELOPMENT. THE KEY VEHICULAR ENTRY POINT SHALL BE ACCENTUATED BY LANDSCAPE ELEMENTS AND SIGNAGE. HORZON BLVD. PROVIDES ACCESS TO THE BUS TRANSIT SYSTEM ON ALAMEDA BLVD.

PARKING LOCATION AND DESIGN

OFF STREET RESIDENT PARKING IS PROVIDED AT EACH GARAGE AND ITS ACCOMPANYING DRIVEWAY. FOUR PARKING SPACES ARE ACCOMMODATED IN THIS WAY AT THE TWO CAR GARAGES. ADDITIONAL PARKING IS PROVIDED ADJACENT TO THE CENTRAL PARK IN THE SHARED USE AND ACCESS AREA OF PHASE 2 (TRACT 4B).

PUBLIC OUTDOOR SPACES THE CENTRALLY LOCATED LANDSCAPED PARK FEATURES A GAZEBO AND PICNIC AREA IN THE SHARED USE AREA.

REFUSE & RECYCLE PICKUP

RECYCLE AND REFUSE PICKUP SHALL BE BY TWO DUMPSTER LOCATIONS WITH SCHEDULED PICKUP TIMES. THE LOCATIONS ARE READILY ACCESSIBLE TO ALL RESIDENTS.

LOCATION, HEIGHT, DESIGN AND PURPOSE OF ALL WALLS AND WALL OPENINGS

THE CMU / WROUGHT IRON FENCING PROVIDE PRIVACY AND SECURITY FOR THE RESIDENTS. ALL WALLS AND FENCES ARE SUBJECT TO SECTION 14-16-3-19 OF THE ZONING ORDINANCE. ALL WALLS SHALL BE 6-0" IN HEIGHT ABOVE HIGH GROUND ELEVATION OF INTEGRAL TAN COLOR; THEY SHALL BE EXPOSED BLOCK WITH REPEATING PATTERNS AND VARIEGATED TEXTURES OR COMBINED WITH WROUGHT IRON FEATURES.

LOCATION, HEIGHT, DESIGN AND PURPOSE OF LIGHTING

STREET LIGHTING WILL BE PROVIDED AT APPROPRIATE LOCATIONS FOR SAFETY AND SECURITY. LIGHTING SHALL COMPLY WITH ALL REQUIREMENTS IN SECTION 14-16-3-9 OF THE ZONING ORDINANCE. RESIDENCE-MOUNTED LIGHTING ELEMENTS SHALL BE INCANDESCENT, METAL HALIDE OR HALOGEN ONLY. RESIDENCE MOUNTED FLOODLIGHTS (MAXIMUM 75 WATT BULBS) SHALL BE SHIELDED OR AIMED IN SUCH A WAY THAT THEY DO NOT SHINE INTO OTHER LOTS OR THE STREET.

SCREENING / BUFFERING TECHNIQUES

MULTIPLE STREET SHADE TREES SCREEN RESIDENCES FROM ADJACENT ROADWAY WHILE CREATING PEDESTRIAN AMENITIES WITHIN THE URBAN FABRIC OF THE DEVELOPMENT. AT MATURITY, THESE TREES SHALL CREATE A COOLING MICRO

STREET REALM TRANSIT. BICYCLE, PEDESTRIAN AMENITIES

THE SITE IS ACCESSIBLE TO TRANSIT ROUTES ON ALAMEDA BLVD., WHICH IS A PRINCIPAL ARTERIAL. CITY OF ALBUQUERQUE "ABQ RIDE" BUS STOP IS LOCATED NEAR THE DEVELOPMENT. THE SITE IS IN THE VICINITY OF SEVERAL CITY PARKS ANDS TRAIL FACILITIES.

LANDSCAPING IS A KEY ELEMENT OF THE DESIGN. IT IS INTEGRAL TO THE GOAL OF PROVIDING PLACES THAT PROMOTE COMMUNITY AND ENRICH THE LIVES OF THE AREA RESIDENTS. A CENTRAL COMMUNITY PARK IS A PROMINENT ELEMENT TO ACHIEVE THIS GOAL.

THE LANDSCAPE NETWORK CONSISTS OF:

STREET SHADE TREES ALONG PRIMARY DRAVE SHALL BE SITUATED IN LANDSCAPE STRIPS W/ ROCK OR BARK GROUNDCOVER. STREET TREE SPACING SHALL BE DETERMINED BY TREE CANOPY AT FULL MATURITY.

INTERIOR STREET SCAPE STREET SHADE TREES, AND LANDSCAPING IN AND AROUND UNIT DRIVEWAYS SHALL BE PROVIDED AND MAINTAINED BY AN OWNERS ASSOCIATION. AT MINIMUM, ONE 8'-0" TO 12M)" TALL SHADE TREE AT THE STREET FRONTAGE OF EACH STRUCTURE. IN ADDITION > 5 GALLON SHRUBS SHALL BE LOCATED IN A ROCK/COBBLE ACCENT LANDSCAPING SCHEME.

DECIDUOUS STREET SHADE TREES PROVIDE PASSIVE SOLAR MITIGATION OF PAVED SURFACES. THE LANDSCAPING SHALL BALANCE

THE DENSITY OF THE HOUSING UNITS AND CREATE HUMAN SCALE. THE TREE SPECIES SHALL BE VARIED TO AVOID MONOCULTURE. SUGGESTED PLANT SPECIES AS SHOWN ARE NOT MANDATORY, HOWEVER ANY SUBSTITUTIONS WILL BE LIMITED TO MEDIUM OR LOW WATER USE SPECIES. PLANT SPECIES SHOULD REFLECT THE CHARACTER AND SCALE OF THE SURROUNDING NEIGHBORHOOD.

BUILDING DESIGN CONTEXT

THE PROPOSED DEVELOPMENT IS SITUATE WITHIN A MIXED USE AREA. THE DEVELOPMENT FURTHERS THE GOAL OF THE MIXED USE BY PROVIDING PROXIMIMITY IN THE LIVE / WORK ENVIRONMENT.

ARCHITECTURAL THEME OR STYLE

FOR THE PROPOSED TOWNHOUSE DEVELOPMENT, TWO BUILDING CONFIGURATIONS WILL BE USED. THE SOUTHWEST CRAFTSMEN ARCHITECTURAL STYLE WILL HAVE A FLAT ROOF/FRAME WITH A BRICK AND STUCCO FACADE. PARAPETS FOR FLAT ROOF DESIGNS SHALL NOT EXCEED 15% OF THE HEIGHT OF THE SUPPORTING WALL AND SHALL SHIELD THE VIEW OF THE ROOF MATERIAL FROM ANY PUBLIC OR PRIVATE RIGHT-OF-WAY.

BUILDING HEIGHT, SCALE, MASSING, MATERIALS, COLORS AND ARTICULATION

THE DEVELOPMENT IS ORGANIZED TO EMPHASIZE A RESIDENTIAL NEIGHBORHOOD RESPONSE TO THE SITE. THE BUILDINGS ARE PLACED WITH THEIR FRONT FACADES FACING THE PRIVATE WAY. THE BUILDING DESIGNS SHALL INCORPORATE PRUDENT USE OF BOTH VERTICAL AND HORIZONTAL ARTICULATION AS APPROPRIATE TO RESIDENTIAL DESIGN. AN EARTH TONED PALETTE SHALL BE IN EVIDENCE AT ALL OF THE EXTERIOR BUILDING WALLS AND SURROUNDING PROPERTY LINE WALLS.

SHEET LIST

SHEET NUMBER	SHEET NAME	
SP1	SITE DEVELOPMENT PLAN	
SP2	PLAT	
SP3	GRADING AND DRAINAGE PLAN	
SP4	UTILITY PLAN	

VICINITY MAP C-17-Z ACQUISITION PROJECT SITE PARK ASHINGTON BUSINESS PAI BALLOON

LEGEND

FIESTA

NEW CURB AND GUTTER & SIDEWALK ===== EX CURB AND GUTTER & SIDEWALK

> FIRE ACCESS LANE 20' WIDTH STANDARD. MIN. INSIDE CURVE RADIUS=28', MIN. OUTSIDI CURVE RADIUS=48' TURN AROUND DEPTH=60

O KEYED NOTES

- 1. PHASE 1 PROPERTY LINE
- 2. TRASH ENCLOSURE WITH 6' TALL INTEGRAL COLOR TAN CMU
- YARD WALL WITH GATE PER 1/SP 1.2 3. 4' SIDEWALK
- 4. LANDSCAPE BUFFER
- 5. 6' SIDEWALK
- 6. PROPERTY LINE (TYP.) 7. FIRE ACCESS LANE
- 8. MONUMENT SIGN PER 2/SP 1.2
- 9. ACCESSIBLE PEDESTRIAN CROSSWALK PER 3/SP 1.2
- 10. ENTRANCE WITH 6' LANDSCAPED MEDIAN PER 6/SP 1.2
- 11. LANDSCAPED AREA PER LANDSCAPE PLAN
- 12. WATER QUALITY FEATURE AND DRAINAGE DISCHARGE PER GRADING PLAN SP 3.1
- 13. EXISTING 30' DRAINAGE EASEMENT (TO BE VACATED)
- 14. EXISTING 25' SANITARY SEWER EASEMENT
- 15. INTEGRAL COLOR TAN CMU / IRON PERMITER FENCING PER
- 5/SP 1.2 16. POLE MOUNTED LIGHT FIXTURE FORWARD THROW PER 4/SP 1.2
- 17. GAZEBO AND PICNIC TABLE
- 18. IMPROVED BALLOON FIESTA / AMAFCA ACCESS ROAD
- 19. 9' X 20' TYPICAL PARKING SPACE / SHARED PARKING AREA
- 20. STANDARD 8' CURB AND GUTTER
- 21. 6" CURB
- 22. STANDARD MOUNTABLE CURB
- 23. FIRE HYDRANT
- 24. 55' JOINT USE AND ACCESS EASEMENT

No.	Revision/Issue	Date
	LIODIZON VIII	·


HORIZON VILLAGE PHASE I — ALDEA HORIZON SITE PLAN


Albuquerque, New Mexico





THE HENSLEY ENGINEERING GROUP 300 BRANDING IRON RD. SE RIO RANCHO, NEW MEXICO 87124 Phone:(505) 410-1622

Sheet Title	Sheet Number
SITE DEVELOPMENT PLAN	
MARCH 1, 2019	ISP1.
Project No.	

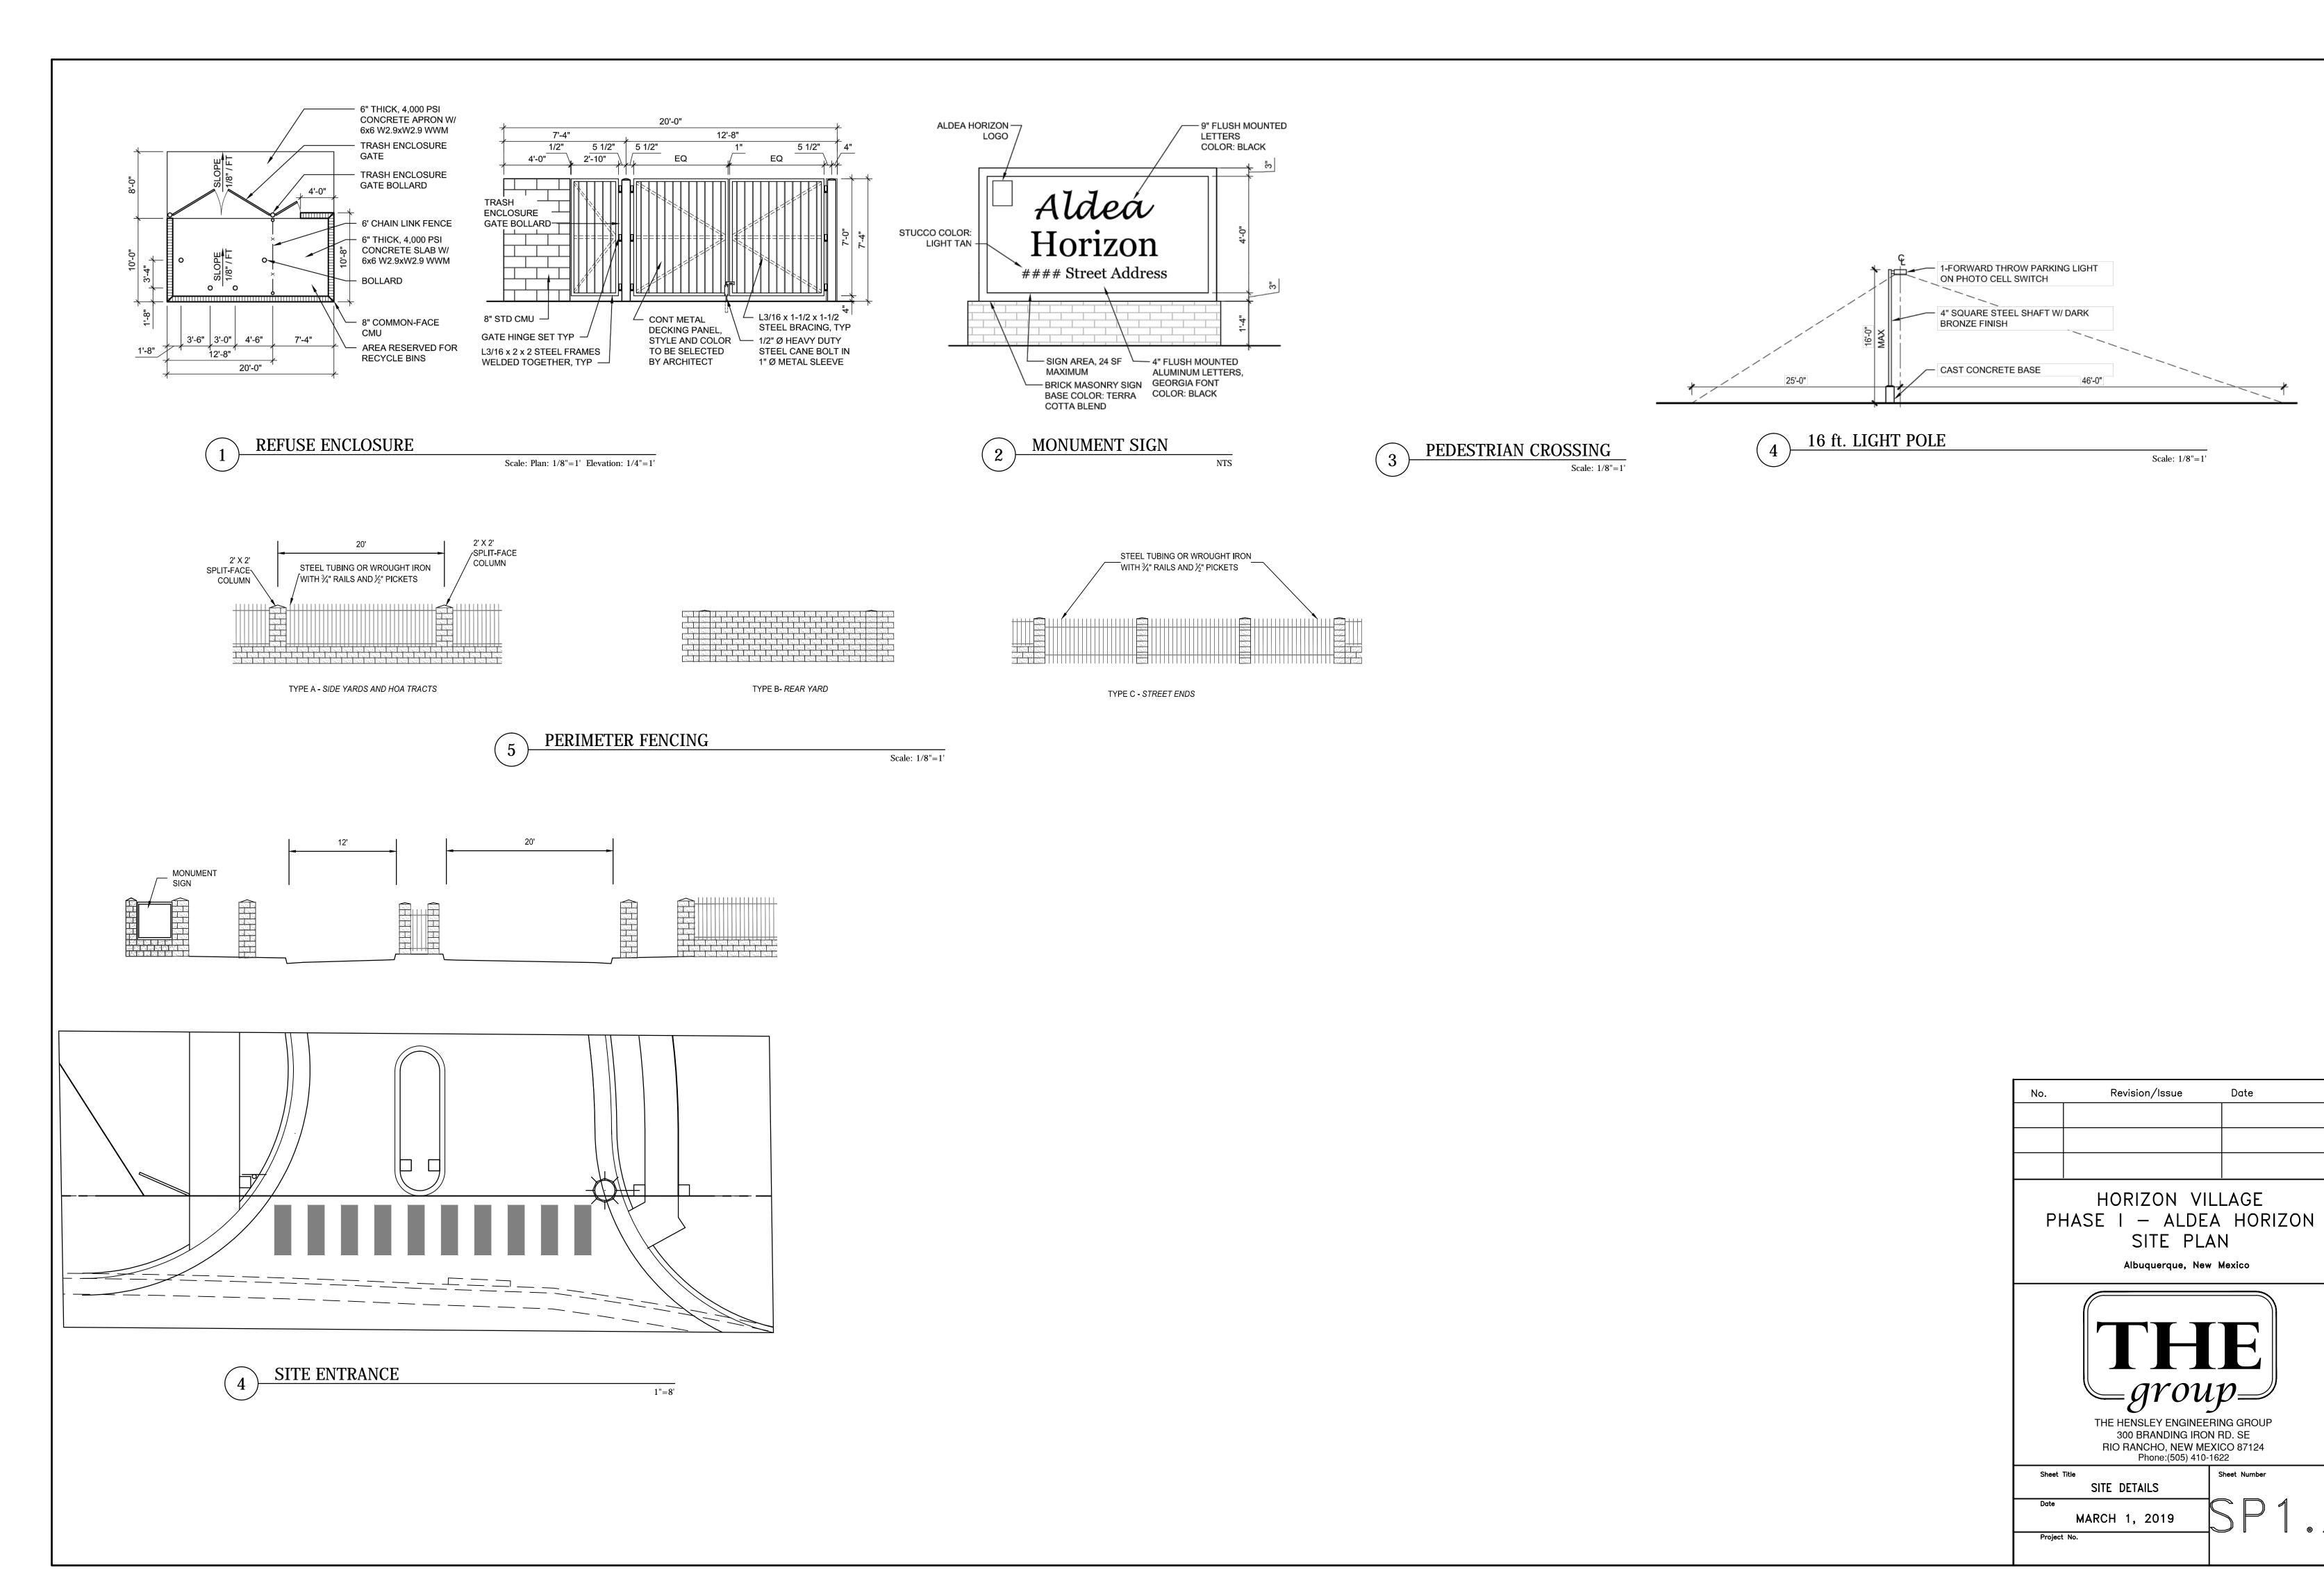


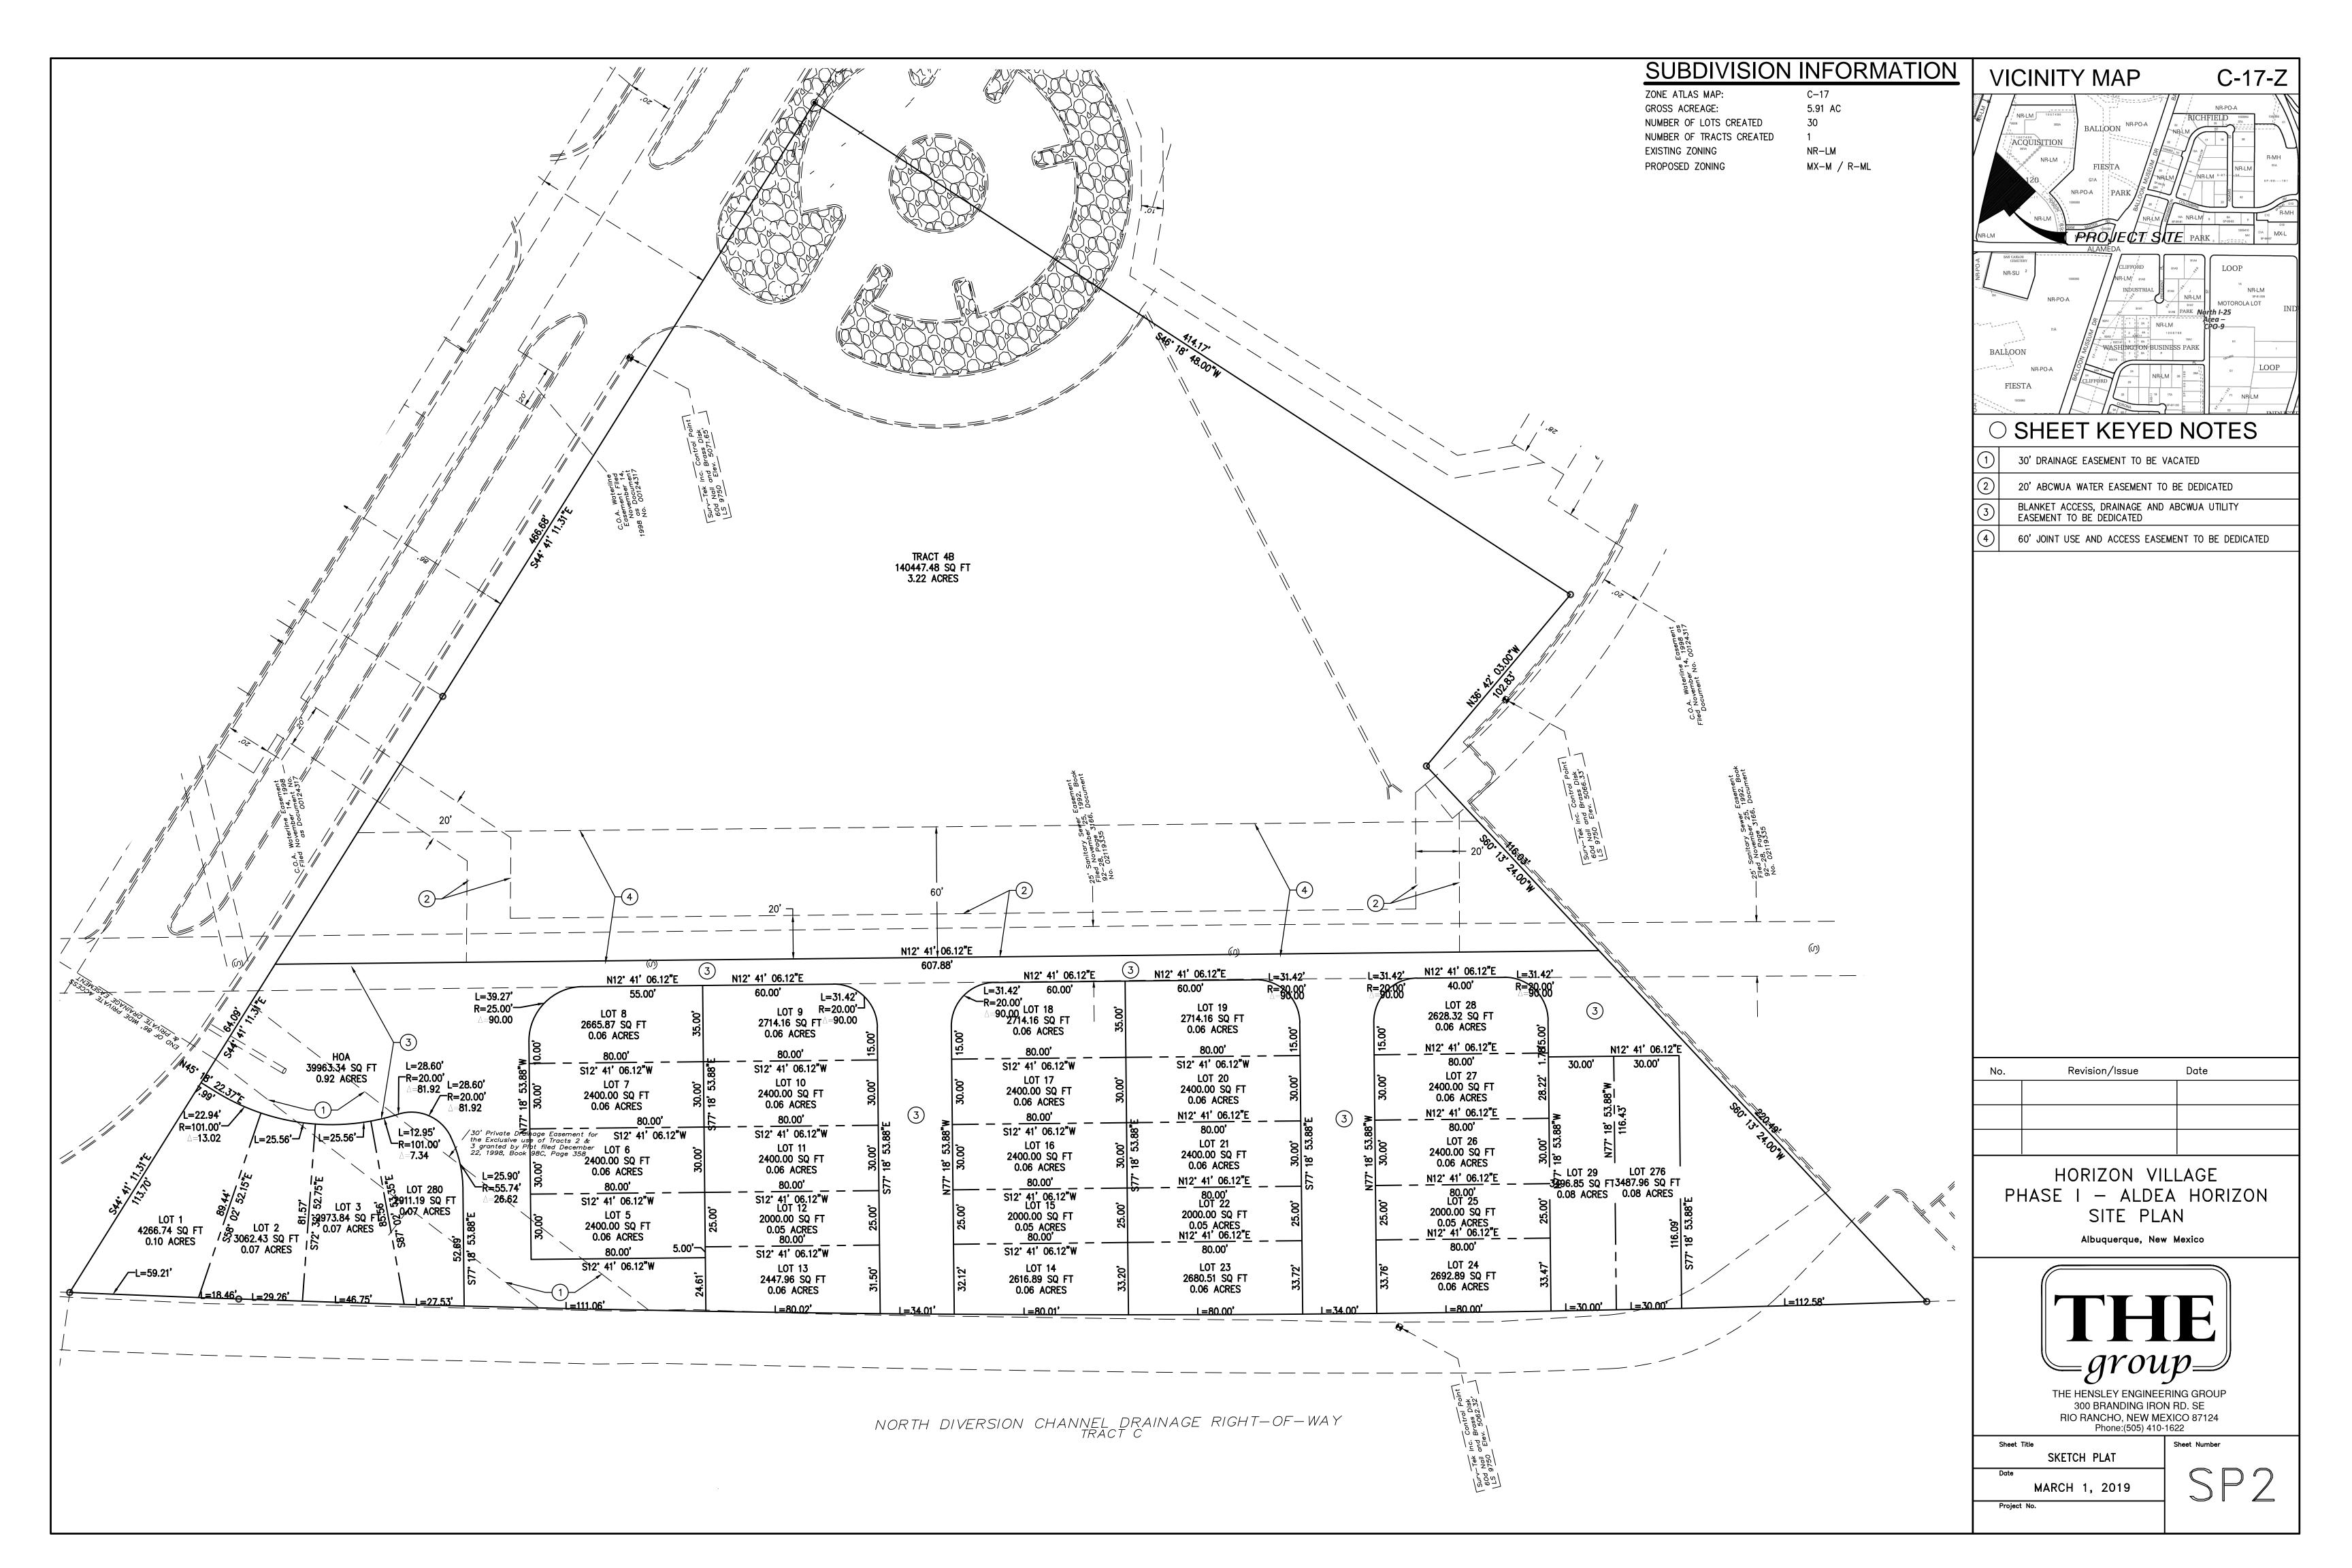

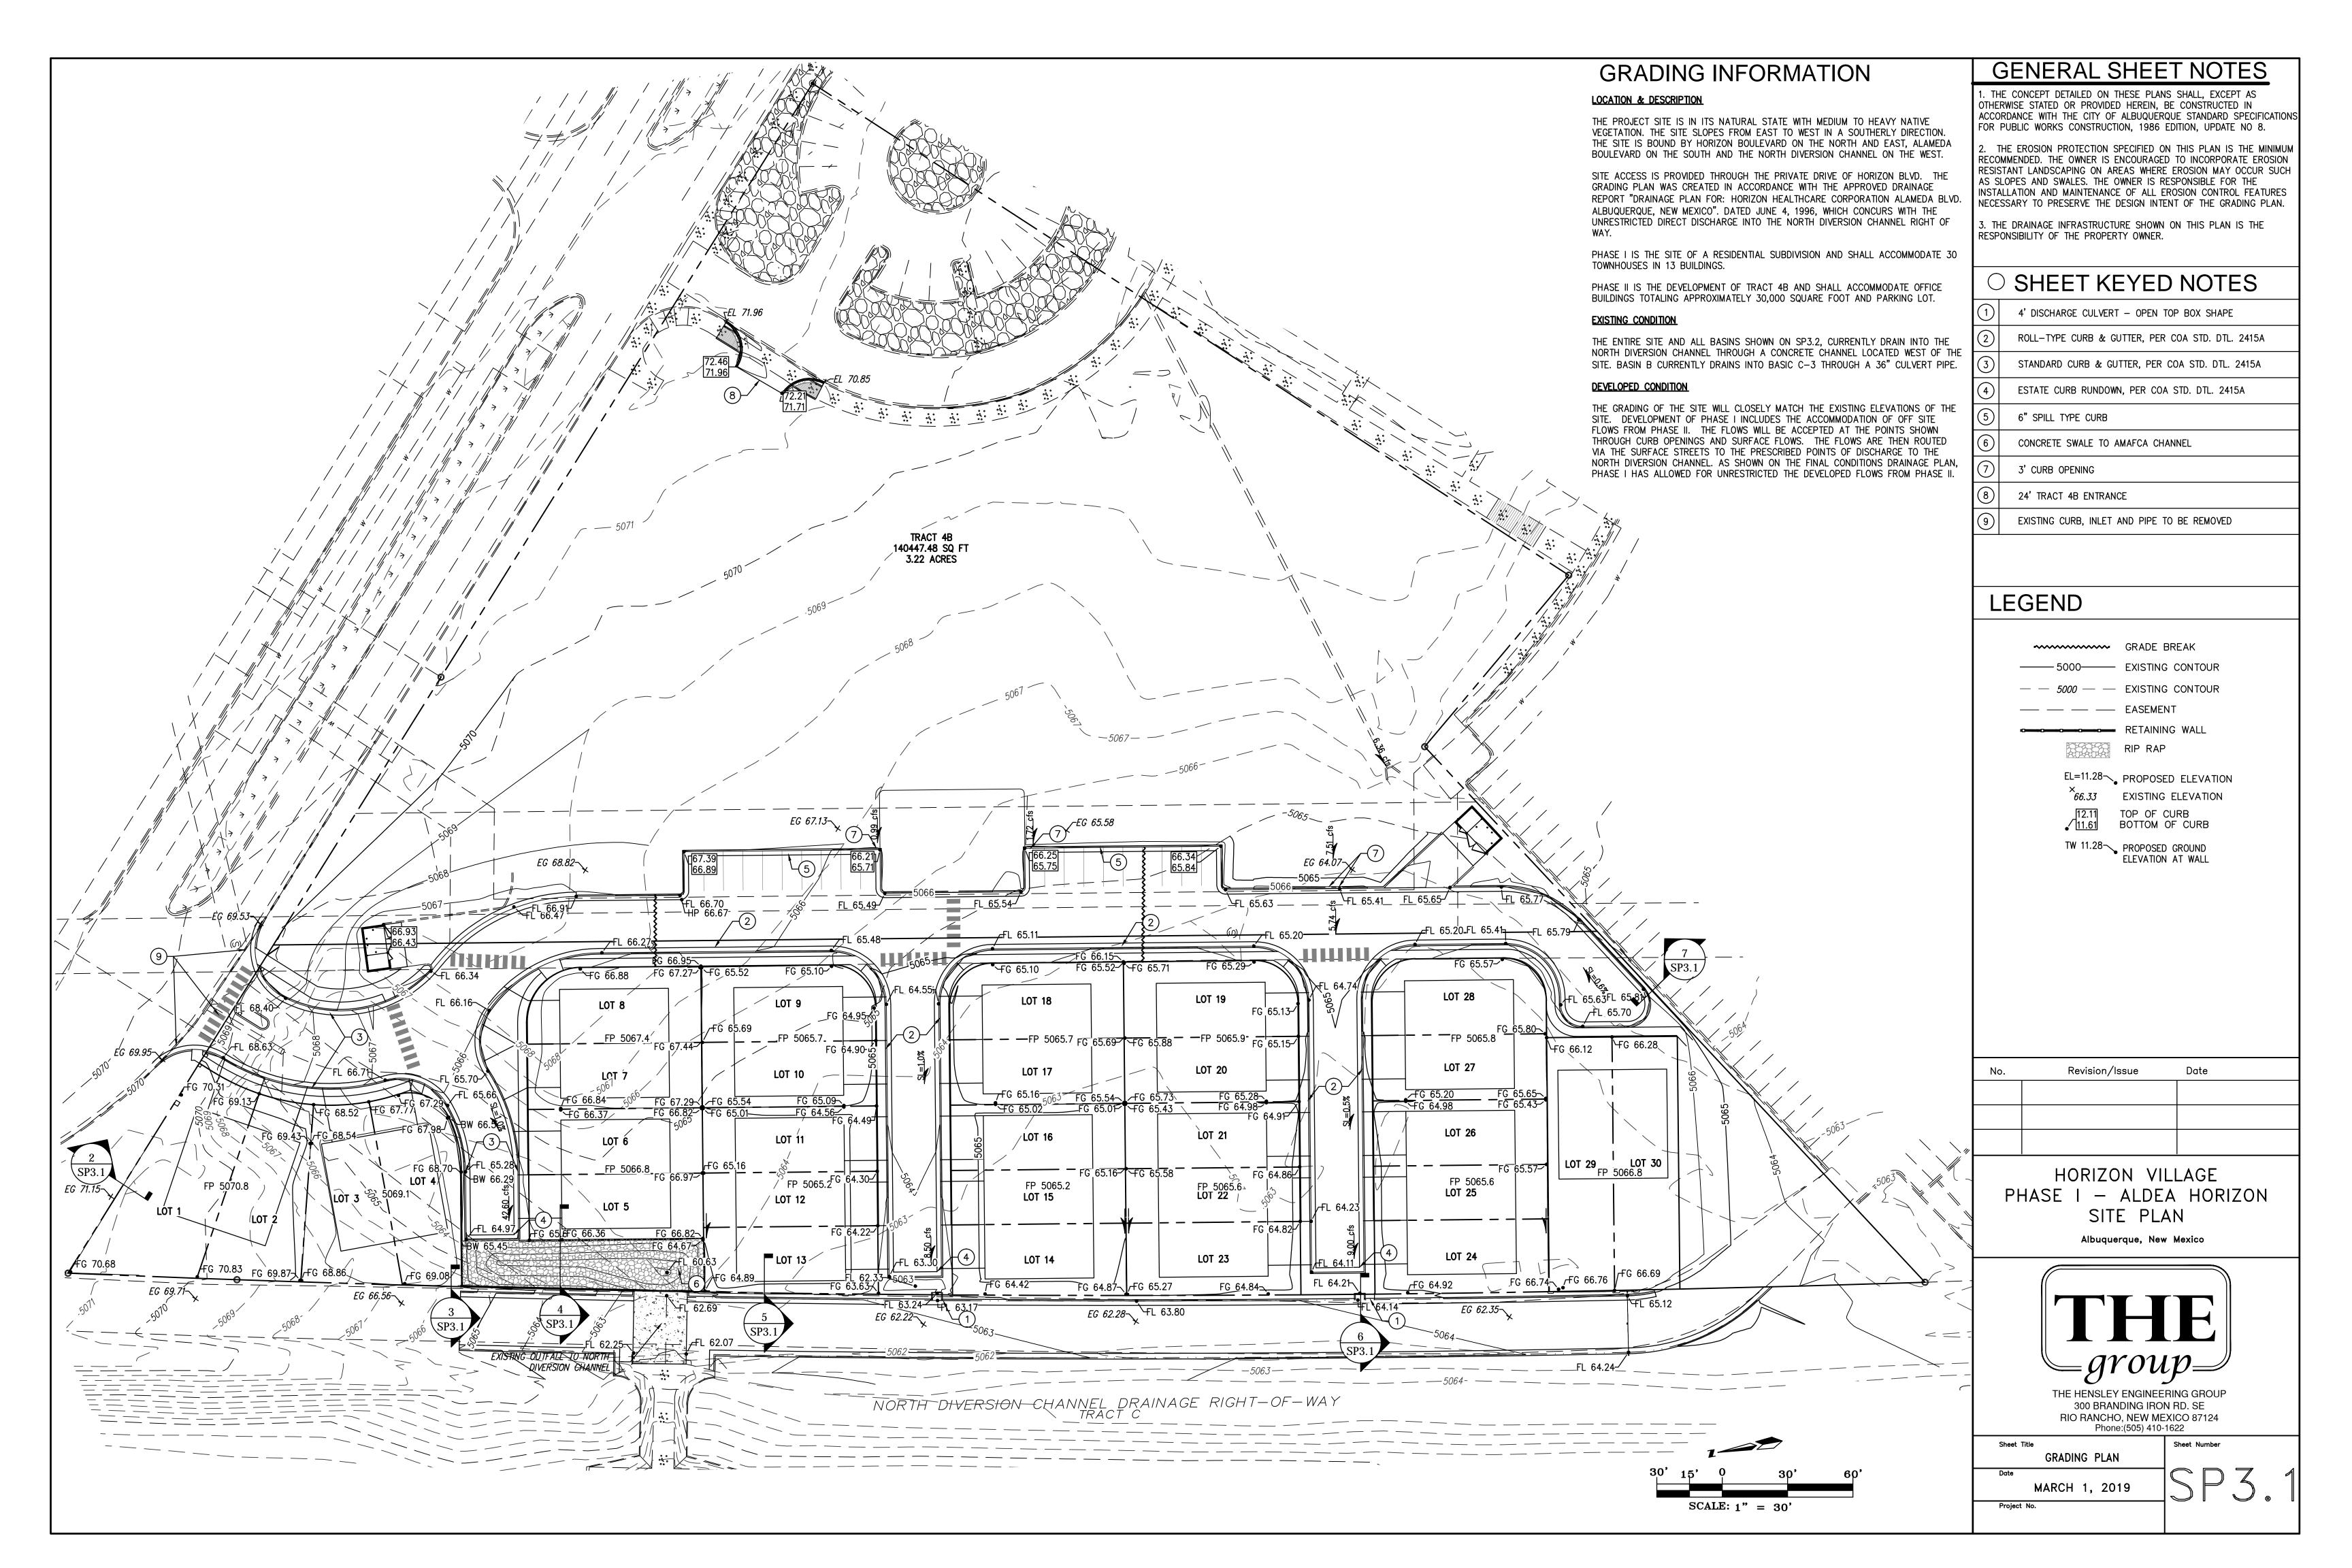

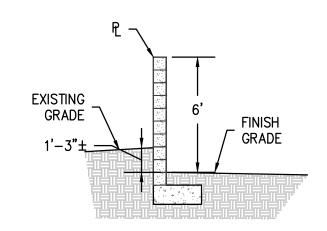


SECTION AT PROPERY LINE

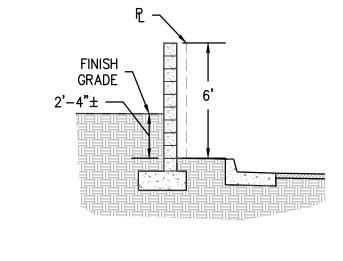


SECTION AT PROPERY LINE

Scale: 1"=5

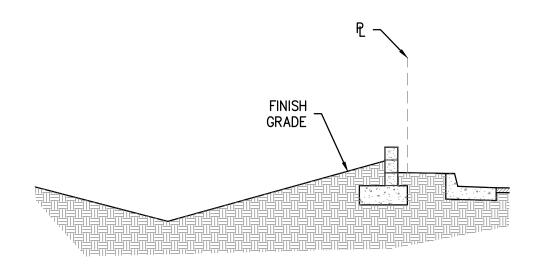


SECTION AT WATER QUALITY
Scale: 1"-5"

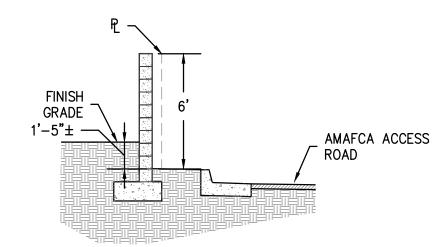


5 SECTION AT PROPERY LINE

Scale: 1"=5"

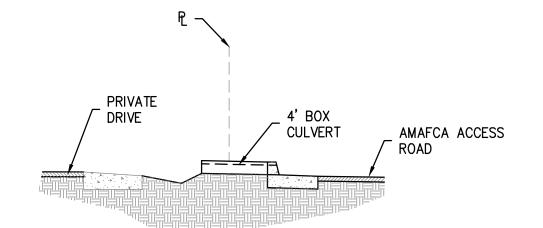


6 SECTION AT PROPERY LINE

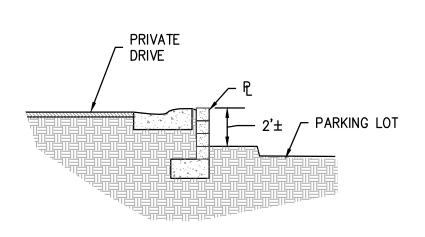


7 SECTION AT PROPERY LINE

Scale: 1"=5"

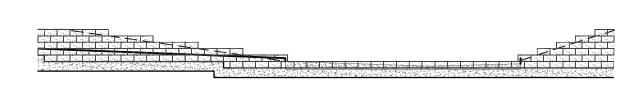

DRAIANGE DISCHARGE WIER

Scale: 1"=10'

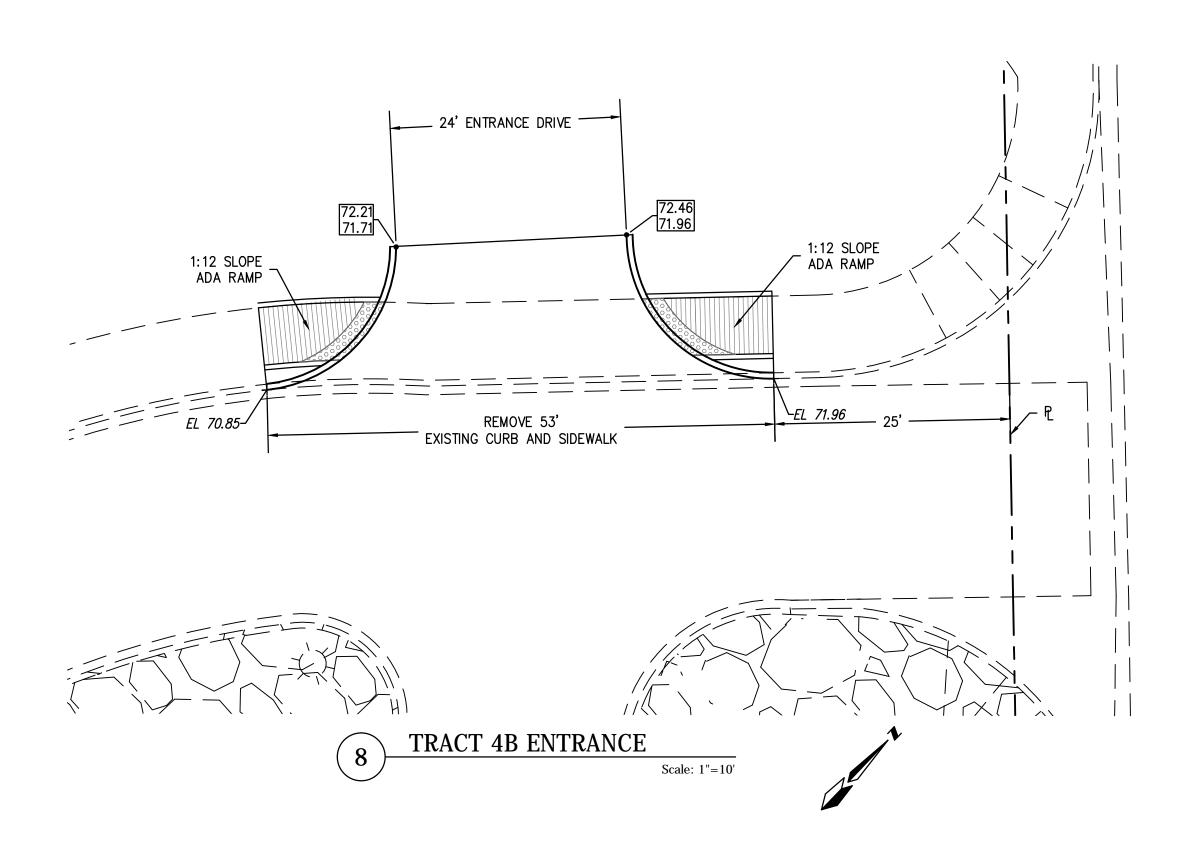

GENERAL SHEET NOTES

1. THE CONCEPT DETAILED ON THESE PLANS SHALL, EXCEPT AS OTHERWISE STATED OR PROVIDED HEREIN, BE CONSTRUCTED IN ACCORDANCE WITH THE CITY OF ALBUQUERQUE STANDARD SPECIFICATIONS FOR PUBLIC WORKS CONSTRUCTION, 1986 EDITION, UPDATE NO 8.

2. THE EROSION PROTECTION SPECIFIED ON THIS PLAN IS THE MINIMUM RECOMMENDED. THE OWNER IS ENCOURAGED TO INCORPORATE EROSION RESISTANT LANDSCAPING ON AREAS WHERE EROSION MAY OCCUR SUCH AS SLOPES AND SWALES. THE OWNER IS RESPONSIBLE FOR THE INSTALLATION AND MAINTENANCE OF ALL EROSION CONTROL FEATURES NECESSARY TO PRESERVE THE DESIGN INTENT OF THE GRADING PLAN.

3. THE DRAINAGE INFRASTRUCTURE SHOWN ON THIS PLAN IS THE RESPONSIBILITY OF THE PROPERTY OWNER.

O SHEET KEYED NOTES

LEGEND

GRADE BREAK

—— 5000— EXISTING CONTOUR

—— 5000— EXISTING CONTOUR

—— EASEMENT

RETAINING WALL

RIP RAP

EL=11.28— PROPOSED FLEVATION

PROPOSED ELEVATION

* 66.33 EXISTING ELEVATION

TOP OF CURB
BOTTOM OF CURB

TW 11.28 PROPOSED GROUND ELEVATION AT WALL

No. Revision/Issue Date

HORIZON VILLAGE PHASE I — ALDEA HORIZON SITE PLAN

Albuquerque, New Mexico



THE HENSLEY ENGINEERING GROUP 300 BRANDING IRON RD. SE RIO RANCHO, NEW MEXICO 87124 Phone:(505) 410-1622

Sheet Title

GRADING DETIALS

Date

AAA DOLL 1 20010

MARCH 1, 2019 ject No.

