

ARCHITECT SEAL TATE FISHBURN ENGINEER SEAL

>回


99 A

SEPTEMBER 27, 2019

OR AS NOTED DRAWING NAME SITE DEVELOPMENT PLAN FOR

1"=80'

SHEET NUMBER

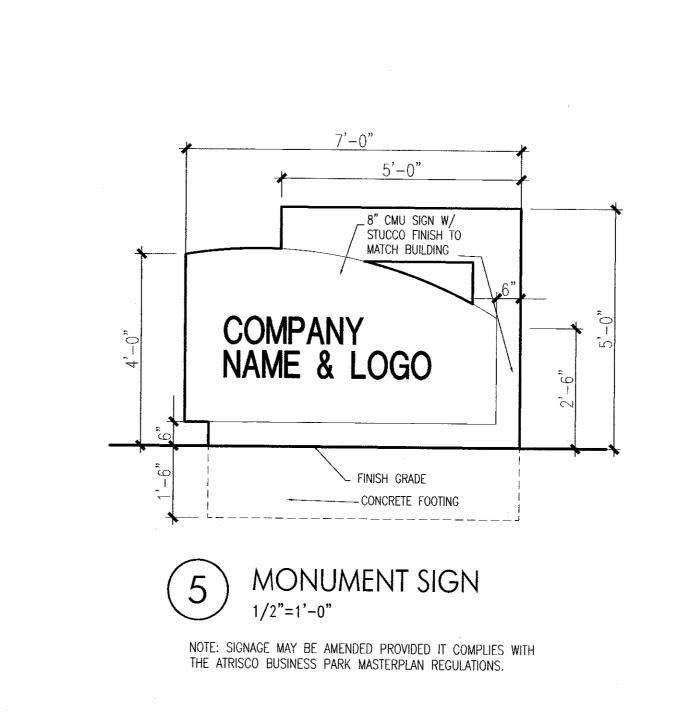



TILT-UP CONC. PANELS- COLOR 1- LIGHT GRAY COLOR 2- MEDIUM GRAY COLOR 3- DARK GRAY

METAL ACCENT COLOR- GREEN
ALUMINUM WINDOW FRAMES- CLEAR ANODIZED

WINDOW GLAZING- 1" TINTED INSULATED TINT COLOR- SOLAR GRAY OVERHEAD & HM DOORS- LIGHT GRAY


ALL BUILDING MOUNTED SIGNAGE TO BE LIGHTED EITHER INTERNALLY OR EXTERNALLY. ANY LIGHTING FOR SIGNAGE SHALL CONFORM TO NIGHT SKIES ACT. SIGNAGE MATERIAL TO BE EITHER RAISED METAL LETTERING OR TRANSLUCENT LEXAN PANELS OF ANY COLOR.

NOTE: SIGNAGE MAY BE AMENDED PROVIDED IT COMPLIES WITH THE ATRISCO BUSINESS PARK MASTERPLAN REGULATIONS.

BUILDING SIGNAGE CALCS:


WEST ELEVATION— BLDG. AREA.—17,509 S.F. SIGNAGE— 600 S.F. 600 / 17509 = 3.4%

NORTH ELEVATION— BLDG. AREA.—8,699 S.F. SIGNAGE— 150 S.F. 150 / 8699 = 1.7%

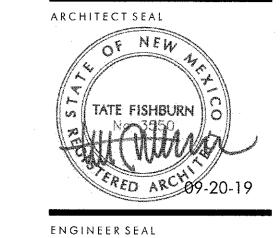

GRAPHIC SCALE

0 10' 30' 60'

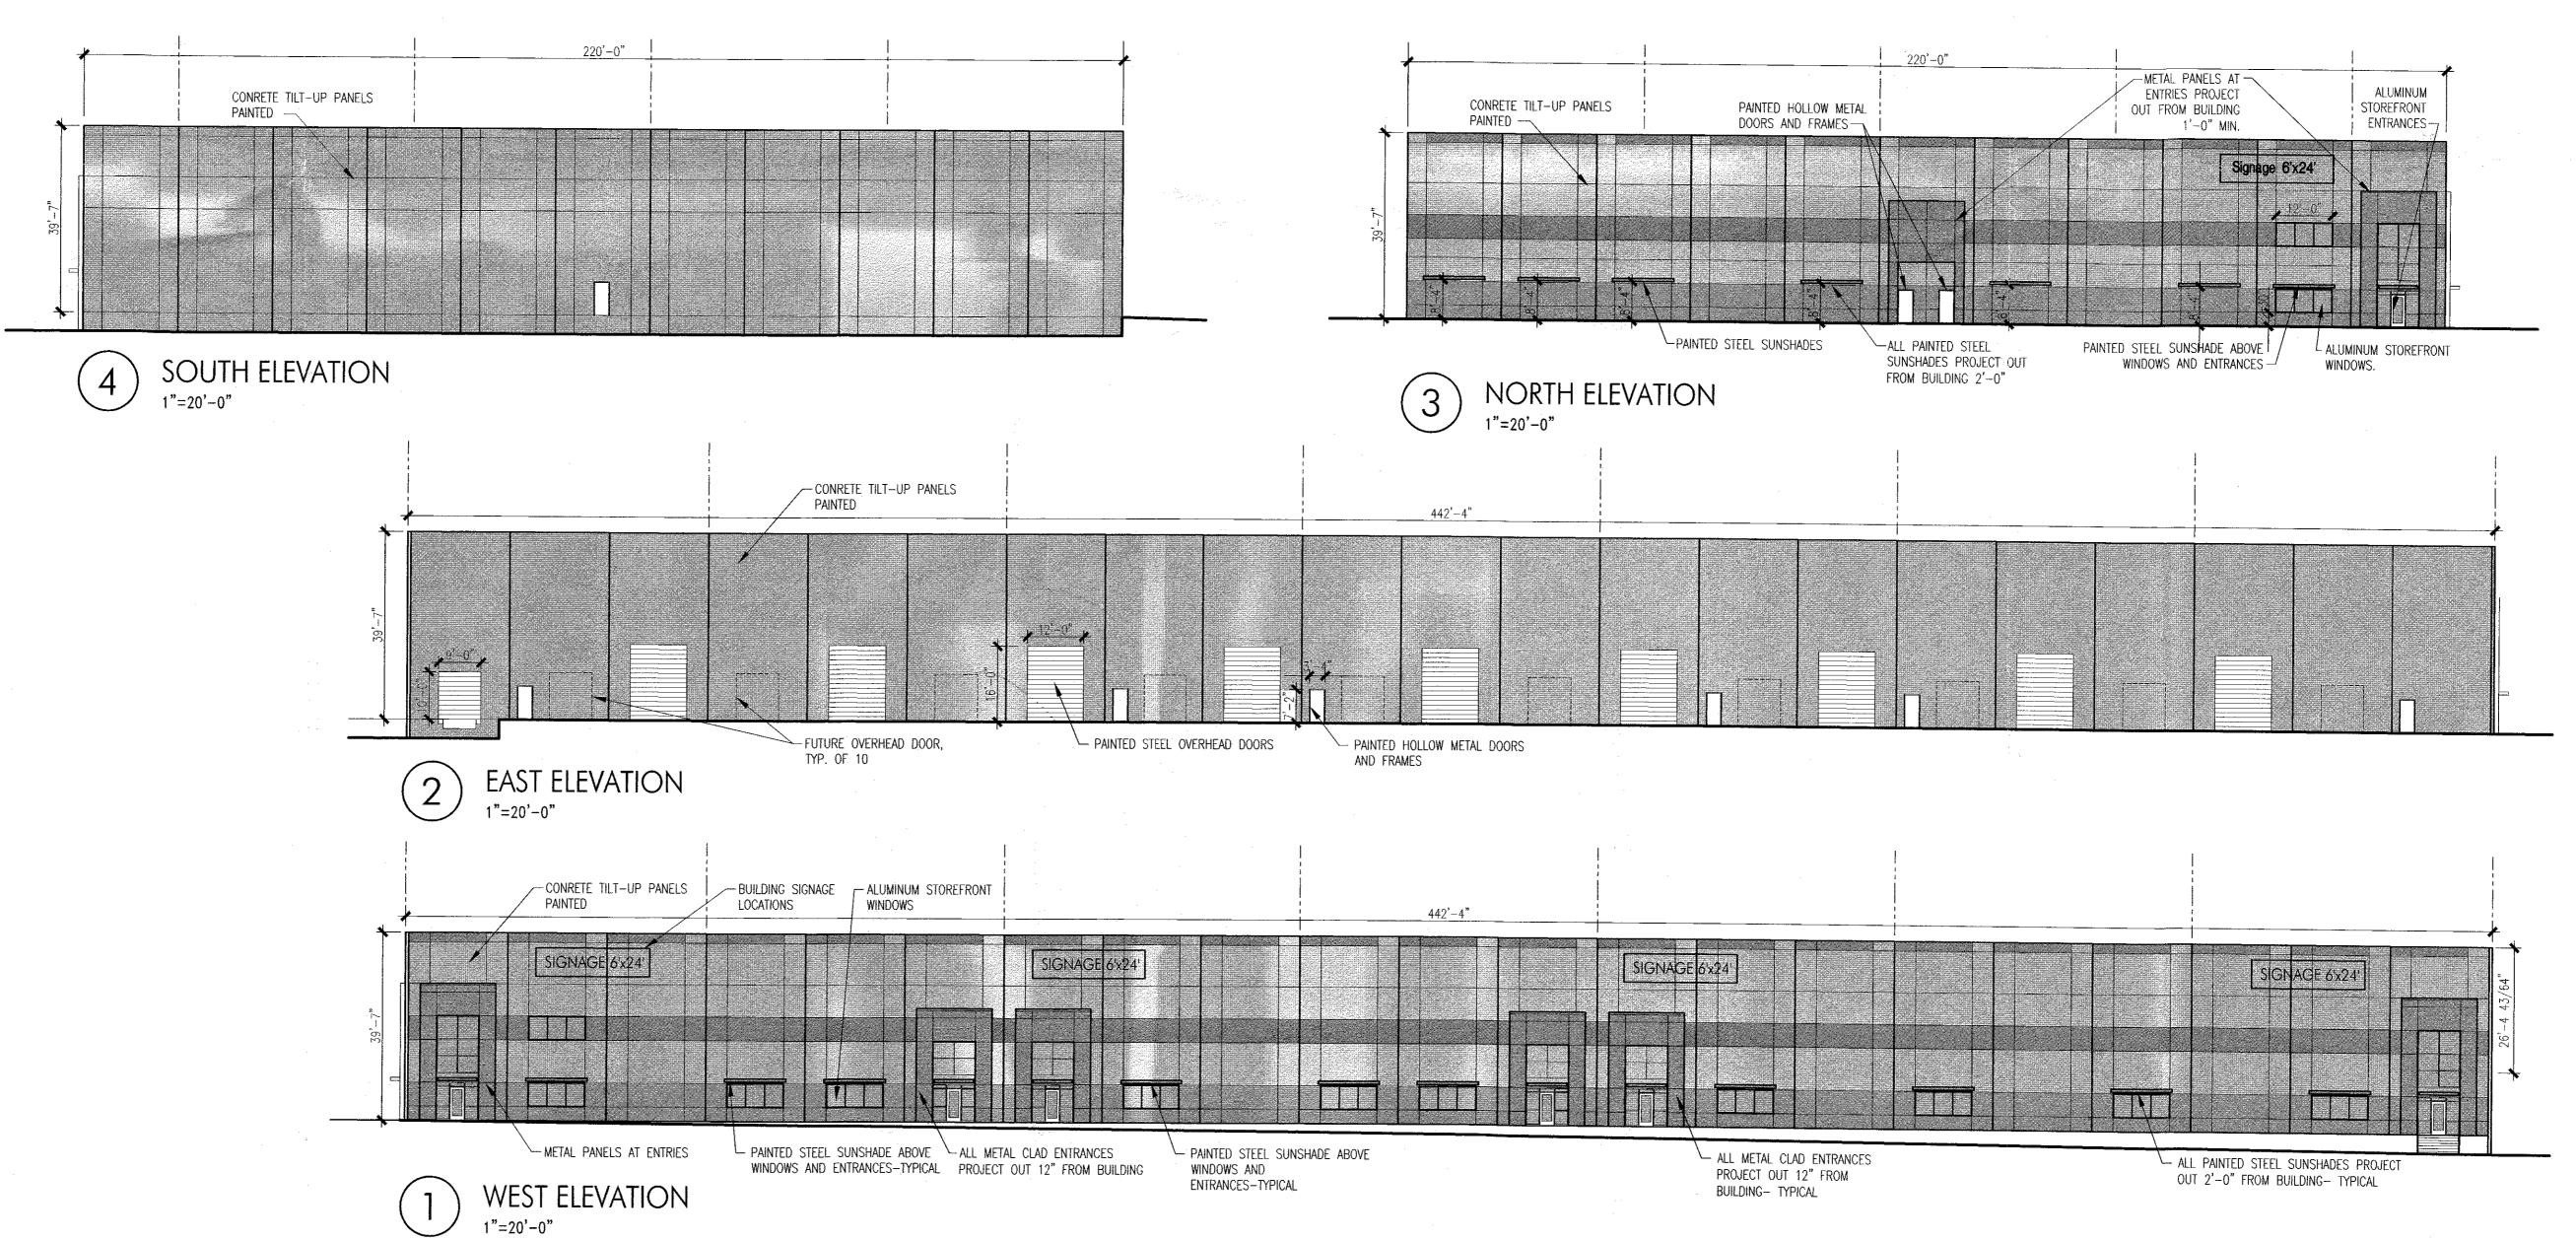

PROJECT

SITE DEVELOPMENT PLAN
FOR BUILDING PERMIT
7601 LOS VOLCANES, NW UNIT A

REVISIONS.

SEPTEMBER 20, 2019


1"=20' OR AS NOTED

DRAWING NAME

ELEVATIONS

SHEET NUMBER

SDP-2

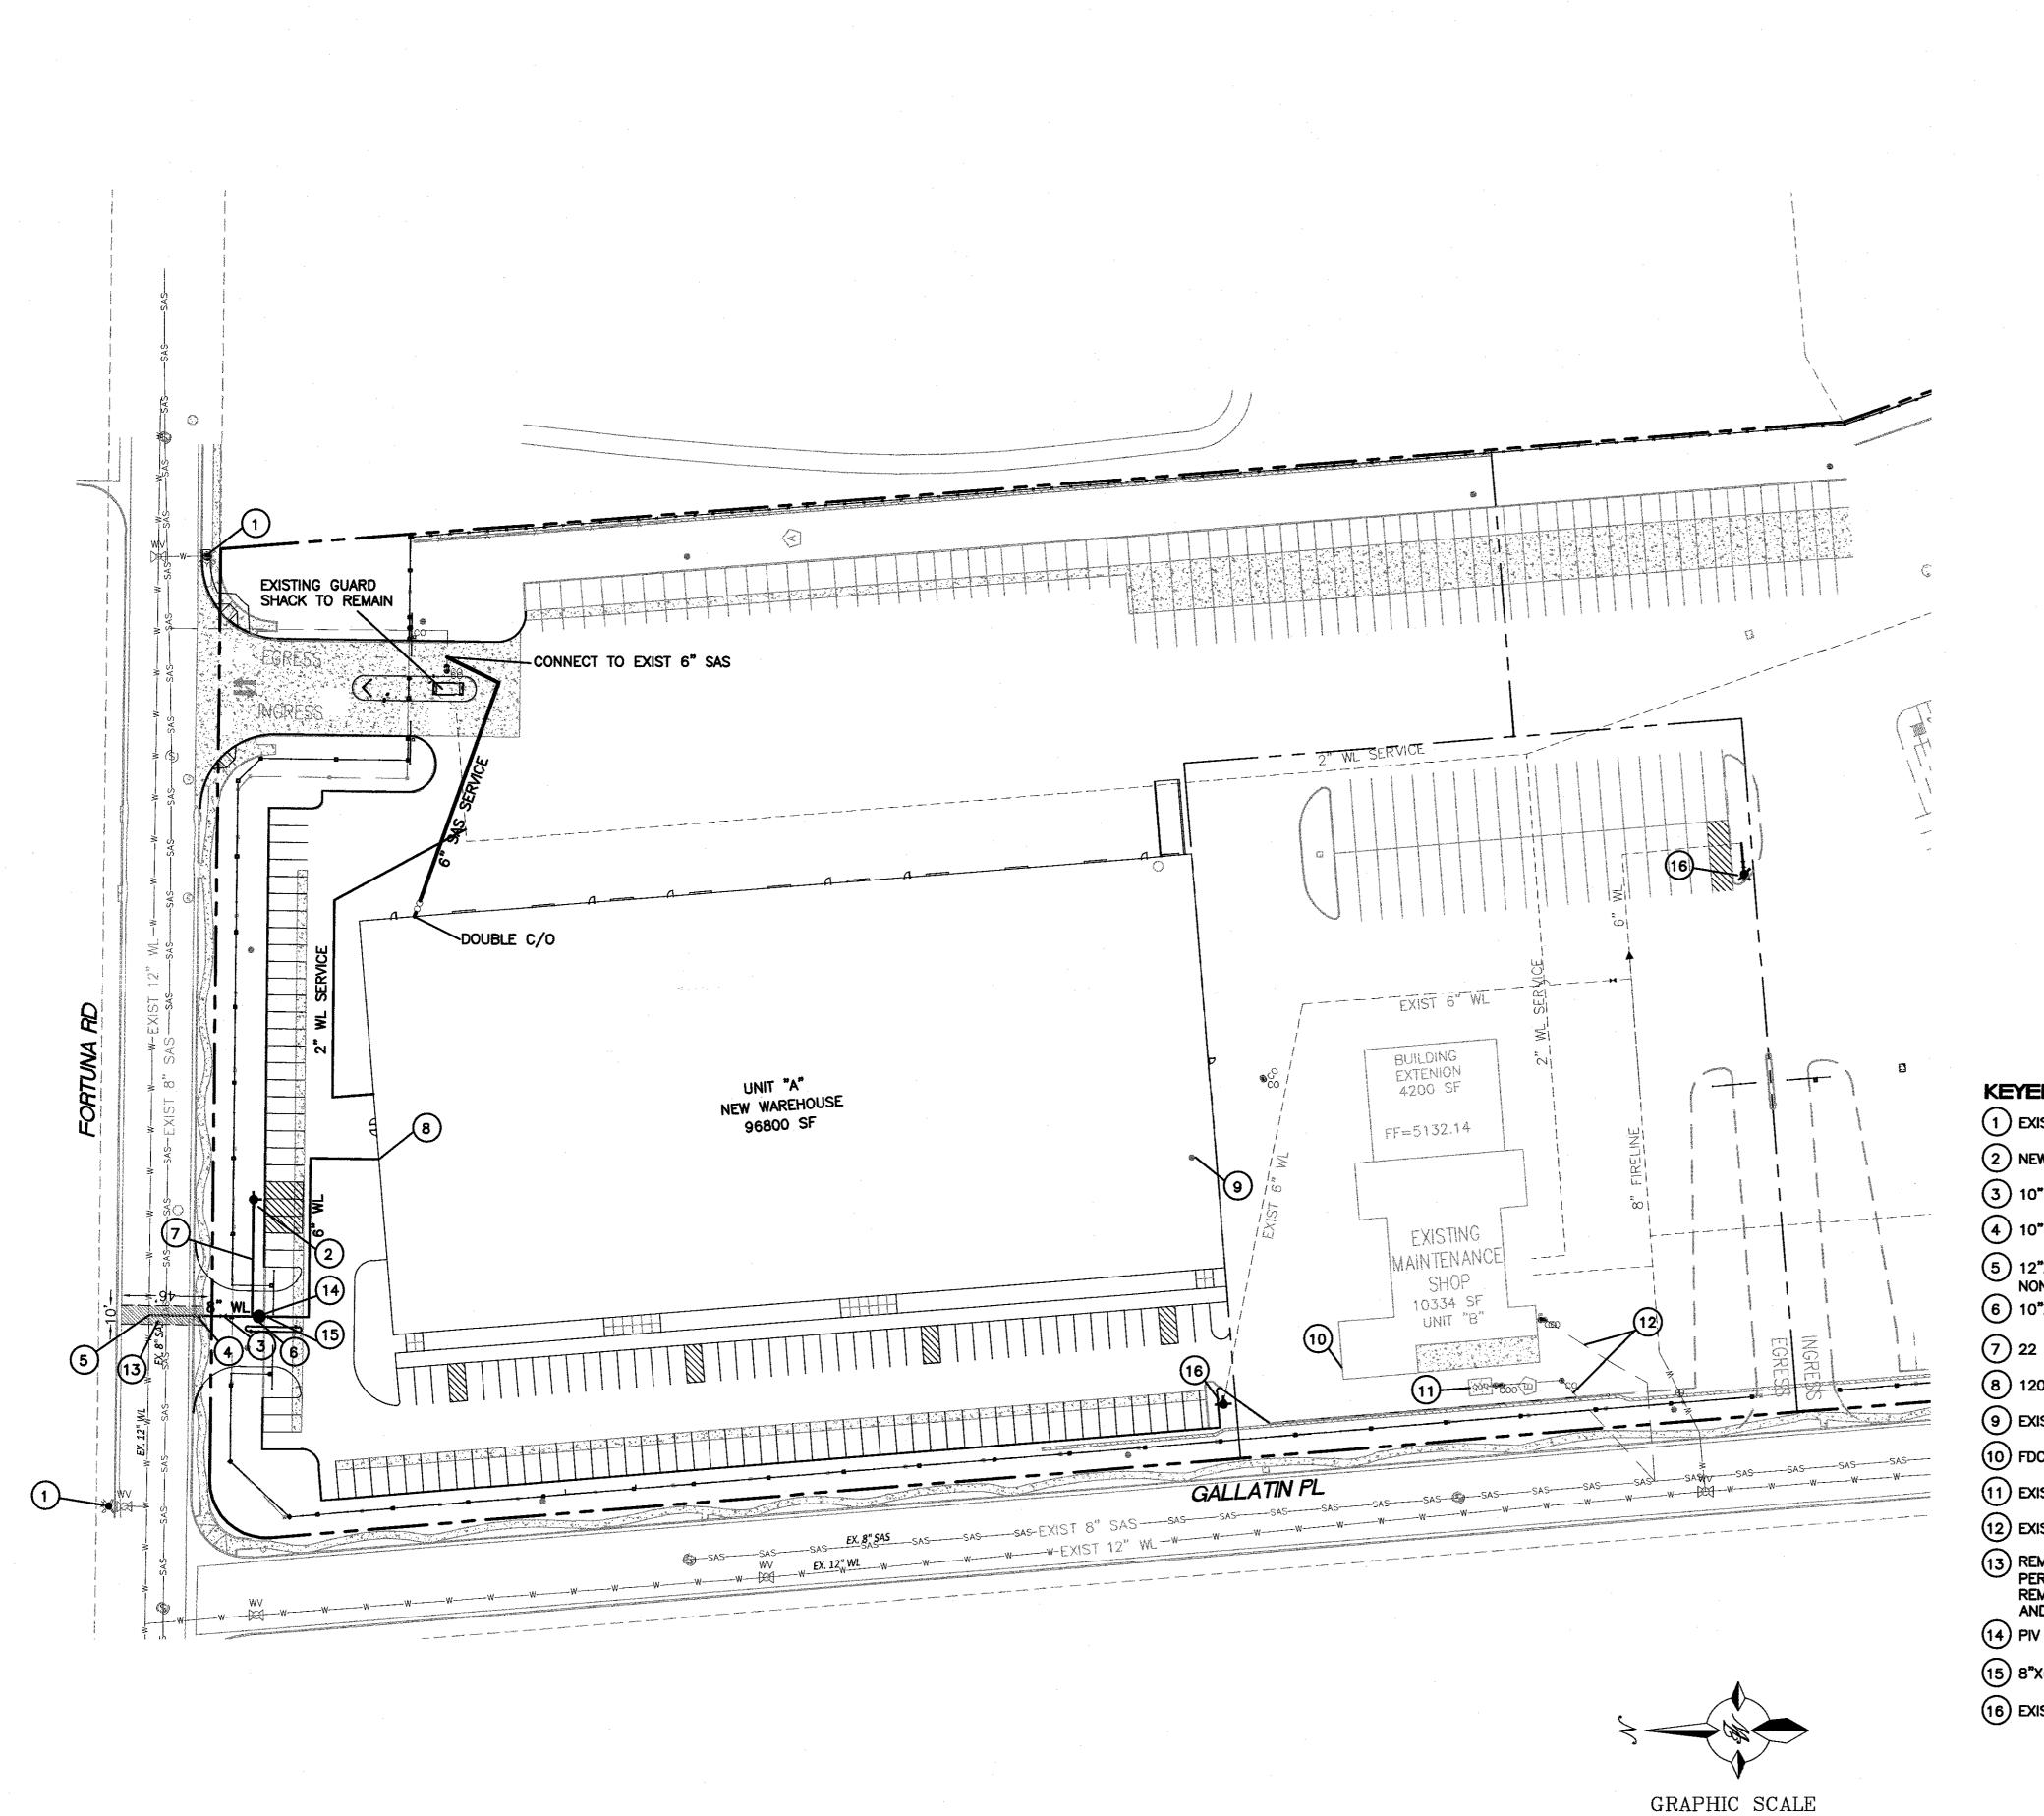



CURB & GUTTER BOUNDARY LINE --- EASEMENT BUILDING CONCRETE THE SHARE SH SD ---- EXISTING STORM SEWER LINE SAS ---- EXISTING SANITARY SEWER LINE EXISTING WATERLINE EXISTING ELECTRIC LINE EXISTING SINGLE CLEAN OUT DOUBLE CLEAN OUT EXISTING SD MANHOLE EXISTING INLET EXISTING SAS MANHOLE EXISTING FIRE HYDRANT EXISTING WATER METER EXISTING POWER POLE EXISTING LIGHT STANDARD (TO REMAIN) PROPOSED FIRE HYDRANT

GENERAL UTILITY NOTES:

- 1. ALL WATER AND SEWER UTILITY WORK TO BE DONE IN ACCORDANCE WITH COA STANDARDS AND SPECIFICATIONS LATEST EDITION.
- 2. 4' MINIMUM BURY REQUIRED FOR ALL UTILITIES UNLESS OTHERWISE NOTED.
- 3. REFERENCE ARCHITECTURAL PLANS FOR WATER LINE RISER LOCATIONS.
- 4. CLEAN OUTS ARE TO BE BUILT PER UNIFORM PLUMBING CODE
- 5. ALL PLUMBING PIPE MATERIAL TO BE USED PER UPC.
- 6. FIRE LINE AND DOMESTIC WATERLINE MUST HAVE BACKFLOW PREVENTORS PER UPC. IF BACKFLOW PREVENTOR IS INSTALLED EXTERIOR OF BUILDING A HOT BOX SHALL BE INSTALLED AND USED.
- 7. ALL EX. SD INLETS AND MH SHALL HAVE CONCRETE COLLARS POURED AND BE ADJUSTED TO FINISHED GRADE.
- NEW PRIVATE FIRE HYDRANT PER COA STD DWG 2340 8. ALL EXCAVATION, TRENCHING AND SHORING ACTIVITIES MUST BE CARRIED-OUT IN ACCORDANCE WITH OSHA 29 CFR 1926.650 SUBPART P.
 - 9. ALL UTILITY DISTANCES SHOWN ARE FOR REFERENCE ONLY.
 - 10. PNM HAS NUMEROUS ELECTRIC FACILITIES AT THIS SITE CURRENTLY SERVING EXISTING CUSTOMERS. THE APPLICANT SHALL COORDINATE WITH PNM REGARDING THESE EXISTING FACILITIES. ANY RELOCATION, CHANGES OR REALIGNMENT OF EXISTING ELECTRIC UTILITIES WILL BE THE DEVELOPER EXPENSE. IN SOME CASES, RELOCATION OR CHANGES TO EXISTING FACILITIES MAY NOT BE FEASIBLE DUE TO PHYSICAL, USE OR SAFETY CLEARANCE CONSTRAINTS.
 - 11. PNM WILL REVIEW ALL TECHNICAL NEEDS, ISSUES AND SAFETY CLEARANCES FOR ITS ELECTRIC POWER SYSTEMS. ANY EXISTING AND PROPOSED PUBLIC UTILITY EASEMENTS SHALL BE INDICATED ON THE SITE PLAN UTILITY SHEET PRIOR TO DRB REVIEW. PNM'S STANDARD FOR PUBLIC UTILITY EASEMENTS IS 10 FEET IN WIDTH TO ENSURE ADEQUATE, SAFE CLEARANCES.
 - 12. SCREENING SHALL BE DESIGNED TO ALLOW FOR ACCESS TO UTILITY FACILITIES. IT IS NECESSARY TO PROVIDE ADEQUATE CLEARANCE OF TEN FEET SURROUNDING ALL GROUND-MOUNTED UTILITIES FOR SAFE OPERATION, MAINTENANCE AND REPAIR PURPOSES.
 - 13. ALL BUILDINGS CONSTRUCTION TYPE IS II-B

CAUTION

(IN FEET)

1 inch = 50 ft.

KEYED NOTES

(5) 12"X12"X10" TEE

(6) 10"X10"X6" TEE

8 120 LF 10" FIRELINE

9 EXIST LIGHT TO BE REMOVED

(12) EXISTING 4" SAS SERVICE

(15) 8"X6" REDUCER

(11) EXISTING SAND SEPARATOR W/CLEANOUTS

REMOVE AND REPLACE EXIST ASPHALT

(16) EXISTING FIRE HYDRANT (PRIVATE)

PER COA STD DWG 2465 (40'X20') REMOVE AND REPLACE EXIST CURB

AND GUTTER PER COA STD DWG 2415A

(7) 22 LF 6" WL

10) FDC

(1) EXISTING FIRE HYDRANT (PUBLIC)


NON PRESSURE CONNECTION

3 10" GATE VALVE (PRIVATE)

4 10" GATE VALVE (PUBLIC)

ALL EXISTING UTILITIES SHOWN WERE OBTAINED FROM RESEARCH, AS-BUILTS, SURVEYS OR INFORMATION PROVIDED BY OTHERS. IT SHALL BE THE SOLE RESPONSIBILITY OF THE CONTRACTOR TO CONDUCT ALL NECESSARY FIELD INVESTIGATIONS PRIOR TO AND INCLUDING ANY EXCAVATION. TO DETERMINE THE ACTUAL LOCATION OF UTILITIES AND OTHER IMPROVEMENTS, PRIOR TO STARTING THE WORK. ANY CHANGES FROM THIS PLAN SHALL BE COORDINATED WITH AND APPROVED BY THE ENGINEER.

ENGINEER'S SEAL	7601 LOS VOLCANES RD NW ALBUQUERQUE, NM 87121	<i>DRAWN BY</i> pm
	MASTER UTILITY PLAN	<i>DATE</i> 9–26–19
	WINTER OTHER TEACH	<i>DRAWING</i> 2019025—MU
		SHEET #
	TIERRA WEST, LLC 5571 MIDWAY PARK PL NE ALBUQUERQUE, NEW MEXICO 87109	MU-1
RONALD R. BOHANNAN P.E. #7868	(505) 858-3100 www.tierrawestllc.com	<i>JOB </i>

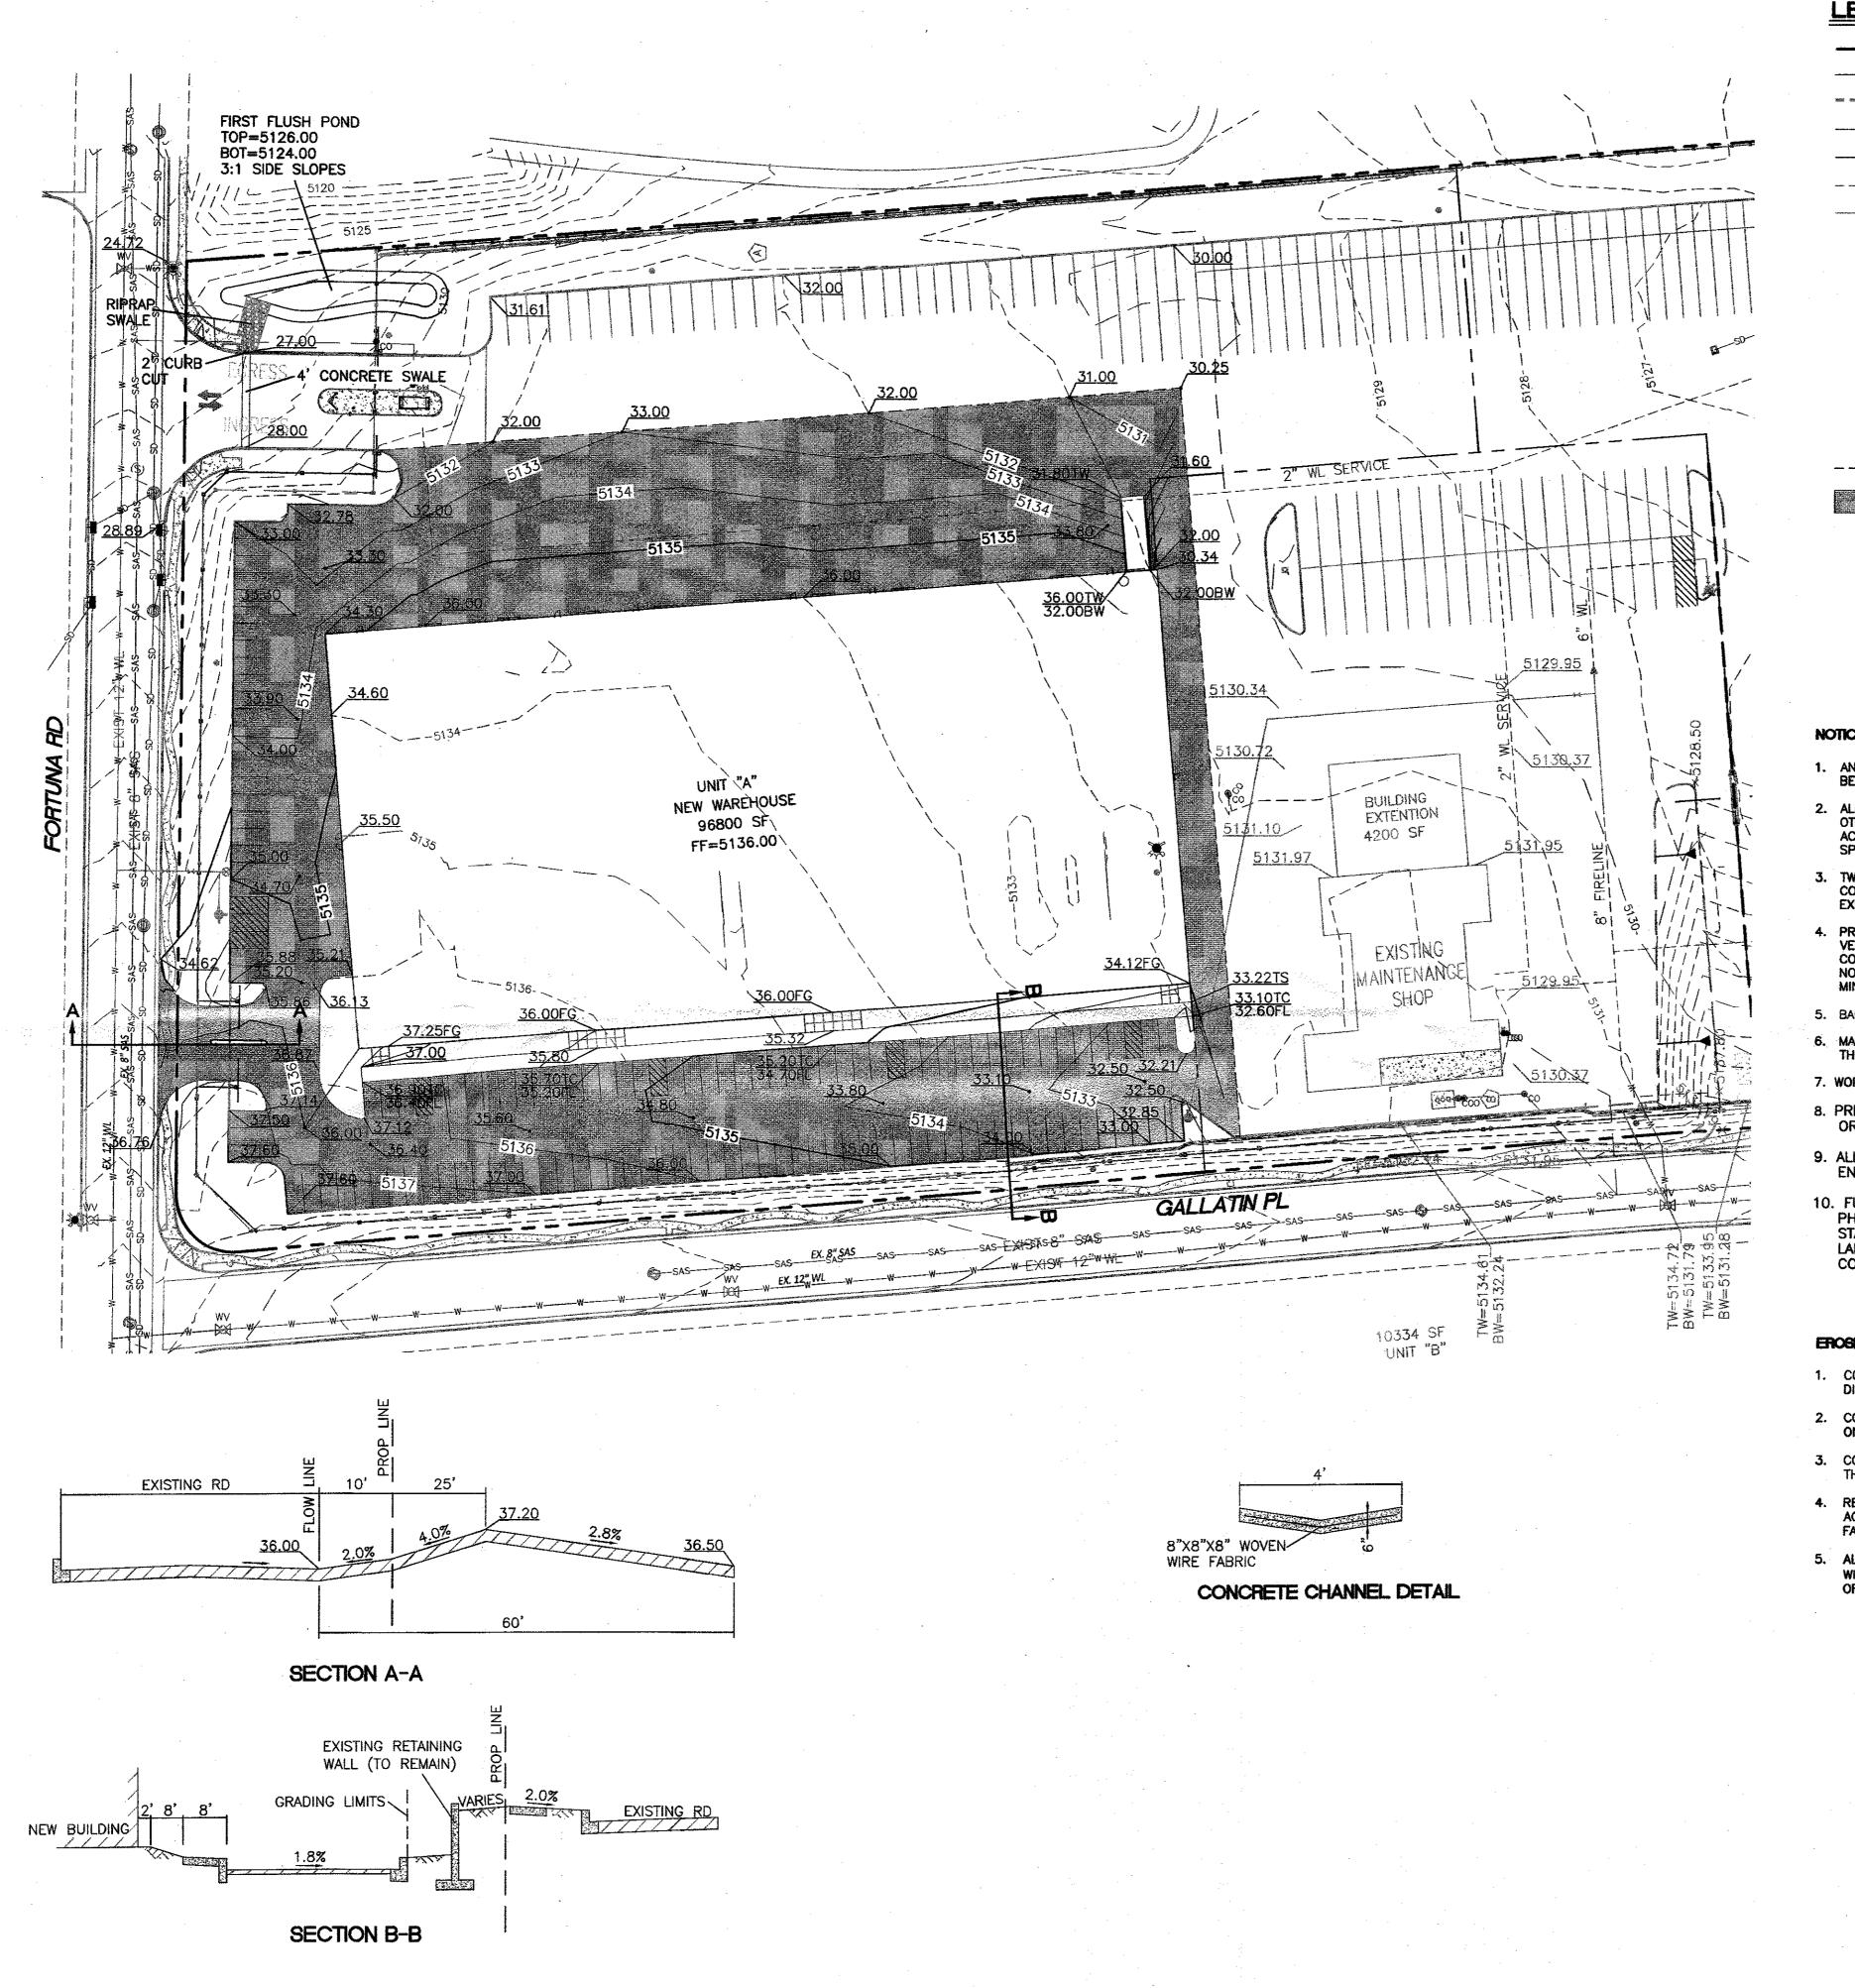

LEGEND

	BOUNDARY LINE
	BUILDING
Mile White Mintel with smile section sweet between holes	EXISTING CURB & GUTTER
SD	EXISTING STORM SEWER LINE
SAS	EXISTING SANITARY SEWER LINE
	EXISTING WATERLINE
	EXISTING ELECTRIC LINE
•	EXISTING SINGLE CLEAN OUT
• •	DOUBLE CLEAN OUT
	EXISTING SD MANHOLE
	EXISTING INLET
\$	EXISTING SAS MANHOLE
	EXISTING FIRE HYDRANT
	EXISTING WATER METER
•	EXISTING POWER POLE
<u></u>	SAWCUT LINE

REMOVE AND REPLACE EXIST PAVING

NOTICE TO CONTRACTORS

- 1. AN EXCAVATION/CONSTRUCTION PERMIT WILL BE REQUIRED BEFORE BEGINNING ANY WORK WITHIN CITY RIGHT-OF-WAY.
- 2. ALL WORK DETAILED ON THESE PLANS TO BE PERFORMED, EXCEPT AS OTHERWISE STATED OR PROVIDED HEREON, SHALL BE CONSTRUCTED IN ACCORDANCE WITH CITY OF ALBUQUERQUE INTERIM STANDARD SPECIFICATIONS FOR PUBLIC WORKS CONSTRUCTION, 1985.
- TWO WORKING DAYS PRIOR TO ANY EXCAVATION, CONTRACTOR MUST CONTACT LINE LOCATING SERVICE, 765-1234, FOR LOCATION OF EXISTING UTILITIES.
- 4. PRIOR TO CONSTRUCTION, THE CONTRACTOR SHALL EXCAVATE AND VERIFY THE HORIZONTAL AND VERTICAL LOCATIONS OF ALL CONNECTIONS. SHOULD A CONFLICT EXIST, THE CONTRACTOR SHALL NOTIFY THE ENGINEER SO THAT THE CONFLICT CAN BE RESOLVED WITH A MINIMUM AMOUNT OF DELAY.
- 5. BACKFILL COMPACTION SHALL BE ACCORDING TO TRAFFIC/STREET USE.
- MAINTENANCE OF THESE FACILITIES SHALL BE THE RESPONSIBILITY OF THE OWNER OF THE PROPERTY SERVED.
- 7. WORK ON ARTERIAL STREETS SHALL BE PERFORMED ON A 24-HOUR BASIS.
- 8. PRIOR TO WORK WITHIN THE COA RIGHT-OF-WAY, A WORK ORDER PERMIT WILL BE REQUIRED
- 9. ALL DISTURBED AREAS MUST BE STABILIZED PRIOR TO ENGINEERS CERTIFICATION FOR CERTIFICATE OF OCCUPANCY
- 10. FUTURE BUILDING AND PAVEMENT AREAS ARE TO BA GRADED IN PHASE 1 TO SUBGRADE ELEVATIONS. THESE AREAS SHALL BE STABILIZED IN PHASE 1 WITH GRAVEL MULCH AS NOTED ON THE LANDSCAPE PLAN. SEE SHEET C-208 FOR ULTIMATE BUILD OUT CONPEPTUAL GRADING AND DRAINAGE PLAN

EROSION CONTROL NOTES:

CAUTION

- 1. CONTRACTOR IS RESPONSIBLE FOR OBTAINING A TOPSOIL DISTURBANCE PERMIT PRIOR TO BEGINNING WORK.
- 2. CONTRACTOR IS RESPONSIBLE FOR MAINTAINING RUN-OFF ON SITE DURING CONSTRUCTION.
- 3. CONTRACTOR IS RESPONSIBLE FOR CLEANING ALL SEDIMENT THAT GETS INTO EXISTING RIGHT-OF-WAY.
- 4. REPAIR OF DAMAGED FACILITIES AND CLEANUP OF SEDIMENT ACCUMULATIONS ON ADJACENT PROPERTIES AND IN PUBLIC FACILITIES IS THE RESPONSIBILITY OF THE CONTRACTOR.
- 5. ALL EXPOSED EARTH SURFACES MUST BE PROTECTED FROM WIND AND WATER EROSION PRIOR TO FINAL (CITY) ACCEPTANCE

ALL EXISTING UTILITIES SHOWN WERE OBTAINED FROM

CONTRACTOR TO CONDUCT ALL NECESSARY FIELD

AND APPROVED BY THE ENGINEER.


RESEARCH, AS-BUILTS, SURVEYS OR INFORMATION PROVIDED


BY OTHERS. IT SHALL BE THE SOLE RESPONSIBILITY OF THE

INVESTIGATIONS PRIOR TO AND INCLUDING ANY EXCAVATION,

TO DETERMINE THE ACTUAL LOCATION OF UTILITIES AND OTHER IMPROVEMENTS, PRIOR TO STARTING THE WORK. ANY

CHANGES FROM THIS PLAN SHALL BE COORDINATED WITH

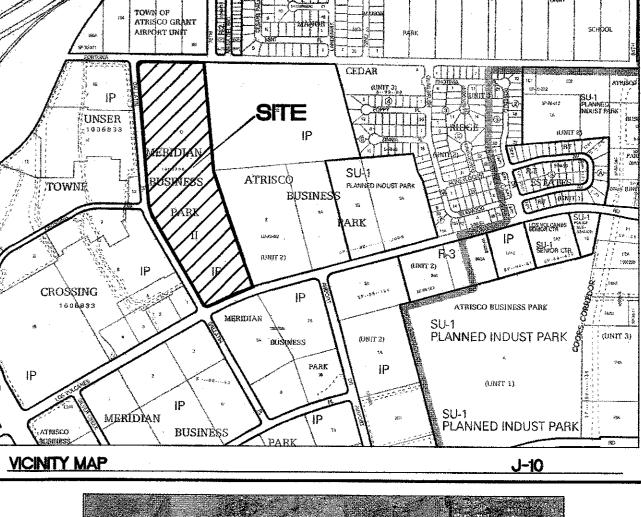

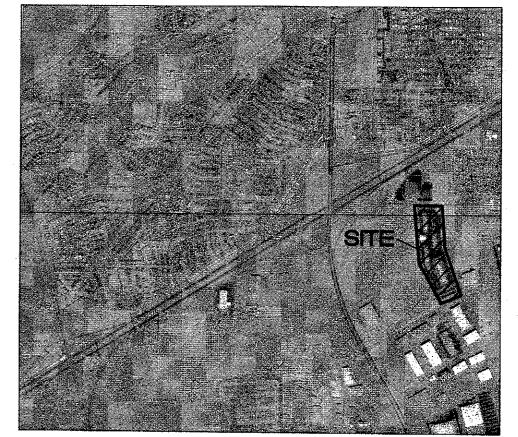


FIRM MAP 35001C0328J




(IN FEET) 1 inch = 50 ft.

2019025

7601 LOS VOLCANES RD NW DRAWN BY SEAL ALBUQUERQUE, NM 87121 pm DATE GRADING PLAN 8-22-19 UNIT A DRAWING 2019025-GR SHEET # TIERRA WEST, LLC 5571 MIDWAY PARK PL NE ALBUQUERQUE, NEW MEXICO 87109 (505) 858-3100 www.tierrawestllc.com RONALD R. BOHANNAN P.E. #7868 JOB

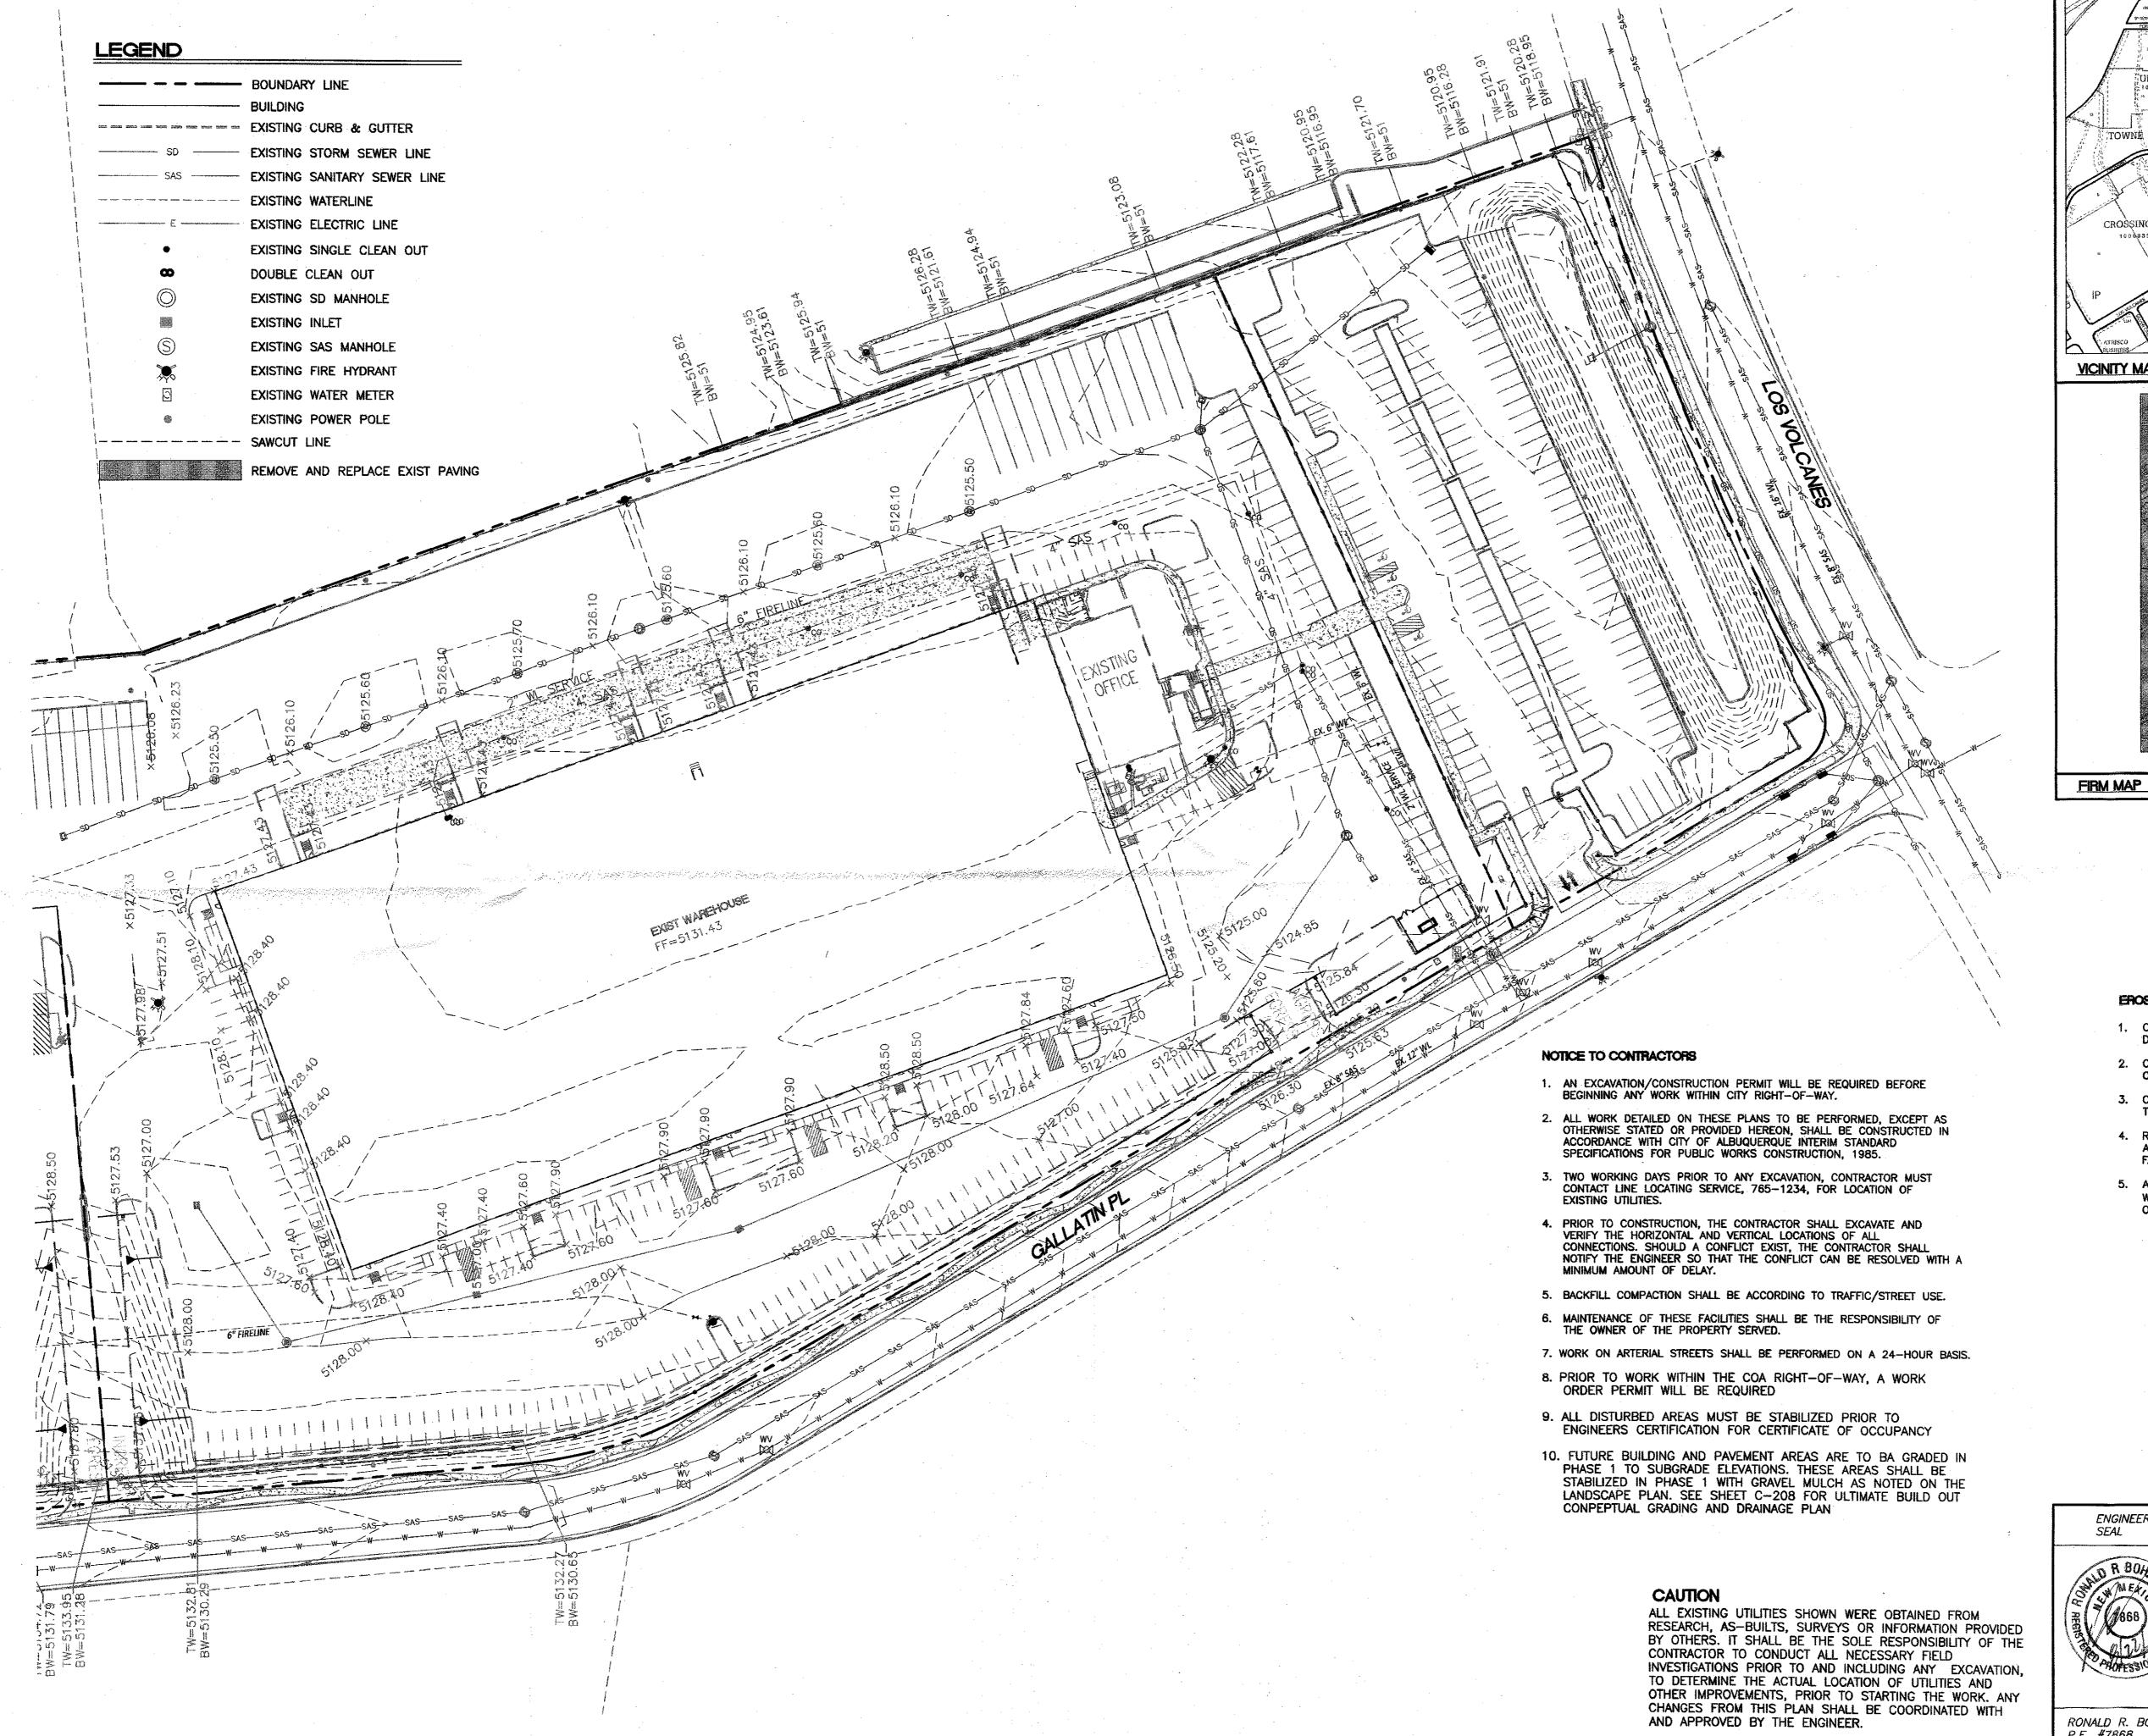

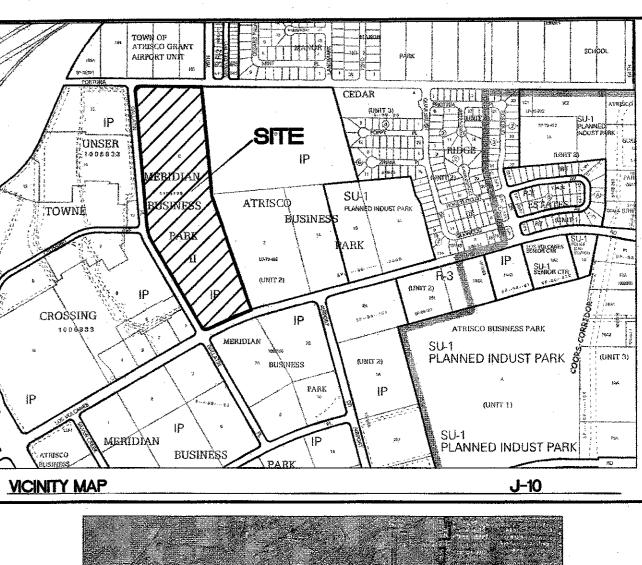



EROSION CONTROL NOTES:

- 1. CONTRACTOR IS RESPONSIBLE FOR OBTAINING A TOPSOIL DISTURBANCE PERMIT PRIOR TO BEGINNING WORK.
- 2. CONTRACTOR IS RESPONSIBLE FOR MAINTAINING RUN-OFF ON SITE DURING CONSTRUCTION.
- 3. CONTRACTOR IS RESPONSIBLE FOR CLEANING ALL SEDIMENT THAT GETS INTO EXISTING RIGHT-OF-WAY.
- 4. REPAIR OF DAMAGED FACILITIES AND CLEANUP OF SEDIMENT ACCUMULATIONS ON ADJACENT PROPERTIES AND IN PUBLIC FACILITIES IS THE RESPONSIBILITY OF THE CONTRACTOR.
- 5. ALL EXPOSED EARTH SURFACES MUST BE PROTECTED FROM WIND AND WATER EROSION PRIOR TO FINAL (CITY) ACCEPTANCE OF ANY PROJECT.




35001C0328J

2019025

(IN FEET) 1 inch = 50 ft.

ENGINEER'S 7601 LOS VOLCANES RD NW DRAWN BY ALBUQUERQUE, NM 87121 pm DATE 8-22-19 **GRADING PLAN** DRAWING UNIT A 2019025-GR SHEET # TIERRA WEST, LLC GR-2 5571 MIDWAY PARK PL NE ALBUQUERQUE, NEW MEXICO 87109 (505) 858-3100 RONALD R. BOHANNAN P.E. **#**7868 JOB # www.tierrawestllc.com

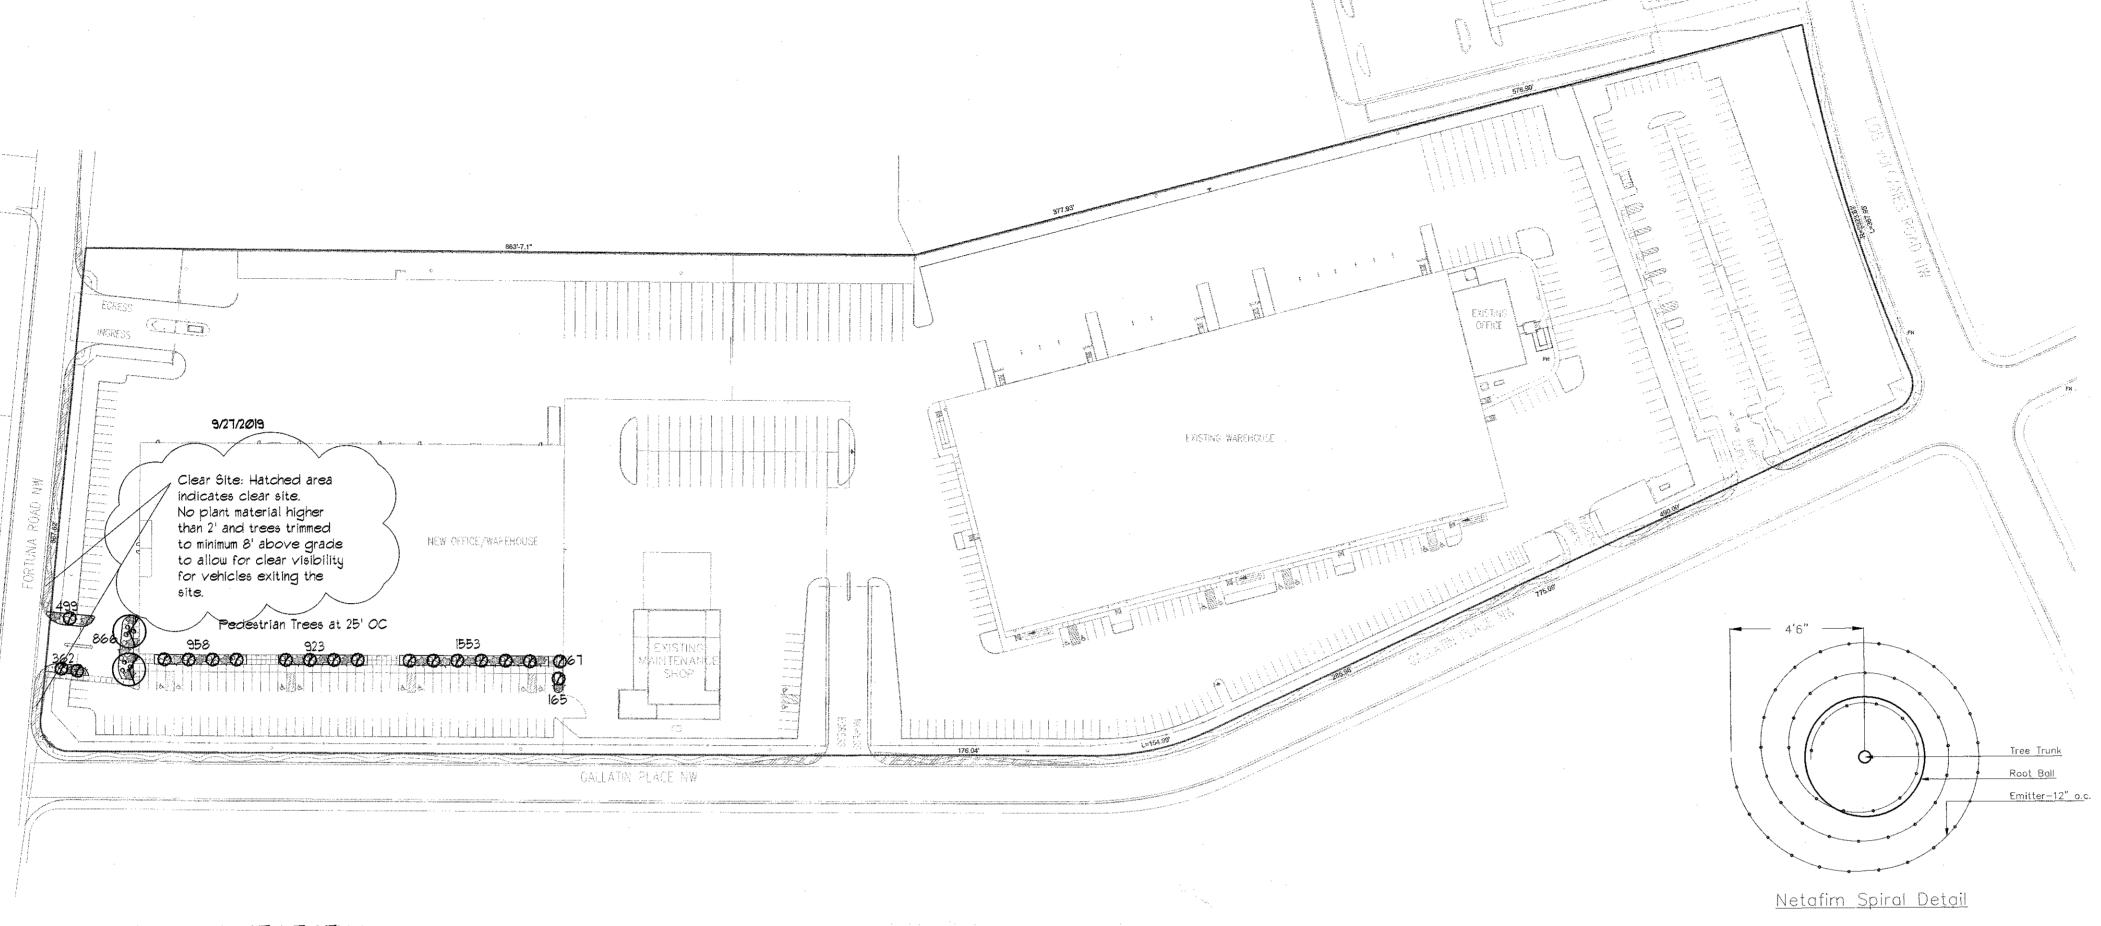

15 Gal. Oklahoma Redbud 15x12 144 2448 M Cercis reniformis Chinese Pistache 40x35 1225 2450 Ms 2" cal Pistacia chinensis India Hawthorne 3x5 25 150 M Raphiolepis indica Wintergreen Barberry 5x6 36 1224 M Buffalo Juniper 1x12, 144 3312 M Juniperus sabina Buffalo Landscape Gravel / Filter Fabric 3/4" Crushed Grey

9584 Total Live Plants 4686 Total Ground Cover

LANDSCAPE CALCULATIONS

TOTAL LOT AREA (6f)		976759	
TOTAL BUILDING AREA (SF)		-248422	
TOTAL LOT AREA (61)		728337	
LANDSCAPE REQUIREMENT	_	× .15	
 TOTAL LANDSCAPE REQUIRED (15%)	109250	
TOTAL EXISTING LANDSCAPE		167370	Į
TOTAL EXISTING GROUNDCOVER	2		
1854 Shrubs @ 32.2 sf each.	35%	59689	<
TOTAL EXISTING VEGETATIVE CO	OVER		
286 Trees @ 604 sf each	106%	173011	
TOTAL NEW LANDSCAPE		6331	
TOTAL NEW GROUNDCOVER			
See Landscape Legend	40%	4686	
TOTAL NEW VEGETATIVE COVER			
See Landscape Legend	109%	9584	
TOTAL LANDSCAPE		173701	
TOTAL GROUNDCOVER			
See Landscape Legend	36%	64375	<
TOTAL VEGETATIVE COVER			4
See Landscape Legend	107%	182595	

7/29/2019

LANDSCAPE NOTES: Landscape maintenance shall be the responsibility of the Property Owner. The Property Owner shall maintain street trees in a living, healthy, and attractive condition.

It is the intent of this plan to comply with the City Of Albuquerque Water Conservation Landscaping and Water Waste Ordinance planting restriction approach. Approval of this plan does not constitute or imply exemption from water waste provisions of the Water Conservation Landscaping and Water Waste Ordinance.

Water management is the sole responsibility of the Property Owner. All landscaping will be in conformance with the City of Albuquerque Zoning Code, Street Tree Ordinance, Pollen Ordinance, and Water Conservation Landscaping and Water Waste Ordinance. In general, water conservative, environmentally sound landscape principles will be followed in design and installation.

Landscape Gravel over Filter Fabric to a minimum depth of 3" shall be placed in all landscape areas which are not designated to receive native seed.

IRRIGATION NOTES:

Irrigation shall be a complete underground system with Trees to receive | Netafim spiral (50' length) with 3 loops at a final radius of 4.5' from tree trunk, pinned in place. Netafim shall have emitters 12" o.c. with a flow of 6 gph. Shrubs to receive (2) 1.0 GPH Drip Emitters. Drip and Bubbler systems to be tied to 1/2" polypipe with flush caps at each end. Trees and shrubs shall be on separate valves.


Run time per each shrub drip valve will be approximately 15 minutes per day. Tree drip valve shall run 1.5 hours, 3 times per week Run time will be adjusted according to the season.


Point of connection for irrigation system is unknown at current time and will be coordinated in the field. Irrigation will be operated by automatic controller.


Location of controller to be field determined and power source for controller to be provided by others.

Irrigation maintenance shall be the responsibility of the Property

Water and Power source shall be the responsibility of the Developer/Builder.

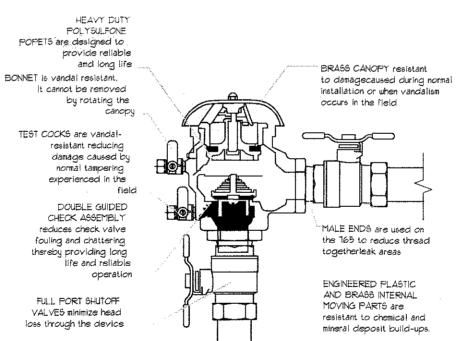

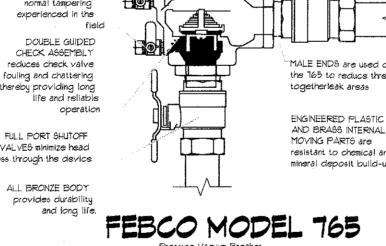

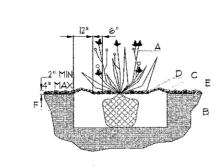


SHRUB PLANTING DETAIL

GENERAL NOTES:


1. THE OUTSIDE DIAMETER OF THE WATER RETENTION BASIN SHALL BE TWICE THE DIAMETER OF THE SHRUB PLANTING. CONSTRUCTION NOTES:

A. SHRUB. A. SHRUB.
B. BACKFILL WITH EXISTING SOIL.
C. EARTH BERM AROUND WATER RETENTION BASIN.
D. 3" DEPTH OF GRAVEL MULCH.
E. FINISH GRADE. F. UNDISTURBED SOIL.

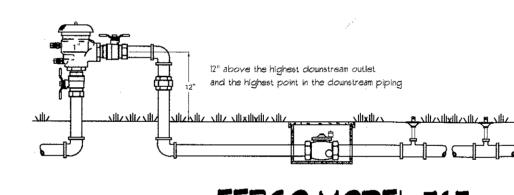

Outside Installation

Pressure Vacuum Breaker

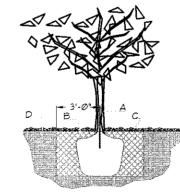

TREE PLANTING DETAIL

GENERAL NOTES:


1. ROOTBALL SHALL BE PLACED ON UNDISTURBED SOIL TO PREVENT TREE FROM SETTLING.

2. TOP OF ROOTCOLLAR INDICATED LEVEL AT WHICH TREE 2. TOP OF ROOTCOLLAR INDICATED LEVEL AT WHICH TREE WAS GROWN AND DUG! THIS REPRESENTS THE LEVEL AT WHICH THE TREE SHOULD BE INSTALLED! THAT LEVEL MAY BE EXCEEDED BY ONLY A ONE INCH LAYER OF SOIL.

3. PRIOR TO BACKFILLING TREE, ALL WIRE, ROPE AND SYNTHETIC MATERIALS SHALL BE REMOVED FROM THE TREE AND THE PLANTING PIT.

4. PRIOR TO BACKFILLING ALL BURLAP SHALL BE CUT AWAY EXCEPT FROM BOTTOM OF THE ROOTBALL. CONSTRUCTION NOTES:

A. TREE B. BACKFILL WITH EXISTING SOIL.
C. 3" DEPTH OF GRAVEL MULCH.
D. UNDISTRUBED SOIL.

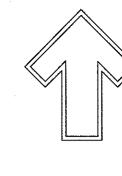

Landscape Architect

Sept 27, 2019


Fed Ex, Unit A 1601 Los Volcanes, Albuquerque, NM




₹ SHEET *

LS-101

SCALE: |" = 100'-0"

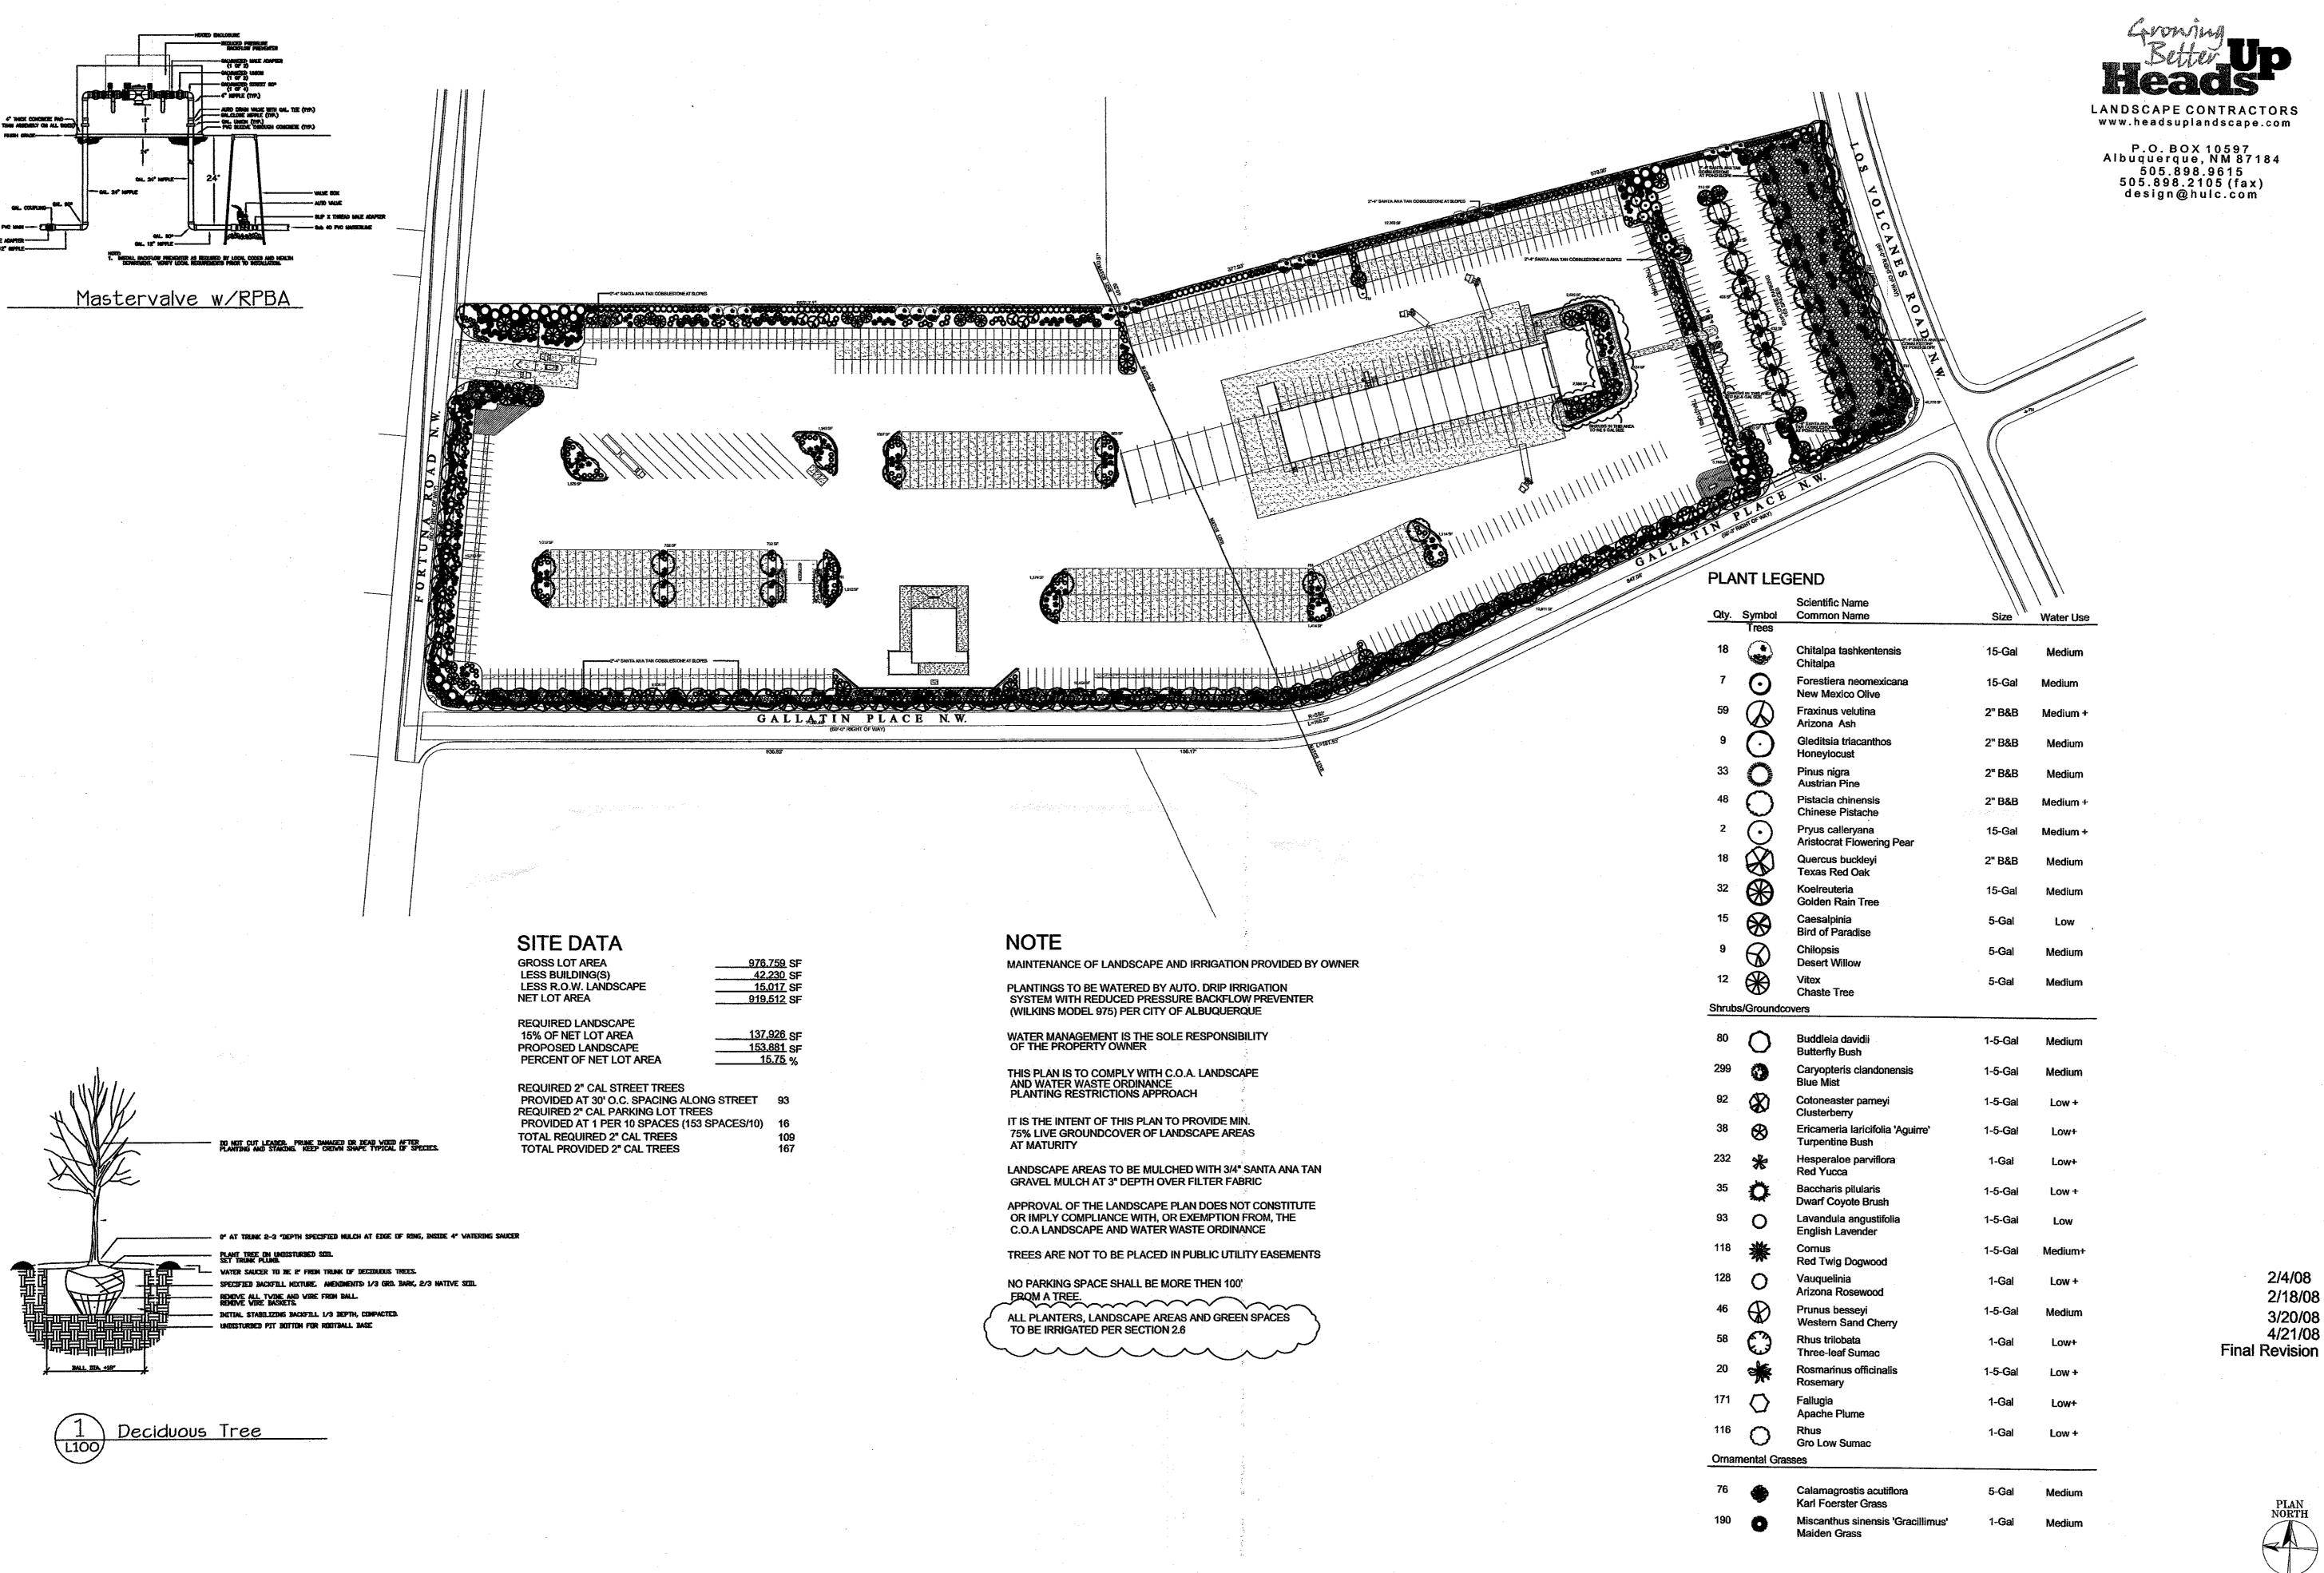

SCALE" 1" = 100'-0"

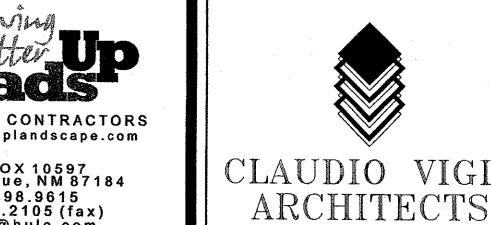


1801 Rio Grande Boulevard, N.W Albuquerque, New Mexico Phone: (505) 842-1113 Fax: (505) 842-1330

OWNERSHIP OF INSTRUMENTS OF SERVICE
All design concepts, details, specifications, plans, computer files, field data, notes and other documents and instruments prepared by Ambysis P.C., D.B.A. Claudio Vigil Architects, as instruments of service shall remain the property of Ambysis P.C., Claudio Vigil Architects, P.C. Architect shall retain all common law, statutory and other reserved rights, including the copyright thereto.

CONSULTANTS

PROFESSIONAL SEAL

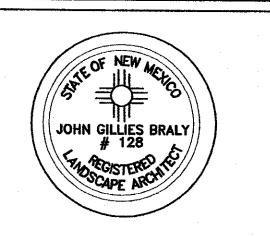

Feelight **

FEDEX FREIGHT ALBUQUERQUE

SERVICE AND DISTRIBUTION CENTER

7601 LOS VOLCANES ROAD, N.W. ALBUQUERQUE, NEW MEXICO


	1/18/08	-
•	12/11/07	-
-	11/20/07	_
_	10/22/07	-
-	10/1/07	
-	9/24/07	_
MARK	DATE	DESCRIPTION

	See 1
PROJECT NUMBER	: 07305
DRAWING FILE:	FEDEX-ATRISCO-C-102-ESP
DRAWN BY:	JC
CHECK BY:	MS
COPYRIGHT: CI	AUDIO VIGIL ARCHITECTS 2007
DATE:	APRIL 21, 2008

LANDSCAPE SITE PLAN

MASTER LANDSCAPE PLANK

sheet number L-100

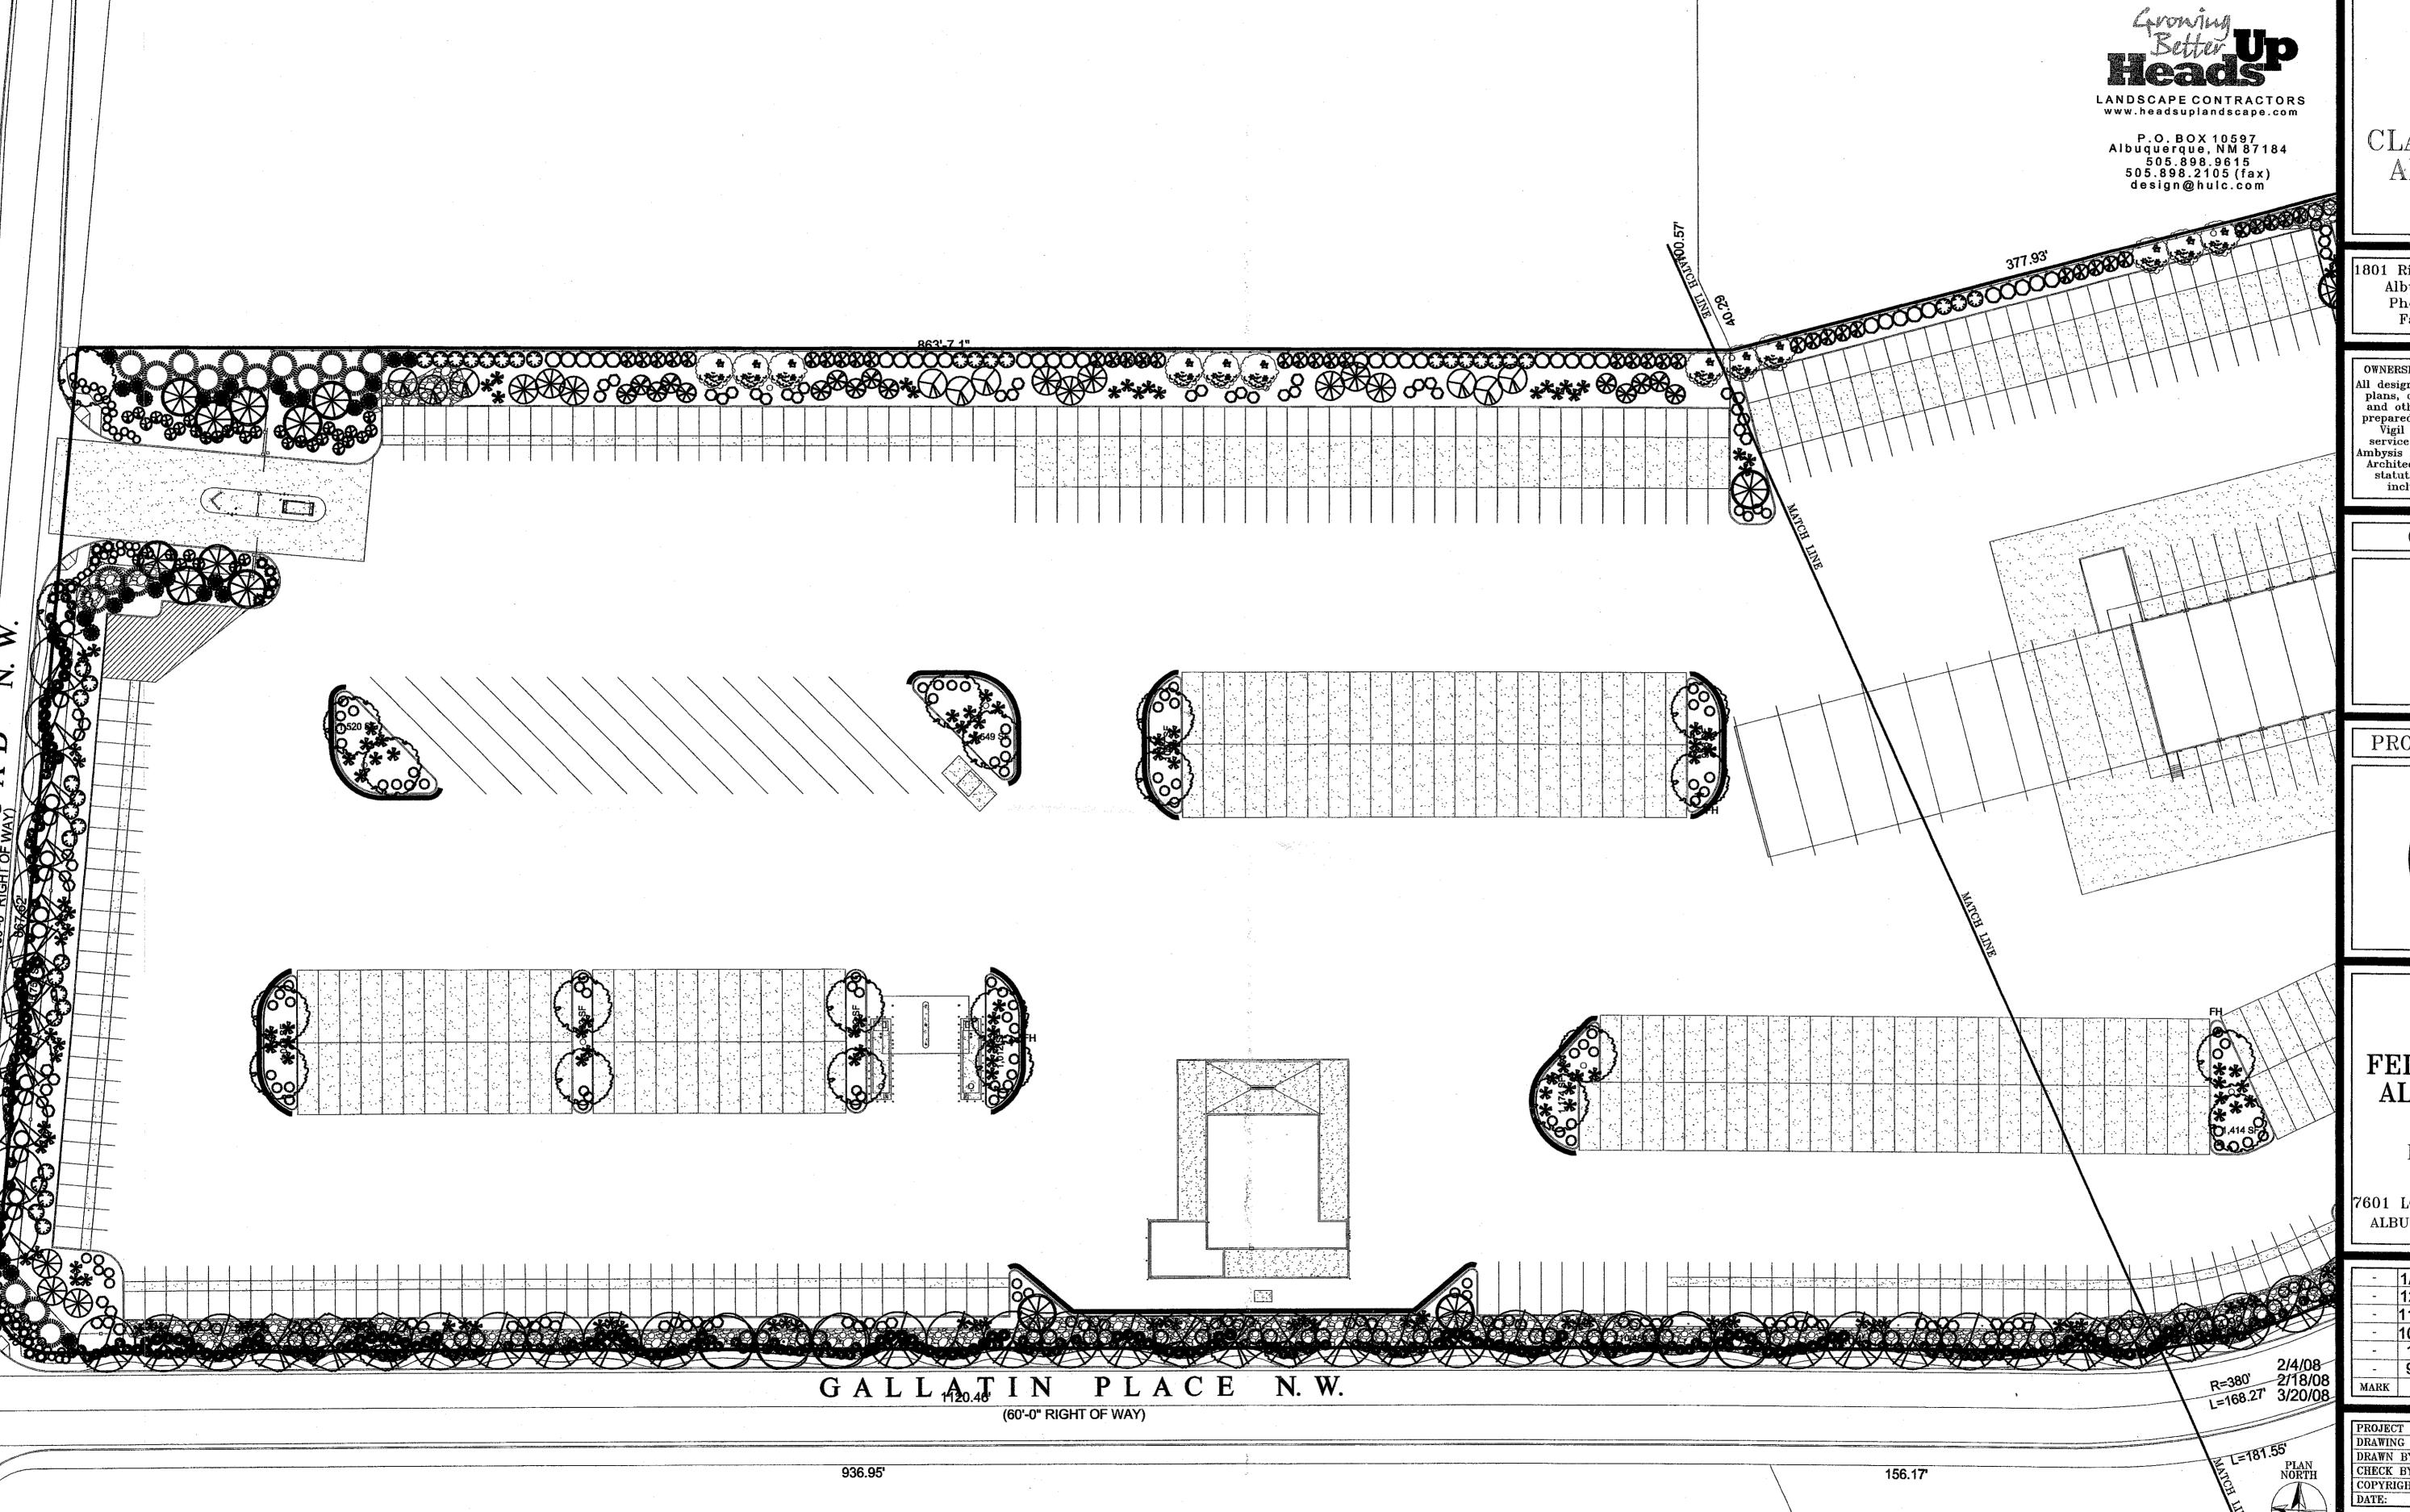




CLAUDIO VIGIL ARCHITECTS

1801 Rio Grande Boulevard, N.W Albuquerque, New Mexico Phone: (505) 842-1113 Fax: (505) 842-1330

OWNERSHIP OF INSTRUMENTS OF SERVICE
All design concepts, details, specifications, plans, computer files, field data, notes and other documents and instruments prepared by Ambysis P.C., D.B.A. Claudio Vigil Architects, as instruments of service shall remain the property of Ambysis P.C., Claudio Vigil Architects, P.C. Architect shall retain all common law, statutory and other reserved rights, including the copyright thereto.

CONSULTANTS

PROFESSIONAL SEAL

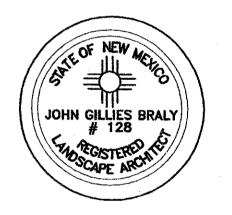

FedEX (*)
Freight

FEDEX FREIGHT ALBUQUERQUE

SERVICE AND DISTRIBUTION CENTER

7601 LOS VOLCANES ROAD, N.W ALBUQUERQUE, NEW MEXICO


		1.00
-	1/18/08	-
-	12/1-1/07	4
-	11/20/07	4
-	10/22/07	-
-	10/1/07	-
-	9/24/07	
MARK	DATE	DESCRIPTION

PROJECT NUMBER: 07305
DRAWING FILE: FEDEX-ATRISCO-C-102-ESP
DRAWN BY: JC
CHECK BY: MS
COPYRIGHT: CLAUDIO VIGIL ARCHITECTS 2007
DATE: MARCH 20, 2008

SHEET TITLE
ENLARGED
PARTIAL
LANDSCAPE PLAN

ENLARGED PARTIAL LANDSCAPE PLAN

SHEET NUMBER
L-101

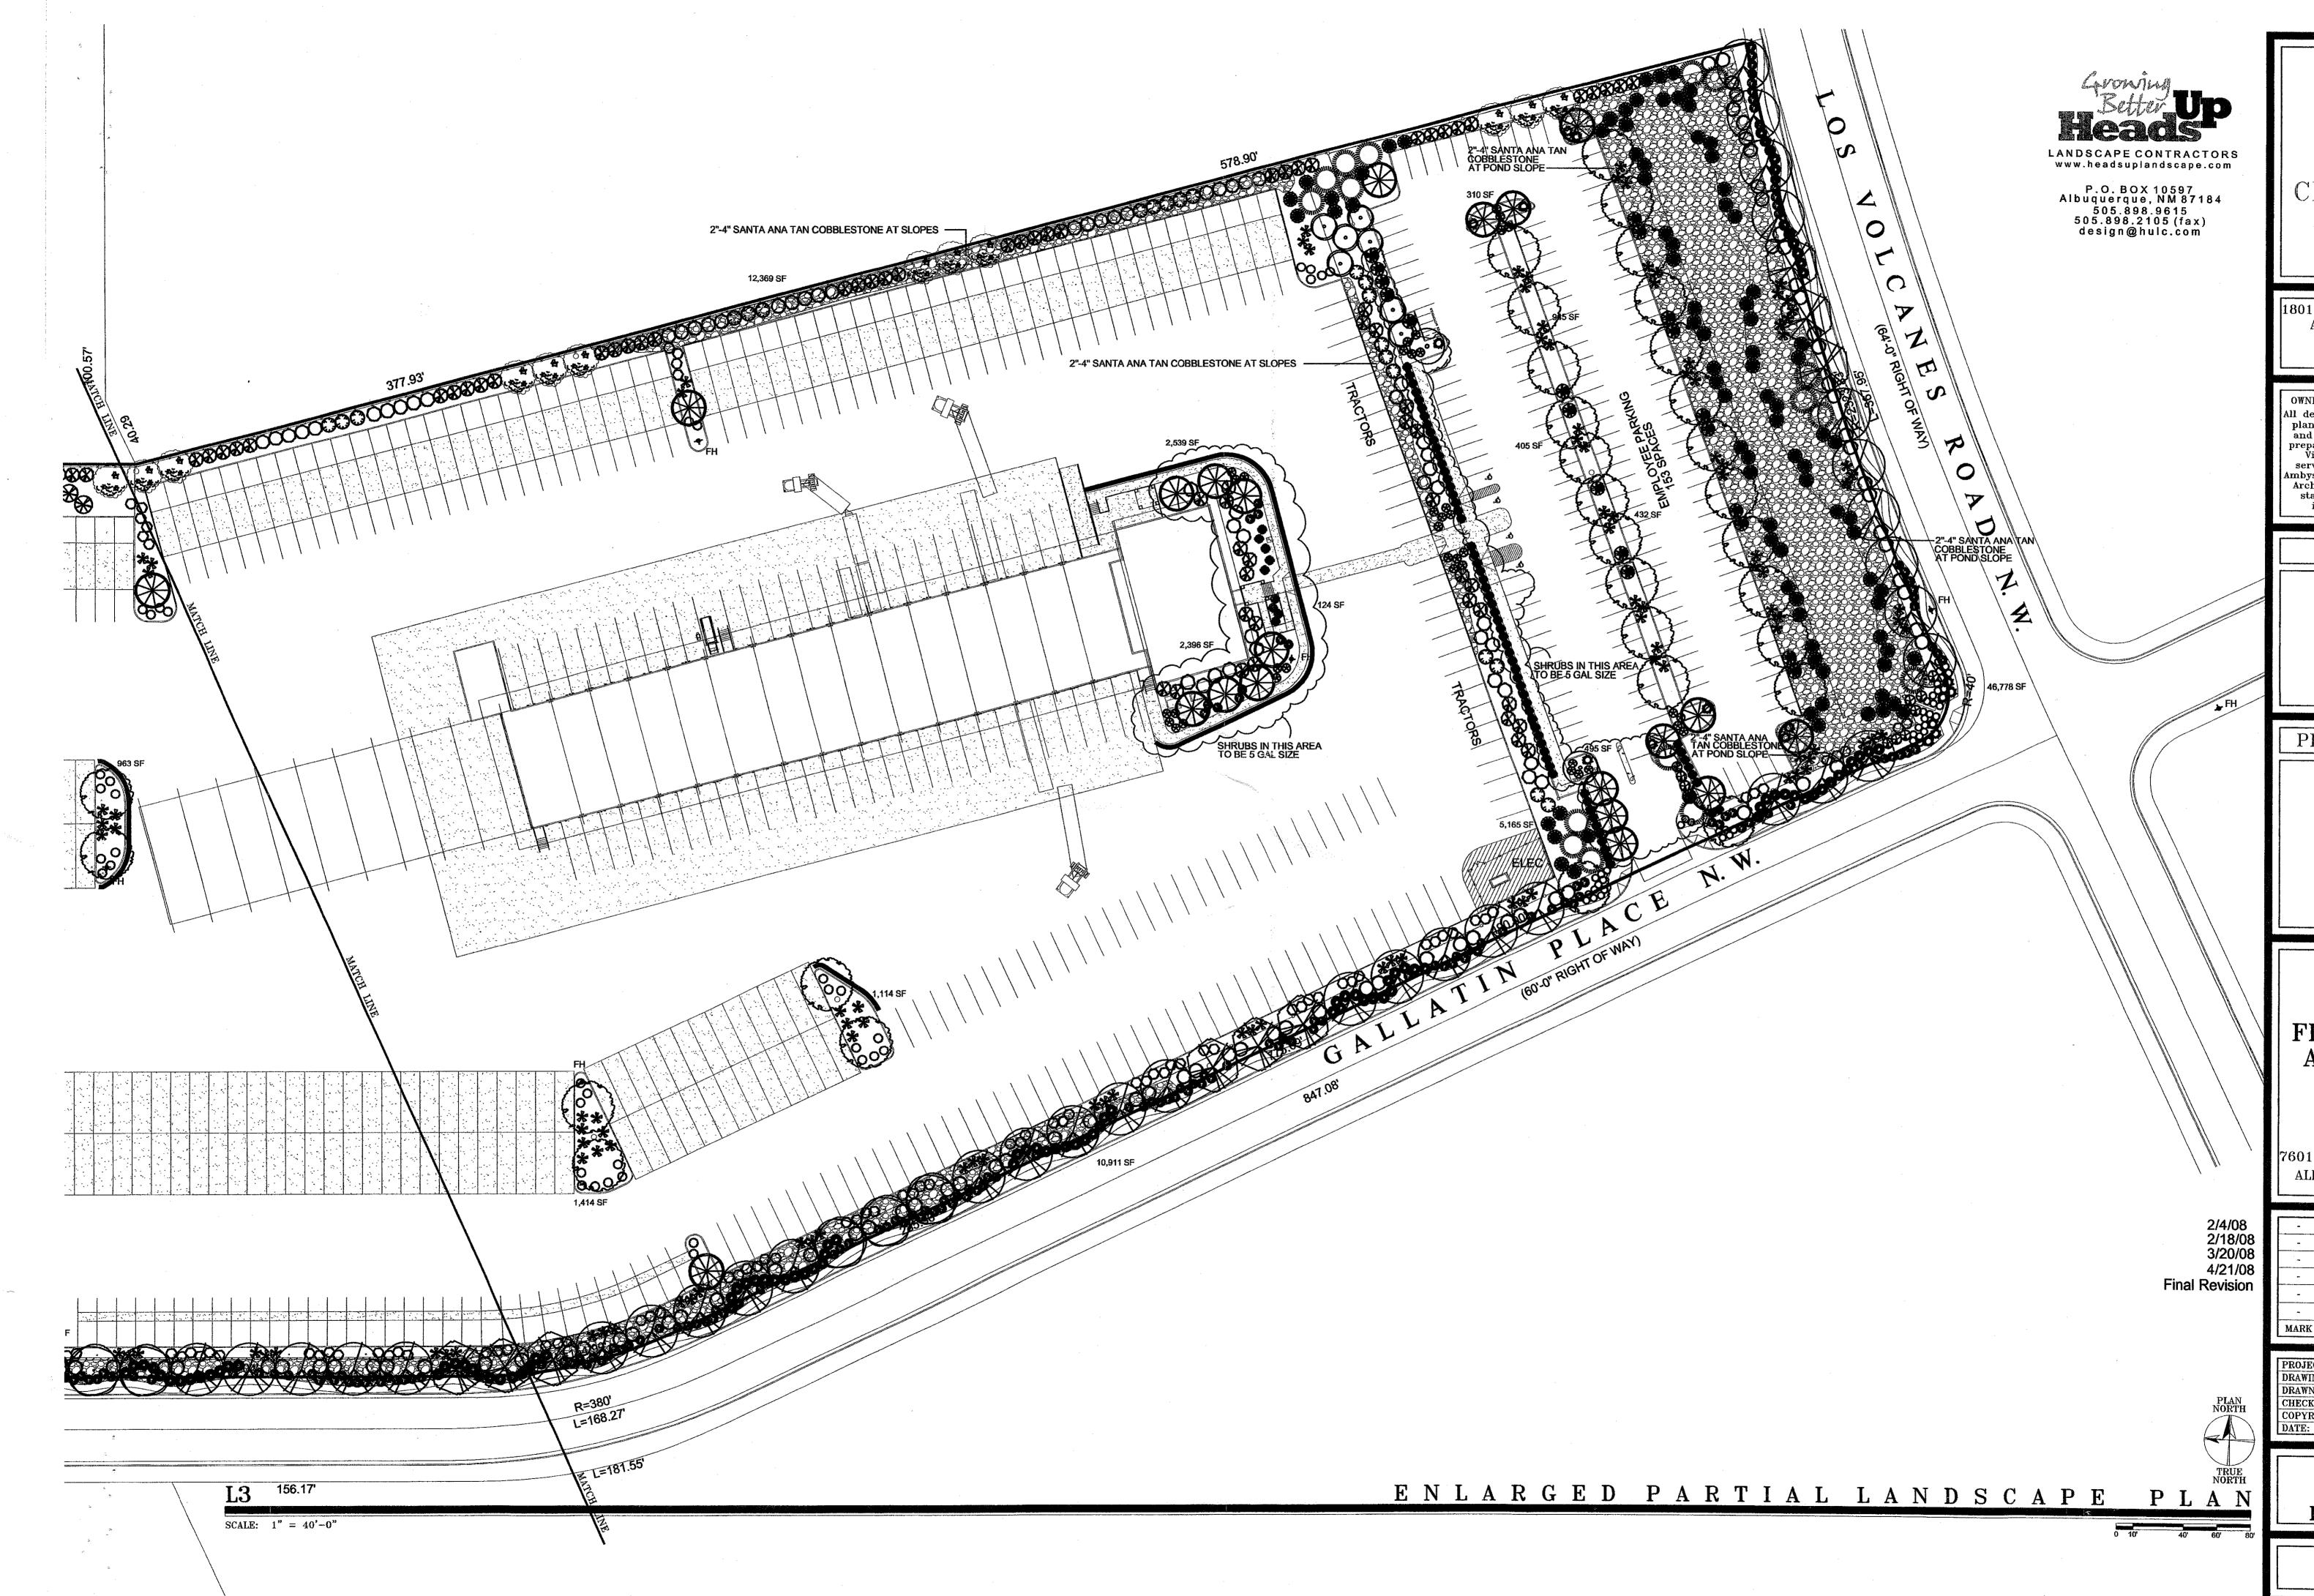



1801 Rio Grande Boulevard, N.W. Albuquerque, New Mexico Phone: (505) 842-1113 Fax: (505) 842-1330

OWNERSHIP OF INSTRUMENTS OF SERVICE
All design concepts, details, specifications, plans, computer files, field data, notes and other documents and instruments prepared by Ambysis P.C., D.B.A. Claudio Vigil Architects, as instruments of service shall remain the property of Ambysis P.C., Claudio Vigil Architects, P.C. Architect shall retain all common law, statutory and other reserved rights, including the copyright thereto.

CONSULTANTS

PROFESSIONAL SEAL



FedEX Freight

FEDEX FREIGHT ALBUQUERQUE

SERVICE AND DISTRIBUTION CENTER

7601 LOS VOLCANES ROAD, N.W. ALBUQUERQUE, NEW MEXICO

_	1/18/08	-
-	12/11/07	-
-	11/20/07	_
-	10/22/07	м,
-	10/1/07	-
-	9/24/07	-
MARK	DATE	DESCRIPTION

PROJECT NUMI	BER: 07305
DRAWING FILE:	FEDEX-ATRISCO-C-102-ESP
DRAWN BY:	JC
CHECK BY:	MS
COPYRIGHT:	CLAUDIO VIGIL ARCHITECTS 2007
DATE:	APRIL 21, 2008

ENLARGED
PARTIAL
LANDSCAPE PLAN

sheet number L-102