PROJECT: Venice Volleyball Facility

Application for Site Plan Administrative – DFT

**Response to Staff Comments** 

PR-2019-001959 SI-2024-00040

Property Location: 5801 Venice Ave. NE

Albuquerque, New Mexico 87113

Legal Description: Tract A-1 Block 3 Unit B North Albuquerque Acres, 1.75± AC

Owner: Verde Management, LLC

Agent: Studio 151, LLC

714 Roma Ave. NW

Albuquerque, NM 87102

505-220-0595

Below are the comments in orange that our office received for the DFT Application No.: SI-2024-00040 for Project: PR-2019-001959. Our response and/or clarification to these comments are immediately below in black, and are indicated as necessary in the revised drawings attached to this response.

#### **Transportation Development**

- 1. Transportation has an approved Conceptual TCL dated 10/13/2023. No objection.
- 2. As a reminder, a full TCL will be required before Building Permit.

### **Hydrology**

- 1. Hydrology has an approved Conceptual Grading & Drainage Plan (B18D022) with engineer's stamp 10/05/2023.
- 2. Hydrology has no objection to the Site Plan for Building Permit.
- 3. Comment Prior to submitting for Building Permit, a licensed New Mexico civil engineer will need to submit a Grading & Drainage Plan to Hydrology for review & approval if one of these conditions is met. (500 cy of grading, 1,000 sf of proposed building, or 10,000 sf of proposed paving).

### **Planning**

 Any Drainage Ponds must meet Standard Specification 1013 or better. See Drainage Ponds Slope Stabilization and Seeding Requirements.pdf (cabq.gov) All Drainage Ponds will meet tor exceed Standard Specification 1013, see note the on DFT Landscaping Plan. This note will also be included in Final Grading and Drainage Plans for Building Permit.

Provide proof of sign posting on property.

Photographs of Sign Posting have been provided and are currently included in the DFT packet for this project.

• Improvements appear to be compliant with section 7 of the DPM Table 7.2.29 and the IL, regarding Sidewalk width requirements and its landscape buffer.

Understood.

• An IL-Infrastructure List was included in the submittal. After approval of the IL, an IIA-Infrastructure Improvements Agreement with financial guarantee will be required prior to final sign-off of the Site Plan.

An IIA-Infrastructure Improvement Agreement will be signed after approval of the IL.

- The project and application numbers must be added to the Site Plan first page and IL.
  The Project and Application Numbers have been added to the Site Plan as well as IL.
- For any revisions and supplemental submittals: All final Plan sheets must be sealed and signed by a design professional licensed in the State of New Mexico. The final Landscape Plan must be sealed and signed by a Landscape Architect licensed in the State of New Mexico.

All final Plan sheets have been sealed and signed by associated design professional.

• Signage is per IDO section 5-12 and CPO-10. Some signage information was included within the submittal, was the intent to create signage standards or will that be addressed at building permit.

All Monumental and Building Mounted Signage will follow standards as set forth by the IDO and will be addressed at building permit.

• Clarify addressing and front of lot. City and County addresses do not match. Design and dimensional standard requirement could be affected if address/front is on Venice because of setback requirements. Defer to Code Enforcement.

The site address has been corrected to 5801 Venice Ave. by Jeff Palmer and Cassandra Murillo. Included in this packet is the Address Verification Letter from Ms. Murillo's office.

■ Because the property is within CPO-10, facades do not appear to be meeting requirements for Building Design. Provide additional detail within the elevation pages and a comment response memo that demonstrates how façade design is meeting the requirements of 3-4-K-4-b and 5-11-E.


The Eastern Façade has been revised to have a continuous band of color, material and elevation wrap from the primary South elevation facing Venice to the East elevation facing Pan American. This Elevation has been reviewed and approved by Jeff Palmer with Code Enforcement. Please see revised SDP5.1.

#### **Parks and Recreation**

**No Comments** 

### **Albuquerque Bernalillo County Water Utility Authority**

- 1. Availability Statement 231005 provides conditions for service. The Statement includes a requirement to extend a public sanitary sewer line. However, if the site can access the sanitary sewer service without the extension and show that is the case, this can be discussed further.
  - a. Currently the site plan shows a connection that is not perpendicular to right-of-way or the existing sanitary sewer line. As noted, the provided requirements are to extend infrastructure which will provide a perpendicular connection and not what has been proposed on this site plan. Shown below are two potential options; 1 (left) is to come perpendicular into the manhole and make bends within the property but a pond appears to be in conflict, 2 (right) extend per the Availability Statement and take service from the new line.

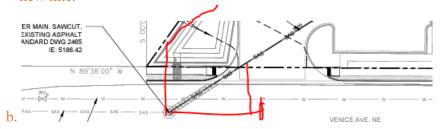

### **Comment:** (Provide written response explaining how comments were addressed)

The Site Utility Plan has been revised to follow Option 1, indicated above. A reduced ponding requirement has allowed for ponding in that area be revised and allow for this sanitary sewer location and path without any conflict with the ponding area. This is shown in the Revised Site Utility Plan included in this response.

#### **Code Enforcement**

1. Please clarify correct address, as it is shown as 5801 Venice Ave NE in County records and on Site Plan, but 5801 Pan American Frwy NE on City Parcel in AGIS records. Contact City Address Assignment for corrections as needed in our system: Cassandra Murillo, Addressing, 505-924-3848, CMurillo@cabq.gov

Jeff Palmer and Cassandra Murillo have informed AGIS of this discrepancy and provided the included Address Verification Letter.

2. Property is zoned NR-LM and must meet Dimensional standards and setbacks of IDO5-1(E), Table 5-1-3. Based on the address of 5801 Venice Ave NW, the front of the lot would be along Venice Ave, as typical with the primary entrance from the street of address, as shown with your entry off of Venice. CE is reviewing with the Front designated along Venice Ave.

Dimensional Standards and Setbacks have been met.

3. Property is located within the North I-25 CPO-10 Overlay zone, Building Height sub-area 3, and must meet all applicable requirements in CPO-10.

The project meets all applicable requirements in CPO-10.

4. Show how you are meeting the CPO-10 Building Design façade requirements as per IDO 3-4(K)(4)(b) and IDO 5-11(E), as referred and required in CPO-10 for a property in the NR-LM zone. See excerpt below.

### 3-4(K)(4)(b) Building Design

All multi-family, mixed-use, and non-residential development shall comply with the standards in Subsection 14-16-5-11(E) (Mixed-use and Non-residential Zone Districts), with the following exceptions.

1. Notwithstanding the exclusion of the NR-LM and NR-GM zone districts in Subsection 14-16-5-11(E)

The Eastern Façade has been revised to have a continuous band of color, material and elevation wrap from the primary South elevation facing Venice to the East elevation facing Pan American. This Elevation has been reviewed and approved by Jeff Palmer with Code Enforcement. Please see revised SDP5.1.

Sincerely,

Tyson Parker, CEO

Studio 151, LLC

## CITY OF ALBUQUERQUE

#### **CODE ENFORCEMENT**

Plaza Del Sol Building, Suite 500 600 2<sup>nd</sup> Street NW Albuquerque, NM 87102 Tel: (505) 924-3850 Fax: (505) 924-3847



January 23, 2024

RE: Address Verification/ UPC 101806520428520113

To Whom It May Concern:

This letter is to serve as a notice of an address verification for Lot A1 Block 3 of the N. ABQ ACRES TR A UNIT B Subdivision, which has been issued situs address of: 5801 Venice Ave NE.

Please update your records to reflect the above addresses; however, if problems arise contact the City Address Verification Office at <a href="mailto:addressing@cabq.gov">addressing@cabq.gov</a>.

Sincerely,



Cassandra Murillo
Planning Research Coordinator
o 505.924.3848
e cmurillo@cabq.gov
cabq.gov/planning

Copy: County Assessor's Office/Gustavo Hernandez, US Postal Service-/Theresa Gonzales/Sylvia Vigil/Jaclyn Velasquez, Mid Region Council of Governments/Steve Montiel, Bureau of Election Office/Larry Romero, AGIS-Planning/ Catherine Bradley, Hydrology/Rudy Rael, PW/Water Meters/ Workgroup, PNM/Victoria Rodriguez, Gas Company of New Mexico, Comcast/Robert Martinez, CenturyLink/Michele Ramirez, Alarm Dispatch/Paul Buck, Emergency Communication Center/Erika Wilson

Current DRC				FIGURE 12			Date Submitted:		
Project Number	er:	<u> </u>				Date Sit	e Plan Approved:		
			INFRA	ASTRUCTURE LIST			ary Plat Approved		
				(Rev. 2-16-18)		Date Prelim	inary Plat Expires		
				EXHIBIT "A"			DFT Project No.		_
				IMPROVEMENTS AGREE		DF	T Application No.	:SI-20	24-00040
			DEVELOPMENT FACILITATION TE	• •	FRASTRUCTURE LIST				
	-			Volleyball Facility					
			PROPOSED NAME OF PLA	AT AND/OR SITE DEVELO	PMENT PLAN				
			Tract A-1, Block 3, North A  EXISTING LEGAL DESCR						
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		11'-10'	5' Sidewalk		Line	Property Line	<del></del>		
		11 10							
			New Beehive Inlet, 24" SD_	Venice Ave	West Property	308' West of West	1	1	1
			Connection & Rock Swale		Line	Property Line			
			New Domestic Water Service	Venice Ave	17'+/- West of l	Fact			
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		if the site	is located in a floodplain, then the finar	icial guarantee will not be r lights per City rquirements		is approved by	FEMA.			
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## PROJECT DATA

PROJECT DESCRIPTION New Indoor Volleyball Facility PROJECT Venice Volleyball Facility PROJECT ADDRESS 5801 Venice Ave NE Albuquerque, New Mexico 87113 Verde Management, LLC LEGAL DESCRIPTION Tract A-1 Block 3 Unit B North Albuquerque Acres, 1.75± AC

Development of new Indoor Volleyball Facility on undeveloped land located in Albuquerque,

ZONING NR-LM (Non-Residential, Light Manufacturing) + CPO-10 North I-25 overlay zone ADJACENT ZONING

## INDEX TO DRAWINGS

general 3 SDP1.1 SITE PLAN ADMINISTRATIVE DFT - SITE PLAN 2 SDP2.1 SITE PLAN ADMINISTRATIVE DFT - LANDSCAPE PLAN 3 SDP3.1 SITE PLAN ADMINISTRATIVE DFT - GRADING PLAN 4 SDP3.2 SITE PLAN ADMINISTRATIVE DFT - DRAINAGE PLAN 5 SDP4.1 SITE PLAN ADMINISTRATIVE DFT - UTILITY PLAN 6 SDP5.1 SITE PLAN ADMINISTRATIVE DFT - BUILDING ELEVATIONS

+ SITE DETAILS ☐ SDP5.2 SITE PLAN ADMINISTRATIVE DFT - SUN AND SHADE ANALYSIS

8 SDP5.3 SITE PLAN ADMINISTRATIVE DFT - SUN AND SHADE

9 F1 SITE PLAN ADMINISTRATIVE DFT - FIRE DEPARTMENT FIRE 1 SITE PLAN

☐ **ES101** SITE PLAN ADMINISTRATIVE DFT - SITE LIGHTING PLAN

# CODE ANALYSIS

International Building Code (IBC) 2015 (NMCBC 2015) Uniform Mechanical Code (UMC) 2105 (NMMC 2015) National Electrical Code (NEC) 2017 (NMEC 2017) International Energy Conservation Code (IECC) 2018 (NMECC 2018) International Existing Building Code (IEBC) 2015 (NMEBC 2015)

CONSTRUCTION TYPE & ALLOWABLE FLOOR AREA + HEIGHT CONSTRUCTION TYPE (IBC Table 503):

Allowable Height Above Grade (IBC Table 504.3): 40'-0" Provided: 29'-6"± (PEAK AT VOLLEYBALL COURT AREA) 15'-0"± (OFFICE / RESTROOM / STORAGE AREA)

Allowable Stories (IBC Table 504.4): 2 stories above grade Actual: 1 story

Allowable Area: 24,000 SQ. FT. 16,640 SQ. FT.:

VB - Fully Sprinklered

OCCUPANCY GROUP (IBC Table 3-A): A-3 (Gymnasium - Other Indoor Entertainment)

OCCUPANT LOAD: Volleyball Courts: 32 players per court x 4 Courts = 128 occupant(s) Seating Area: 73 Seats = 73 occupant(s) 1,350 sf/100 = 14 occupant(s)

TOTAL OCCUPANTS = 215

Number of Exits

Required Exit Width

Required Number (IBC Table 1018.1): 2 Provided Number of Exits: 3 (2 @ 36" + 1 @ 6'-0")

Provided Number: 3Required Width (IBC Table 1005.1): # Occupants x 0.2 (See Occupant Load Table.) = 43 inches

Minimum Width Provided: 120 inches total between three exits (Refer to IBC 1005.5 for distribution of minimum width).

EXIT ACCESS TRAVEL DISTANCE Allowed (IBC Table 1015.1): A Occupancy w/ sprinkler system 250 feet

FIRE EXTINGUISHING SYSTEM

Fire Extinguishers: 2-A 10B. Max travel distance 75 feet.

FIRE-RESISTANCE RATING REQUIREMENTS FOR BUILDING **ELEMENTS:** All Elements: 0 Hours (IBC Table 601)

**IECC 2018** 

Table C402.1.3 **Building Envelope requirements - opaque assemblies** 

Roof - Metal Building: R-19 + R-11 LS (Liner System) (Thermal Spacer Block is required when R-value method is used) (U value method: U-0.035) Walls - Metal Building: R-13 + R-13ci (U value method: U-0.052)

Table C402.4 **Building Envelope requirements** - fenestration U factor: Fixed: 0.38

Operable:0.45 Entrance Doors: 0.77 PF<.0.2: N - 0.48, SEW - 0.36

## CITY APPROVALS

PR-2019-001959 PROJECT NUMBER: SI-2024-00040 Application Number:

Is an Infrastructure List required?  $(\chi)$  Yes () No If yes, then a set of approved DRC plans with a work order is required for any construction within Public Right-of-Way or for construction of public improvements. **DFT SITE DEVELOPMENT PLAN APPROVAL** 

Traffic Engineering, Transportation Division	Date
ABCWUA	Date
Parks and Recreation Department	Date
Hydrology	Date
Code Enforcement	Date
* Environmental Health Department (conditional)	Date
Solid Waste Management	Date
Planning Department	 Date

### PARKING REQUIREMENTS

REQUIRED SPACES = 72 (Office Use 5 + Other Indoor Entertainment 67) Office Use (3.5 Spaces/1,000 sq. ft.): (1,350 sq. ft./1000)3.5 = 4.75 spaces Other Indoor Entertainment (1 space per 3 persons design capacity): Volleyball Courts : 128 occupants Seating Area : 73 occupants

Total Occupants : 201 occupants @ 3 person per deign capacity = 67 spaces

PROVIDED SPACES = 72 spaces 4 - HC 4 - MOTORCYCLE 1 - ELECTRIC SPACE

PLUMBING FIXTURES

PLUMBING FIXTURE REQUIREMENTS: IBC Table 2902.1

GROUP	WATER C 215 OCC (108 male + 1	UPANTS	LAVATORIES MALE/FEMALE (108 male + 108 female)	DRINKING FOUNTAINS	SERVICE SINK		
В	1 PER 125 M 1 PER 65 F		1 PER 200	1 PER 500	1		
REQUIRED							
	1 2		1 M / 1 F	1	1		
PROVIDED							
	2 + 1 URINAL	3	2 M / 2 F	1	1		

# FIRE SYSTEM NOTES

- BUILDING WILL HAVE AN AUTOMATIC SPRINKLER SYSTEM WITH A SUPERVISED FIRE ALARM SYSTEM PER IBC 903.2.1.3 (A3 AREA EXCEEDS 12,000 SF) AND IBC 907
- B. FIRE ALARM CONTRACTOR SHALL SUBMIT SHOP DRAWINGS FOR REVIEW AND APPROVAL.

## LANDSCAPE AREA

REQUIRED LANDSCAPE AREA = 15% OF TOTAL AREA LESS BUILDING AREA (.15 \* (76,480± sf - 16,680± SF)) = 8,972 sf landscape area

PROVIDED =  $17,003 \pm sf$ 

## **GENERAL NOTES**

SPECIFICATIONS.

- A. SEE LANDSCAPE PLAN FOR COMPLIANCE WITH CITY OF
- ALBUQUERQUE LANDSCAPING GUIDELINES. B. SEE ELECTRICAL SITE PLAN FOR PARKING LOT LIGHT FIXTURE
- C. FIRE LANE TO BE PAINTED RED CURBS WITH WHITE STENCIL "FIRE LANE NO PARKING" - TYPICAL.
- D. ALL REQUIRED PUBLIC INFRASTRUCTURE SHALL BE FINANCIALLY
- GUARANTEED. E. LANDSCAPING, SIGNAGE, WALLS, FENCES, TREED, AND
- SHRUBBERY BETWEEN THREE (3') AND EIGHT FEET (8') TALL (AS MEASURED FROM THE GUTTER PAN) ARE NOT ALLOWED WITHIN THE CLEAR SIGHT TRIANGLE.

# SYMBOLS LEGEND

GRAVEL DRIVE. DRIVE ENGINEERED TO MEET OR EXCEED FIRE MARSHALL OFFICE REQUIREMENT OF SUPPORTING 75,000 POUNDS OR MORE.

LANDSCAPE AREA, SEE LANDSCAPE PLAN

CONCRETE PAVED ACCESSIBLE PARKING AREA

TREE, SEE LANDSCAPE PLAN

SHRUB, SEE LANDSCAPE PLAN

 PARKING LOT POLE, SEE SITE LIGHTING PLAN, ES101

STUDIO 151, LLC

P.O.BOX 923

CORRALES, NEW MEXICO

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5 0 5 . 2 4 2 . 7 6 2 7

SARA RAIN STEWART

01.23.2024

NO. 4868

PROJECT NO: 2023-VW 1.23.2024 DATE: SET NO: XXXXDRAWN BY:  $\times \times$ 

SITE PLAN ADMINISTRATIVE DFT - SITE PLAN

CHECKED BY:

SDP1.1

PAD TO REMAIN

SCREENING

TRIANGLE

(A1) LANDSCAPE PLAN

SCALE: 1"=20'-0"

STUDIO 151, LLC

P.O.BOX 923 CORRALES, NEW MEXICO 8 7 0 4 8 5 0 5 . 2 2 0 . 0 5 9 5 5 0 5 . 2 4 2 . 7 6 2 7




PROJECT NO: 2023-VW 10.10.2023 DATE: 23070 SET NO: KΑ DRAWN BY:

BV

CHECKED BY:

plandcollab.com 505 268 2266

SDP2.1

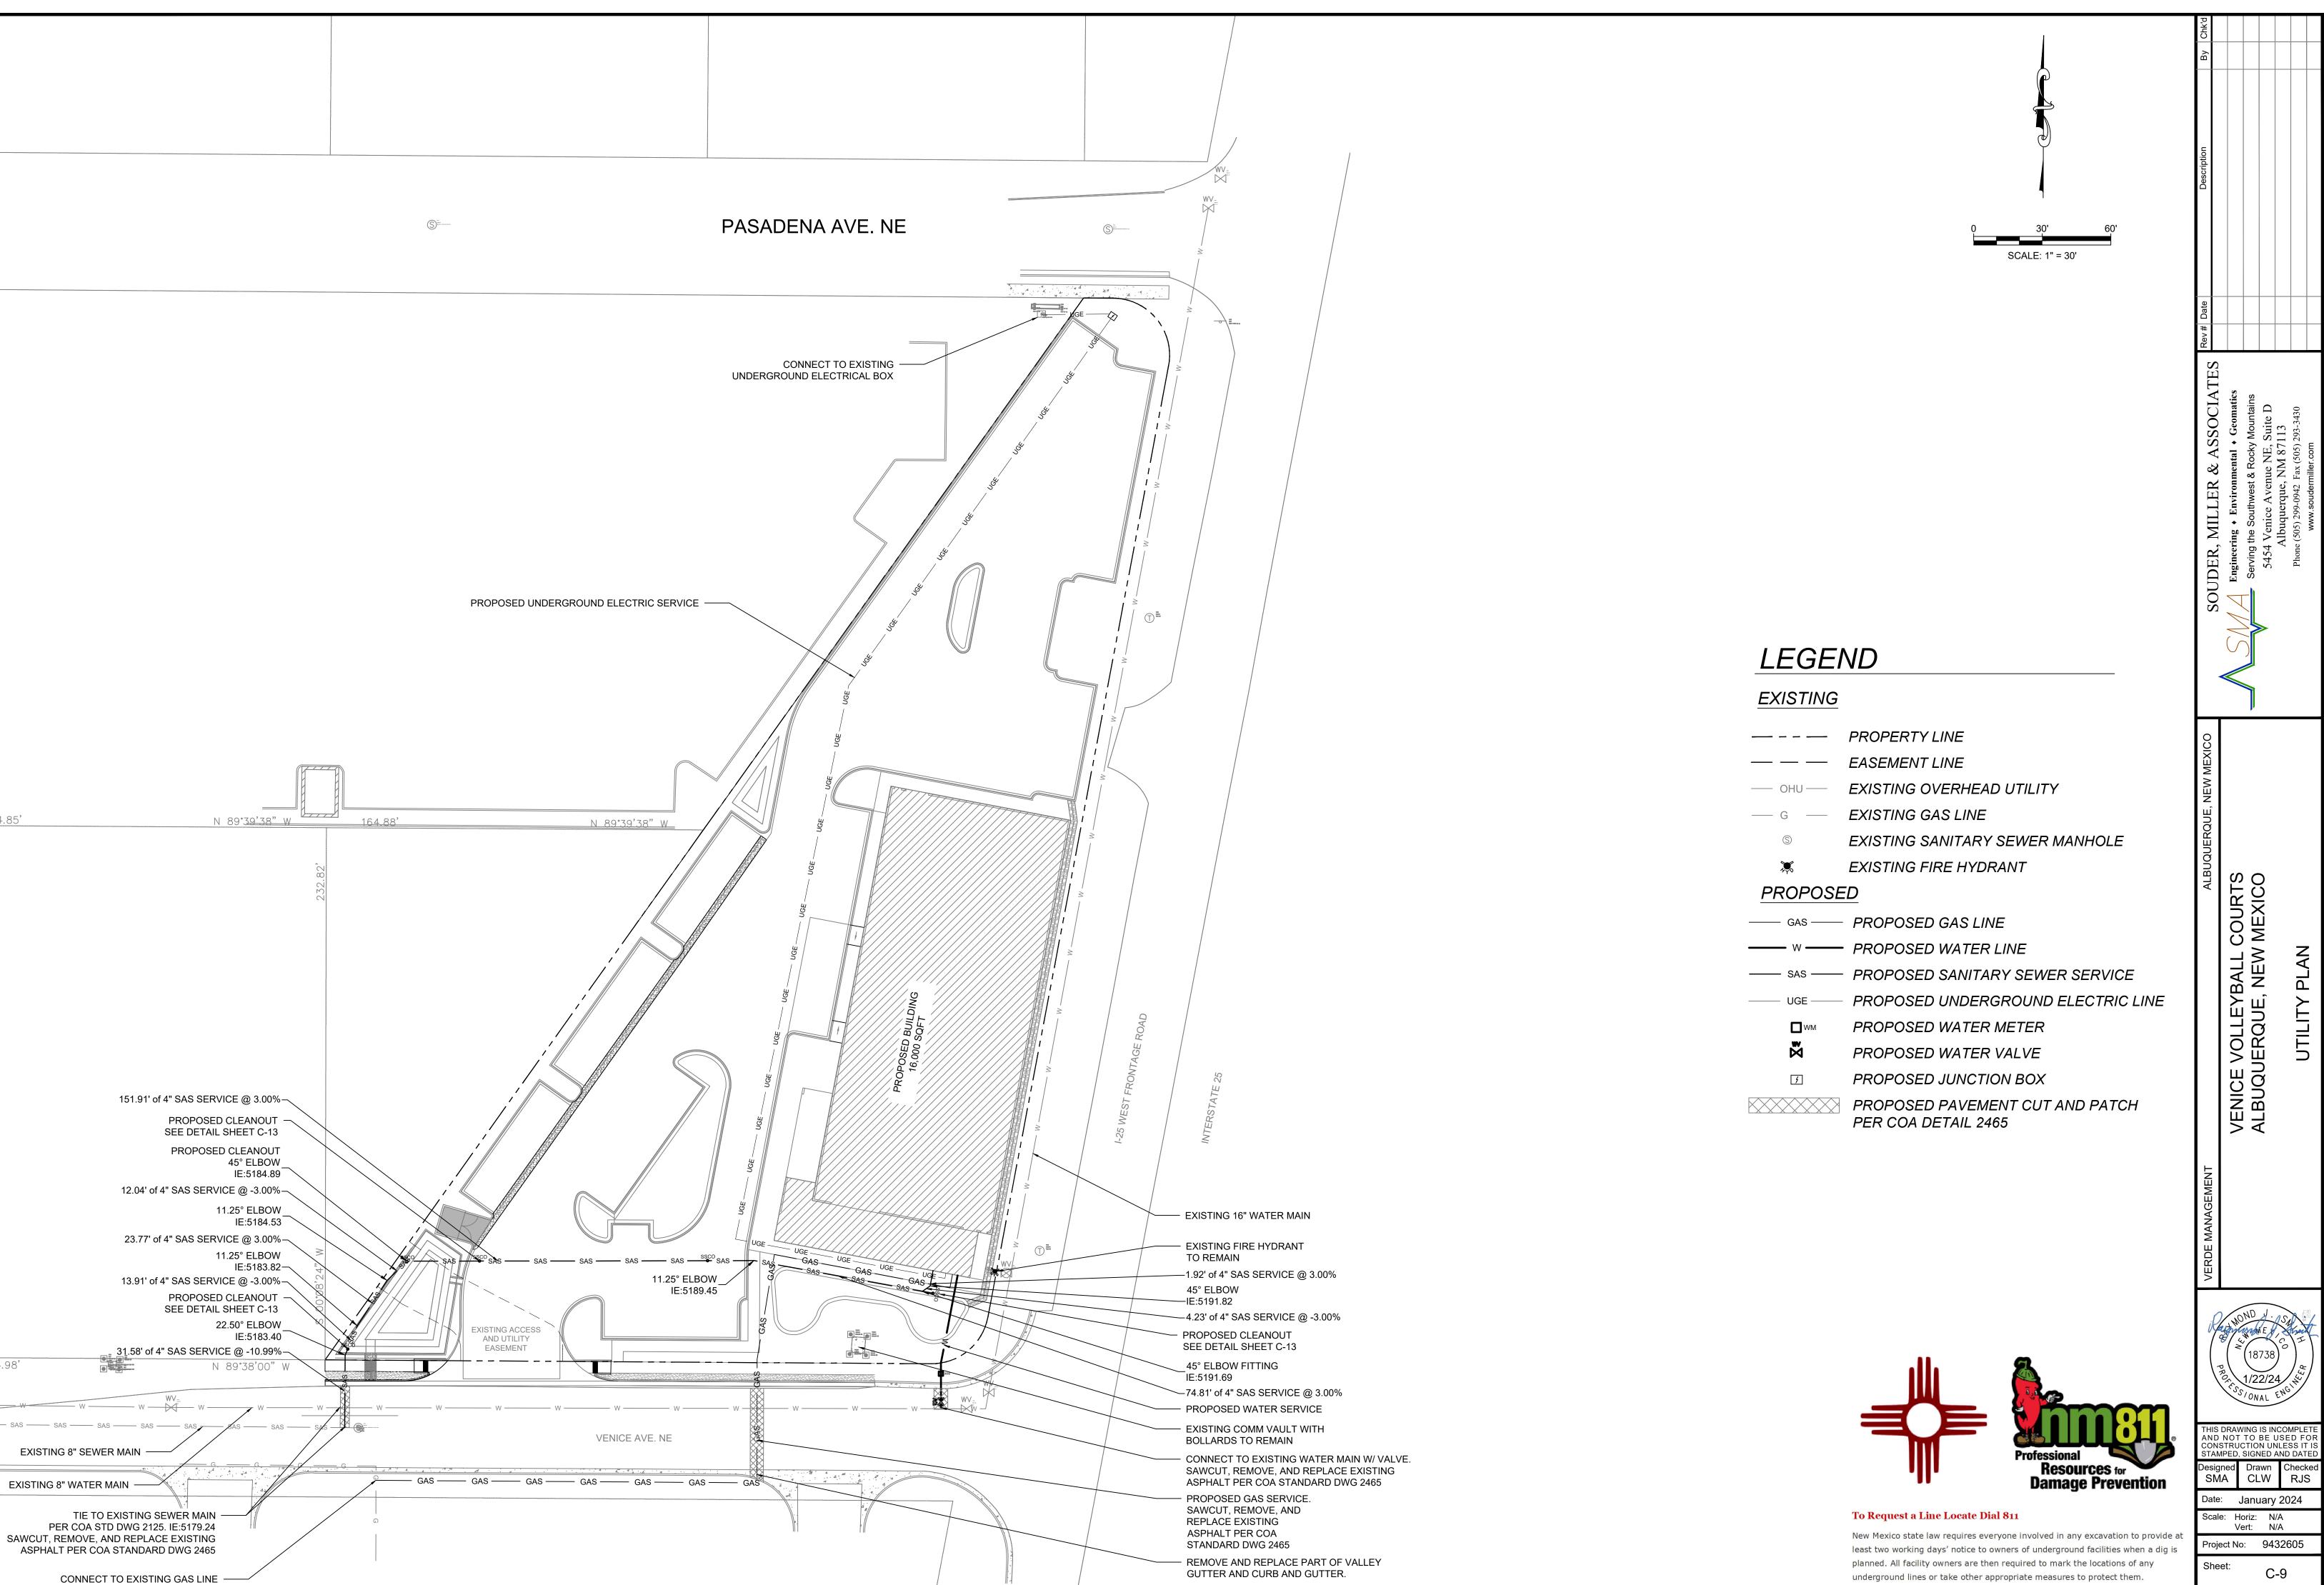

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P:\9-Studio 151 Venice Volleyball Courts (9432605)\CAD\Civil\Planset\UTILITIES.dwg 1/22/2024 10:13 AM CZW

STUDIO 151, LLC

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PROJECT NO: 2023-VW 1.23.2024 DATE: SET NO: XXXX

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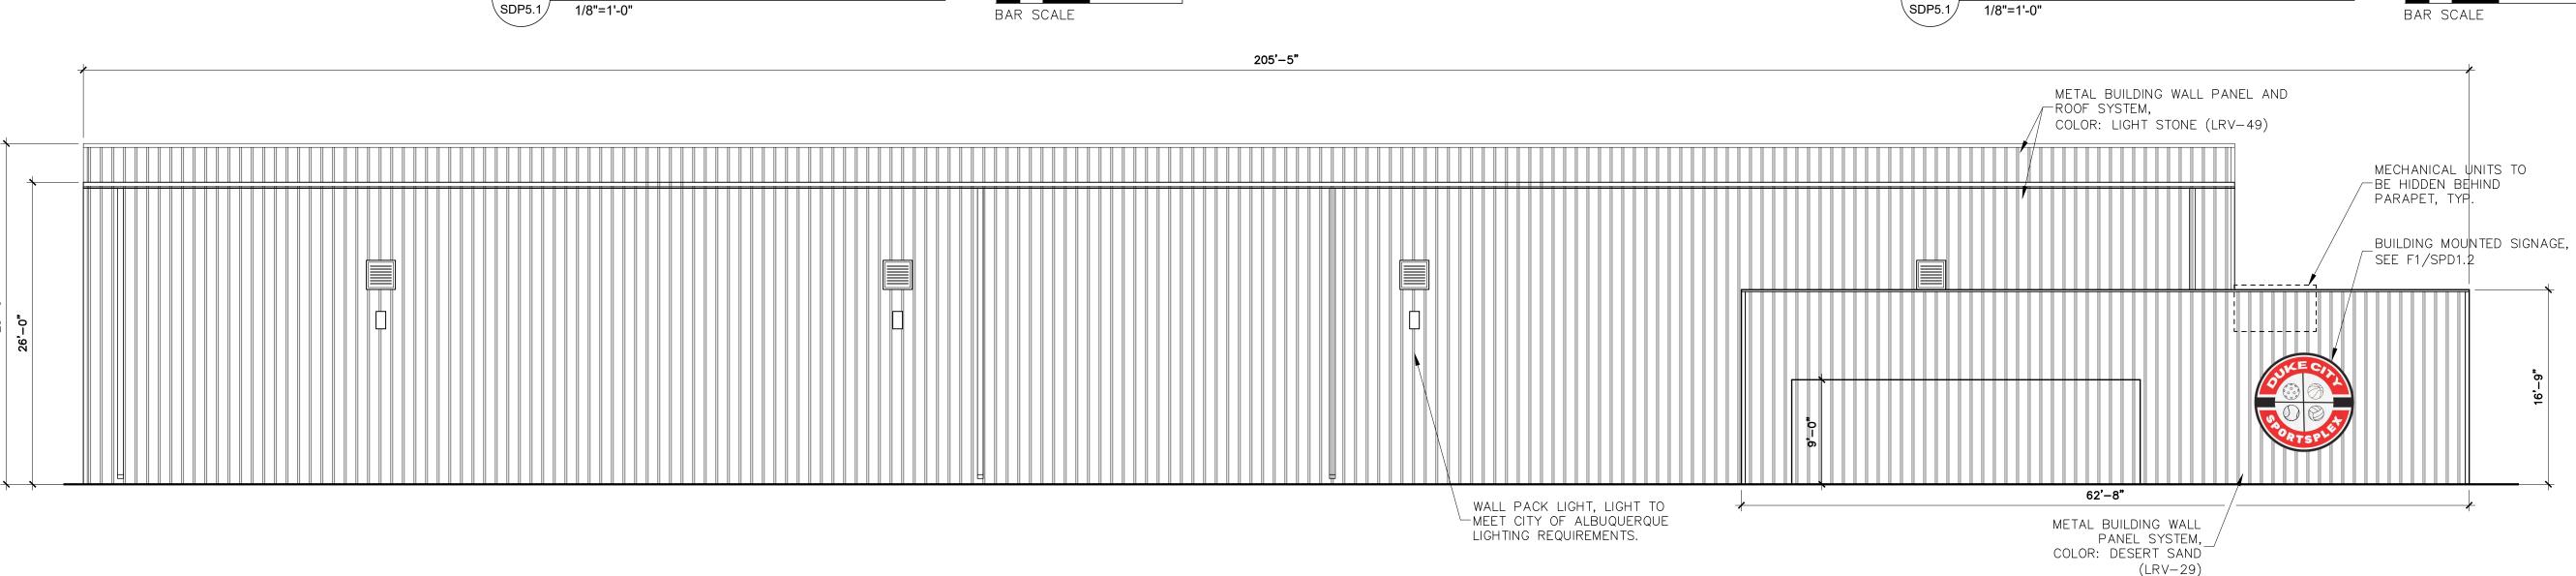
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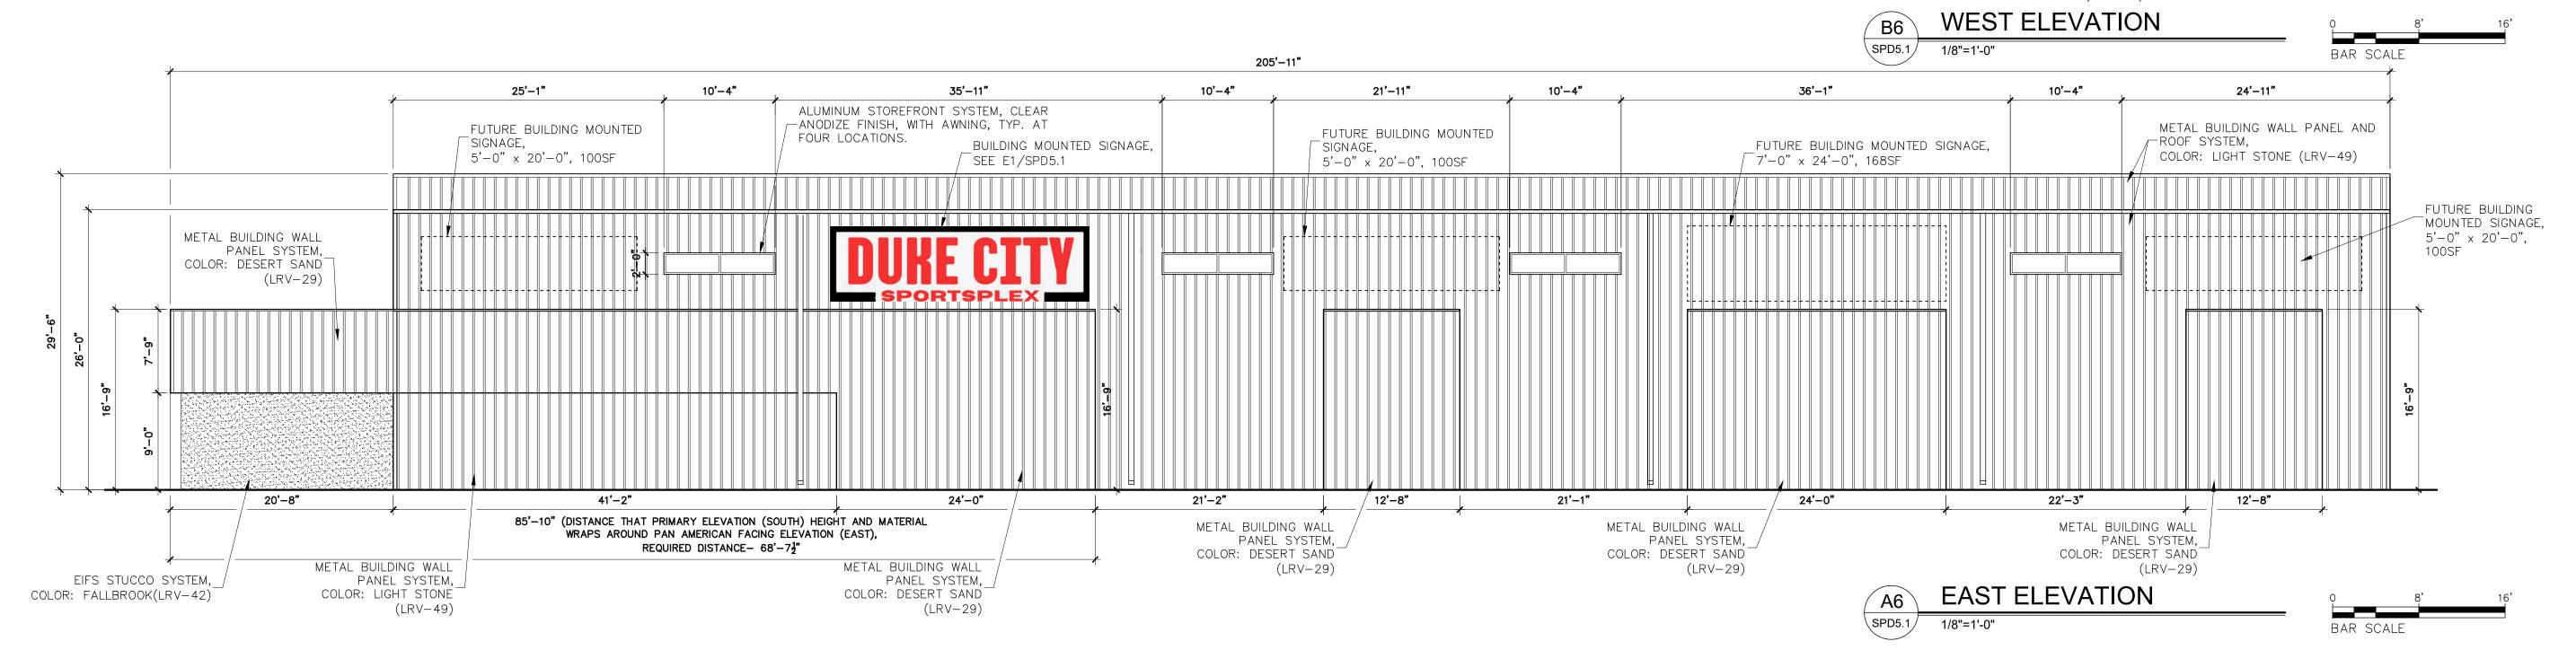
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- UTILITY PLAN

SDP4.1





STUDIO 151, LLC

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-\_-CMU ENCLOSURE

REFUSE ENCLOSURE PLAN 1/4"=1'-0"

( ) ~

6"ø CONCRETE

FILLED STEEL — BOLLARD, TYP.

 $(\circ)$ 

### **GENERAL NOTES**

- A. SEE LANDSCAPE PLAN FOR COMPLIANCE WITH CITY OF ALBUQUERQUE LANDSCAPING GUIDELINES.
- B. SEE ELECTRICAL SITE PLAN FOR PARKING LOT LIGHT FIXTURE
- SPECIFICATIONS. C. FIRE LANE TO BE PAINTED RED CURBS WITH WHITE STENCIL "FIRE
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- GUARANTEED. E. LANDSCAPING, SIGNAGE, WALLS, FENCES, TREED, AND
- SHRUBBERY BETWEEN THREE (3') AND EIGHT FEET (8') TALL (AS MEASURED FROM THE GUTTER PAN) ARE NOT ALLOWED WITHIN THE CLEAR SIGHT TRIANGLE.

### **IDO DEVELOPMENT STANDARDS**

14-16-3-4(K) NORTH 1-25 - CPO-10

3-4(K)(4)(b) Building Design

All multi-family, mixed-use, and non-residential development shall comply with the standards in Subsection 14-16-5-11(E) (Mixed-use and Non-residential Zone Districts), with the

following exceptions. 1. Notwithstanding the exclusion of the NR-LM and NR-GM zone districts in Subsection 14-16-5-11(E) (Mixed-use and Non-residential Zone Districts), development in these zone

districts shall meet the standards in that Subsection. 2. Primary building façades that face a public street shall wrap around the building at a distance of 1/3 the depth of the building or 20 feet, whichever is greater.

REQUIRED - 68'-7<del>1</del>" PROVIDED - 85'-10"

3. Building materials and colors shall have a light reflective value (LVR) ranging from 20 percent to 50 percent. PROVIDED - Metal Panels (49% & 29%)

Stucco (42%) 4. Reflective or mirrored glass is prohibited.

3-4(K)(4)c On -premises Signs Freestanding Signs a. pole mounted signs are prohibited

> square feet with a maximum height of 13 feet, including a base with a height of at least 2 feet and no more than 3 feet. c. 1 additional monument sign is allowed on a

b. Monument signs shall be a maximum size of 50

premises of 5 or more acres.

14-16-5-11(E)(2) FACADE DESIGN

5-11(E)(2)(a) GENERAL 2. EACH STREET-FACING FACADE SHALL INCORPORATE AT LEAST 2 OF THE FOLLOWING FEATURES (ILLUSTRATED BELOW)

ALONG AT LEAST 30 PERCENT OF THE LENGTH OF THE FACADE, DISTRIBUTED ALONG THE FACADE SO THAT AT LEAST 1 OF THE INCORPORATED FEATURES OCCURS EVERY 40 FEET:

a. GROUND-FLOOR TRANSPARENT WINDOWS, WITH THE LOWER EDGE OF THE WINDOW SILLS NO HIGHER THAN

30" ABOVE THE FINISH FLOOR.

b. WINDOWS ON UPPER FLOORS.

c. PRIMARY PEDESTRIAN ENTRANCES.

d. PORTALS, ARCADES, CANOPIES, TRELLISES, AWNINGS OVER WINDOWS, OR OTHER ELEMENTS THAT PROVIDE SHADE OR PROTECTION FROM THE WEATHER.

e. SUN SHELVES OR OTHER EXTERIOR BUILDING FEATURES DESIGNED TO REFLECT SUNLIGHT INTO THE BUILDING AND REDUCE THE NEED FOR INTERIOR LIGHTING. f. RAISED PLANTERS BETWEEN 12 INCHES AND 28 INCHES ABOVE GRADE WITH THE SURFACE PLANTED TO ACHIEVE

AT LEAST 75 PERCENT VEGETATIVE COVER AT MATURITY. 3. EACH STREET-FACING FACADE LONGER THAN 100 FEET SHALL INCORPORATE AT LEAST 1 OF THE FOLLOWING ADDITIONAL FEATURES (ILLUSTRATED BELOW):

a. WALL PLANE PROJECTIONS OR RECESSES OF AT LEAST FOOT IN DEPTH AT LEAST EVERY 100 FEET OF FACADE LENGTH AND EXTEND FOR AT LEAST 25 PERCENT OF THE LENGTH OF THE FACADE.

b. A CHANGE IN COLOR, TEXTURE, OR MATERIAL AT LEAST EVERY 50 FEET OF FACADE LENGTH AND EXTENDING AT LEAST 20 PERCENT OF THE LENGTH OF THE FACADE. c. AN OFFSET, REVEAL, PILASTER, OR PROJECTION ELEMENT NO LESS THAN 2 FEET IN WIDTH, PROJECTING FROM THE FACADE BY AT LEAST 6 INCHES, AND

REPEATING AT A MINIMUM OF 30 FEET OF FACADE

d. THREE DIMENSIONAL CORNICE OR BASE TREATMENTS. e. A PROJECTING GABLE, HIP FEATURE, OR CHANGE IN PARAPET HEIGHT AT LEAST EVERY 100 FEET OF FACADE

f. ART SUCH AS MURALS OR SCULPTURE THAT IS PRIVATELY-OWNED OR COORDINATED THROUGH THE CITY PUBLIC ARTS PROGRAM.

SOUTH ELEVATION

South Facade Length: 93'-2"

Required Design Element Length: 93'-2" \* .3 = 28'-0" Provided Design Element Length: 31'-6"

windows: 21'-2" element that provides shade or protection from the weather: 10'-4"

**EAST ELEVATION** 

East Facade Length: Required Design Element Length: 205'-4" \* .3 = 61'-8"

106'-6"

Provided Design Element Length: 103'-4" windows at upper floors: 41'-4" element that provides shade or protection from the weather: 62'-0" window awnings: 41'-4"

covered building entry: 20'-8"

Facade Length longer than 100'-0" requirement: a change of color every 50 of facade length and extending at least 20 percent of the length of the facade. Required Color Change Length: 205'-7" \* .2 = 41'-1" Provided Color Change Length:



PROJECT NO: 2023-VW 1.23.2024 DATE: SET NO:  $\times \times \times \times$ 

DRAWN BY:

CHECKED BY:

SITE PLAN ADMINISTRATIVE DFT -SITE DETAILS / BUILDING **ELEVATIONS** 

**SDP5.1** 

 $\times \times$ 



STUDIO 151, LLC

P.O.BOX 923



0% OF TRANSPARENT WINDOWS SHADED

EAST ELEVATION

F6 SUN / SHADE ANALYSIS 5/21 9:00AM


PROJECT NO: DATE:


DRAWN BY: CHECKED BY: SITE PLAN

ADMINISTRATIVE DFT


- SUN AND SHADE ANALYSIS

SDP5.2

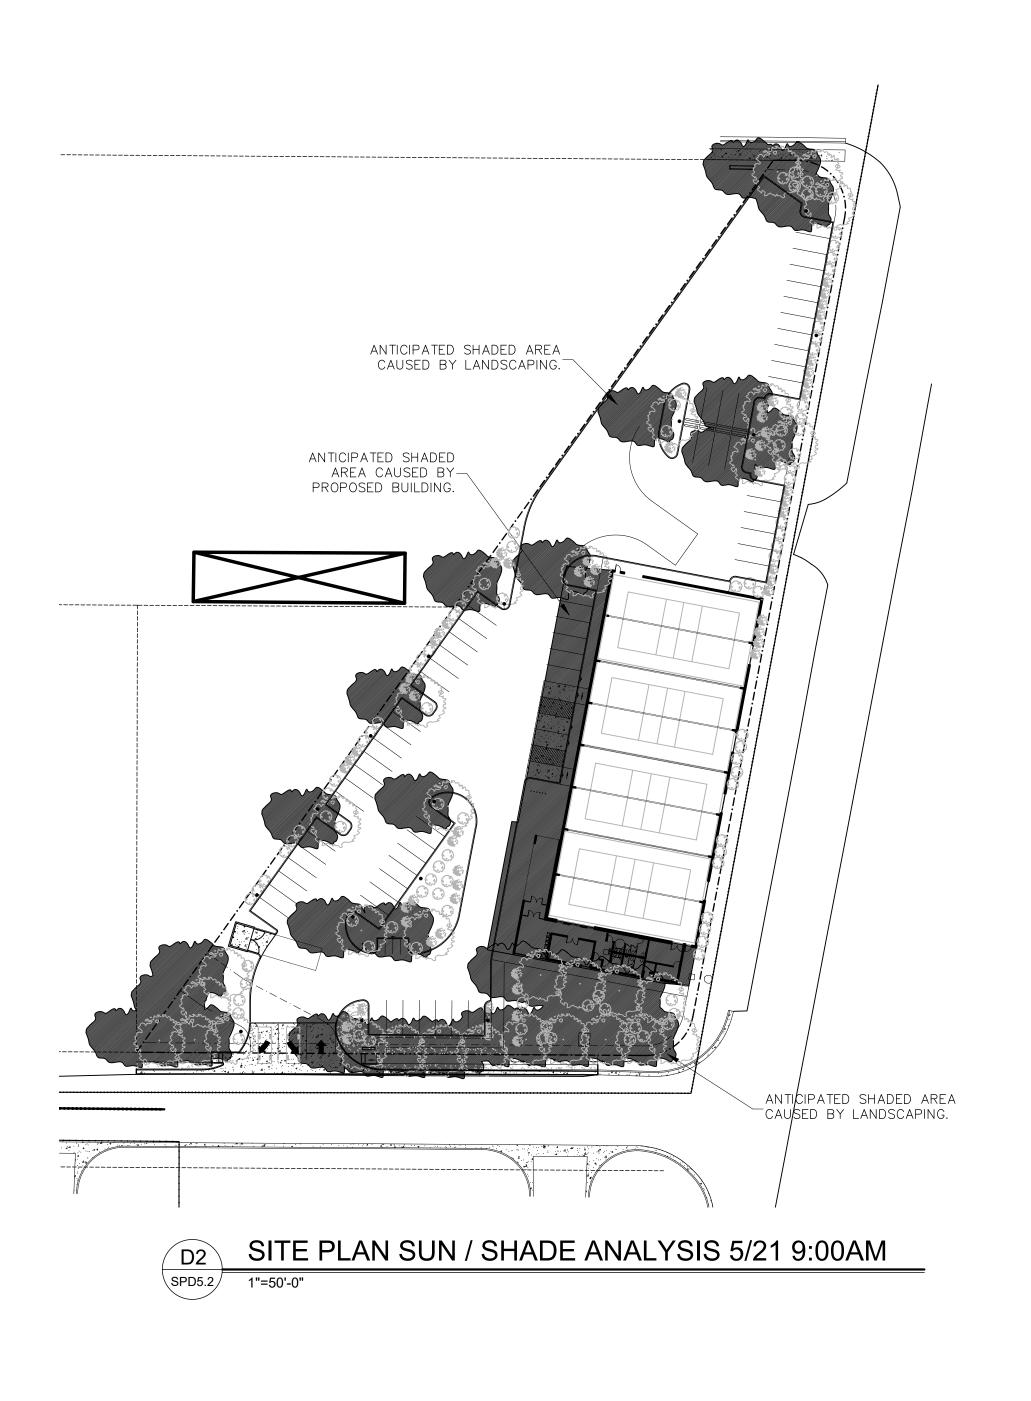


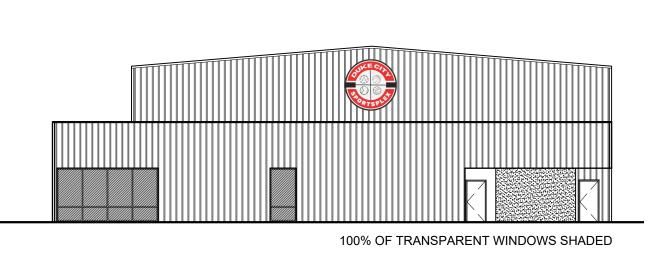



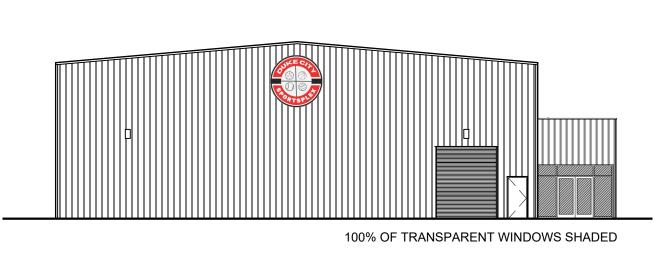


NORTH ELEVATION SUN / SHADE ANALYSIS 5/21 9:00AM SPD5.2 1/16=1'-0"

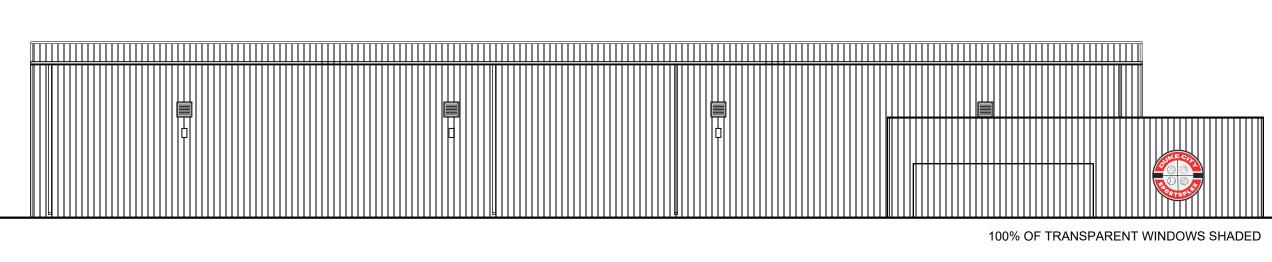


WEST ELEVATION SUN / SHADE ANALYSIS 5/21 9:00AM SPD5.2 1/16=1'-0"


DUKE CITY SPORTSPLEX

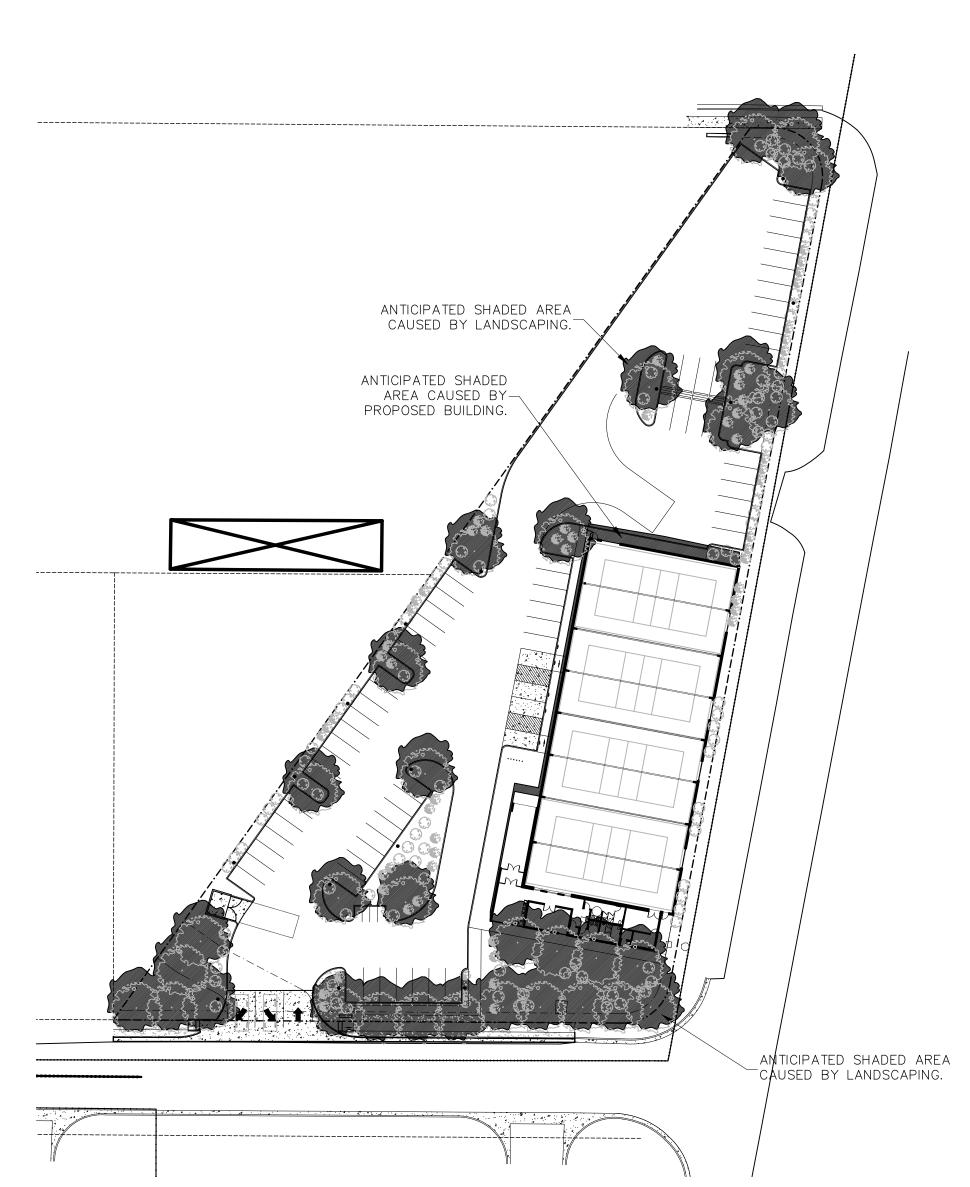


SITE PLAN SUN / SHADE ANALYSIS 5/21 NOON

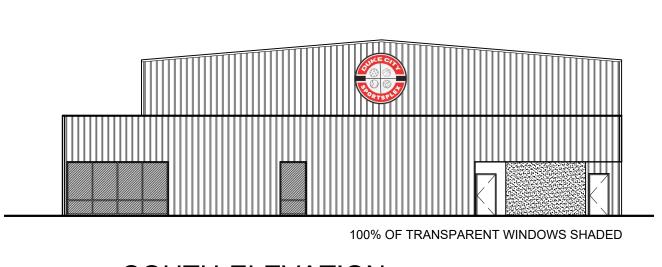




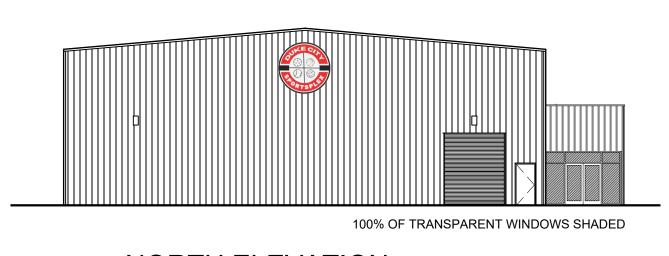

NORTH ELEVATION B2 SUN / SHADE ANALYSIS 5/21 NOON SPD5.2 1/16=1'-0"

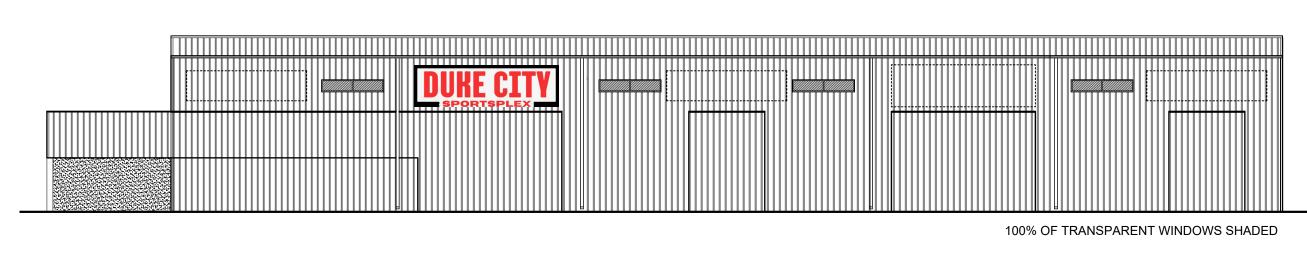

EAST ELEVATION C6 SUN / SHADE ANALYSIS 5/21 NOON

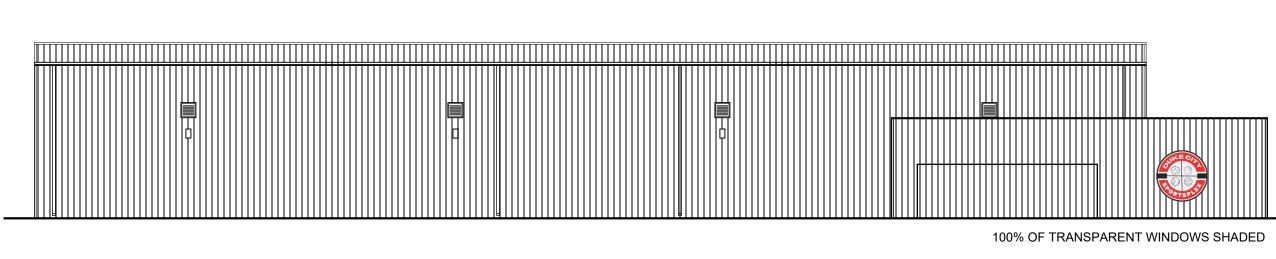


WEST ELEVATION SUN / SHADE ANALYSIS 5/21 NOON SPD5.2 1/16=1'-0"

P.O.BOX 923 CORRALES, NEW MEXICO 8 7 0 4 8 5 0 5 . 2 2 0 . 0 5 9 5 5 0 5 . 2 4 2 . 7 6 2 7


STUDIO 151, LLC



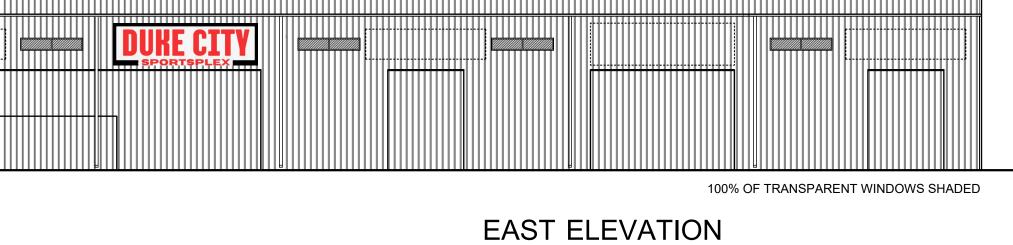

SOUTH ELEVATION F3 SUN / SHADE ANALYSIS 5/21 4:00PM

42% OF TRANSPARENT WINDOWS SHADED

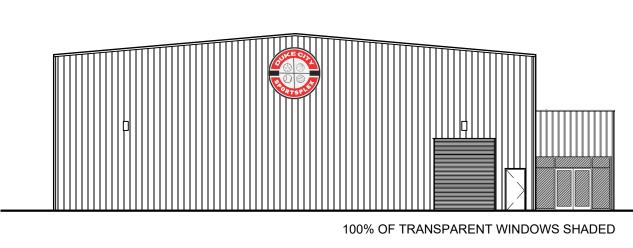


NORTH ELEVATION SUN / SHADE ANALYSIS 5/21 4:00PM SPD5.3 1/16"=1'-0"

ANTICIPATED SHADED


AREA CAUSED BY
PROPOSED BUILDING.

ANTICIPATED SHADED AREA CAUSED BY LANDSCAPING.

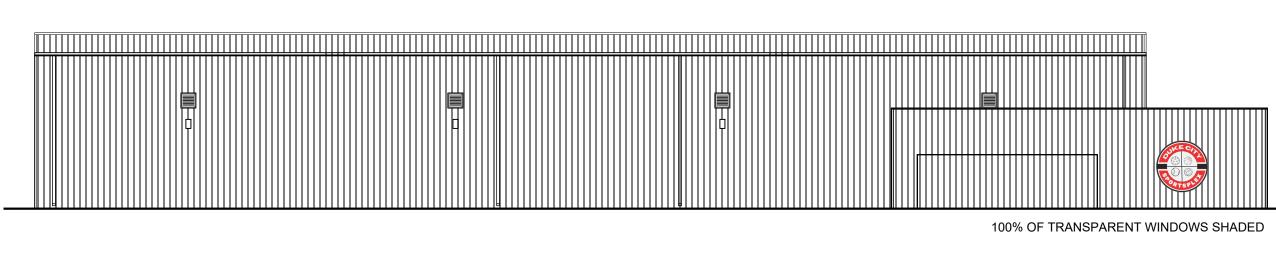


WEST ELEVATION SUN / SHADE ANALYSIS 5/21 4:00PM SPD5.3 1/16"=1'-0"

SUN / SHADE ANALYSIS 5/21 4:00PM

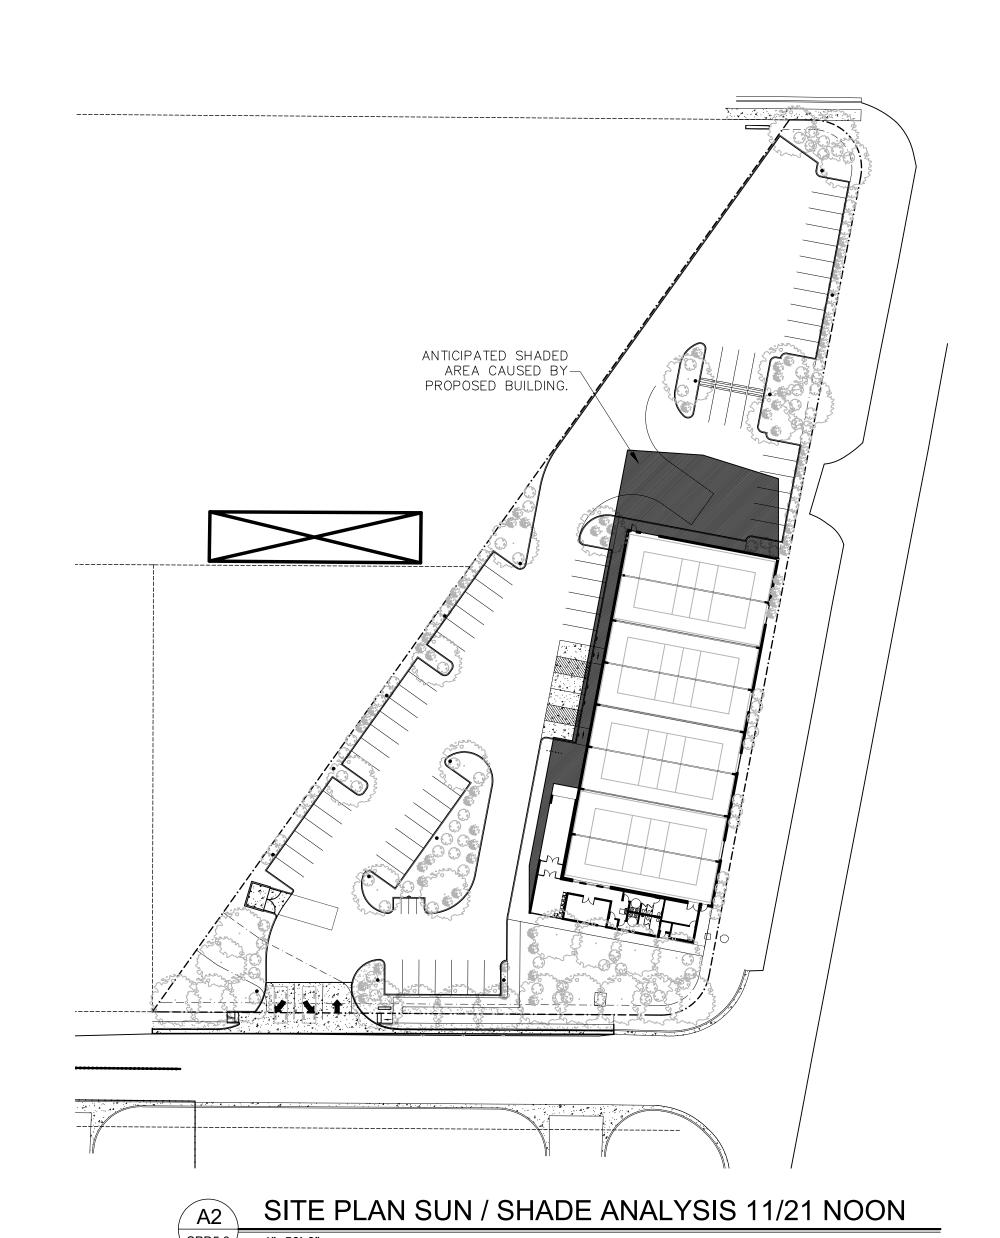


ANTICIPATED SHADED AREA CAUSED BY LANDSCAPING.


SITE PLAN SUN / SHADE ANALYSIS 5/21 4:00PM

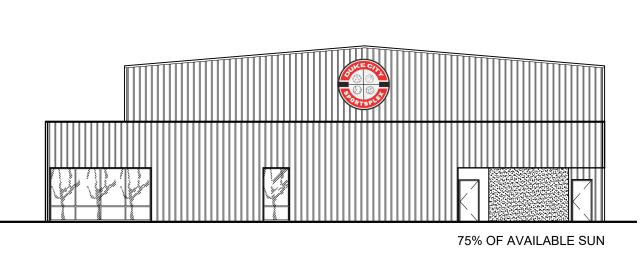


SOUTH ELEVATION C3 SUN / SHADE ANALYSIS 11/21 NOON SPD5.3 1/16"=1'-0"

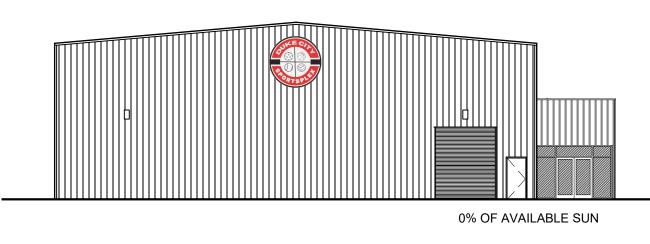


NORTH ELEVATION B3 SUN / SHADE ANALYSIS 11/21 NOON SPD5.3 1/16"=1'-0"

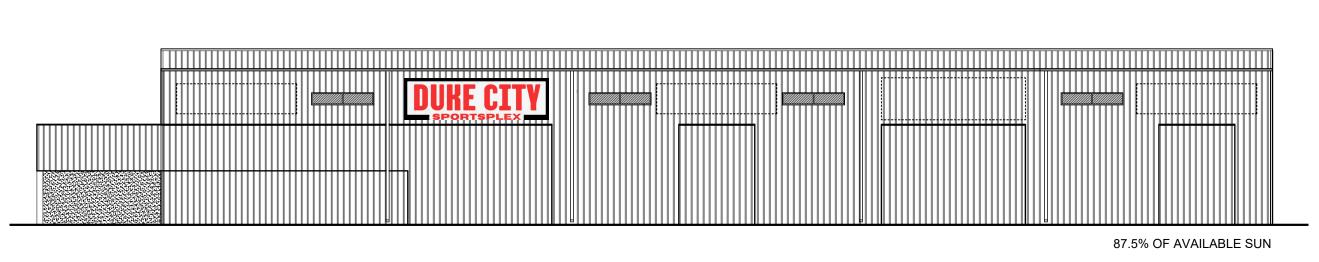

EAST ELEVATION C6 SUN / SHADE ANALYSIS 11/21 NOON

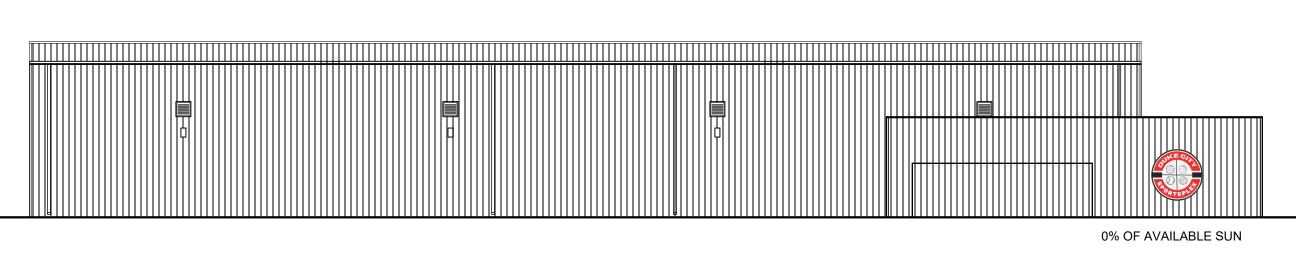

WEST ELEVATION SUN / SHADE ANALYSIS 11/21 NOON SPD5.3 1/16"=1'-0"

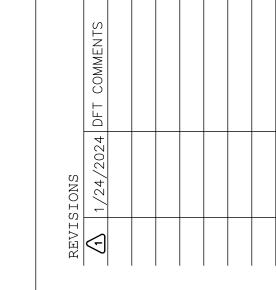

PROJECT NO: 2023-VW 1.23.2024 DATE: SET NO: XXXX DRAWN BY:  $\times \times$ 

SITE PLAN ADMINISTRATIVE DFT - SUN AND SHADE ANALYSIS

CHECKED BY:

SDP5.3