




DEVELOPMENT REVIEW BOARD APPLICATION


Please check the appropriate box(es) a of application.		er to supplemental f	orms for submittal rec	quireme	nts. All fees must be	e paid at the time		
SUBDIVISIONS	d	Final Sign off of EPC Si	ite Plan(s) (Form P2)					
☐ Major – Preliminary Plat (Form P1)		Amendment to Site Plan	n (Form P2)	□ Va	acation of Public Right-c	of-wav (Form V)		
☐ Minor – Preliminary/Final Plat (Form S2)	MIS	SCELLANEOUS APPL	ICATIONS		□ Vacation of Public Easement(s) DRB (Form V			
☐ Major - Final Plat (Form S1)		Extension of Infrastructu	ure List or IIA (Form S1)		□ Vacation of Private Easement(s) (Form V)			
☐ Amendment to Preliminary Plat (Form S2)			frastructure List (Form S2)	-	PRE-APPLICATIONS			
☐ Extension of Preliminary Plat (FormS1)	_	Temporary Deferral of S		50000	☐ Sketch Plat Review and Comment (Form S2)			
	_	Sidewalk Waiver (Form		+	teterr lat Neview and C	Johnnellt (Form 32)		
SITE PLANS	0.50	Waiver to IDO (Form V		APPI	ΕΔΙ			
□ DRB Site Plan (Form P2)		Waiver to DPM (Form V			ecision of DRB (Form A)			
BRIEF DESCRIPTION OF REQUEST		reares to Dr W (r orm v	-1		ecision of DRB (Form A)			
Major Site Plan Amendment to allow	for cons	struction of two new	w building and accord	atod city	n modifications			
Plan has been reviewed and approve			v building and associa	aleu Sile	e modifications.			
APPLICATION INFORMATION								
Applicant: La Vida Llena (Joe Gome	z)			Р	hone: 505-991-555	7		
Address: 10501 Lagrima De Oro Roa				Email: jgomez@lavid				
City: Albuquerque			State: NM	Zi	Zip: 87111			
Professional/Agent (if any): The Deign G	roup (D	avid Aube)		Phone: 505-998-6430				
Address: 120 Vassar Drive SE, Suite	100			E		gngroupnm.com		
City: Albuquerque			State: NM	Zi	p: 87106			
Proprietary Interest in Site: Owner			List all owners: La					
SITE INFORMATION (Accuracy of the existing	ng legal d	description is crucial!	Attach a separate sheet	if necess	ary.)			
Lot or Tract No.: La Vida Llena			Block: 0000	Uı	nit:			
Subdivision/Addition: La Vida Llena			MRGCD Map No.:	UI	UPC Code: 102106137909740340			
Zone Atlas Page(s): F-21-Z		Existing Zoning: RM	I-L	Pr	Proposed Zoning RM-L			
# of Existing Lots: 1	1	# of Proposed Lots: 1	Total Area of Site (Acres): 16			16.89		
LOCATION OF PROPERTY BY STREETS								
Site Address/Street: La Vida Llena		Between: La Vida Ll			a Vida Llena			
CASE HISTORY (List any current or prior pro								
#2019-002114 (1003807), \$1-2019-00	0117, V	A-2019-00152, VA	-2019-00179, SP-82-	12				
Signature:								
Signature: Hawking Signature: La Vida Llena	£ . · .				ate: 8-6-2019			
					Applicant or Agent			
FOR OFFICIAL USE ONLY					T			
Case Numbers Ac	ction	Fees	Case Numbers		Action	Fees		
		+						
		+						
Meeting Date:				T _F -	e Total:			
Staff Signature:			Date:		e rotal:			

FORM P2: SITE PLAN - DRB

Please refer to the DRB public meeting schedules for meeting dates and deadlines. Your attendance is required.

riease refer to the DRB public meeting schedules for meeting dates and deadlin								
A Single PDF file of the complete application including all documents being submitted must be emaking a submittal. Zipped files or those over 9 MB cannot be delivered via email, in which case PDF <u>shall be organized</u> with the Development Review Application and this Form P2 at the front the <u>order provided on this form.</u>	e the PDF must be provided on a CD							
☐ SITE PLAN – DRB☐ MAJOR AMENDMENT TO SITE PLAN – DRB☐								
EXTENSION OF SITE PLAN - DRB								
Interpreter Needed for Hearing? if yes, indicate language:								
PDF of application as described above								
Zone Atlas map with the entire site clearly outlined and labeled								
Letter of authorization from the property owner if application is submitted by an agent Sites 5 acres or greater. Archaeological Certificate in accordance with IDO Section 14.	is a series ()							
Signed Traffic Impact Study (TIS) Form	Sites 5 acres or greater: Archaeological Certificate in accordance with IDO Section 14-16-6-5(A) (not required for Extension) Signed Traffic Impact Study (TIS) Form							
Signed Form DRWS Drainage Report, Grading and Drainage Plan, and Water & Sewer	r Availability Statement filing information							
(not required for Extension)								
Justification letter describing, explaining, and justifying the request per the criteria in IDC	O Section 14-16-6-6(G)(3)							
Explanation and justification of requested deviations, if any, in accordance with IDO Set Note: If requesting more than allowed by deviation, a Variance – ZHE or Variance – DR	ction 14-16-6-4(O)							
Proof of Pre-Application Meeting with City staff per IDO Section 14-16-6-4(B) (not required)	(B will be required, as applicable.							
Proof of Neighborhood Meeting per IDO Section 14-16-6-4(C)	rea for Exterision)							
Office of Neighborhood Coordination neighborhood meeting inquiry response								
Proof of email with read receipt OR Certified Letter offering meeting to applicable as:	sociations							
If a meeting was requested or held, copy of sign-in sheet and meeting notes Sign Posting Agreement								
Required notices with content per IDO Section 14-16-6-4(K)(6)								
Office of Neighborhood Coordination notice inquiry response								
 Copy of notification letter and proof of first class mailing Proof of emailed notice to affected Neighborhood Association representatives 								
Buffer map and list of property owners within 100 feet (excluding public rights-of-way)	A provided by Planning Denartment or							
created by applicant, copy of notifying letter, and proof of first class mailing	/) provided by Franking Department of							
Completed Site Plan Checklist								
 Site Plan and related drawings (7 copies, 24" x 36" folded to fit into an 8.5" x 14" pocket Copy of the original approved Site Plan or Master Development Plan (for amendments of the company of the original approved Site Plan or Master Development Plan (for amendments of the company of the original approved Site Plan or Master Development Plan (for amendments of the company of the co	24" . 26"							
Site Plan and related drawings reduced to 8.5" x 11" format (1 copy)								
Landfill disclosure statement per IDO Section 14-16-5-2(G) if site is within a designated	landfill buffer zone							
Infrastructure List, if required	30 - 200 Maria Cara Cara Cara Cara Cara Cara Cara							
FINAL SIGN-OFF FOR MASTER DEVELOPMENT PLANS AND SITE PLANS – EPC								
NIA Interpreter Needed for Hearing? № if yes, indicate language:								
Zone Atlas map with the entire site clearly outlined and labeled								
Letter of authorization from the property owner if application is submitted by an agent								
Solid Waste Department signature on Site Plan								
Signed Form DRWS Drainage Report, Grading and Drainage Plan, and Water & Sewer Approved Grading and Drainage Plan	Availability Statement filing information							
Copy of Site Plan with Fire Marshal's stamp, i.e. "Fire 1" plan (not required for Master Di	evelopment Plans)							
Copy of EPC Notice of Decision and letter explaining how each EPC condition has been	n met							
Site Plan and related drawings (7 copies, 24" x 36" folded to fit into an 8.5" x 14" pocket) Site Plan and related drawings reduced to 8.5" x 11" format (1 copy))							
Infrastructure List, if required								
I, the applicant or agent, acknowledge that if any required information is not submitted with this scheduled for a public meeting, if required, or otherwise processed until it is complete.	s application, the application will not be							
scheduled for a public meeting if required or otherwise processed until it is complete. Signature:	Date: 8-6-19							
DIVILE IN AUG	☐ Applicant or ☐ Agent							
FOR OFFICIAL USE ONLY								
Case Numbers: Project Number:	A R II							
	A STATE OF THE STA							
Staff Signature:								
Date:								

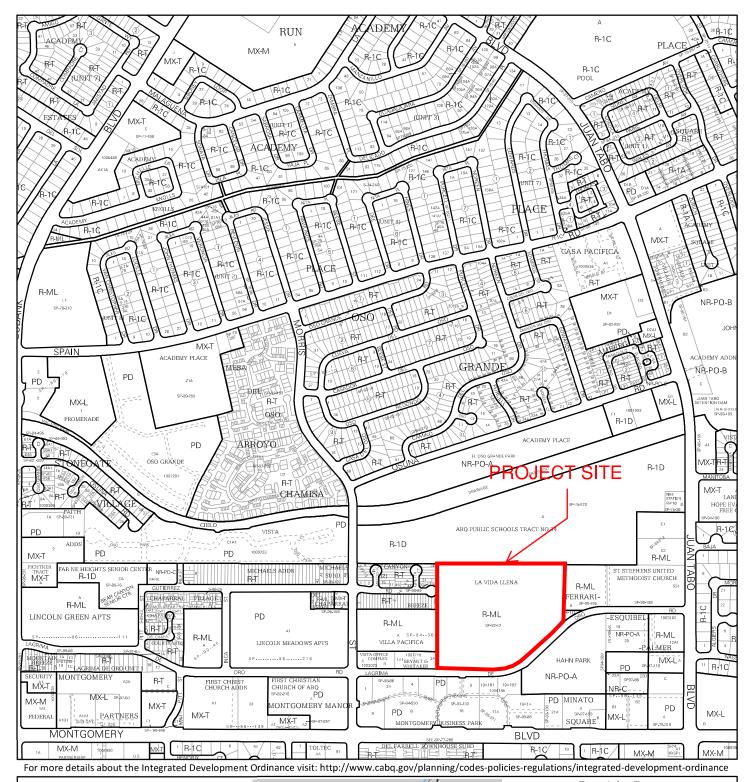

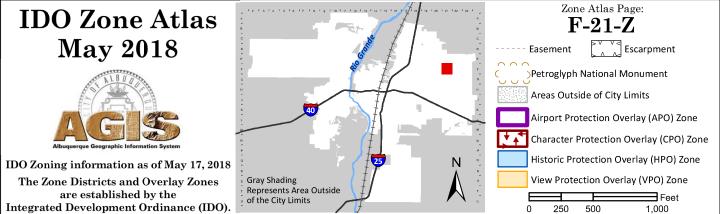



February 13, 2019

Dan Serrano, Chairman
Environmental Planning Commission
City of Albuquerque
600 Second Street NW
Albuquerque, NM 87102

Dear Mr. Serrano,

The purpose of this letter is to provide authorization to Consensus Planning and Hartman + Majewski Design Group to act as our agents on behalf of La Vida Llena (owner of the property) for all requests related to the proposed expansion at 10501 Lagrima Del Oro NE. This includes an Administrative Amendment that will be submitted to the City Planning Director and a subsequent Major Site Plan Amendment to the Environmental Planning Commission (EPC).

Sincerely,

E. DeAnn Eaton

Chief Executive Officer

Haverland Carter Lifestyle Group

& Dellan Eaton

10701 Lagrima de Oro, NE between Morris Street NE and Juan Tabo Blvd. NE PROJECT LOCATION:

AMENDED PLAT LAND IN Sec 33, T11N, R4E, LA VIDA LLENA Containing 16.89 AC. LEGAL DESCRIPTIONS:

ZONE ATLAS PAGE: F-21-Z

TOTAL ACREAGE: 16.8937 ACRES

R-ML Multi-family Low EXISTING ZONING: Density

Independent Living, Assisted Living, Memory Care and Skilled Nursing Facility PROPOSED USES:

PROJECT NUMBER:

Application Number:

and the This plan is consistent with the specific Site Development Plan approved by the Environmental Planning Commission (EPC), dated are Satisfied. Is an Infrastructure List required? () Yes () No If yes, then a set of approved DRC plans with a work order is required for any construction within Public Right-of-Way or for construction of public improvements.

DRB SITE DEVELOPMENT PLAN APPROVAL:

Date Date Date Date Date Date Date * Environmental Health Department (conditional) Traffic Engineering, Transportation Division DRB Chairperson, Plarning Department Parks and Recreation Department Solid Waste Management City Engineer/Hydrology Code Enforcement ABCWUA

2/16/18

"Environmental Health, if necessary

2

FERRARI—ESQUIBEL—PALMER LANDS OF

Asphalt

July 31, 2019

<u>Chair</u> Debbie O'Malley County of Bernalillo Commissioner, District 1

Vice Chair Klarissa J. Peña City of Albuquerque Councilor, District 3

Maggie Hart Stebbins County of Bernalillo Commissioner, District 3

Trudy E. Jones City of Albuquerque Councilor, District 8

Timothy M. Keller City of Albuquerque Mayor

Steven Michael Quezada County of Bernalillo Commissioner, District 2

Ken Sanchez City of Albuquerque Councilor, District 1

Ex-Officio Member Pablo R. Rael Village of Los Ranchos Board Trustee

Executive Director Mark S. Sanchez

Website www.abcwua.org

David Aube
Design Group
120 Vassar Dr. SE, Suite 100
Albuquerque, New Mexico 87106

RE: Water and Sanitary Sewer Availability Statement #190606 La Vida Llena 10501 LAGRIMA DE ORO RD NE

Dear Mr. Aube:

Project Description: The subject site is located on Lagrima De Oro Rd. east of Morris St. within the City of Albuquerque. The proposed development consists of approximately 16.9 acres and the property is currently zoned R-ML for multifamily low density. The property lies within the Pressure Zone 6E in the Montgomery trunk. The request for availability indicates plans to construct a new, five story, 76,100 square foot, assisted living/independent living/health care rooms as well as a new 3 story, 47,400 square foot, assisted living facility.

Existing Conditions: Water infrastructure in the area consists of the following:

- Eight-inch PVC distribution main (project #26-1406.83) along Lagrima De Oro Rd.
- Eight-inch PVC distribution main (project #26-1406-83) transecting a northeastern section of the site.
- Ten-inch AC distribution main (project #20-049-28-80) along the north property border.

Sanitary sewer infrastructure in the area consists of the following:

• Eight-inch PVC collector line (project #26-1646-86) along Lagrima De Oro Rd.

Water Service: New metered water service to the property can be provided via routine connection to the existing infrastructure mentioned within the "Existing Conditions" section of this document. From the Fire Marshal approved "Fire One Plan" and supporting proposed "Utility Plans" it is understood that a section of onsite public water line as well as an existing service will need to be relocated to accommodate the proposed development. For this reason, service to the new buildings is contingent upon relocation of the affected waterline, relocation of the existing service, and installation of the three required fire hydrants. Due to the nature of the hydrants and their preclusion from use by adjacent properties, the proposed hydrants are to be considered private. All proposed public distribution main shall be within a dedicated 20-foot public waterline easement and the meter service shall be centered within a 35 X 35-foot public water meter vault easement. Please note that all public infrastructure shall be located in alignments conducive to operating and maintaining of the infrastructure.

All metered service and fire lines that will not be utilized are to be removed by shutting the valve near the distribution main and capping the line near the valve. For fire lines, the valve access shall be grouted and collar removed. Service is also contingent upon compliance with the Fire Marshal's instantaneous fire flow requirements. Water service will not be sold without adequate fire protection. Water service will only be sold in conjunction with sanitary sewer service.

Sanitary Sewer Service: Sanitary sewer service can be provided via routine connection to the existing infrastructure mentioned within the "Existing Conditions" section of this document. All food service establishments must install a grease trap upstream of the domestic private sewer connection prior to discharge into the public sanitary sewer lines.

Fire Protection: From the request for availability the instantaneous fire flow requirements for the project are 2,625 gallons-per-minute and three new hydrants. As modeled using InfoWater™ computer software, the fire flow can be met. Analysis was performed by simulating the desired flow from existing hydrant 365 internal to the site. Any changes to the proposed connection points shall be coordinated through Utility Development. All new required hydrants as well as their exact locations must be determined through the City of Albuquerque Fire Marshal's Office and verified through the Utility Development Office prior to sale of service. Please note that the engineer designing the fire line is responsible for determining pressure losses and sizing of the private water line(s) downstream of the public water line to serve the proposed fire hydrants and/or fire suppression system.

Cross Connection Prevention: Per the Cross Connection Ordinance, all new non-residential premises must have a reduced pressure principle backflow prevention assembly approved by the Water Authority and installed at each domestic service connection at a location accessible to the Water Authority. All new fire line services to fire protection systems shall be equipped with a reduced pressure principle backflow prevention assembly approved by the Water Authority and Fire Marshal having jurisdiction at each service connection. A double check valve assembly approved by the Water Authority and Fire Marshal having jurisdiction may be installed instead of a reduced pressure backflow prevention assembly provided the fire protection system contains ANSI/NSF Standard 60 or 61 water piping throughout the entire fire protection system, the fire sprinkler drain discharges into atmosphere, and there are no reservoirs, fire department connections, connections from auxiliary water supplies, antifreeze nor other additives. The Water Authority requests that all backflow (containment) devices be located above ground just outside the easement or roadway right-of-way. Contact Cross Connection at 289-3439 for more information.

Easements: Exclusive public water and sanitary sewer easements are required for all public lines that are to be constructed outside of any dedicated rights-of-way. A minimum width easement of 20 feet is required for a single utility and 25 feet for water and sewer both within the same easement. Easements for standard sized water meters need to be five feet by five feet and include the length of the water service if located on private property. For larger meters that require a meter vault, a 35 feet by 35 feet easement is required. Actual easement widths may vary depending on the depth of the

lines to be installed. Acceptable easements must be documented prior to approval of service.

Pro Rata: Pro Rata is not owed and the property can utilize the services available upon completion of the requirements of this statement to connect to water and sanitary sewer.

Design and Construction of all required improvements will be at the developer / property owner's expense. Improvements must be coordinated through the City of Albuquerque via the Work Order process. Designs must be performed by a licensed, New Mexico registered, professional engineer. Construction must be performed by a licensed and bonded public utility contractor.

Costs and Fees: In addition to installation and construction costs, any new metered water services will be subject to both water and sanitary sewer Utility Expansion Charges (UEC) payable at the time of service application. All charges and rates collected will be based on the ordinances and policies in effect at the time service is actually requested and authorized.

Water Use: Where available, outdoor water usage shall utilize reclaimed water. All new commercial developments shall be subject to the requirements for water usage and water conservation requirements as defined by the Water Authority, particularly the Water Waste Ordinance. Where available, outdoor water usage shall utilize reclaimed water.


Closure: This availability statement provides a commitment from the Water Authority to provide services to the development, as long as identified conditions are met. It will remain in effect for a period of one year from the date of issue and applies only to the development identified herein. Its validity is, in part, contingent upon the continuing accuracy of the information supplied by the developer. Changes in the proposed development may require reevaluation of availability and should be brought to the attention of the Utility Development Section of the Water Authority as soon as possible.


Please feel free to contact Mr. Kristopher Cadena in our Utility Development Section at (505) 289-3301 or email at kcadena@abcwua.org if you have questions regarding the information presented herein or need additional information.

Sincerely.


Mark S. Sanchez Executive Director

Enclosures: Infrastructure Maps (2) f/ Availability Statement190606

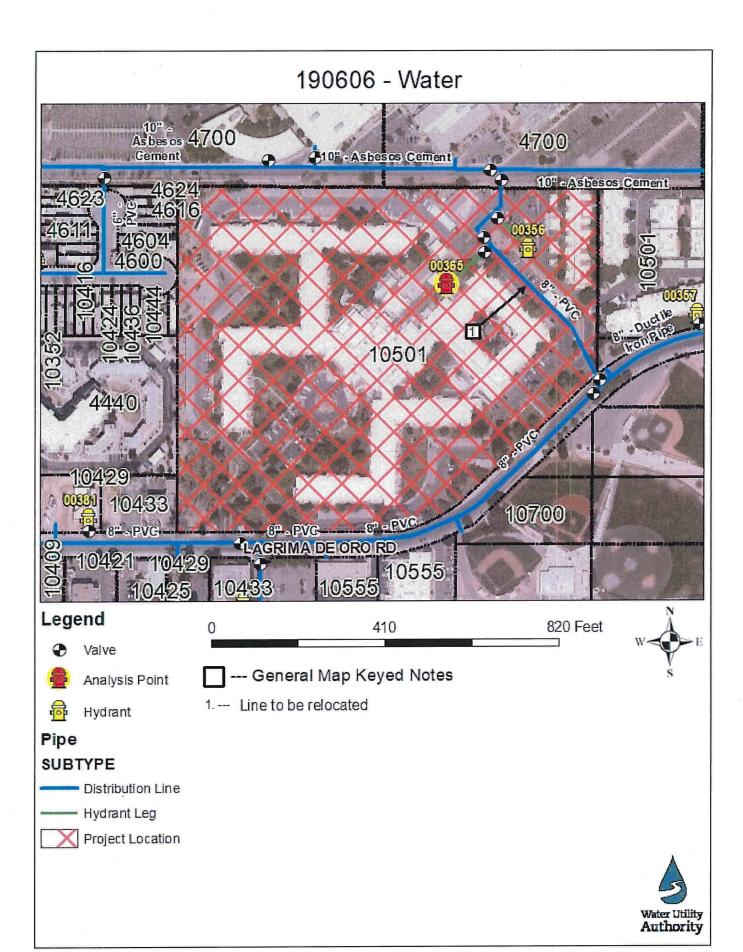

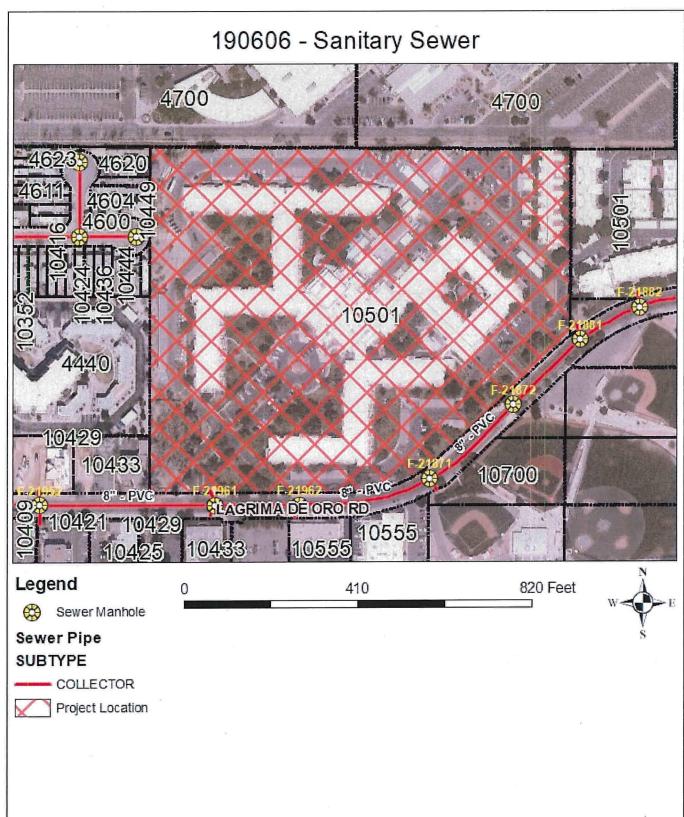



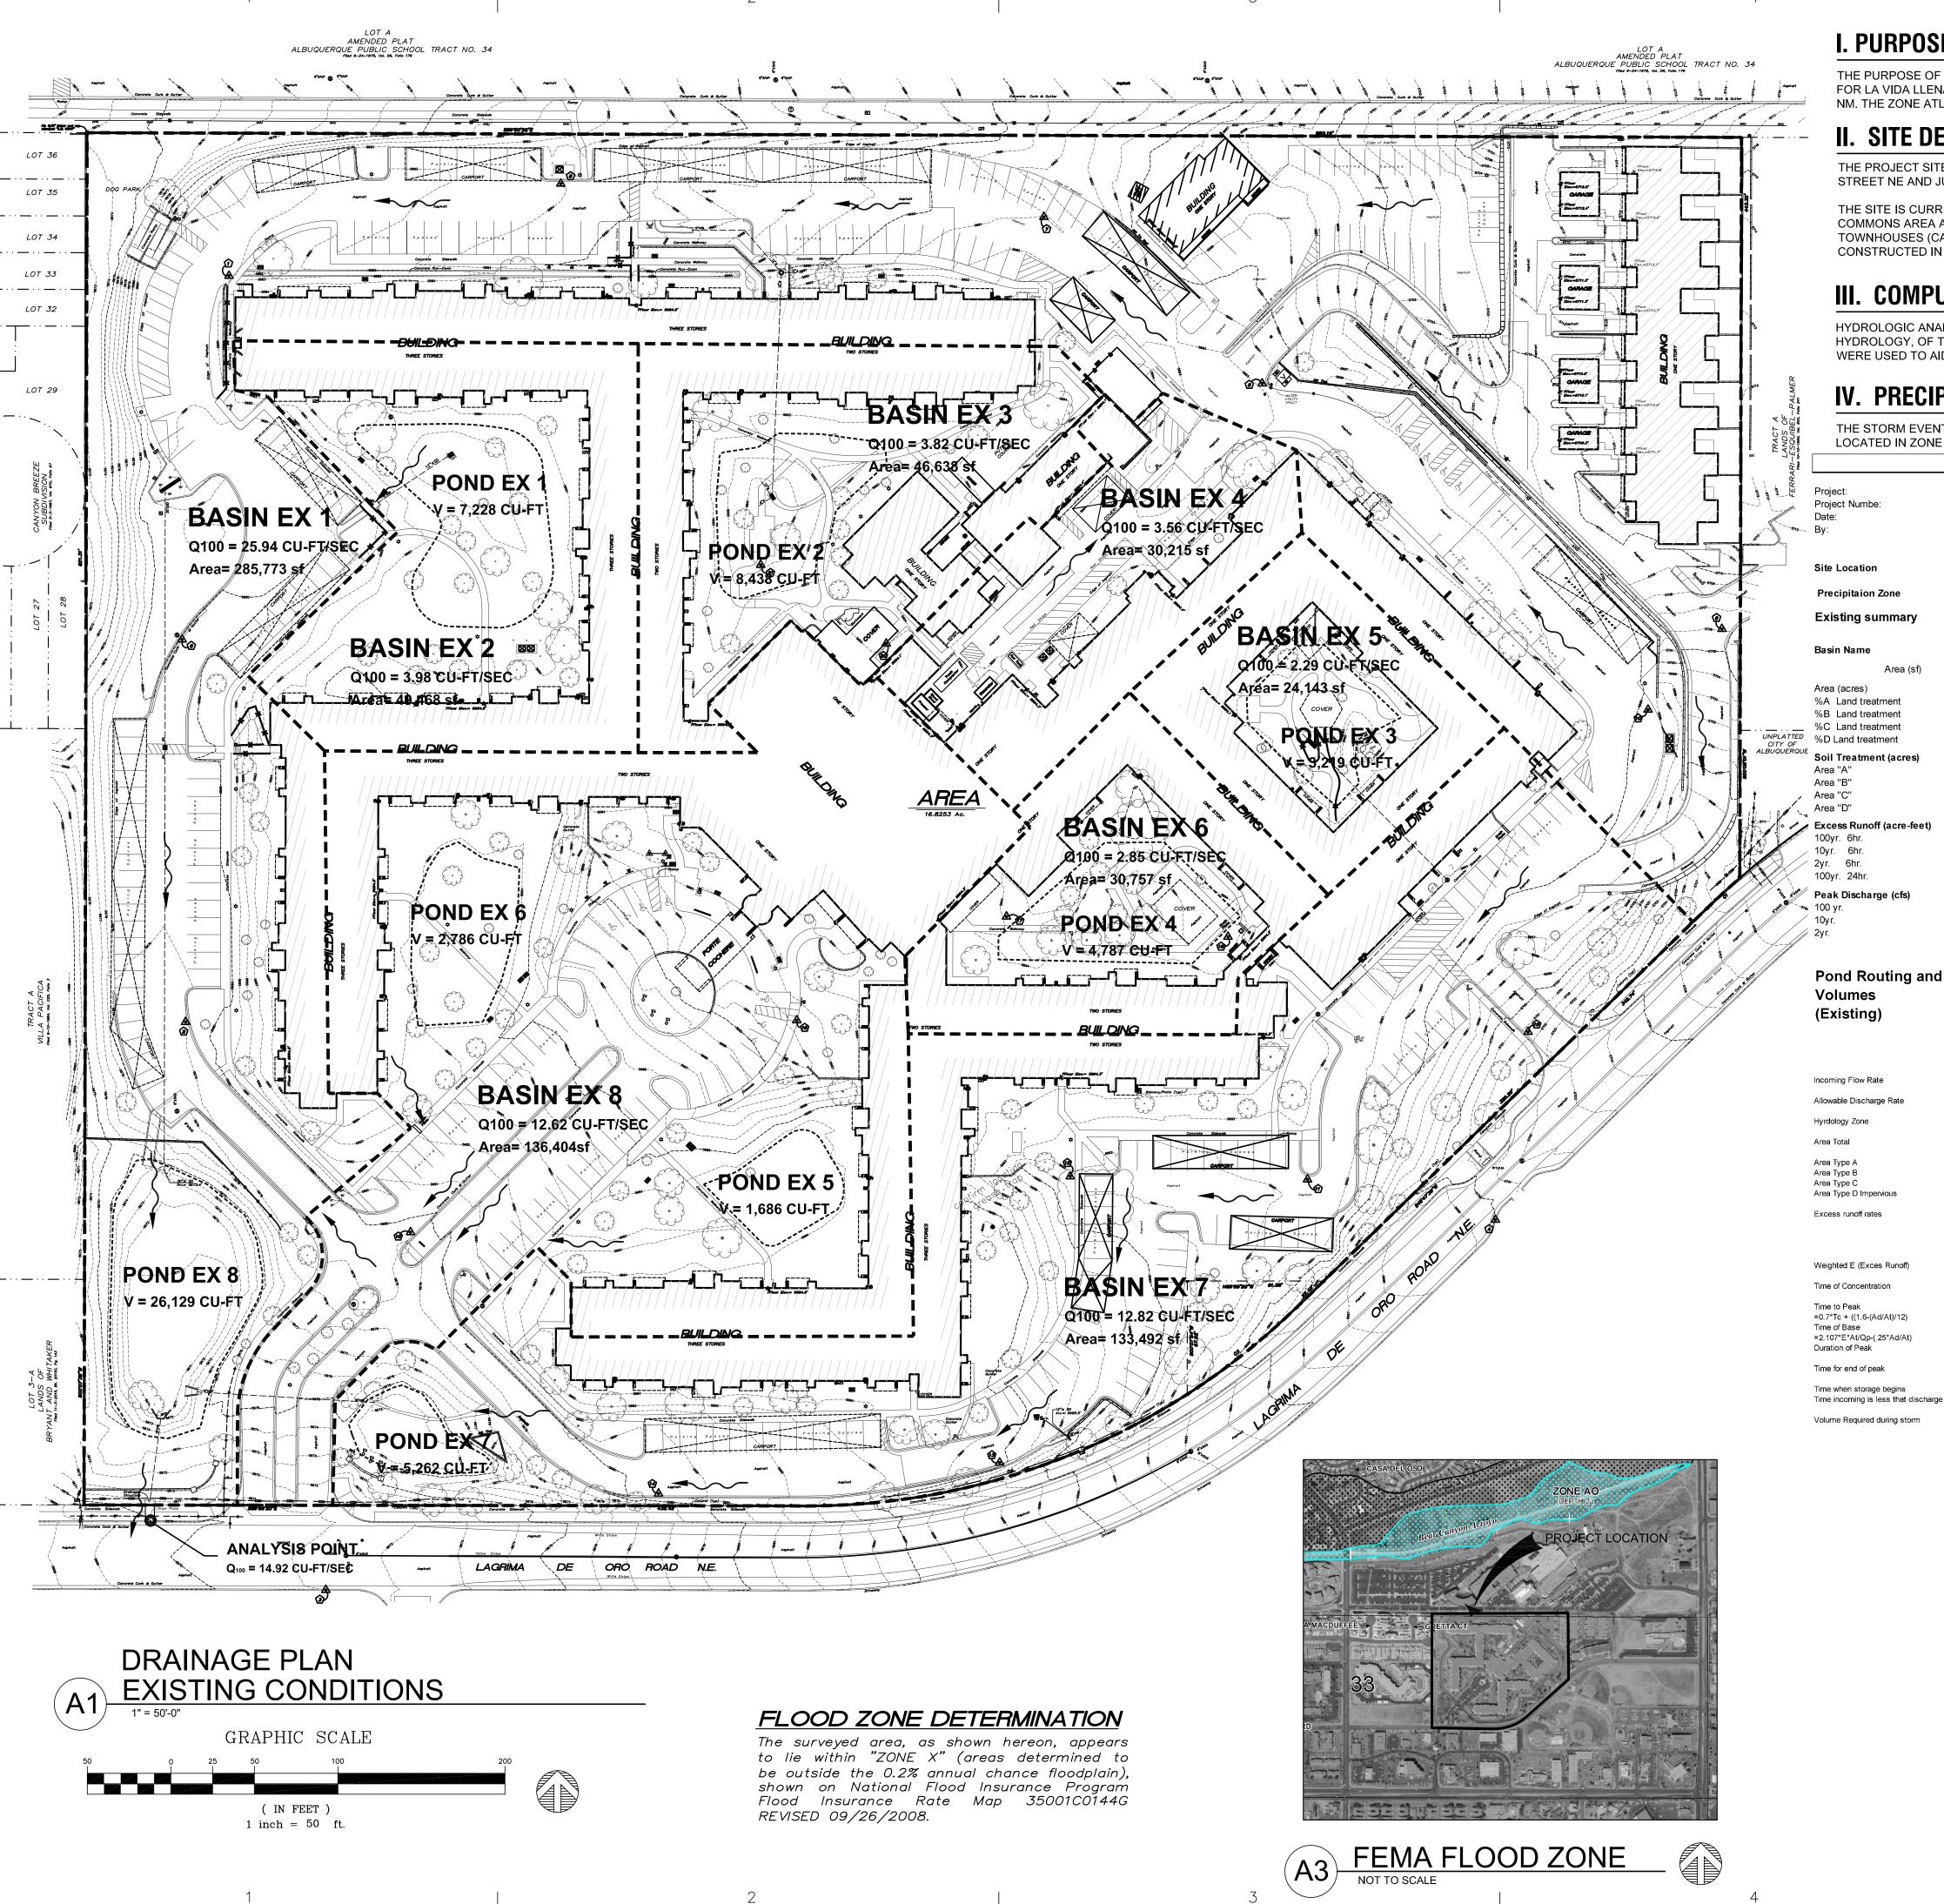

I. PURPOSE AND SCOPE

THE PURPOSE OF THIS DRAINAGE PLAN IS TO PRESENT THE EXISTING AND PROPOSED DRAINAGE CONDITIONS FOR LA VIDA LLENA LIFE PLAN COMMUNITY, LOCATED AT 10701 LAGRIMA DE ORO ROAD NE IN ALBUQUERQUE, NM. THE ZONE ATLAS PAGE FOR THE SITE IS F-21-Z.

II. SITE DESCRIPTION AND HISTORY

THE PROJECT SITE IS LOCATED ON THE NORTH SIDE OF LAGRIMA DE ORO ROAD NE, BETWEEN MORRIS STREET NE AND JUAN TABO BOULEVARD NE.

THE SITE IS CURRENTLY COMPOSED OF 16.8 ACRE LOT WITH SEVERAL MUTLI-RESIDENT BUILDINGS, A

COMMONS AREA AS WELL AS A SKILLED NURSING WING. THE SITE ALSO CONTAINS SEVERAL SINGLE RESIDENT TOWNHOUSES (CASITAS) AND A MAINTENANCE BUILDING. A MAJORITY OF THE SITE WAS DEISGNED AND CONSTRUCTED IN 1979 AND 1984.

III. COMPUTATIONAL PROCEDURES

HYDROLOGIC ANALYSIS WAS PERFORMED UTILIZING THE DESIGN CRITERIA BASED ON SECTION 22.2, HYDROLOGY, OF THE DEVELOPMENT PROCESS MANUAL RELEASED JUNE 1997. TABLES WITHIN SECTION 22.2 WERE USED TO AID IN THE STUDY OF THE SITE HYDROLOGY.


IV. PRECIPITATION

THE STORM EVENT USED FOR THE FOLLOWING CALCULATIONS IS THE 100YR-6HR STORM. THE PROJECT SITE IS LOCATED IN ZONE 4 (EAST OF EUBANK BOULEVARD NE).

Drainage Summary

La Vida Llena

5712	Project: Project Numbe: Date: By:		La Vida L 2811 04/19/19 Dave A	iena										
	Site Location		10701 La	grima De	oro Road	I NE								
	Precipitaion Zone			4 Per	Гable А-1 (COA DPM S	Section 22.2							
	Existing summary													
	Basin Name		Ex 1	E	x 2	Ex 3	Ex 4	Ex 5	Ex 6	Ex 7	Ex 8			
	Area (sf)		285773		3468	46638	30215	24143	30757	133492	136404			
	Area (acres)		6.56		.11	1.07	0.69	0.55	0.71	3.06	3.13			
	%A Land treatment		40		55	55	0	25	35	35	40			
	%B Land treatment		0		0	0	5	15	0	0	0			
	%C Land treatment		5		0	0	0	0	10	0	0			
TED OF	%D Land treatment		55		45	45	95	60	55	65	60			
RQUE	Soil Treatment (acres)													
	Area "A"		2.62).61	0.59	0.00	0.14	0.25	1.07	1.25			
	Area "B"		0.00		0.00	0.00	0.03	0.08	0.00	0.00	0.00			
/	Area "C"		0.33		0.00	0.00	0.00	0.00	0.07	0.00	0.00			
`~~a	Area "D"		3.61	().50	0.48	0.66	0.33	0.39	1.99	1.88			
South Section 1	Excess Runoff (acre-feet)		4 0007		4540	0.4450	0.4404	0.0000	0.4405	0.5007	0.4000		4	
•	100yr. 6hr. 10yr. 6hr.		1.0087 0.5893		1510 0848	0.1453 0.0816	0.1481 0.0941	0.0899 0.0533	0.1105 0.0648	0.5097 0.3056	0.4968 0.2938		acre-ft acre-ft	
//	2yr. 6hr.		0.3093			0.0616	0.0558	0.0333	0.0347	0.3694	0.2930		acre-ft	
	100yr. 24hr.		1.2342		1822	0.1754	0.1893	0.1107	0.1348	0.6342	0.6143		acre-ft	
)s/s/														
5/ 5m	Peak Discharge (cfs) 100 yr.		25.94	-	3.98	3.82	3.56	2.29	2.85	12.82	12.62		cfs	
/	10yr.		15.91		2.32	2.23	2.40	1.43	1.76	8.04	7.80		cfs	
	2yr.		8.29		.12	1.07	1.44	0.76	0.93	4.38	4.14		cfs	
	Pond Routing and													
	-													
	Volumes		Pond	Pond	Pond		Pond	Pond	Pond	Pond	l Pond			
	(Existing)		EX8	EX1	EX2		EX3	EX4	EX7	EX5	EX6			
			Basin	Basin	Basin				Basin	Basir EX#8				
			EX#1	EX#2	EX#3	EX#4	1 EX#5	EX#6	EX#7	East	West			
	Incoming Flow Rate	Qin	45.90		3.98	3.82	3.56	2.29	2.85	13.24	6.31	6.31	cfs	
	Allowable Discharge Rate	Qout	14.92		0	0.00	3.56	0.32	0.10	8.20	4.50	3.70	cfs	
	Hyrdology Zone Area Total	At	6.57		4 1.11	4 1.07	4 0.69	4 0.55	4 0.71	3.06	4 1.57	1.57	Figure A-1 acres	
	Alea Total	Αl	0.57		1.11	1.07	0.09	0.55	0.71	3.00	1.57	1.57	acies	
	Area Type A	Aa Ab	40 0		55 0	55 0	0 5	25	35 0	35 0	40 0	40 0	% %	
	Area Type B Area Type C	Ac	5		0	0	0	15 0	10	0	0	0	%	
	Area Type D Impervious	Ad	55		45	45	95	60	55	65	60	60	%	
	Excess runoff rates	Α	0.80		0.80	0.80	0.80	0.80	0.80	0.80	0.80	0.80	inches	
		В	1.08		1.08	1.08	1.08	1.08	1.08	1.08	1.08	1.08	inches	
		C D	1.46 2.64		1.46 2.64	1.46 2.64	1.46 2.64	1.46	1.46	1.46 2.64	1.46 2.64	1.46	inches inches	
		U	∠.64		4.04	2.04	2.64	2.64	2.64	2.64	2.04	2.64	IIICHES	
	Weighted E (Exces Runoff)		1.85		1.63	1.63	2.56	1.95	1.88	2.00	1.90	1.90	in	
	Time of Concentration		0.2		0.2	0.2	0.2	1.2	2.2	3.2	4.2	3.2	hours	
	Time to Peak =0.7*Tc + ((1.6-(Ad/At)/12)		0.228		.236	0.236	0.194		1.628		3.023	2.323	hours	

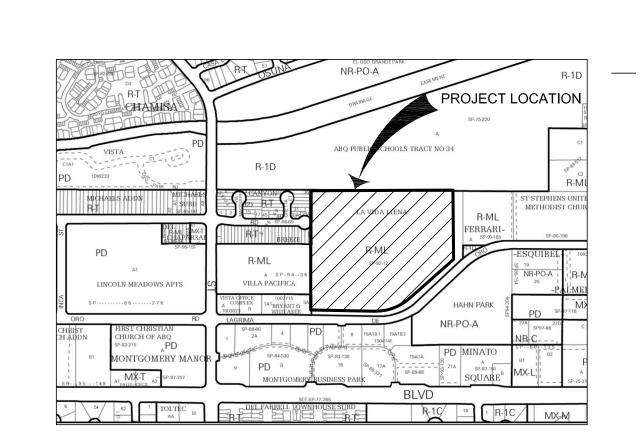

ZONE ATLAS PAGE F-21



DESIGN GROUP Architects • Engineers • Interior Design Planners • Urban Designers • LEED®

120 Vassar Drive SE Suite 100 Albuquerque New Mexico 87106 T 505 242 6880 • F 505 242 6881

CONSULTANT

STAMP



PROJECT NAME

REVISIONS:

LA VIDA LLENA 10501 LAGRIMA DE ORO NE

HAVERLAND CARTER GROUP 10701 Montgomery Boulevard NE ALBUQUERQUE NM, 87111


No.	DATE	DESCRIPTION
Copy	wright: D	esign Group
Drav	vn by	
Chec	ked by	
Date		7-31-2019
Proje	ect number	2811
Cad	file name	

SHEET TITLE:

DRAINAGE PLAN **EXISTING CONDITIONS**

SHEET NUMBER:

CD-1

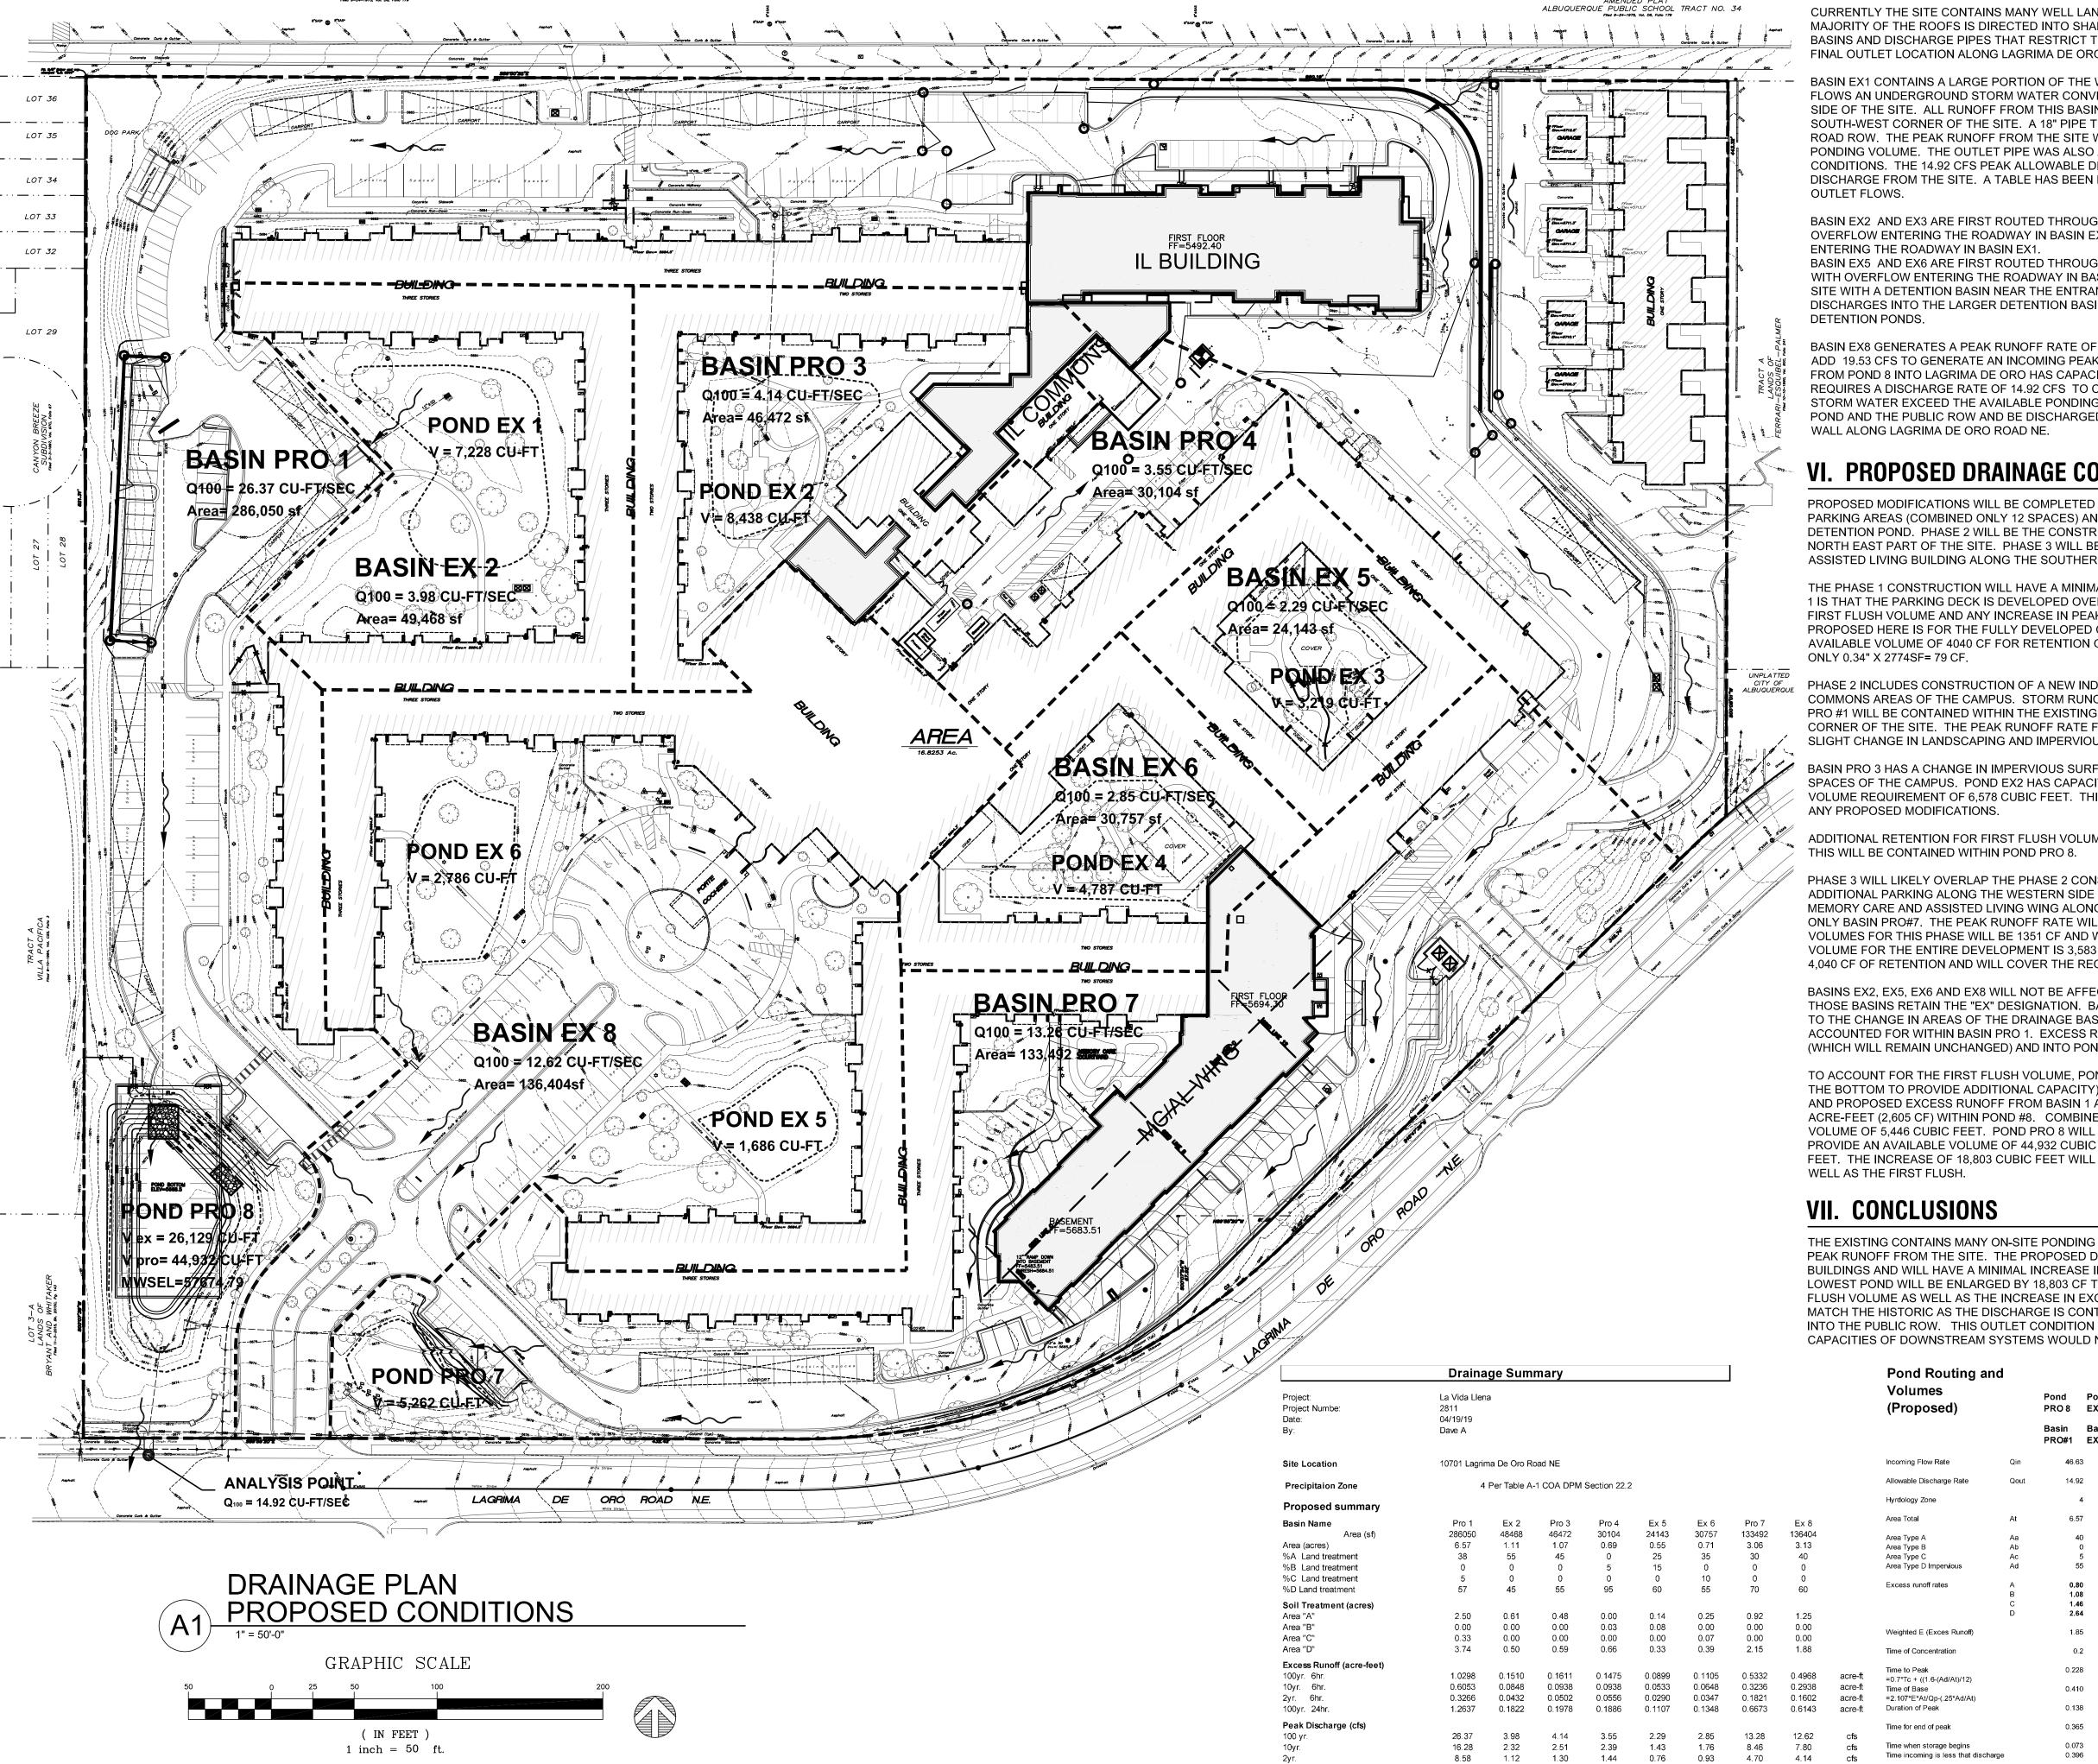

First Flush Ponding Voulme (cf)

V. EXISTING DRAINAGE CONDITIONS

CURRENTLY THE SITE CONTAINS MANY WELL LANDSCAPED DETENTION/RETENTION AREAS. RUNOFF FROM A BASINS AND DISCHARGE PIPES THAT RESTRICT THE RUNOFF RATES FROM THE DETENTION AREAS TOWARD THE

PONDING VOLUME. THE OUTLET PIPE WAS ALSO ANALYZED AND CAN CONVEY 18.5 CFS UNDER INLET CONTROL CONDITIONS. THE 14.92 CFS PEAK ALLOWABLE DISCHARGE RATE WILL BE USED AS THE EXISTING ALLOWABLE DISCHARGE FROM THE SITE. A TABLE HAS BEEN PROVIDED ON SHEET CD1 OF ALL PONDS AND ROUTED PEAK

BASIN EX2 AND EX3 ARE FIRST ROUTED THROUGH PONDING AREAS WITHIN THE LANDSCAPING AREAS, WITH OVERFLOW ENTERING THE ROADWAY IN BASIN EX1. BASIN EX4 IS THE SERVICE YARD WITH EXCESS RUNOFF

BASIN EX5 AND EX6 ARE FIRST ROUTED THROUGH PONDINGS AREA WITHIN THE LANDSCAPED COURYARD AREAS WITH OVERFLOW ENTERING THE ROADWAY IN BASIN EX7. BASIN EX7 CONTAINS THE SOUTHERN PORTION OF THE SITE WITH A DETENTION BASIN NEAR THE ENTRANCE DRIVE FROM LAGRIMA DE ORO. THIS POND THEN DISCHARGES INTO THE LARGER DETENTION BASIN IN BASIN EX1. A 18" STORM DRAIN PIPE CONNECTS THE TWO

BASIN EX8 GENERATES A PEAK RUNOFF RATE OF 26.37 CFS. OTHER BASINS THAT ARE ROUTED INTO BASIN EX8 ADD 19.53 CFS TO GENERATE AN INCOMING PEAK FLOWRATE INTO POND EX8 OF 45.90 CFS. THE OUTLET PIPE FROM POND 8 INTO LAGRIMA DE ORO HAS CAPACITY TO CONVEY 18.5 CFS. BUT THE ROUTING HYDROGRAPH ONLY REQUIRES A DISCHARGE RATE OF 14.92 CFS TO CONTAIN THE 100 YEAR 6 HOUR DESIGN STORM. SHOULD THE STORM WATER EXCEED THE AVAILABLE PONDING VOLUME. THE WATER WILL OVERTOP THE BERM BETWEEN THE POND AND THE PUBLIC ROW AND BE DISCHARGED THROUGH A SERIES OF TURNED BLOCKS IN THE MASONRY

VI. PROPOSED DRAINAGE CONDITIONS

PROPOSED MODIFICATIONS WILL BE COMPLETED IN THREE PHASES. THE FIRST PHASE IS TWO SMALL SURFACE PARKING AREAS (COMBINED ONLY 12 SPACES) AND AN ELEVATED PARKING DECK OVER AN EXISTING DETENTION POND. PHASE 2 WILL BE THE CONSTRUCTION OF A NEW INDEPENDENT LIVING BUILDING IN THE NORTH EAST PART OF THE SITE. PHASE 3 WILL BE A THE CONSTRUCTION OF A NEW MEMORY CARE AND ASSISTED LIVING BUILDING ALONG THE SOUTHERN PART OF THE SITE ADJACENT TO LAGRIMA DE ORO.

THE PHASE 1 CONSTRUCTION WILL HAVE A MINIMAL IMPACT ON STORM RUNOFF RATES. THE ISSUE FOR PHASE 1 IS THAT THE PARKING DECK IS DEVELOPED OVER AN EXISTING POND. THIS POND WILL NEED TO CONTAIN THE FIRST FLUSH VOLUME AND ANY INCREASE IN PEAK RUNOFF RATES FOR FUTURE PHASES. THE PLAN BEING PROPOSED HERE IS FOR THE FULLY DEVELOPED CONDITIONS. RESHAPING OF POND PRO 8 WILL CREATE AN AVAILABLE VOLUME OF 4040 CF FOR RETENTION OF FIRST FLUSH VOLUMES. PHASE 1 FIRST FLUSH VOLUME IS

PHASE 2 INCLUDES CONSTRUCTION OF A NEW INDEPENDENT LIVING BUILDING AND ADDITIONS TO THE COMMONS AREAS OF THE CAMPUS. STORM RUNOFF PATTERNS ARE MAINTAINED AND INCREASE FROM BASIN PRO #1 WILL BE CONTAINED WITHIN THE EXISTING RING ROAD AND DIRECTED OVER TO POND PRO 8 AT THE SE CORNER OF THE SITE. THE PEAK RUNOFF RATE FROM BASIN PRO#1 IS INCREASED BY 0.43 CFS DUE TO A SLIGHT CHANGE IN LANDSCAPING AND IMPERVIOUS SURFACES.

BASIN PRO 3 HAS A CHANGE IN IMPERVIOUS SURFACE DUE TO BUILDING ADDITIONS FOR THE COMMONS SPACES OF THE CAMPUS. POND EX2 HAS CAPACITY OF 8,438 CUBIC FEET WITH A PROPOSED EXCESS RUNOFF VOLUME REQUIREMENT OF 6,578 CUBIC FEET. THIS POND AND THE DISCHARGE PIPING WILL REMAIN WITHOUT

ADDITIONAL RETENTION FOR FIRST FLUSH VOLUMES IS 1771CF (BASIN PRO#1)+ 382 CF (BASIN PRO#3)= 2153 CF.

PHASE 3 WILL LIKELY OVERLAP THE PHASE 2 CONSTRUCTION ACTIVITIES. PHASE 3 INCLUDES CREATION OF ADDITIONAL PARKING ALONG THE WESTERN SIDE OF THE SITE TO PROVIDE OVERFLOW PARKING AND A NEW MEMORY CARE AND ASSISTED LIVING WING ALONG THE SOUTH EAST PORTION OF THE SITE. THIS WILL AFFECT ONLY BASIN PRO#7. THE PEAK RUNOFF RATE WILL BE INCREASED BY 0.46 CFS IN BASIN PRO #7. FIRST FLUSH VOLUMES FOR THIS PHASE WILL BE 1351 CF AND WILL BE CONTAINED IN POND PRO 8. THE TOTAL FIRST FLUSH VOLUME FOR THE ENTIRE DEVELOPMENT IS 3,583 CF. THE PHASE 1 RESHAPING OF POND PRO 8 WILL PROVIDE 4,040 CF OF RETENTION AND WILL COVER THE REQUIRED FIRST FLUSH VOLUME.

BASINS EX2, EX5, EX6 AND EX8 WILL NOT BE AFFECTED BY THE PROPOSED DEVELOPMENT. FOR SIMPLICITY THOSE BASINS RETAIN THE "EX" DESIGNATION. BASIN PRO 4 HAS A SLIGHT DECREASE IN EXCESS RUNOFF DUE TO THE CHANGE IN AREAS OF THE DRAINAGE BASIN. THE AREA THAT WAS REMOVED FROM THIS BASIN, IS NOW ACCOUNTED FOR WITHIN BASIN PRO 1. EXCESS RUNOFF FROM BASIN PRO 7 WILL BE ROUTED THOUGH POND 7 (WHICH WILL REMAIN UNCHANGED) AND INTO POND PRO#8.

AND PROPOSED EXCESS RUNOFF FROM BASIN 1 AND 7 CREATES A NEED TO POND AN ADDITIONAL 0.0596 ACRE-FEET (2.605 CF) WITHIN POND #8. COMBINED THIS REQUIRES THAT POND #8 HAVE AN ADDITIONAL VOLUME OF 5,446 CUBIC FEET. POND PRO 8 WILL BE RESHAPED IN PHASE 1 OF THE PROJECT AND WILL PROVIDE AN AVAILABLE VOLUME OF 44,932 CUBIC FEET. ORIGINAL VOLUME OF THIS POND WAS 26,129 CUBIC FEET. THE INCREASE OF 18,803 CUBIC FEET WILL EASILY CONTAIN THE REQUIRED EXCESS RUNOFF VOLUME AS

THE EXISTING CONTAINS MANY ON-SITE PONDING FACILITIES THAT WILL CONTINUE TO DETAIN AND DELAY THE PEAK RUNOFF FROM THE SITE. THE PROPOSED DEVELOPMENT WILL BE REPLACING PARKING LOTS FOR BUILDINGS AND WILL HAVE A MINIMAL INCREASE IN PEAK RUNOFF ENTERING THE PONDING AREAS. THE LOWEST POND WILL BE ENLARGED BY 18,803 CF TO PROVIDE THE REQUIRED VOLUME TO RETAIN THE FIRST FLUSH VOLUME AS WELL AS THE INCREASE IN EXCESS RUNOFF. DISCHARGE POINTS FROM THE SITE WILL MATCH THE HISTORIC AS THE DISCHARGE IS CONTROLLED BY THE OUTLET CONDITIONS BEFORE DISCHARGING INTO THE PUBLIC ROW. THIS OUTLET CONDITION WILL NOT BE MODIFIED BY THE PROPOSED DEVELOPMENT. CAPACITIES OF DOWNSTREAM SYSTEMS WOULD NOT BE AFFECTED BY THE PROPOSED DEVELOPMENT

Volumes (Proposed)		Pond PRO 8	Pond EX1	Pond EX 2		Pond EX 3	Pond EX 4	Pond PRO 7	Pond EX 5	Pond EX 6	
		Basin PRO#1	Basin EX#2	Basin EX#3	Basin PRO#4	Basin EX#5	Basin EX#6	Basin PRO#7	Basin EX #8 East	Basin EX #8 West	
Incoming Flow Rate	Qin	46.63	3.98	4.14	3.56	2.29	2.85	13.70	6.31	6.31	cfs
Allowable Discharge Rate	Qout	14.92	0	0.00	3.56	0.32	0.10	8.50	4.50	3.70	cfs
Hyrdology Zone		4	4	4	4	4	4	. 4	. 4	4	Figure A
Area Total	At	6.57	1.11	1.07	0.69	0.55	0.71	3.06	1.57	1.57	acres
Area Type A	Aa	40	55	4 5	0	25	35	35	40	40	%
Area Type B	Ab	0									
Area Type C	Ac	5									
Area Type D Impervious	Ad	55	45	55	95	60	55	65	60	60	%
Excess runoff rates	Α	0.80									
	В	1.08									
	C D	1.46 2.64					1.46 2.64				
Weighted E (Exces Runoff)		1.85	1.63	1.81	2.56	1.95	1.88	2.00	1.90	1.90) in
Time of Concentration		0.2	0.2	0.2	0.2	1.2	2.2	3.2	4.2	3.2	hours
Fime to Peak =0.7*Tc + ((1.6-(Ad/At)/12)		0.228	0.236	0.228	0.194	0.923	1.628	2.319	3.023	2.323	hours
Time of Base		0.410	0.846	0.846	0.810	0.842	0.843	0.778	0.845	0.845	hours
=2.107*E*At/Qp-(.25*Ad/At) Duration of Peak		0.138	0.113	0.138	0.238	0.150	0.138	0.163	0.150	0.150	hours
Time for end of peak		0.365	0.348	0.365	0.432	1.073	1.765	2.482	3.173	2.473	hours
Time when storage begins		0.073	0.000	0.000	0.194	0.129	0.057	1.439	2.156	1.362	hours
Time incoming is less that discha	arge	0.396	0.846	0.846	0.432	0.875	0.875	1.835	2.506	1.800	hours
Volume Required during storm		7.298	1.908	2.037	0.000	0.882	1.314	1.453	0.452	0.767	acre inc
		26491	6927	7393	0	3202	4770	5273	1641	2784	cubic fe



120 Vassar Drive SE Suite 100 Albuquerque New Mexico 87106 T 505 242 6880 • F 505 242 6881

CONSULTANT

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PROJECT NAME

REVISIONS:


LA VIDA LLENA 10501 LAGRIMA DE ORO NE

HAVERLAND CARTER GROUP 10701 Montgomery Boulevard NE ALBUQUERQUE NM, 87111

No.	DATE	DESCRIPTION
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Date	<u> </u>	7-31-20
Proje	ect number	28
Cad	file name	
SHE	ET TITLE	:

DRAINAGE PLAN PROPOSED CONDITIONS

SHEET NUMBER:

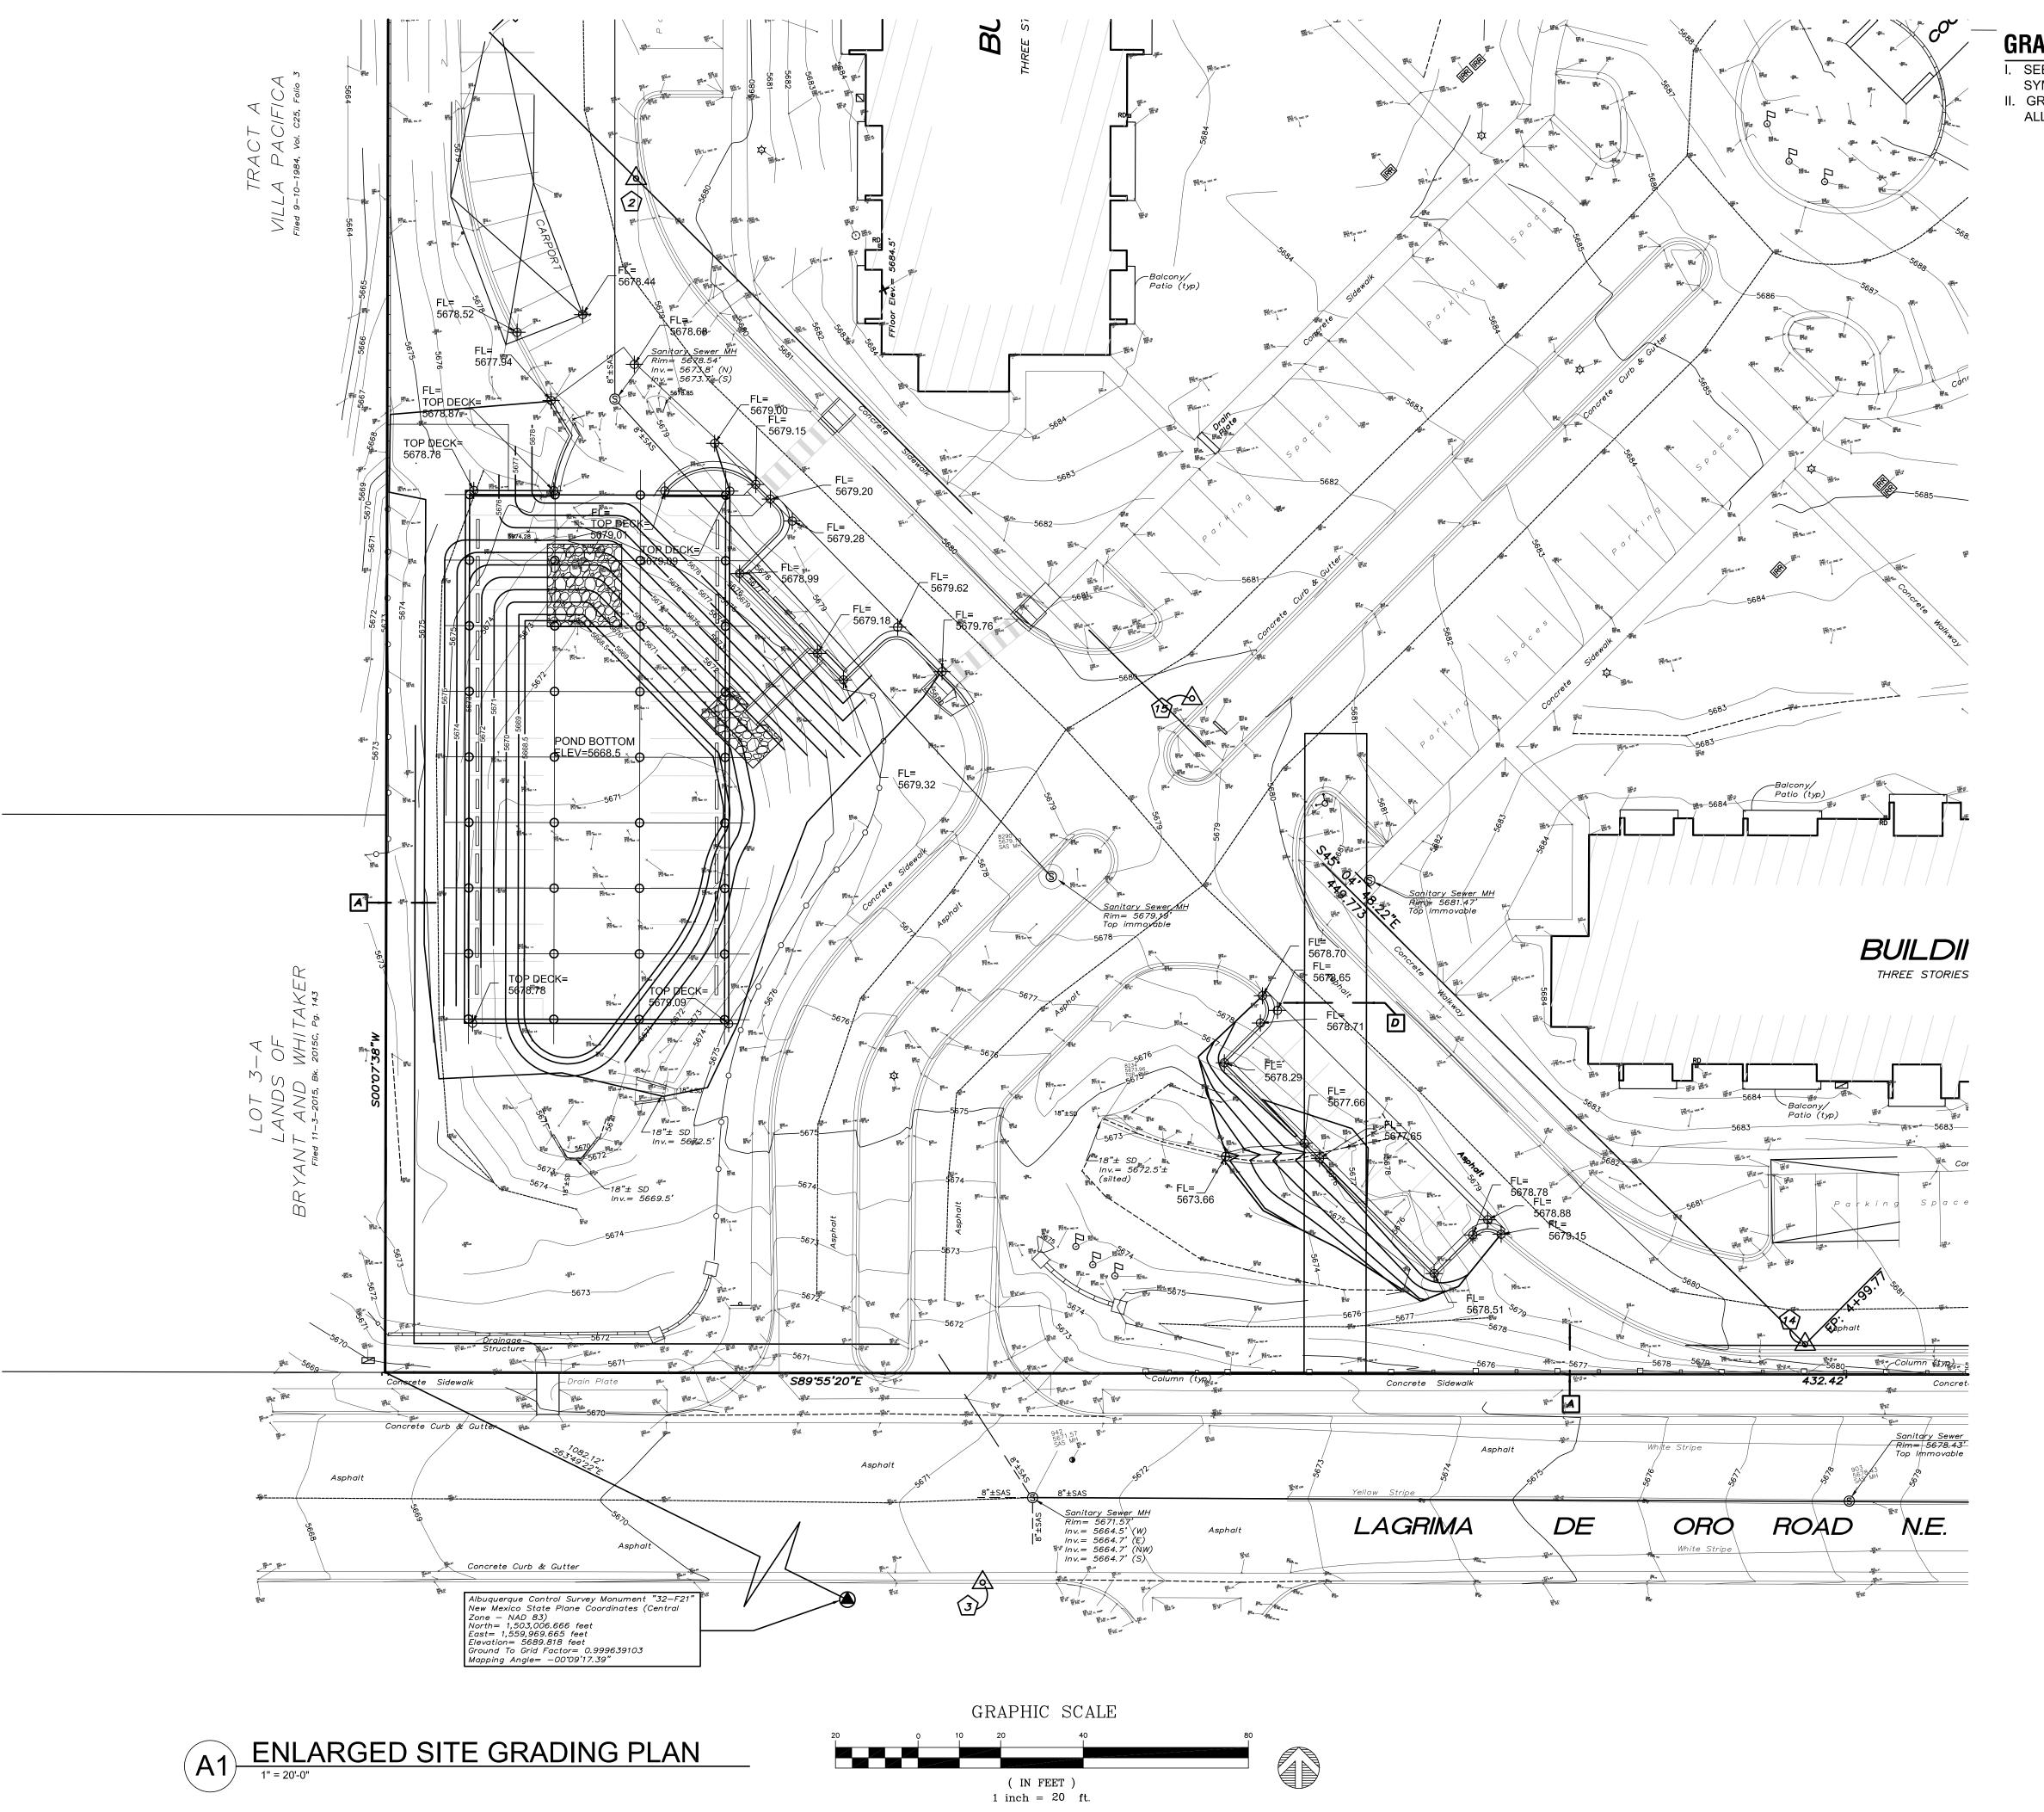

GRADING PLAN GENERAL NOTES

- I. SEE SHEET CG001 FOR COMPLETE LIST OF GENERAL NOTES AND SYMBOL/LINETYPE LEGEND THAT APPLY TO ALL SHEETS.
- II. GRADING PLAN KEYED NOTES ARE COMMON TO ALL SHEETS. NOT ALL KEYED NOTES WILL APPEAR ON EVERY PAGE.



DESIGN GROUP

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PROJECT NAME

LA VIDA LLENA LAGRIMA DE ORO

HAVERLAND CARTER GROUP Street Address ALBUQUERQUE NM, 87111


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ENLARGED SITE GRADING PLAN

SHEET NUMBER:

SHEET TITLE:

C-201




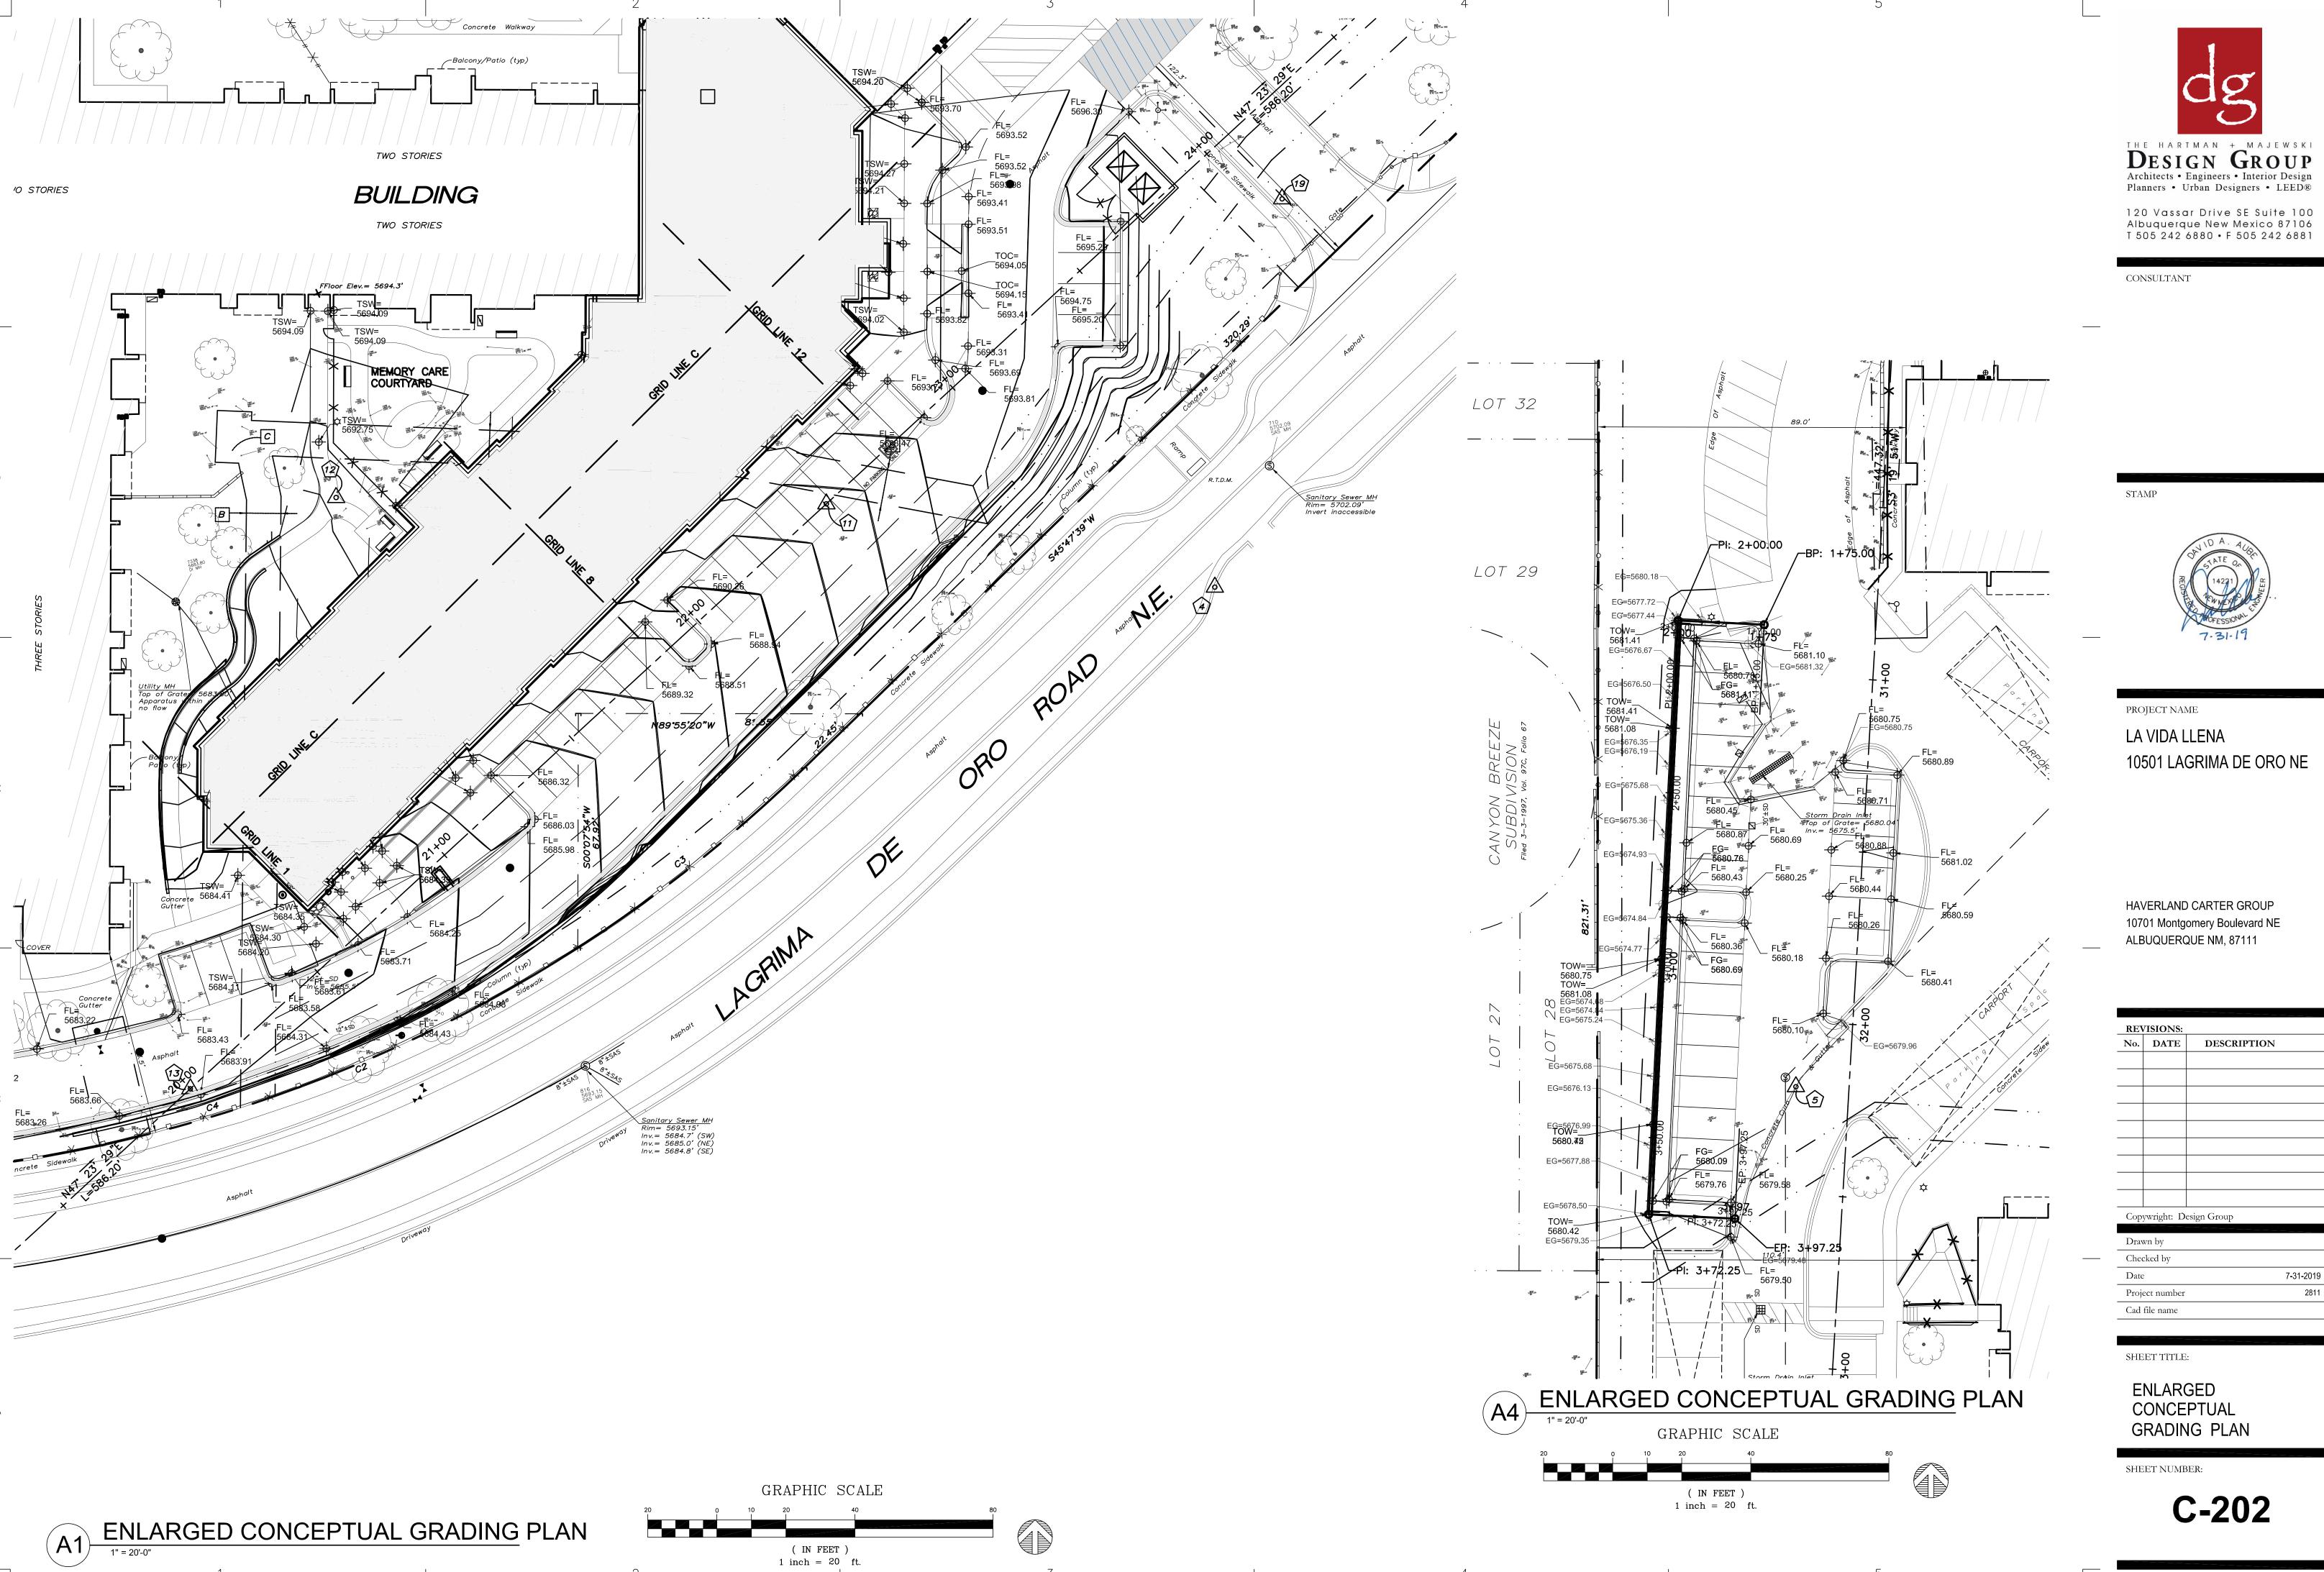


10501 LAGRIMA DE ORO NE

10701 Montgomery Boulevard NE

DESCRIPTION 7-31-2019 2811

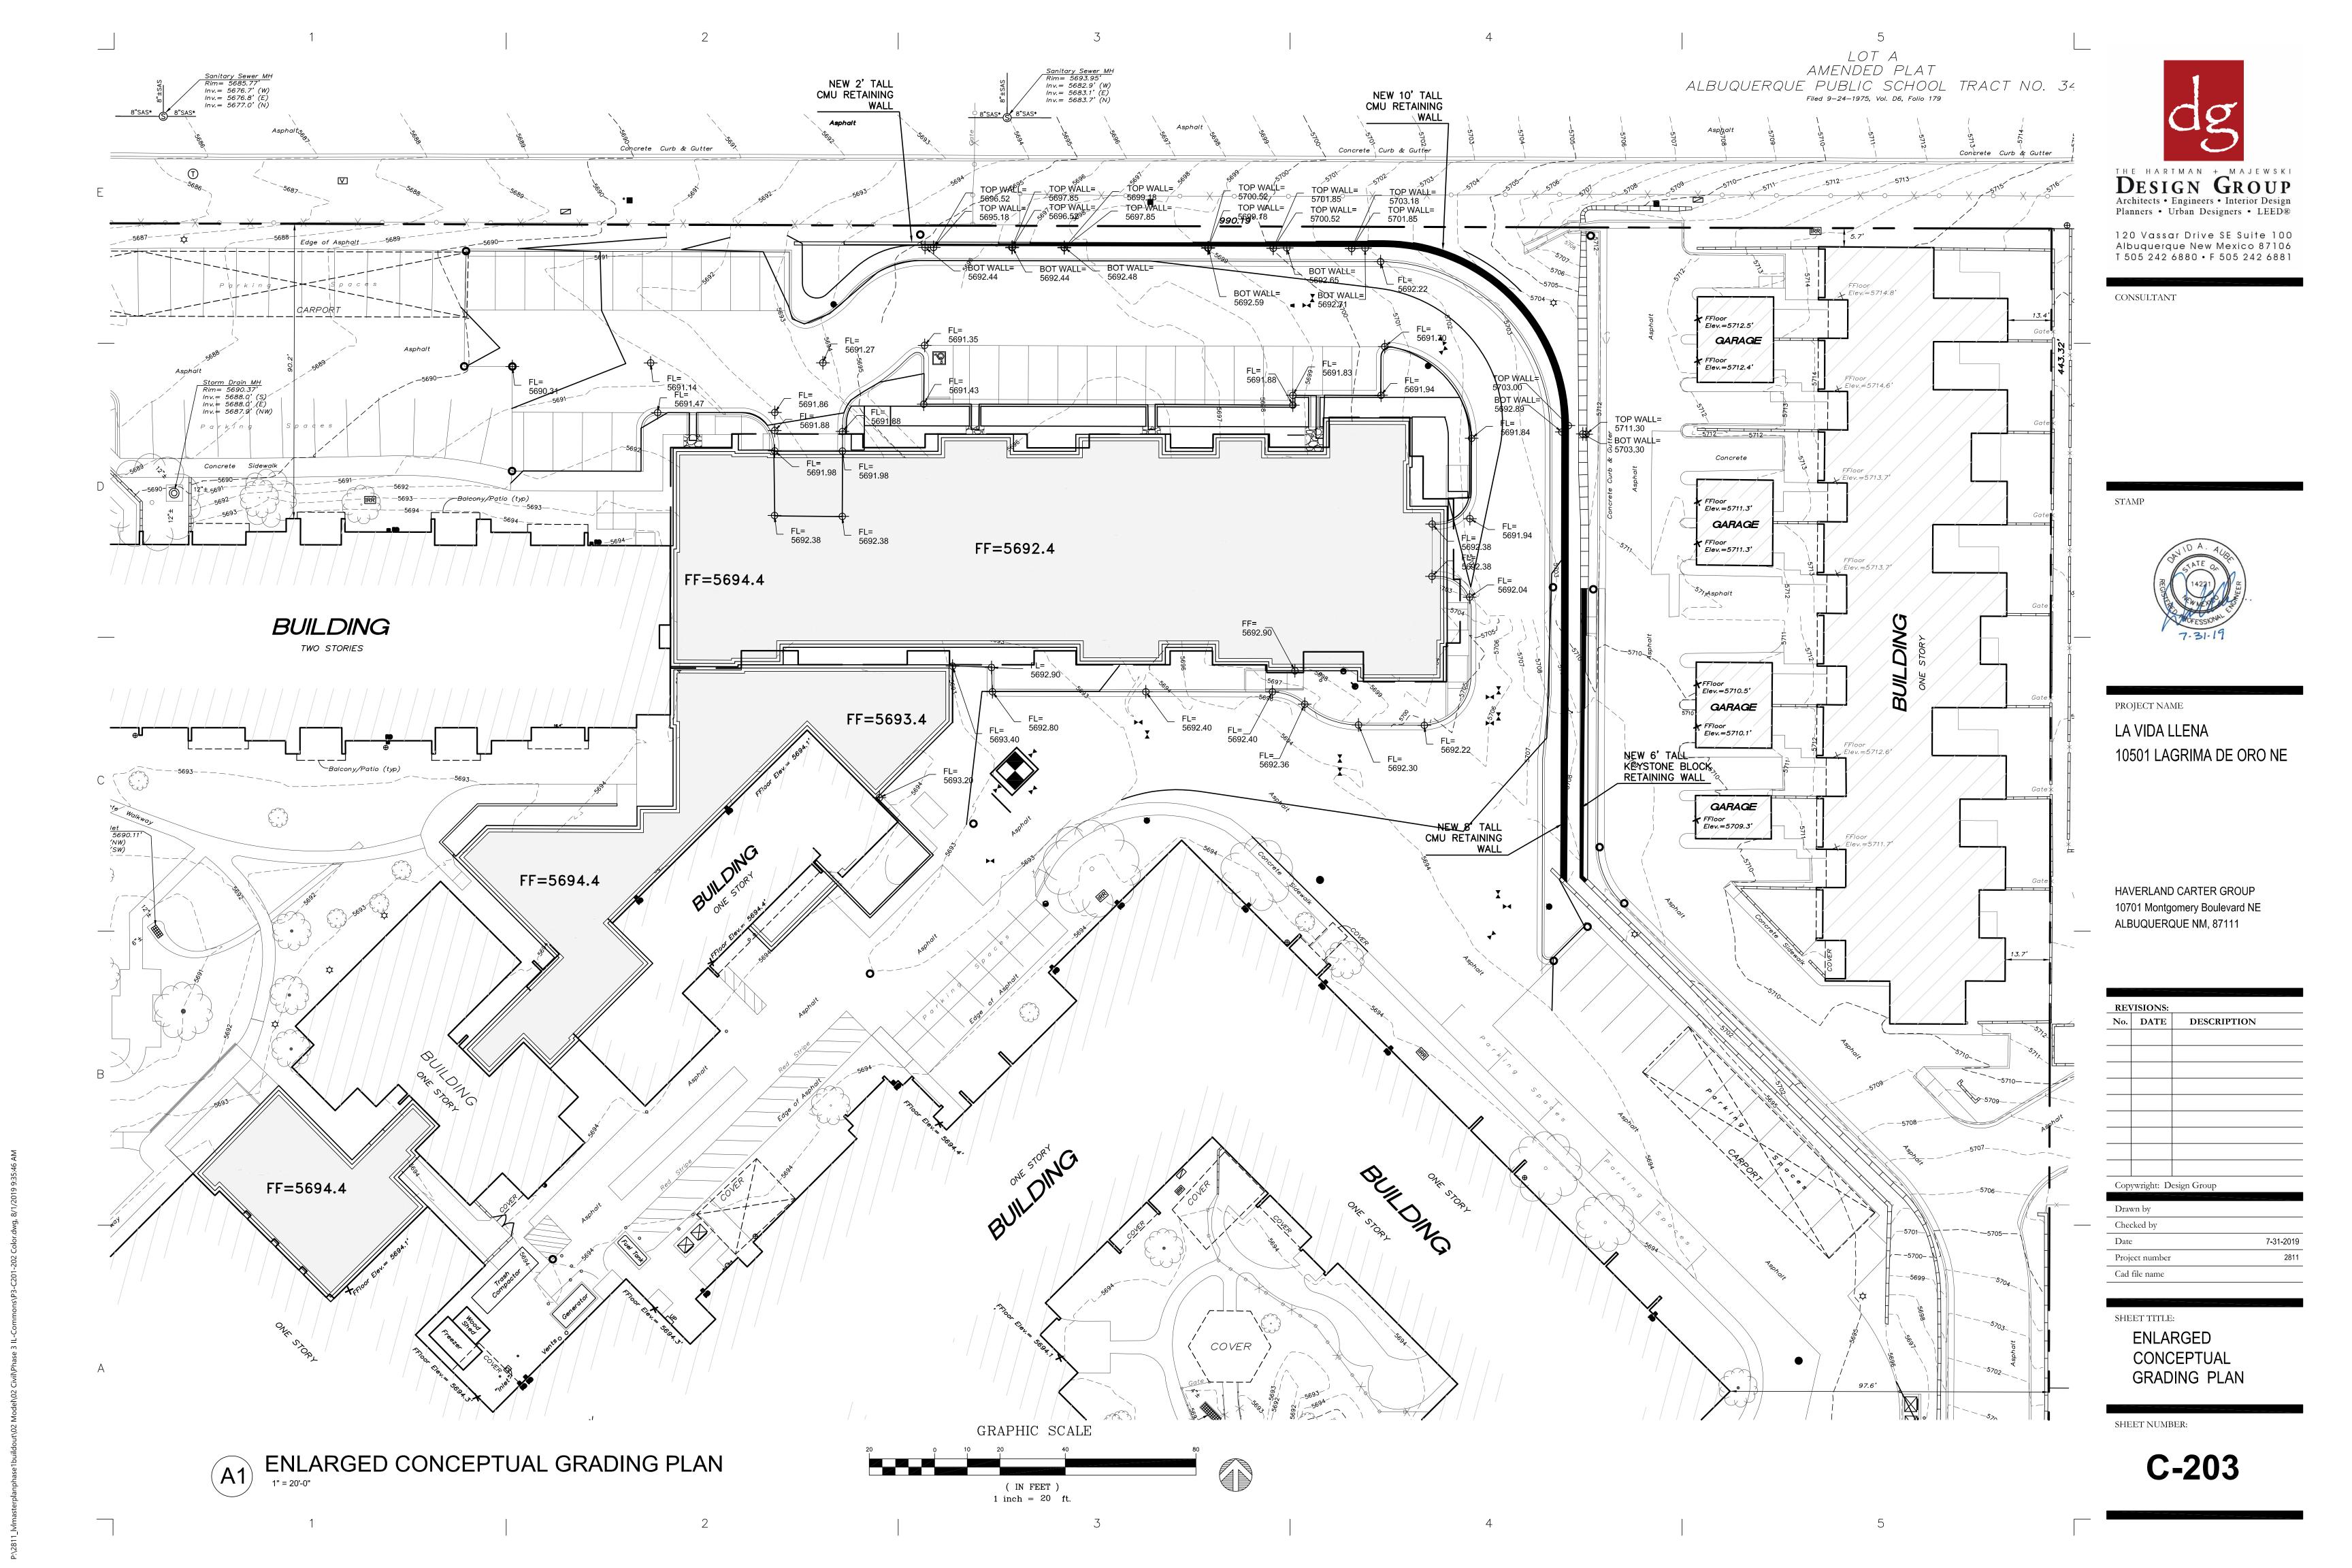

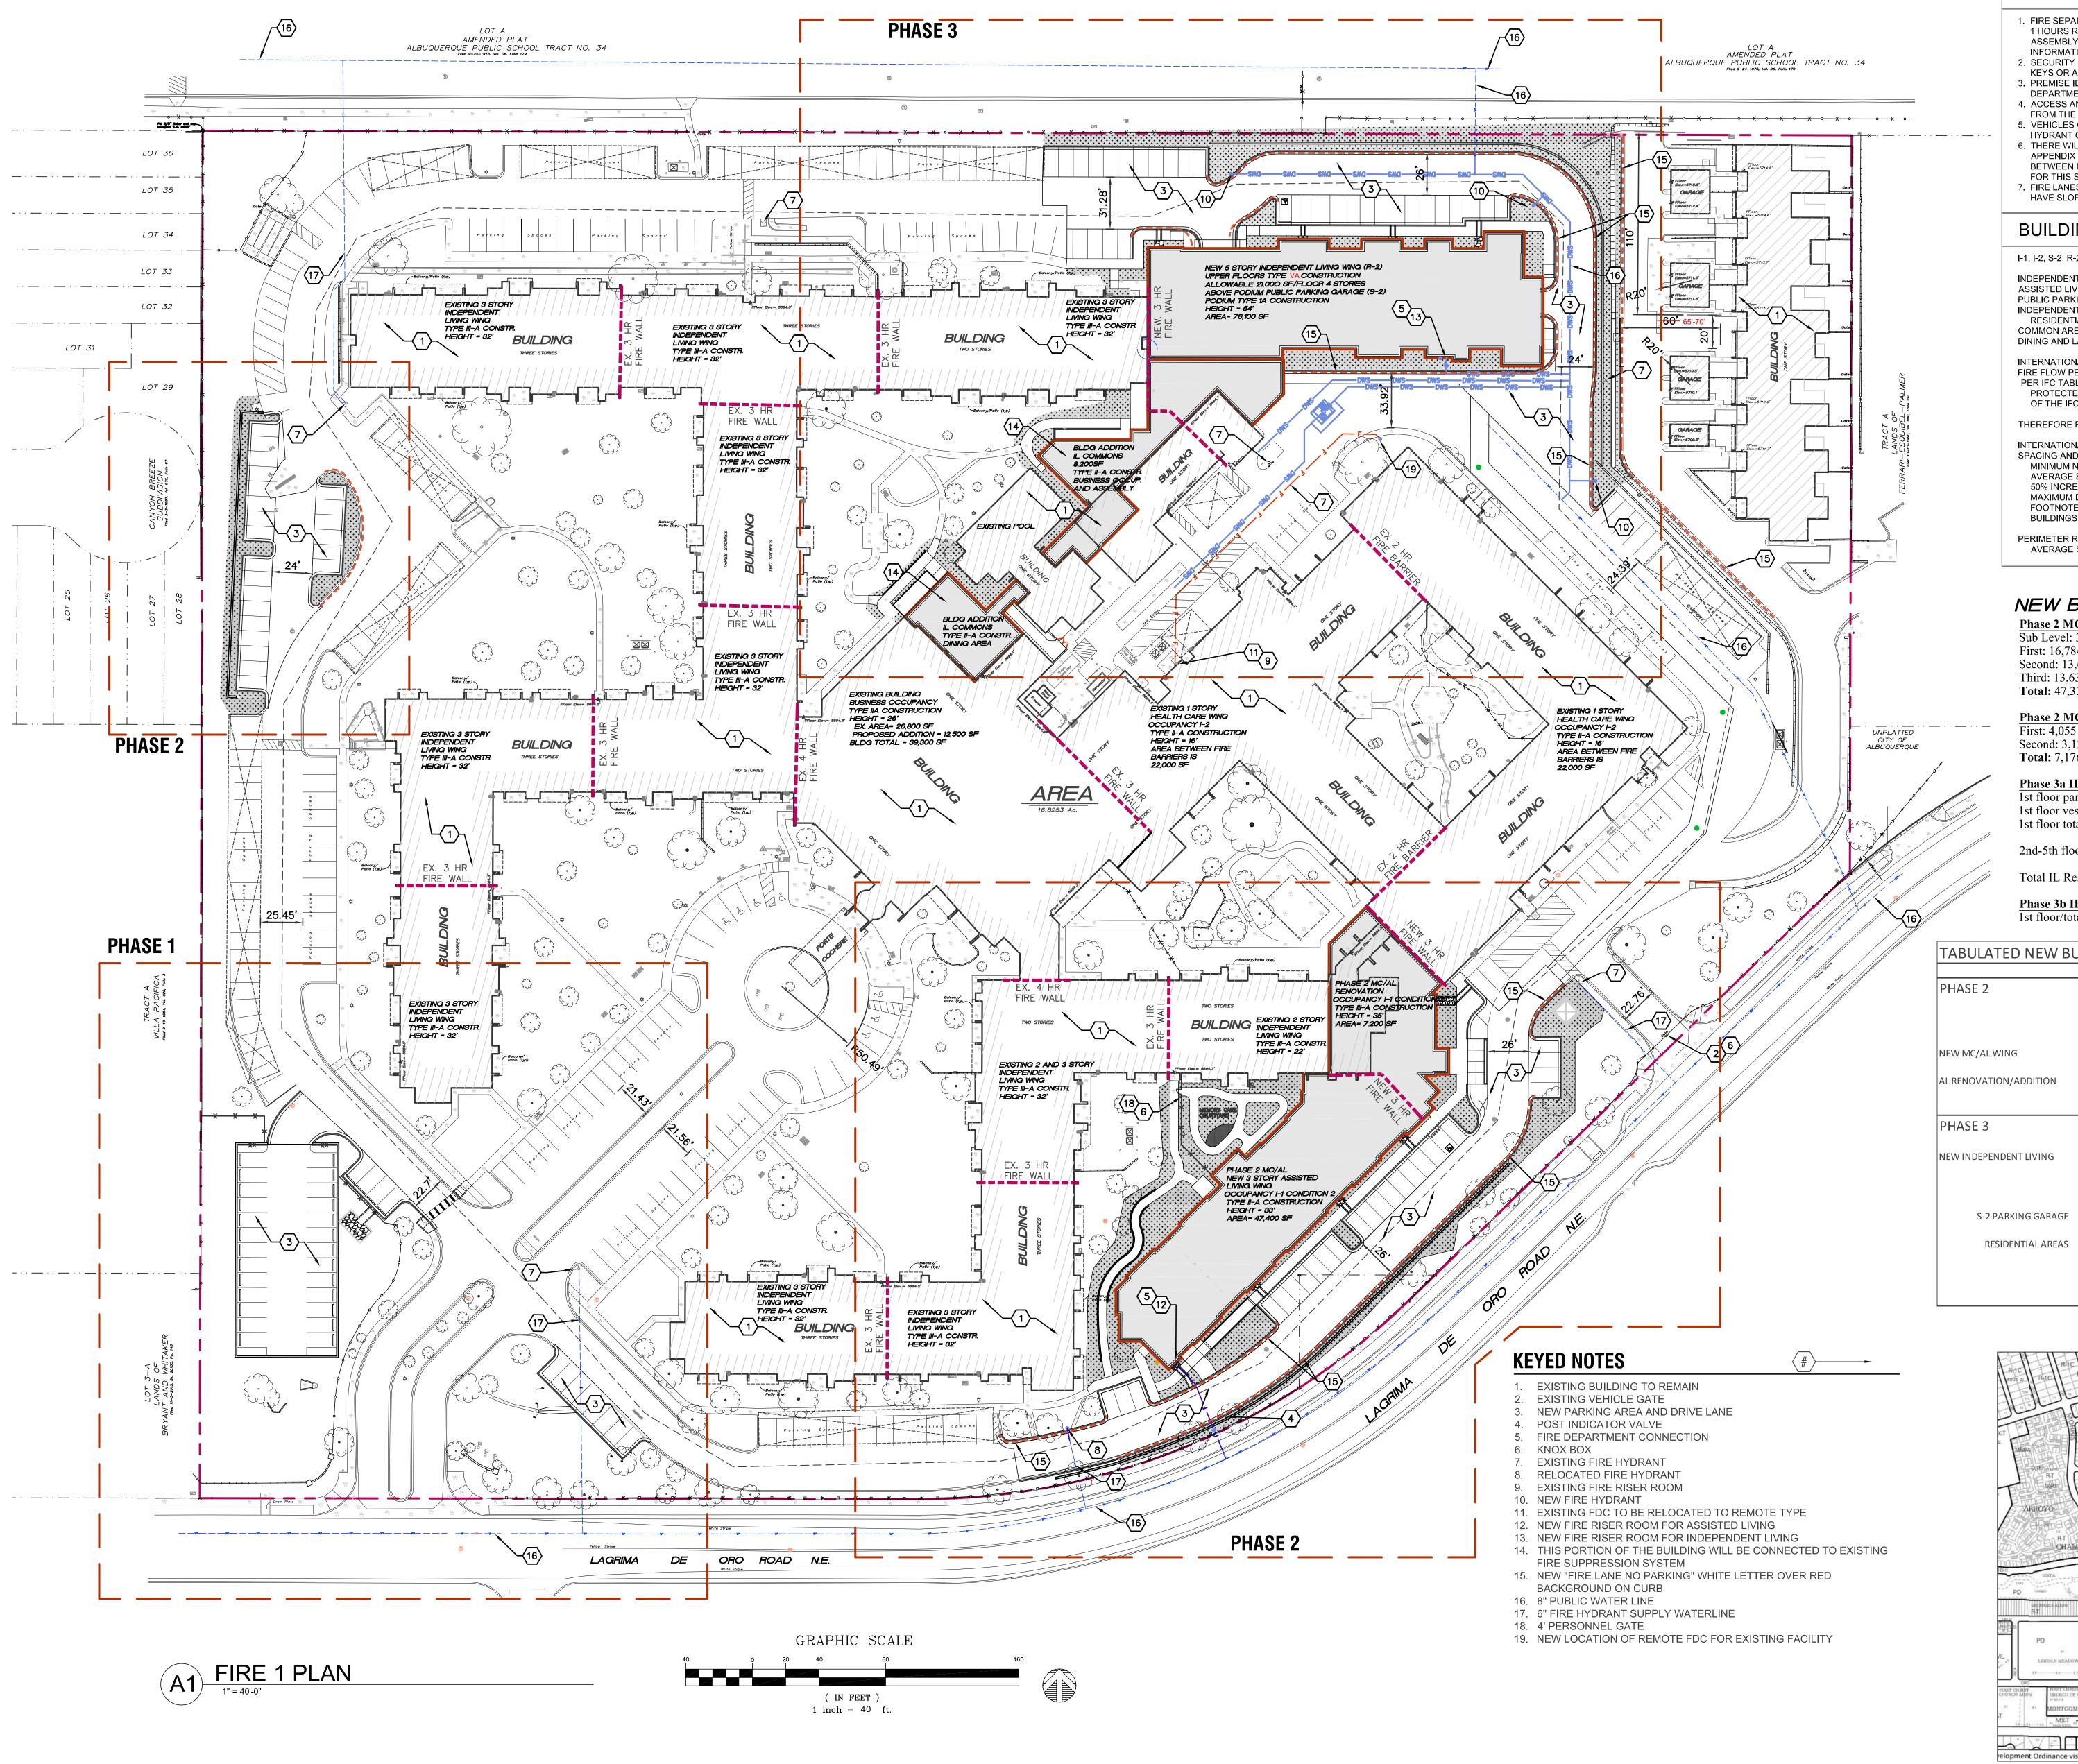

GENERAL SHEET NOTES

- 1. FIRE SEPARATION BETWEEN FLOORS CONTAINING SLEEPING QUARTERS WILL BE 1 HOURS RATED ASSEMBLIES. PLEASE REFER TO FIRE 2 PLAN FOR FLOOR ASSEMBLY RATING INFORMATION AS WELL AS FOR RATED DEMISING WALL
- 2. SECURITY GATES (BOTH PERSONNEL AND VEHICULAR) CAN BE CONTROLLED BY KEYS OR ACCESS CODES LOCATED WITHIN KNOX BOXES. 3. PREMISE IDENTIFICATION WILL BE ADDED PER CITY OF ALBUQUERQUE FIRE
- 4. ACCESS AND LOADING ZONES WILL BE IDENTIFIED IN THE FIELD PER DIRECTION FROM THE CITY OF ALBUQUERQUE FIRE DEPARTMENT. 5. VEHICLES OR OBSTRUCTIONS SHALL NOT BE LOCATED WITHIN 15' OF A FIRE HYDRANT OR 5' OF THE FDC.
- 6. THERE WILL BE A TOTAL OF 4 FIRE HYDRANTS SURROUNDING THE SITE. PER APPENDIX C, OF IFC FOR FIRE FLOWS LESS THAN 3000 GPM THE SPACING BETWEEN FIRE HYDRANTS CAN BE 400' AVERAGE. ACTUAL AVERAGE SPACING FOR THIS SITE IS 475'.

7. FIRE LANES WILL BE DESIGNED TO SUPPORT AT LEAST 75,000 POUNDS AND WILL HAVE SLOPES LESS THAN 10% GRADE.

BUILDING INFORMATION

I-1, I-2, S-2, R-2, B, AND A MIXED OCCUPANCY BUILDING, FULLY SPRINKLED INDEPENDENT LIVING IN EXISTING IS CONSIDERED I-1 (CONDITION 1) ASSISTED LIVING IS CONSIDERED I-1 (CONDITION 2) PUBLIC PARKING GARAGE IS CONSIDERED S-2

INDEPENDENT LIVING IN NEW BUILDING IS CONSIDERED R-2 (MULTI FAMILY COMMON AREAS ARE TYPICALLY B (BUSINESS OCCUPANCY) DINING AND LARGE GATHERING AREAS ARE CONSIDERED ASSEMBLY SPACES

INTERNATIONAL FIRE CODE 2015, APPENDIX B (FOR IL ADDITION - LARGEST BLDG) FIRE FLOW PER IFC TABLE B105.1(2) IS 5250 GPM (NON SPRINKLED BUILDING) PER IFC TABLE B105(1) FIRE FLOW CAN BE REDUCED TO 50% IF BUILDING PROTECTED BY AUTOMATIC SPRINKLER SYSTEM IN COMPLIANCE WITH 913.3.1.3 OF THE IFC.

THEREFORE REQUIRED FIRE FLOW IS 2,625 GPM.

INTERNATIONAL FIRE CODE 2015, APPENDIX C SPACING AND NUMBER OF HYDRANTS FOR PROPOSAL BUILDING PER TABLE C102.1 MINIMUM NUMBER OF HYDRANTS = 3 AVERAGE SPACING BETWEEN HYDRANTS = 600' PER FOOTNOTE F, ALLOWING A 50% INCREASE IN SPACING FOR SPRINKLED BUILDINGS MAXIMUM DISTANCE FROM ANY POINT ON FIRE LANE TO HYDRANT = 375' PER FOOTNOTE F, ALLOWING A 50% INCREASE IN SPACING FOR SPRINKLED

PERIMETER ROAD CONTAINS 7 HYDRANTS OVER A TRAVEL LENGTH OF 2800'. AVERAGE SPACING IS 400'

NEW BUILDING AREA BY FLOOR

Phase 2 MC+AL New First: 16,784 sf Second: 13,637 st Third: 13,637 sf **Total:** 47,338 sf

Phase 2 MC+AL Renovation First: 4,055 sf

Second: 3,121 sf

Total: 7,176 so

1st floor parking: 11,955 sf 1st floor vestibule/lobby: 1,422 sf

1st floor total: 13,377 sf

2nd-5th floor each (with balconies): 16,937 sf

Total IL Residential (with balconies): 67,748 sf above podium

Phase 3b IL Commons

1st floor/total IL Commons: 8,192 sf

TABLILATED NEW BLILLDING ADEAS AND SIDE SLOWS

PHASE 2				
			Fire Flow per Minin	num Fire
		Construction	IFC Appendix B Flow	per Table
	AREA	Type	Table B105.1(2) B105.	2
NEW MC/AL WING	47338	II-A	2250	1125
AL RENOVATION/ADDITION	7,716	III-A	1500	1000 Minimur
PHASE 3				
NEW INDEPENDENT LIVING				
			Fire Flow per Minir	num Fire
		Construction	IFC Appendix B Flow	per Table
	AREA	Туре	Table B105.1(2) B105.	2

DESIGN GROUP Architects • Engineers • Interior Design Planners • Urban Designers • LEED®

120 Vassar Drive SE Suite 100 Albuquerque New Mexico 87106

T 505 242 6880 • F 505 242 6881

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PROJECT NAME MASTERPLAN BUILDOUT PHASE 3

IL + COMMONS

10501 LAGRIMA DE ORO, NE. ALBUQUERQUE, NEW MEXICO 87111

HAVERLAND CARTER LIFESTYLE GROUP

> 948-17 PLANS CHECKING DIVISION SOFT SILES CONSTRUCTION TYPE APPROVED L'DISAPPROVE


2625 50% of

Table B105.1(2)

5250

Based on 81,125 sf

total building area

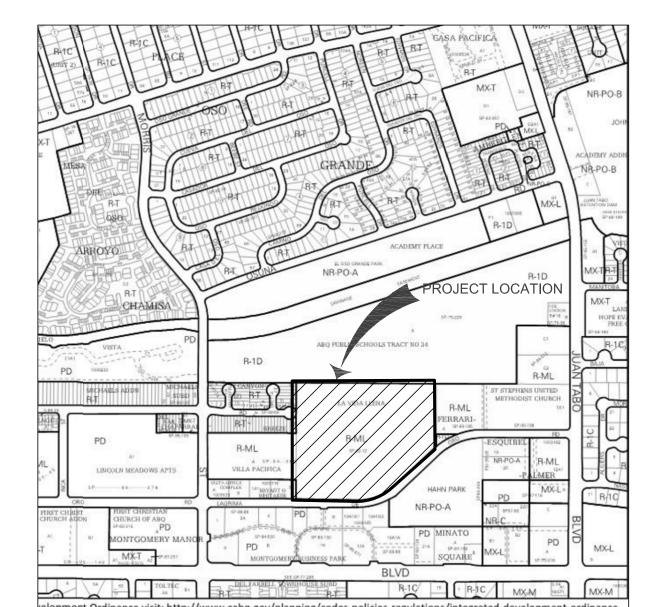

A6 ZONE ATLAS PAGE F-21 NOT TO SCALE

REVISIONS Description Copyright: Design Group May 24, 2019 Project number CAD file name SHEET TITLE

FIRE 1 PLAN

SHEET NUMBER

FIRE -1

CITY OF ALBUQUERQUE

PLANNING DEPARTMENT URBAN DESIGN & DEVELOPMENT DIVISION 600 2nd Street NW, 3rd Floor, 87102 P.O. Box 1293, Albuquerque, NM 87103 Office (505) 924-3860 Fax (505) 924-3339



OFFICIAL NOTIFICATION OF DECISION

June 13, 2019

Project #2019-002114 (1003807)

La Vida Llena 10501 Lagrima De Oro Rd NE ABQ, NM 87111 SI-2019-00117 – Major Amendment Site Development Plan VA-2019-00152 – Variance

VA-2019-00179 - Variance

LEGAL DESCRIPTION:

The above action for all or a portion of Amended Plat Land in Section 33 T11N R4E La Vida Lena, zoned R-ML, located at 10501 Lagrima de Oro Rd. NE, between Morris St. NE, and Juan Tabo Blvd. NE, containing approximately 17 acres. (C-8)

Staff Planner: Cheryl Somerfeldt

PO Box 13, 2019 the Environmental Planning Commission (EPC) voted to APPROVE Project 2019-002114/SI-2019-00117, a Major Amendment Site Development Plan, VA-2019-00152, a Variance, and VA-2019-00179, a Variance, based on the following Findings.

Albuquerque

FINDINGS, SI-2019-00117, Major Amendment to a Prior Approval, Site Development Plan

This is a request for a Major Amendment to a Prior Approval, Site Development Plan for the La Vida Llena Retirement Community complex for all or a portion of Amended Plat Land in Section 33 T11N R4E La Vida Lena, located at 10501 Lagrima de Oro Road NE, and containing approximately 16.9 acres.

- 2. The applicant wishes to add two new buildings and a parking area to the existing Site Development Plan for Building Permit. This approved Site Plan-EPC will replace the pre-existing Site Development Plan.
 - 3. The proposed "Assisted Living Facility or Nursing Home" use is Permissive within the existing R-ML zone.
 - 4. The Site Development Plan for Building Permit that originally permitted the La Vida Llena (LVL) complex was approved by the Environmental Planning Commission (EPC) in June of 1981 (Z-80-135) in conjunction with the zone change to SU-1 for Retirement Center/Nursing Home. LVL opened its doors in 1983.
 - 5. In 2012, LVL opened a 4-story building containing 58 Independent Living units at the southwest corner of Lagrima de Oro and Juan Tabo.

OFFICIAL NOTICE OF DECISION Project #2019-002114 June 13, 2019 Page 2 of 13

- 6. In May of 2018, the Integrated Development Ordinance (IDO) converted the property's previous zoning, SU-1 for Retirement Center/Nursing Home, which was Site Plan controlled, to R-ML with an existing Site Plan pursuant to City Council adopted conversion rules: the existing use, Assisted Living Facility or Nursing Home, is first permitted in the R-ML zone.
- 7. The Albuquerque/Bernalillo County Comprehensive Plan and the City of Albuquerque Integrated Development Ordinance (IDO) are incorporated herein by reference and made part of the record for all purposes.
- 8. The subject site is located in an Area of Change as designated by the Comprehensive Plan. Areas of Change are intended to be the focus of urban-scale development that benefits job growth and housing opportunities.
- 9. The Comprehensive Plan designates Montgomery Boulevard NE to the south as a Major Transit Corridor which is intended to prioritize high-frequency transit in Corridors consistent with regional transportation plans. Applicable policies include:
 - 5.1.10 Major Transit Corridors: Foster corridors that prioritize high-frequency transit service with pedestrian-oriented development.
 - a) Encourage higher-density residential developments within ¼ mile of transit stops or stations.
 - b) Minimize negative impacts on nearby neighborhoods by providing transitions between development along Transit Corridors and abutting single-family residential areas.
 - 5.6 City Development Areas: Encourage and direct growth to Areas of Change where it is expected and desired and ensure that development in and near Areas of Consistency reinforces the character and intensity of the surrounding area.
 - 9.1.1 Housing Options: Support the development, improvement, and conservation of housing for a variety of income levels and types of residents and households.
 - a) Increase the supply of housing that is affordable for all income levels.
 - c) Assure the availability of a wide distribution of quality housing for all persons regardless of race, color, religion, sex, national origin, ancestry, age, or disabled status.
 - e) Provide for the development of quality housing for elderly residents.
 - 9.2.2 High Quality: Encourage quality and innovation in new housing design and construction, materials, and energy and water conservation.
- 10. The attached Site Development Plan has been evaluated for conformance with applicable regulations and policies of the City adopted Integrated Development Ordinance (IDO) and the Comprehensive Plan. The Conditions of Approval correspond to the Site Development Plan elements that do not conform to the requirements of applicable IDO regulations.
- 11. The applicant notified the District 8 Coalition of Neighborhood Associations and property owners within 100 feet of the subject site as required. A neighborhood meeting occurred with the District 8 Coalition of Neighborhood Associations on May 23, 2019.

OFFICIAL NOTICE OF DECISION Project #2019-002114 June 13, 2019 Page 3 of 13

- 12. The applicant performed outreach with its residents since 2017.
- 13. In total, staff received two (2) letters in opposition to the request from residents of La Vida Llena including a petition with seven (7) names.
- 14. In total, staff received seventeen (17) letters in support to the request from residents of La Vida Llena.
- 15. Staff received a letter of support from CNM (Central New Mexico Community College), the property owner to the north.
- 16. Staff has not received comments in support or opposition from the District 8 Coalition of Neighborhood Associations or from the property owners to the west of La Vida Llena.

CONDITIONS OF APPROVAL, SI-2019-00117, Major Amendment to a Prior Approval, Site Development Plan

- 1. The applicant shall coordinate with the staff planner to ensure that all Conditions of Approval are met and then submit a vetted, final version after DRB review and approval of technical standards to the staff planner for filing at the Planning Department in the project file.
- 2. The Site Development Plan shall comply with the General Regulations of the IDO, the Subdivision Ordinance, and all other applicable design regulations, except as specifically approved by the EPC.
- 3. The Site Plan shall note any Variance-EPC that has been granted/approved.
- 4. The Site Plan be reviewed and approved by the Development Review Board (DRB) subsequent to EPC approval for review of technical standards.
- 5. Pursuant to Table 5-1-1, Usable Open Space is required to be 200 square foot per Efficiency unit. The Site Plan shall meet the applicable regulation for Usable Open Space and the applicant shall show this in a calculation on the Site Plan.
- 6. The Site Plan shall provide, pursuant to IDO Section 5-5(E)(4)(e), where the primary use includes 100 or more dwelling units, 20 percent of required bicycle spaces should be in secured long term storage lockers, approximately 6 lockers.
- 7. The Site Plan shall illustrate to the satisfaction of the City Engineer, pursuant to 5-7(F)(1)(a), retaining walls limited to 6-feet unless a higher wall is approved by the City Engineer as necessary. Pursuant to 5-7(F)(1)(b), Retaining walls higher than 6-feet tall shall be terraced. Pursuant to 5-7(F)(2), the terraces should be broken by at least 4-feet wide planters/pockets for landscaping unless reduced by approval by the City Engineer.
- 8. The Site Plan shall provide, pursuant to IDO Section 5-9(E)(2), a minimum 6-foot high opaque wall as required to visually screen the new parking lots bordering Protected Lots, which includes the townhouses to the west. The proposed wall on the west side of the parking lot shall be increased from 42" to 72".

OFFICIAL NOTICE OF DECISION Project #2019-002114 June 13, 2019 Page 4 of 13

9. Conditions of Approval from other agencies:

Transportation Development Services

- Developer is responsible for permanent improvements to the transportation facilities adjacent to the proposed development site plan, as required by the Development Review Board (DRB)
- Site plan shall comply and be in accordance with all applicable City of Albuquerque requirements, including the Development Process Manual and current ADA criteria.

The following comments need to be addressed prior to DRB:

• Please provide referenced detail sheet C-501 for review along with this set.

Police Department/Planning

- Ensure adequate lighting throughout the project, to include parking areas, pedestrian walkways, and courtyards.
- Limit and clearly delineate access to the property; i.e. Resident Parking and Visitor Parking.
- Install No Trespassing signs that cite the City Ordinance so that they are visible immediately upon entering the property.

Solid Waste Management Department

• The new/proposed bldg #38/IL Wing on Pg. SP-EPC-1 appears to hinder refuse driver's turnaround/back up access to existing refuse compactor. Adjust per SWM requirements.

Albuquerque Bernalillo County Water Utility Authority (ABCWUA)

- From the proposed Utility Plan, it is understood that several fire lines, sanitary sewer services, and a large meter service are required for the two proposed structures. In addition to the desired infrastructure there is also need for the public waterline (onsite) to be relocated. Prior to these infrastructure improvements being performed, an Availability Statement must first be executed for the site.
- As a condition of approval please request an availability statement here: http://www.abcwua.org/Availability_Statements.aspx
- Request shall include a City Fire Marshal approved Fire 1 Plan and a zone map showing the site location.
- Please note that a work order process will be required for the relocation of the existing public onsite waterline.
- Please note that all onsite public waterline shall be within a public waterline easement. Existing waterline easements that will not be utilized should be abandoned.
- All onsite hydrants shall be considered private and painted safety orange.

OFFICIAL NOTICE OF DECISION Project #2019-002114 June 13, 2019 Page 5 of 13

Public Service Company of New Mexico (PNM)

- There are numerous electric utility easements on the property serving La Vida Llena. It is the applicant's obligation to abide by any conditions or terms of those easements and required clearances. The applicant will need to coordinate with PNM's New Service Delivery Department regarding proposed building location, proposed tree species and building heights in order to ensure sufficient safety clearances and to avoid interference with the existing overhead and underground distribution facilities. Any relocation, changes or realignment of existing electric utilities will be the developer's expense. PNM's standard is for trees to be planted outside the PNM easement.
- It will be necessary to contact the PNM New Service Delivery Department to coordinate electric service regarding this project. Contact: Andrew Gurule, PNM Service Center, 4201 Edith Boulevard NE, Albuquerque, NM 87107, Phone: (505) 241-0589.

OFFICIAL NOTICE OF DECISION Project #2019-002114 June 13, 2019 Page 6 of 13

FINDINGS, VA-2019-00152, Variance to R-ML Building Height

- 1. This is a request for a 12-foot 9-inch (ALMC building) and a 29-foot 1.5-inch (IL building) Variance to the 35-foot maximum building height in the R-ML Zone pursuant to IDO Table 2-3-9, for the La Vida Llena Retirement Community complex for all or a portion of Amended Plat Land in Section 33 T11N R4E La Vida Lena, located at 10501 Lagrima de Oro Road NE, and containing approximately 16.9 acres.
- 2. The applicant wishes to add two new buildings and a parking area to the existing Site Development Plan for Building Permit.
- 3. The proposed use of "Assisted Living Facility or Nursing Home" is Permissive within the existing R-ML zone.
- 4. The Site Development Plan for Building Permit that originally permitted the La Vida Llena (LVL) complex was approved by the Environmental Planning Commission (EPC) in June of 1981 (Z-80-135) in conjunction with the zone change to SU-1 for Retirement Center/Nursing Home. LVL opened its doors in 1983.
- 5. In 2012, LVL opened a 4-story building containing 58 Independent Living units in very close proximity at the southwest corner of Lagrima de Oro and Juan Tabo.
- 6. In May of 2018, the Integrated Development Ordinance (IDO) converted the property's previous zoning, SU-1 for Retirement Center/Nursing Home, which was Site Plan controlled, to R-ML with an existing Site Plan pursuant to City Council adopted conversion rules: the existing use, Assisted Living Facility or Nursing Home, is first permitted in the R-ML zone.
- The Albuquerque/Bernalillo County Comprehensive Plan and the City of Albuquerque Integrated Development Ordinance (IDO) are incorporated herein by reference and made part of the record for all purposes.
- 8. The subject site is located in an Area of Change as designated by the Comprehensive Plan. Areas of Change are intended to be the focus of urban-scale development that benefits job growth and housing opportunities.
- 9. The Comprehensive Plan designates Montgomery Boulevard NE to the south as a Major Transit Corridor which is intended to prioritize high-frequency transit in Corridors consistent with regional transportation plans. Applicable policies include:
 - 5.1.10 Major Transit Corridors: Foster corridors that prioritize high-frequency transit service with pedestrian-oriented development.
 - a) Encourage higher-density residential developments within ¼ mile of transit stops or stations.
 - b) Minimize negative impacts on nearby neighborhoods by providing transitions between development along Transit Corridors and abutting single-family residential areas.
 - 5.6 City Development Areas: Encourage and direct growth to Areas of Change where it is
 expected and desired and ensure that development in and near Areas of Consistency
 reinforces the character and intensity of the surrounding area.

OFFICIAL NOTICE OF DECISION Project #2019-002114 June 13, 2019 Page 7 of 13

- 9.1.1 Housing Options: Support the development, improvement, and conservation of housing for a variety of income levels and types of residents and households.
 - a) Increase the supply of housing that is affordable for all income levels.
 - c) Assure the availability of a wide distribution of quality housing for all persons regardless of race, color, religion, sex, national origin, ancestry, age, or disabled status.
 - e) Provide for the development of quality housing for elderly residents.
- 9.2.2 High Quality: Encourage quality and innovation in new housing design and construction, materials, and energy and water conservation.
- 10. Pursuant to IDO Section 6-6(M)(3) Review and Decision Criteria, "an application for a Variance-EPC shall be approved if it meets all of the following criteria":
 - 1) 6-6(N)(3)(a) There are special circumstances applicable to the subject property that are not self-imposed and that do not apply generally to other property in the same zone district and vicinity, including but not limited to size, shape, topography, location, surroundings, and physical characteristics, and such special circumstances were created either by natural forces or by government eminent domain actions for which no compensation was paid. Such special circumstances of the property either create an extraordinary hardship in the form of a substantial and unjustified limitation on the reasonable use or return on the property, or practical difficulties result from strict compliance with the minimum standards.
 - The applicant argues and the EPC agrees the existing topography and the shape of the lot as special circumstances applicable to the subject property that are not self-imposed and do not apply generally to other property in the same zone district and vicinity, and which create practical difficulties. Although one of these aspects alone may not pose an extraordinary hardship, the two together limits the area where buildings may be constructed on the subject site. The Site Plan locates the proposed buildings in the configuration shown, adjacent to the front and rear property line in order to limit the effect on surrounding properties while managing difficulties with the topography and lot shape and adding stories.
 - 2) 6-6(N)(3)(b) The Variance will not be materially contrary to the public safety, health, or welfare. The applicant cites reasons regarding the research into the well-being of seniors why the proposed project will contribute to the health and welfare of the public. There is no evidence to the contrary that extra height and closeness of the parking area, as long as there is the required screening wall and landscaped buffer will be un-safe or unhealthy or contrary to public welfare. The property to the north is occupied by the local community college, CNM. The nursing program coordinates with LVL for student interaction with residents and there is cross access from users of each site, which contributes to public welfare. The property immediately across the street to the south (zoned NR-PO-A) is occupied by little league baseball fields and other properties across Lagrima de Oro are zoned PD and used for office use, which means residences will not be affected.

3) The Variance does not cause significant material adverse impacts on surrounding properties or infrastructure improvements in the vicinity.

To the north the subject site is adjacent to the CNM campus, which is zoned R-1D low density residential. CNM, a subdivision of the State, is immune from compliance with City zoning, and has developed the campus with buildings of considrably large mass and large parking lots as is needed by a community college. Therefore, because low density residential development does not occur on the lot, it is not a "Protected Lot" pursuant to IDO Section 5-9. In addition, the subject site is below the natural grade of the adjacent CNM property, and therefore, the height impact will be lessened. CNM has submitted a letter in support of the LVL project proposal.

To the south of the subject site, across the street, are little-league baseball fields zoned NR-PO-A. Other properties across Lagrima de Oro are zoned PD and are used for commercial office use. Further to the south is the commercial area along Montgomery Boulevard NE, a Major Transit Corridor. Therefore, because they are non-residential uses, the request will not materially adversely affect these properties.

4) The Variance will not materially undermine the intent and purpose of this IDO or the applicable zone district.

The purpose of the IDO is to:

- 1-3(A) Implement the adopted Albuquerque/Bernalillo County Comprehensive Plan (ABC Comp Plan), as amended.
- 1-3(B) Ensure that all development in the City is consistent with the spirit and intent of any other plans and policies adopted by City Council.
- 1-3(C) Ensure the provision of adequate public facilities and services for new development.
- 1-3(D) Protect the quality and character of residential neighborhoods.
- 1-3(E) Promote the economic development and fiscal sustainability of the City.
- 1-3(F) Provide for the efficient administration of City land use and development regulations.
- 1-3(G) Protect the health, safety, and general welfare of the public.
- 1-3(H) Provide for orderly and coordinated development patterns.
- 1-3(I) Encourage the conservation and efficient use of water and other natural resources.
- 1-3(J) Implement a connected system of parks, trails, and open spaces to promote improved outdoor activity and public health.
- 1-3(K) Provide reasonable protection from possible nuisances and hazards and to otherwise protect and improve public health.
- 1-3(L) Encourage efficient and connected transportation and circulation systems for motor vehicles, bicycles, and pedestrians.

The purpose of the R-ML zone district is to provide for a variety of low- to medium-density housing options. The primary land uses are townhouses and low-density multi-family buildings, as well as civic and institutional uses, such as Assisted Living, to serve the surrounding residential areas.

In general, the request will not materially undermine the intent and purpose of applicable zone district because it provides expanded housing options and parking options for senior residents. This Variance is appropriate given the history and context of the subject site and the surrounding area.

OFFICIAL NOTICE OF DECISION Project #2019-002114 June 13, 2019 Page 9 of 13

5) The Variance approved is the minimum necessary to avoid extraordinary hardship or practical difficulties.

This Variance is the minimum necessary to avoid extraordinary hardship or practical difficulties for this institutional facility that provides a needed service for seniors at this facility.

- 11. The applicant notified the District 8 Coalition of Neighborhood Associations and property owners within 100 feet of the subject site as required. A neighborhood meeting occurred with the District 8 Coalition of Neighborhood Associations on May 23, 2019.
- 12. The applicant performed outreach with its residents since 2017.
- 13. In total, staff received two (2) letters in opposition to the request from residents of La Vida Llena including a petition with seven (7) names.
- 14. In total, staff received seventeen (17) letters in support to the request from residents of La Vida Llena.
- 15. Staff received a letter of support from CNM (Central New Mexico Community College), the property owner to the north.
- 16. Staff has not received comments in support or opposition from the District 8 Coalition of Neighborhood Associations or from the property owners to the west of La Vida Llena.

OFFICIAL NOTICE OF DECISION Project #2019-002114 June 13, 2019 Page 10 of 13

FINDINGS, VA-2019-00179, Variance to Neighborhood Edges

- 1. This is a request for a 30-foot Variance from the required 50-foot parking area separation pursuant to Neighborhood Edges IDO Section 5-9(F)(1), for the La Vida Llena Retirement Community complex for all or a portion of Amended Plat Land in Section 33 T11N R4E La Vida Lena, located at 10501 Lagrima de Oro Road NE, and containing approximately 16.9 acres.
- 2. The applicant wishes to add two new buildings and a parking area to the existing Site Development Plan for Building Permit.
- 3. The proposed use of "Assisted Living Facility or Nursing Home" is Permissive within the existing R-ML zone.
- 4. The Site Development Plan for Building Permit that originally permitted the La Vida Llena (LVL) complex was approved by the Environmental Planning Commission (EPC) in June of 1981 (Z-80-135) in conjunction with the zone change to SU-1 for Retirement Center/Nursing Home. LVL opened its doors in 1983.
- 5. In 2012, LVL opened a 4-story building containing 58 Independent Living units at the southwest corner of Lagrima de Oro and Juan Tabo.
- 6. In May of 2018, the Integrated Development Ordinance (IDO) converted the property's previous zoning, SU-1 for Retirement Center/Nursing Home, which was Site Plan controlled, to R-ML with an existing Site Plan pursuant to City Council adopted conversion rules: the existing use, Assisted Living Facility or Nursing Home, is first permitted in the R-ML zone.
- 7. The Albuquerque/Bernalillo County Comprehensive Plan and the City of Albuquerque Integrated Development Ordinance (IDO) are incorporated herein by reference and made part of the record for all purposes.
- 8. The subject site is located in an Area of Change as designated by the Comprehensive Plan. Areas of Change are intended to be the focus of urban-scale development that benefits job growth and housing opportunities.
- 9. The Comprehensive Plan designates Montgomery Boulevard NE to the south as a Major Transit Corridor which is intended to prioritize high-frequency transit in Corridors consistent with regional transportation plans. Applicable policies include:
 - 5.1.10 Major Transit Corridors: Foster corridors that prioritize high-frequency transit service with pedestrian-oriented development.
 - a) Encourage higher-density residential developments within ¼ mile of transit stops or stations.
 - b) Minimize negative impacts on nearby neighborhoods by providing transitions between development along Transit Corridors and abutting single-family residential areas.
 - 5.6 City Development Areas: Encourage and direct growth to Areas of Change where it is expected and desired and ensure that development in and near Areas of Consistency reinforces the character and intensity of the surrounding area.
 - 9.1.1 Housing Options: Support the development, improvement, and conservation of housing for a variety of income levels and types of residents and households.

OFFICIAL NOTICE OF DECISION Project #2019-002114 June 13, 2019 Page 11 of 13

- a) Increase the supply of housing that is affordable for all income levels.
- c) Assure the availability of a wide distribution of quality housing for all persons regardless of race, color, religion, sex, national origin, ancestry, age, or disabled status.
- e) Provide for the development of quality housing for elderly residents.
- 9.2.2 High Quality: Encourage quality and innovation in new housing design and construction, materials, and energy and water conservation.
- 10. Pursuant to IDO Section 6-6(M)(3) Review and Decision Criteria, "an application for a Variance-EPC shall be approved if it meets all of the following criteria":
 - 1) 6-6{N){3}{a} There are special circumstances applicable to the subject property that are not self-imposed and that do not apply generally to other property in the same zone district and vicinity, including but not limited to size, shape, topography, location, surroundings, and physical characteristics, and such special circumstances were created either by natural forces or by government eminent domain actions for which no compensation was paid. Such special circumstances of the property either create an extraordinary hardship in the form of a substantial and unjustified limitation on the reasonable use or return on the property, or practical difficulties result from strict compliance with the minimum standards.

The applicant cites the existing topography and the shape of the lot as special circumstances applicable to the subject property that are not self-imposed and do not apply generally to other property in the same zone district and vicinity, and which create practical difficulties. Staff finds that although one of these aspects alone may not pose an extraordinary hardship, the two together limits the area where elements may be constructed on the subject site.

The applicant also describes the existing development as constructed under the prior SU-1 zone which was controlled by an EPC approved Site Plan and would have permitted expansion per EPC approval. The applicant is constrained by existing development and coordinating new development with the existing, which affects the alignment of the parking area on the west property line, making it not possible to locate this parking area 50-foot from the adjacent lot.

2) 6-6(N)(3)(b) The Variance will not be materially contrary to the public safety, health, or welfare.

The applicant states the Variance requests will not be materially contrary to public safety, health, or welfare. There is no evidence that extra height and closeness of the parking area, as long as there is the required screening wall and landscaped buffer will be un-safe or unhealthy or contrary to public welfare. The applicant cites reasons regarding the research into the well-being of seniors why the proposed project will contribute to the health and welfare of the public.

The property to the north is occupied by the local community college, CNM. The nursing program coordinates with LVL for student interaction with residents and there is cross access from users of each site, which contributes to public welfare. The property to the west is occupied by townhouses and a 6-foot screening wall will mitigate potential issues.

3) The Variance does not cause significant material adverse impacts on surrounding properties or infrastructure improvements in the vicinity.

The applicant states the Variances will not cause significant material adverse impacts on surrounding properties or infrastructure improvements in the vicinity.

To the west, the subject site is bordered by a low-density residential use which has protected status. Planning staff has not received any comments from these property owners, and even if there is not a full 50-foot separation of new parking spaces, it will be required that the applicant meet the other Neighborhood Edges provisions, including a 6-foot opaque wall and a minimum 15-foot wide landscape buffer. The subject site is at a higher elevation than the townhouses, and the required 6-foot opaque wall and the proposed 15-25 foot landscape buffer will effectively screen parked cars from view.

4) The Variance will not materially undermine the intent and purpose of this IDO or the applicable zone district.

The purpose of the IDO is to:

- 1-3(A) Implement the adopted Albuquerque/Bernalillo County Comprehensive Plan (ABC Comp Plan), as amended.
- 1-3(B) Ensure that all development in the City is consistent with the spirit and intent of any other plans and policies adopted by City Council.
- 1-3(C) Ensure the provision of adequate public facilities and services for new development.
- 1-3(D) Protect the quality and character of residential neighborhoods.
- 1-3(E) Promote the economic development and fiscal sustainability of the City.
- 1-3(F) Provide for the efficient administration of City land use and development regulations.
- 1-3(G) Protect the health, safety, and general welfare of the public.
- 1-3(H) Provide for orderly and coordinated development patterns.
- 1-3(I) Encourage the conservation and efficient use of water and other natural resources.
- 1-3(J) Implement a connected system of parks, trails, and open spaces to promote improved outdoor activity and public health.
- 1-3(K) Provide reasonable protection from possible nuisances and hazards and to otherwise protect and improve public health.
- 1-3(L) Encourage efficient and connected transportation and circulation systems for motor vehicles, bicycles, and pedestrians.

The purpose of the R-ML zone district is to provide for a variety of low- to medium-density housing options. The primary land uses are townhouses and low-density multi-family buildings, as well as civic and institutional uses, such as Assisted Living, to serve the surrounding residential areas.

In general, the request will not materially undermine the intent and purpose of applicable zone district because it provides expanded housing options and parking options for senior residents.

5) The Variance approved is the minimum necessary to avoid extraordinary hardship or practical difficulties.

The site hardship supports the Variance to Neighborhood Edges 50-foot separation, which is the minimum necessary.

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- 11. The applicant notified the District 8 Coalition of Neighborhood Associations and property owners within 100 feet of the subject site as required. A neighborhood meeting occurred with the District 8 Coalition of Neighborhood Associations on May 23, 2019.
- 12. The applicant performed outreach with its residents since 2017.
- 13. In total, staff received two (2) letters in opposition to the request from residents of La Vida Llena including a petition with seven (7) names.
- 14. In total, staff received seventeen (17) letters in support to the request from residents of La Vida Llena.
- 15. Staff received a letter of support from CNM (Central New Mexico Community College), the property owner to the north.
- 16. Staff has not received comments in support or opposition from the District 8 Coalition of Neighborhood Associations or from the property owners to the west of La Vida Llena.

<u>APPEAL</u>: If you wish to appeal this decision, you must do so within 15 days of the EPC's decision or by **JUNE 28, 2019.** The date of the EPC's decision is not included in the 15-day period for filing an appeal, and if the 15th day falls on a Saturday, Sunday or Holiday, the next working day is considered as the deadline for filing the appeal.

For more information regarding the appeal process, please refer to Section 14-16-6 of the IDO, Administration and Enforcement. A Non-Refundable filing fee will be calculated at the Land Development Coordination Counter and is required at the time the appeal is filed. It is not possible to appeal EPC Recommendations to City Council; rather, a formal protest of the EPC's Recommendation can be filed within the 15 day period following the EPC's recommendation.

You will receive notification if any person files an appeal. If there is no appeal, you can receive Building Permits at any time after the appeal deadline quoted above, provided all conditions imposed at the time of approval have been met. Successful applicants are reminded that other regulations of the City Zoning Code must be complied with, even after approval of the referenced application(s).

Sincerely,

David S. Campbell Planning Director

OFFICIAL NOTICE OF DECISION Project #2019-002114 June 13, 2019 Page 14 of 14

DSC/CS

cc: La Vida Llena, 10501 Lagrima De Oro Rd., NE, ABQ, NM 87111 Consensus Planning, Inc., Jackie Fishman, 302 8th St., NW, ABQ, NM 87102 Donald Couchman, Dist. 8 Coalition of NA's 6441 Concordia Rd NE, ABQ, NM 87111 Mary Kurkjian, Dist. 8 Coalition of NA's, 13709 Canada del Oso Pl., NE, ABQ, NM 87111 Marge Meyer, 10501 Lagrima de Oro NE, #874, ABQ, NM 87111 Richard Pettit, 10501 Lagrima de Oro NE, ABQ, NM 87111 Don & Glyndon Hossink, 10501 Lagrima de Oro NE, ABQ, NM 87111 Mary Ellen Simms, 1100 Lagrima de Oro Rd NE, ABQ, NM 87111 Chris Enke, 10501 Lagrima de Oro NE #38D, ABQ, NM 87111 Milo Myers, 10501 Lagrima de Oso, ABQ, NM 87111 Len Boscarine, 11100 Lagrima de Oro NE, ABQ, NM 87111 Pat Kneen, 10501 Lagrima de Oro NE #159, ABQ, NM 87111 Linda Plein, 11100 Lagrima de Oro NE, ABQ, NM 87111 Olen Thompson, 10501 Lagrima de Oro NE #248, ABQ, NM 87111 Dr. M. Krasnow, 10501 Lagrima de Oro NE, ABQ, NM 87111 Alan Varela, avarela@cabq.gov Sue Norton, sndlv/860@comeast.net Zoe Rae, zhrae(waol.com Kay Grant, kkkkaty6@comcast.net Don Norton, sndlvl860@comcast.net DeAnn Eaton, deaton(a)haverlandcarter.com Linda Givens, lgivens@lavidallena.com

August 6, 2019



Kym Dicome, DRB Chair City of Albuquerque Development Review Board 600 Second Street NW Albuquerque, New Mexico 87102

Re: La Vida Llena

Request for DRB Approval- Major Amendment to EPC Site Plan COA Project #2019-002114 (1003807)

Dear DRC Chair:

On behalf of our client, La Vida Llena (LVL), The Hartman + Majewski Design Group (DG) and Consensus Planning are writing to request Design Review Board (DRB) approval of a Major Amendment to EPC Site Plan la Vida Llena located on the north side of Lagrima De Oro Road NE between Morris and Juan Tabo NE. The IDO zoning designation for this property is R-ML. This zoning is not affected by this Application.

The Official Notice of Decision from the Environmental Planning Commission received on June 13, 2019, is included within this application. This letter contains responses outlining how each condition has been addressed, and required minor plan revisions to accommodate the conditions. Responses to conditions are as follows for SI-2019-00117 Major Amendment to a Prior Approved Site Development Plan:

CONDITION 1:

We met with our staff planner Cheryl Somerfeldt on August 5, 2019 to review the application and conditions.

CONDITION 2:

The Site Plan has been reviewed and to our knowledge is in compliance with the General Regulation of the IDO.

CONDITION 3:

Note have been added to the Site Plan identifying the Variances-EPC.

CONDITION 4:

This letter and this submittal to the DRB serves as the response to Condition 1.

CONDITION 5:

We have computed the available open space on the campus. The required open space is 94,900sf, and the available open space (within the ring road of the campus) is 138,420 sf. The area identified did not include the residential unit balconies that would further increase the available open space. The area outside of the ring road was not calculated as the requirements have already been satisfied.

CONDITION 6:

Bike Racks have been added as well as a secure locker type facility within the parking level of the Independent Living Building to satisfy the 20% of required parking spaces being inside a locker. Plan now shows 32 total parking with 6 enclosed in covered/lockers.

CONDITION 7:

We have discussed the walls with the City Engineer (Shahab Biazar) and because the walls are only 1' tall as viewed from the adjacent parcels the walls are permitted to exceed the 6' height limit as required by IDO Table 5-7-1. There is an existing segmented block wall that exceeds the 6' tall and we will be connecting to the existing wall. We have created terraced retaining walls where possible.

CONDITION 8:

The Wall has been adjusted to be 3'6" tall above the curb line. The curb is used to make up the remaining 6" to achieve over the required 72" tall screen wall as viewed from the adjacent residential at the small parking lot located at the western side of the site.

CONDITION 9:

- References to sheet C-501 for details have been removed.
- Solid Waste has approved the site plan for access.

The EPC approval included a request for height Variance for the two proposed buildings. These variances only included Findings and did not include Conditions that would need to be clarified as part of this letter.

The EPC approval also include a request setback from protected lots located along the western side of the site. The variances only included Findings and did not include Conditions that would need to be clarified as part of this letter.

We respectfully request that the **Development Review Board** review and approve the requested application. Please do not hesitate to contact me at 505-998-6430 if you have any questions or require additional information.

Sincerely

David Aube, PE

Principal


cc: DeAnn Eaton, LVL

Joe Gomez, LVL

Jackie Fishman, Consensus Planning

Mark Wade, AIA, DG

P:\2439_GAHP-plazaciudana\C2_Agency\DRB Comments\DRB Justification Ltr_2019.08.06.doc

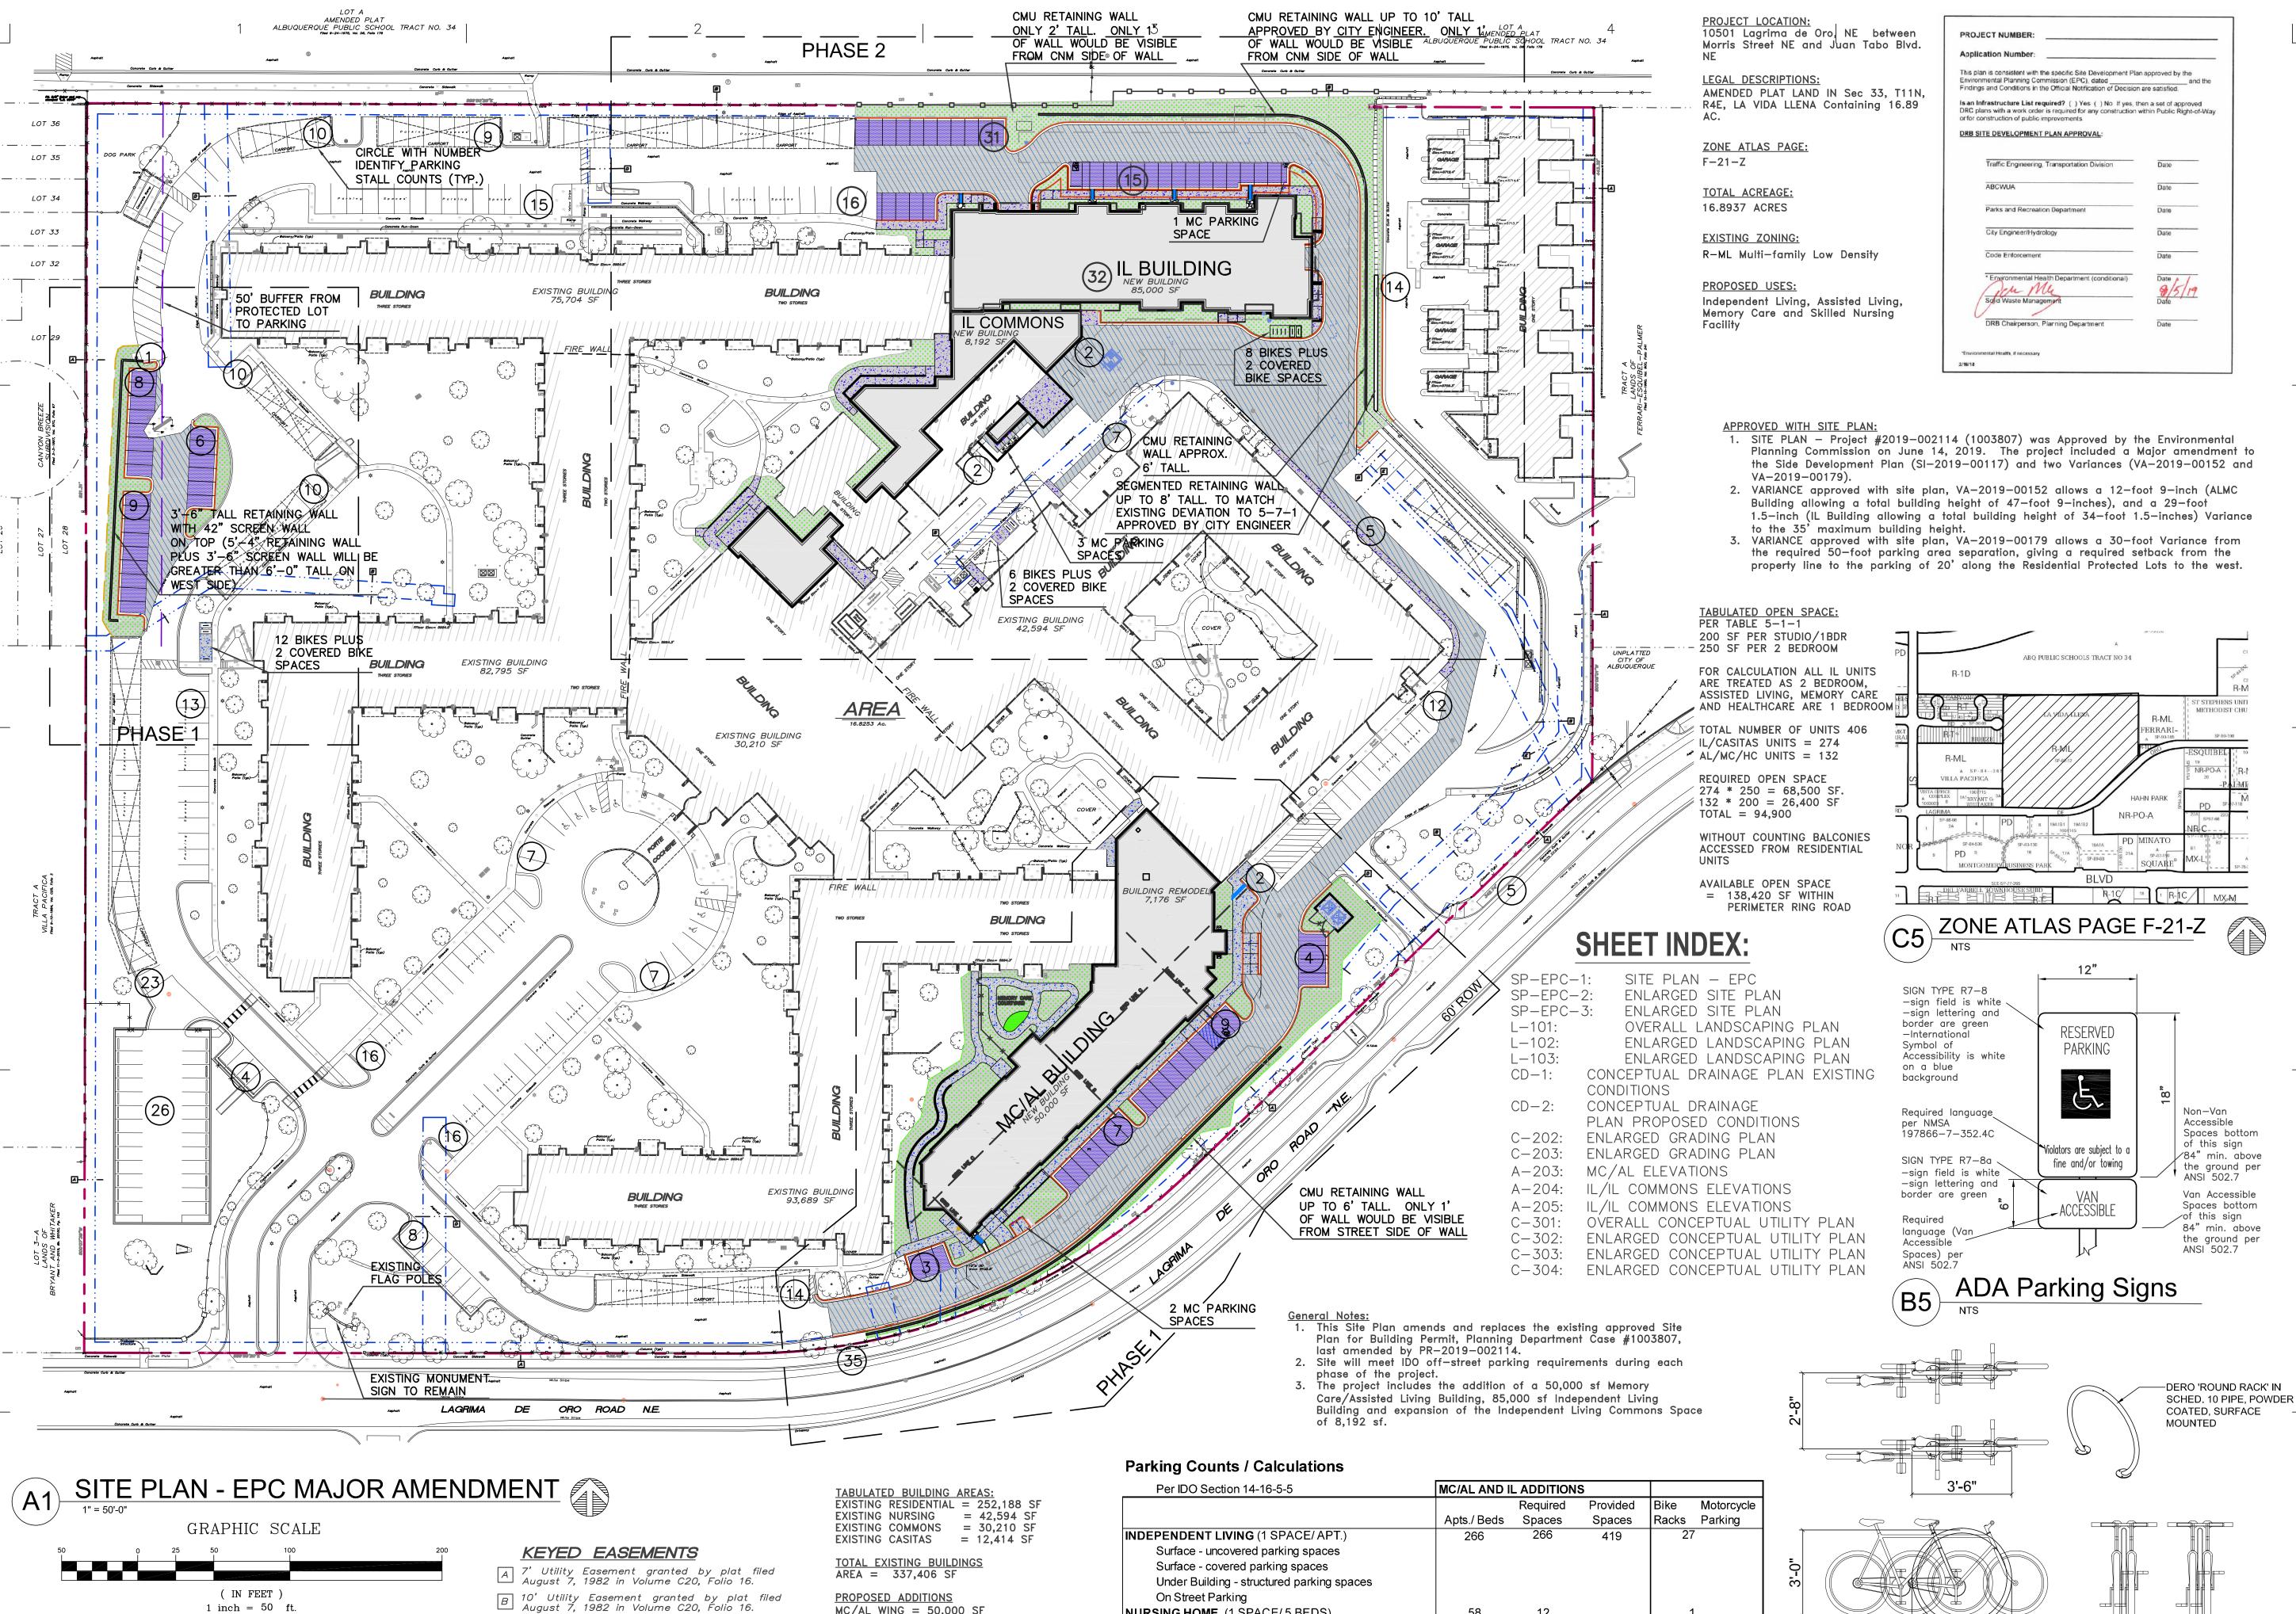

PROPOSED ADDITIONS

C 15' Utility Easement granted by plat filed August 7, 1982 in Volume C20, Folio 16.

D 15' Waterline Easement granted by plat filed August 7, 1982 in Volume C20, Folio 16.

E 20' Waterline Easement granted by plat filed August 7, 1982 in Volume C20, Folio 16.

MC/AL WING = 50,000 SF IL WING = 85,000 SF

IL COMMONS = 8,192 SF

TOTAL PROPOSED ADDITIONS AREA = 143,192 SF

 $\underline{\mathsf{CAMPUS}} \ \ \underline{\mathsf{TOTAL}} \ = \ 480,598 \ \ \underline{\mathsf{SF}}$

1 inch = 50 ft.

CURVE TABLE

 CURVE
 LENGTH
 RADIUS
 TANGENT
 CHORD
 CRD
 BEARING
 DELTA

 C1
 26.45'
 480.00'
 13.23'
 26.45'
 \$47.21'30"W
 3'09'27"

 C2
 324.62'
 420.00'
 170.90'
 316.60'
 \$67.56'09"W
 44'17'01"

 C3
 83.95'
 420.00'
 42.12'
 83.81'
 \$51'31'14"W
 11'27'11"

 C4
 240.66'
 420.00'
 123.73'
 237.38'
 \$73'39'45"W
 32'49'50"

Design Group

120 Vassar Drive SE Suite 100 Albuquerque New Mexico 87106 T 505 242 6880 • F 505 242 6881

Architects • Engineers • Interior Design

Planners • Urban Designers • LEED®

CONSULTANT

STAMP

PROJECT NAME

LA VIDA LLENA

10501 LAGRIMA DE ORO NE

HAVERLAND CARTER GROUP

10701 Montgomery Boulevard NE ALBUQUERQUE NM, 87111

No. DATE DESCRIPTION

Copywright: Design Group Drawn by Checked by 7-31-2019 Date

2811

SHEET TITLE:

Project number

Cad file name

PROPOSED OVERALL SITE PLAN

SHEET NUMBER:


2'-8"

Bike Rack

SP-EPC-1

Per IDO Section 14-16-5-5	MC/AL AND I				
		Required	Provided	Bike	Motorcycle
	Apts./ Beds	Spaces	Spaces	Racks	Parking
NDEPENDENT LIVING (1 SPACE/ APT.)	266	266	419	27	
Surface - uncovered parking spaces					
Surface - covered parking spaces					
Under Building - structured parking spaces					
On Street Parking					
NURSING HOME (1 SPACE/ 5 BEDS)	58	12		1	
ASSISTED LIVING/ MEMORY CARE (1 SPACE/ 3 BEDS)	74	25		3	
CASITAS (1 SPACE/ DWELLING UNIT)	8	8	14	1	
TOTAL	406	311	433	32	6


Per IDO Section 14-16-5-5	MC/AL AND I	L ADDITION			
		Required	Provided	Bike	Motorcycle
	Apts./ Beds	Spaces	Spaces	Racks	Parking
INDEPENDENT LIVING (1 SPACE/ APT.)	266	266	419	27	,
Surface - uncovered parking spaces					
Surface - covered parking spaces					
Under Building - structured parking spaces					
On Street Parking					
NURSING HOME (1 SPACE/ 5 BEDS)	58	12		1	
ASSISTED LIVING/ MEMORY CARE (1 SPACE/ 3 BEDS)	74	25		3	1
CASITAS (1 SPACE/ DWELLING UNIT)	8	8	14	1	
TOTAL	406	311	433	32	: 6
OVER/UNDER		122			

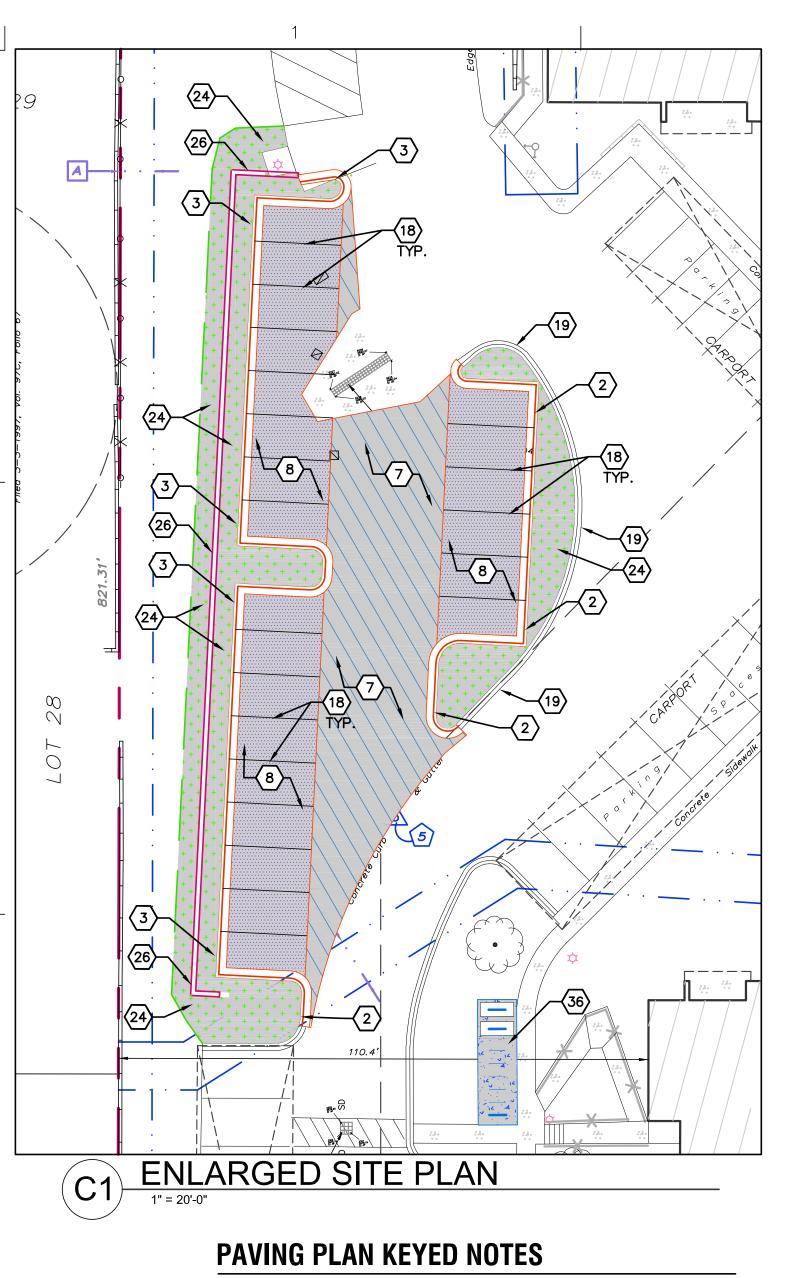

- 1. CONCRETE PAVEMENT.
- 2. 6" STANDARD CURB AND GUTTER.
- 3. 6" DEPRESSED CURB AND GUTTER.
- 4. RUNDOWN DEPRESSED GUTTER.
- 5. 6" HEADER CURB. 6. CURB TRANSITION.
- 7. MAIN DRIVE ASPHALT PAVEMENT.
- 8. PARKING LOT ASPHALT PAVEMENT. 9. CMU RETAINING WALL, 4'-0" TALL MAX.
- 10. CONCRETE CURB ACCESS RAMP.
- 11. CONCRETE SIDEWALK.
- 12. TURNDOWN EDGE ON SIDEWALK.
- 13. CONCRETE RUNDOWN CHANNEL.
- 14. CONCRETE STOOP.
- 15. CONCRETE SIDEWALK CULVERT. 16. RIP RAP EROSION PROTECTION.
- 17. CONCRETE EQUIPMENT PAD UNDER NEW TRANSFORMER. 18. 4" WIDE WHITE TRAFFIC PARKING.
- 19. PAINT CURB RED WITH 6" TALL WHITE LETTERS READING "NO
- PARKING FIRE LANE". 20. HANDRAIL.
- 21. PAINT CURB YELLOW WHERE HEIGHT IS BETWEEN ¹/₄" AND 6" TALL.
- 22. 4' WIDE X 6' TALL PERSONNEL GATE.
- 23. 6' TALL DECORATIVE WROUGHT IRON FENCE. PROVIDE CONCRETE HEADER CURB BELOW FENCE TO ALLOW BOTTOM OF FENCE TO BE A UNIFORM ELEVATION.SEE LANDSCAPING PLANS FOR DETAILS.
- 24. COOLING TOWER FOR MECHANICAL SYSTEM.
- 25. KEYSTONE BLOCK WALL WITH MAX HEIGHT 6' PER MANUFACTURERS RECOMMENDATIONS.
- 26. CAST IN PLACE CONCRETE RETAINING WALL UP TO 3' TALL. 27. MECHANICAL YARD WITH CONCRETE PAVEMENT, 6' TALL CMU
- 28. CONCRETE TAILWALL 18" TALL.
- 29. CONCRETE SEATING AREA,. CONCRETE SIDEWALK, SEE

SCREEN WALL, AND GATES.

- LANDSCAPING PLAN FOR SITE FURNISHINGS.
- 30. RESERVED PARKING SYMBOL.
- 31. 12" TALL WHITE LETTERS "NO PARKING"
- 32. UNLOADING ZONE
- 33. VAN ACCESSIBLE RESERVED PARKING SIGN, MOUNTED TO FACE OF BUILDING.
- 34. ADA COMPLIANT CURB ACCESS RAMP.
- 35. MC PARKING STALL WITH LETTERING AND SIGN.
- 36. BICYCLE PARKING.

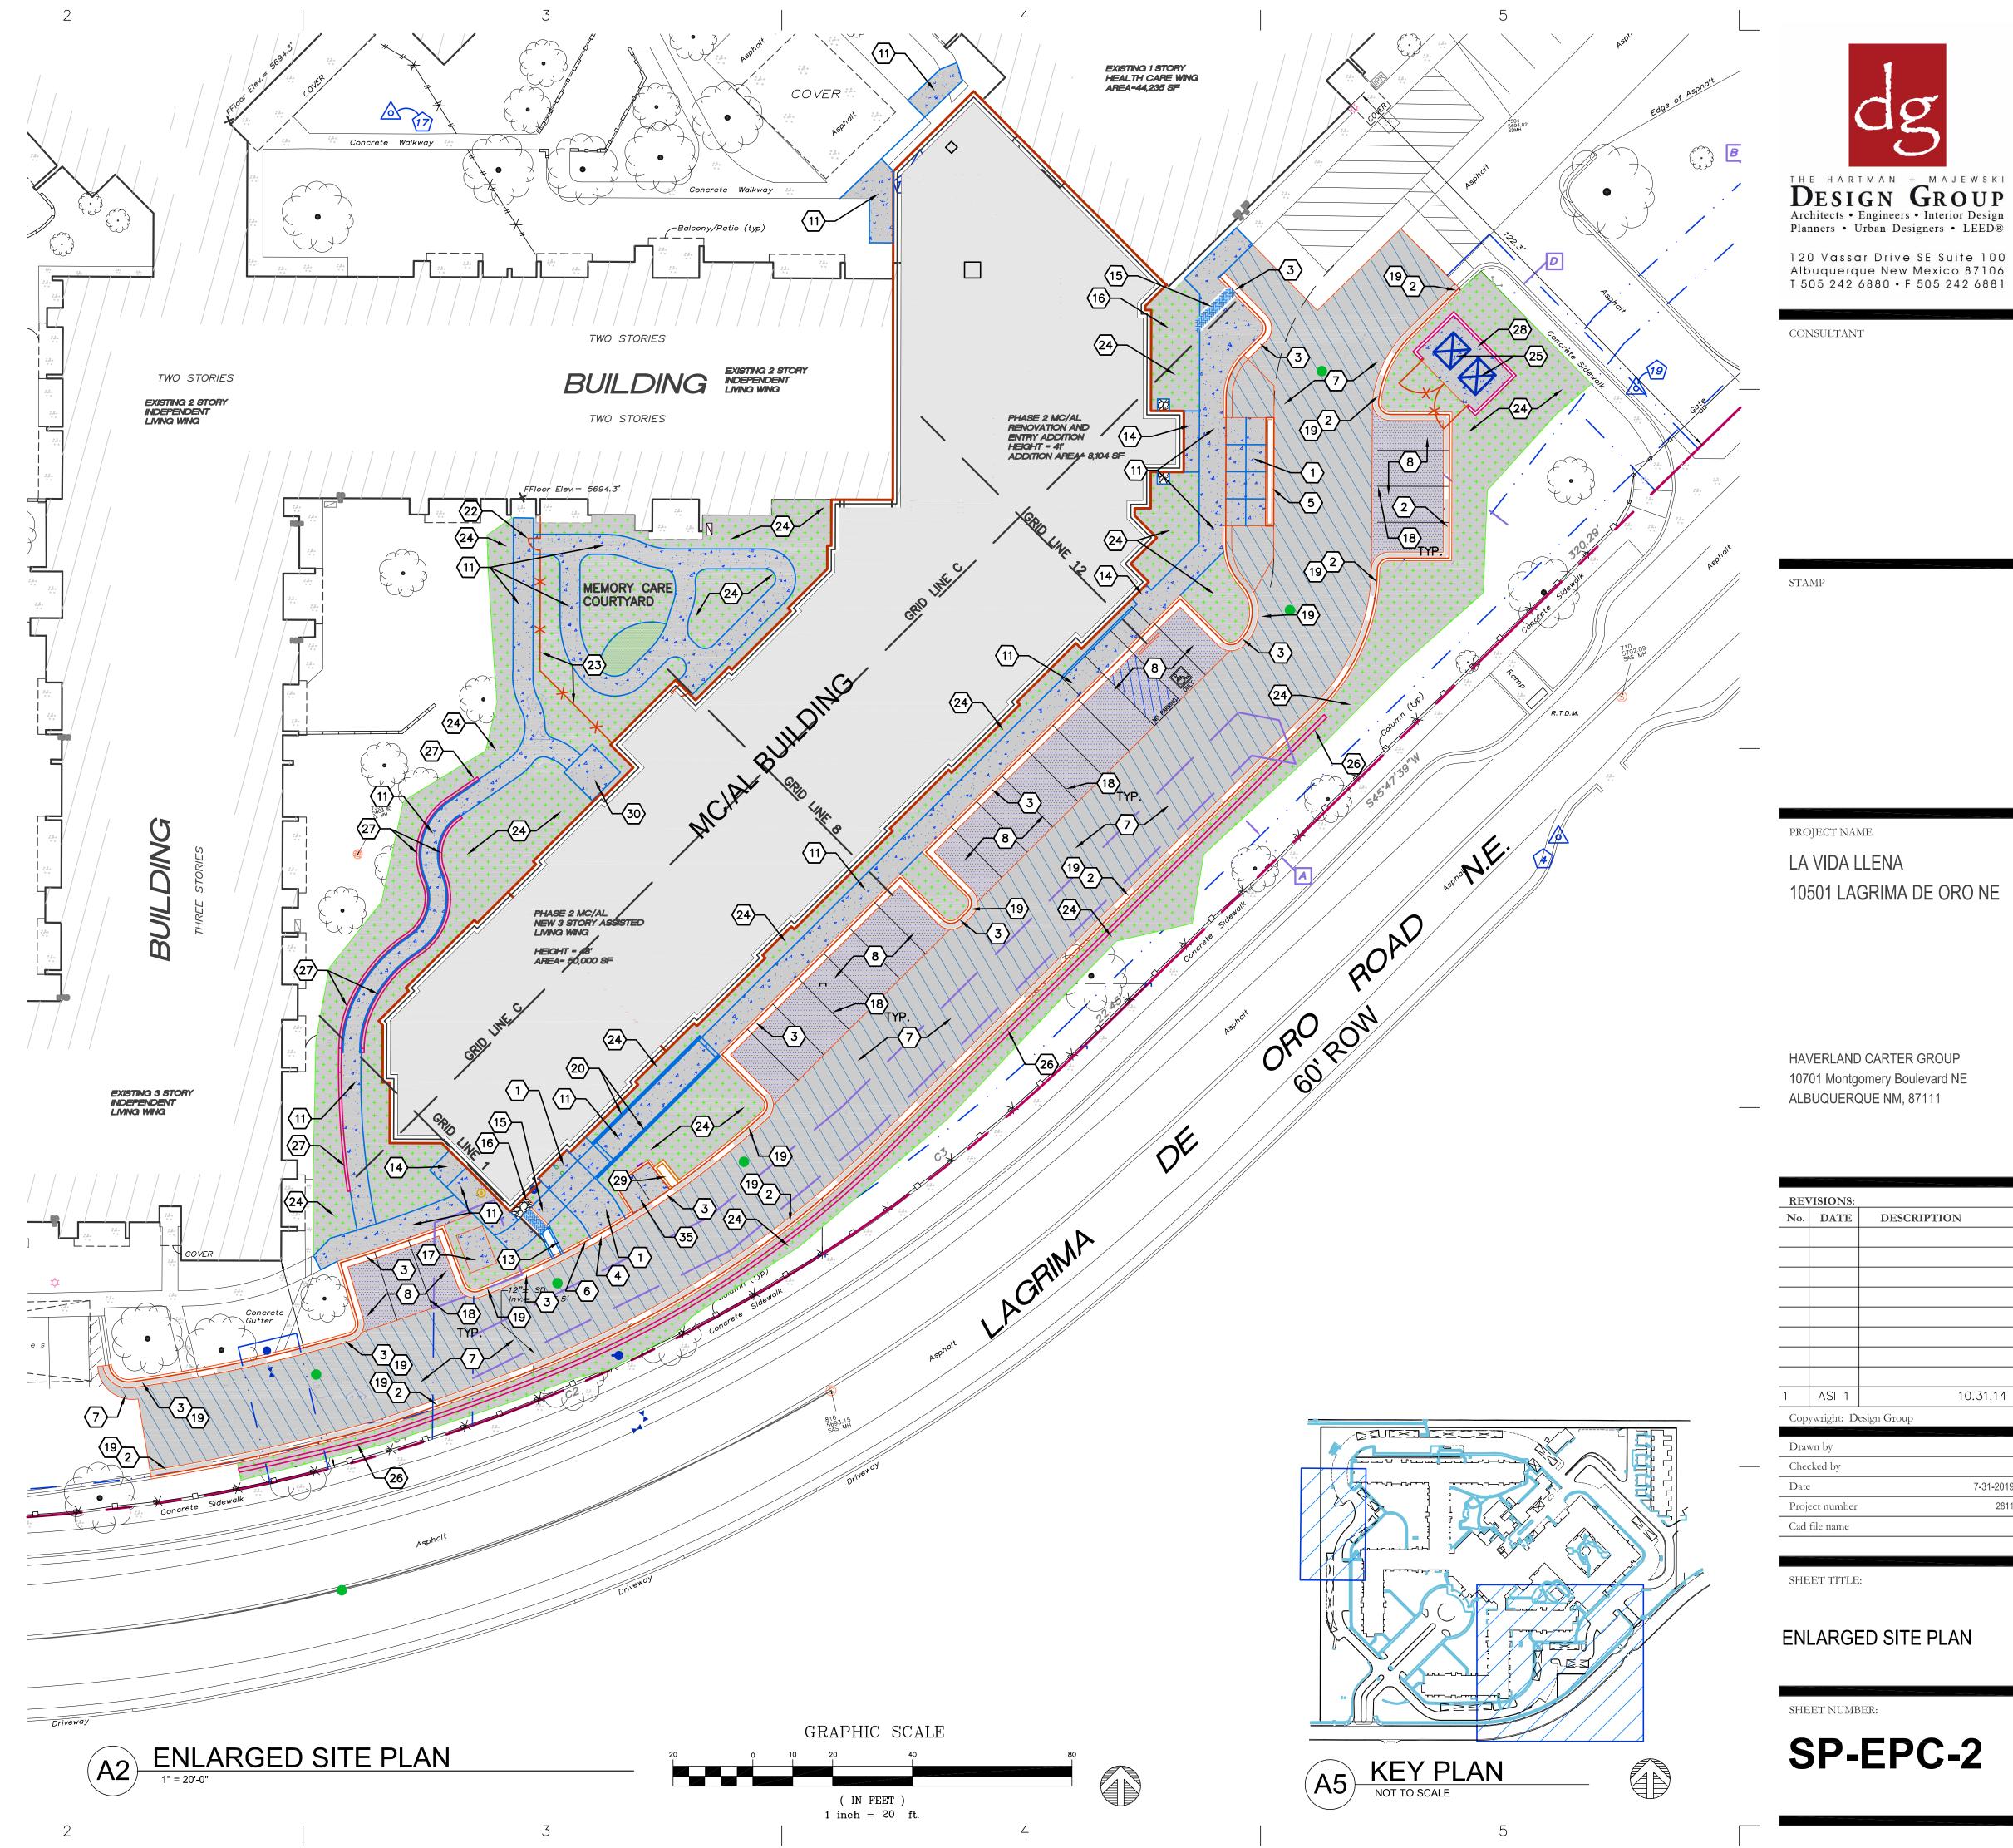

DESIGN GROUP
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CONSULTANT

PROJECT NAME

10501 LAGRIMA DE ORO NE

HAVERLAND CARTER GROUP 10701 Montgomery Boulevard NE ALBUQUERQUE NM, 87111

No. DATE DESCRIPTION 10.31.14 ASI 1 Copywright: Design Group


Drawn by Checked by 7-31-2019 Date 2811 Project number Cad file name

SHEET TITLE:

ENLARGED SITE PLAN

SHEET NUMBER:

SP-EPC-2

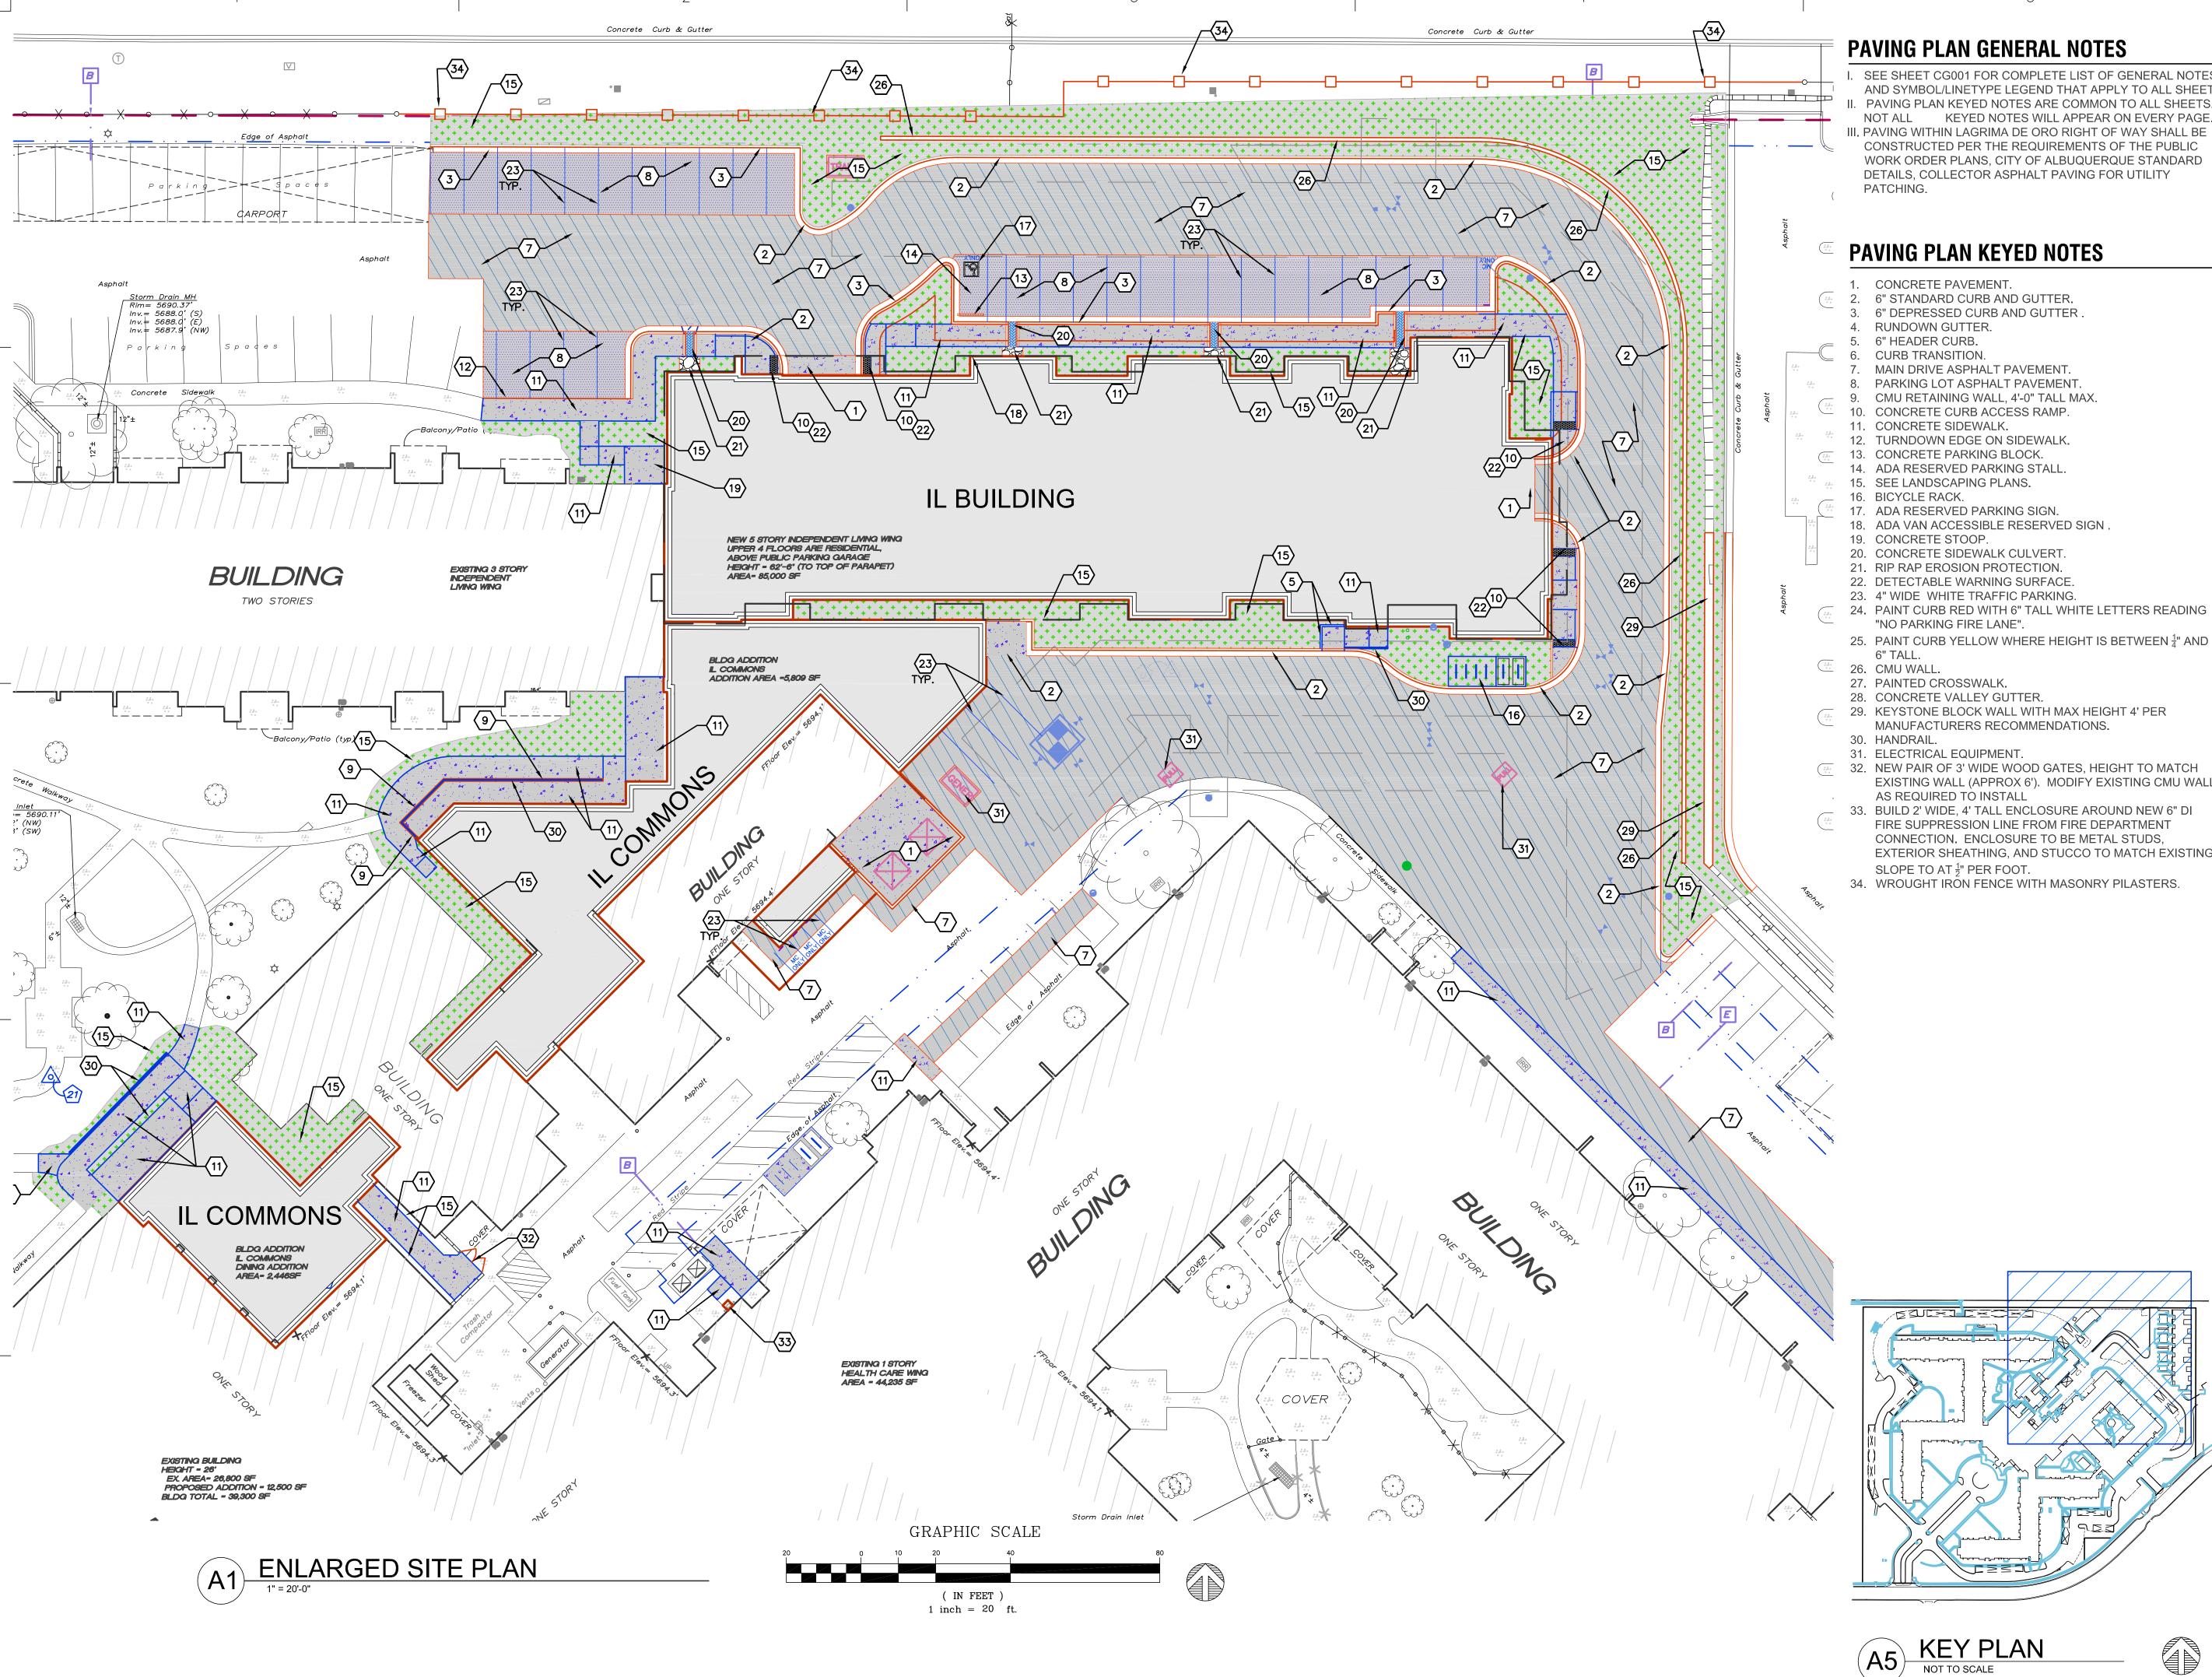

I. SEE SHEET CG001 FOR COMPLETE LIST OF GENERAL NOTES AND SYMBOL/LINETYPE LEGEND THAT APPLY TO ALL SHEETS.

I. PAVING PLAN KEYED NOTES ARE COMMON TO ALL SHEETS. KEYED NOTES WILL APPEAR ON EVERY PAGE.

CONSTRUCTED PER THE REQUIREMENTS OF THE PUBLIC WORK ORDER PLANS, CITY OF ALBUQUERQUE STANDARD DETAILS, COLLECTOR ASPHALT PAVING FOR UTILITY

- 32. NEW PAIR OF 3' WIDE WOOD GATES, HEIGHT TO MATCH EXISTING WALL (APPROX 6'). MODIFY EXISTING CMU WALL
- FIRE SUPPRESSION LINE FROM FIRE DEPARTMENT CONNECTION. ENCLOSURE TO BE METAL STUDS, EXTERIOR SHEATHING, AND STUCCO TO MATCH EXISTING.



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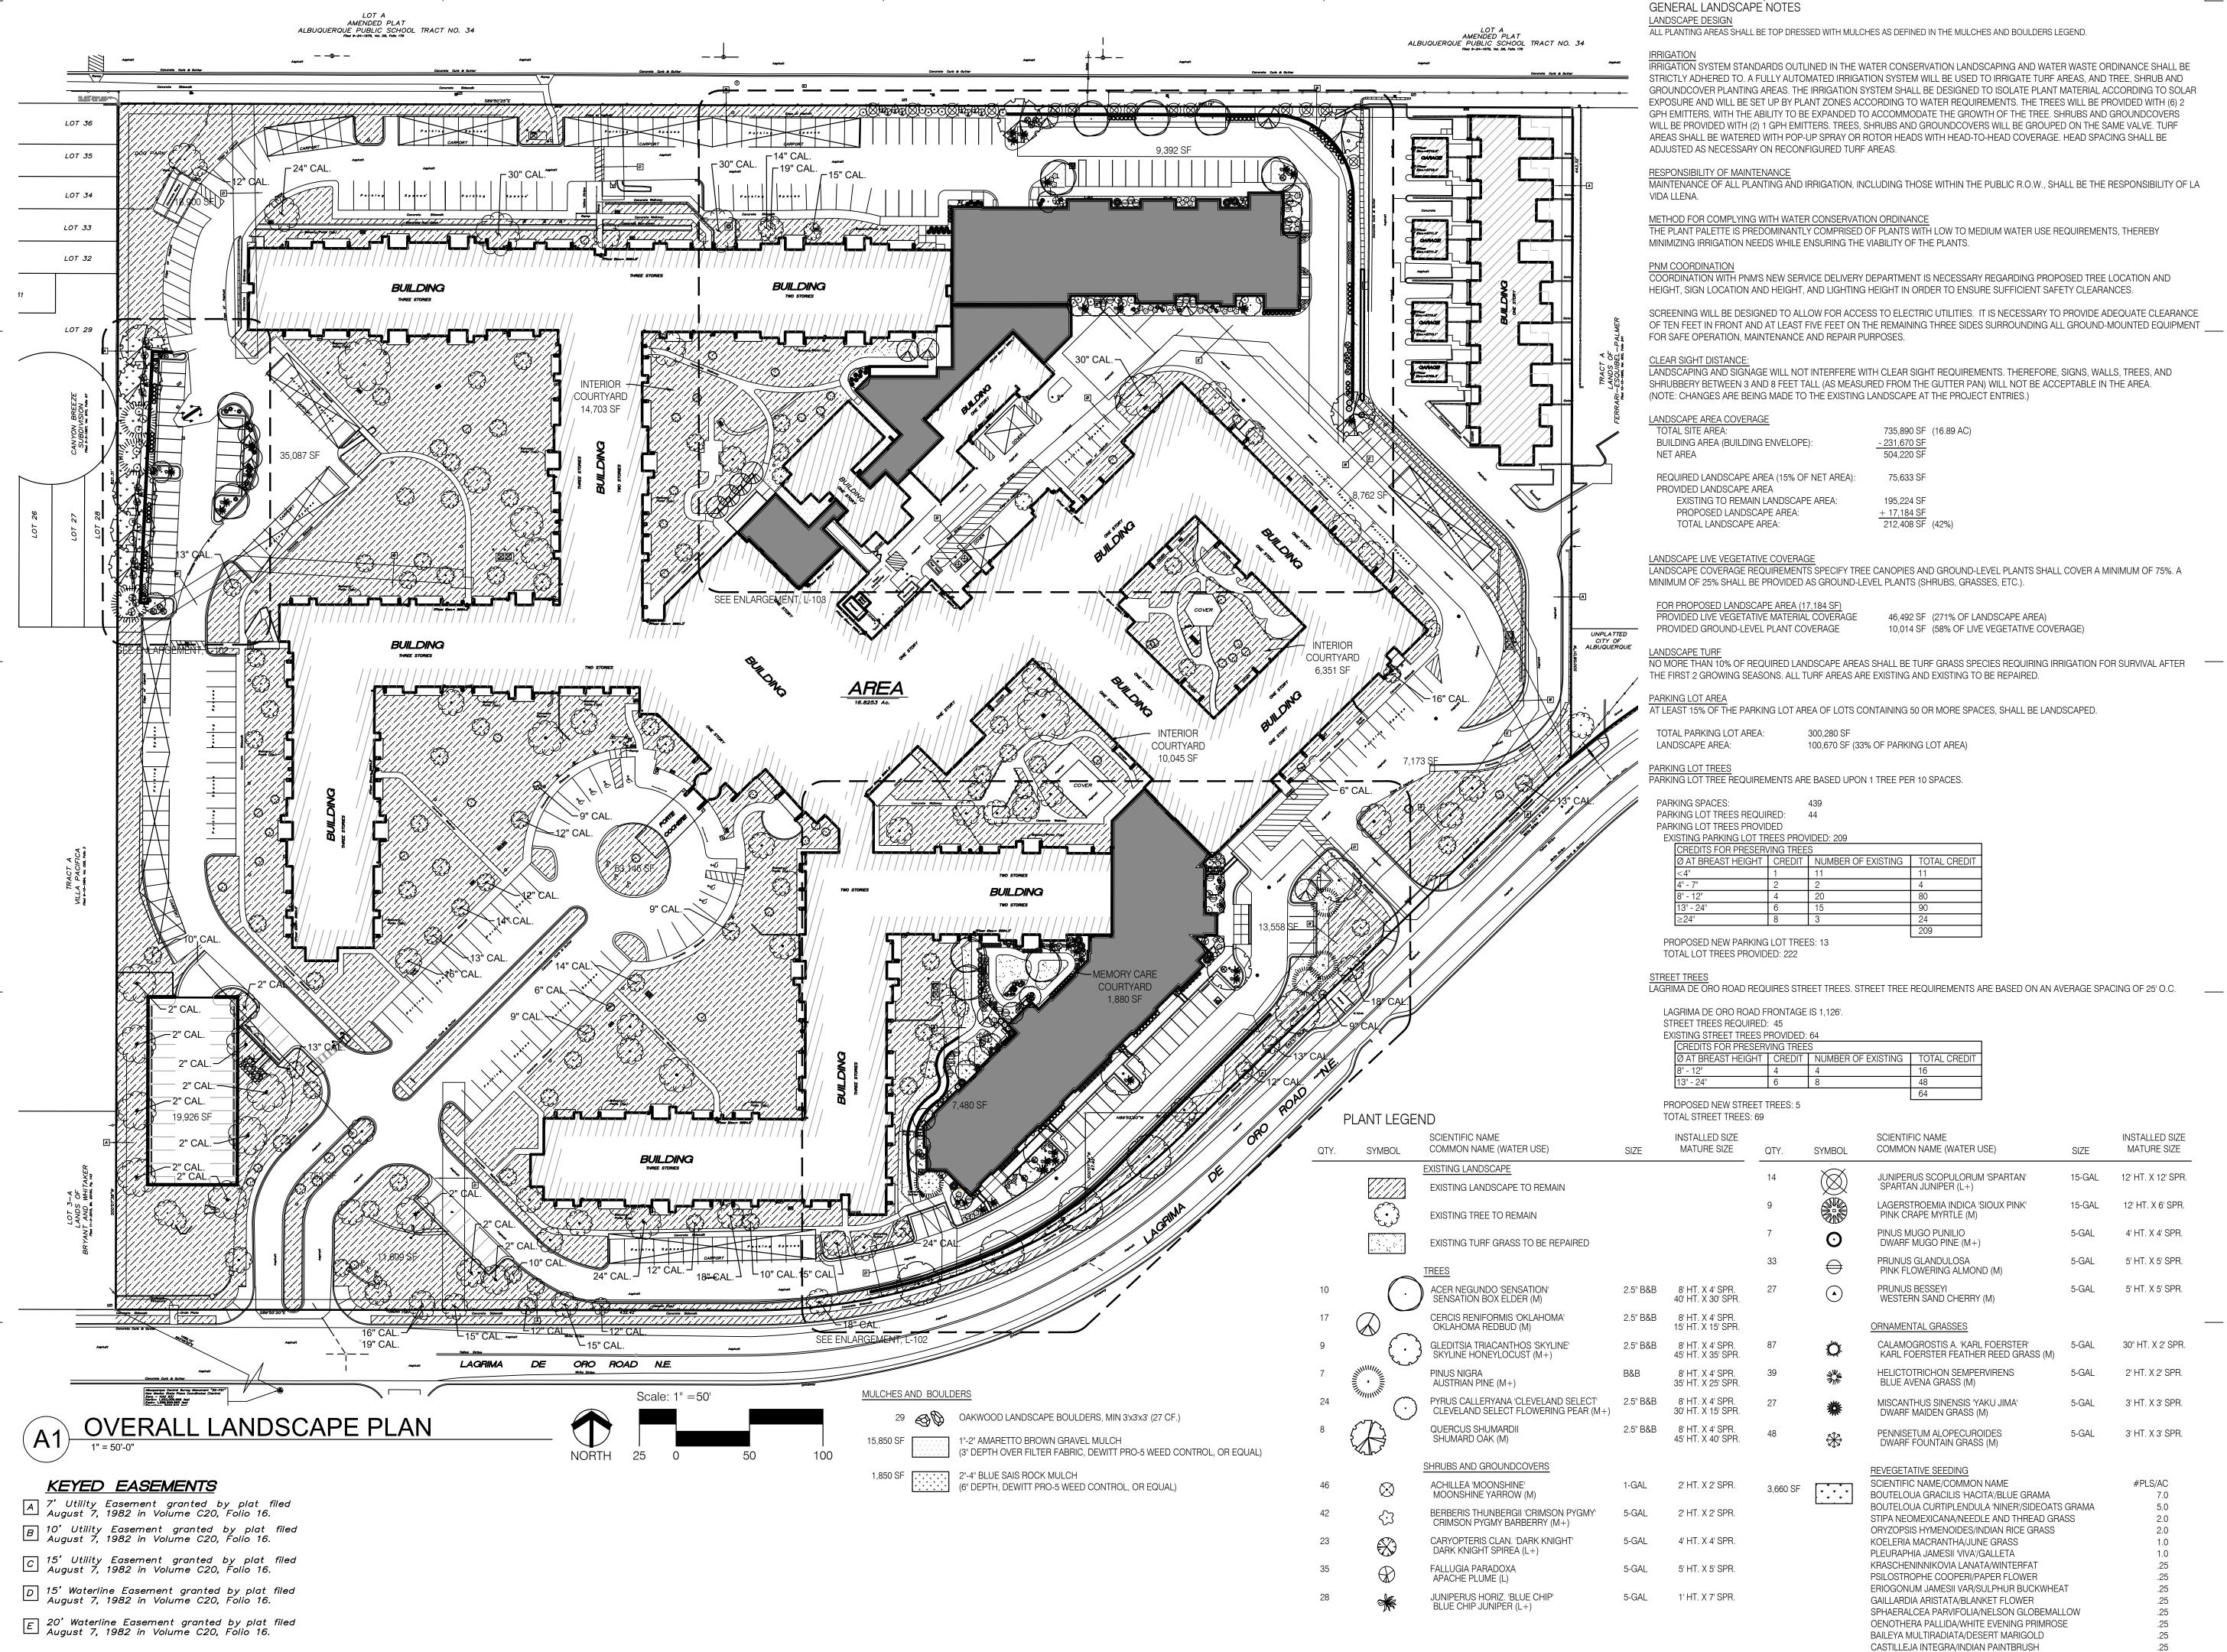
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ENLARGED SITE PLAN

SHEET NUMBER:

SP-EPC-3



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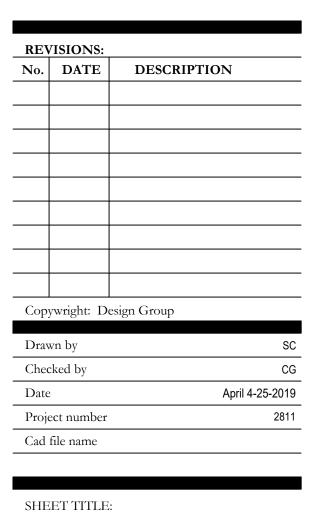
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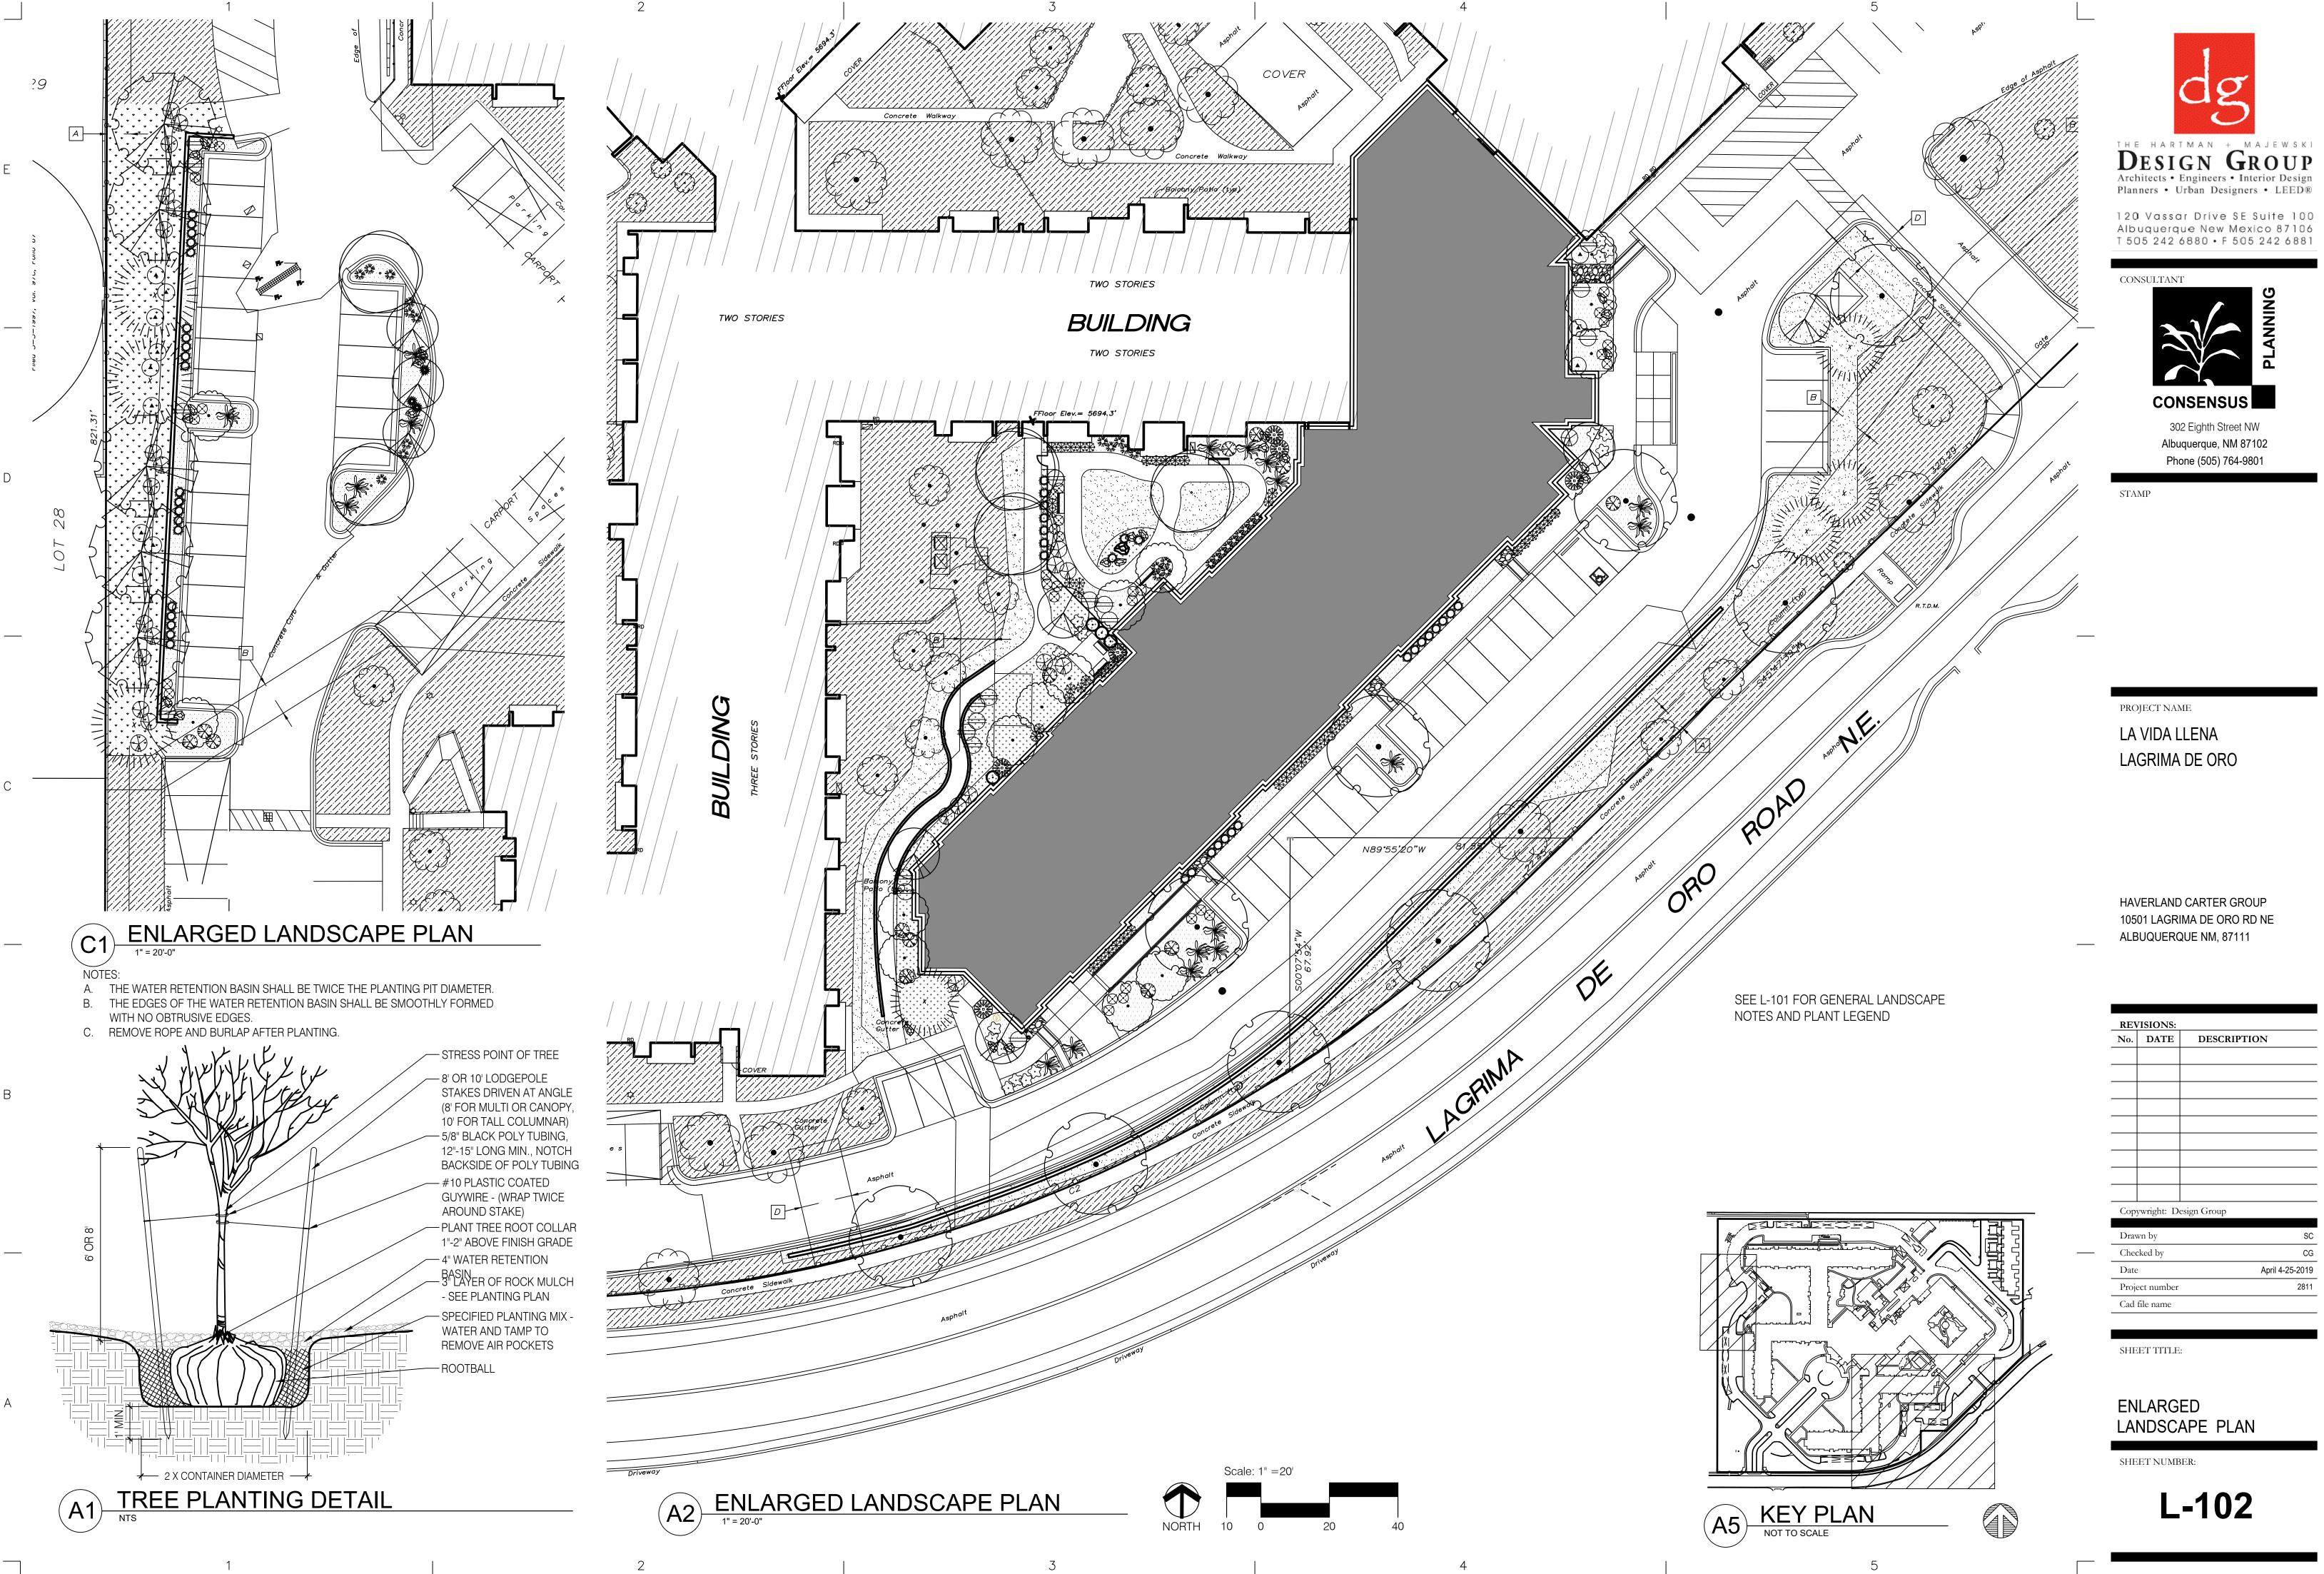


OVERALL


LANDSCAPE PLAN

SHEET NUMBER:

L-101



April 4-25-2019

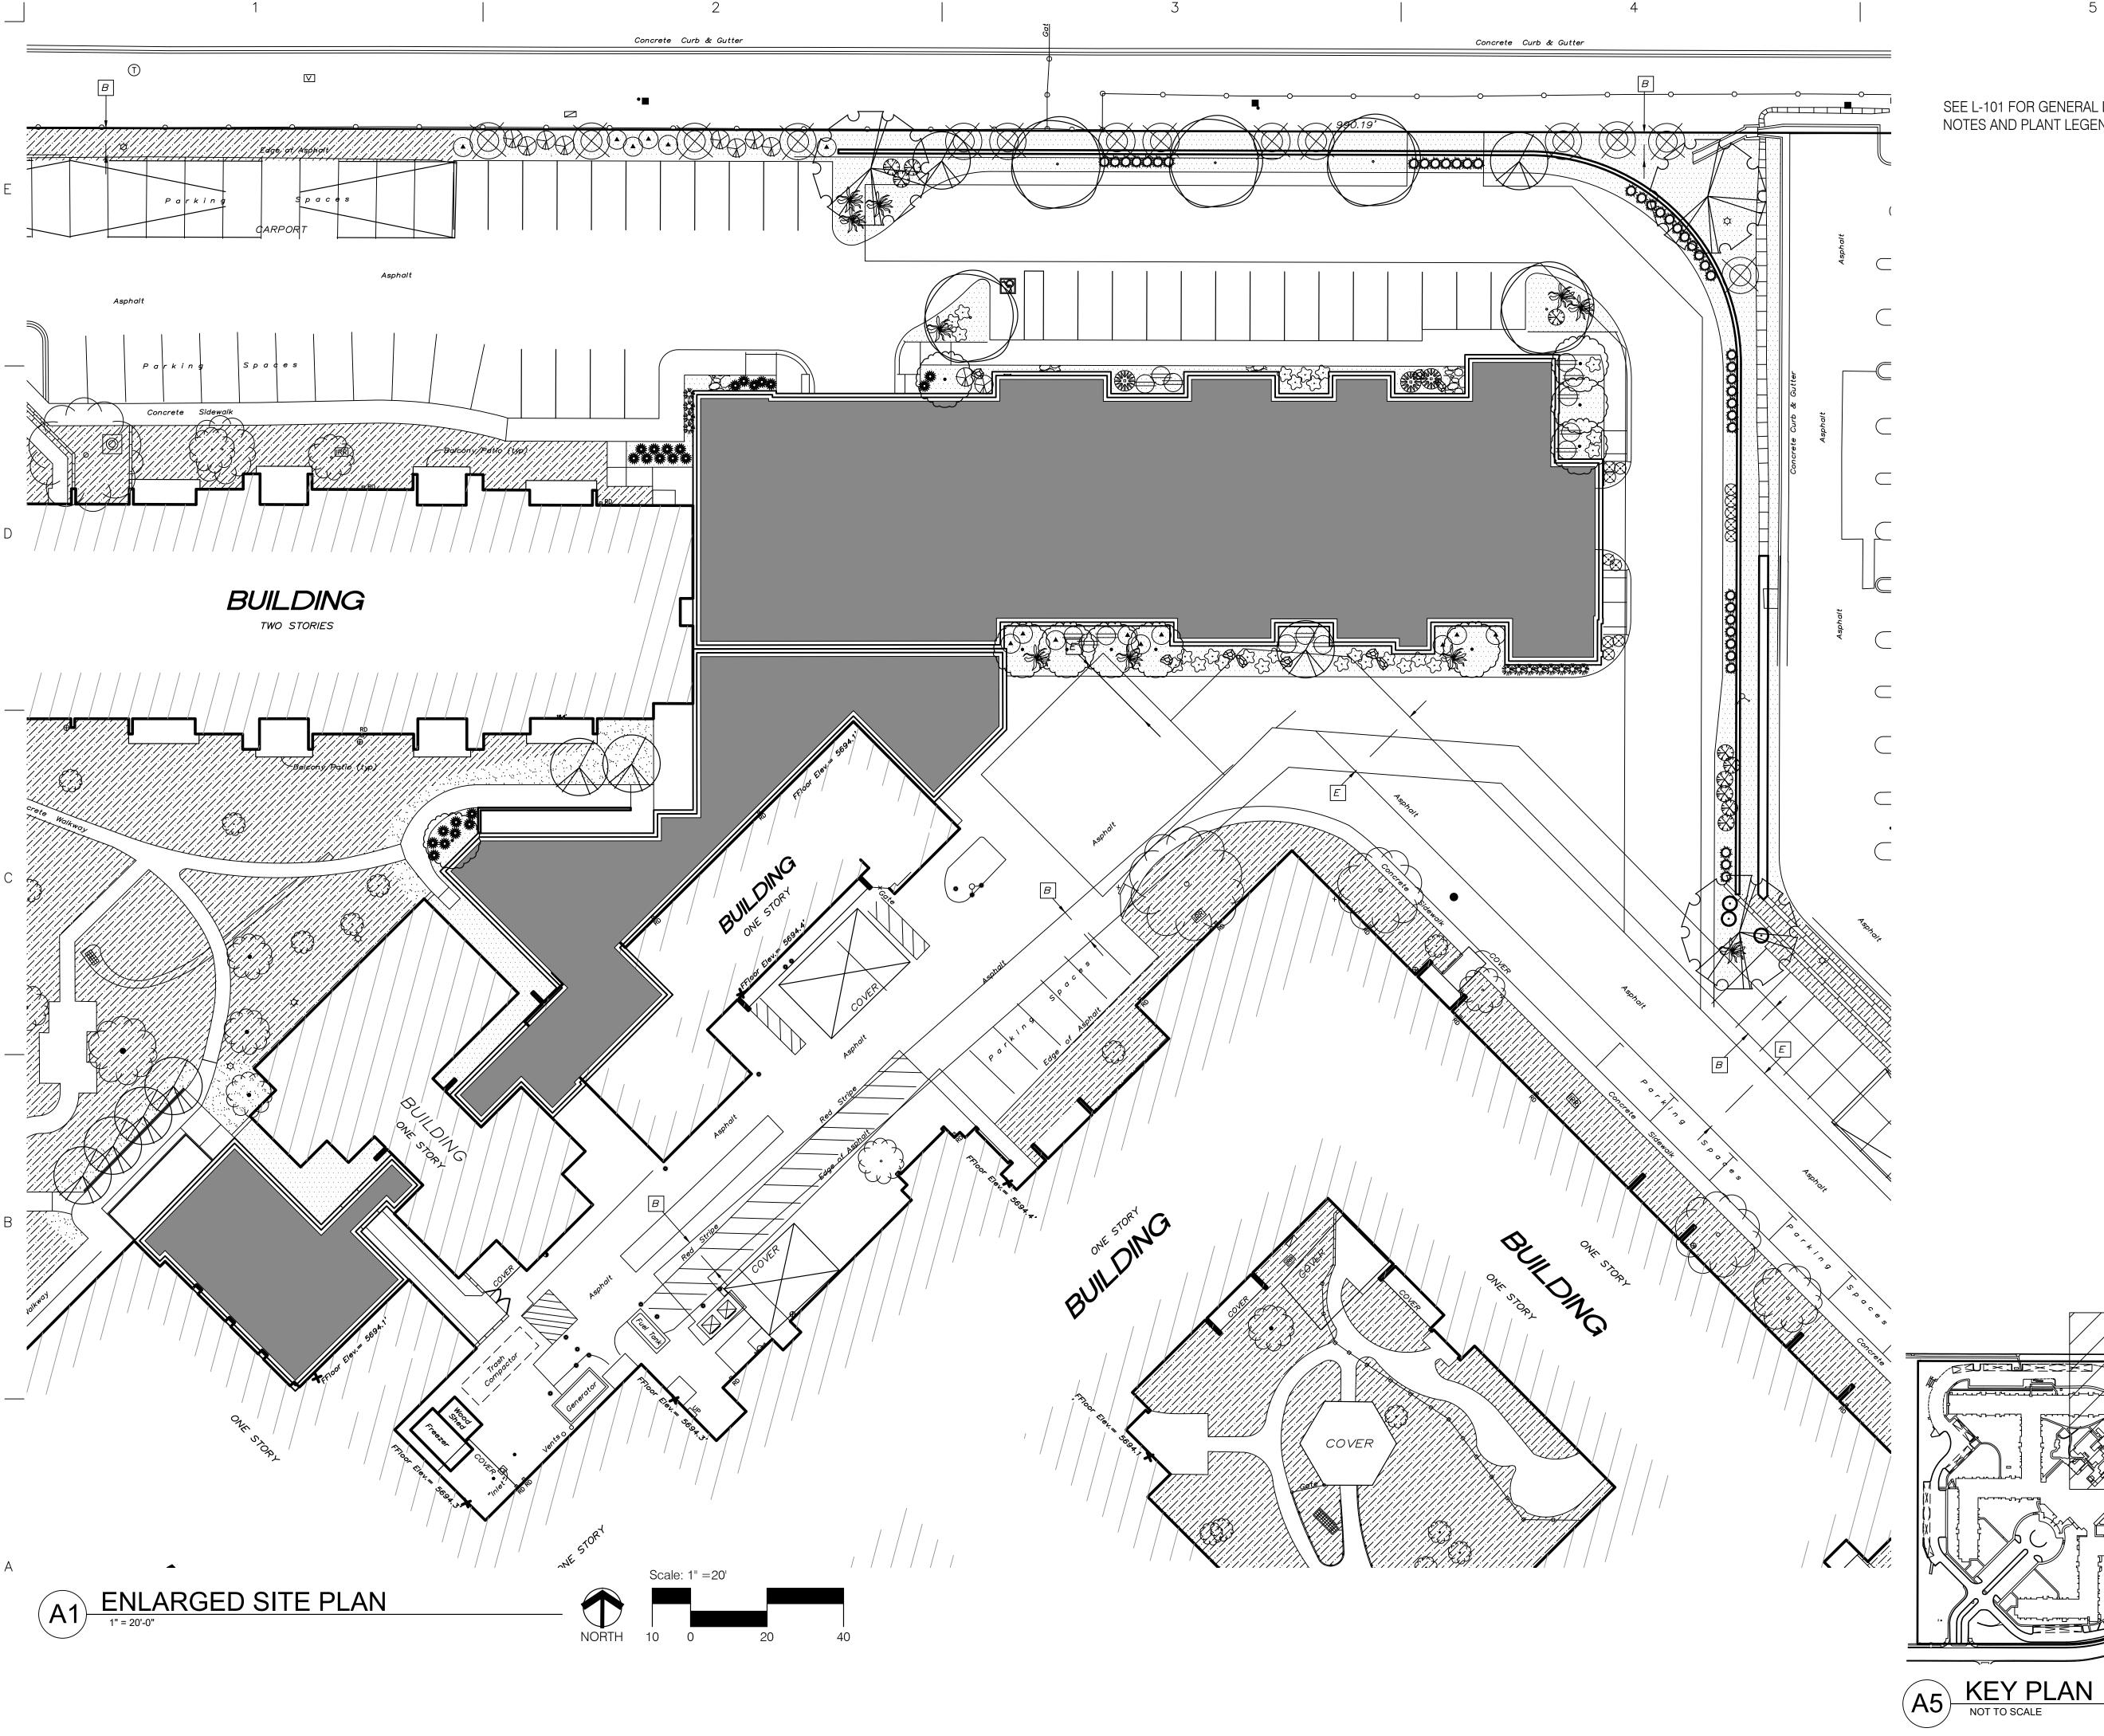

SEE L-101 FOR GENERAL LANDSCAPE NOTES AND PLANT LEGEND



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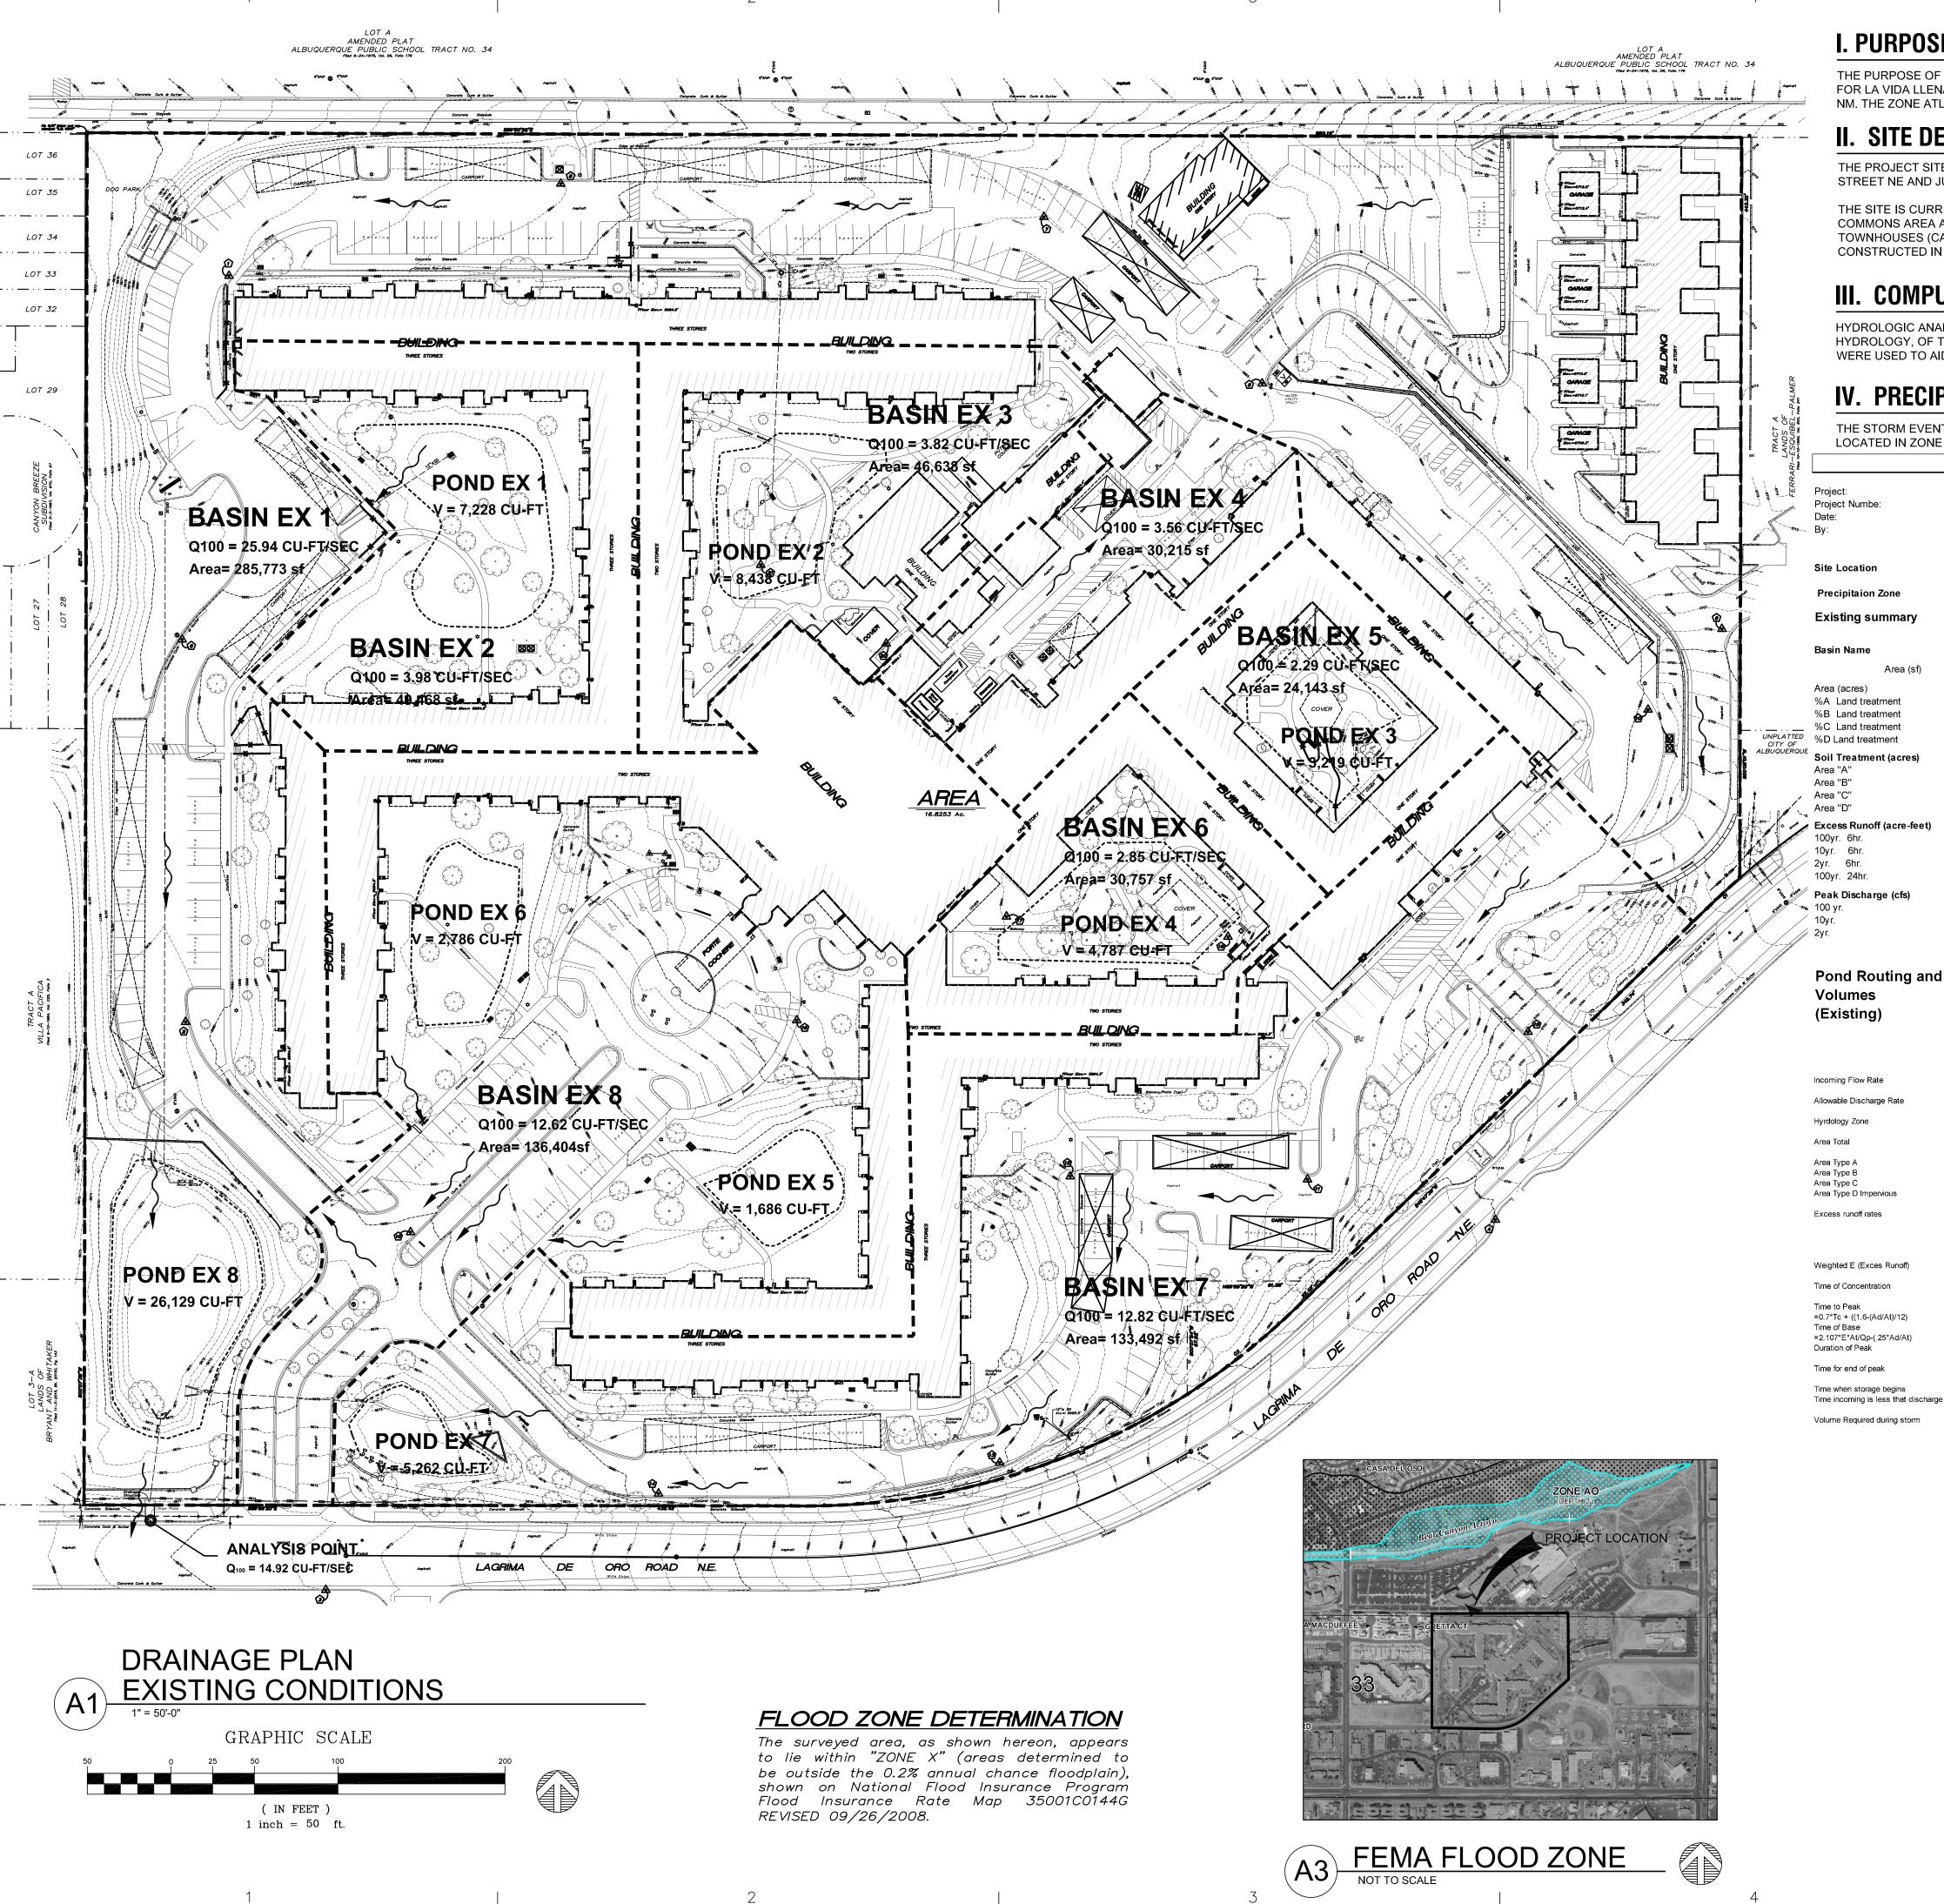
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Proj	ect number	2811
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ENLARGED LANDSCAPE PLAN

SHEET NUMBER:

L-103



I. PURPOSE AND SCOPE

THE PURPOSE OF THIS DRAINAGE PLAN IS TO PRESENT THE EXISTING AND PROPOSED DRAINAGE CONDITIONS FOR LA VIDA LLENA LIFE PLAN COMMUNITY, LOCATED AT 10701 LAGRIMA DE ORO ROAD NE IN ALBUQUERQUE, NM. THE ZONE ATLAS PAGE FOR THE SITE IS F-21-Z.

II. SITE DESCRIPTION AND HISTORY

THE PROJECT SITE IS LOCATED ON THE NORTH SIDE OF LAGRIMA DE ORO ROAD NE, BETWEEN MORRIS STREET NE AND JUAN TABO BOULEVARD NE.

THE SITE IS CURRENTLY COMPOSED OF 16.8 ACRE LOT WITH SEVERAL MUTLI-RESIDENT BUILDINGS, A

COMMONS AREA AS WELL AS A SKILLED NURSING WING. THE SITE ALSO CONTAINS SEVERAL SINGLE RESIDENT TOWNHOUSES (CASITAS) AND A MAINTENANCE BUILDING. A MAJORITY OF THE SITE WAS DEISGNED AND CONSTRUCTED IN 1979 AND 1984.

III. COMPUTATIONAL PROCEDURES

HYDROLOGIC ANALYSIS WAS PERFORMED UTILIZING THE DESIGN CRITERIA BASED ON SECTION 22.2, HYDROLOGY, OF THE DEVELOPMENT PROCESS MANUAL RELEASED JUNE 1997. TABLES WITHIN SECTION 22.2 WERE USED TO AID IN THE STUDY OF THE SITE HYDROLOGY.


IV. PRECIPITATION

THE STORM EVENT USED FOR THE FOLLOWING CALCULATIONS IS THE 100YR-6HR STORM. THE PROJECT SITE IS LOCATED IN ZONE 4 (EAST OF EUBANK BOULEVARD NE).

Drainage Summary

La Vida Llena

5712	Project: Project Numbe: Date: By:		La Vida L 2811 04/19/19 Dave A	iena										
	Site Location		10701 La	grima De	oro Road	I NE								
	Precipitaion Zone			4 Per	Γable A-1 (COA DPM S	ection 22.2							
	Existing summary													
	Basin Name		Ex 1	E	Ex 2	Ex 3	Ex 4	Ex 5	Ex 6	Ex 7	Ex 8			
	Area (sf)		285773		3468	46638	30215	24143	30757	133492	136404			
	Area (acres)		6.56		.11	1.07	0.69	0.55	0.71	3.06	3.13			
	%A Land treatment		40		55	55	0	25	35	35	40			
	%B Land treatment		0		0	0	5	15	0	0	0			
	%C Land treatment		5		0	0	0	0	10	0	0			
TED OF	%D Land treatment		55		45	45	95	60	55	65	60			
RQUE	Soil Treatment (acres)													
	Area "A"		2.62).61	0.59	0.00	0.14	0.25	1.07	1.25			
	Area "B"		0.00		0.00	0.00	0.03	0.08	0.00	0.00	0.00			
/	Area "C"		0.33		0.00	0.00	0.00	0.00	0.07	0.00	0.00			
`~~a	Area "D"		3.61	().50	0.48	0.66	0.33	0.39	1.99	1.88			
South Section 1	Excess Runoff (acre-feet)		4 0007		4540	0.4450	0.4404	0.0000	0.4405	0.5007	0.4000		4	
•	100yr. 6hr. 10yr. 6hr.		1.0087 0.5893		1510 0848	0.1453 0.0816	0.1481 0.0941	0.0899 0.0533	0.1105 0.0648	0.5097 0.3056	0.4968 0.2938		acre-ft acre-ft	
//	2yr. 6hr.		0.3093			0.0610	0.0558	0.0333	0.0347	0.3030	0.2930		acre-ft	
	100yr. 24hr.		1.2342		1822	0.1754	0.1893	0.1107	0.1348	0.6342	0.6143		acre-ft	
)s/s/														
5/ 5m	Peak Discharge (cfs) 100 yr.		25.94	-	3.98	3.82	3.56	2.29	2.85	12.82	12.62		cfs	
	10yr.		15.91		2.32	2.23	2.40	1.43	1.76	8.04	7.80		cfs	
	2yr.		8.29		.12	1.07	1.44	0.76	0.93	4.38	4.14		cfs	
	Pond Routing and													
	-													
	Volumes		Pond	Pond	Pond		Pond	Pond	Pond	Pond	Pond			
	(Existing)		EX8	EX1	EX2		EX3	EX4	EX7	EX5	EX6			
			Basin	Basin	Basin				Basin	Basir EX#8				
			EX#1	EX#2	EX#3	EX#4	EX#5	EX#6	EX#7	East	West			
	Incoming Flow Rate	Qin	45.90		3.98	3.82	3.56	2.29	2.85	13.24	6.31	6.31	cfs	
	Allowable Discharge Rate	Qout	14.92		0	0.00	3.56	0.32	0.10	8.20	4.50	3.70	cfs	
	Hyrdology Zone Area Total	At	6.57		4 1.11	4 1.07	0.69	4 0.55	4 0.71	4 3.06	4 1.57	1.57	Figure A-1 acres	
	Alea Total	Αι	0.57		1.11	1.07	0.09	0.55	0.71	3.00	1.37	1.57	acies	
	Area Type A	Aa Ab	40 0		55 0	55 0	0 5	25	35 0	35 0	40 0	40 0	% %	
	Area Type B Area Type C	Ac	5		0	0	0	15 0	10	0	0	0	%	
	Area Type D Impervious	Ad	55		45	45	95	60	55	65	60	60	%	
	Excess runoff rates	Α	0.80		0.80	0.80	0.80	0.80	0.80	0.80	0.80	0.80	inches	
		В	1.08		1.08	1.08	1.08	1.08	1.08	1.08	1.08	1.08	inches	
		C D	1.46 2.64		1.46 2.64	1.46 2.64	1.46 2.64	1.46	1.46	1.46 2.64	1.46 2.64	1.46	inches inches	
		U	∠.64		4.04	2.04	2.64	2.64	2.64	2.64	2.04	2.64	IIICHES	
	Weighted E (Exces Runoff)		1.85		1.63	1.63	2.56	1.95	1.88	2.00	1.90	1.90	in	
	Time of Concentration		0.2		0.2	0.2	0.2	1.2	2.2	3.2	4.2	3.2	hours	
	Time to Peak =0.7*Tc + ((1.6-(Ad/At)/12)		0.228		.236	0.236	0.194		1.628		3.023	2.323	hours	

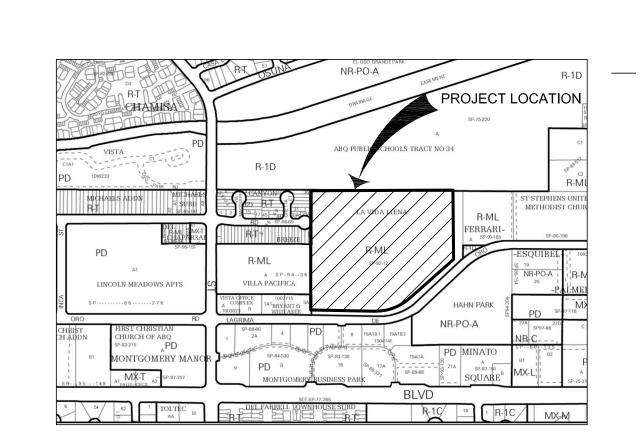

ZONE ATLAS PAGE F-21



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PROJECT NAME

REVISIONS:

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HAVERLAND CARTER GROUP 10701 Montgomery Boulevard NE ALBUQUERQUE NM, 87111


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Date		7-31-2019
Proje	ect number	2811
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SHEET TITLE:

DRAINAGE PLAN **EXISTING CONDITIONS**

SHEET NUMBER:

CD-1

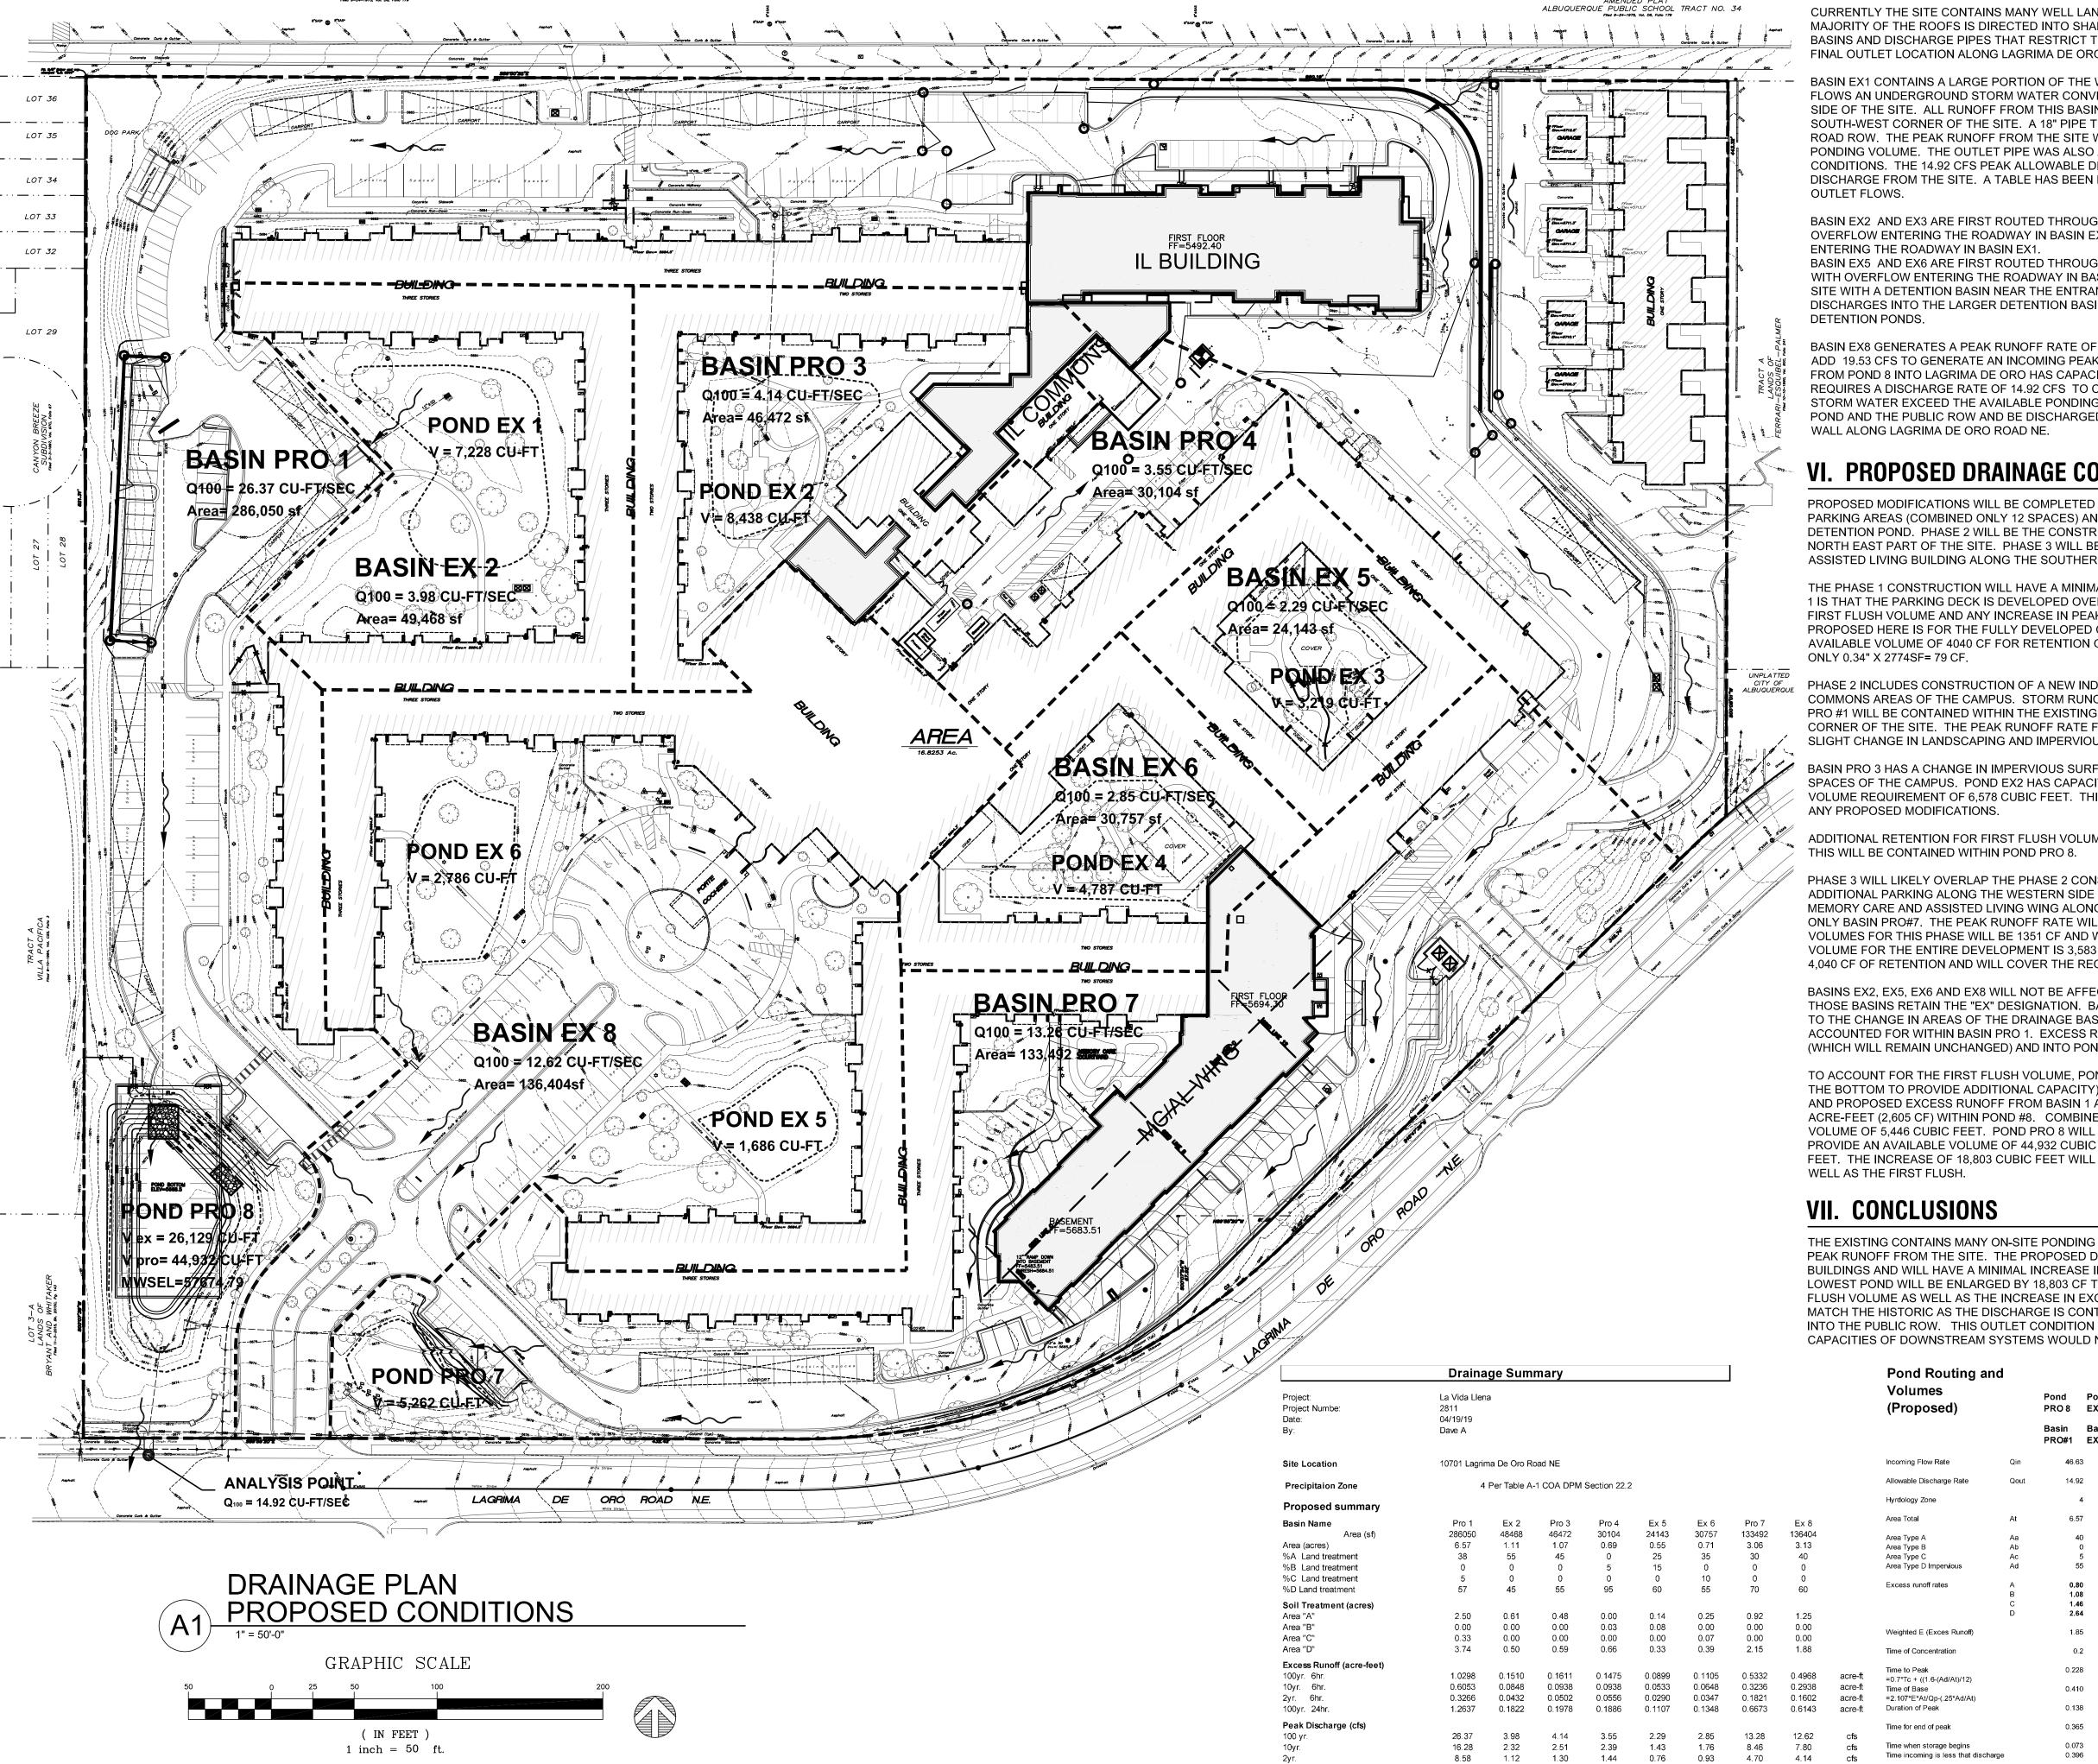

First Flush Ponding Voulme (cf)

V. EXISTING DRAINAGE CONDITIONS

CURRENTLY THE SITE CONTAINS MANY WELL LANDSCAPED DETENTION/RETENTION AREAS. RUNOFF FROM A BASINS AND DISCHARGE PIPES THAT RESTRICT THE RUNOFF RATES FROM THE DETENTION AREAS TOWARD THE

PONDING VOLUME. THE OUTLET PIPE WAS ALSO ANALYZED AND CAN CONVEY 18.5 CFS UNDER INLET CONTROL CONDITIONS. THE 14.92 CFS PEAK ALLOWABLE DISCHARGE RATE WILL BE USED AS THE EXISTING ALLOWABLE DISCHARGE FROM THE SITE. A TABLE HAS BEEN PROVIDED ON SHEET CD1 OF ALL PONDS AND ROUTED PEAK

BASIN EX2 AND EX3 ARE FIRST ROUTED THROUGH PONDING AREAS WITHIN THE LANDSCAPING AREAS, WITH OVERFLOW ENTERING THE ROADWAY IN BASIN EX1. BASIN EX4 IS THE SERVICE YARD WITH EXCESS RUNOFF

BASIN EX5 AND EX6 ARE FIRST ROUTED THROUGH PONDINGS AREA WITHIN THE LANDSCAPED COURYARD AREAS WITH OVERFLOW ENTERING THE ROADWAY IN BASIN EX7. BASIN EX7 CONTAINS THE SOUTHERN PORTION OF THE SITE WITH A DETENTION BASIN NEAR THE ENTRANCE DRIVE FROM LAGRIMA DE ORO. THIS POND THEN DISCHARGES INTO THE LARGER DETENTION BASIN IN BASIN EX1. A 18" STORM DRAIN PIPE CONNECTS THE TWO

BASIN EX8 GENERATES A PEAK RUNOFF RATE OF 26.37 CFS. OTHER BASINS THAT ARE ROUTED INTO BASIN EX8 ADD 19.53 CFS TO GENERATE AN INCOMING PEAK FLOWRATE INTO POND EX8 OF 45.90 CFS. THE OUTLET PIPE FROM POND 8 INTO LAGRIMA DE ORO HAS CAPACITY TO CONVEY 18.5 CFS. BUT THE ROUTING HYDROGRAPH ONLY REQUIRES A DISCHARGE RATE OF 14.92 CFS TO CONTAIN THE 100 YEAR 6 HOUR DESIGN STORM. SHOULD THE STORM WATER EXCEED THE AVAILABLE PONDING VOLUME. THE WATER WILL OVERTOP THE BERM BETWEEN THE POND AND THE PUBLIC ROW AND BE DISCHARGED THROUGH A SERIES OF TURNED BLOCKS IN THE MASONRY

VI. PROPOSED DRAINAGE CONDITIONS

PROPOSED MODIFICATIONS WILL BE COMPLETED IN THREE PHASES. THE FIRST PHASE IS TWO SMALL SURFACE PARKING AREAS (COMBINED ONLY 12 SPACES) AND AN ELEVATED PARKING DECK OVER AN EXISTING DETENTION POND. PHASE 2 WILL BE THE CONSTRUCTION OF A NEW INDEPENDENT LIVING BUILDING IN THE NORTH EAST PART OF THE SITE. PHASE 3 WILL BE A THE CONSTRUCTION OF A NEW MEMORY CARE AND ASSISTED LIVING BUILDING ALONG THE SOUTHERN PART OF THE SITE ADJACENT TO LAGRIMA DE ORO.

THE PHASE 1 CONSTRUCTION WILL HAVE A MINIMAL IMPACT ON STORM RUNOFF RATES. THE ISSUE FOR PHASE 1 IS THAT THE PARKING DECK IS DEVELOPED OVER AN EXISTING POND. THIS POND WILL NEED TO CONTAIN THE FIRST FLUSH VOLUME AND ANY INCREASE IN PEAK RUNOFF RATES FOR FUTURE PHASES. THE PLAN BEING PROPOSED HERE IS FOR THE FULLY DEVELOPED CONDITIONS. RESHAPING OF POND PRO 8 WILL CREATE AN AVAILABLE VOLUME OF 4040 CF FOR RETENTION OF FIRST FLUSH VOLUMES. PHASE 1 FIRST FLUSH VOLUME IS

PHASE 2 INCLUDES CONSTRUCTION OF A NEW INDEPENDENT LIVING BUILDING AND ADDITIONS TO THE COMMONS AREAS OF THE CAMPUS. STORM RUNOFF PATTERNS ARE MAINTAINED AND INCREASE FROM BASIN PRO #1 WILL BE CONTAINED WITHIN THE EXISTING RING ROAD AND DIRECTED OVER TO POND PRO 8 AT THE SE CORNER OF THE SITE. THE PEAK RUNOFF RATE FROM BASIN PRO#1 IS INCREASED BY 0.43 CFS DUE TO A SLIGHT CHANGE IN LANDSCAPING AND IMPERVIOUS SURFACES.

BASIN PRO 3 HAS A CHANGE IN IMPERVIOUS SURFACE DUE TO BUILDING ADDITIONS FOR THE COMMONS SPACES OF THE CAMPUS. POND EX2 HAS CAPACITY OF 8,438 CUBIC FEET WITH A PROPOSED EXCESS RUNOFF VOLUME REQUIREMENT OF 6,578 CUBIC FEET. THIS POND AND THE DISCHARGE PIPING WILL REMAIN WITHOUT

ADDITIONAL RETENTION FOR FIRST FLUSH VOLUMES IS 1771CF (BASIN PRO#1)+ 382 CF (BASIN PRO#3)= 2153 CF.

PHASE 3 WILL LIKELY OVERLAP THE PHASE 2 CONSTRUCTION ACTIVITIES. PHASE 3 INCLUDES CREATION OF ADDITIONAL PARKING ALONG THE WESTERN SIDE OF THE SITE TO PROVIDE OVERFLOW PARKING AND A NEW MEMORY CARE AND ASSISTED LIVING WING ALONG THE SOUTH EAST PORTION OF THE SITE. THIS WILL AFFECT ONLY BASIN PRO#7. THE PEAK RUNOFF RATE WILL BE INCREASED BY 0.46 CFS IN BASIN PRO #7. FIRST FLUSH VOLUMES FOR THIS PHASE WILL BE 1351 CF AND WILL BE CONTAINED IN POND PRO 8. THE TOTAL FIRST FLUSH VOLUME FOR THE ENTIRE DEVELOPMENT IS 3,583 CF. THE PHASE 1 RESHAPING OF POND PRO 8 WILL PROVIDE 4,040 CF OF RETENTION AND WILL COVER THE REQUIRED FIRST FLUSH VOLUME.

BASINS EX2, EX5, EX6 AND EX8 WILL NOT BE AFFECTED BY THE PROPOSED DEVELOPMENT. FOR SIMPLICITY THOSE BASINS RETAIN THE "EX" DESIGNATION. BASIN PRO 4 HAS A SLIGHT DECREASE IN EXCESS RUNOFF DUE TO THE CHANGE IN AREAS OF THE DRAINAGE BASIN. THE AREA THAT WAS REMOVED FROM THIS BASIN, IS NOW ACCOUNTED FOR WITHIN BASIN PRO 1. EXCESS RUNOFF FROM BASIN PRO 7 WILL BE ROUTED THOUGH POND 7 (WHICH WILL REMAIN UNCHANGED) AND INTO POND PRO#8.

AND PROPOSED EXCESS RUNOFF FROM BASIN 1 AND 7 CREATES A NEED TO POND AN ADDITIONAL 0.0596 ACRE-FEET (2.605 CF) WITHIN POND #8. COMBINED THIS REQUIRES THAT POND #8 HAVE AN ADDITIONAL VOLUME OF 5,446 CUBIC FEET. POND PRO 8 WILL BE RESHAPED IN PHASE 1 OF THE PROJECT AND WILL PROVIDE AN AVAILABLE VOLUME OF 44,932 CUBIC FEET. ORIGINAL VOLUME OF THIS POND WAS 26,129 CUBIC FEET. THE INCREASE OF 18,803 CUBIC FEET WILL EASILY CONTAIN THE REQUIRED EXCESS RUNOFF VOLUME AS

THE EXISTING CONTAINS MANY ON-SITE PONDING FACILITIES THAT WILL CONTINUE TO DETAIN AND DELAY THE PEAK RUNOFF FROM THE SITE. THE PROPOSED DEVELOPMENT WILL BE REPLACING PARKING LOTS FOR BUILDINGS AND WILL HAVE A MINIMAL INCREASE IN PEAK RUNOFF ENTERING THE PONDING AREAS. THE LOWEST POND WILL BE ENLARGED BY 18,803 CF TO PROVIDE THE REQUIRED VOLUME TO RETAIN THE FIRST FLUSH VOLUME AS WELL AS THE INCREASE IN EXCESS RUNOFF. DISCHARGE POINTS FROM THE SITE WILL MATCH THE HISTORIC AS THE DISCHARGE IS CONTROLLED BY THE OUTLET CONDITIONS BEFORE DISCHARGING INTO THE PUBLIC ROW. THIS OUTLET CONDITION WILL NOT BE MODIFIED BY THE PROPOSED DEVELOPMENT. CAPACITIES OF DOWNSTREAM SYSTEMS WOULD NOT BE AFFECTED BY THE PROPOSED DEVELOPMENT

Volumes (Proposed)		Pond PRO 8	Pond EX1	Pond EX 2		Pond EX 3	Pond EX 4	Pond PRO 7	Pond EX 5	Pond EX 6	
		Basin PRO#1	Basin EX#2	Basin EX#3	Basin PRO#4	Basin EX#5	Basin EX#6	Basin PRO#7	Basin EX #8 East	Basin EX #8 West	
Incoming Flow Rate	Qin	46.63	3.98	4.14	3.56	2.29	2.85	13.70	6.31	6.31	cfs
Allowable Discharge Rate	Qout	14.92	0	0.00	3.56	0.32	0.10	8.50	4.50	3.70	cfs
Hyrdology Zone		4	4	4	4	4	4	4	. 4	4	Figure A
Area Total	At	6.57	1.11	1.07	0.69	0.55	0.71	3.06	1.57	1.57	acres
Area Type A	Aa	40	55	4 5	0	25	35	35	40	40	%
Area Type B	Ab	0									
Area Type C	Ac	5									
Area Type D Impervious	Ad	55	45	55	95	60	55	65	60	60	%
Excess runoff rates	Α	0.80									
	В	1.08									
	C D	1.46 2.64					1.46 2.64				
Weighted E (Exces Runoff)		1.85	1.63	1.81	2.56	1.95	1.88	2.00	1.90	1.90) in
Time of Concentration		0.2	0.2	0.2	0.2	1.2	2.2	3.2	4.2	3.2	hours
Fime to Peak =0.7*Tc + ((1.6-(Ad/At)/12)		0.228	0.236	0.228	0.19 4	0.923	1.628	2.319	3.023	2.323	hours
Time of Base		0.410	0.846	0.846	0.810	0.842	0.843	0.778	0.845	0.845	hours
=2.107*E*At/Qp-(.25*Ad/At) Duration of Peak		0.138	0.113	0.138	0.238	0.150	0.138	0.163	0.150	0.150	hours
Time for end of peak		0.365	0.348	0.365	0.432	1.073	1.765	2.482	3.173	2.473	hours
Time when storage begins		0.073	0.000	0.000	0.194	0.129	0.057	1.439	2.156	1.362	hours
Time incoming is less that discha	arge	0.396	0.846	0.846	0. 4 32	0.875	0.875	1.835	2.506	1.800	hours
Volume Required during storm		7.298	1.908	2.037	0.000	0.882	1.314	1.453	0.452	0.767	acre inc
		26491	6927	7393	0	3202	4770	5273	1641	2794	cubic fee



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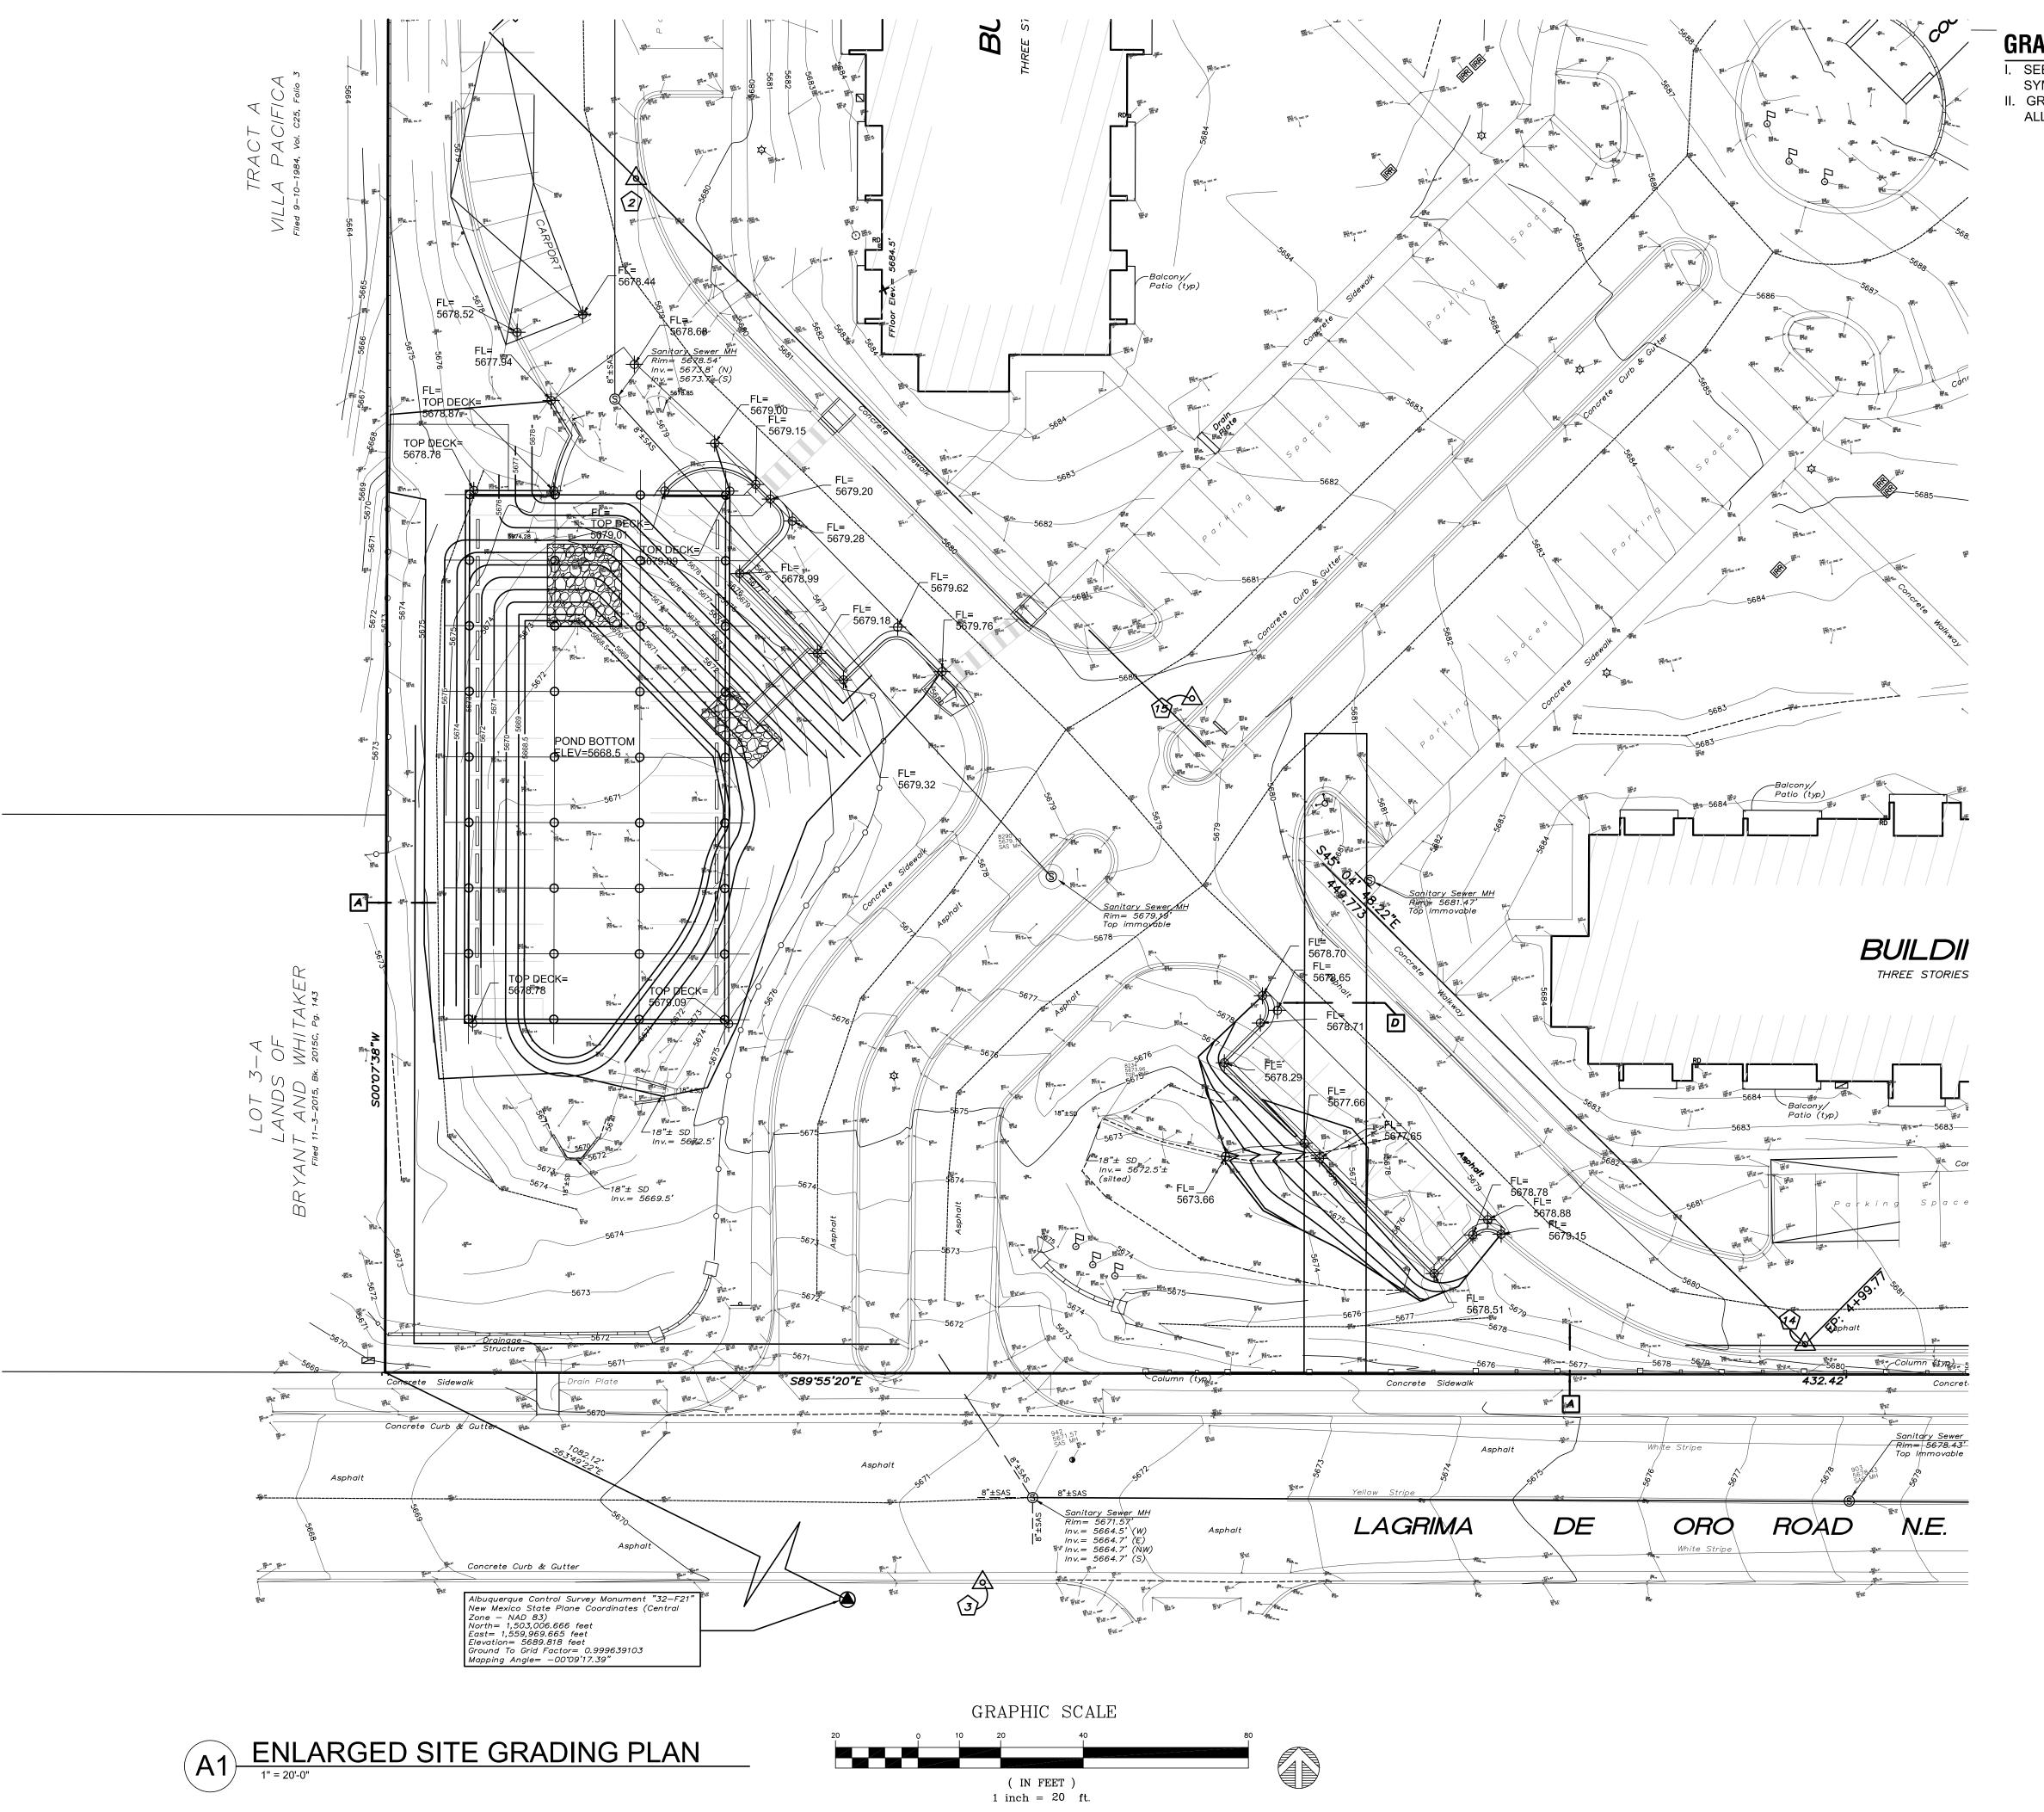
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DRAINAGE PLAN PROPOSED CONDITIONS

SHEET NUMBER:



GRADING PLAN GENERAL NOTES

- I. SEE SHEET CG001 FOR COMPLETE LIST OF GENERAL NOTES AND SYMBOL/LINETYPE LEGEND THAT APPLY TO ALL SHEETS.
- II. GRADING PLAN KEYED NOTES ARE COMMON TO ALL SHEETS. NOT ALL KEYED NOTES WILL APPEAR ON EVERY PAGE.



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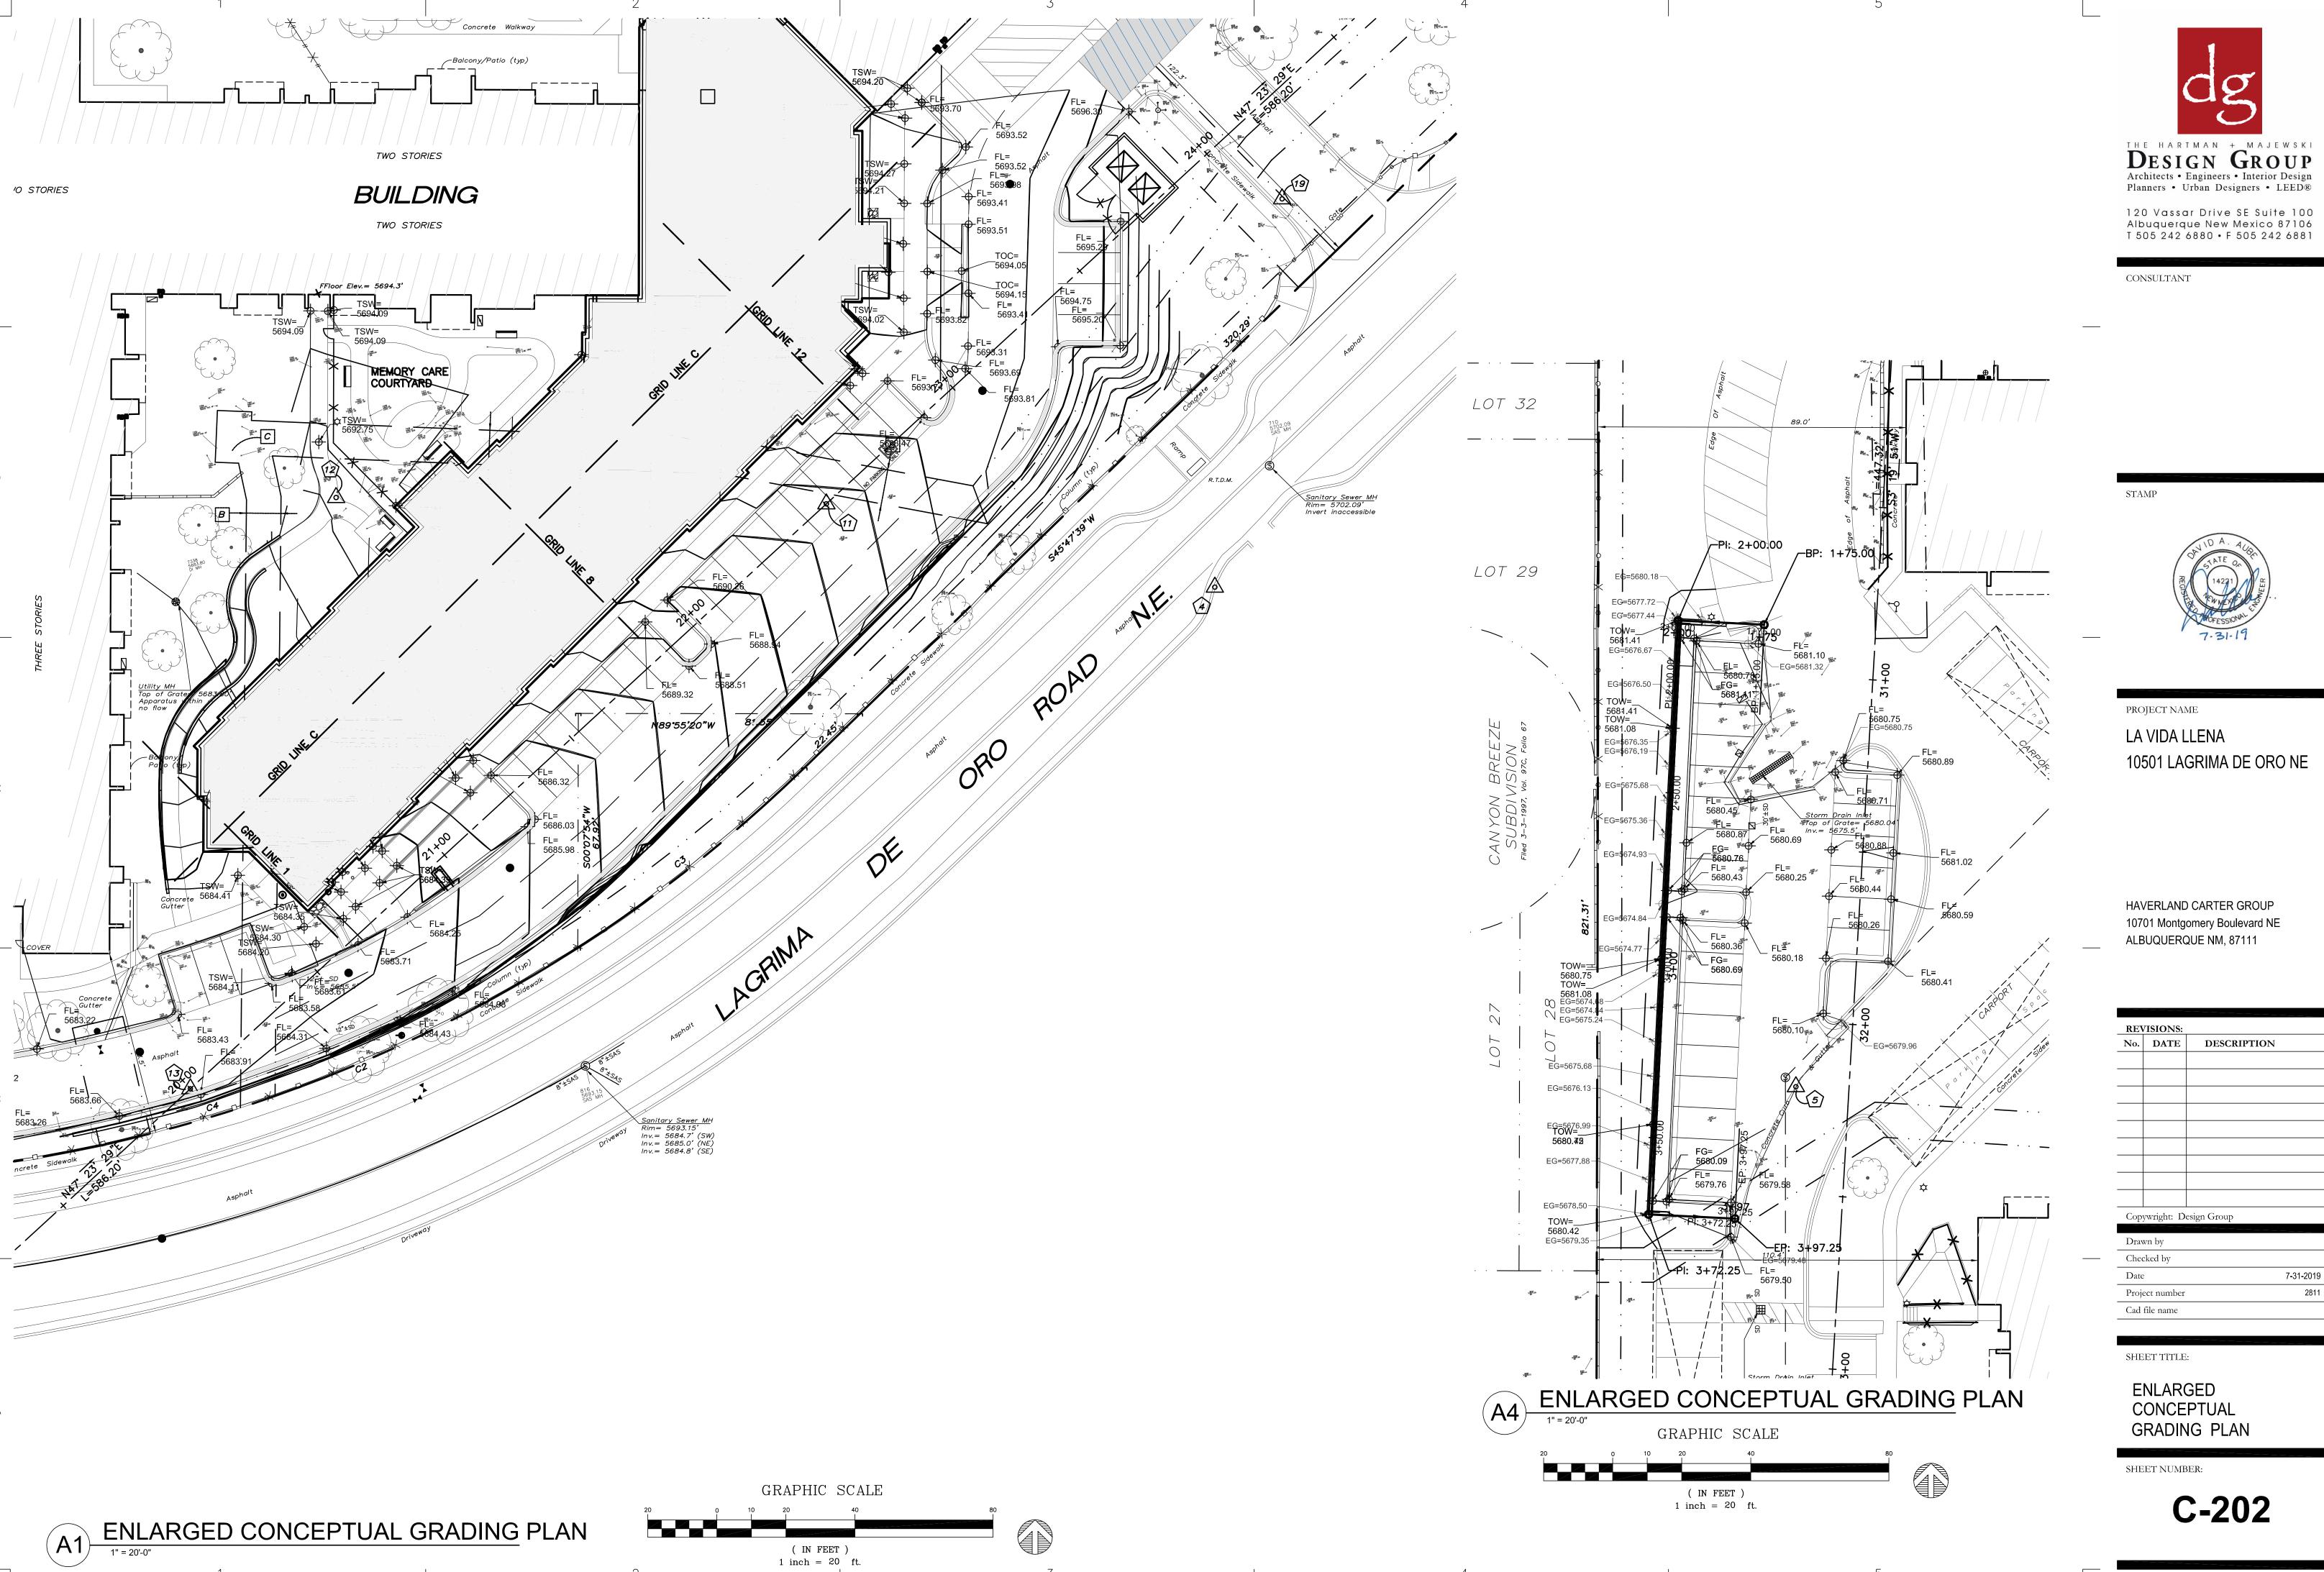
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ENLARGED SITE GRADING PLAN

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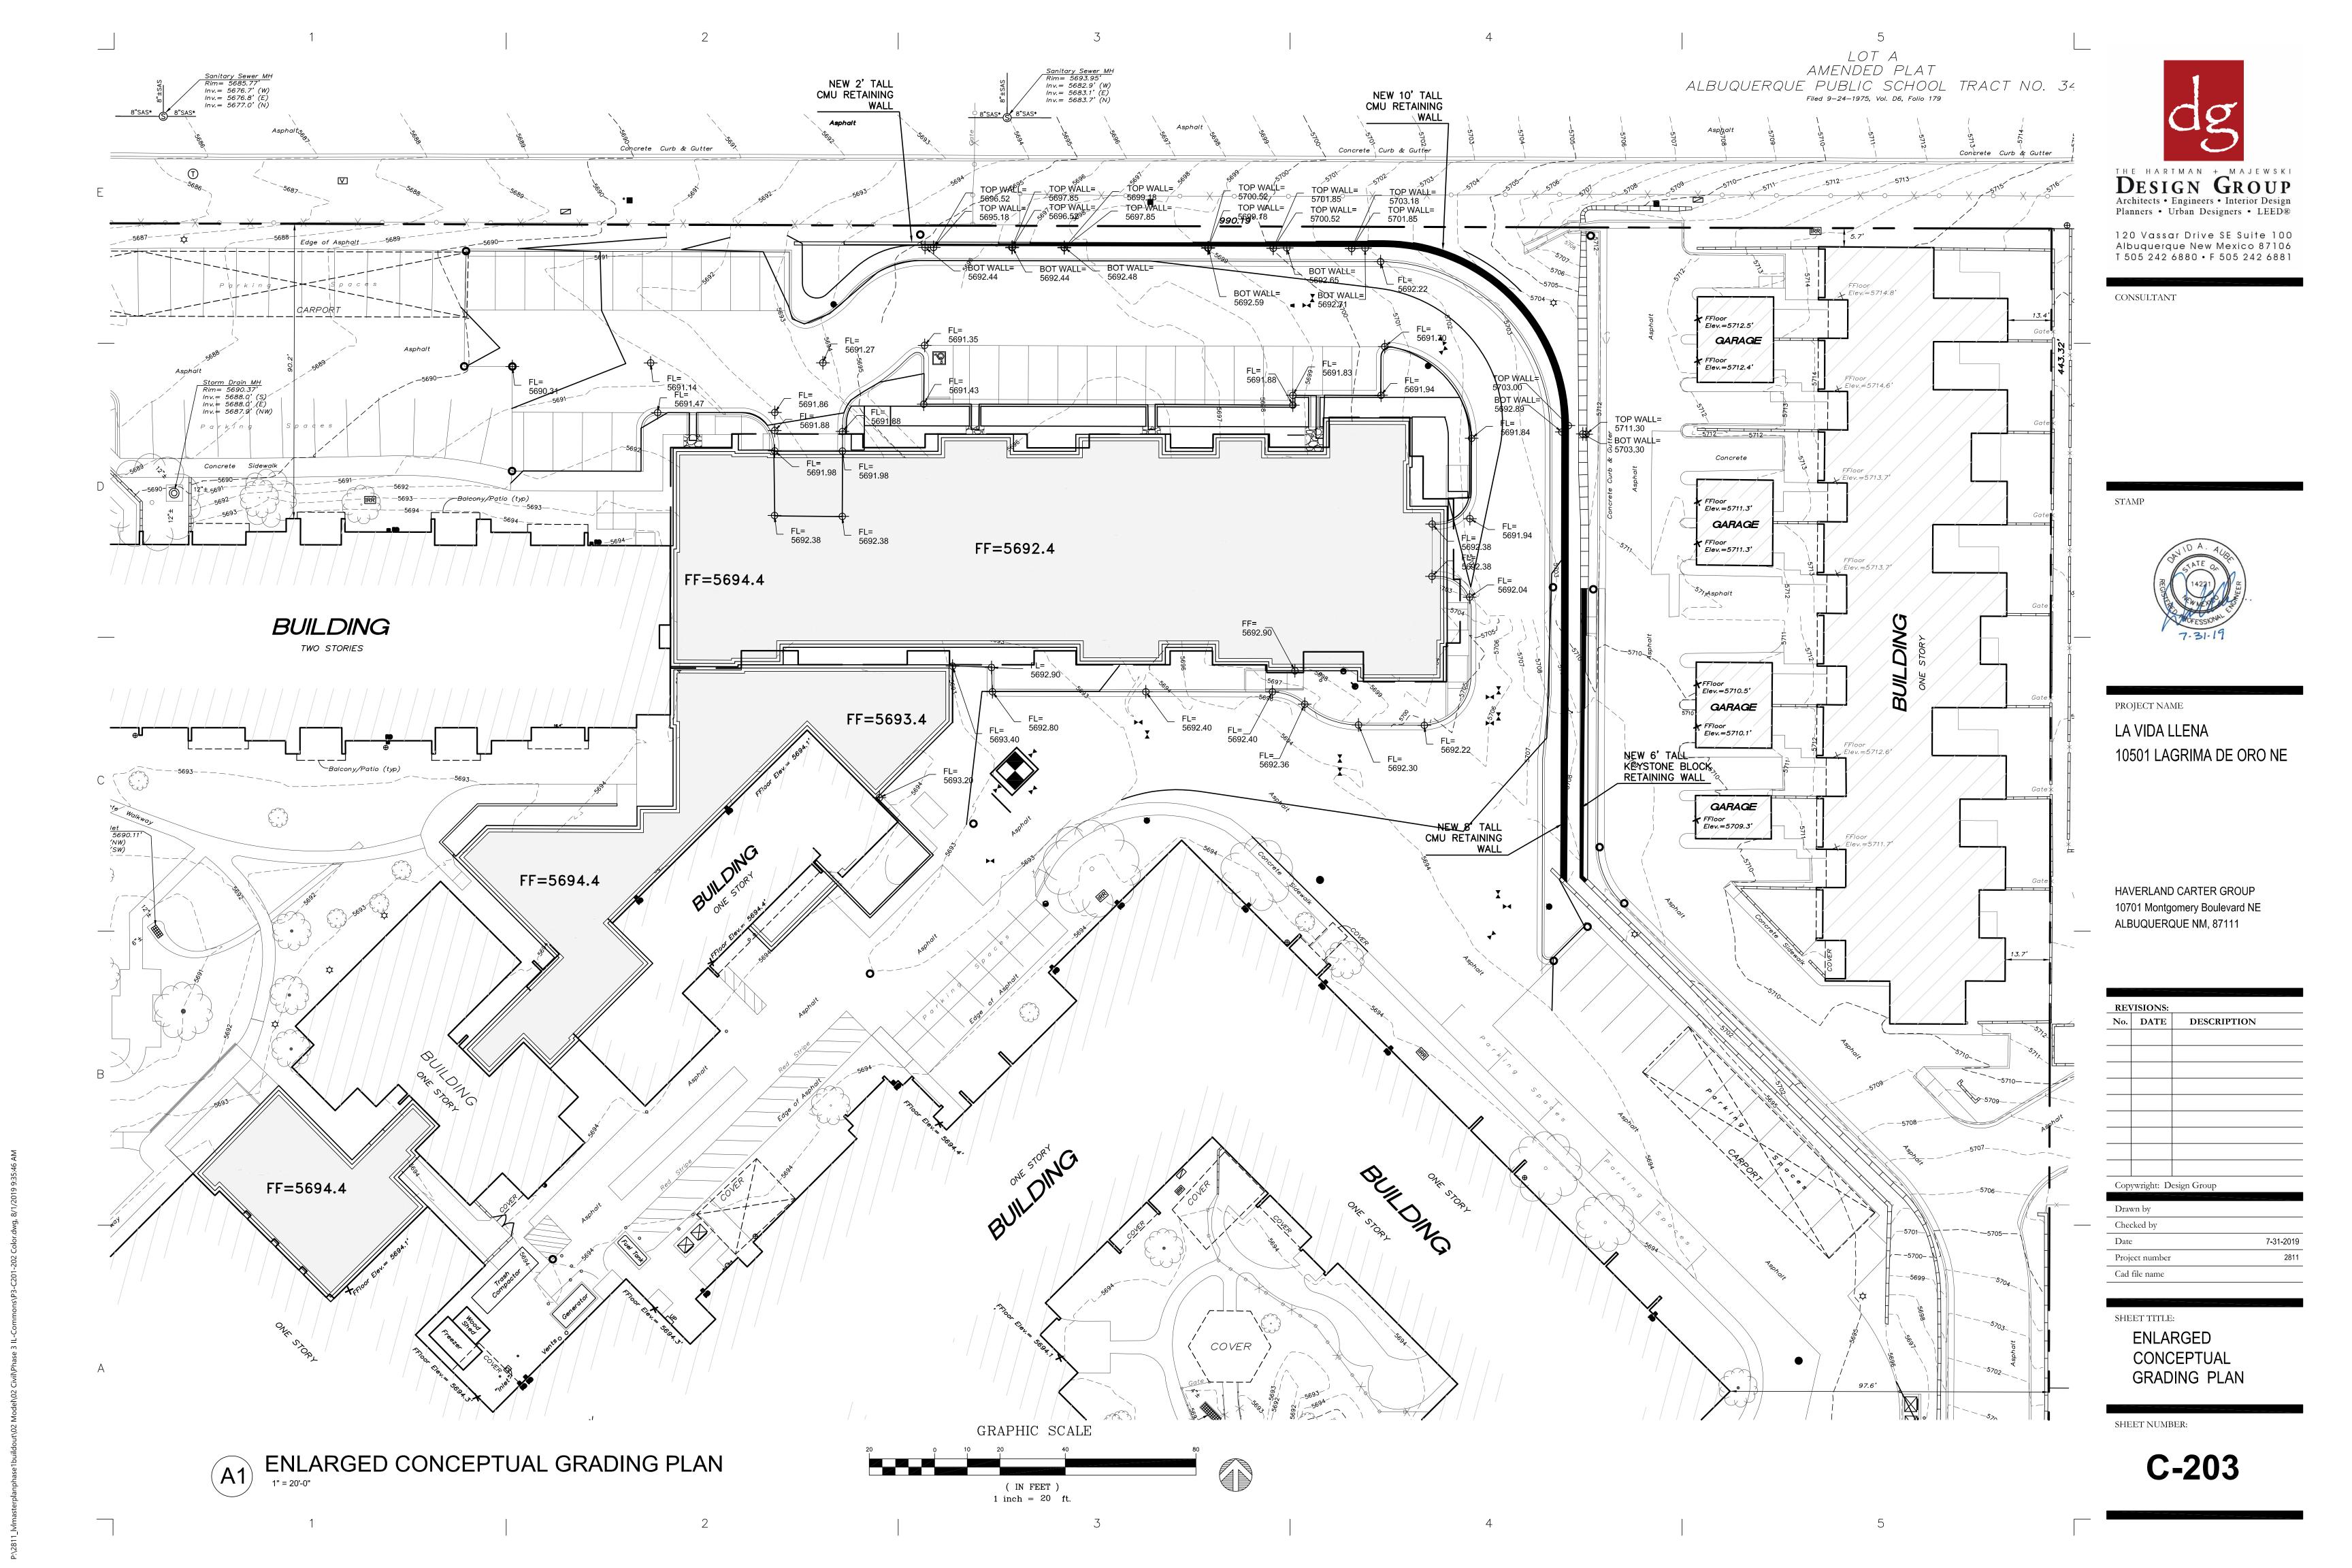





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10701 Montgomery Boulevard NE

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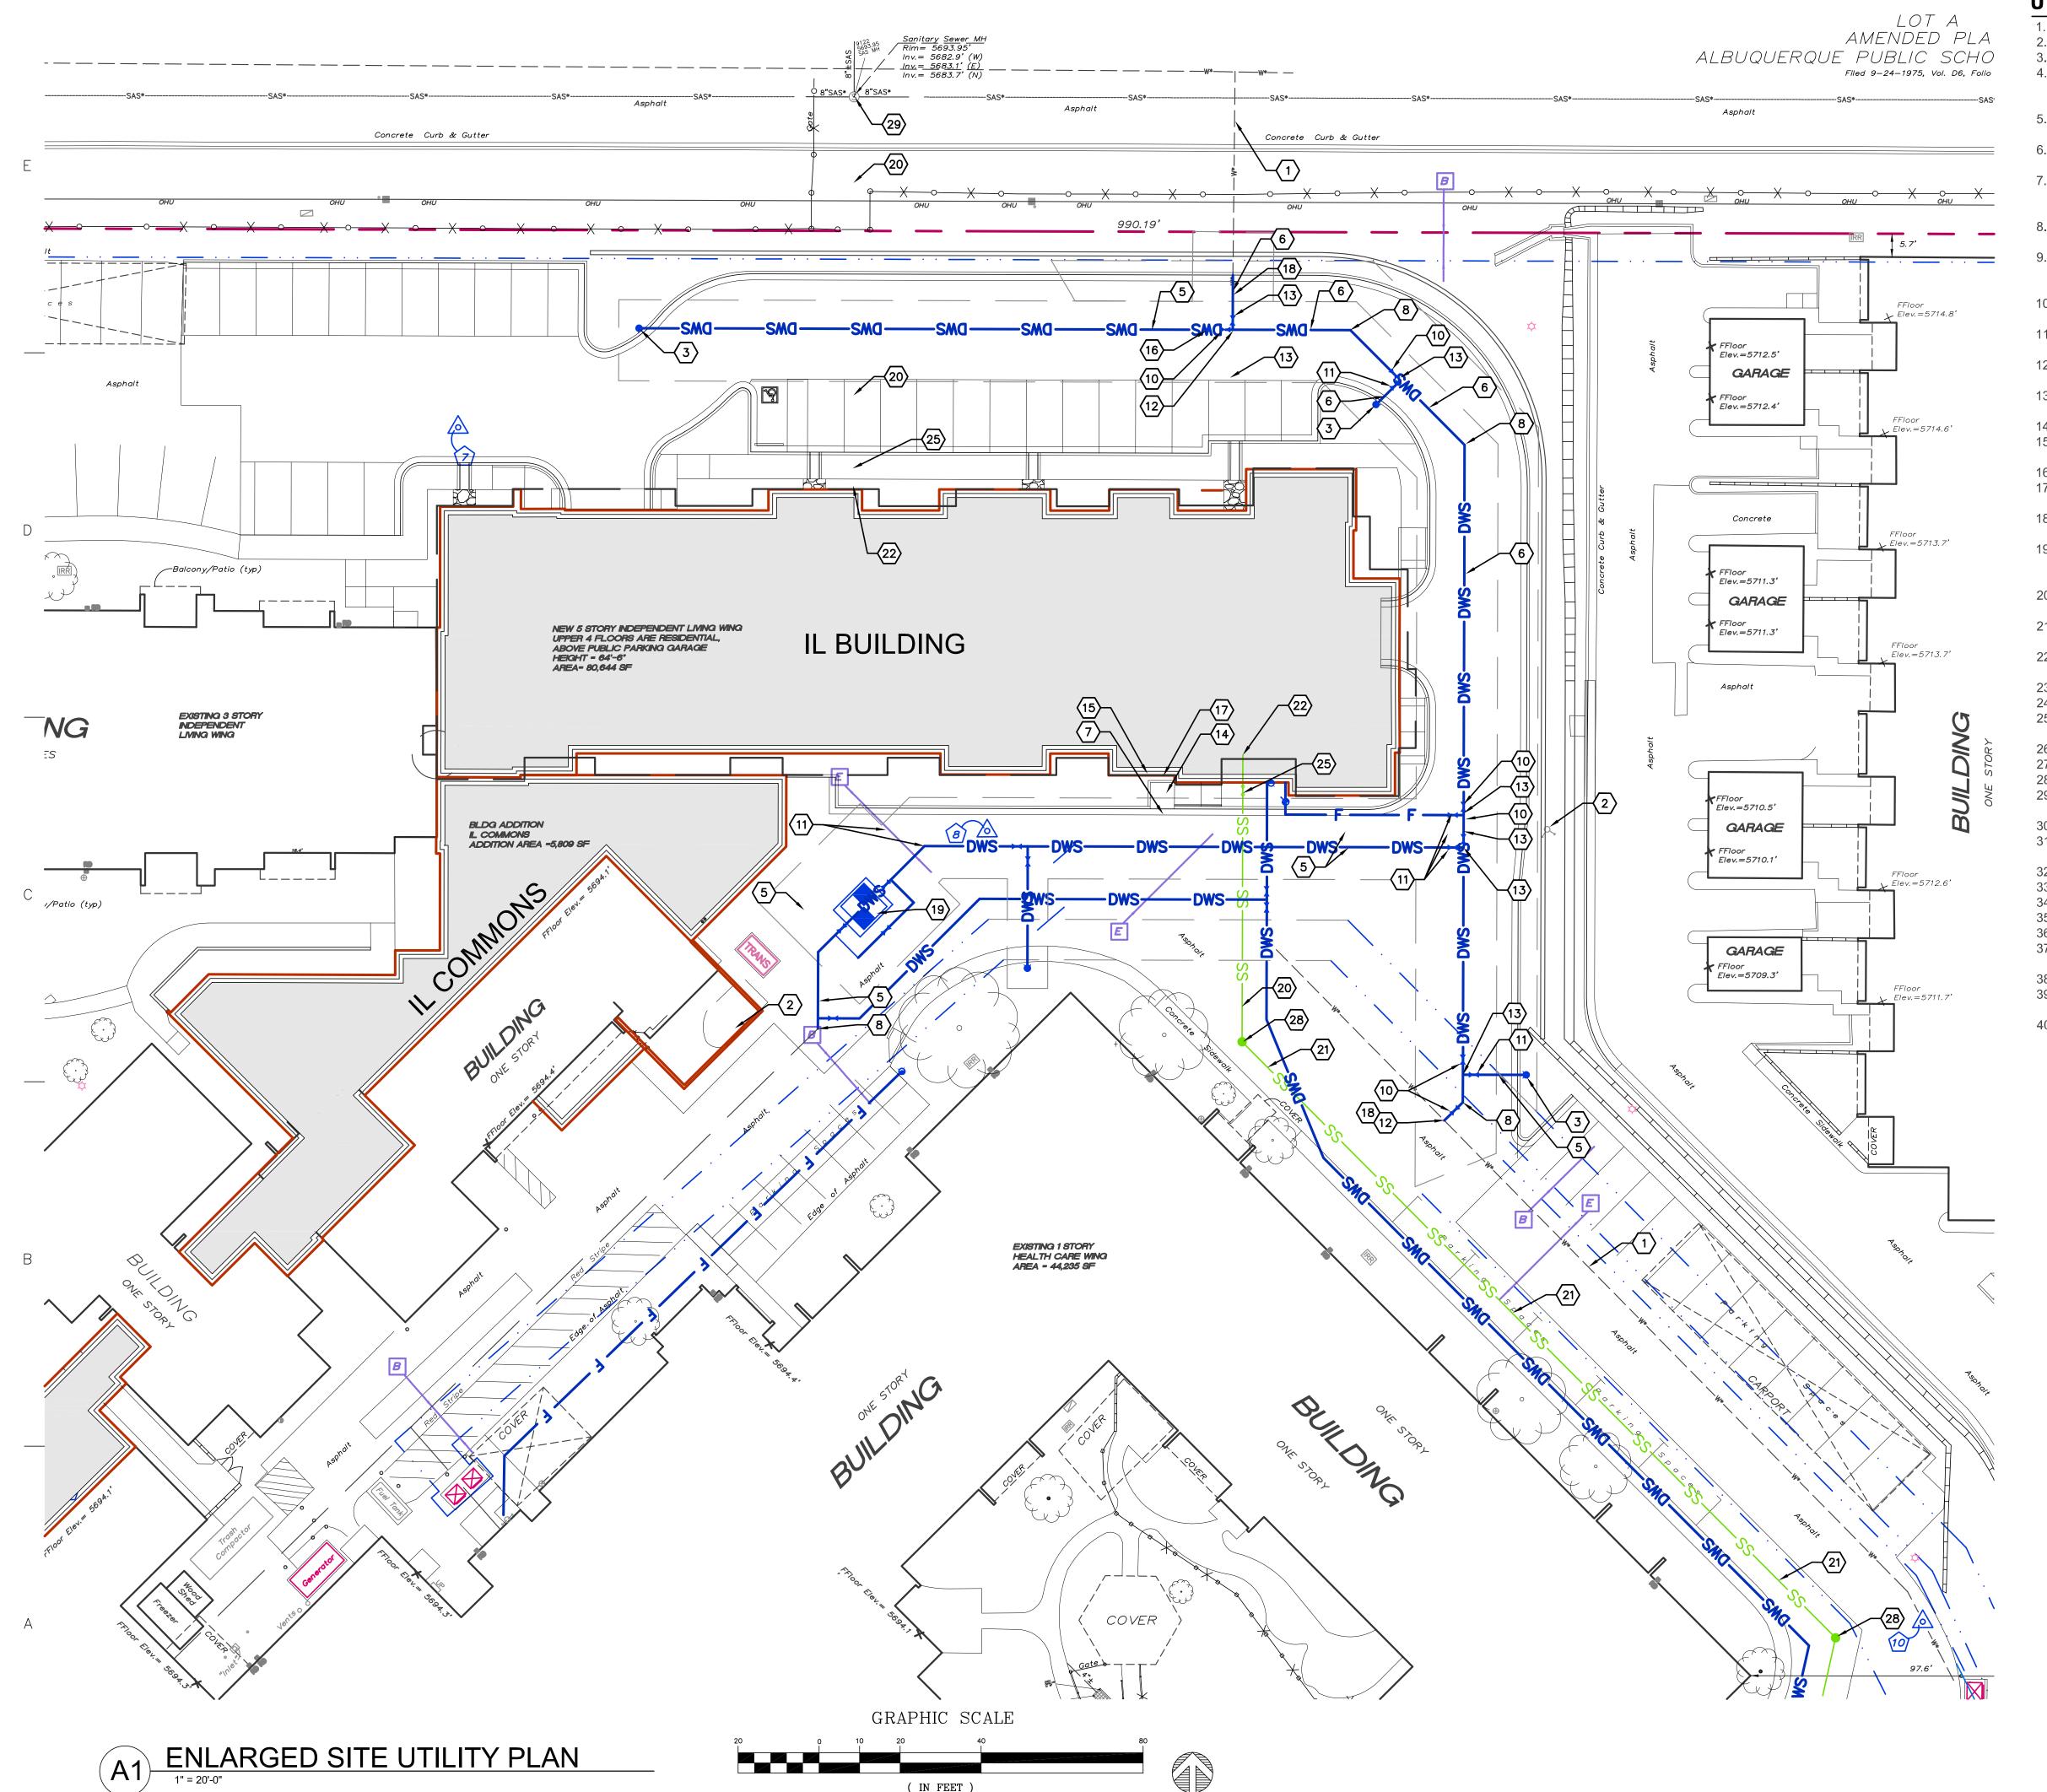
SHEET TITLE:

Project number

Cad file name

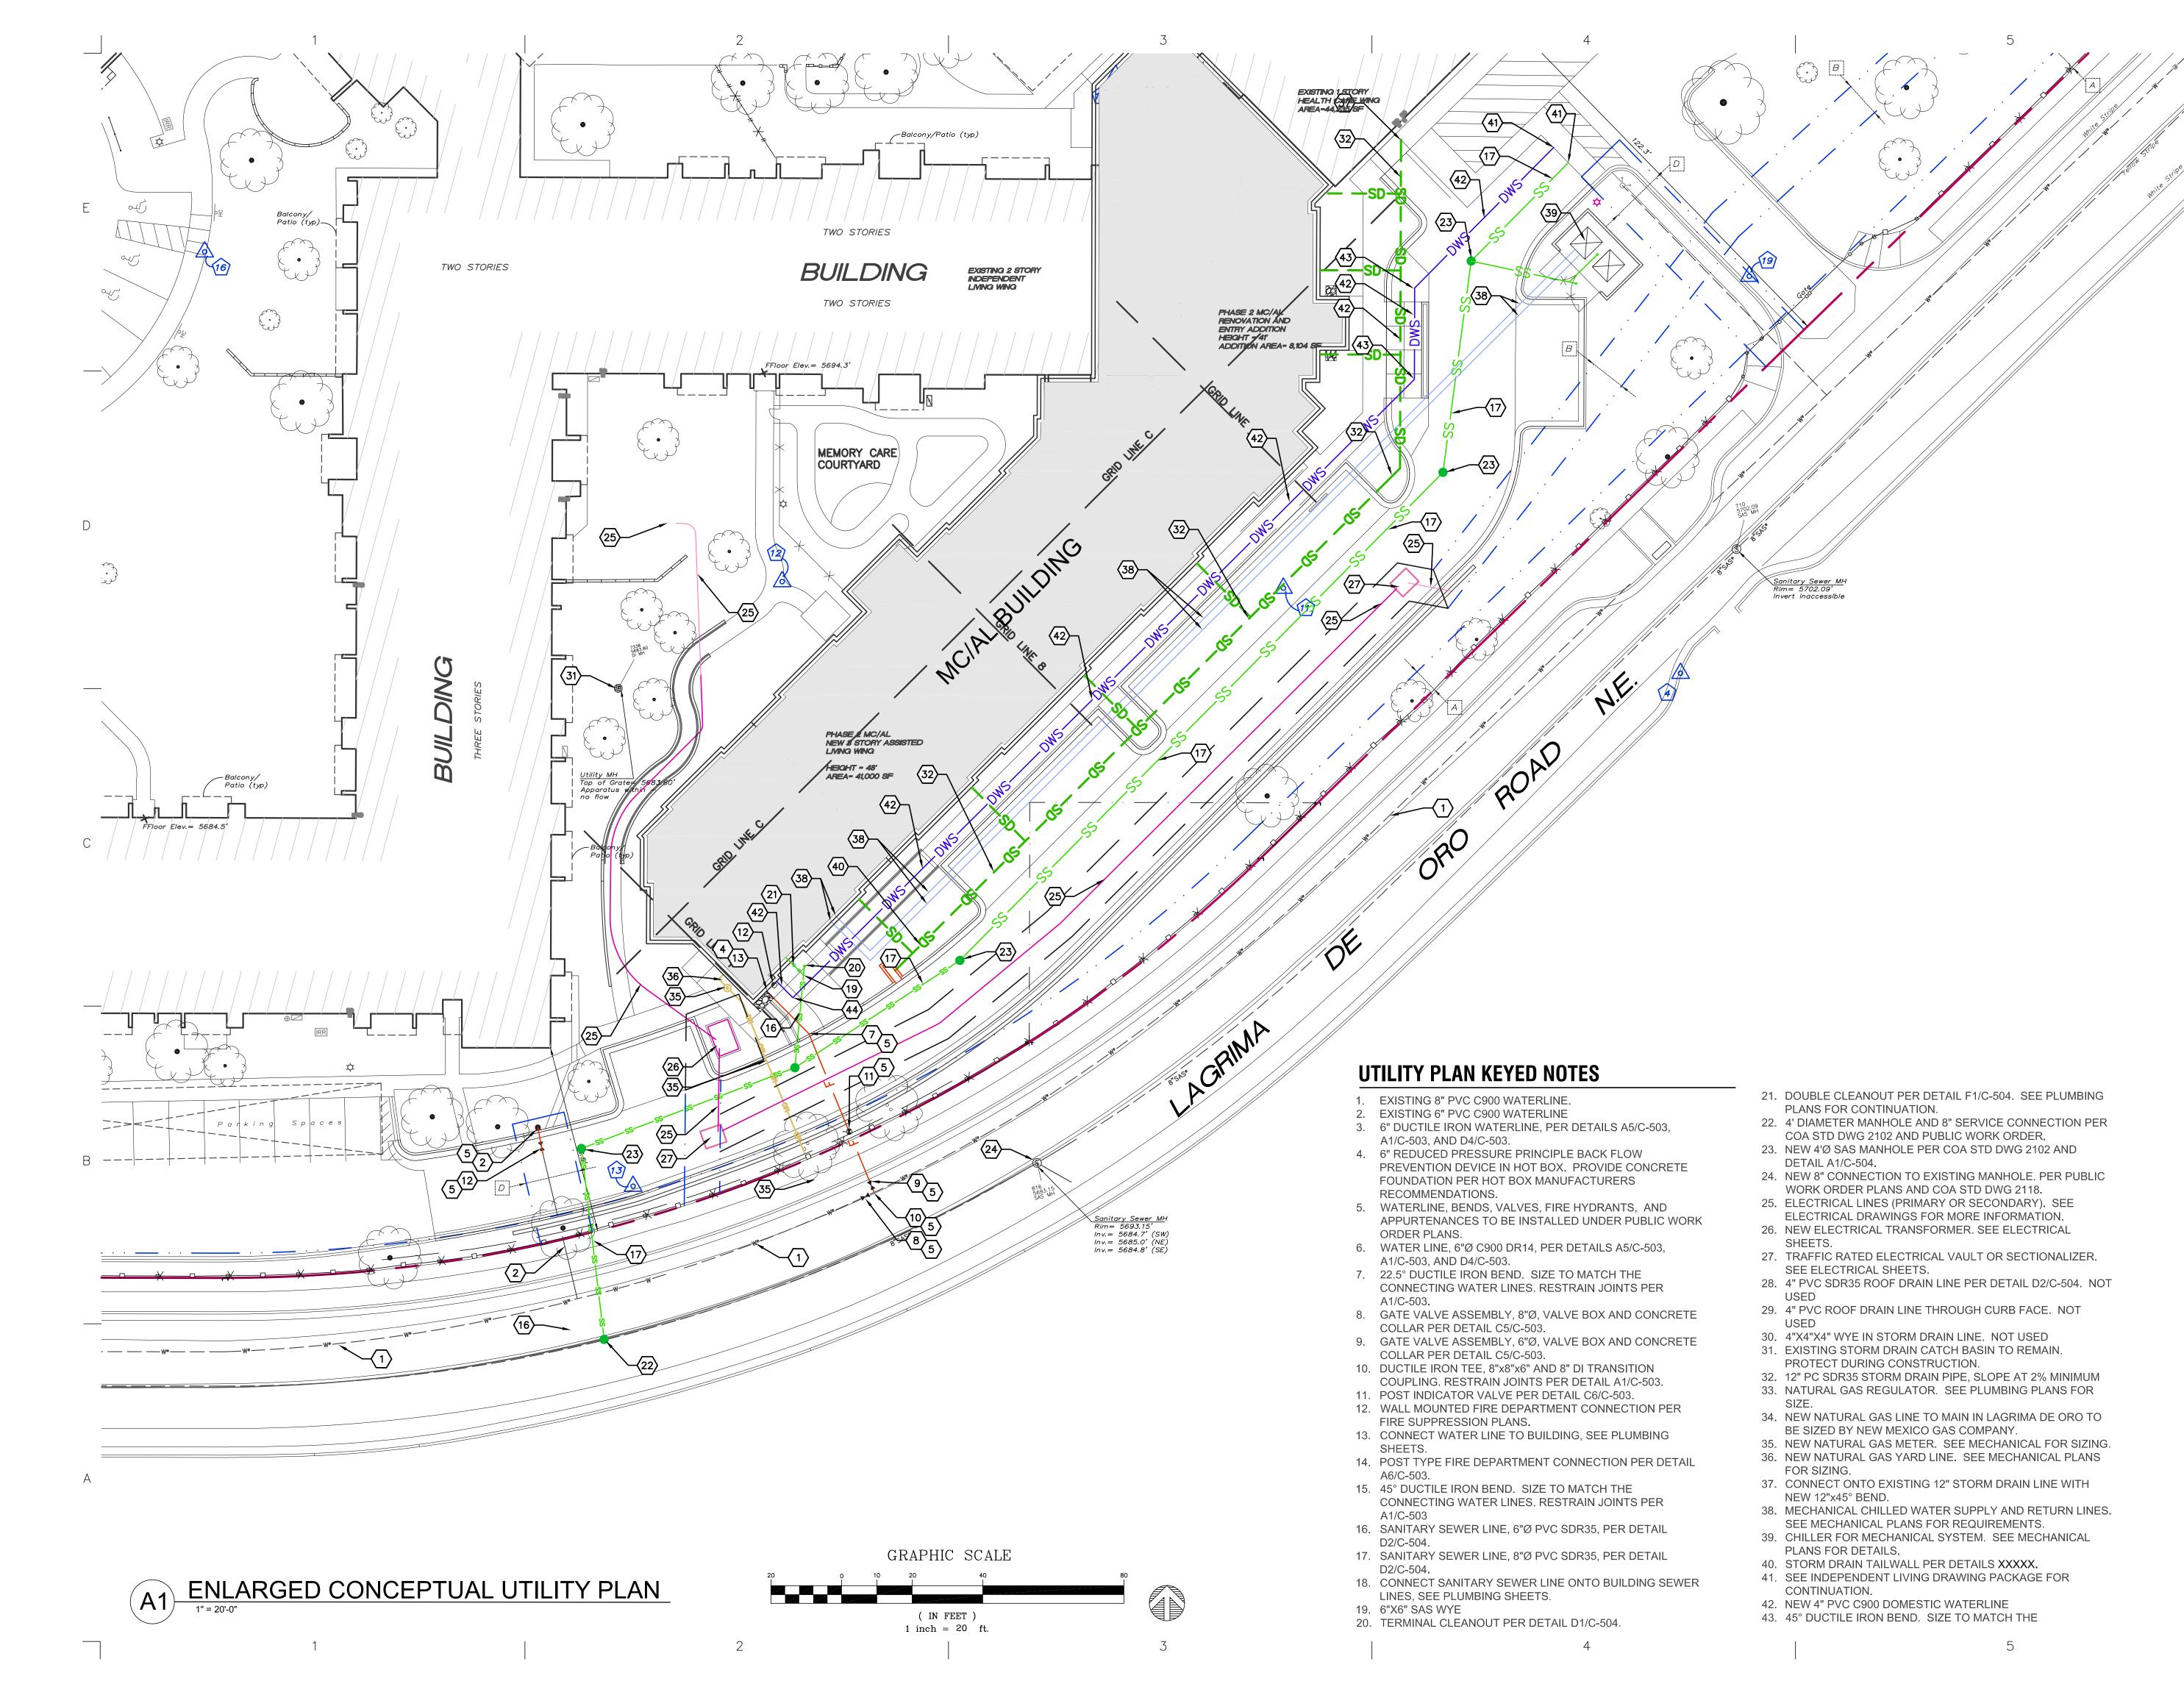ENLARGED CONCEPTUAL UTILITY PLAN

SHEET NUMBER:



1 inch = 20 ft.

UTILITY PLAN KEYED NOTES

- EXISTING 8" PVC C900 WATERLINE.
- 2. EXISTING FIRE HYDRANT
- 3. FIRE HYDRANT PER DETAIL A4/C-503. 4. WATERLINE, BENDS, VALVES, FIRE HYDRANTS, AND APPURTENANCES TO BE INSTALLED UNDER MINI WORK ORDER PLANS.
- 5. WATER LINE, 6"Ø C900 DR14, PER DETAILS A5/C-503,
- A1/C-503, AND D4/C-503.
- WATER LINE, 8"Ø C900 DR14, PER DETAILS A5/C-503, A1/C-503, AND D4/C-503.
- 7. 90° DUCTILE IRON ELBOW, SIZE TO MATCH THE CONNECTING WATER LINES. RESTRAIN JOINTS PER DETAIL A1/C-503.
- 45° DUCTILE IRON BEND, SIZE TO MATCH THE CONNECTING WATER LINES. RESTRAIN JOINTS PER DETAIL A1/C-503.
- 22.5° DUCTILE IRON BEND. SIZE TO MATCH THE CONNECTING WATER LINES. RESTRAIN JOINTS PER A1/C-503.
- 10. GATE VALVE ASSEMBLY, 8"Ø, VALVE BOX AND CONCRETE COLLAR PER DETAIL C5/C-503.
- 11. GATE VALVE ASSEMBLY, 6"Ø, VALVE BOX AND CONCRETE
- COLLAR PER DETAIL C5/C-503. 12. DUCTILE IRON TEE, 8"x8"x8". RESTRAIN JOINTS PER DETAIL
- A1/C-503.
- 13. DUCTILE IRON TEE, 8"x8"x6". RESTRAIN JOINTS PER DETAIL A1/C-503.
- 14. POST INDICATOR VALVE PER DETAIL C6/C-503.
- 15. WALL MOUNTED FIRE DEPARTMENT CONNECTION PER
- DETAIL A6/C-503. 16. 8"X6" DUCTILE IRON REDUCER
- 17. CONNECT WATER LINE TO BUILDING, SEE PLUMBING SHEETS.
- 18. CONNECT TO EXISTING WATERLINE, PROVIDE DUCTILE IRON TRANSITION COUPLING AS REQUIRED.
- 19. 6" DOMESTIC WATER METER AND TRAFFIC RATED VAULT PER ABCWUA STANDARD DRAWINGS 2371. INCLUDING BYPASS LINES, AND ASSOCIATED VALVES.
- 20. SANITARY SEWER LINE, 6"Ø PVC SDR35, PER DETAIL D2/C-504.
- 21. SANITARY SEWER LINE, 8"Ø PVC SDR35, PER DETAIL
- D2/C-504. 22. CONNECT SANITARY SEWER LINE ONTO BUILDING SEWER LINES, SEE PLUMBING SHEETS.
- 23. CONNECT TO 8" LINE STUBBED OUT IN PHASE 2.
- 24. TERMINAL CLEANOUT PER DETAIL D1/C-504.
- 25. DOUBLE CLEANOUT PER DETAIL F1/C-504. SEE PLUMBING
- PLANS FOR CONTINUATION. 26. 8"X8"X6" WYE IN SAS LINE.
- 27. 6"X6"X6" WYE IN SAS LINE.
- 28. 4' Ø SANITARY SEWER MANHOLE PER DETAIL A1/C-504. 29. CONNECT NEW SAS LINE TO EXISTING MANHOLE.
- RESHAPE BASE AND SHELVES AS REQUIRED.
- 31. ELECTRICAL LINES (PRIMARY OR SECONDARY). SEE
- ELECTRICAL DRAWINGS FOR MORE INFORMATION. 32. ELECTRICAL TRANSFORMER. SEE ELECTRICAL SHEETS
- 34. 4" PVC SDR35 ROOF DRAIN LINE PER DETAIL D2/C-504.
- 35. 4" PVC ROOF DRAIN LINE THROUGH CURB FACE.
- 36. 4"X4"X4" WYE IN STORM DRAIN LINE.
- 37. EXISTING STORM DRAIN CATCH BASIN TO REMAIN. PROTECT DURING CONSTRUCTION.
- 39. CONNECT TO ROOF DRAIN LINE, SEE PLUMBING FOR CONTINUATION.
- 40. CONNECT TO ROOF DRAIN LEADER WITH RUBBER TRANSITION BOOT.

DESIGN GROUP Architects • Engineers • Interior Design Planners • Urban Designers • LEED®

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CONSULTANT

STAMP

PROJECT NAME

MASTERPLAN BUILDOUT -INDEPENDENT LIVING

10501 LAGRIMA DE ORO RD NE ALBUQUERQUE, NEW MEXICO 87111

DESCRIPTION

HAVERLAND CARTER LIFESTYLE GROUP


Cop	ywright: D	esign Group	
Drav	wn by		
Che	cked by		
Date	2		AUGUST 2, 201
Proj	ect number		281
Cad	file name		

SHEET TITLE:

No. DATE

ENLARGED CONCEPTUAL UTILITY PLAN

SHEET NUMBER:

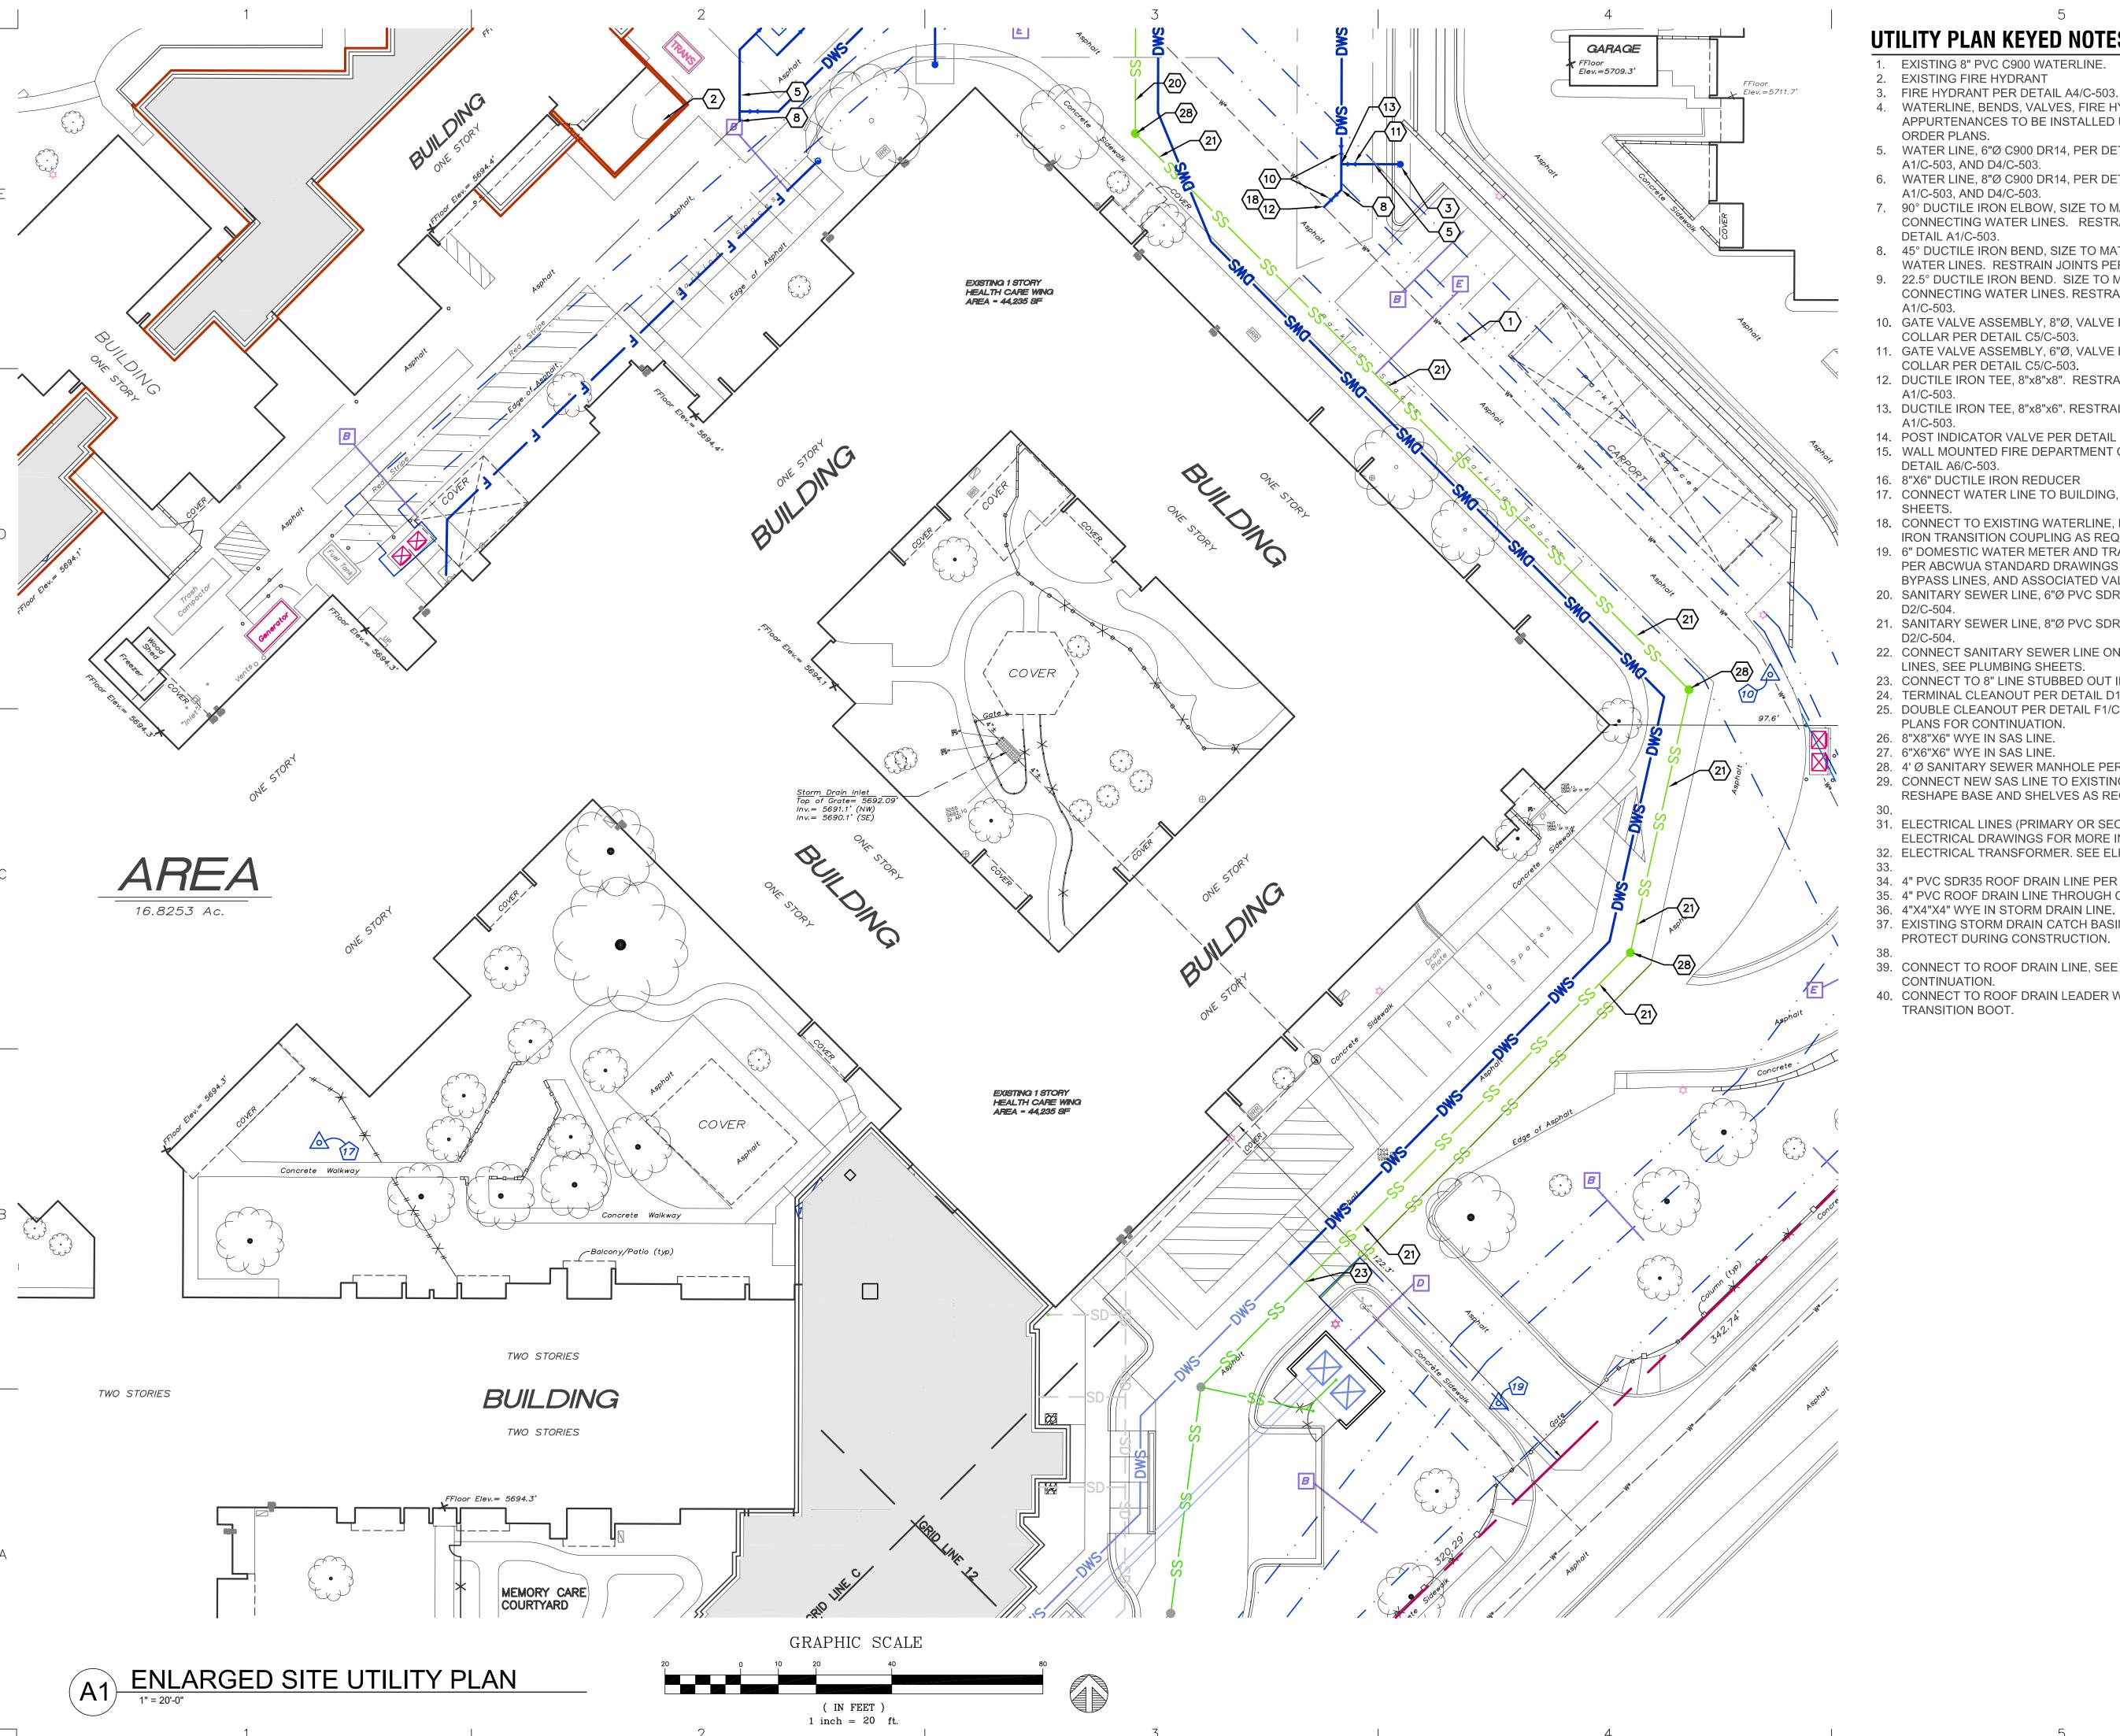

UTILITY PLAN KEYED NOTES

- 1. EXISTING 8" PVC C900 WATERLINE.
- 2. EXISTING FIRE HYDRANT
- 4. WATERLINE, BENDS, VALVES, FIRE HYDRANTS, AND APPURTENANCES TO BE INSTALLED UNDER MINI WORK ORDER PLANS.
- 5. WATER LINE, 6"Ø C900 DR14, PER DETAILS A5/C-503, A1/C-503, AND D4/C-503.
- 6. WATER LINE, 8"Ø C900 DR14, PER DETAILS A5/C-503, A1/C-503, AND D4/C-503.
- 7. 90° DUCTILE IRON ELBOW, SIZE TO MATCH THE CONNECTING WATER LINES. RESTRAIN JOINTS PER DETAIL A1/C-503.
- 8. 45° DUCTILE IRON BEND, SIZE TO MATCH THE CONNECTING WATER LINES. RESTRAIN JOINTS PER DETAIL A1/C-503.
- 9. 22.5° DUCTILE IRON BEND. SIZE TO MATCH THE CONNECTING WATER LINES. RESTRAIN JOINTS PER A1/C-503.
- 10. GATE VALVE ASSEMBLY, 8"Ø, VALVE BOX AND CONCRETE COLLAR PER DETAIL C5/C-503.
- 11. GATE VALVE ASSEMBLY, 6"Ø, VALVE BOX AND CONCRETE
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- 18. CONNECT TO EXISTING WATERLINE, PROVIDE DUCTILE
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- 22. CONNECT SANITARY SEWER LINE ONTO BUILDING SEWER LINES, SEE PLUMBING SHEETS.
- 23. CONNECT TO 8" LINE STUBBED OUT IN PHASE 2.
- 24. TERMINAL CLEANOUT PER DETAIL D1/C-504. 25. DOUBLE CLEANOUT PER DETAIL F1/C-504. SEE PLUMBING
- PLANS FOR CONTINUATION.
- 26. 8"X8"X6" WYE IN SAS LINE.
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- 29. CONNECT NEW SAS LINE TO EXISTING MANHOLE. RESHAPE BASE AND SHELVES AS REQUIRED.
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- PROTECT DURING CONSTRUCTION.
- 39. CONNECT TO ROOF DRAIN LINE, SEE PLUMBING FOR
- CONTINUATION. 40. CONNECT TO ROOF DRAIN LEADER WITH RUBBER
- TRANSITION BOOT.

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PROJECT NAME

MASTERPLAN BUILDOUT -INDEPENDENT LIVING

10501 LAGRIMA DE ORO RD NE ALBUQUERQUE, NEW MEXICO 87111

HAVERLAND CARTER LIFESTYLE GROUP

Сор	ywright: D	esign Group	
Dra	wn by		
Che	cked by		
Date	2		AUGUST 2, 2019

2811

DESCRIPTION

SHEET TITLE:


Project number

Cad file name

No. DATE


ENLARGED CONCEPTUAL UTILITY PLAN

SHEET NUMBER:

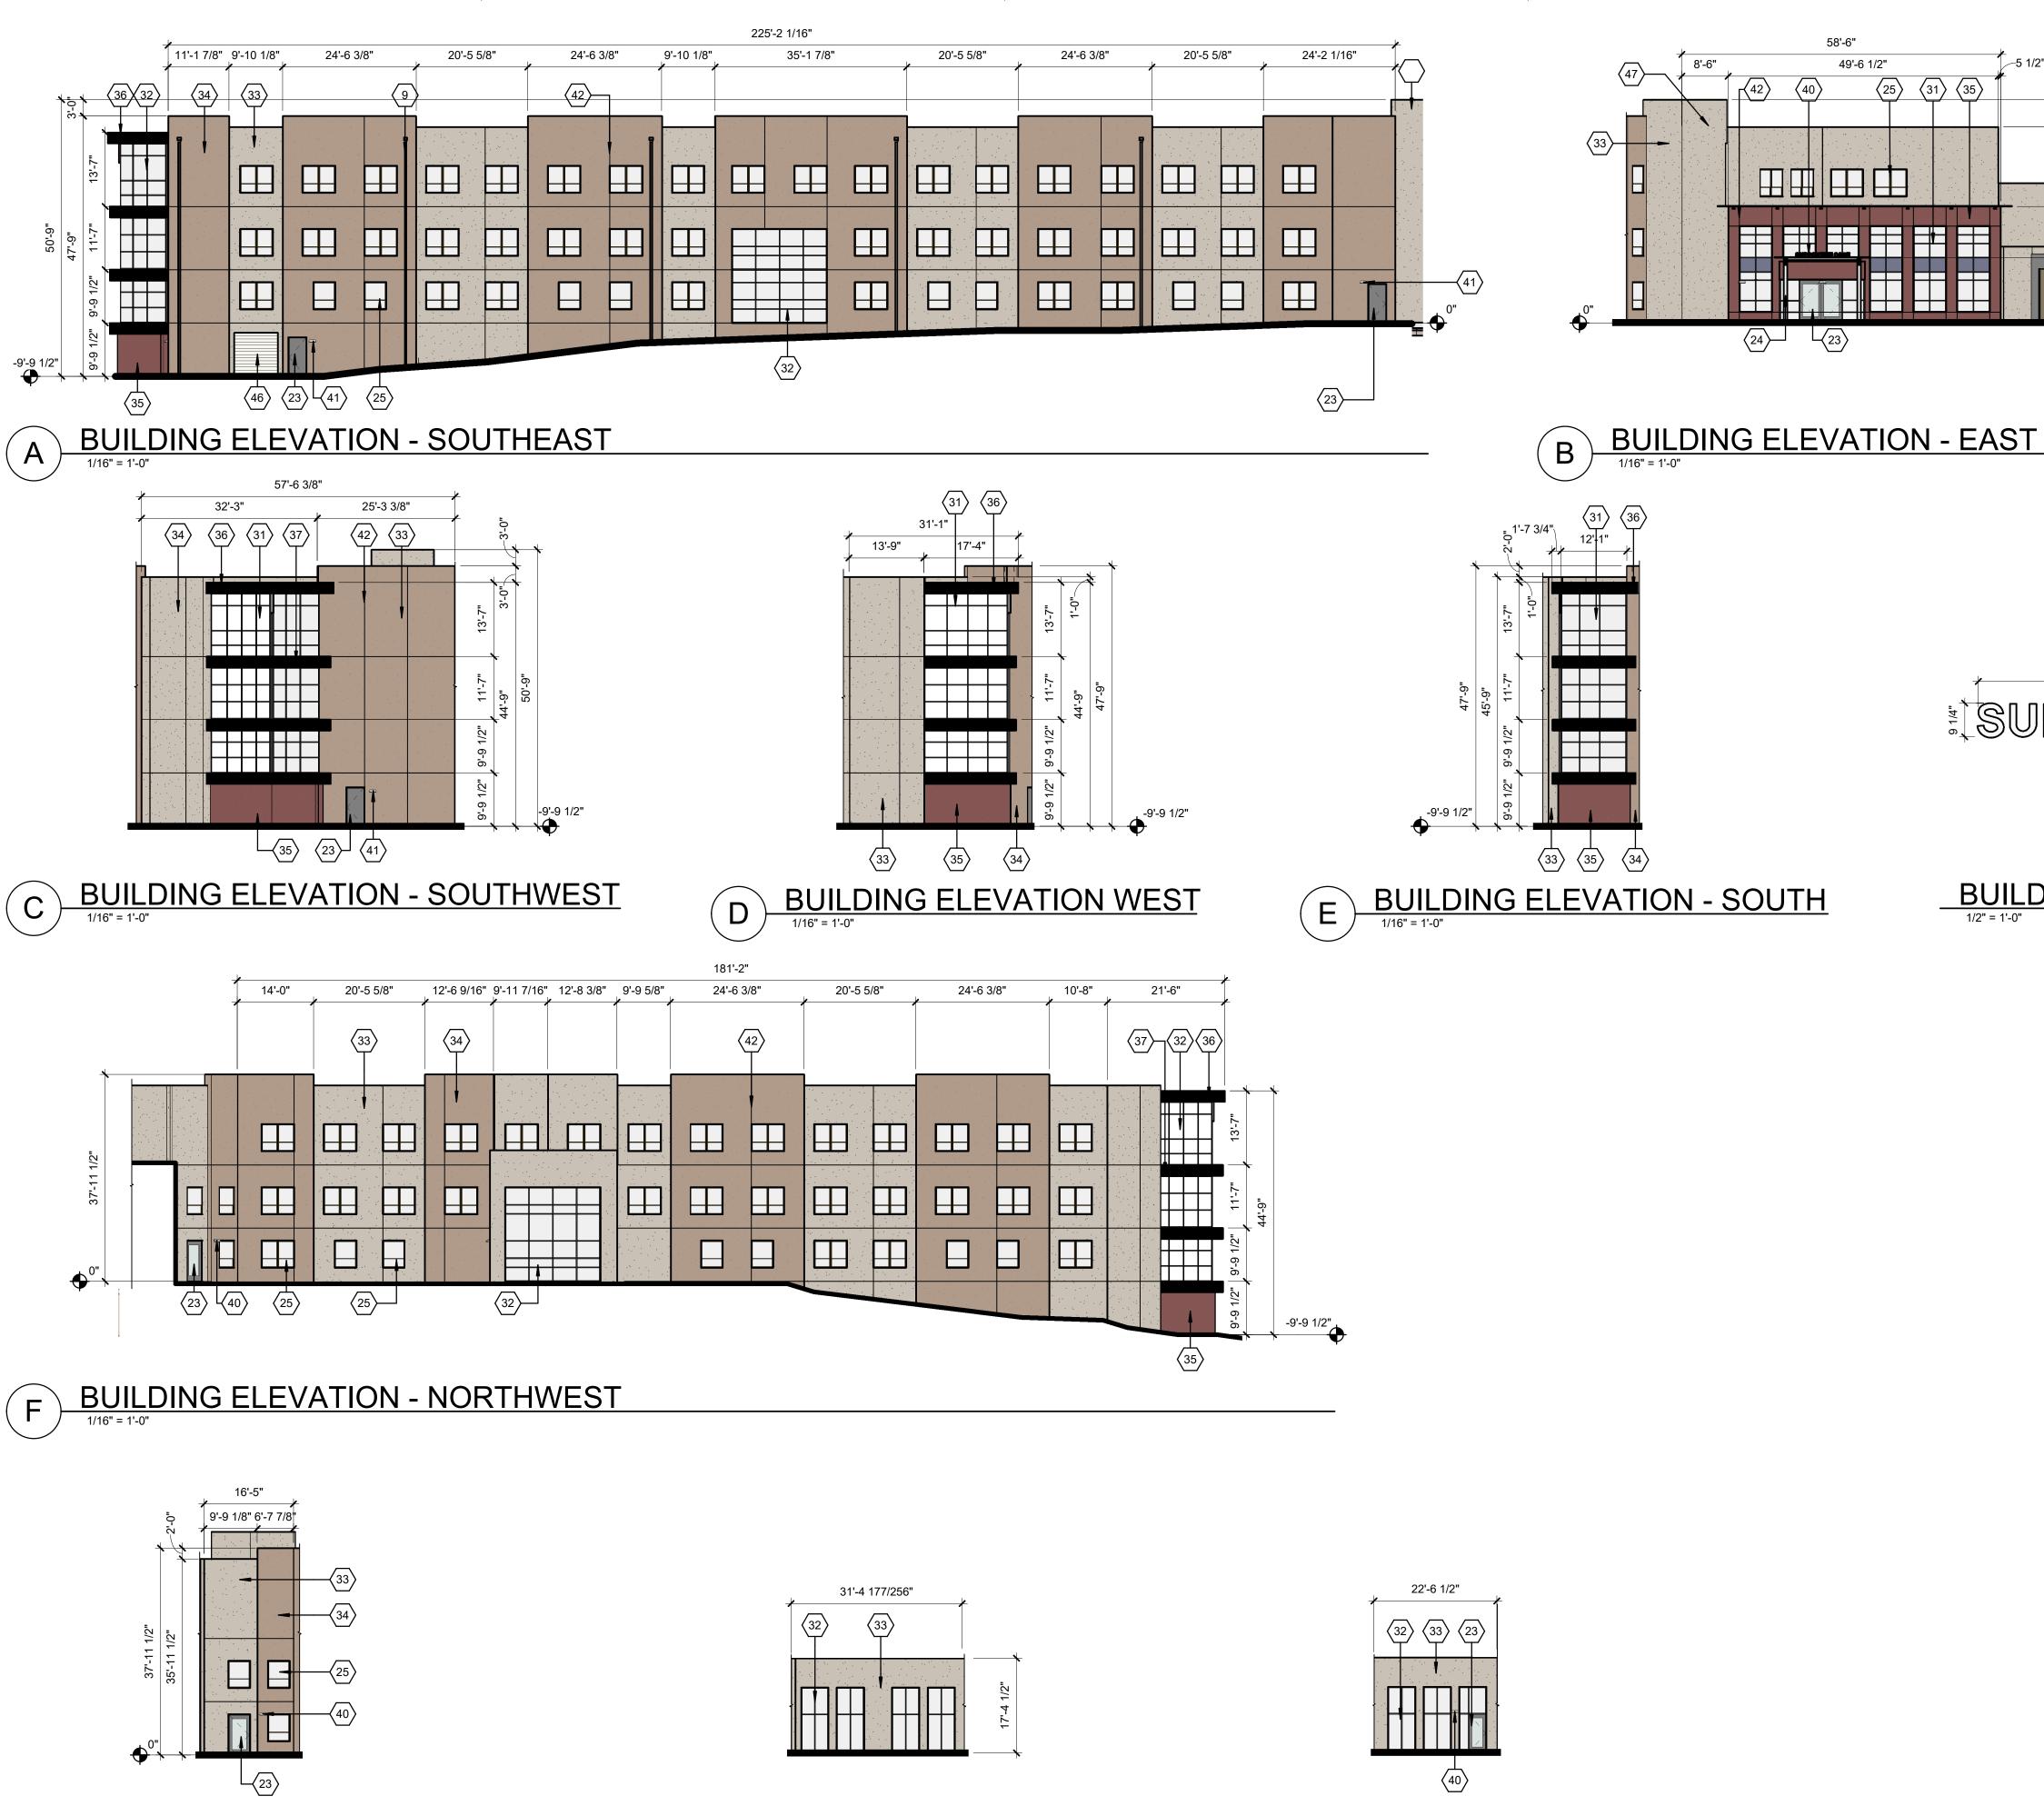

BUILDING ELEVATION - NORTHWEST

BUILDING ELEVATION - WEST

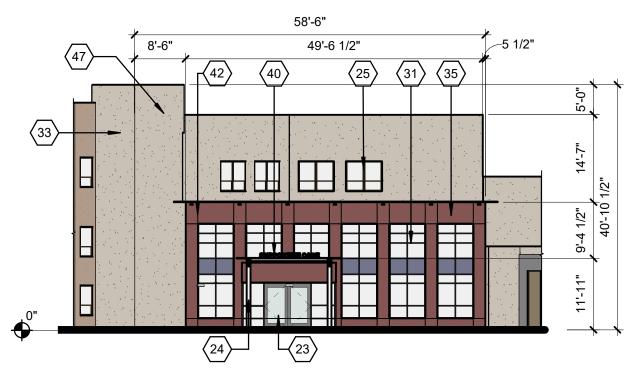

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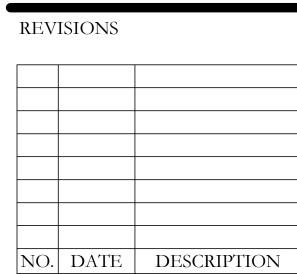
STAMP

DESIGN DEVELOPMENT

MASTERPLAN BUILDOUT PHASE 2 MEMORY CARE + ASSISTED LIVING

10501 LAGRIMA DE ORO RD NE ALBUQUERQUE, NEW MEXICO 87111

HAVERLAND CARTER LIFESTYLE GROUP



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Drawn by	STAFF
Checked by	MW
Date	APRIL 12, 2019
Project number	2811

SHEET TITLE MEMORY CARE + ASSISTED LIVING

BUILDING ELEVATIONS -

SHEET NUMBER

A-203

(SIGNAGE MATERIAL) OVERHEAD GARAGE DOOR **ELEVATOR TOWER KEY PLAN**

SUPPORTIVE CARE

① SHEET KEYNOTES

DOWNSPOUT DOOR CANOPY

VINYL WINDOW

STOREFRONT

CURTAIN WALL SYSTEM

STUCCO COLOR: RED

BUILDING SIGNAGE

LIGHT FIXTURE


STUCCO COLOR: LIGHT BROWN STUCCO COLOR: DARK BROWN

STUCCO COLOR: DARK GREY STUCCO COLOR: LIGHT GREY

BUILDING SIGNAGE


STUCCO CONTROL JOINT

BUILDING ELEVATION - WEST

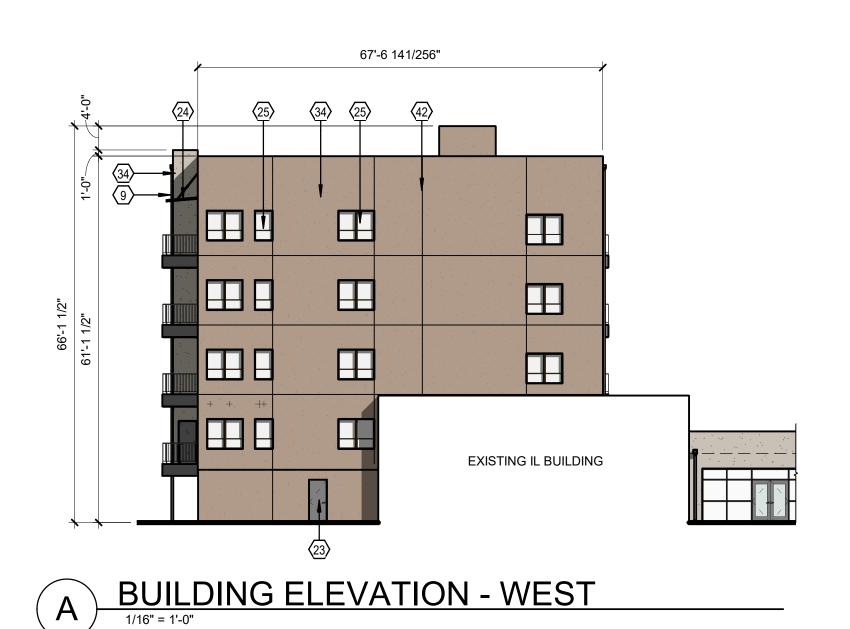




BUILDING ELEVATION

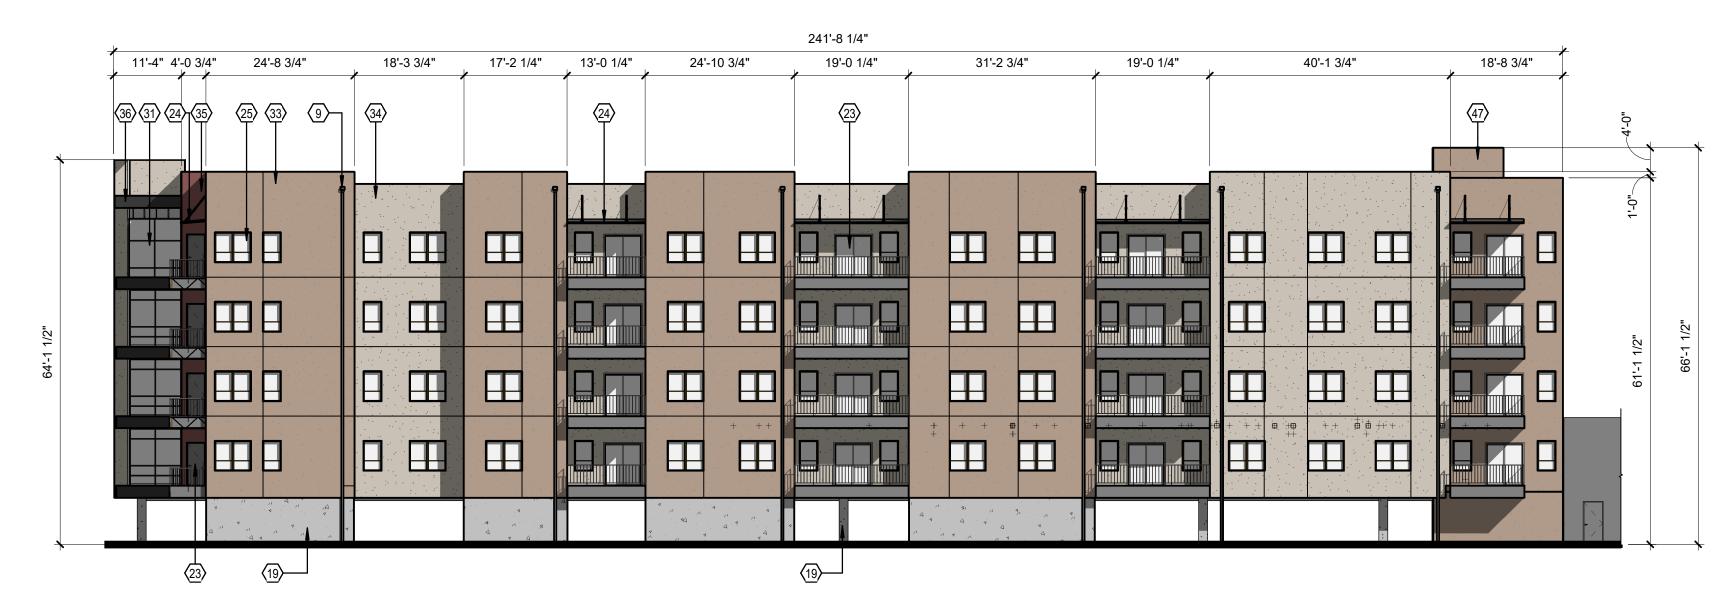

BUILDING ELEVATION - NORTH

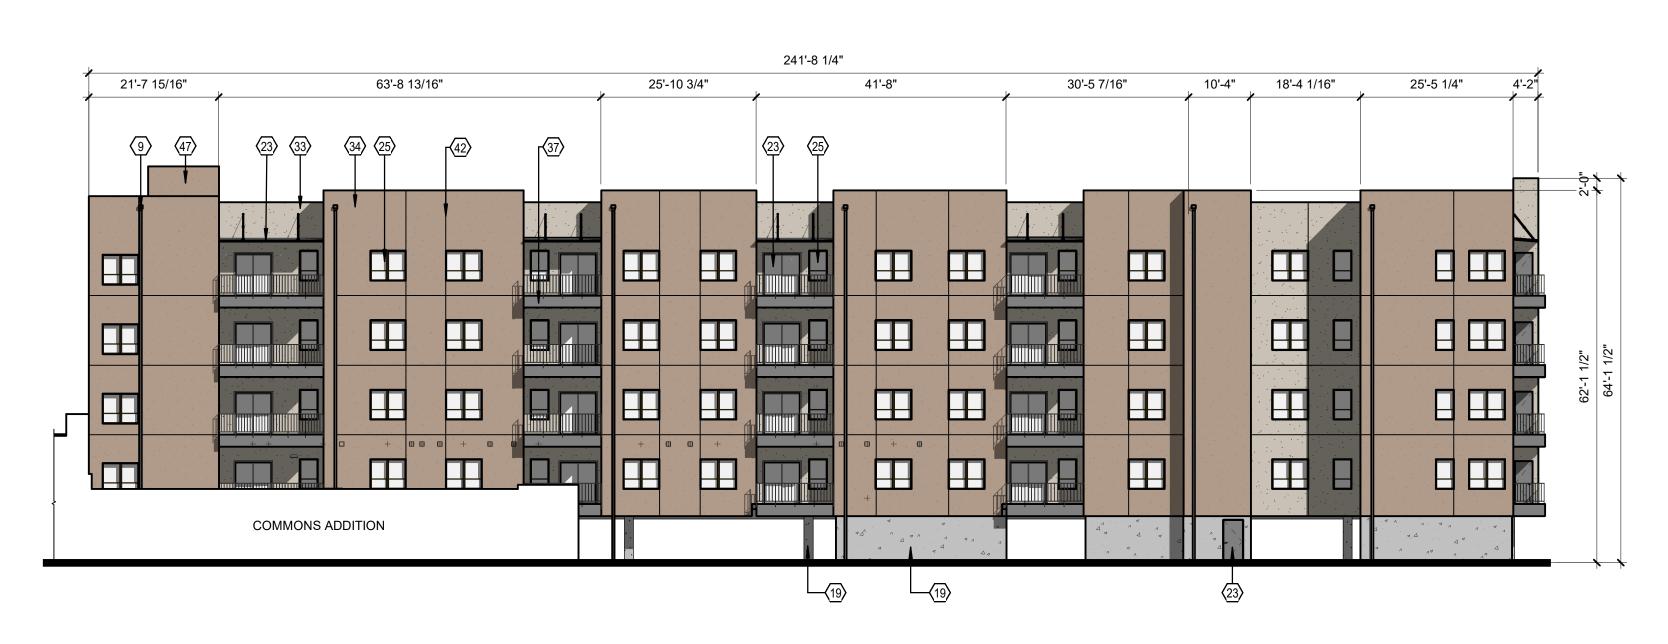

BUILDING ELEVATION - SOUTH
1/16" = 1'-0"




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DESIGN DEVELOPMENT

MASTERPLAN BUILDOUT PHASE 3 - IL ADDITION AND COMMONS

10501 LAGRIMA DE ORO RD NE, ALBUQUERQUE, NM 87111

> HAVERLAND CARTER LIFESTYLE GROUP

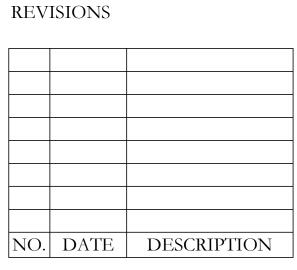

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Date	APRIL 12, 2019
Project number	2811

SHEET TITLE INDEPENDENT LIVING

BUILDING ELEVATIONS -EPC SUBMITTAL

SHEET NUMBER

A-204

① SHEET KEYNOTES DOWNSPOUT CAST IN PLACE CONCRETE DOOR CANOPY VINYL WINDOW CURTAIN WALL SYSTEM STOREFRONT STUCCO COLOR: LIGHT BROWN STUCCO COLOR: DARK BROWN STUCCO COLOR: RED STUCCO COLOR: DARK GREY STUCCO COLOR: LIGHT GREY STUCCO CONTROL JOINT **ELEVATOR TOWER**

KEY PLAN






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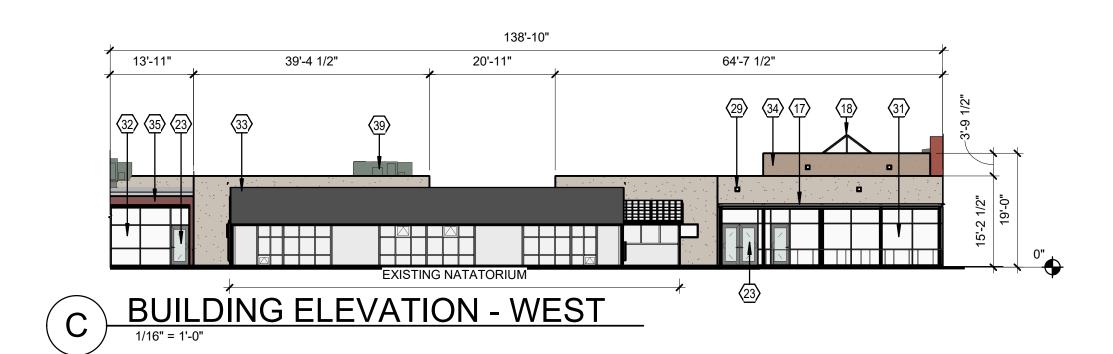



PARTIAL BUILDING ELEVATION - NORTH

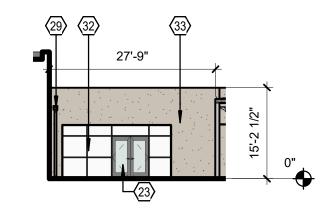

2

PARTIAL BUILDING ELEVATION - NORTH



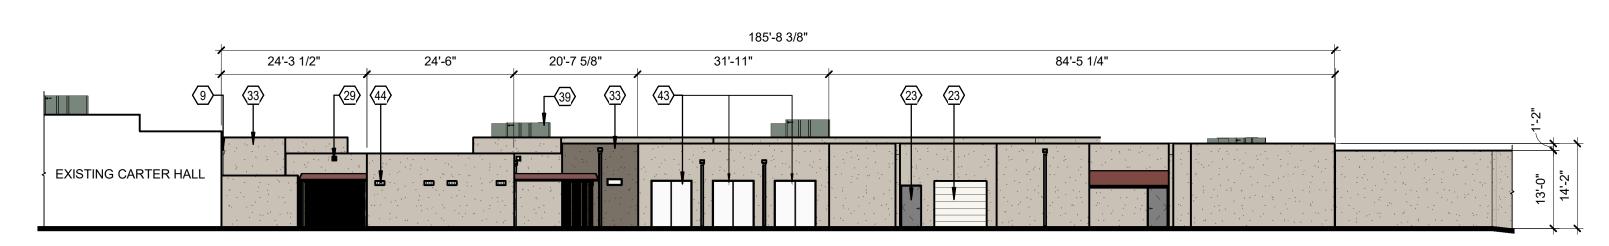

BUILDING ELEVATION - SOUTH

DESIGN DEVELOPMENT

MASTERPLAN BUILDOUT PHASE 3 - IL ADDITION AND COMMONS

10501 LAGRIMA DE ORO RD NE, ALBUQUERQUE, NM 87111

HAVERLAND CARTER LIFESTYLE GROUP

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NO.	DATE	DESCRIPTION					

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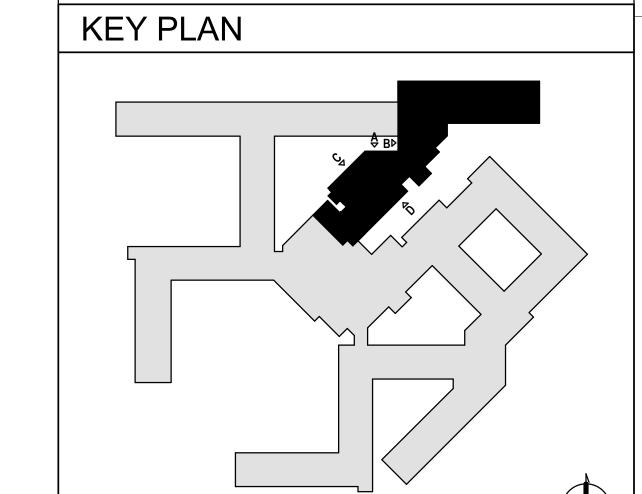
Drawn by	STAFF
Checked by	MW
Date	APRIL 12, 2019
Project number	2811

SHEET TITLE INDEPENDENT LIVING COMMONS

BUILDING ELEVATIONS -EPC SUBMITTAL

SHEET NUMBER

A-205



① SHEET KEYNOTES

STANDING SEAM METAL ROOF

STUCCO COLOR: LIGHT BROWN

STUCCO COLOR: DARK BROWN

CURTAIN WALL SYSTEM

STUCCO COLOR: RED METAL DECK ROOF **ROOFTOP UNIT**

EXISTING STOREFRONT

DOWNSPOUT

SKYLIGHT DOOR SCUPPER

STOREFRONT

Existing window

18

29

Date Submitted:	Date Site Plan Approved:	Date Preliminary Plat Approved:	Date Preliminary Plat Expires:	DRB Project No.:	DRB Application No.:		
FIGURE 12		<u>INFRASTRUCTURE LIST</u>	(Rev. 2-16-18)	EXHIBIT "A"	TO SUBDIVISION IMPROVEMENTS AGREEMENT	DEVELOPMENT REVIEW BOARD (D.R.B.) REQUIRED INFRASTRUCTURE LIST	
Current DRC	Project Number:						

La Vida Llena

Amended Plat Land in Secntion 33, T11N, R4E, La Vida Llena containing 16.89 ac. PROPOSED NAME OF PLAT AND/OR SITE DEVELOPMENT PLAN

EXISTING LEGAL DESCRIPTION PRIOR TO PLATTING ACTION

items in the listing and related financial guarantee. Likewise, if the DRC Chair determines that appurtenant or non-essential items can be deleted from the listing, those items may be deleted as well as the related portions of the financial guarantees. All such revisions require approval by the DRC Chair, the User Department and agent/owner. If such approvals are obtained, these revisions to the listing will be incorporated administratively. In addition, any unforeseen items which arise during construction which are necessary to complete the project and which normally are the Subdivider's responsibility will be required as a condition of project acceptance and close out by the City. Following is a summary of PUBLIC/PRIVATE Infrastructure required to be constructed or financially guaranteed for the above development. This Listing is not necessarily a complete listing. During the SIA process and/or unforeseen items have not been included in the infrastructure listing, the DRC Chair may include those

Construction Certification	City Cnst		-					_		,
struction Cert	Private or P.E.			-	_	_	_	_	_	
Cons	Priv	_		_		_				_
1	0	South Propoerty Line				Existing 8" WL	Water Meter	Fire Hydrant		
ı	From	Ex. SAS Line	Exisitng SAS Line			Existing 8" WL in La Vida Llena	East Service Drive	New 8" Public Waterline		
-	Location	Lagrima De Oro	Lagrima De Oro		Service Yard	East Service Drive	Service Yard	North Service Drive		
Transfer of landstones	Type of improvement	Sanitary Sewer Service Line	Sanitary Sewer Manhole		Water Meter	Public Waterline	Public Waterline	Public Waterline		
Cizo	2176	<u>.</u>	. 4		9	 8	-9	9		
Constructed	Under	DRC#								
Financially	Guaranteed	DRC#								

P

PAGE

Date City Cnst Engineer Construction Certification The items listed below are on the CCIP and approved for Impact Fee credits. Signatures from the Impact Fee Administrator and the City User Department is required prior to DRB approval of this listing. The Items listed below are subject to the standard SIA requirements. Approval of Creditable Items: City User Dept. Signature P.E Private Inspector AGENT /OWNER PARKS & RECREATION - date CODE ENFORCEMENT - date Date - date If the site is located in a floodplain, then the financial guarantee will not be released until the LOMR is approved by FEMA. AMAFCA - date Z₀ Impact Fee Admistrator Signature DEVELOPMENT REVIEW BOARD MEMBER APPROVALS Approval of Creditable Items: From USER DEPARTMENT **DESIGN REVIEW COMMITTEE REVISIONS** Street lights per City rquirements. TRANSPORTATION DEVELOPMENT - date Location UTILITY DEVELOPMENT - date CITY ENGINEER - date DRB CHAIR - date Type of Improvement DRC CHAIR Size DATE The Design Group David A Aube SIGNATURE - date AGENT / OWNER Constructed DRC# REVISION Under Financially Guaranteed DRC# 2

12