

ORIENTATION. REFER TO PHOTOMETRIC DRAWINGS FOR HEAD PLACEMENT.

•1/2" @ ALL EXIT DOORS

•1 1/2" @ OVERHEAD DOORS

•1/2" @ ALL SHOWROOM GLAZING LOCATIONS

• 1 1/2" @PRE-FAB METAL WALL PANELS

4. GC TO COORDINATE SITE SECURITY LAYOUT AND CONDUIT SIZE & LOCATION WITH THE OWNER.

5. GC TO ENSURE PAVING AT ALL EXITS SHALL NOT EXCEED A 2% MAX SLOPE IN ALL

6. PAVING SHALL BE LOWER THAN THE BUILDING SLAB BY THE FOLLOWING AMOUNTS UNO:

- PROVIDED HEREON, SHALL BE CONSTRUCTED IN ACCORDANCE WITH CITY OF ALBUQUERQUE INTERIM STANDARD SPECIFICATIONS FOR PUBLIC WORKS CONSTRUCTION, 1985.
- 3. TWO WORKING DAYS PRIOR TO ANY EXCAVATION, CONTRACTOR MUST CONTACT LINE LOCATING SERVICE, 260-1990 (OR DIAL 811 LOCALLY), FOR LOCATION OF EXISTING UTILITIES.
- 4. PRIOR TO CONSTRUCTION, THE CONTRACTOR SHALL EXCAVATE AND VERIFY THE HORIZONTAL AND VERTICAL LOCATIONS OF ALL CONSTRUCTIONS. SHOULD A CONFLICT EXIST, THE CONTRACTOR SHALL NOTIFY THE ENGINEER SO THAT THE CONFLICT CAN BE RESOLVED WITH A MINIMUM AMOUNT OF DELAY.



CURB & GUTTER ----- BOUNDARY LINE

--- --- EASEMENT

— BUILDING

PROPOSED SIDEWALK

— EXISTING CURB & GUTTER ---- EXISTING BOUNDARY LINE

LIGHT

PARKING COUNT

KEYED NOTES

- 1) ACCESSIBLE PARKING W/SIGN PER ADA STANDARDS (1.0% MIN - 2.0% MAX SLOPE), SEE DETAIL SHEET DET-1
- 2) UNIDIRECTIONAL ACCESSIBLE RAMP PER COA DWG 2443, SEE DETAIL SHEET DET-2
- (3) STANDARD CURB AND GUTTER (TYP) PER COA STD DWG 2415A, SEE DETAIL SHEET DET-1
- (4) PARKING LOT LIGHT STANDARD (TYP) FULL CUTOFF LED'S, 25' HIGH, SEE DETAIL SHEET DET-2
- (5) 6' VALLEY GUTTER PER COA STD DWG 2415B, SEE DETAIL SHEET DET-1
- (6) MOTORCYCLE SPACE (4'X8' MIN) W/SIGN
- (7) RETENTION POND
- (8) NEW ASPHALT PAVING, SEE DETAIL SHEET DET-1
- (9) BICYCLE RACK, SEE DETAIL SHEET DET-1
- (10) MONUMENT SIGN
- (11) 6' PEDESTRIAN CROSSING, SEE DETAIL SHEET DET-1
- (12) NEW 5' CONCRETE SIDEWALK PER COA STD DW 2430 SEE DETAIL SHEET DET-1 (13) ZERO-FLUSH CURB W/ 8" BOLLARDS SEE DETAIL SHEET DET-1
- (14) GREASE INTERCEPTOR
- 15) SANITARY SEWER FLOOR DRAIN PROVIDED AT COMPACTOR
- (16) LANDSCAPE ISLAND WATER HARVESTING (TYP), SEE DETAIL SHEET DET-3
- (17) 3' CMU BLOCK WALL
- (18) RETAINING WALL

SITE DATA

PROPOSED USAGE INDOOR ENTERTAINMENT 402445 SF (9.23 ACRES) LOT AREA ZONING

NR-C

FRONT: 5' BUILDING SETBACKS SIDE: 0' REAR: 0'

PARKING REQUIRED

1 SPACE/210 GSF FOR 51,000 GSF= 243 SPACES PER TABLE 5-5-2 1 SPACE/3 OCCUPANTS FOR INDOOR TRACK (50 OCCUPANTS)= 17 SPACES 20% PARKING REDUCTION FOR EMPLOYMENT CENTER AND MASS TRANSIT CORRIDOR= -52 SPACES

TOTAL REQUIRED PARKING= 208 SPACES PARKING PROVIDED= 343 SPACES

HC PARKING REQUIRED 12 SPACES (2 VAN SPACES) HC PARKING PROVIDED 12 SPACES (2 VAN SPACES)

BICYCLE SPACES REQUIIRED 10% OF OFF-STREET PARKING


35 SPACES BICYCLE SPACES PROVIDED 35 SPACES


MOTORCYCLE SPACES REQUIRED 6 SPACES

A PARKING REDUCTION STUDY WAS APPROVED BY THE PLANNING DIRECTOR ON 10-13-2022 FOR THE PROVIDED 343 PARKING SPACES SHOWN ON THIS PLAN.



GRAPHIC SCALE

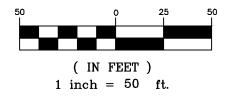

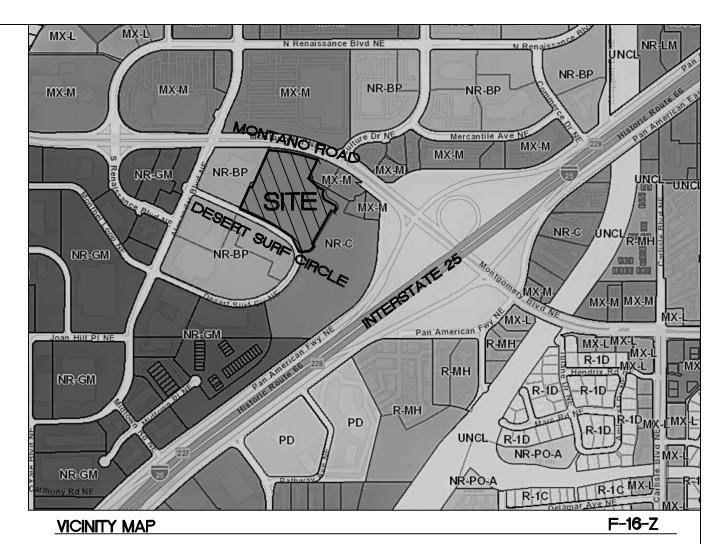

LEGAL DESCRIPTION:

PARCEL B-1-A CORRECTION PLAT OF PARCELS C-1-A, C-1-B ANDB-1-A RENAISSANCE CENTER III CONT 9.2281 AC

NOTES:

1. EXISTING PRIVATE DRAINAGE EASEMENT WILL BE VACATED BY PLAT.


2. APPROVAL OF THIS PLAN DOES NOT CONSTITUTE OR IMPLY EXEMPTION FROM WATER WASTE PROVISIONS OF THE WATER CONSERVATION LANDSCAPING AND WATER WASTE ORDINANCE WATER WASTE MANAGEMENT IS THE SOLE RESPONSIBILITY OF THE PROPERTY OWNER.

3. LANDSCAPE MAINTENANCE SHALL BE THE RESPONSIBILITY OF THE OWNER.


4. LIGHT POLES SHALL BE A MAXIMUM OF 25' FEET WITH FULL CUT OFF LIGHT FIXTURES. LIGHT FIXTURES SHALL BE A MAXIMUM OF 20' WITH FULL CUT OFF SHIELDS ON FIXTURES SO THAT NO FUGITIVE LIGHT SHALL ESCAPE BEYOND THE PROPERTY LINE. THE LIGHT FIXTURES SHALL BE FULLY SHIELDED WITH HORIZONTAL LAMPS.

- 5. SIGN PERMITS SHALL BE ACQUIRED FOR ALL MONUMENT SIGNS AS WELL AS WALL SIGNS GREATER THAN 24 SQUARE FT, PURSUANT TO IDO 5-12(D)(1).
- 6. ACCESS AT DESERT SURF CIRCLE BE FULL MOVEMENT.
- 7. ROOF EQUIPMENT SHALL BE BELOW PARAPET HEIGHT OR SCREENED FROM VIEW. ALL GROUND MOUNTED EQUIPMENT SHALL BE SCREENED BY SCREEN WALLS WITH TOP OF EQUIPMENT BELOW TOP OF SCREEN WALL.

PROJECT NUMBER: PR-2019-002284 APPLICATION NUMBER: _SI-2021-00168 This plan is consistent with the specific Site Development Plan approved by the Environmental Planning Commission (EPC), dated ______, and the Findings and Conditions in the Official Notification of Decision are satisfied. Is an Infrastructure List required? () Yes () No If Yes, then a set f approved DRC plans with a work order is required for any construction within Public Right—of—Way or for construction of public improvements. SITE DEVELOPMENT PLAN SIGNOFF APPROVAL: Jul 16, 2024 PLANNING Date Einest armijo Oct 16, 2023 TRANSPORTATION DEVELOPMENT Date Oct 18, 2023 **ÚTILITY DEVELOPMENT** Date CITY ENGINEER Date Whitney Phelan Oct 12, 2023 PARKS & RECREATION Date AMAFCA Date Oct 12, 2023 Date Tiegre Cha Oct 12, 2023 **HYDROLOGY** Date

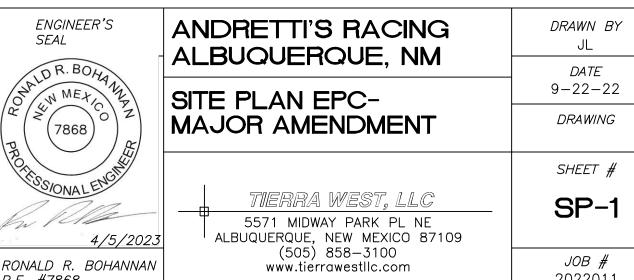

RONALD R. BOHANNAN 2022011 P.E. #7868

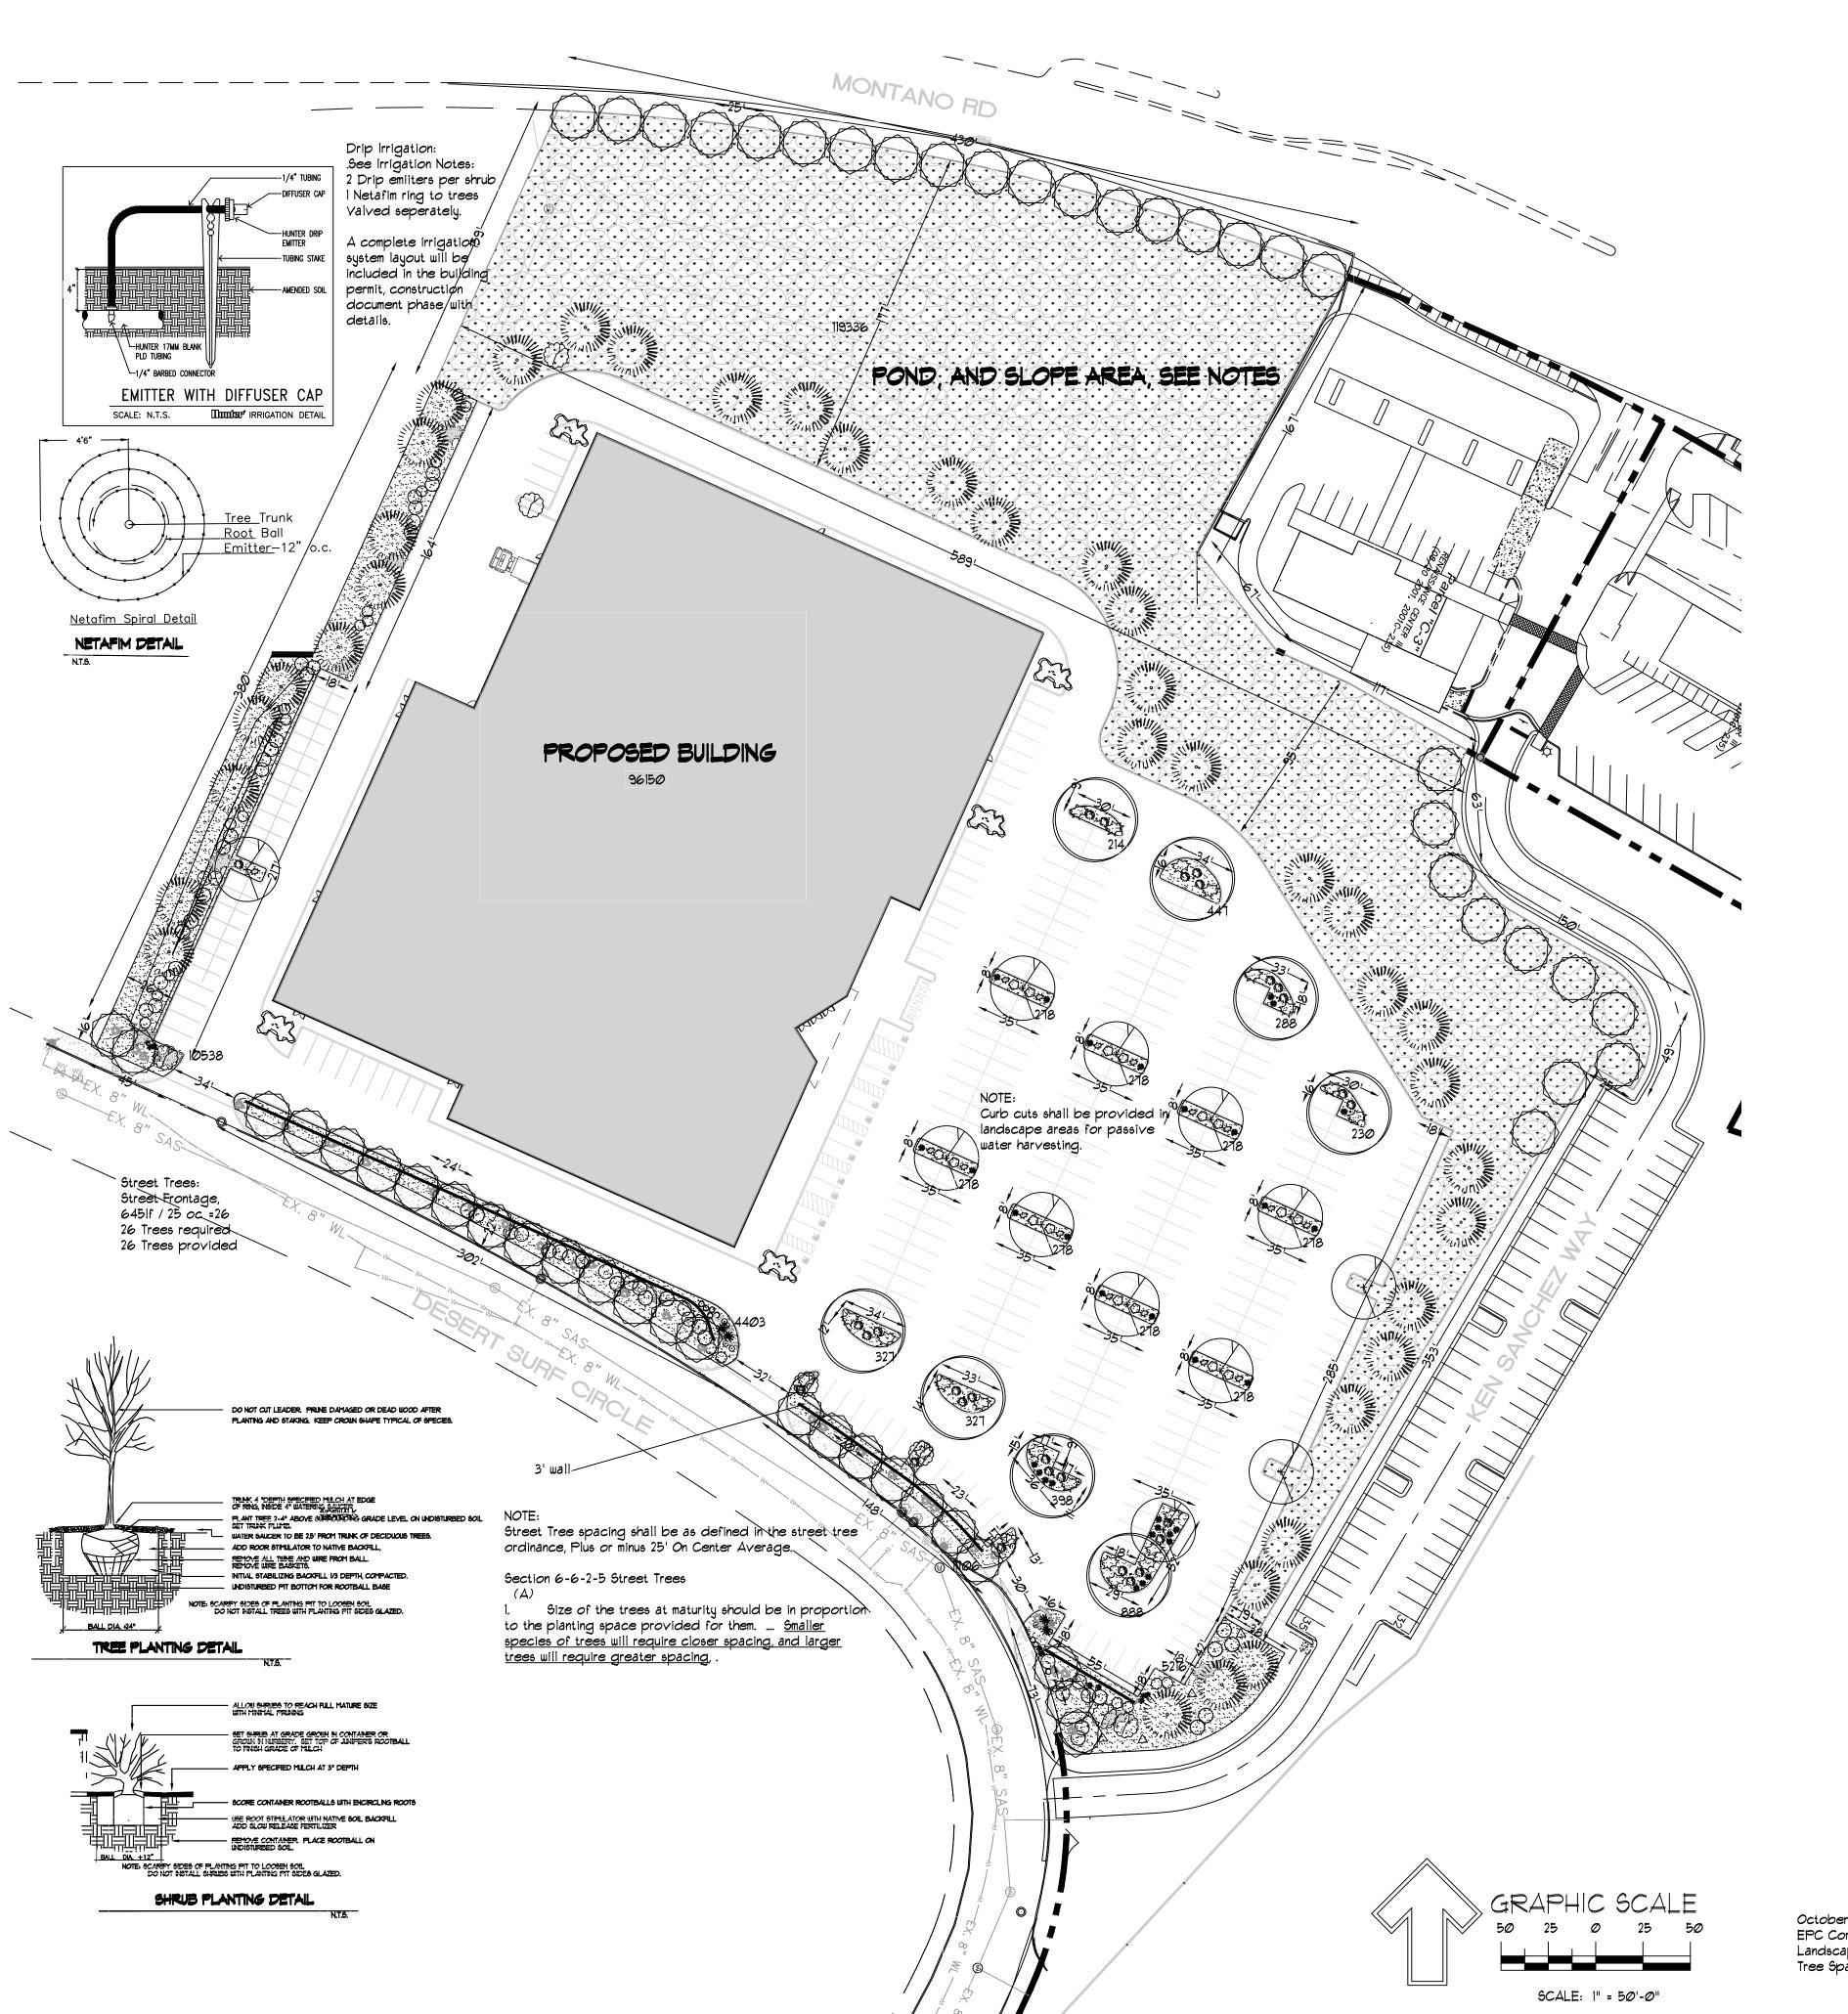

	QTY	SIZE	CØMMON/BOTANICAL			H20 USE
		Trees		,		
	12	2" cal	Chinese Pistache 40x35 Pistacia chinensis	1225	14700) M+
	8	2" cal	Honey Locust 50x45 Gleditsia triacanthos	2Ø25	16200	М
	38	6 - 8'	Austrian Pine 35x25 Pinus nigra	625	2375 <i>©</i>	М
	5	15 Gal	Crape Myrtle 30x20 Lagerstroemia indica Tree Form, 18'-20' o		2 000 uritv	М
**	4	4 - 6'	Palm Yucca 15x6 Yucca faxoniana	36	144	М
	8	15 Gal.	Oklahoma Redbud 15x12 Cercis reniformis	144	1152	М
	53	15 Gal	Desert Willow 20x25 Chilopsis linearis	625	33125	
		Shrubs \$	Groundcovers		IFQIE	TREE COVERAGE
•	28	5 Gal	India Hawthorne 3x5 Raphiolepis indica	25	7 <i>0</i> 0	М
*	10	5 Gal	Feather Reed Grass 2.5x2 Calamogrostis arudina	4 acea	40	М
0	16	5 Gal	Wintergreen Barberry 5x5 Berberis julianae	25	400	М
Δ	4	5 Gal	Butterfly Bush 5x7 Buddleia davidii	49	196	М
\$7	22	5 Gal	Winter Jasmine 4x12 Jasminum nudiflorum	144	3168	М
	8	5 Gal	Buffalo Juniper lx12 Juniperus sabina 'Buff	144 falo'	1152	М
٥	8	5 Gal	Cherry Sage 2x3 Salvia greggii	9	٦2	М
0	Т	5 Gal	Blue Mist 3x3 Caryopteris x clandone	9 ensis	63	М
0	2Ø	5 Gal	Fern Bush 5x6 Chamaebatiaria millefo	36 olium	720	L
0	26	5 Gal	Apache Plume 6x1 Fallugia paradoxa	49	1274	L
\odot	28	5 Gal	Chamisa 5x7 Chrysothamnus nause	49 osus	1372	L
•	32	5 Gal	Dwarf Fountain Grass 3x3 Pennisetum alopecuro	9 pides 'i	288 Hame	M lin'
₽	П	5 Gal	Carpet Roses 2x4 Rosa sp.	16	272	L
%	39	2-3cf	Boulders To be placed at cor	ntracto	9717 r disa	SHRUB COVERAGE
	26683		Landscape Gravel / Filter F 3/4" Crushed Grey		. 4100	
	119336		RIP RAP AND SEEDED SLO REFERENCE GRADING			NAGE BASIN NOTES
	146019	TOTAL LANDS				

LANDSCAPE NOTES:

Landscape maintenance shall be the responsibility of the Property Owner. The Property Owner shall maintain all landscaping in a living, healthy, and attractive

Water management is the sole responsibility of the Property Owner. All landscaping will be in conformance with the City of Albuquerque Zoning Code. In general, water conservative, environmentally sound landscape principles will be followed in design and installation.

Landscape Gravel over Filter Fabric to a minimum depth of 3" shall be placed in all landscape areas.

IRRIGATION NOTES:

Irrigation system maintenance and operation shall be the sole responsibility of the owner. It shall be the owners responsibility to ensure that fugitive water does not leave the site due to overwatering.

Irrigation shall be a complete underground system with Trees to receive 1 Netafim spiral (50' length) with 3 loops at a final radius of 4.5' from tree trunk, pinned in place. Netafim shall have emitters 12" o.c. with a flow of .6 aph. Shrubs to receive (2) 1.0 GPH Drip Emitters. Drip and Bubbler systems to be tied to 1/2" polypipe with flush caps at each end.

Run time per each shrub drip valve will be approximately 15 minutes per day. Tree drip valve shall run 1.5 hours, 3 times per week. Run time will be adjusted according to the season.

Point of connection for irrigation system is unknown at current time and will be coordinated in the field. Irrigation will be operated by automatic controller.

Location of controller to be field determined and power source for controller to be provided by others.

Irrigation maintenance shall be the responsibility of the Property Owner.

Water and Power source shall be the responsibility of the Developer/Builder.

LANDSCAPE CALCULATIONS

TOTAL LOT AREA (6f)	402105
TOTAL BUILDING AREA (sf)	-96149
TOTAL LOT AREA (sf)	305956
LANDSCAPE REQUIREMENT	X .15
TOTAL LANDSCAPE REQUIRED (15%)	45893
TOTAL ON-SITE LANDSCAPE PROVIDED	146019
TOTAL LIVE GROUNDCOVER REQUIRED	43806
TOTAL LIVE GROUNDCOVER PROVIDED	129053
TOTAL NATIVE SEED AREA, POND AND SLOPE	119336
TOTAL LIVE PLANT COVER REQUIRED	109514
TOTAL LIVE PLANT COVER PROVIDED	220196

Street Tree Notes:

Per Section 5-6(D)(1)(a) Required Street Trees. Trees are GENERALLY required along street frontages every 25 feet on center unless otherwise specified in Part 6-2-2 of ROA 1994 (Street Trees)

Section 6-6-2-5 Street Trees

1. Size of the trees at maturity should be in proportion to the planting space provided for them. Smaller species of trees will require closer spacing, and larger trees will require greater spacing, . Spacing shall be approved as

2. On sites where evenly spaced street trees are not possible, or do not conform to the overall design needed. objectives of the site, provided that the number of trees equals or exceeds the number that would Maintenance will be per City of Albuquerque be required if the trees were evenly spaced

Clear Site Triangle Note: Landscaping and signage will not interfere with clear site requirements. Signs, walls, trees and shrubbery between 3 and 8 feet tall, (as measured from the gutter pan) are not included within the clear site triangle.

part of the plan approval process.

Drainage Basin Treatments Per City of Albuquerque Drainage Basin Treatments

The bottom and sides must be seeded with a native mix per City Standard specification 1012.2 depending on soil type for that City area. Please reference this native seed selection and the section on plan sheet.

For pond bottoms: Gravel ¾ to 1 inch mulch. One layer thick, not stacked

Native grass establishment must be achieved by the contractor within a 3 year time frame. Temporary irrigation or water trucks must be used when rain is lacking. Seeds must germinate in one year or reseeding will likely be

Specification 1012.3.9.1 and 1012.3.9.2.

Contractor must weed the basin during/after the first growing season.

Needs city inspection. Stormwater Quality Ordinance-final stabilization must be accepted by the City.





505.639.9583

danny@mitchellassociatesinc.com

ANDRETTI'S RACING ALBUQUERQUE, NM	<i>DRAWN BY</i> pm
ALBOQUENQUE, INIVI	DATE
LANDSCAPE PLAN FOR	5-17-22
BUILDING PERMIT	DRAWING
	SHEET #
l tierra west, llc	2
5571 MIDWAY PARK PL NE ALBUQUERQUE, NEW MEXICO 87109	2
(505) 858-3100 www.tierrawestllc.com	<i>JOB #</i> 2022011

October 27, 2022 EPC Comments Addressed. Landscape Areas dimensioned. Tree Spacing not greater than 25'

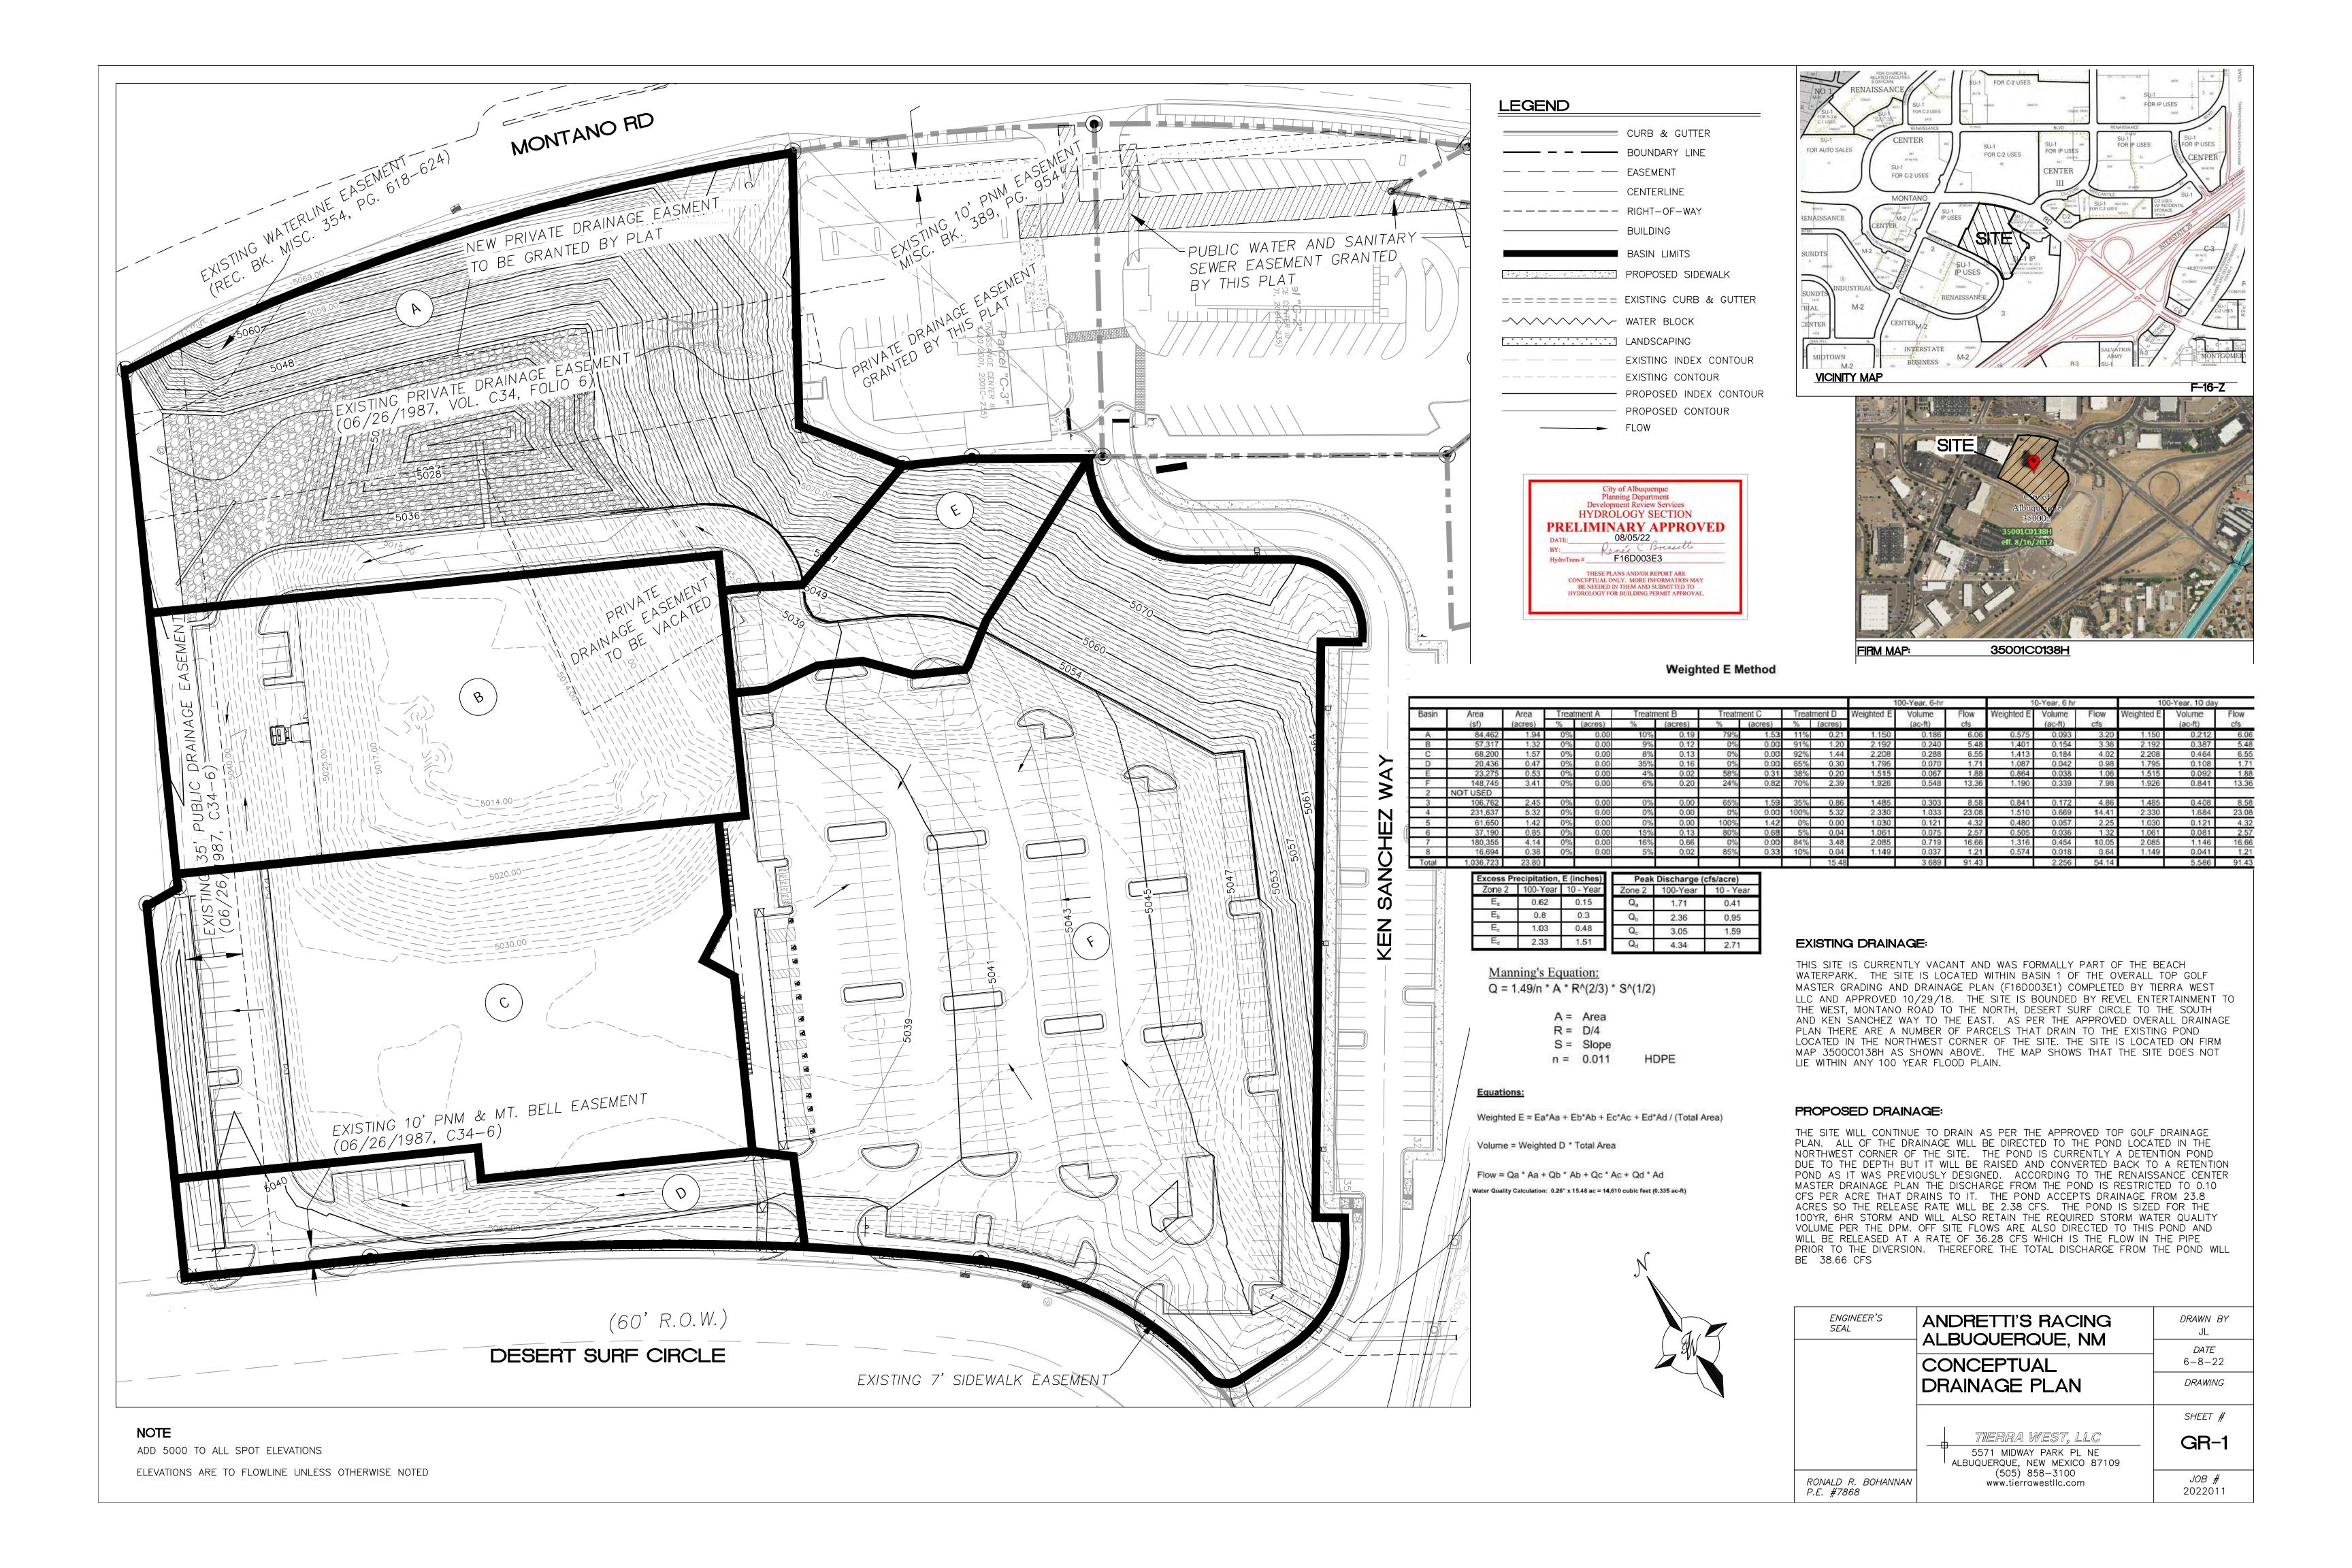

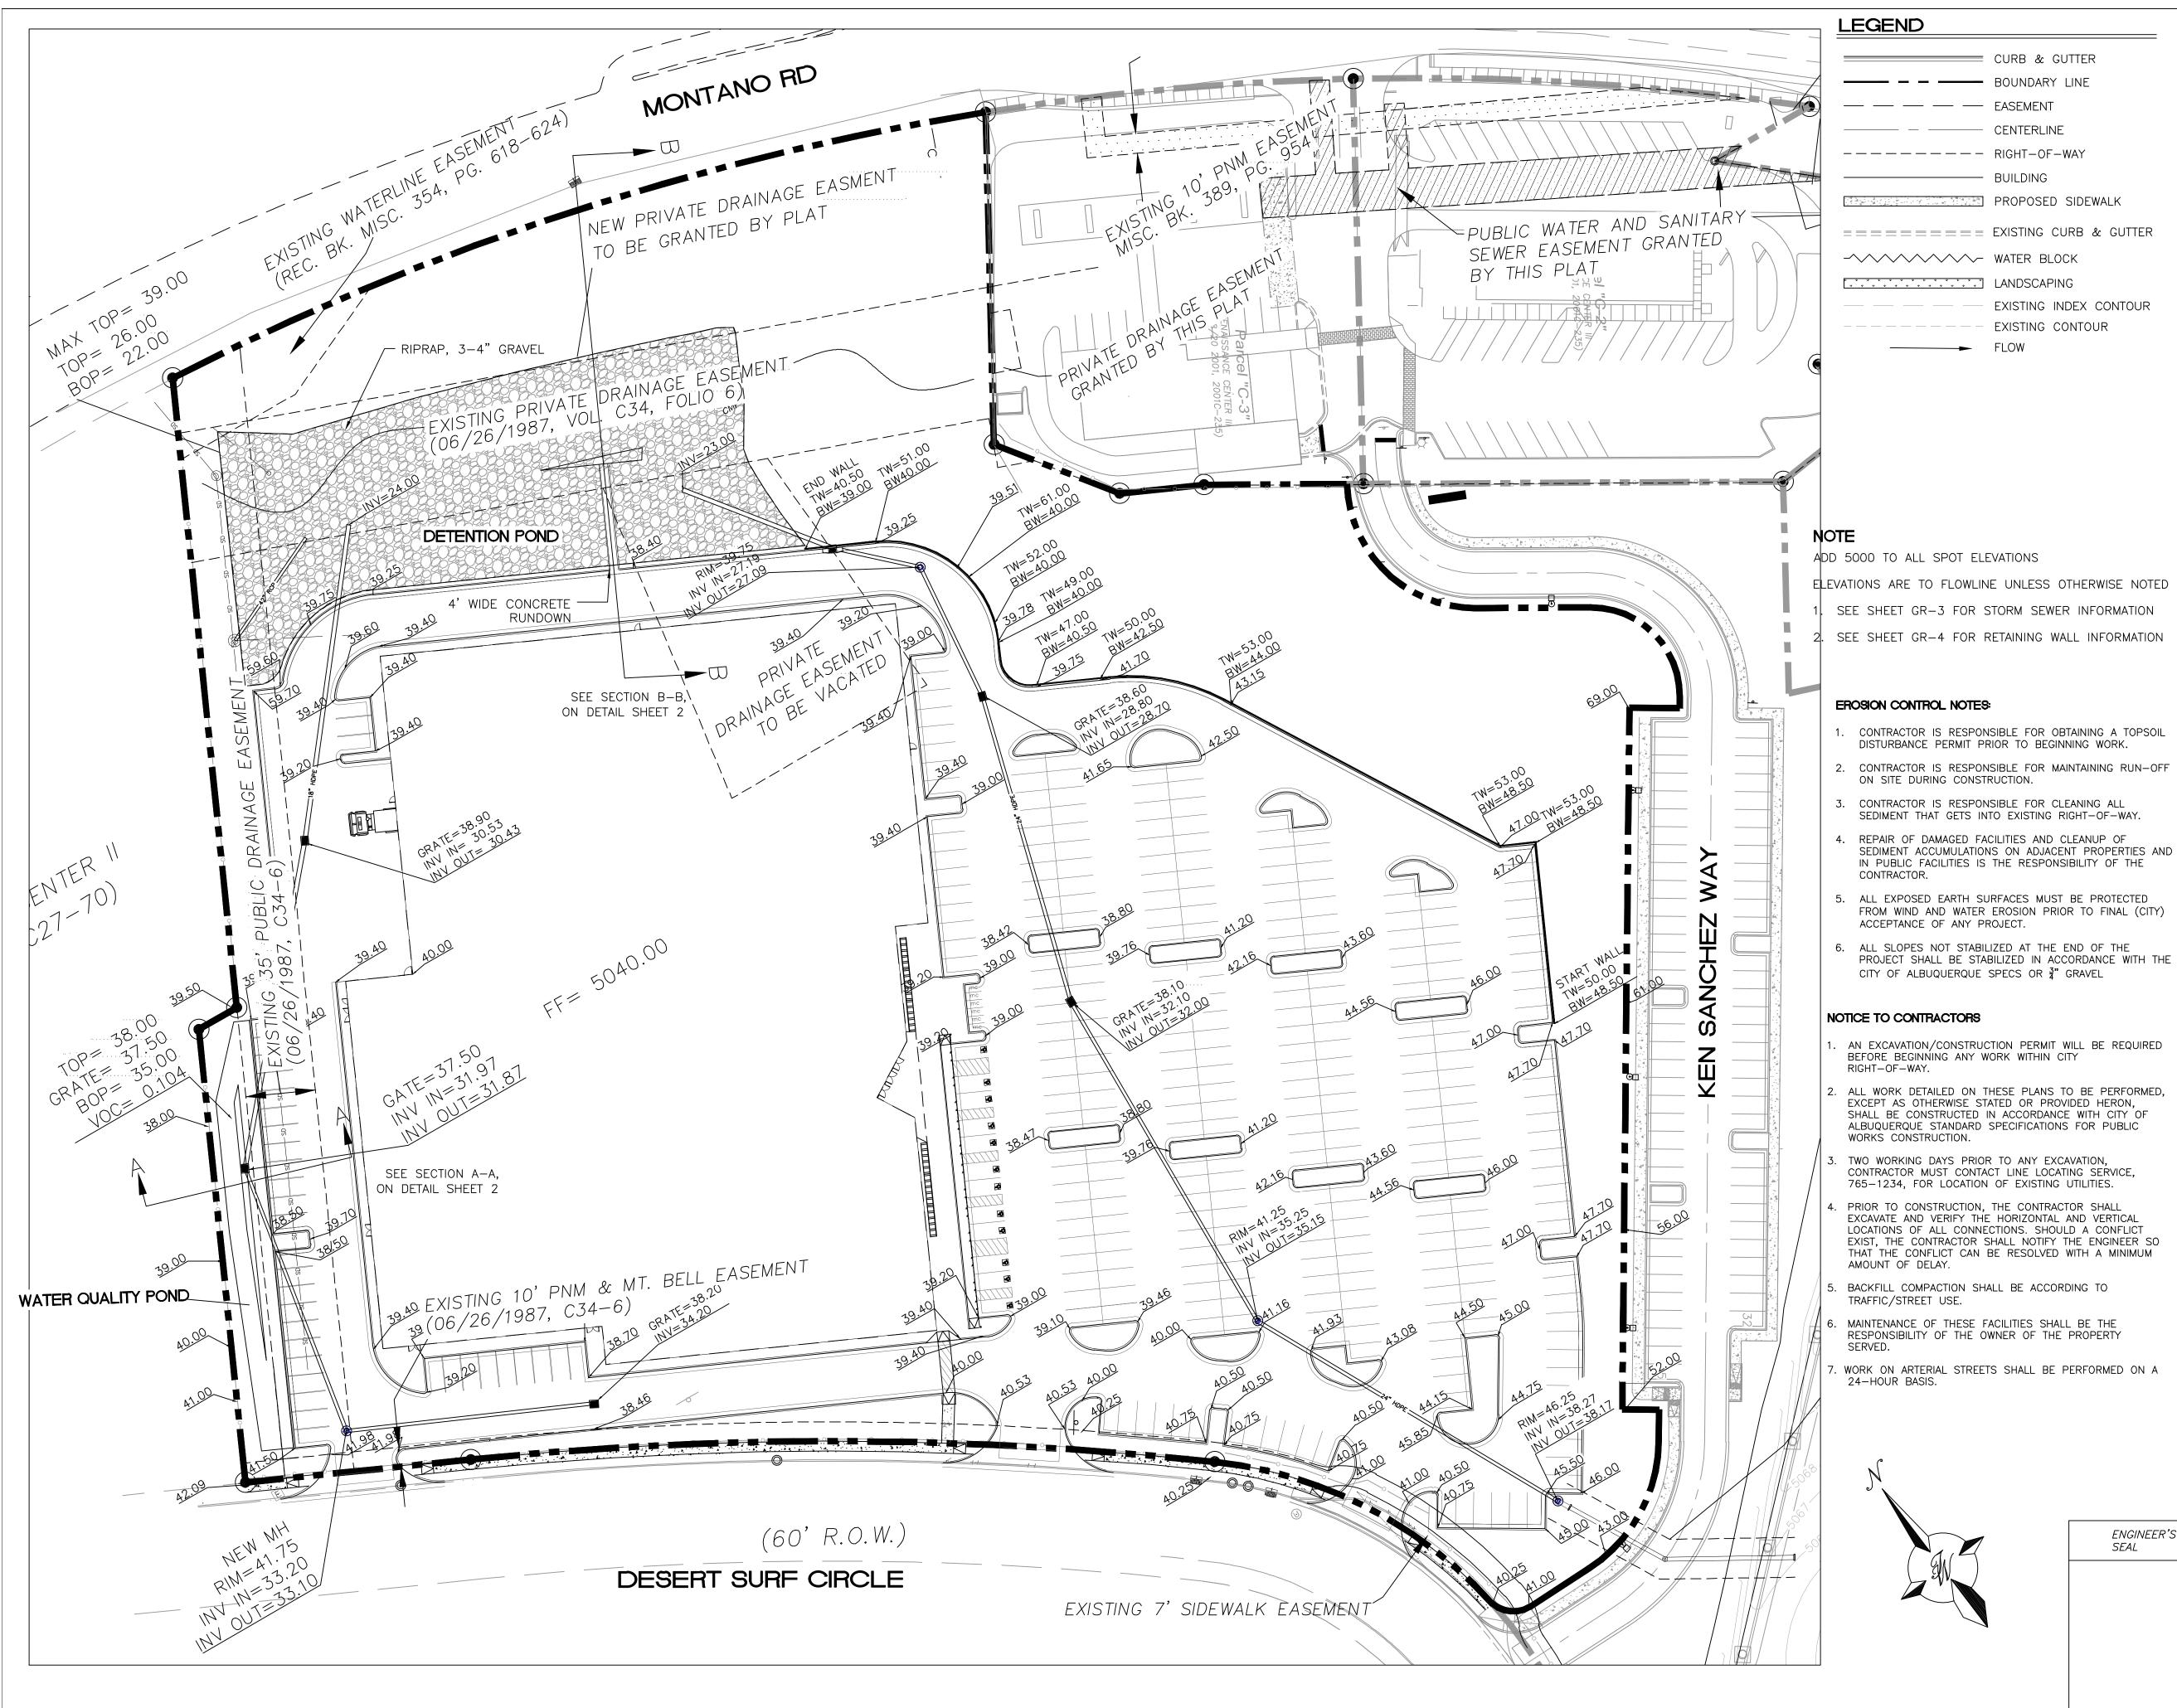

VOLUME CALCULATIONS

Water Quality Pond

Ab - Bottom Of The Pond Surface Area

At - Top Of The Pond Surface Area

D - Water Depth

Dt - Total Pond Depth

C - Change In Surface Area / Water Depth

Volume = Ab * D + 0.5 * C * D2

C = (At - Ab) / Dt

Ab = 667.00

At = 4,184.003.00

1172.33

ACTUAL	DEPTH	VOLUME
ELEV.	(FT)	(AC-FT)
5035.00	0.00	0.00
5035.50	0.50	0.0077
5036.00	1.00	0.0187
5036.50	1.50	0.0364
5037.00	2.00	0.0609
5037.50	2.50	0.0921
5038.00	3.00	0.1300

Grate Elevation

VOLUME CALCULATIONS

DETENTION POND

Ab - Bottom Of The Pond Surface Area At - Top Of The Pond Surface Area

D - Water Depth

C - Change In Surface Area / Water Depth

Dt - Total Pond Depth

Volume = Ab * D + 0.5 * C * D2 C = (At - Ab) / Dt

At = 29,965.00

Dt = 16.50

C = 1759.09

ACTUAL ELEV.	DEPTH (FT)	VOLUME (AC-FT)	Q (CFS)	1
5022.50	0.00	0.00	0.0000	1
5023.50	1.00	0.0216	0.0000	1
5024.50	2.00	0.0634	0.0000	1
5025.50	3.00	0.1455	0.0000	1
5026.50	4.00	0.2680	0.0000	٧
5027.50	5.00	0.4310	3.5176	1
5028.50	6.00	0.6343	13.4573	1
5029.50	7.00	0.8780	18.7036	1
5030,50	8.00	1.1620	22,7717	1
5031.50	9.00	1.4865	26.2160	1
5032.50	10.00	1.8513	29.2575	1
5033,50	11.00	2.2565	32.0114	1
5034.50	12.00	2.7021	34.5464	1
5035.50	13.00	3.1881	36.9078	1
5036.28	13.78	3.5974	38.6583	1
5037.00	14.50	3.9951	40.1988	I
5038.50	16.00	4.8909	43.2323	

Water Quality Elevation

100-yr Volume

Orifice Equation


Q = CA SQRT(2gH)

0.6 22.24 Diameter (in) 2.698 Area (ft^2)=


32.2 H(Ft) =Depth of water above center of orifice Q (CFS)=


5039.00 16.50 5.2097 44.1973


Planning Department Development Review Services HYDROLOGY SECTION PRELIMINARY APPROVED 08/05/22 BY: Reference Bressette
HydroTrans# F16D003E3 THESE PLANS AND/OR REPORT ARE CONCEPTUAL ONLY. MORE INFORMATION MAY BE NEEDED IN THEM AND SUBMITTED TO HYDROLOGY FOR BUILDING PERMIT APPROVAL.

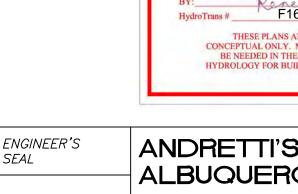



ENGINEER'S SEAL	ANDRETTI'S RACING ALBUQUERQUE, NM	<i>DRAWN BY</i> JL
	ALBOCOLI ICOL, INIVI	DATE
	CONCEPTUAL	6-8-22
	GRADING PLAN	DRAWING
		SHEET #
	TIERRA WEST, LLC 5571 MIDWAY PARK PL NE ALBUQUERQUE, NEW MEXICO 87109	GR-2
RONALD R. BOHANNAN P.E. #7868	(505) 858-3100 www.tierrawestllc.com	<i>JOB #</i> 2022011

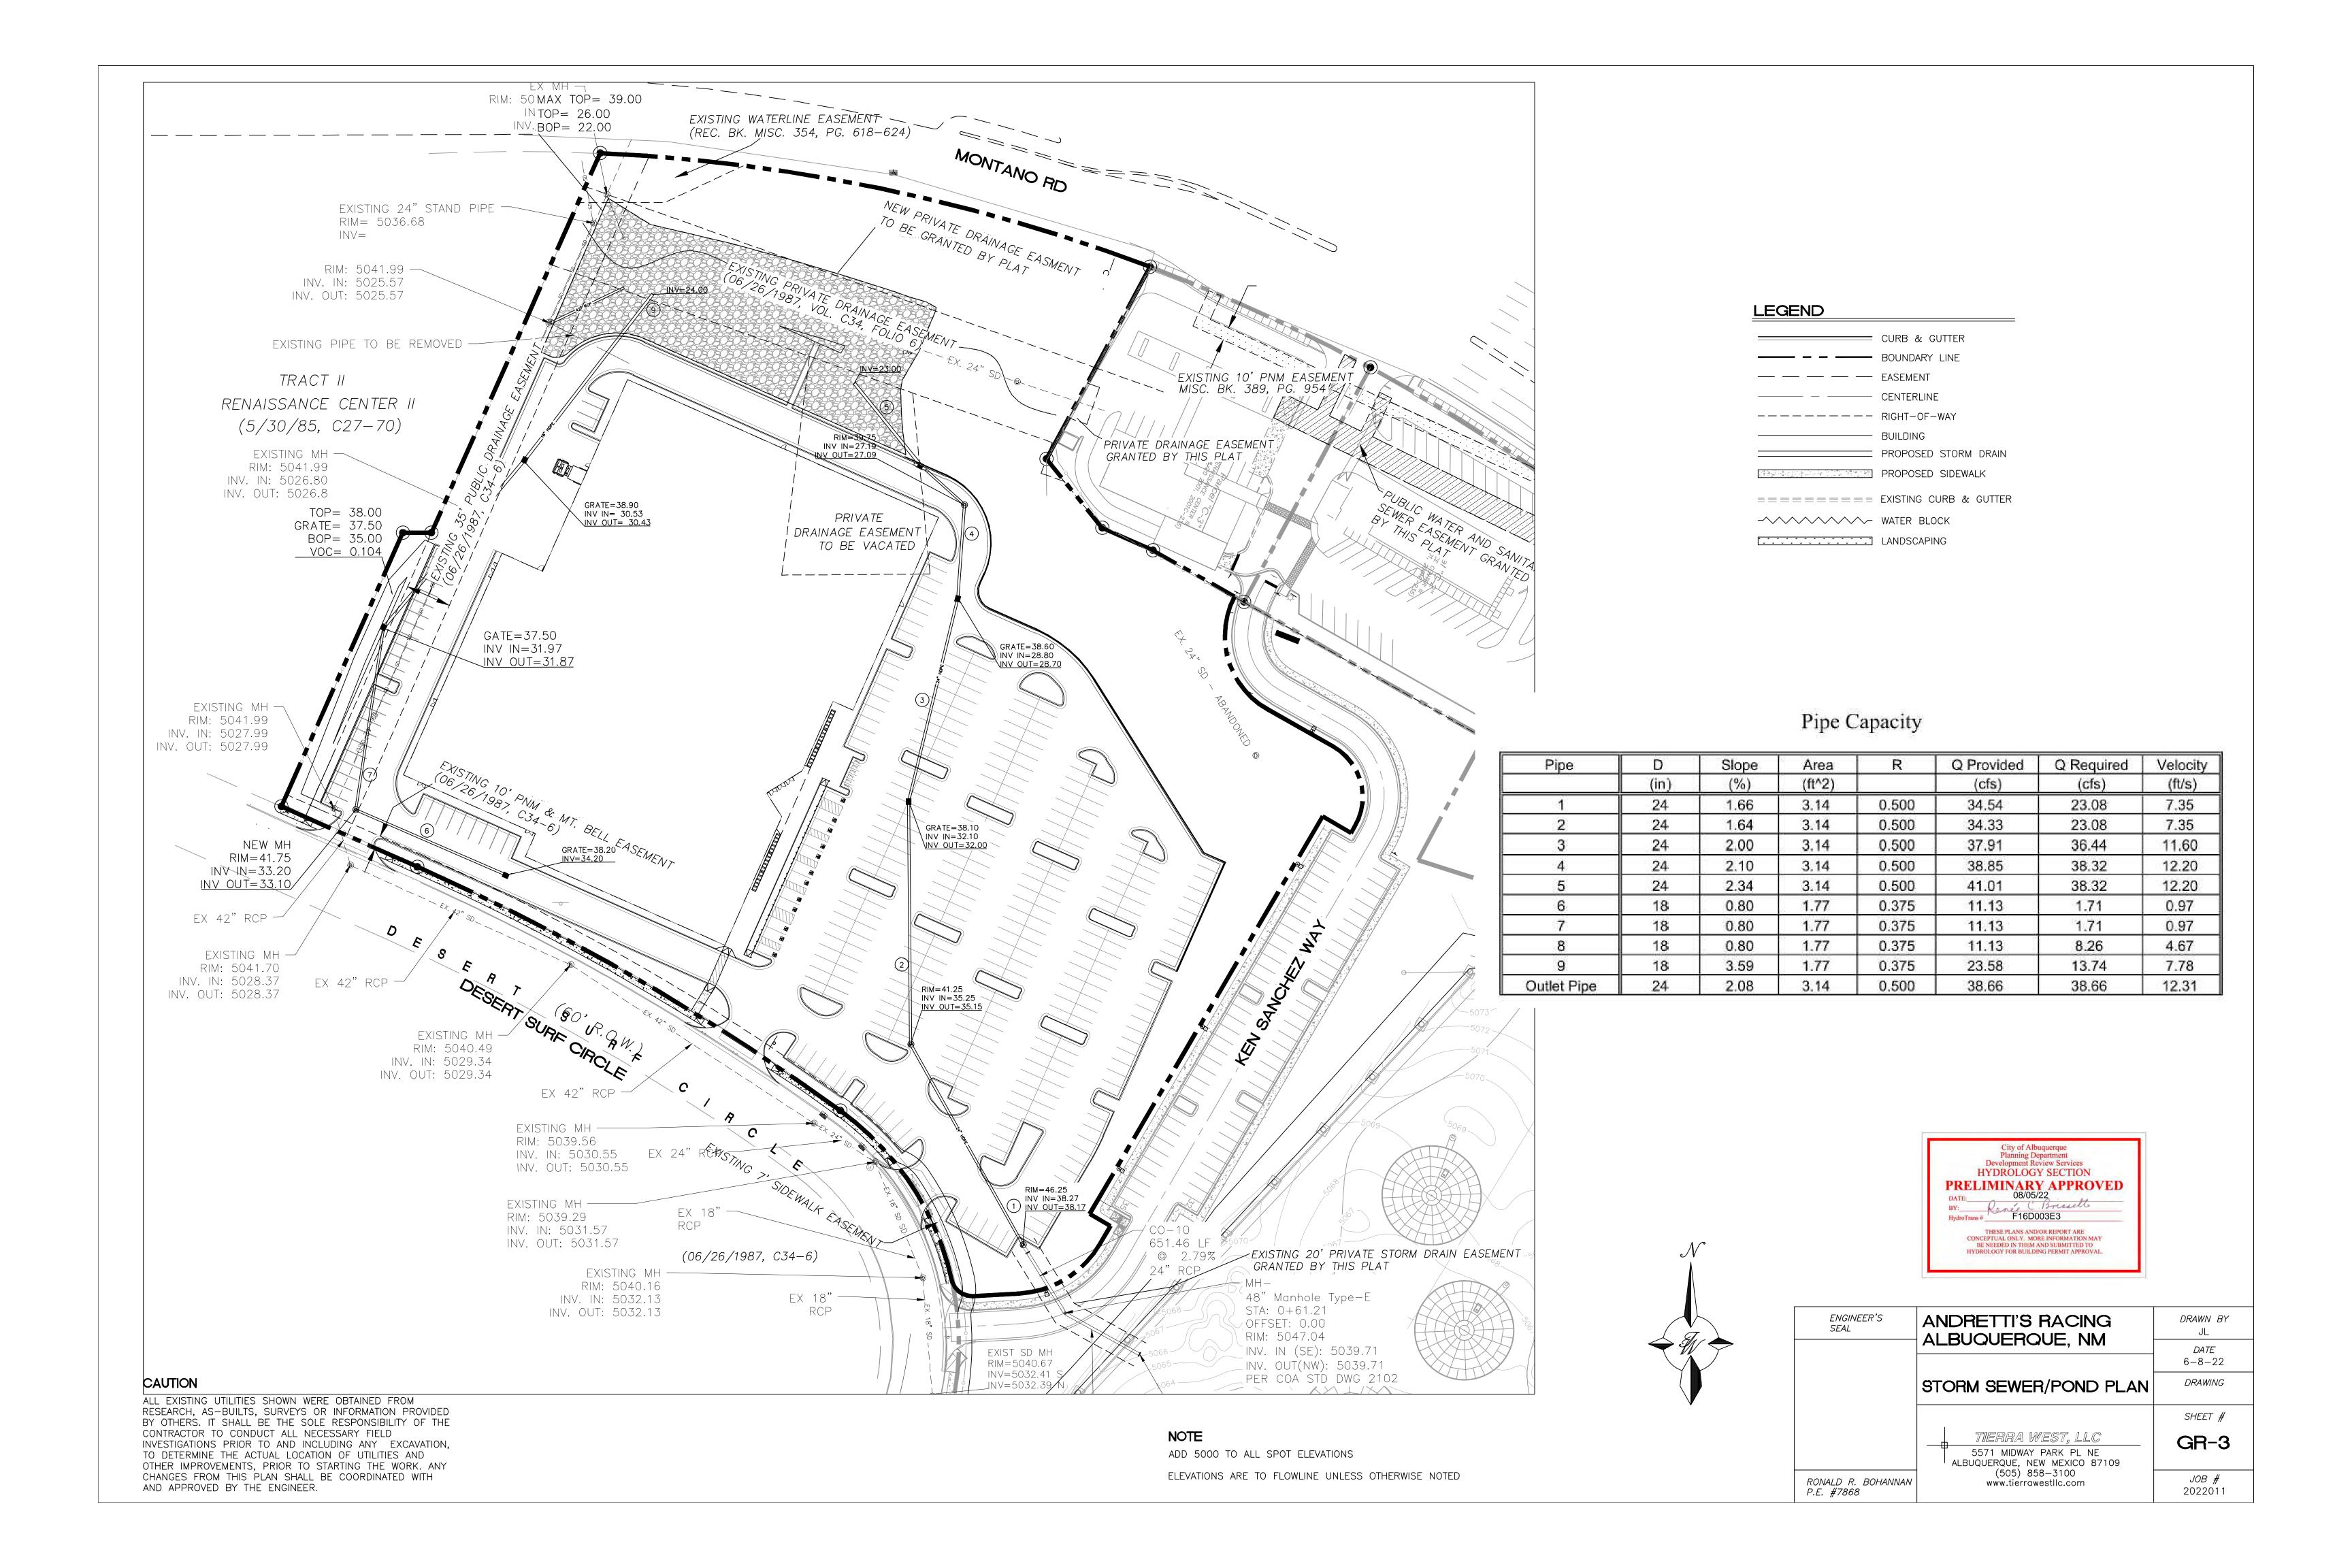

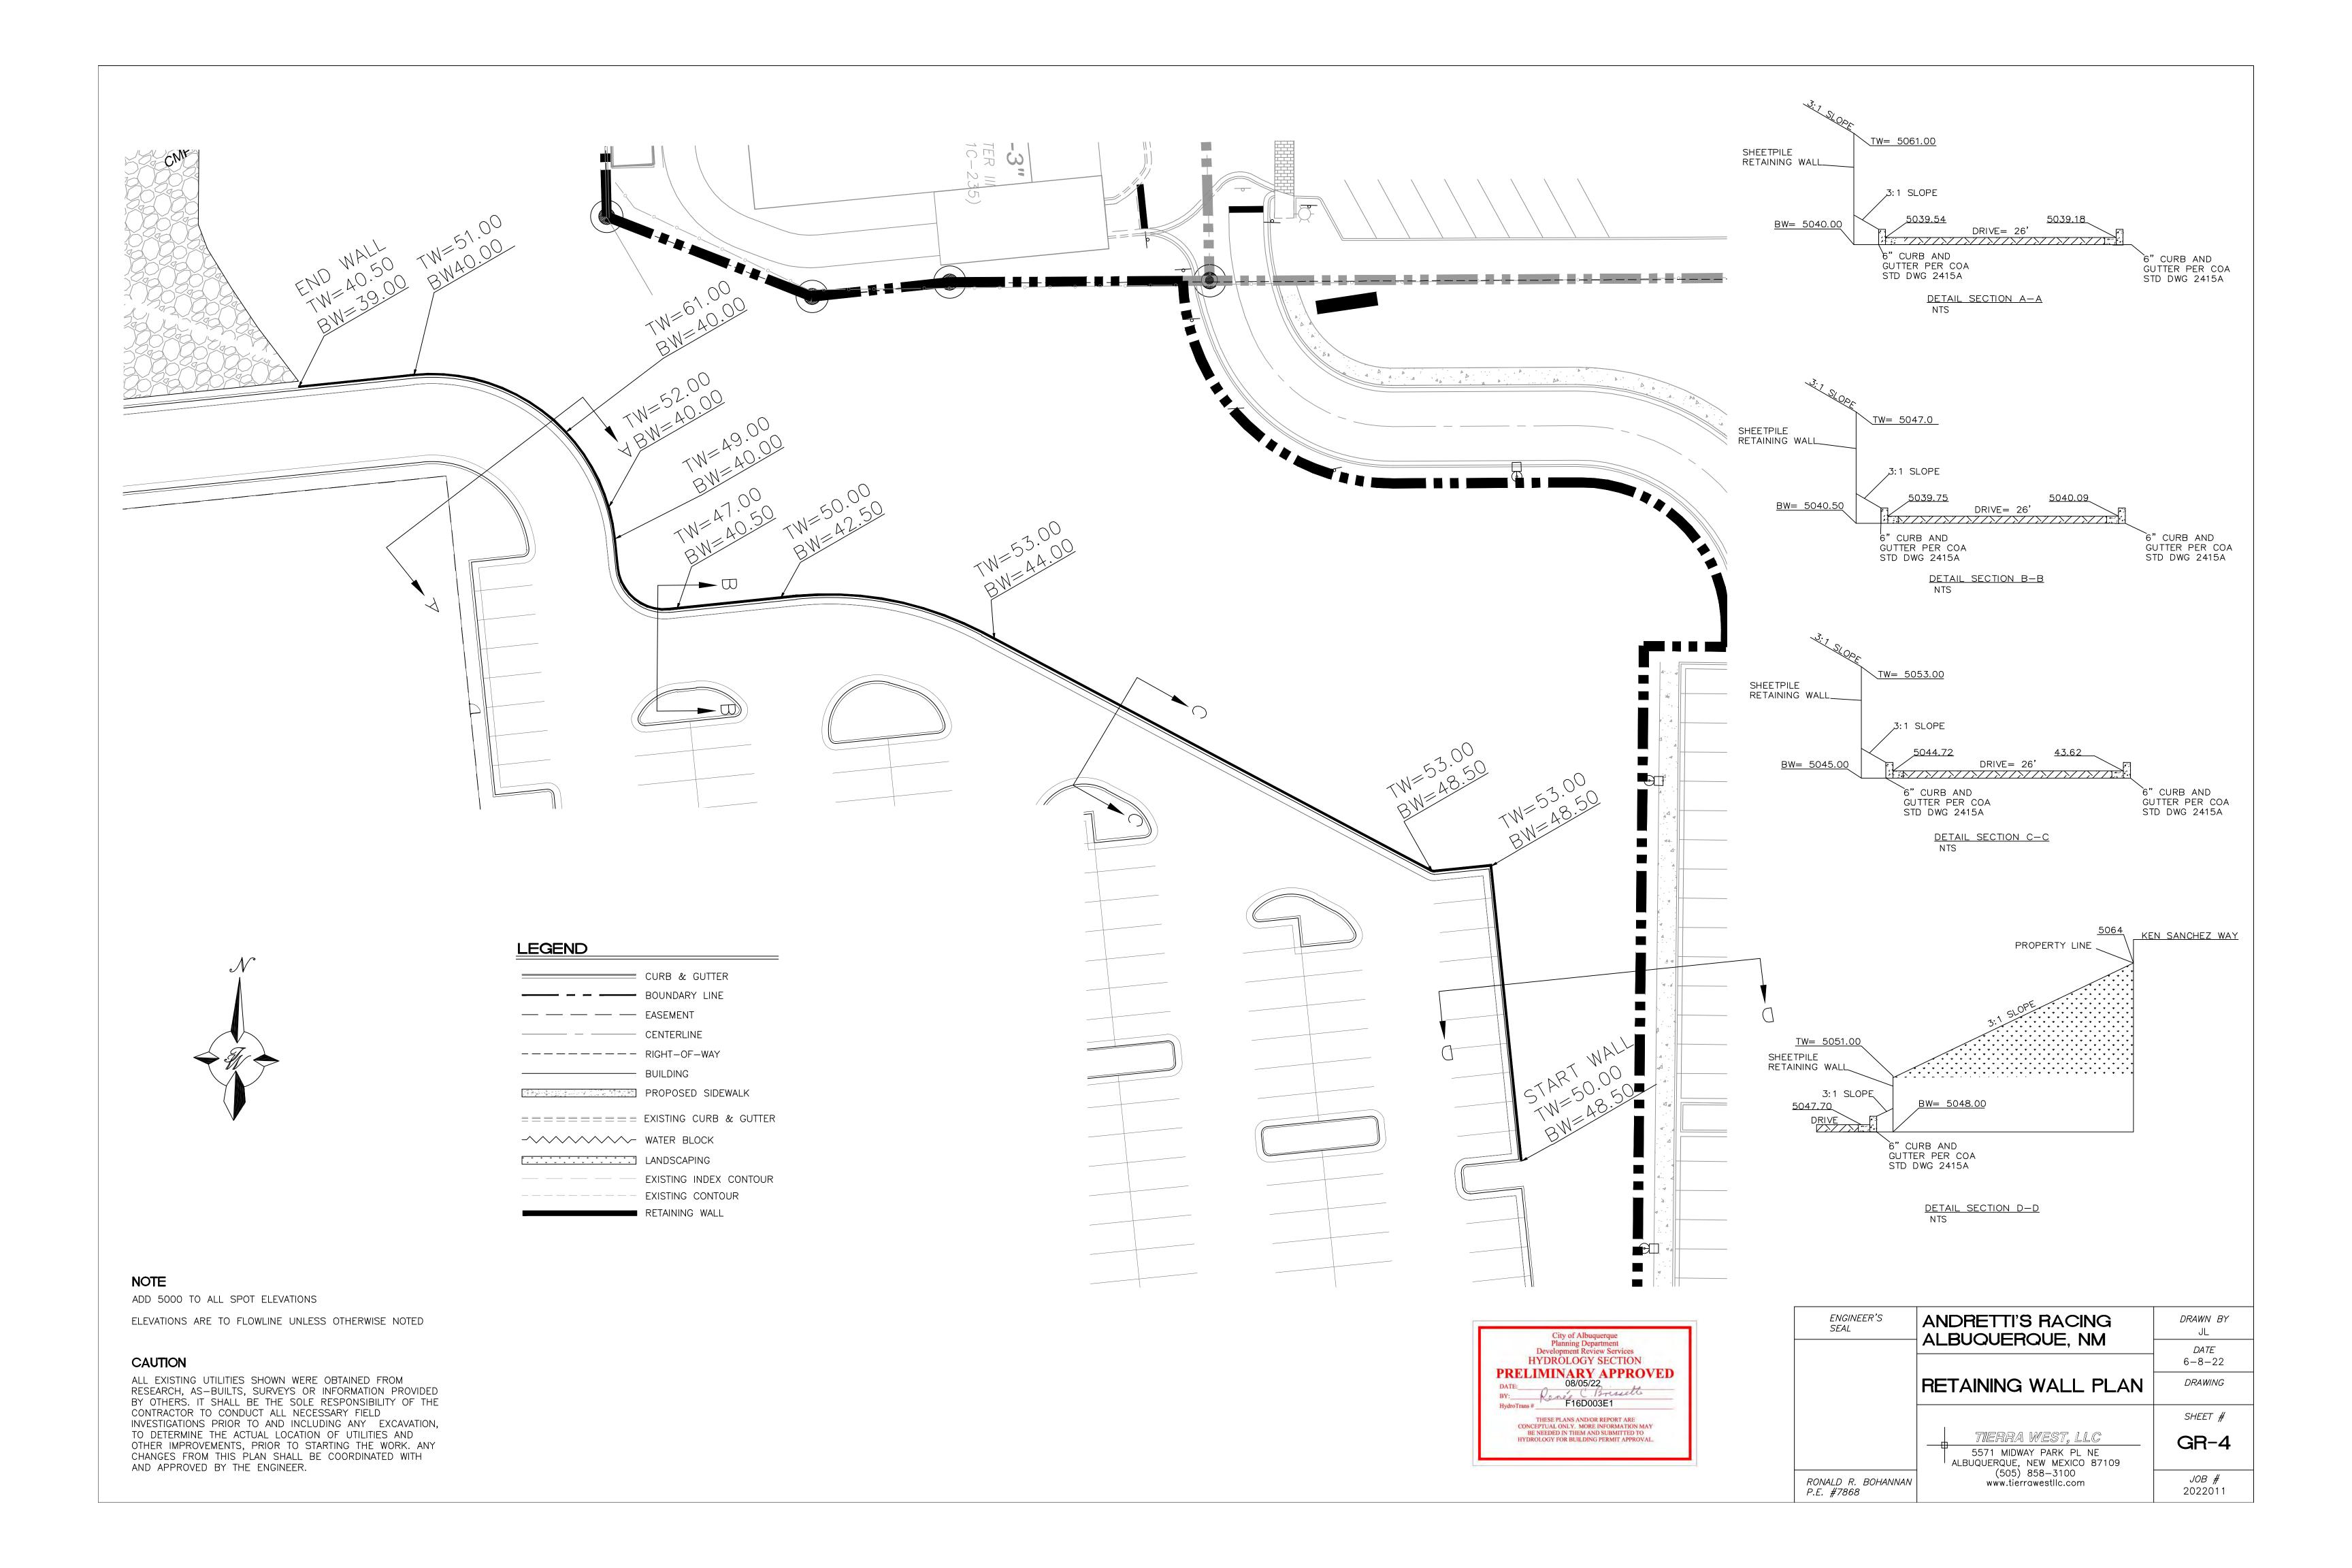


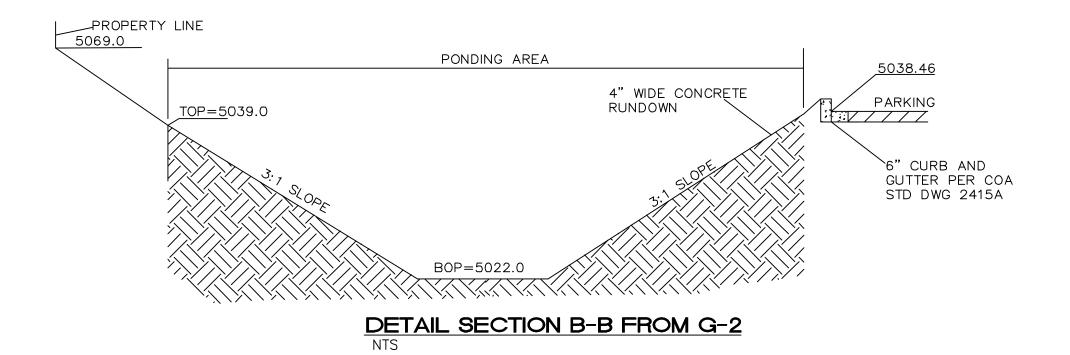


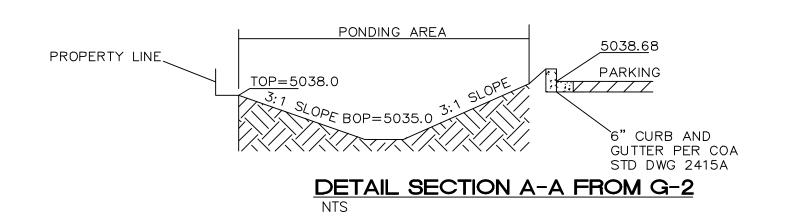

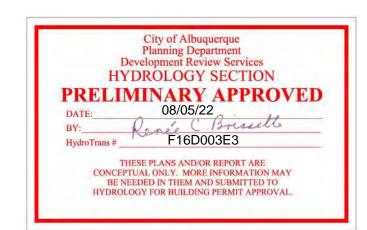

ENGINEER'S SEAL	ANDRETTI'S RACING ALBUQUERQUE, NM	DRAWN BY JL
	DETAIL	<i>DATE</i> 6-8-22
	DETAIL	DRAWING
		SHEET #
	TIERRA WEST, LLC 5571 MIDWAY PARK PL NE ALBUQUERQUE, NEW MEXICO 87109	GR-2
RONALD R. BOHANNAN P.E. #7868	(505) 858-3100 www.tierrawestllc.com	<i>JOB #</i> 2022011

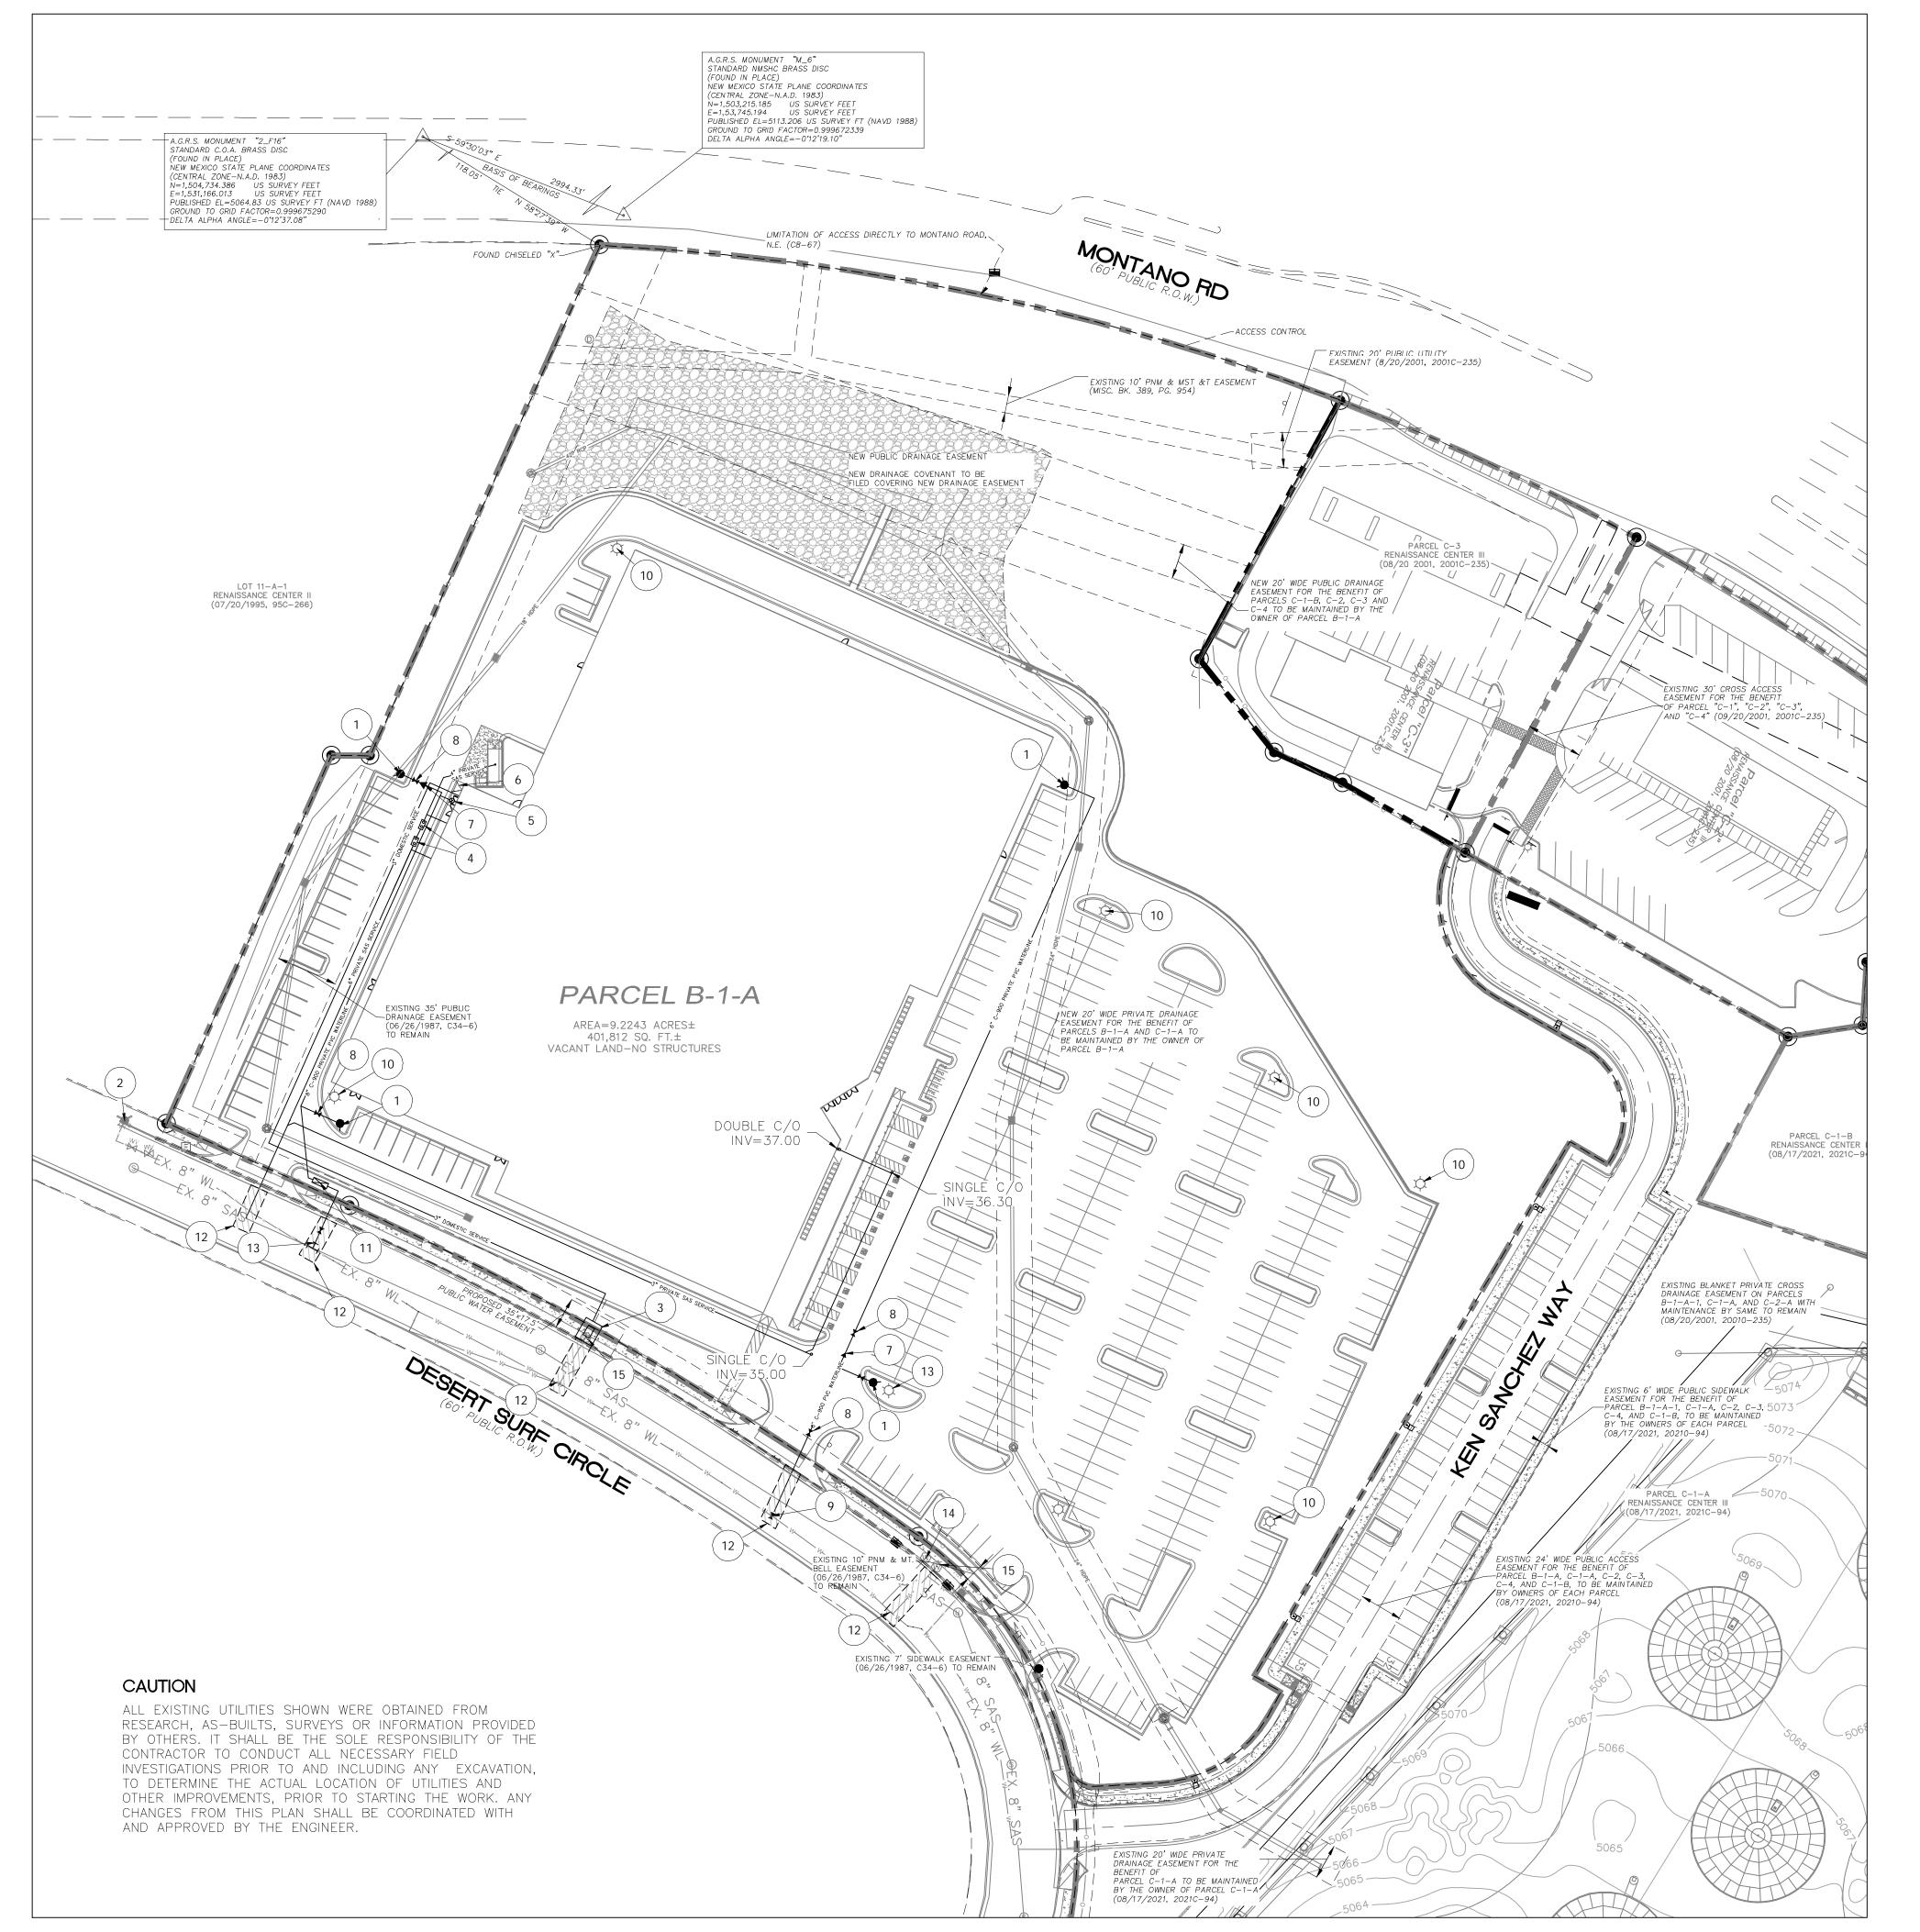

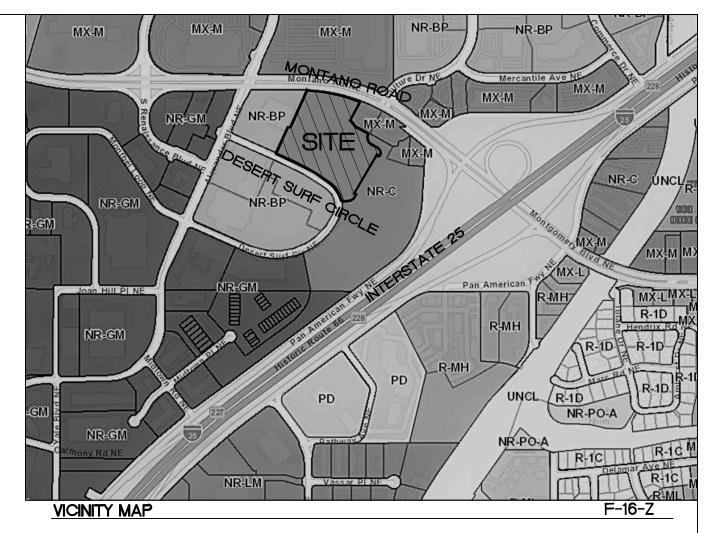

LEGAL DESCRIPTION:

PARCEL B-1-A CORRECTION PLAT OF PARCELS C-1-A, C-1-B ANDB-1-A RENAISSANCE CENTER III CONT 9.2281 AC

LEGEND

CURB & GUTTER — — — EASEMENT ---- RIGHT-OF-WAY BUILDING PROPOSED SIDEWALK

======== EXISTING CURB & GUTTER

	SANITARY SEWER LINE
	STORM SEWER LINE WATERLINE
_	PROPOSED HYDRANT
H	NEW WATER VALVE
	NEW SINGLE WATER MET
S	EXISTING SAS MH
\bowtie	EXISTING GATE VALVE
	EXISTING WATERLINE
	EXISTING SAS

GENERAL UTILITY NOTES:


- 1. ALL WATER AND SEWER UTILITY WORK TO BE DONE IN ACCORDANCE WITH CITY OF RIO RANCHO STANDARDS AND SPECIFICATIONS LATEST EDITION.
- 2. 4' MINIMUM BURY REQUIRED FOR ALL UTILITIES UNLESS OTHERWISE NOTED.
- 3. REFERENCE PLUMBING PLANS FOR WATER LINE RISER LOCATIONS. BACKFLOW PREVENTOR LOCATED INSIDE BUILDING
- 4. CLEAN OUTS ARE TO BE BUILT PER UNIFORM PLUMBING CODE STANDARDS AT LOCATIONS INDICATED AND AT MID RUN IF LONGER THAN 100'
- 5. ALL PLUMBING PIPE MATERIAL TO BE USED PER UPC.
- 6. FIRE LINE AND DOMESTIC WATERLINE MUST HAVE BACKFLOW PREVENTORS PER UPC. TO BE PROVIDED IN THE BUILDING
- 7. ALL EX. SD INLETS AND MH'S SHALL HAVE CONCRETE COLLARS POURED AND BE ADJUSTED TO FINISHED GRADE.
- 8. ALL EXCAVATION, TRENCHING AND SHORING ACTIVITIES MUST BE CARRIED-OUT IN ACCORDANCE WITH OSHA 29
- 9. ALL UTILITY DISTANCES SHOWN ARE FOR REFERENCE ONLY.
- 10. COORDINATION WITH WATER AUTHORITY CROSS CONNECTION SECTION WILL BE REQUIRED TO ENSURE PROPER BACKFLOW CONTAINMENT IS IN PLACE PRIOR TO RELEASE OF METER FOR SITE. CONTACT THE CROSS CONNECTION SECTION AT 505-289-3454.
- 11. COORDINATION WITH THE WATER AUTHORITY PRE-TREATMENT ENGINEER IS REQUIRED TO ENSURE THE SITE COMPLIES WITH WATER AUTHORITY SEWER USE ORDINANCE. CONTACT PRE-TREATMENT ENGINEER AT 505-289-3439.

KEYED NOTES


LIGHT

- PROPOSED PRIVATE FIRE HYDRANT.


 1) TO BE PAINTED ORANGE PER CITY FIRE MARSHALL REQUIREMENT.
- (2) EXISTING PUBLIC FIRE HYDRANT
- 3" WATER METER PIT PER COA STD DWG. 2370
- (4) PROPOSED GREASE INTERCEPTOR
- 5) PIV
- 6 FDC
- (7) 8"X6" REDUCER
- 8 6" PRIVATE GATE VALVE PER COA STD DWG. 2326
- 9 6" PUBLIC GATE VALVE PER COA STD DWG. 2326
- PARKING LOT LIGHT STANDARD (TYP) FULL CUTOFF LED'S, 25' HIGH, SEE DETAIL SHEET DET-2
- (11) 8" BACKFLOW PREVENTER W/ HOTBOX
- (12) REMOVE AND REPLACE ASPHALT
- CONNECT TO EX 8" WL W/ 8"X8" TEE AND 8" GATE VALVE (PUBLIC)
- (14) EX. WATER METER TO BE USED FOR LANDSCAPING
- (15) EX. WATER METER TO BE ABANDONED AT MAIN

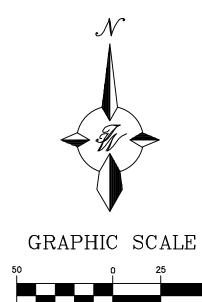

(IN FEET) 1 inch = 50 ft.

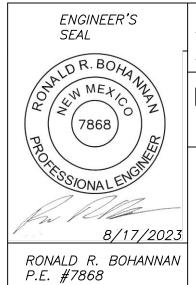

ENGINEER'S SEAL	ANDRETTI'S RACING ALBUQUERQUE, NM	<i>DRAWN BY</i> JL
IDR. BOHANA	ALBOGOLI (GOL, INIVI	DATE
W ME+COZ	MASTER UTILITY PLAN	8/17/2023
(7868)	WAOTER OHERT LAN	DRAWING
		SHEET #
\$5/ONALENG! 8/17/2023	TIERRA WEST, LLC 5571 MIDWAY PARK PL NE ALBUQUERQUE, NEW MEXICO 87109	MU-1
ALD R. BOHANNAN	(505) 858-3100 www.tierrawestllc.com	JOB #
#7868	www.tierrawestiic.com	2022011

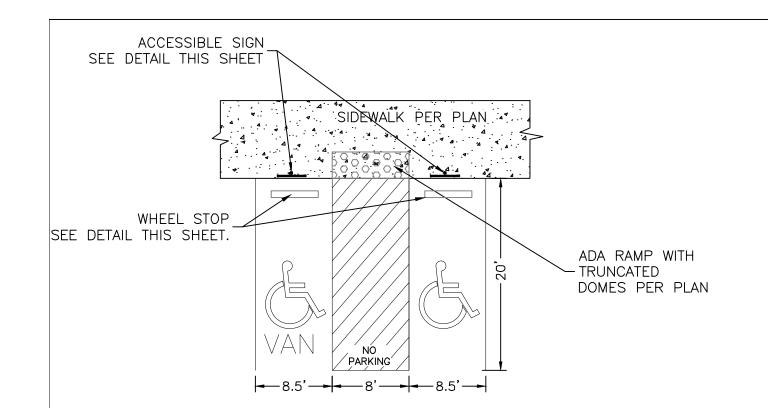


NOTES:


1) International Symbol of Accessibility shall be painted on the pavement at rear of space, white symbol on blue background.
2) Parking space lines and diagonal striping to be painted blue.
3) Access aisle shall have the words "NO PARKING" in capital letters, each of which shall be at least one foot high and at least two inches wide, placed at the rear of the parking space so as to be close to where an adjacent vehicle's rear tires would be placed.

4)ADA parking areas — not to exceed a slope greater than 2% in any direction

(1) HC PARKING DETAIL SCALE: NTS

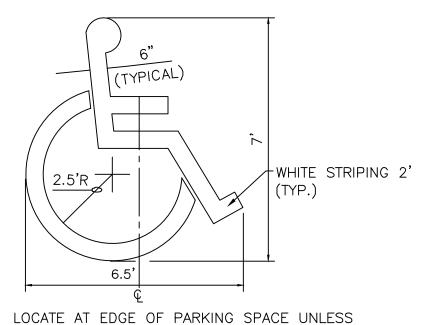

ACCESSIBLE PARKING SYMBOL

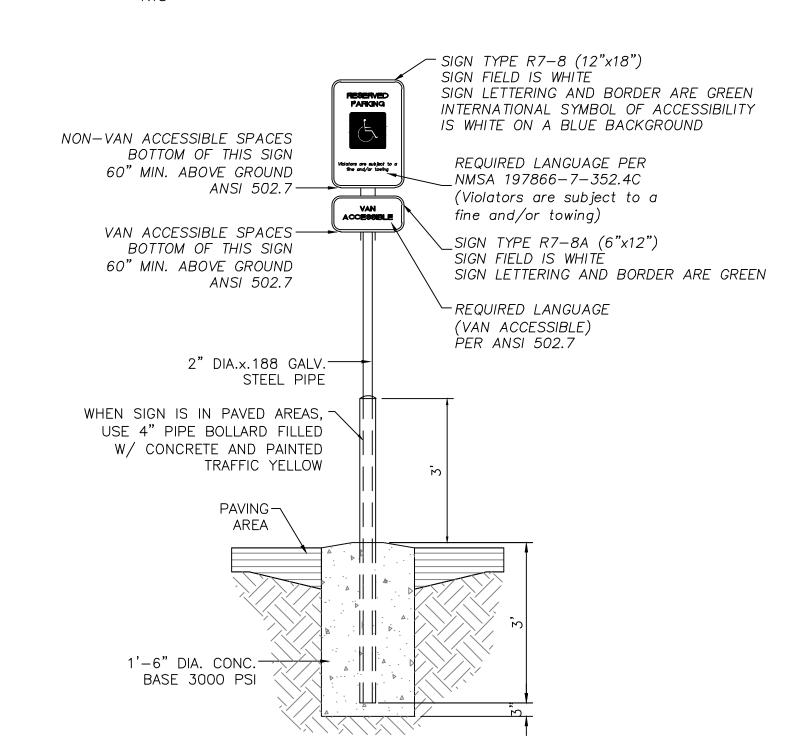

ACCESSIBLE PARKING SIGN

MAIRAX DIVISION GRABER MAIRTAX DIVISION GRABER MAIRTAX DIVISION GRABER MAIRTAX DIVISION MAIRAX DIVISION

PRODUCT: U238-IG(SF)
DESCRIPTION: 'U' BIKE RACK
2 BIKE, SURFACE OR IN GROUND MOUNT
DATE: 10-4-18
ENG: SMC
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NOTES:

1. INSTALL BIKE RACKS ACCORDING TO MANUFACTURER'S SPECIFICATIONS.


2. CONSULTANT TO SELECT COLOR (FINISH), SEE MANUFACTURER'S SPECIFICATIONS.

3. SEE SITE PLAN FOR LOCATION OR CONSULT DWNER.


3. BIKE RACK SHALL HAVE A 1-FOOT CLEAR ZONE ALL ARDUND.


3. EACH BIKE RACK SPACE SHALL BE AT LEAST 6 FEET LONG AND 2 FEET WIDE.

BIKE RACK DETAIL SCALE: NONE

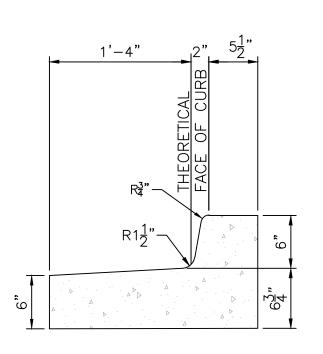


STANDARD CURB / GUTTER PER COA 2415A

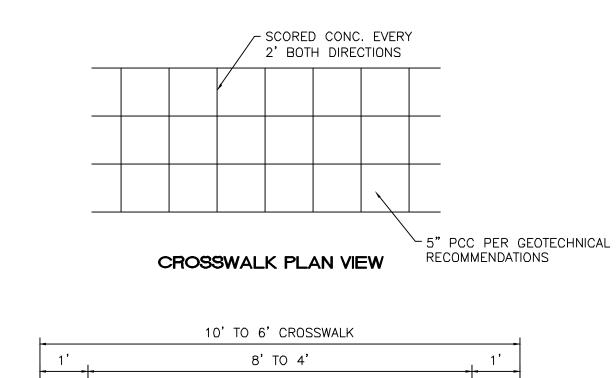

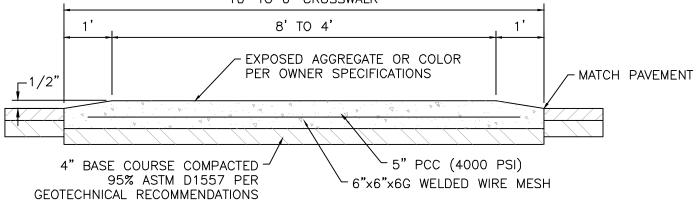

RAISED CROSSWALK

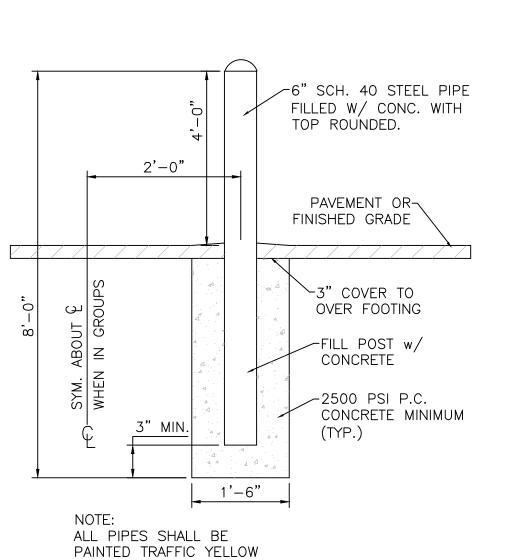


ZERO CURB NTS

CONC. PAVING

OR SIDEWALK

-6x6 W2.9xW2.9 W.W.F.

BOLLARD DETAIL

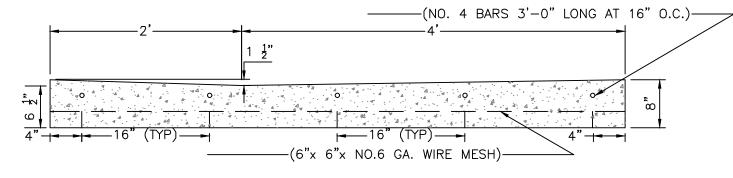

1/2" RADIUS ¬


PAVING —

1/2" EXP. JT. -& SEALANT


> #4 REBARS— CONT.

EDGE

CONCRETE VALLEY GUTTER DETAIL PER COA 2415B

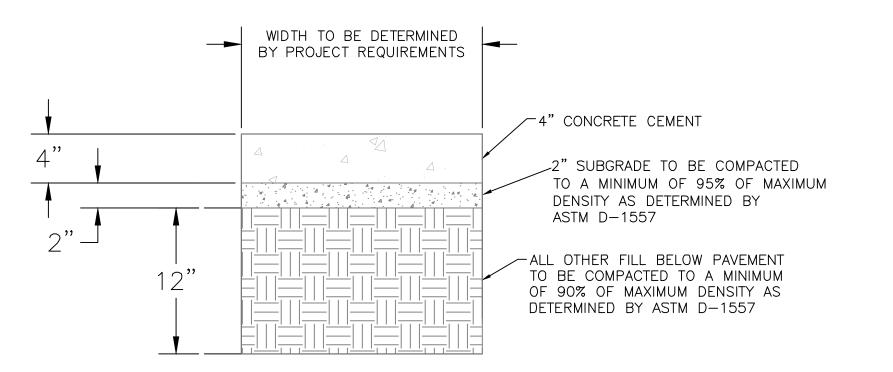



CONCRETE SIDEWALK SECTION

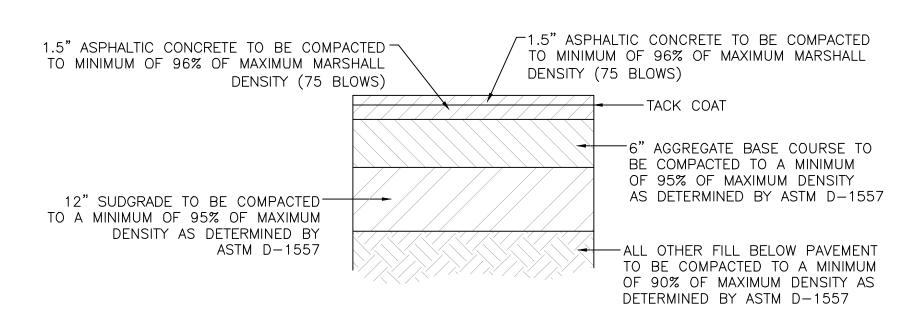


SITE ASPHALT PAVEMENT SECTION

NOTE: CONTRACTOR TO VERIFY WITH OWNER PROVIDED SOILS REPORT.

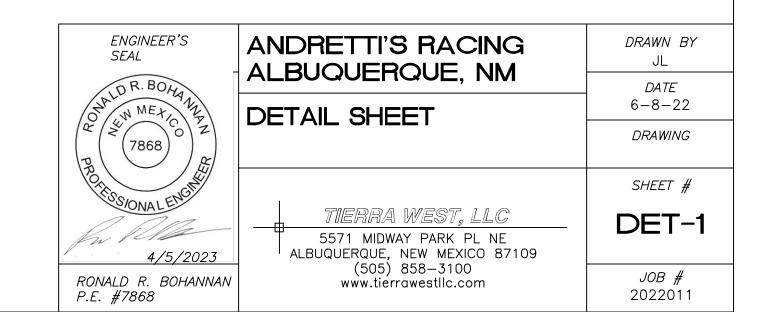

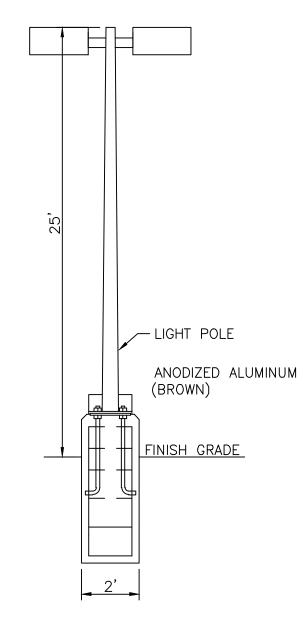


LIGHT POLE DETAIL

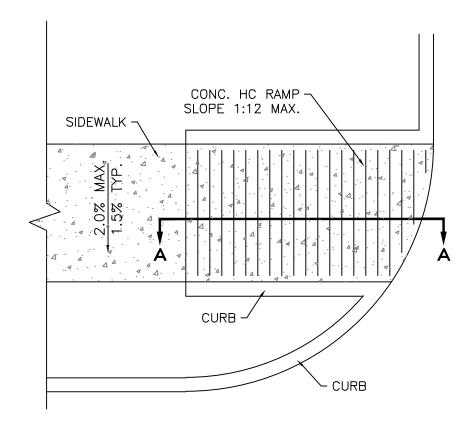

NOTES:

- 1. THE SURFACE OF RAMP AND SIDES SHALL HAVE A TRANSVERSE BROOMED SURFACE TEXTURE ROUGHER THAN THE SURROUNDING SIDEWALK.
- 2. THE RAMP SHALL BE GROOVED IN A TRANSVERSE PATTERN WITH 1/4" GROOVES APPROXIMATELY 1-1/2" O.C. SEE SECTION
- 3. THE BOTTOM OF THE RAMP SHALL HAVE A 1/4" LIP OF 45°.
- 4. RAMP SIDE SLOPE VARIES UNIFORMLY FROM A MAXIMUM OF UP TO 10% AT CURB TO CONFORM WITH LONGITUDINAL SIDEWALK SLOPE ADJACENT TO TOP OF THE RAMP.
- 5. CONSTRUCT PER A.D.A. STANDARDS.

PLAN

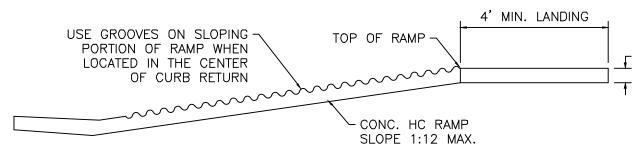

SECTION A-A


UNIDIRECTIONAL HC RAMP PER COA 2443

SCALE: NTS




LIGHT DETAIL

ENGINEER'S SEAL	ANDRETTI'S RACING ALBUQUERQUE, NM	<i>DRAWN BY</i> JL
ON MEXICO Z	,	<i>DATE</i> 6–8–22
(((7868))	DETAIL SHEET	DRAWING
PROPERTY OF THE PROPERTY OF TH		SHEET #
4/5/2023	TIERRA WEST, LLC 5571 MIDWAY PARK PL NE ALBUQUERQUE, NEW MEXICO 87109	DET-2
RONALD R. BOHANNAN P.E. #7868	(505) 858-3100 www.tierrawestllc.com	<i>JOB #</i> 2022011

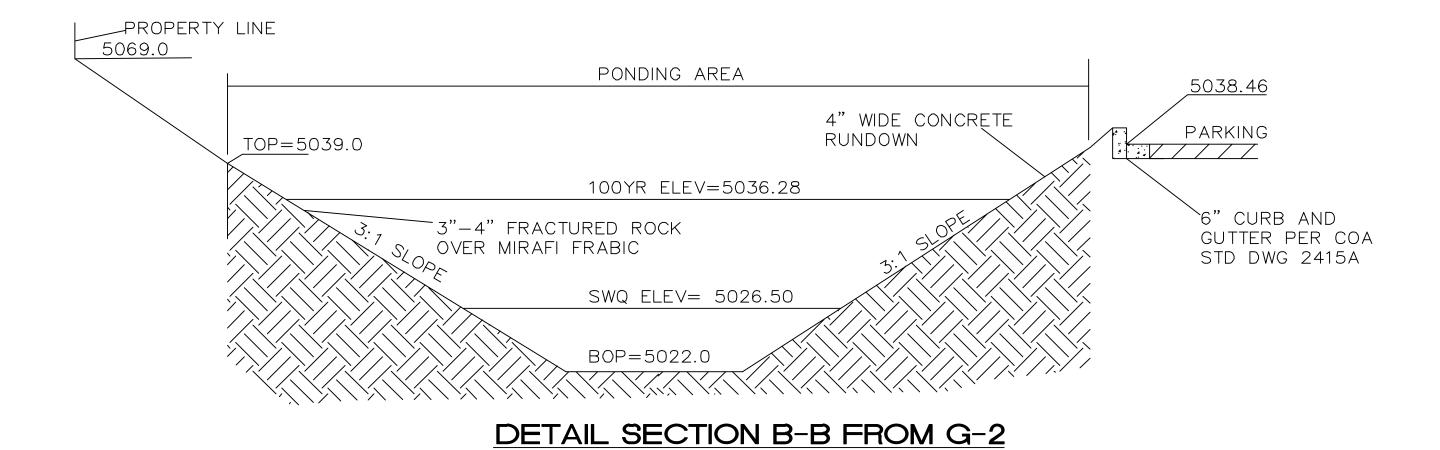


NOTE:

SIDE SLOPES NEED TO BE STABILIZED WITH NATIVE GRASS SEED (PER CITY SPEC 1012) WITH AGGREGATE MULCH OR EQUAL (MUST SATISFY THE "FINAL STABILIZATION CRITERIA" CGP2.214.b.)

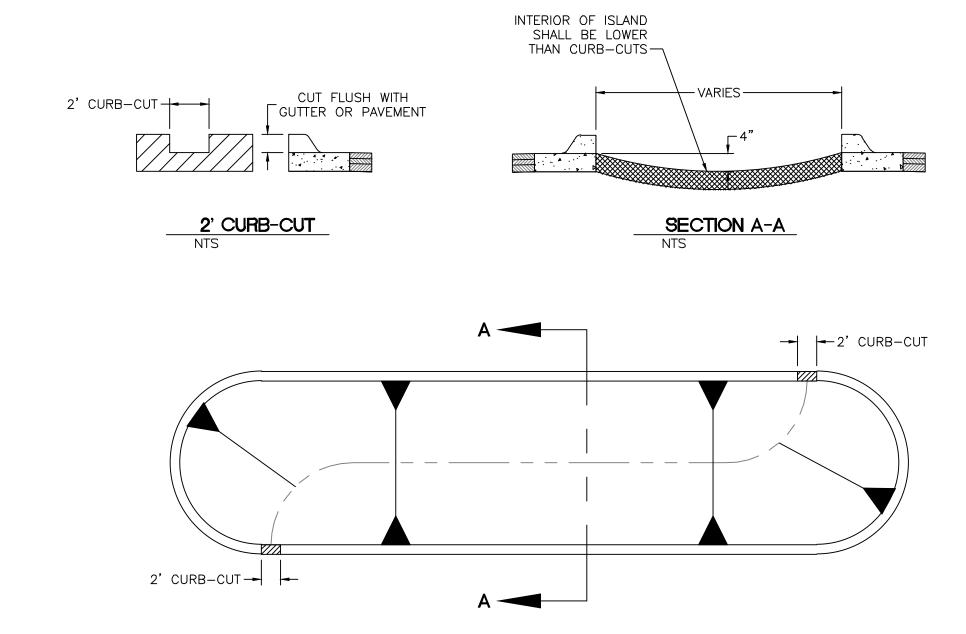


LANDSCAPE ISLAND WATER HARVESTING DETAIL
BUILD ISLAND GEOMETRY PER SITE AND GRADING PLAN

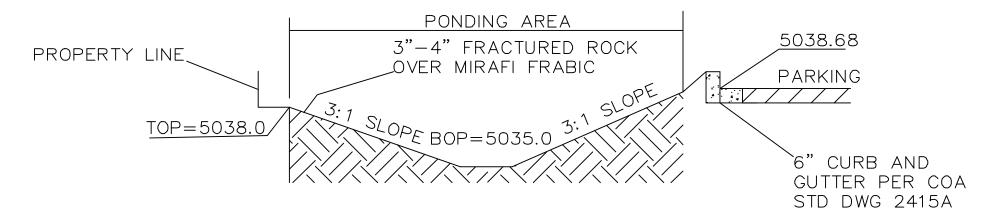

DETAIL SECTION A-A FROM G-2

NOTE:

SIDE SLOPES NEED TO BE STABILIZED WITH NATIVE GRASS SEED (PER CITY SPEC 1012) WITH AGGREGATE MULCH OR EQUAL (MUST SATISFY THE "FINAL STABILIZATION CRITERIA" CGP2.214.b.)

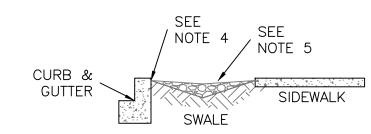



LANDSCAPE BUFFER SWALE


LANDSCAPE BUFFER SWALE NOTES:


- 1. SWALE TO HAVE SIDE SLOPES OF 5:1 (H:V)
- FOR WIDE LANDSCAPE BUFFERS, GREATER THAN 10 FEET, THE MAXIMUM DEPTH IS 10 INCHES.
- 3. LANDSCAPE BUFFERS 2 FEET AND LESS IN WIDTH ARE EXCLUDED.
- 4. FINAL GRADE OF DIRT TO BE 1 TO 2 INCHES BELOW TOP OF CURB AND TOP OF SIDEWALK GRADE.
- 5. SURFACE BETWEEN BACK OF CURB AND SIDEWALK TO BE COVERED WITH GRAVEL MULCH (MINIMUM3/4") COBBLE OR RIP—RIP. DO NOT FILL ENTIRE SWALE.
- 6. A CHECK DAM WILL BE REQUIRED FOR SWALES ON STEEPER LONGITUDINAL SLOPES, 2.5% AND GREATER, AND LONGER SECTIONS. THE ENGINEER WILL DETERMINE THE LOCATION.
- 7. LANDSCAPE FABRIC IS RECOMMENDED, BUT NOT REQUIRED, BETWEEN THE DIRT AND THE STONE. IF LANDSCAPE FABRIC IS TO BE USED IT IS TO BE PERMEABLE.
- 8. IN THE CASE WHERE THE SIDEWALK IS EXISTING AND THE LANDSCAPE BUFFER IS IMPROVED WITH LANDSCAPING AND/OR SOME FORM OF EROSION PROTECTION, THIS REQUIREMENT DOES NOT APPLY.


ENGINEER'S SEAL	ANDRETTI'S RACING ALBUQUERQUE, NM	<i>DRAWN BY</i> JL
DR. BOHANA W MEXICO Z	DETAIL SHEET	<i>DATE</i> 6-8-22
(((7868)))		DRAWING
The Committee of the Co		SHEET #
4/5/2023	TIERRA WEST, LLC 5571 MIDWAY PARK PL NE ALBUQUERQUE, NEW MEXICO 87109	DET-3
RONALD R. BOHANNAN P.E. #7868	(505) 858—3100 www.tierrawestllc.com	<i>JOB #</i> 2022011

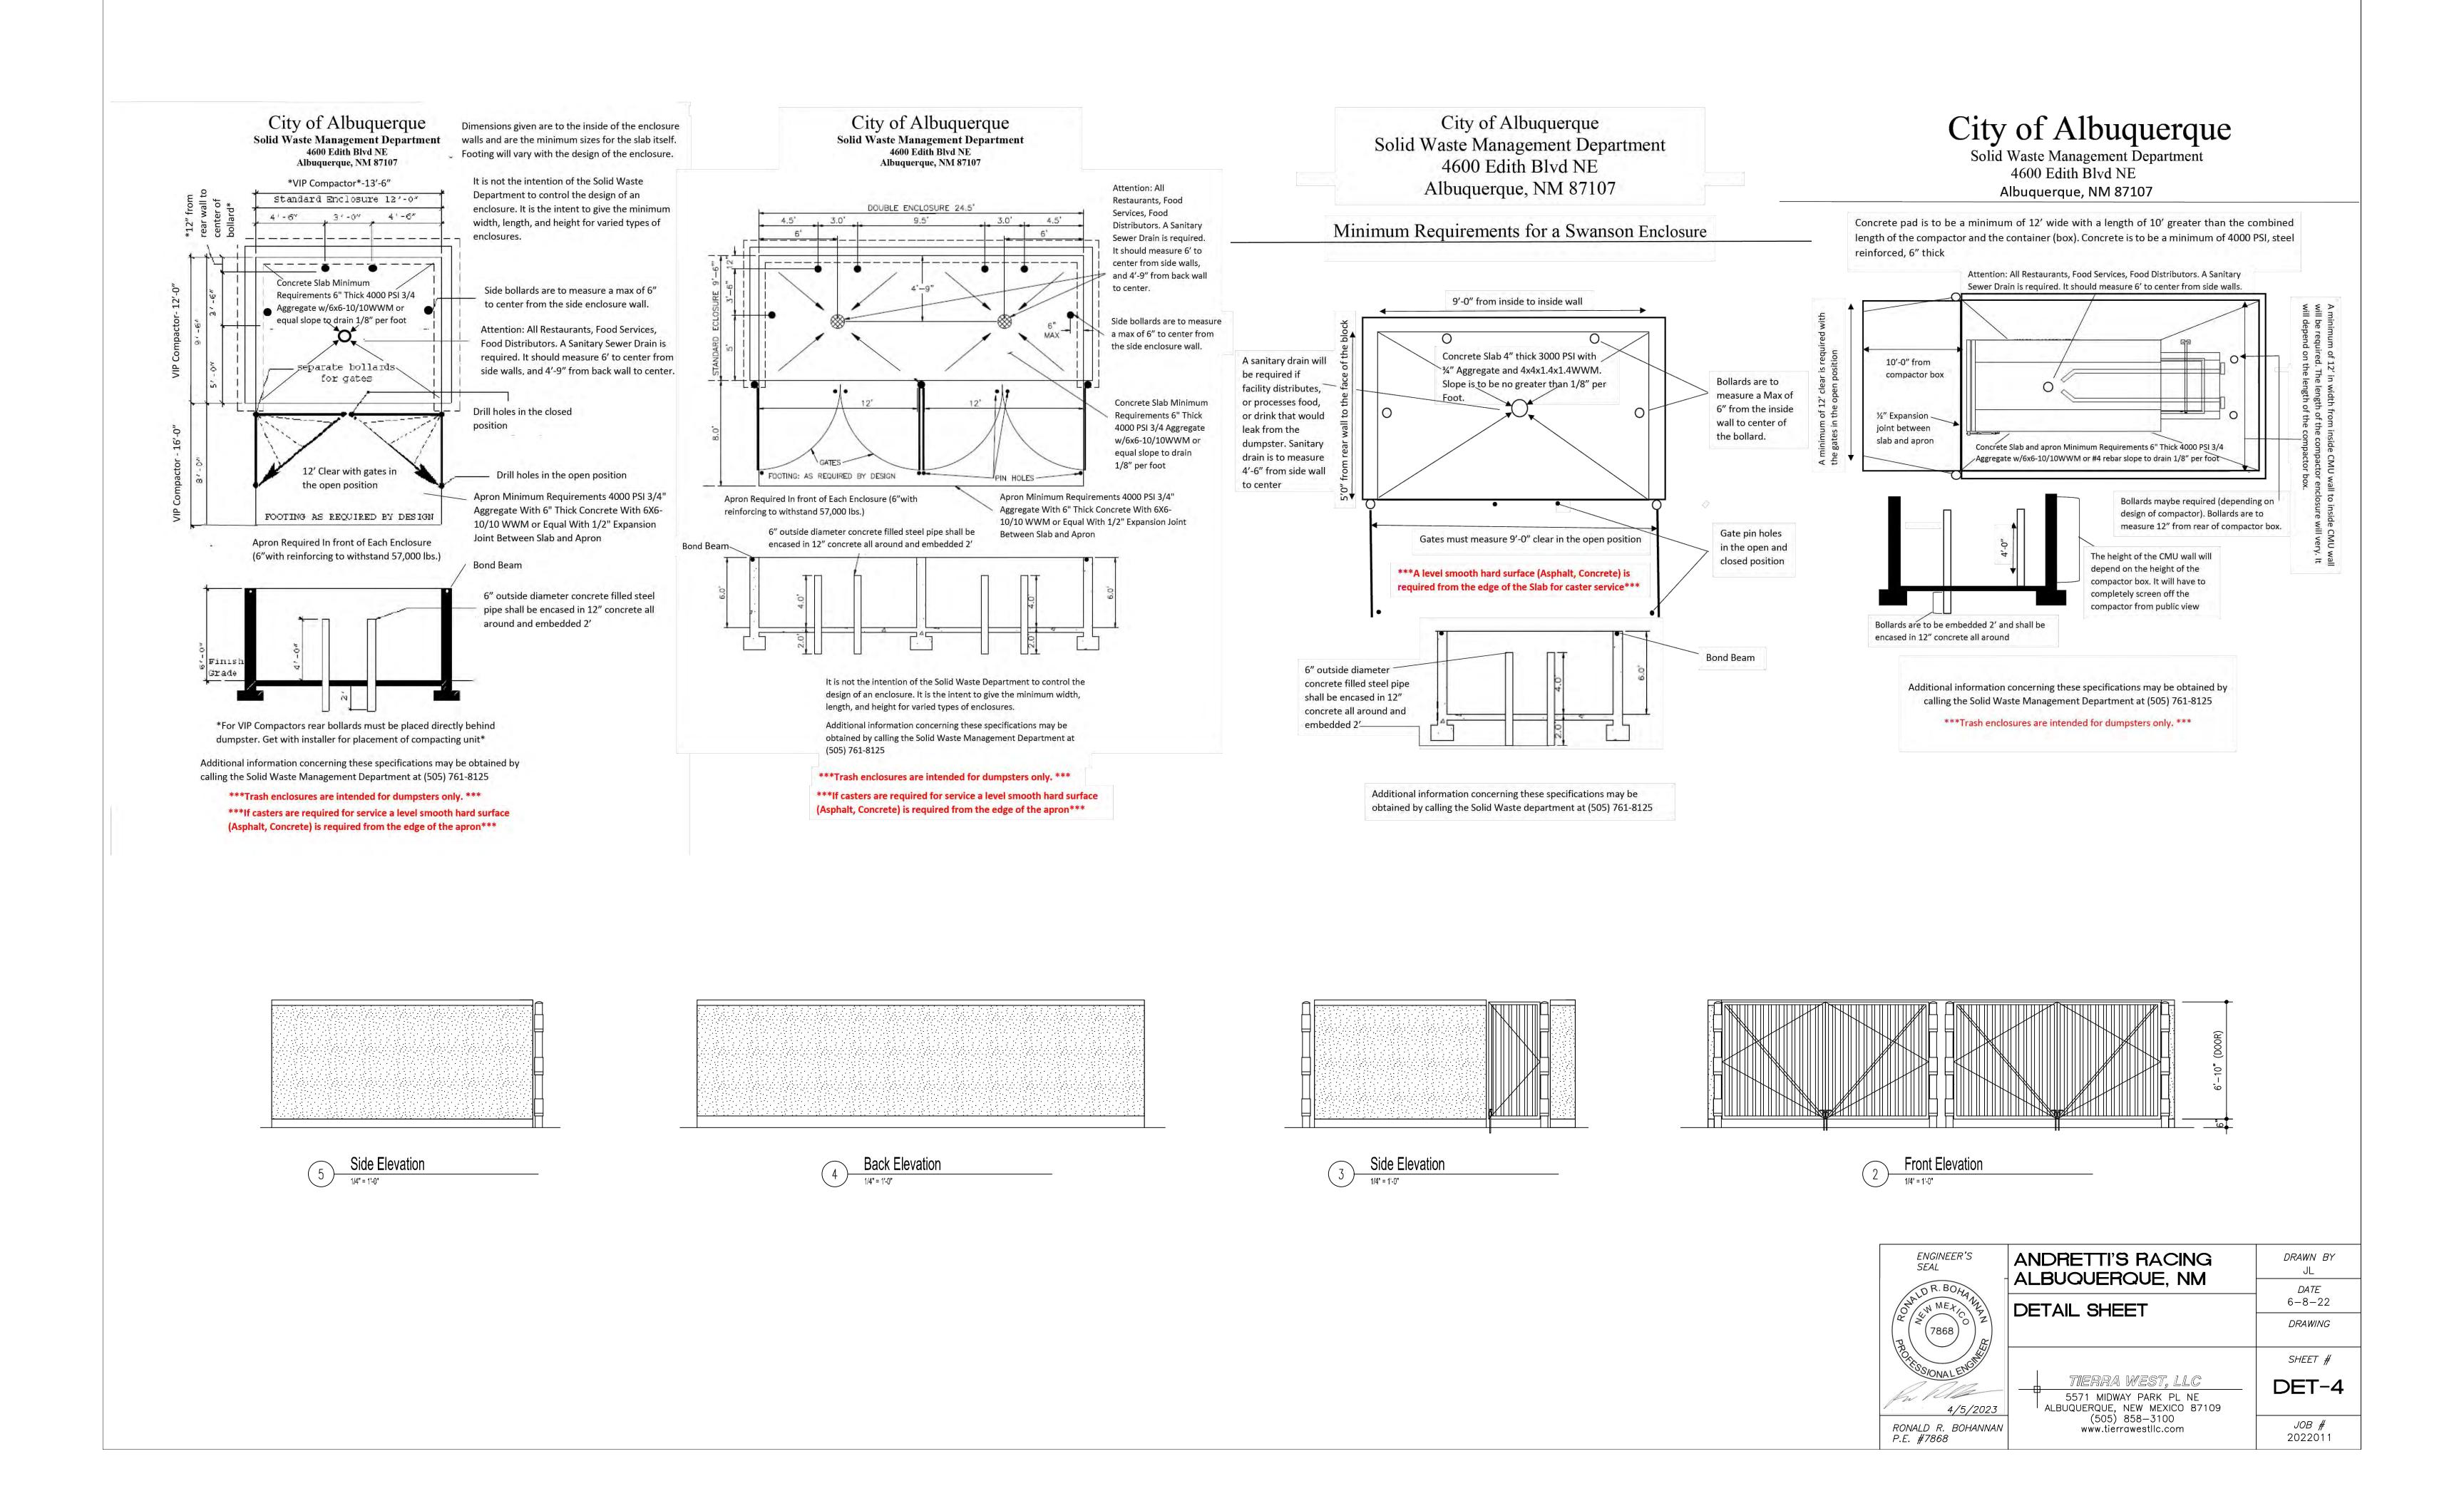

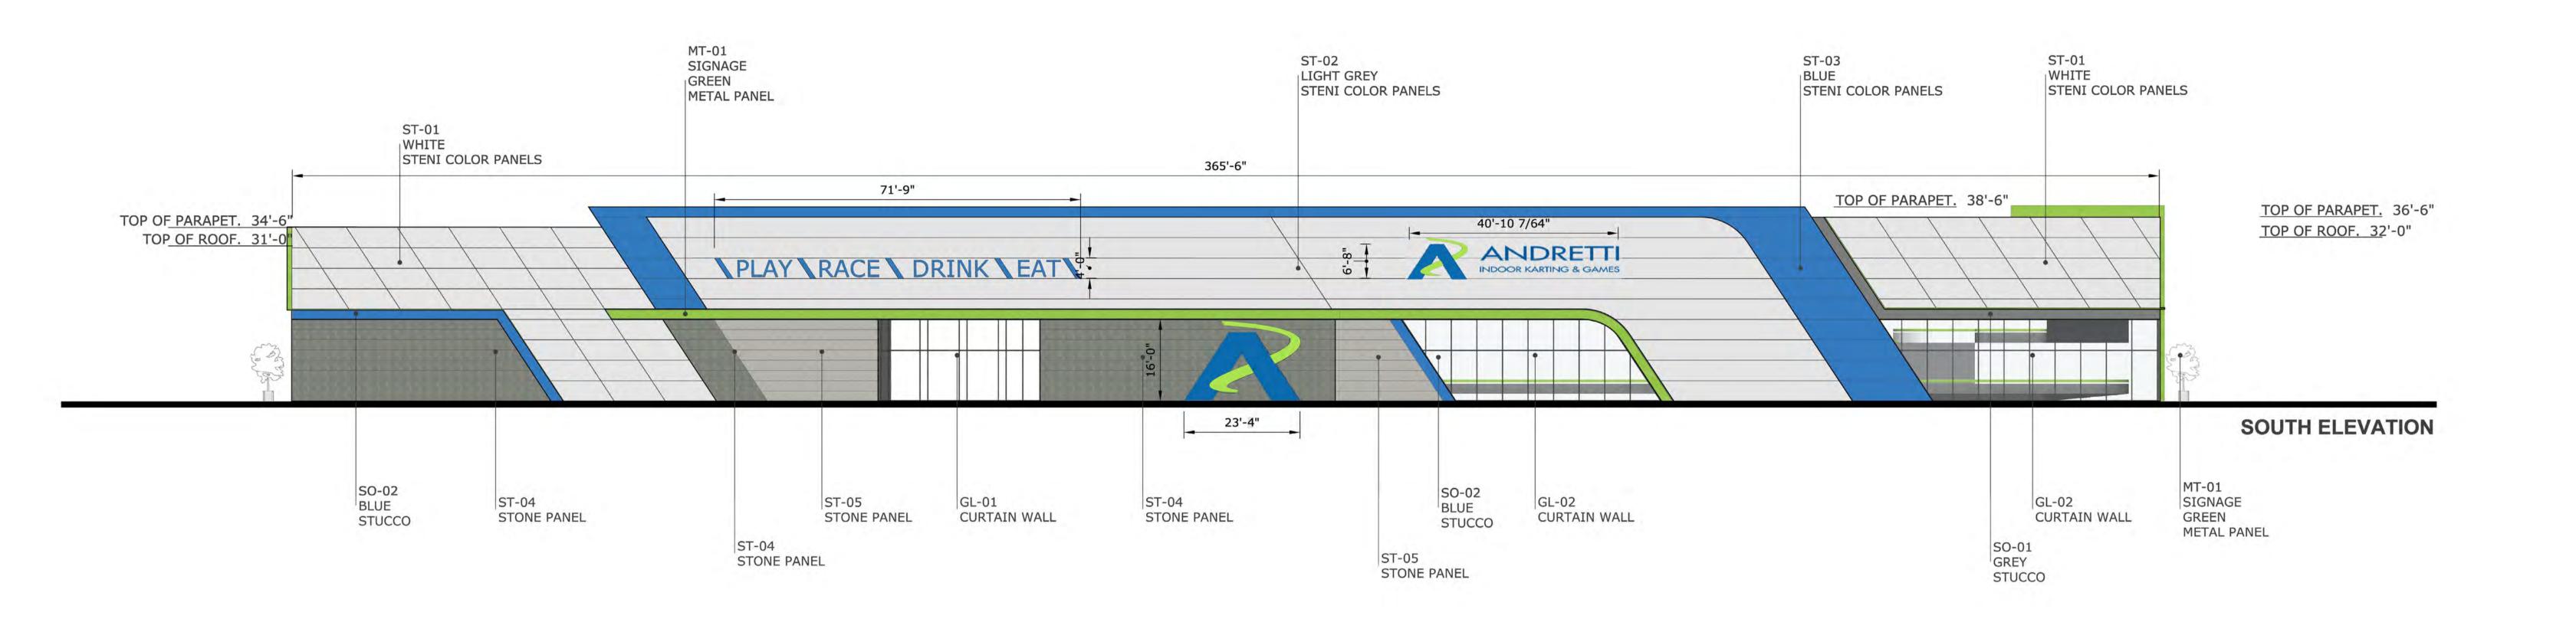

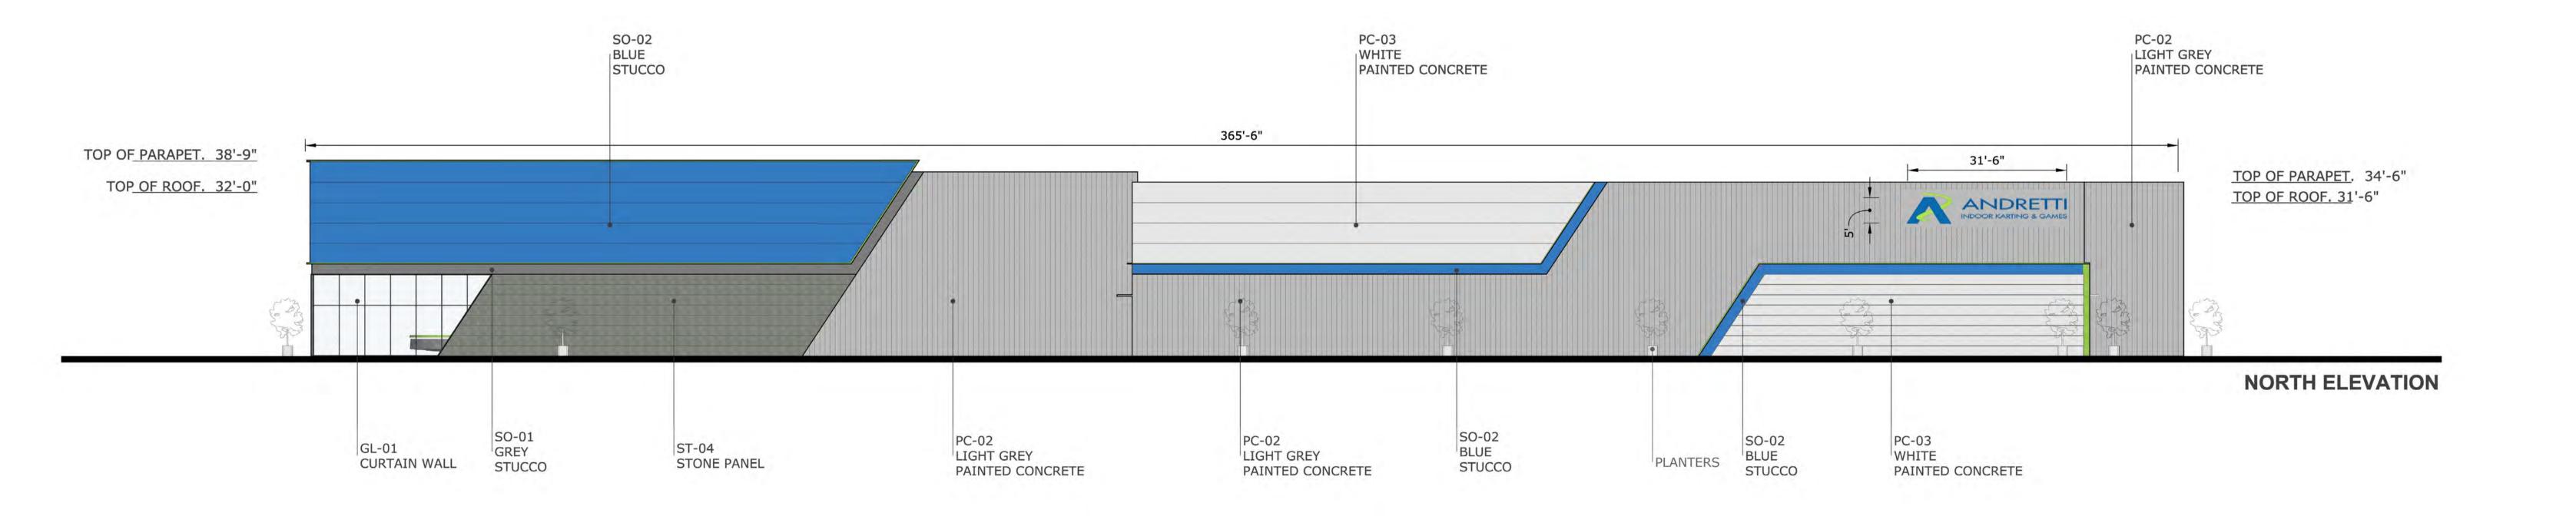

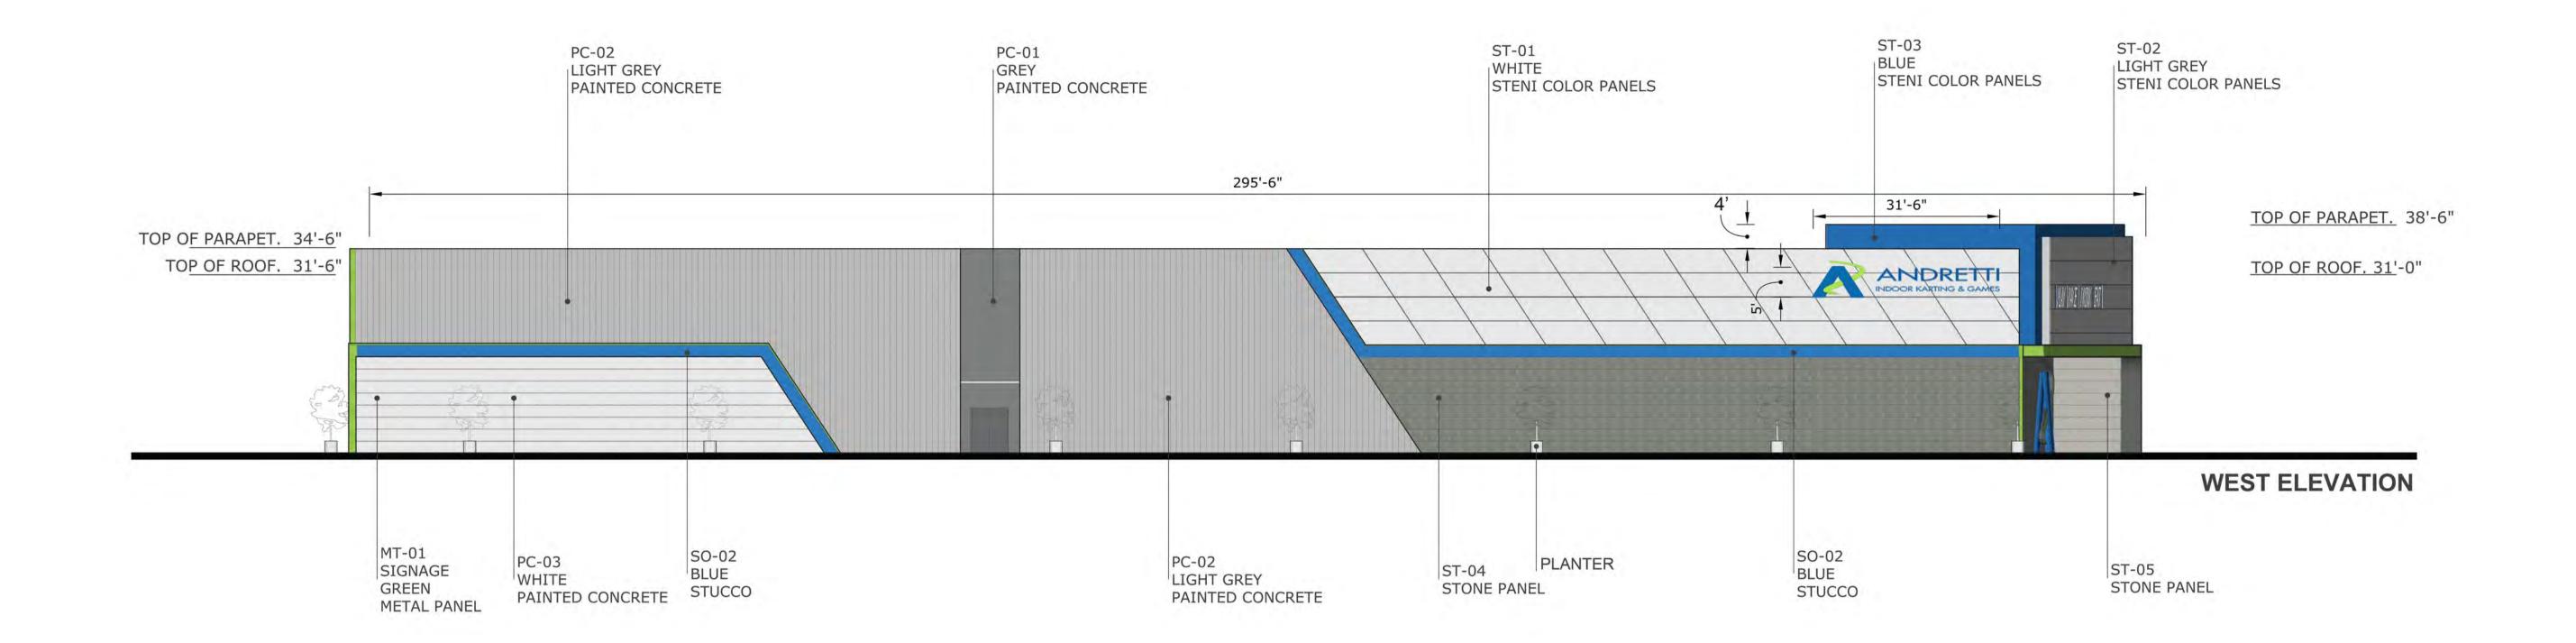

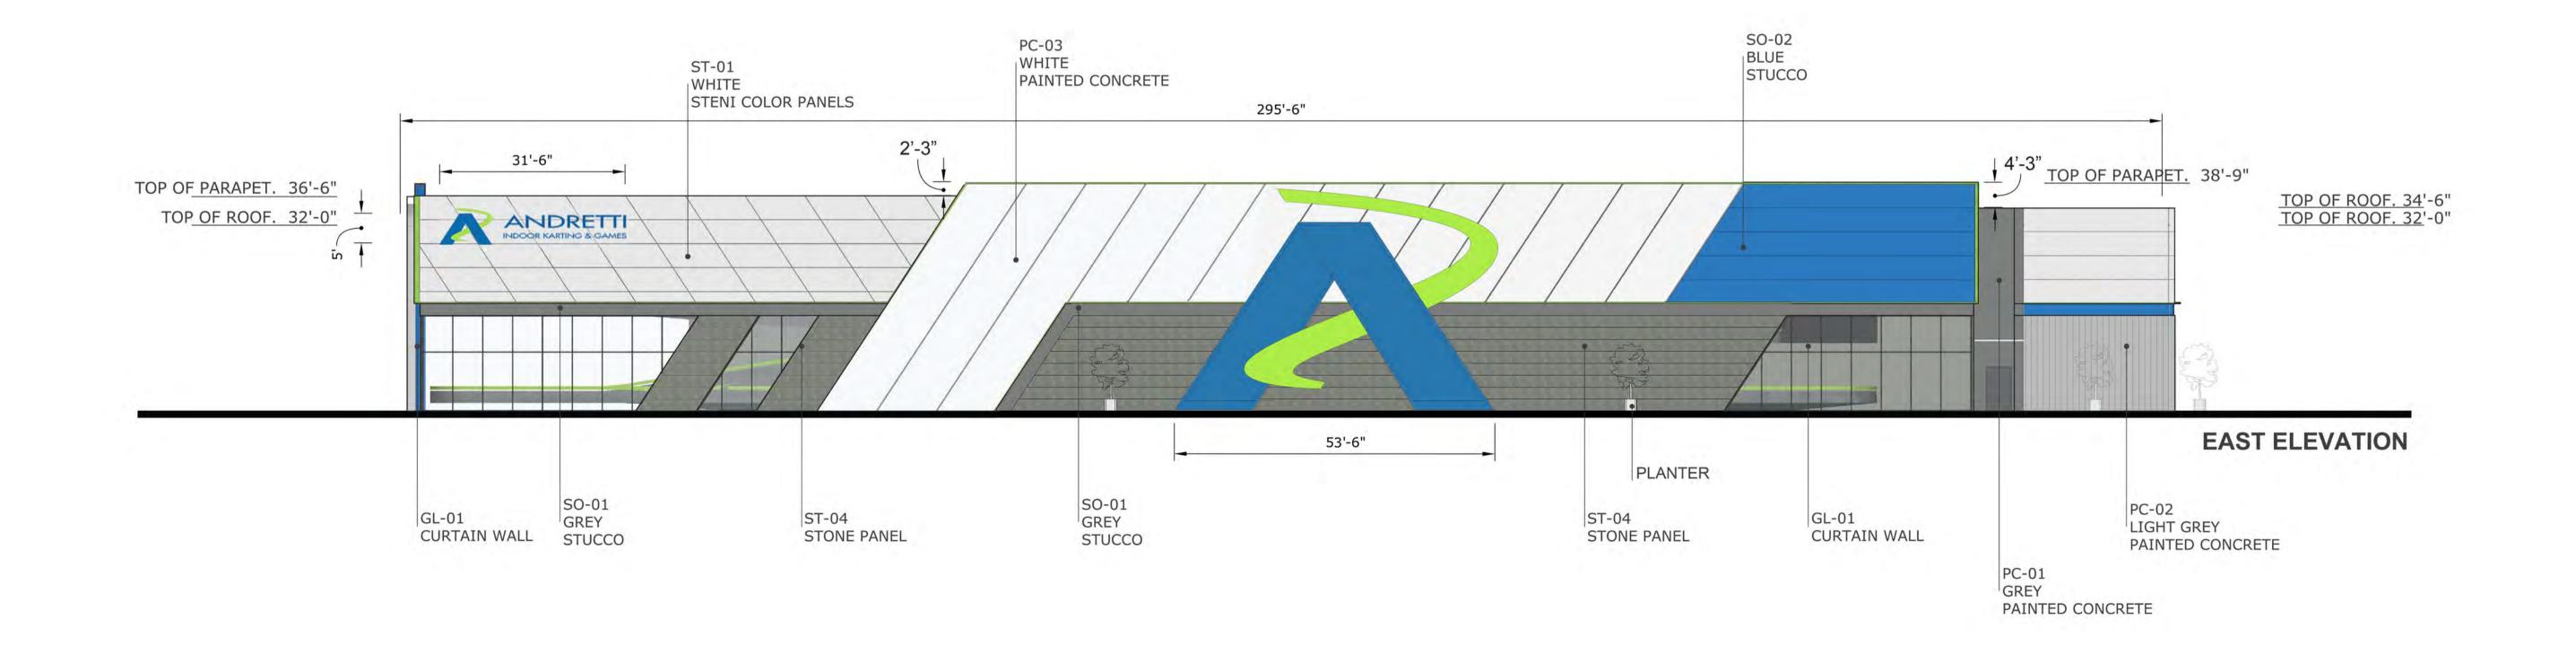





ALBUQUERQUE, NM

EXTERIOR SIGNAGE

ORIG. DATE - 10.06.2022

220P7483-7



This sign is intended to be installed in accordance with the requirements of Article 600 of the National Electrical Code and/or other applicable local codes. This includes proper grounding and bonding of the sign. Dimensions are approximate & may change due to construction factors or exact field conditions. Color shown are as close as printing will allow; Always follow written specifications. All rights reserved: This design has been created for you in connection with a project being planned for you by SSC Signs & Lighting. It may not be reproduced in any manner without prior consent.

SITE MAP

SIGN SCHEDULE			
LOCATION	QTY	ITEM DESCRIPTION	
001	1	LOGO & CHANNEL LETTERS	
002	1	LOGO CABINET	
003	1	CHANNEL LETTERS	
004	3	LOGO & CHANNEL LETTERS	
005	-	LOGO CABINET	
006	-	COVE CHANNEL	





CLIENT

Andretti Indoor Carting & Games

ADDRESS
Albuquerque, NM

DATE 10.06.22
DESIGNER - GO
DRAWING NO.
220P7483-7


I	REVISION	DATE
I	<u>1. AM</u> 1	0.10.22
I	2. REDUCE SIGN #5	
ı	OAH	AM
I	3. GROW SIGN #5	10.21.22
I	OAH	AM
I	4. ADD CROSS	10.25.22
I	SECTION DETAILS	AM
I	5. ADD CROSS	10.27.22
ı	SECTION DETAILS	AM
ı	6. CORRECTED SIZE OF	3.28.23
I	005 ON PAGES 6 & 11	DAA
ı	7. ADDED SQ FT TO	4.25.23
ı	ELEVATIONS	DAA

APPROVAL DATE -

APPROVED BY -

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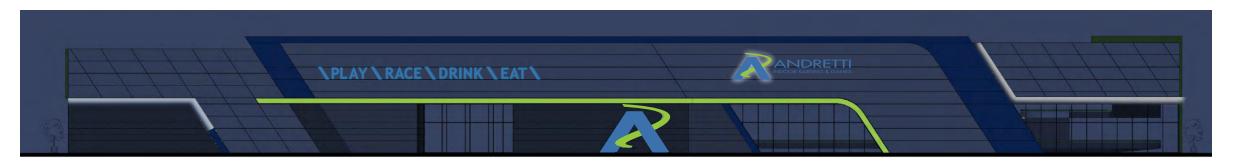
PAGE 2 OF 13

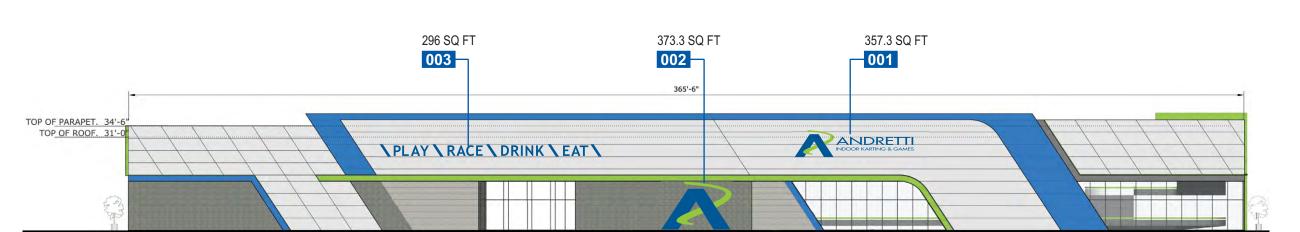

34'-6""H x 365'-6" Elevation Area 14,071.75 SQ FT Elevation Area 15% of Elevation Area = 2110.76 Sq Ft Allowed Signage

SOUTH ELEVATION

SCALE: 1/32" = 1'-0"



NIGHT SIMULATION



CLIENT

Andretti Indoor Carting & Games

ADDRESSAlbuquerque, NM

DATE 10.06.22 DESIGNER - GO DRAWING NO. 22OP7483-7

REVISION	DATE
<u>1. AM</u> 1	0.10.22
2. REDUCE SIGN #5 OAH	10.18.22 AM
3. GROW SIGN #5 OAH	10.21.22 AM
4. ADD CROSS SECTION DETAILS	10.25.22 AM
5. ADD CROSS SECTION DETAILS	10.27.22 AM
6. CORRECTED SIZE OF 005 ON PAGES 6 & 11	
7. ADDED SQ FT TO ELEVATIONS	4.25.23 DAA


APPROVAL DATE -

APPROVED BY -

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PAGE 3 OF 13



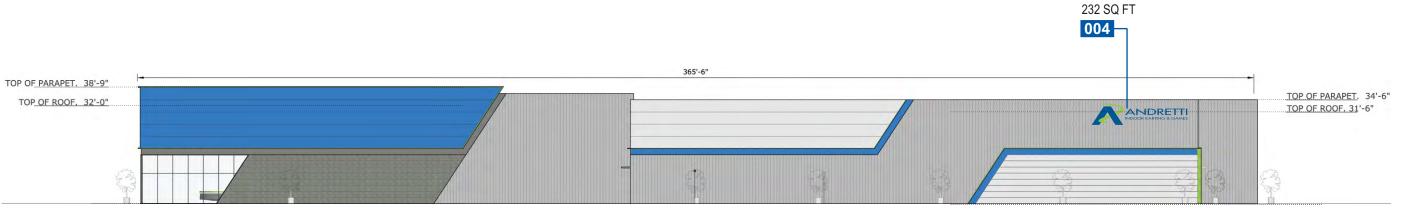

38'-9"H x 365'-6" Elevation Area 14,163.13 SQ FT Elevation Area 15% of Elevation Area = 2124.46 Sq Ft Allowed Signage

NORTH ELEVATION

SCALE: 1/32" = 1'-0"



NIGHT SIMULATION

CLIENT

Andretti Indoor Carting & Games

ADDRESSAlbuquerque, NM

DATE 10.06.22 DESIGNER - GO DRAWING NO. 22OP7483-7

REVISION	DATE
<u>1. AM</u> 1	0.10.22
2. REDUCE SIGN #5 OAH	10.18.22 AM
3. GROW SIGN #5 OAH	10.21.22 AM
4. ADD CROSS SECTION DETAILS	10.25.22 AM
5. ADD CROSS SECTION DETAILS	10.27.22 AM
6. CORRECTED SIZE OF 005 ON PAGES 6 & 11	3.28.23 DAA
7. ADDED SQ FT TO ELEVATIONS	4.25.23 DAA


APPROVAL DATE -

APPROVED BY -

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PAGE 4 OF 13



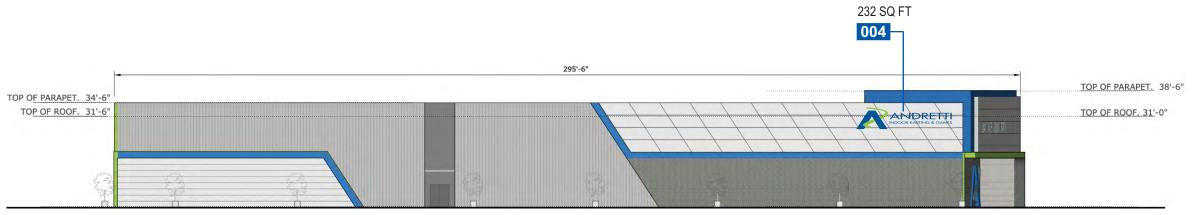

34'-6"H x 295'-6" Elevation Area 10,194.75 SQ FT Elevation Area 15% of Elevation Area = 1529.21 Sq Ft Allowed Signage

WEST ELEVATION

SCALE: 1/32" = 1'-0"



CLIENT

Andretti Indoor Carting & Games

ADDRESSAlbuquerque, NM

DATE 10.06.22 DESIGNER - GO DRAWING NO. 22OP7483-7


REVISION	DATE
<u>1. AM</u>	10.10.22
2. REDUCE SIGN #5 OAH	10.18.22 AN
3. GROW SIGN #5 OAH	10.21.22 AN
4. ADD CROSS SECTION DETAILS	10.25.22 AN
5. ADD CROSS SECTION DETAILS	10.27.22 AN
6. CORRECTED SIZE OF 005 ON PAGES 6 & 11	
7. ADDED SQ FT TO ELEVATIONS	4.25.23 DAA

APPROVAL DATE -

APPROVED BY -

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PAGE 5 OF 13

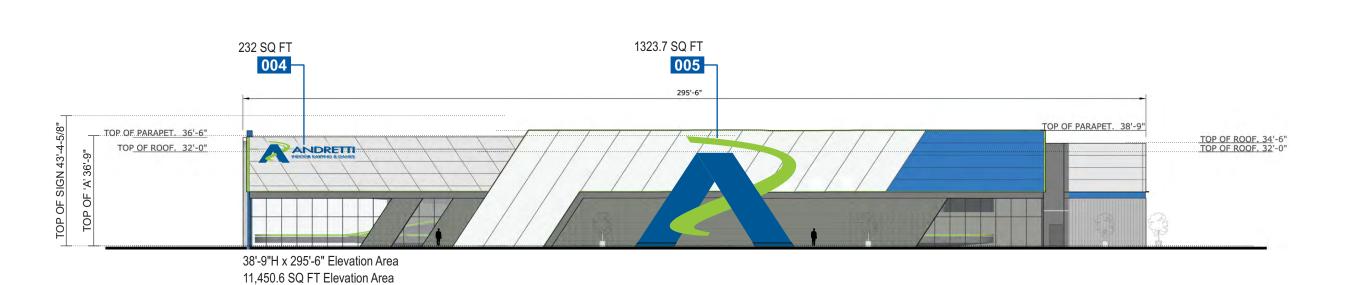

EAST ELEVATION

SCALE: 1/32" = 1'-0"



NIGHT SIMULATION

15% of Elevation Area = 1,717.59 Sq Ft Allowed Signage



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Andretti Indoor Carting & Games

ADDRESSAlbuquerque, NM

DATE 10.06.22 DESIGNER - GO DRAWING NO. 22OP7483-7

REVISION	DATE
<u>1. AM</u> 1	0.10.22
2. REDUCE SIGN #5 OAH	10.18.22 AM
3. GROW SIGN #5 OAH	
4. ADD CROSS SECTION DETAILS	10.25.22 AM
5. ADD CROSS SECTION DETAILS	10.27.22 AM
6. CORRECTED SIZE OF 005 ON PAGES 6 & 11	3.28.23 DAA
7. ADDED SQ FT TO ELEVATIONS	4.25.23 DAA

APPROVAL DATE -

APPROVED BY -

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PAGE 6 OF 13




357.3 SQ. FT.

FACE & HALO-LIT LOGO / FACE-LIT CHANNEL LETTERS

SCALE: 3/16" = 1'-0"

QTY. 1

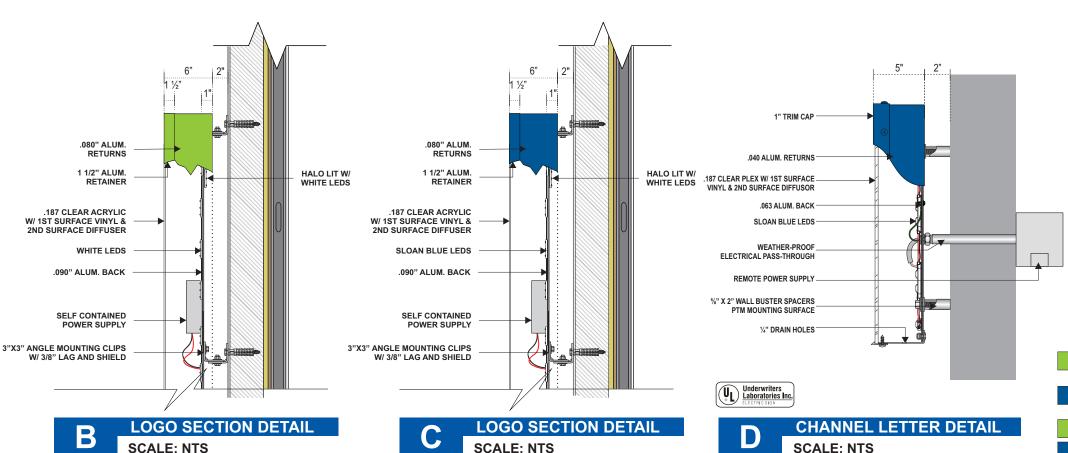

SPECIFICATIONS

1. FABRICATED FACE & HALO LIT CHANNEL LOGO W/ 6" DEEP RETURNS TO BE .080" ALUMINUM & 1 1/2" ALUM. RETAINER. BACK TO BE .090" ALUMINUM BACK STEPPED 1" TO PROVIDE HALO LIT EFFECT. FACE LIT W/ "A" SLOAN BLUE (701269-BLSJ1-MB) LEDS & EVERYLITE 3D 6500 WHITE LEDS; "CURVED GRAPHIC" TO BE ILLUMINATED W/ EVERYLITE 3D 6500 WHITE LEDS. HALO LIT W/ EVERYLITE 3D 6500 WHITE LEDS. SELF CONTAINED POWER SUPPLY AS REQUIRED PER ILLUMINATION.

RETURNS & INTERIORS PAINTED TO MATCH GREEN SW 6921 ELECTRIC LIME AND BLUE SW 6966 BLUEBLOOD.

2. "A" TO BE .187 CLEAR PLEX FACE WITH FIRST SURFACE VINYL TO MATCH 3M 3730-157L SULTAN BLUE & SECOND SURFACE 70% WHITE DIFFUSER.

NOTE: LOGO FACE TO BE ONE PIECE OF ACRYLIC, NO SEAMS

3. "CURVED GRAPHIC" FACE TO BE .187 CLEAR PLEX FACE WITH FIRST SURFACE VINYL TO MATCH 3M 3730-106L BRILLIANT GREEN & SECOND SURFACE 70% WHITE DIFFUSER .

MOUNTED USING 3"X3" ANGLE CLIPS WITH 3/8" LAG BOLTS AND SHIELDS

- 4. 5" DEEP FABRICATED ALUMINUM CHANNEL LETTERS. .040 ALUM. RETURNS AND .063 ALUM BACK. BLUE SW 6966 BLUEBLOOD. 1" TRIM CAP PAINTED TO MATCH BLUE SW 6966 BLUEBLOOD. INTERNALLY LIT WITH SLOAN BLUE (701269-BLSJ1-MB) LEDS.
- 5. .187" CLEAR PLEX FACE WITH FIRST SURFACE VINYL 3M 3730-157L SULTAN BLUE & SECOND SURFACE VINYL DIFFUSER 70% WHITE.
- 6. CHANNEL LETTERS MOUNTED WITH MECHANICAL FASTENERS AND 2" SPACERS. SPACERS PAINTED TO MATCH BUILDING EXTERIOR.

- P1 - PAINT TO MATCH GREEN SW 6921 ELECTRIC LIME

- P2 - PAINT TO MATCH BLUE SW 6966 BLUEBLOOD.

- V1 - VINYL TO MATCH 3M BRILLIANT GREEN 3730-106L

- V2 - VINYL TO MATCH SULTAN BLUE 3730-157L

- V3 - VINYL TO BE DIFFUSER 70% WHITE

- PAINTED TO MATCH BUILDING EXTERIOR

SSSC SIGNS&LIGHTING 972,219,2495

CLIENT

Andretti Indoor Carting & Games

ADDRESSAlbuquerque, NM

DATE 10.06.22
DESIGNER - GO
DRAWING NO.
220P7483-7


REVISION	DATE
<u>1. AM</u> 1	0.10.22
2. REDUCE SIGN #5 OAH	10.18.22 AM
3. GROW SIGN #5 OAH	10.21.22 AM
4. ADD CROSS	10.25.22
SECTION DETAILS	AM
5. ADD CROSS	10.27.22
SECTION DETAILS	AM
6. CORRECTED SIZE OF	3.28.23
005 ON PAGES 6 & 11	DAA
7. ADDED SQ FT TO	4.25.23
ELEVATIONS	DAA

APPROVAL DATE -

APPROVED BY -

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PAGE 7 OF 13

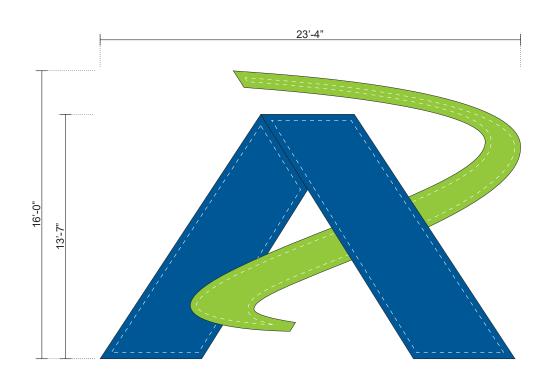


373.3 SQ. FT.


nno iclh.01 - face & halo lit logo cabinet

SCALE: 3/16" = 1'-0"

QTY (1)

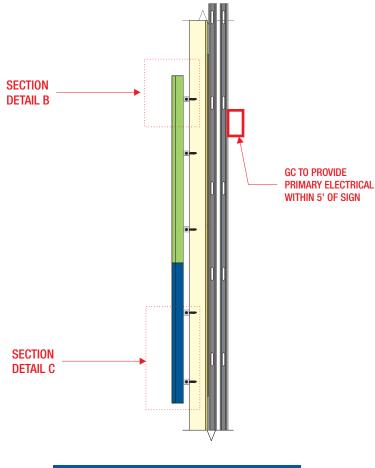



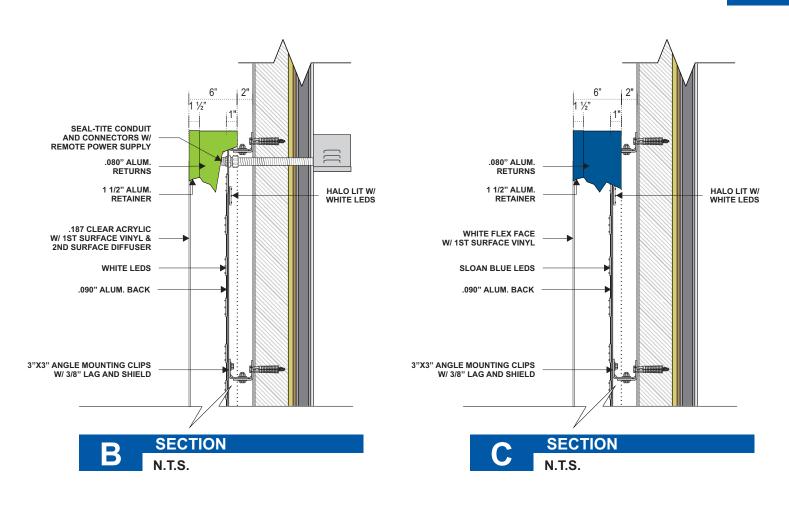

SPECIFICATIONS

1. FABRICATED FACE & HALO LIT CHANNEL LOGO W/ 6" DEEP RETURNS TO BE .080" ALUMINUM & 1 1/2" ALUM. RETAINER. BACK TO BE .090" ALUMINUM BACK STEPPED 1" TO PROVIDE HALO LIT EFFECT. FACE LIT W/ "A" SLOAN BLUE (701269-BLSJ1-MB) LEDS & EVERYLITE 3D 6500 WHITE LEDS; "CURVED GRAPHIC" TO BE ILLUMINATED W/ EVERYLITE 3D 6500 WHITE LEDS. HALO LIT W/ EVERYLITE 3D 6500 WHITE LEDS. REMOTE POWER SUPPLY AS REQUIRED PER ILLUMINATION.

RETURNS & INTERIORS PAINTED TO MATCH GREEN SW 6921 ELECTRIC LIME AND BLUE SW 6966 BLUEBLOOD.

2. "A" TO BE WHITE FLEX FACE WITH FIRST SURFACE VINYL TO MATCH 3M 3730-157L SULTAN BLUE.

"CURVED GRAPHIC" FACE TO BE .187 CLEAR PLEX FACE WITH FIRST SURFACE VINYL TO MATCH 3M 3730-106L BRILLIANT GREEN & SECOND SURFACE 70% WHITE DIFFUSER.

3. MOUNTED USING 3"X3" ANGLE CLIPS WITH 3/8" LAG BOLTS AND SHIELDS

4. ELECTRICAL CONDUITS BRIDGED INTO TOP GREEN SIGN SECTION. EXTERIOR POWER WIREWAYS ON PARAPHET WALL ABOVE ROOF MEMBRANE,

- P1 - PAINT TO MATCH GREEN SW 6921

- P2 - PAINT TO MATCH BLUE SW 6966

- V1 - VINYL TO MATCH 3M BRILLIANT GREEN 3730-106L

- V2 - VINYL TO MATCH SULTAN BLUE 3730-157L

- V3 - VINYL TO BE DIFFUSER 70% WHITE

ELECTRIC LIME

BLUEBLOOD.



CLIENT

Andretti Indoor Carting & Games

ADDRESS
Albuquerque, NM

DATE 10.06.22 DESIGNER - GO DRAWING NO. 22OP7483-7

REVISION	DATE
<u>1. AM</u> 1	0.10.22
2. REDUCE SIGN #5 OAH	10.18.22 AN
3. GROW SIGN #5 OAH	10.21.22 AN
4. ADD CROSS SECTION DETAILS	10.25.22 AN
5. ADD CROSS	10.27.22
SECTION DETAILS	AN
6. CORRECTED SIZE OF	3.28.23
005 ON PAGES 6 & 11	DAA
7. ADDED SQ FT TO	4.25.23
ELEVATIONS	DAA

APPROVAL DATE -

APPROVED BY -

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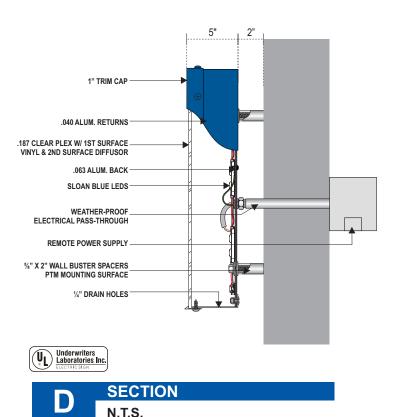
PAGE 8 OF 13

\PLAY\RACE\DRINK\EAT\

FACE-LIT CHANNEL LETTERS

SCALE: 1/8" = 1'-0"

QTY. 1



SPECIFICATIONS

- 1. 5" DEEP FABRICATED ALUMINUM CHANNEL LETTERS. .040 ALUM. RETURNS P.T.M. SW 6966 BLUEBLOOD. 1" TRIM CAP PAINTED TO MATCH RETURNS. INTERNALLY LIT WITH SLOAN BLUE (701269-BLSJ1-MB) LEDS.
- 2. .187" CLEAR PLEX FACE WITH FIRST SURFACE VINYL 3M 3730-157L SULTAN BLUE & SECOND SURFACE VINYL DIFFUSER 70% WHITE.
- 3. MOUNTED WITH MECHANICAL FASTENERS AND 2" SPACERS. SPACERS PAINTED TO MATCH BUILDING EXTERIOR.

- P2 - PAINT TO MATCH BLUE SW 6966

- V2 - VINYL TO MATCH SULTAN BLUE 3730-157L

- V3 - VINYL TO BE DIFFUSER 70% WHITE

- PAINTED TO MATCH BUILDING EXTERIOR

BLUEBLOOD.



CLIENT

Andretti Indoor Carting & Games

ADDRESS

Albuquerque, NM

DATE 10.06.22 DESIGNER - GO DRAWING NO. 22OP7483-7

REVISION	DATE
<u>1. AM</u> 1	0.10.22
2. REDUCE SIGN #5	10.18.22
OAH	AM
3. GROW SIGN #5	10.21.22
OAH	AM
4. ADD CROSS	10.25.22
SECTION DETAILS	AM
5. ADD CROSS	10.27.22
SECTION DETAILS	AM
6. CORRECTED SIZE OF	3.28.23
005 ON PAGES 6 & 11	DAA
7. ADDED SQ FT TO	4.25.23
ELEVATIONS	DAA

APPROVAL DATE -

APPROVED BY -

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PAGE 9 OF 13




232 SQ. FT.

PACE & HALO-LIT LOGO / FACE-LIT CHANNEL LETTERS

SCALE: 3/16" = 1'-0"

QTY. 3

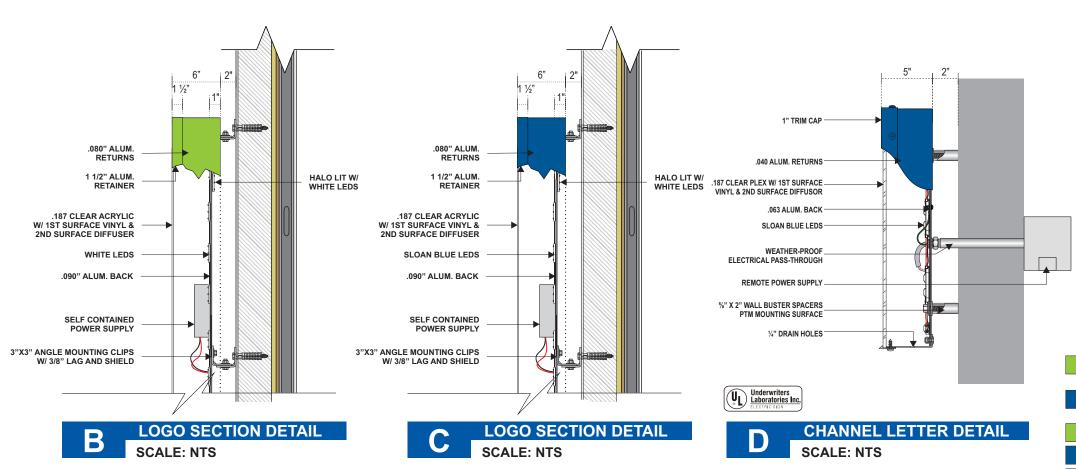

SPECIFICATIONS

1. FABRICATED FACE & HALO LIT CHANNEL LOGO W/ 6" DEEP RETURNS TO BE .080" ALUMINUM & 1 1/2" ALUM. RETAINER. BACK TO BE .090" ALUMINUM BACK STEPPED 1" TO PROVIDE HALO LIT EFFECT. FACE LIT W/ "A" SLOAN BLUE (701269-BLSJ1-MB) LEDS & EVERYLITE 3D 6500 WHITE LEDS; "CURVED GRAPHIC" TO BE ILLUMINATED W/ EVERYLITE 3D 6500 WHITE LEDS. HALO LIT W/ EVERYLITE 3D 6500 WHITE LEDS. SELF CONTAINED POWER SUPPLY AS REQUIRED PER ILLUMINATION.

RETURNS & INTERIORS PAINTED TO MATCH GREEN SW 6921 ELECTRIC LIME AND BLUE SW 6966 BLUEBLOOD.

2. "A" TO BE .187 CLEAR PLEX FACE WITH FIRST SURFACE VINYL TO MATCH 3M 3730-157L SULTAN BLUE & SECOND SURFACE 70% WHITE DIFFUSER.

NOTE: LOGO FACE TO BE ONE PIECE OF ACRYLIC, NO SEAMS

3. "CURVED GRAPHIC" FACE TO BE .187 CLEAR PLEX FACE WITH FIRST SURFACE VINYL TO MATCH 3M 3730-106L BRILLIANT GREEN & SECOND SURFACE 70% WHITE DIFFUSER .

MOUNTED USING 3"X3" ANGLE CLIPS WITH 3/8" LAG BOLTS AND SHIELDS

- 4. 5" DEEP FABRICATED ALUMINUM CHANNEL LETTERS. .040 ALUM. RETURNS AND .063 ALUM BACK. BLUE SW 6966 BLUEBLOOD. 1" TRIM CAP PAINTED TO MATCH BLUE SW 6966 BLUEBLOOD. INTERNALLY LIT WITH SLOAN BLUE (701269-BLSJ1-MB) LEDS.
- 5. .187" CLEAR PLEX FACE WITH FIRST SURFACE VINYL 3M 3730-157L SULTAN BLUE & SECOND SURFACE VINYL DIFFUSER 70% WHITE.
- 6. CHANNEL LETTERS MOUNTED WITH MECHANICAL FASTENERS AND 2" SPACERS. SPACERS PAINTED TO MATCH BUILDING EXTERIOR.

- P1 - PAINT TO MATCH GREEN SW 6921 ELECTRIC LIME

- P2 - PAINT TO MATCH BLUE SW 6966 BLUEBLOOD.

- V1 - VINYL TO MATCH 3M BRILLIANT GREEN 3730-106L

- V2 - VINYL TO MATCH SULTAN BLUE 3730-157L

- V3 - VINYL TO BE DIFFUSER 70% WHITE

- PAINTED TO MATCH BUILDING EXTERIOR



CLIENT

Andretti Indoor Carting & Games

ADDRESSAlbuquerque, NM

DATE 10.06.22 DESIGNER - GO DRAWING NO. 22OP7483-7


REVISION	DATE
1. AM 1	0.10.22
2. REDUCE SIGN #5 OAH	10.18.22 AM
3. GROW SIGN #5 OAH	10.21.22 AM
4. ADD CROSS	10.25.22
SECTION DETAILS	AM
5. ADD CROSS	10.27.22
SECTION DETAILS	AM
6. CORRECTED SIZE OF	3.28.23
005 ON PAGES 6 & 11	DAA
7. ADDED SQ FT TO	4.25.23
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APPROVAL DATE -

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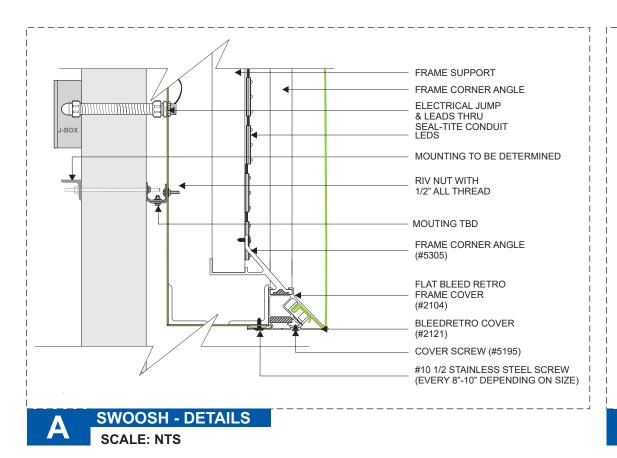



005 ILLUMINATED CUSTOM WALL SIGN

SCALE: 3/32" = 1'-0"

1323.7 SQ. FT.

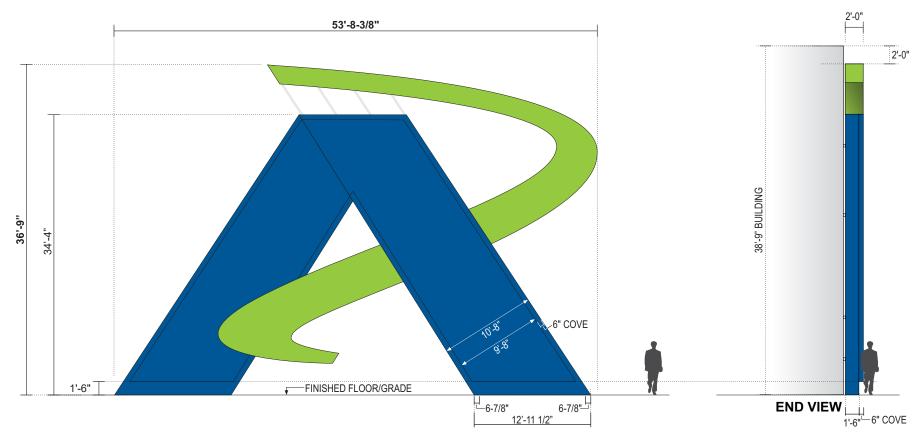QTY (1)



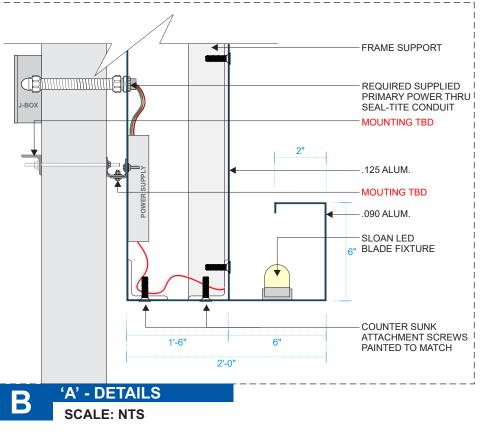

SPECIFICATIONS

1.
FABRICATED ALUMINUM SIGN CABINET
WITH 2" X 2" STACKED ALUM. SQ. TUBE
WITH A 2" X 2" STRUCTURAL SUPPORT
FRAME. SIGN COMP RETRO BLEED FRAME
#2104 AND BLEED FACE COVERS #2121.
BACK PANEL MADE USING .090 ALUM.
INTERNALLY ILLUMINATED & GRAPHIC
EVERYLITE 3D 6500 WHITE LEDS. CURVED
GRAPHIC TO BE ILLUMINATED W/
EVERYLITE 3D 6500 WHITE LEDS. SELF
CONTAINED POWER SUPPLY AS REQUIRED
PER ILLUMINATION.

BACKS, RETURNS, COVERS & SIGN INTERIORS PAINTED TO MATCH GREEN (3M VINYL 3630-136 LIME GREEN) AND BLUE (3M VINYL 3630-35 PATRIOT BLUE).

2.
"A" TO BE .125 ALUMINUM WITH PAINTED
BLUE TO MATCH "3M VINYL 3630-35 PATRIOT
BLUE" & ILLUMINATED COVE BORDER.

3.
"CURVED GRAPHIC" FACE TO BE WHITE
FLEX FACE WITH FIRST SURFACE VINYL TO
MATCH GREEN (3M VINYL 3630-136 LIME
GREEN)

MOUNTED TO DETERMINED BASE ON BUILDING CONSTRUCTION.

*PRIMARY ELECTRICAL CIRCUIT TO SIGN PROVIDED BY OTHERS

- P1 - PAINT TO MATCH GREEN (3M VINYL 3630-136 LIME GREEN)

- P3 - PAINT TO MATCH BLUE (3M VINYL 3630-35 PATRIOT BLUE).

- V1 - VINYL TO MATCH 3M 3630-136 LIME GREEN

- V2 - VINYL TO MATCH 3630-47 PATRIOT BLUE

- V3 - VINYL TO BE DIFFUSER 70% WHITE



CLIENT

Andretti Indoor Carting & Games

ADDRESS
Albuquerque, NM

DATE 10.06.22 DESIGNER - GO DRAWING NO. 220P7483-7

REVISION DATE 10.10.22 1. AM 2. REDUCE SIGN #5 10.18.22 OAH AM 3. GROW SIGN #5 10.21.22 OAH AM 4. ADD CROSS 10.25.22 SECTION DETAILS AM 5. ADD CROSS 10.27.22 SECTION DETAILS AM 3.28.23 6. CORRECTED SIZE OF 005 ON PAGES 6 & 11 DAA 7. ADDED SQ FT TO 4.25.23 **ELEVATIONS** DAA


APPROVAL DATE -

APPROVED BY -

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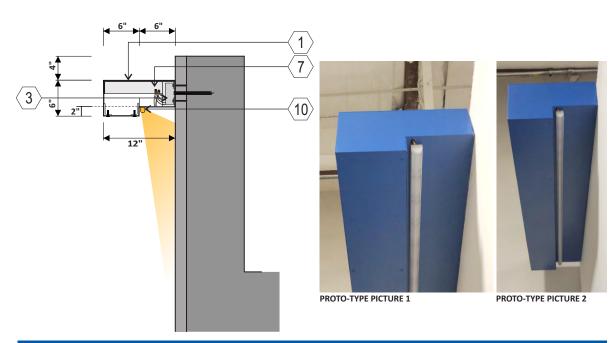
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LIT COVE CHANNEL




F1.L - SECTION

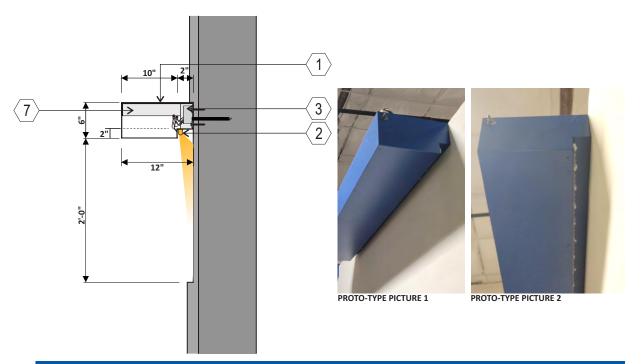SCALE: NTS



F3.L - SECTION

SCALE: NTS

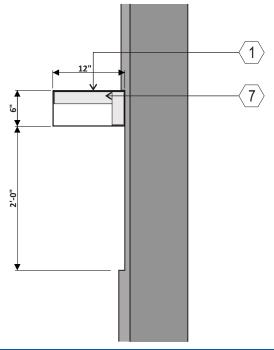

F2.L - SECTION

SCALE: NTS


NON-ILLUMINATED

SPECIFICATIONS

- 1 BREAK-FORMED .090" ALUMINUM PAINTED P1, P2
- 2 PRINCIPAL LED ILLUMINATION
- 3 LED POWER SUPPLY
- 4 REMOVABLE TOP SECURED WITH COUNTER SUNK SCREW
- 5 MOUNTING HARDWARE (TBD)
- 6 PRIMARY POWER (BY OTHERS)
- $\langle 7 \rangle$ 2" X 2" ALUM. ANGLE FRAME
- 8 DRAIN HOLE
- \langle 9 angle 3/16" ACRYLIC WITH FIRST SURFACE TRANS. VINYL
- (10) SLOAN LED BLADE WHITE ILLUMINATION

NOTE:

- ALL SEAMS COVERED AND SEALED FROM INSIDE CHANNEL WITH 2" BREAK- FORMED ALUMINUM CLIP TO PREVENT LIGHT LEAKS.
- SURVEY NEEDED TO DETERMINE LENGTHS AND CORNER DIMS.

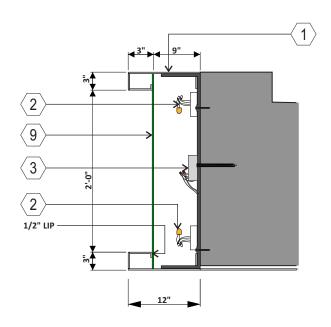



F4.L - SECTION

SCALE: NTS

- V1 - VINYL TO MATCH 3M BRILLIANT GREEN 3730-106L

- P1 - MAP SATIN TO MATCH SW 6966 BLUEBLOOD.

- P2 - MAP SATIN TO MATCH SW 6921 ELECTRIC LIME

SSC SIGNS&LIGHTING 972.219.2495

CLIENT

Andretti Indoor Carting & Games

ADDRESS

Albuquerque, NM

DATE 10.06.22
DESIGNER - GO
DRAWING NO.

220P7483-7

REVISION	DATE
<u>1. AM</u>	10.10.22
2. REDUCE SIGN #5 OAH	10.18.22 AN
3. GROW SIGN #5 OAH	10.21.22 AM
4. ADD CROSS SECTION DETAILS	10.25.22 AN
5. ADD CROSS SECTION DETAILS	10.27.22 AN
6. CORRECTED SIZE OF 005 ON PAGES 6 & 11	
7. ADDED SQ FT TO ELEVATIONS	4.25.23 DAA

APPROVAL DATE -

APPROVED BY -

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CLIENT, MANUFACTURING, AND INSTALLATION NOTES FOR ALL DESIGNS

SSSC SIGNS&LIGHTING 972,219,2495

CLIENT NOTES:

- 1) CLIENT TO PROVIDE VECTOR ARTWORK INCLUDING CORRECT FONTS.
- 2) CLIENT TO PROVIDE ALL COLORS FOR SIGNS WITHIN DESIGN INCLUDING RACEWAY COLORS. COLORS TO BE PROVIDED ARE TO BE IN A SHERWIN WILLIAMS OR PANTONE / PMS COLORS. CMYK COLORS ARE NOT USABLE.
- 3) CLIENT TO APPROVE AND INITIAL DESIGNS THEN RETURN TO SSC SIGNS & LIGHTING ONCE APPROVED.
- 4) CLIENT TO PROVIDE ELECTRICAL TO ALL ILLUMINATED SIGNS. ELECTRICAL TO BE WITHIN 5'-0" OF SIGNAGE PRIOR TO INSTALL DATE.
- 5) ALL ELECTRICAL SCOPE TO BE INSTALLED BY TENANT CONTRACTOR

MANUFACTURING NOTES:

- 1) IF SIGN NEEDS TO BE PERMITTED, MANUFACTURING WILL START AS SOON AS PERMITS ARE APPROVED BY CITY.
- 2) MANUFACTURING TO SUPPLY ALL NEEDED HARDWARE AND ELECTRICAL COMPONENTS NEEDED FOR INSTALLATION OF SIGN.
- 3) A MINIMUM OF 6'-0" WHIPS FROM THE BACK OF EACH CHANNEL LETTERS FOR INSTALLATION WHEN NEEDED.

INSTALLATION NOTES:

- 1) INSTALLER TO INSPECT SIGN UPON RECEIPT AND REPORT ANY ISSUES OR DAMAGED ITEMS. INSTALLER WILL BE HELD LIABLE FOR ANY DAMAGES OR ISSUES REPORTED AFTER DAY SIGN IS RECEIVED.
- 2) INSTALLER TO VERIFY WITH CLIENT THAT SIGN IS BEING INSTALLED IN CORRECT LOCATION.
- 3) INSTALLER TO VERIFY ALL SERVICE IS COMPLETE PRIOR TO LEAVING THE SITE FOR THAT DAY AND/OR NIGHT INCLUDING COMPLETION PHOTOS OF SIGNS INSTALLED AND ILLUMINATED.
- 4) INSTALLER TO CLEAN UP ALL TRASH AND DEBRIS. ALSO, CLEAN ALL SIGNS AS NEEDED INCLUDING FACES.

CLIENT

Andretti Indoor Carting & Games

ADDRESSAlbuquerque, NM

DATE 10.06.22 **DESIGNER -** GO **DRAWING NO.**

220P7483-7


REVISION	DATE
<u>1. AM</u> 1	0.10.22
2. REDUCE SIGN #5 OAH	10.18.22 AN
3. GROW SIGN #5 OAH	10.21.22 AM
4. ADD CROSS SECTION DETAILS	10.25.22 AN
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7. ADDED SQ FT TO ELEVATIONS	4.25.23 DAA

APPROVAL DATE -

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- SERVICE, 260-1990 (OR DIAL 811 LOCALLY), FOR LOCATION OF EXISTING UTILITIES.
- 4. PRIOR TO CONSTRUCTION, THE CONTRACTOR SHALL EXCAVATE AND VERIFY THE HORIZONTAL AND VERTICAL LOCATIONS OF ALL CONSTRUCTIONS. SHOULD A CONFLICT EXIST, THE CONTRACTOR SHALL NOTIFY THE ENGINEER SO THAT THE CONFLICT CAN BE RESOLVED WITH A MINIMUM AMOUNT OF DELAY.



----- BOUNDARY LINE — — — — EASEMENT
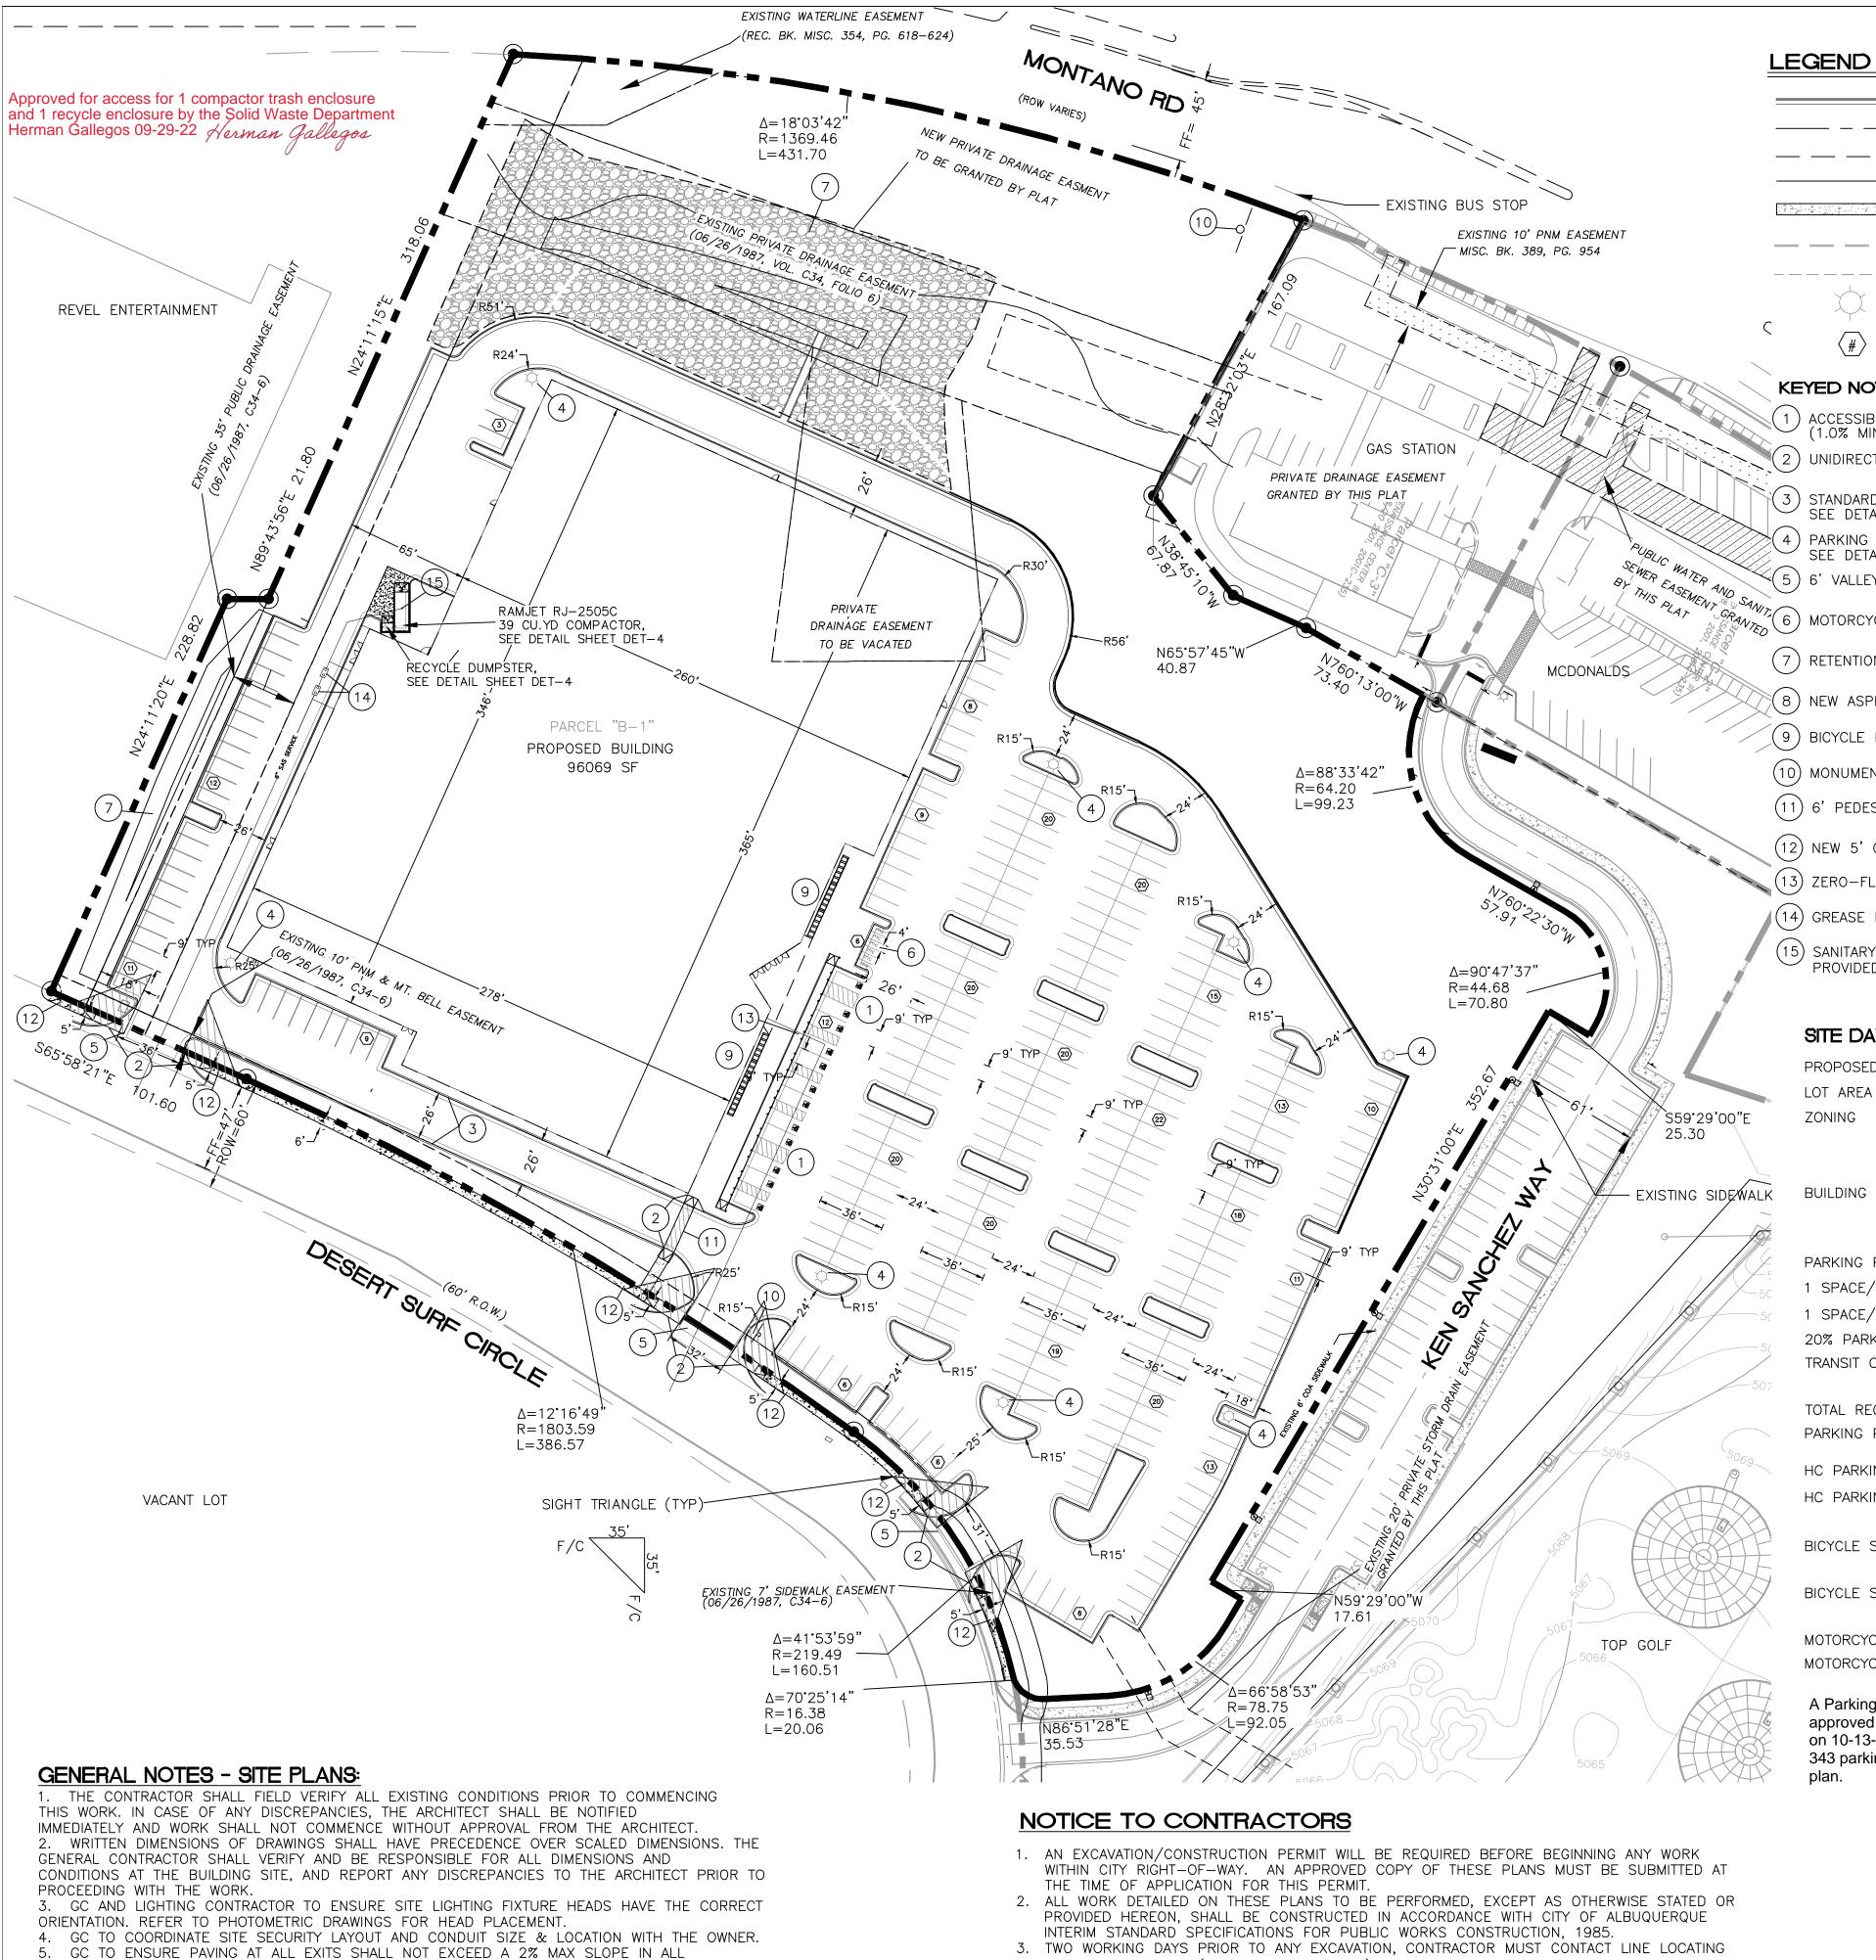
> — BUILDING PROPOSED SIDEWALK

— — — EXISTING CURB & GUTTER EXISTING BOUNDARY LINE

PARKING COUNT

KEYED NOTES

-) ACCESSIBLE PARKING W/SIGN PER ADA STANDARDS (1.0% MIN - 2.0% MAX SLOPE) SEE DETAIL SHEET DET-1
- (2) UNIDIRECTIONAL ACCESSIBLE RAMP
- 3) STANDARD CURB AND GUTTER (TYP) PER COA STD DWG 2415A SEE DETAIL SHEET DET-1
- (4) PARKING LOT LIGHT STANDARD (TYP) FULL CUTOFF LED'S, 25' HIGH,
- SEE DETAIL SHEET DET-2 (5) 6' VALLEY GUTTER PER COA STD DWG 2415B SEE DETAIL SHEET DET-1
- (6) MOTORCYCLE SPACE (4'X8' MIN) W/SIGN
- (7) RETENTION POND
- (8) NEW ASPHALT PAVING SEE DETAIL SHEET DET-1
- (9) BICYCLE RACK, SEE DETAIL SHEET DET-1
- (10) MONUMENT SIGN
- (11) 6' PEDESTRIAN CROSSING SEE DETAIL SHEET DET-1
- (12) NEW 5' CONCRETE SIDEWALK PER COA STD DW 2430 SEE DETAIL SHEET DET-1
- (13) ZERO-FLUSH CURB W/ 8" BOLLARDS SEE DETAIL SHEET DET-1
- (14) GREASE INTERCEPTOR
- (15) SANITARY SEWER FLOOR DRAIN PROVIDED AT COMPACTOR

SITE DATA

PROPOSED USAGE INDOOR ENTERTAINMENT LOT AREA 402445 SF (9.23 ACRES)

FRONT: 5'

BUILDING SETBACKS SIDE: 0' REAR: 0'

PARKING REQUIRED

- 1 SPACE/210 GSF FOR 51,000 GSF= 243 SPACES PER TABLE 5-5-2
- 1 SPACE/3 OCCUPANTS FOR INDOOR TRACK (50 OCCUPANTS)= 17 SPACES 20% PARKING REDUCTION FOR EMPLOYMENT CENTER AND MASS TRANSIT CORRIDOR = -52 SPACES

TOTAL REQUIRED PARKING= 208 SPACES

PARKING PROVIDED= 343 SPACES


HC PARKING REQUIRED 12 SPACES (2 VAN SPACES) HC PARKING PROVIDED 12 SPACES (2 VAN SPACES)

10% OF OFF-STREET PARKING BICYCLE SPACES REQUIRED


35 SPACES BICYCLE SPACES PROVIDED 35 SPACES


MOTORCYCLE SPACES REQUIRED 6 SPACES MOTORCYCLE SPACES PROVIDED 6 SPACES

A Parking Reduction Study was \mathcal{N} approved by the Planning Director on 10-13-2022 for the provided

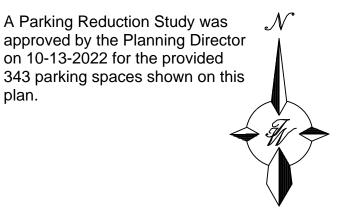

GRAPHIC SCALE

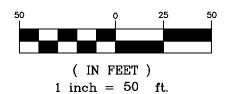

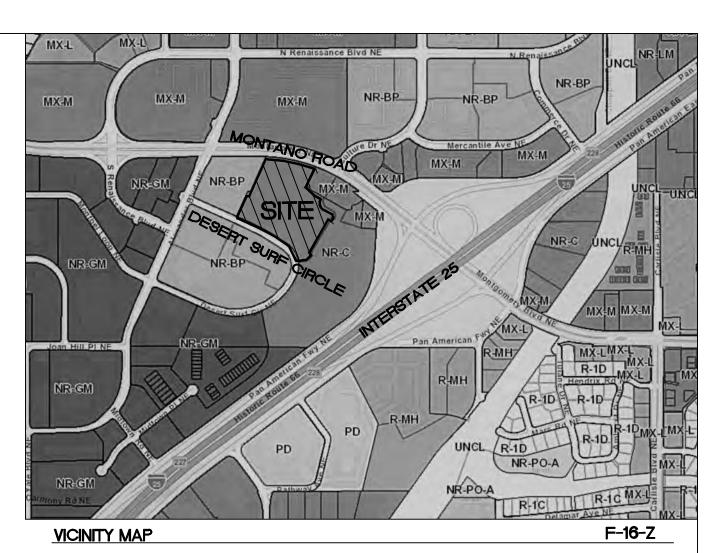

LEGAL DESCRIPTION:

PARCEL B-1-A CORRECTION PLAT OF PARCELS C-1-A, C-1-B ANDB-1-A RENAISSANCE CENTER III CONT 9.2281 AC

NOTES:

1. COMMON STORM DRAINAGE, PEDESTRIAN, AND VEHICULAR ACCESS ACROSS NEW TRACTS IS GRANTED BY THIS SITE PLAN AND WILL BE GRANTED ON THE REPLAT.

2. APPROVAL OF THIS PLAN DOES NOT CONSTITUTE OR IMPLY EXEMPTION FROM WATER WASTE PROVISIONS OF THE WATER CONSERVATION LANDSCAPING AND WATER WASTE ORDINANCE WATER WASTE MANAGEMENT IS THE SOLE RESPONSIBILITY OF THE PROPERTY

3. LANDSCAPE MAINTENANCE SHALL BE THE RESPONSIBILITY OF THE OWNER.

4. LIGHT POLES SHALL BE A MAXIMUM OF 20' FEET WITH FULL CUT OFF LIGHT FIXTURES. LIGHT FIXTURES SHALL BE A MAXIMUM OF 20' WITH FULL CUT OFF SHIELDS ON FIXTURES SO THAT NO FUGITIVE LIGHT SHALL ESCAPE BEYOND THE PROPERTY LINE. THE LIGHT FIXTURES SHALL BE FULLY SHIELDED WITH HORIZONTAL LAMPS. LIGHT POLES WITHIN 100' OF RESIDENTIAL ZONING SHALL BE LIMITED TO 16'

5. THERE SHALL BE NO BACKLIT, PLASTIC, OR VINYL AWNINGS OR ILLUMINATED PLASTIC BANDING ON SIGNAGE.

- 6. ACCESS AT DESERT SURF CIRCLE BE FULL MOVEMENT.
- 7. ROOF EQUIPMENT SHALL BE BELOW PARAPET HEIGHT AND SCREENED FROM VIEW. ALL GROUND MOUNTED EQUIPMENT SHALL BE SCREENED BY SCREEN WALLS WITH TOP OF EQUIPMENT BELOW TOP OF SCREEN WALL.

PROJECT NUMBER: APPLICATION NUMBER

This plan is consistent with the specific Site Development Plan approved by the Environmental Planning Commission (EPC), dated _____, and the Findings and Conditions in the Official Notification of Decision are satisfied.

Is an Infrastructure List required? () Yes () No If Yes, then a set of approved DRC plans with a work order is required for any construction within Public Right—of—Way or for construction of public improvements.

DRB SITE DEVELOPMENT PLAN SIGNOFF APPROVAL:

Traffic Engineer, Transportation Division	Date
Water Utility Development	Date
Parks & Recreation Department	Date
City Engineer	Date
* Environmental Health Department (conditional)	Date
Herman Gallegos Herman Gallegos Solid Waste Management	09-29-22
Solid Waste Management	Date
Code Enforcement	Date

* Environmental Health, if necessary

DRB Chairperson, Planning Department



ANDRETTI'S RACING ALBUQUERQUE, NM

Date

TIERRA WEST, LLC 5571 MIDWAY PARK PL NE

(505) 858-3100 www.tierrawestllc.com SP-1 JOB # 2022011

DRAWN BY

JL

9-22-22

DRAWING

SHEET #


ALBUQUERQUE, NEW MEXICO 87109 P.E. #7868

•1 1/2" @ OVERHEAD DOORS • 1 1/2" @PRE-FAB METAL WALL PANELS

•1/2" @ ALL SHOWROOM GLAZING LOCATIONS

•1/2" @ ALL EXIT DOORS

6. PAVING SHALL BE LOWER THAN THE BUILDING SLAB BY THE FOLLOWING AMOUNTS UNO:

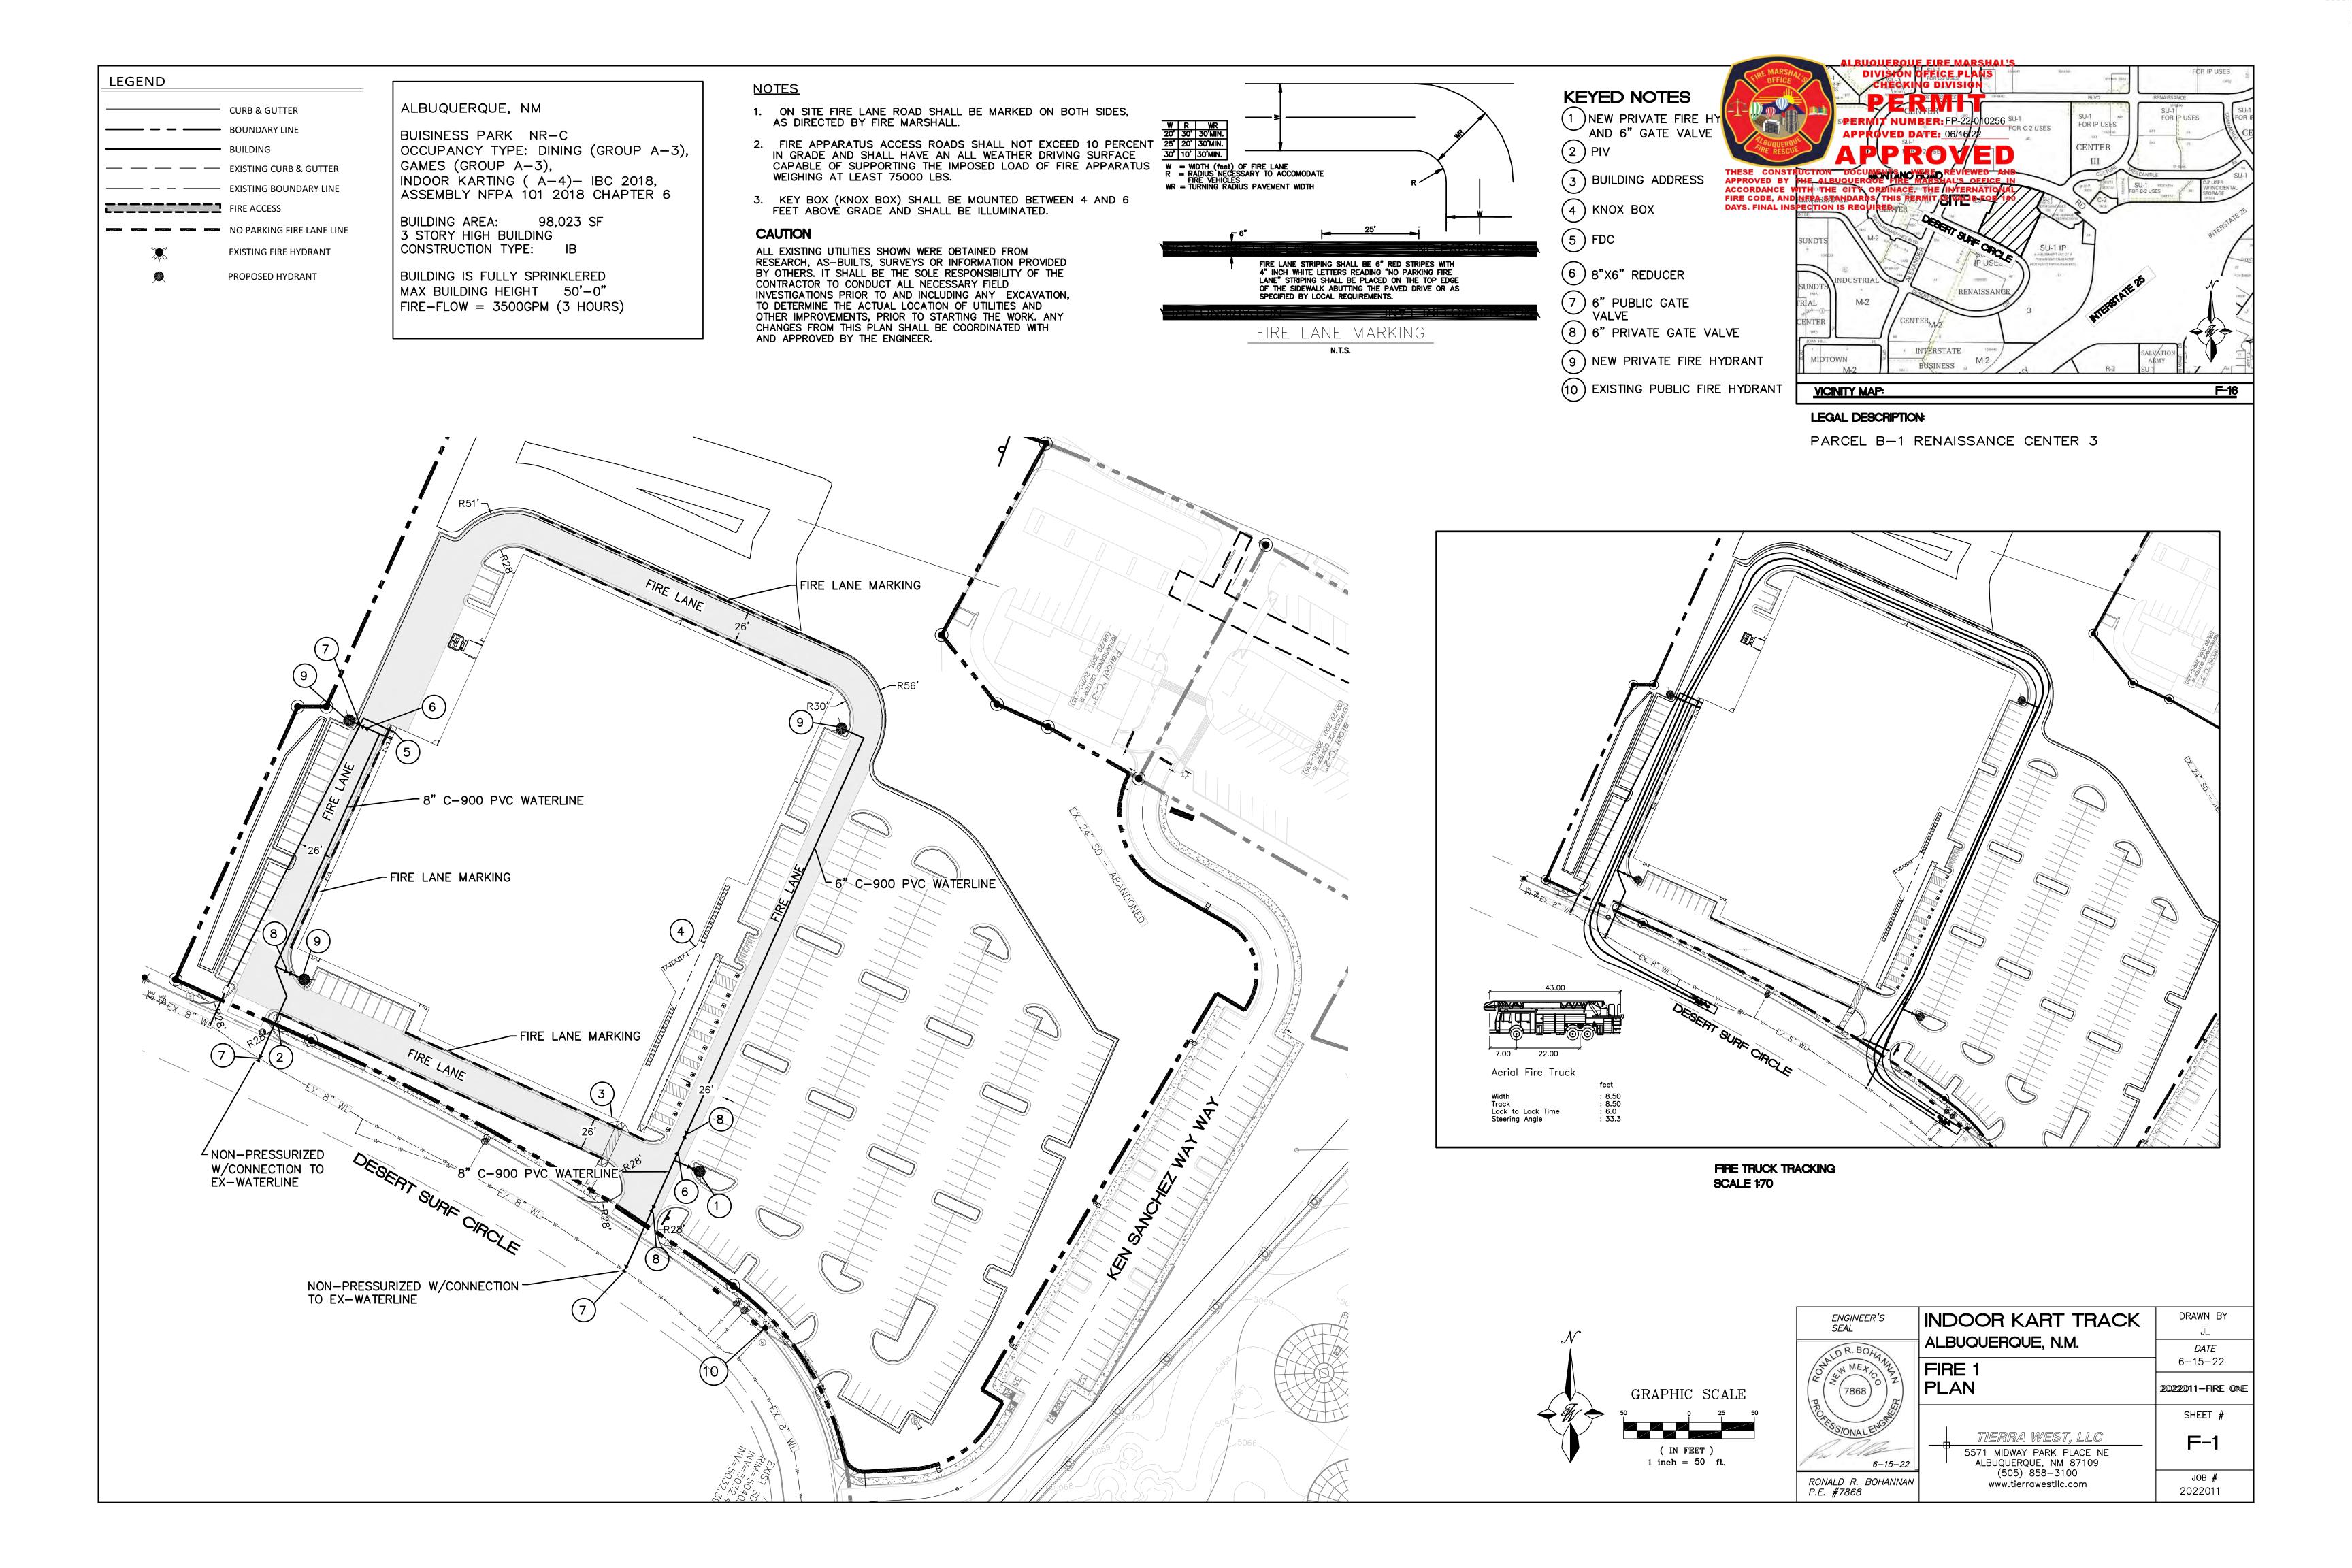

PR_2019-002284_SI-2023-00168_Site_Plan_Ap proved_8-30-23

Final Audit Report 2024-07-16

Created: 2023-10-12

By: Jay Rodenbeck (jrodenbeck@cabq.gov)

Status: Signed

Transaction ID: CBJCHBCAABAABjymy2Tiv2wEGt85CcnHXKp3F7p0xWSS

"PR_2019-002284_SI-2023-00168_Site_Plan_Approved_8-30-2 3" History

- Document created by Jay Rodenbeck (jrodenbeck@cabq.gov) 2023-10-12 4:25:03 PM GMT- IP address: 143.120.132.76
- Document emailed to Jolene Wolfley (jwolfley@cabq.gov) for signature 2023-10-12 4:29:18 PM GMT
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- Document emailed to Tiequan Chen (tchen@cabq.gov) for signature 2023-10-12 4:29:19 PM GMT
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 Signature Date: 2023-10-12 5:00:58 PM GMT Time Source: server- IP address: 143.120.132.73
- Document e-signed by Whitney Phelan (wphelan@cabq.gov)
 Signature Date: 2023-10-12 5:35:15 PM GMT Time Source: server- IP address: 143.120.170.188
- Document e-signed by Ernest Armijo (earmijo@cabq.gov)

 Signature Date: 2023-10-16 1:34:59 PM GMT Time Source: server- IP address: 143.120.132.81
- Email viewed by David G. Gutierrez (dggutierrez@abcwua.org) 2023-10-18 1:38:07 PM GMT- IP address: 165.225.216.122
- Document e-signed by David G. Gutierrez (dggutierrez@abcwua.org)

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- Document e-signed by Jolene Wolfley (jwolfley@cabq.gov)
 Signature Date: 2024-07-16 7:20:54 PM GMT Time Source: server
- Agreement completed. 2024-07-16 - 7:20:54 PM GMT