



### DEVELOPMENT FACILITATION TEAM (DFT) APPLICATIONS

Effective 12/15/2022

Please check the appropriate box(es) and refer to supplemental forms for submittal requirements. All fees must be paid at the time of application.				
MISCELLANEOUS APPLICATION	NS	Extension of Infrastructu	re List or IIA <i>(Form S3)</i>	
□ Site Plan Administrative DFT (Forms P & P2)		PRE-APPLICATIONS		
□ Final EPC Sign-off for Master Development/Site PI	ans - EPC <i>(Form P2)</i>	□ Sketch Plat Review and Comment (Form S3)		
□ Amendment to Infrastructure List (Form S3)		□ Sketch Plan Review and	Comment (Form S3)	
□ Temporary Deferral of S/W (Form S3)			APPEAL	
□ Extension of IIA: Temp. Def. of S/W (Form S3)		□ Administrative Decision	(Form A)	
BRIEF DESCRIPTION OF REQUEST				
APPLICATION INFORMATION				
Applicant/Owner:			Phone:	
Address:		-	Email:	
City:		State:	Zip:	
Professional/Agent (if any):			Phone:	
Address:			Email:	
City:		State:	Zip:	
Proprietary Interest in Site:		List <u>al</u> l owners:		
SITE INFORMATION (Accuracy of the existing lega	al description is crucia	II! Attach a separate sheet i	f necessary.)	
Lot or Tract No.:		Block:	Unit:	
Subdivision/Addition:		MRGCD Map No.:	UPC Code:	
Zone Atlas Page(s):	Existing Zoning:		Proposed Zoning	
# of Existing Lots:	# of Proposed Lots:		Total Area of Site (Acres):	
LOCATION OF PROPERTY BY STREETS	-			
Site Address/Street: Between: and:			and:	
CASE HISTORY (List any current or prior project a	nd case number(s) th	at may be relevant to your r	equest.)	
I certify that the information I have included here and sent in the required notice was complete, true, and accurate to the extent of my knowledge.           Signature:         Date:				
Printed Name:				
- · · · · · · · · · · · · · · · · · · ·				

### FORM P2: SITE PLAN ADMINISTRATIVE – Development Facilitation Team (DFT) as of 12/25/2022

### \_ SITE PLAN ADMINISTRATIVE – DFT

A Single PDF file of the complete application including all documents being submitted must be emailed to <u>PLNDRS@cabq.gov</u>. Zipped files or those over 9 MB cannot be delivered via email, in which case the PDF must be provided to City Staff using other online resources such as Dropbox or FTP. <u>The PDF shall</u> <u>be organized in the number order below</u>. Divide the PDF with a title sheet for each of the three documentation sections in **bold** below.

### SITE PLAN DOCUMENTATION

- \_\_\_\_\_ 1) DFT Application form completed, signed, and dated
- \_\_\_\_\_ 2) Form P2 with all the submittal items checked/marked
- \_\_\_\_\_ 3) Form P with signatures from Hydrology, Transportation, and ABCWUA
- \_\_\_\_\_ 4) Zone Atlas map with the entire site clearly outlined and labeled
- \_\_\_\_\_ 5) Site Plan and related drawings (include a Site Plan key of the sheets submitted)
- \_\_\_\_\_ 6) Copy of the original approved Site Plan or Master Development Plan (for amendments to or Extensions of the Site Plan)
- \_\_\_\_\_ 7) Infrastructure List, if required for building of public infrastructure
- 8) Sensitive Lands Site Analysis for new site design in accordance with IDO Section 5-2(C) (The Sensitive Lands Site Analysis form can be obtained online at): <u>https://documents.cabq.gov/planning/development-review-board/Sensitive lands analysis form.pdf</u>
- 9) Responses to climatic and geographic responsive design considerations (Recommended to promote sustainability, but not required. The Climatic and Geographic Responsiveness form can be obtained online at): <u>https://documents.cabq.gov/planning/IDO/SubmittalFormIDO5-</u> <u>2(D)ClimaticGeographic\_Responsiveness.pdf</u>

### SUPPORTIVE DOCUMENTATION

- \_\_\_\_\_ 10) Completed Site Plan Checklist
- \_\_\_\_\_ 11) Letter of authorization from the property owner if application is submitted by an agent
- 12) Justification letter describing and justifying the request per the criteria in IDO Section 16-6-5(G)(3)
- 13) Explanation and justification of requested deviations, if any, in accordance with IDO Section 14-16-6-4(P). Note: If requesting more than allowed by deviation, a Variance – ZHE or Waiver –DHO will be required, as applicable
- 14) Sites 5 acres or greater: Archaeological Certificate in accordance with IDO Section 14-16-6-5(A) (not required for Extension)

- 15) Landfill disclosure statement per IDO Section 14-16-6-4(S)(5)(d)(2)(d) if site is within a designated landfill buffer zone
- 16) Architectural Review Committee approval letter if the site is located within a Master Development Plan area or a Framework Plan area


### PUBLIC NOTICE DOCUMENTATION


- \_\_\_\_\_ 17) Sign Posting Agreement
- 18) Proof of a <u>Pre-Submittal</u> Neighborhood Meeting per IDO 6-4(C)(1)(b) for new building or multiple new buildings that include a total of more than 100 multi-family residential dwelling units or more than 50,000 square feet of non-residential development
  - \_\_\_Office of Neighborhood Coordination neighborhood meeting inquiry response
  - Proof of email with read receipt OR Certified Letter offering meeting to applicable associations
  - \_\_\_ Completed neighborhood meeting request form(s)
  - \_\_\_ If a meeting was requested or held, copy of sign-in sheet and meeting notes
  - 19) Required Content of Notice <u>at Submittal</u> per IDO Section 14-16-6-4(K)(1) (not required for an extension)
    - \_\_\_ Office of Neighborhood Coordination notice inquiry response
    - Completed notification form(s), proof of additional information provided in accordance with IDO Section 6-4(K)(1)(b)
    - \_\_\_ Proof of emailed notice to affected Neighborhood Association representatives

### \_ FINAL SIGN-OFF FOR MASTER DEVELOPMENT PLANS AND SITE PLANS – EPC

A Single PDF file of the complete application including all documents being submitted must be emailed to <u>PLNDRS@cabq.gov</u> prior to making a submittal. Zipped files or those over 9 MB cannot be delivered via email, in which case the PDF must be provided to City Staff using other online resources such as Dropbox or FTP. <u>The PDF shall be organized in the number order below.</u>

- \_\_\_\_\_1) DFT Application form completed, signed, and dated
- \_\_\_\_\_ 2) Form P2 with all the submittal items checked/marked
- \_\_\_\_\_ 3) Zone Atlas map with the entire site clearly outlined and labeled
- \_\_\_\_\_ 4) Site Plan and related drawings
- \_\_\_\_\_ 5) Infrastructure List, if require
- \_\_\_\_\_ 6) Copy of EPC Notice of Decision and letter explaining how each EPC condition has been met
- \_\_\_\_\_ 7) Letter of authorization from the property owner if application is submitted by an agent
- \_\_\_\_\_ 8) Solid Waste Department signature on Site Plan
- 9) Signed Form DRWS Drainage Report, Grading and Drainage Plan, and Water & Sewer Availability Statement filing information
- \_\_\_\_\_ 10) Approved Grading and Drainage Plan
- \_\_\_\_\_ 11) Copy of Site Plan with Fire Marshal's stamp, i.e. "Fire 1" plan (not required for Master Development Plans)

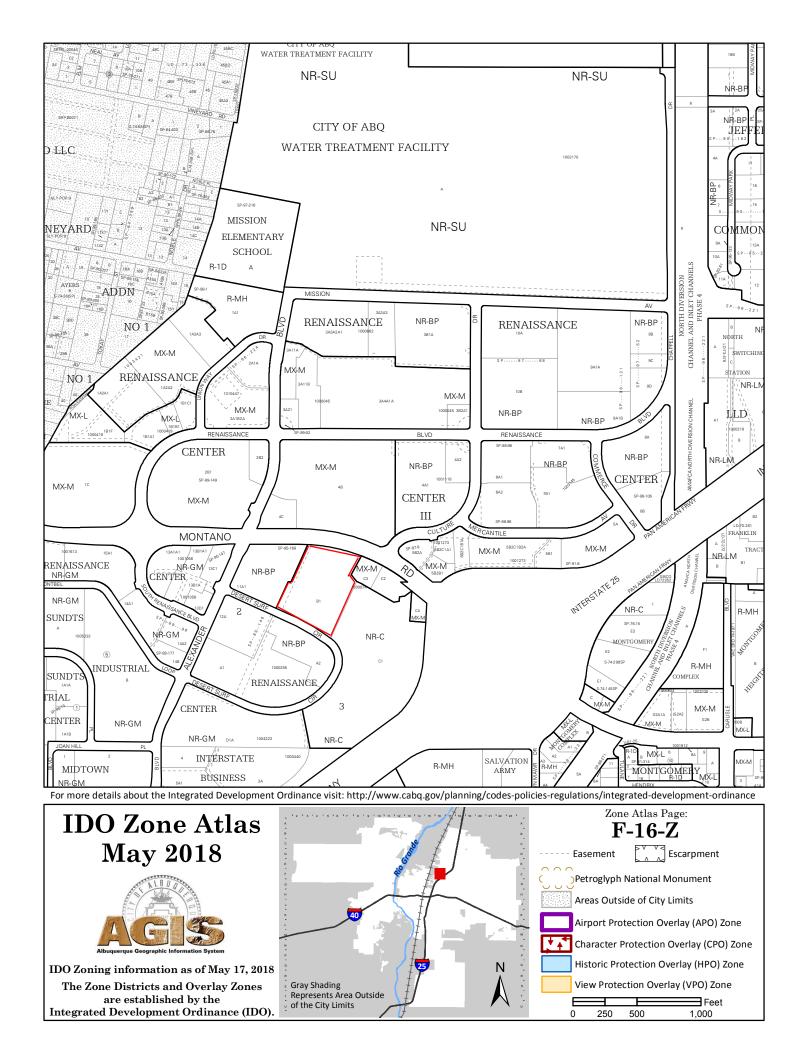

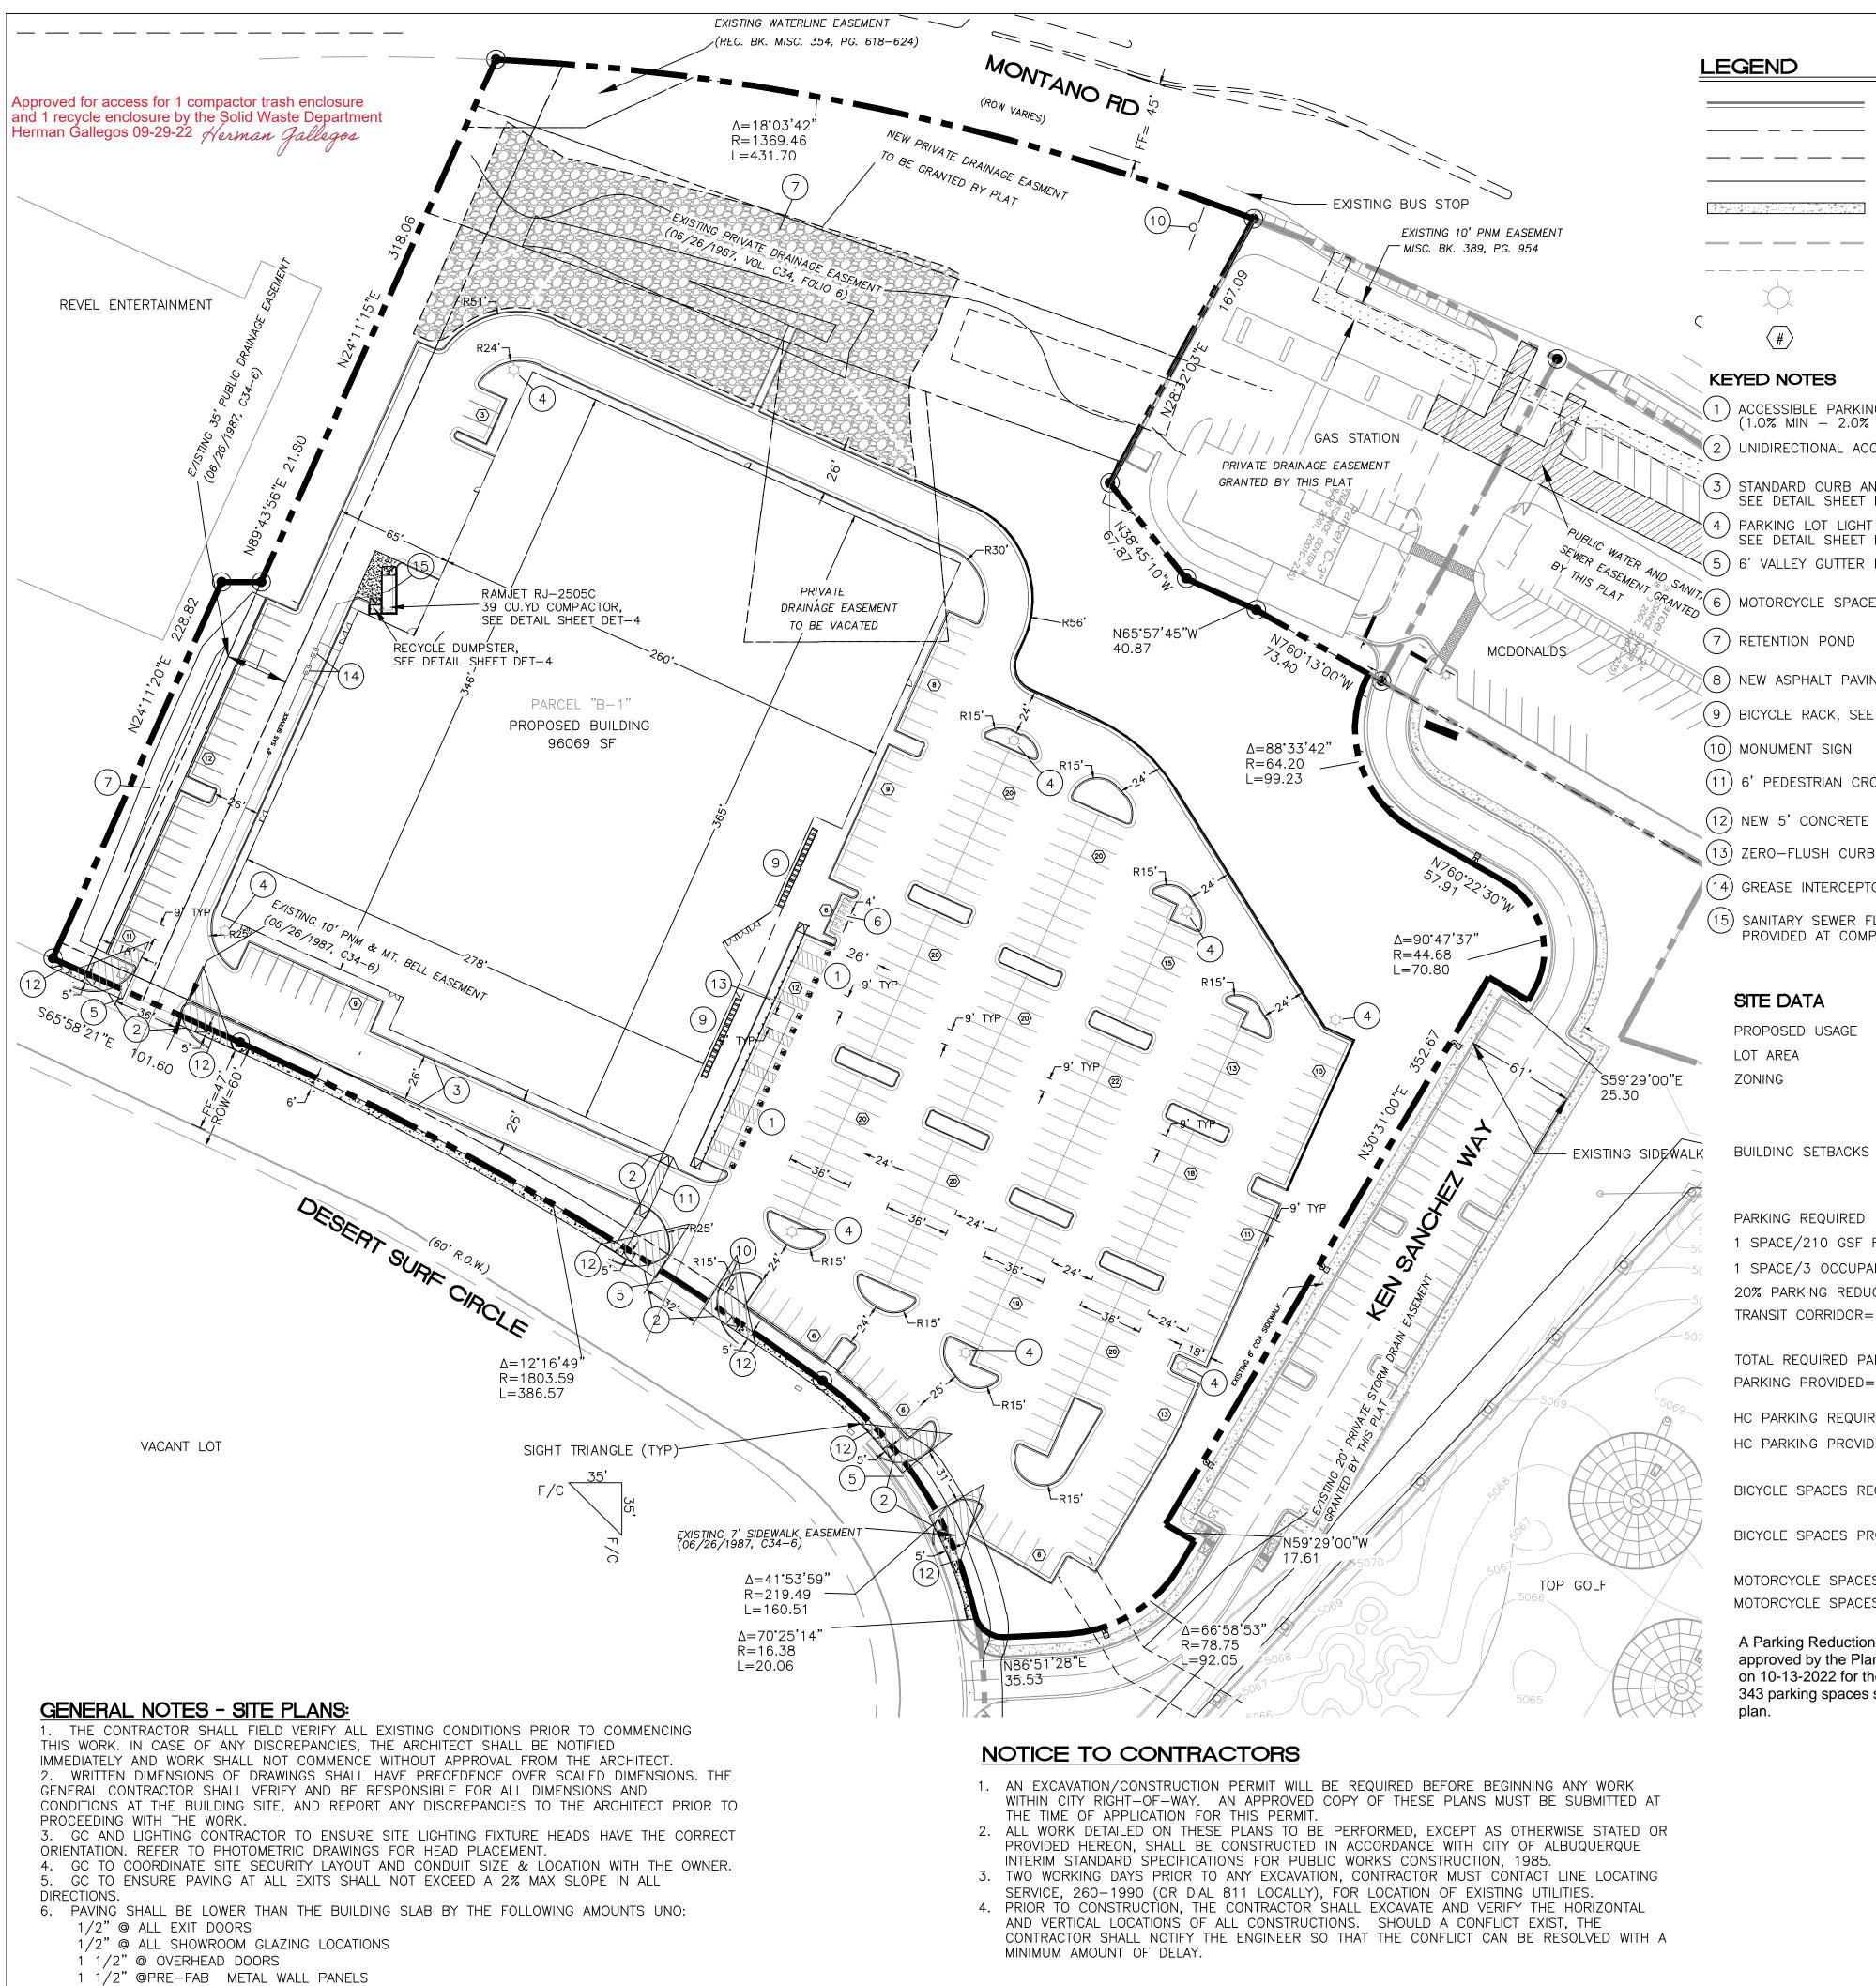

## LEGEND

		CURB & GUTTER
		BOUNDARY LINE
		EASEMENT
		BUILDING
		PROPOSED SIDEWALK
		EXISTING CURB & GUTTER
		EXISTING BOUNDARY LINE
~	$\langle \cdot \rangle$	LIGHT
C	$\langle \# \rangle$	PARKING COUNT

## **KEYED NOTES**

1)	ACCESSIBLE PARKING W/SIGN PER ADA STANDARDS
	ACCESSIBLE PARKING W/SIGN PER ADA STANDARDS (1.0% MIN – 2.0% MAX SLOPE) SEE DETAIL SHEET DET–1
_	
2)	UNIDIRECTIONAL ACCESSIBLE RAMP

STANDARD CURB AND GUTTER (TYP) PER COA STD DWG 2415A SEE DETAIL SHEET DET-1 (4) PARKING LOT LIGHT STANDARD (TYP) FULL CUTOFF LED'S, 25' HIGH, SEE DETAIL SHEET DET-2 (5) 6' VALLEY GUTTER PER COA STD DWG 2415B SEE DETAIL SHEET DET-1

- (6) MOTORCYCLE SPACE (4'X8' MIN) W/SIGN
- (7) RETENTION POND
- (8) NEW ASPHALT PAVING SEE DETAIL SHEET DET-1
- (9) BICYCLE RACK, SEE DETAIL SHEET DET-1
- (10) MONUMENT SIGN
- (11) 6' PEDESTRIAN CROSSING SEE DETAIL SHEET DET-1
- (12) NEW 5' CONCRETE SIDEWALK PER COA STD DW 2430 SEE DETAIL SHEET DET-1
- (13) ZERO-FLUSH CURB W/ 8" BOLLARDS SEE DETAIL SHEET DET-1
- (14) GREASE INTERCEPTOR
- (15) SANITARY SEWER FLOOR DRAIN PROVIDED AT COMPACTOR

## SITE DATA

PROPOSED USAGE	INDOOR ENTERTAINMENT
LOT AREA	402445 SF (9.23 ACRES)
ZONING	NR-C


FRONT: 5' SIDE: O' REAR: 0'

## PARKING REQUIRED


1 SPACE/210 GSF FOR 51,000 GSF= 243 SPACES PER TABLE 5-5-2 1 SPACE/3 OCCUPANTS FOR INDOOR TRACK (50 OCCUPANTS) = 17 SPACES 20% PARKING REDUCTION FOR EMPLOYMENT CENTER AND MASS TRANSIT CORRIDOR= -52 SPACES


TOTAL REQUIRED PARKING= PARKING PROVIDED=	208 SPACES 343 SPACES
HC PARKING REQUIRED 12 SP	PACES (2 VAN SPACES)
HC PARKING PROVIDED 12 SP	PACES (2 VAN SPACES)
BICYCLE SPACES REQUIIRED	10% OF OFF-STREET 35 SPACES 35 SPACES
DICTULE SPACES FROMDED	JJ SFACES
MOTORCYCLE SPACES REQUIIRED	D 6 SPACES
MOTORCYCLE SPACES PROVIDED	0 6 SPACES


A Parking Reduction Study was  $\mathcal{N}$ approved by the Planning Director on 10-13-2022 for the provided 343 parking spaces shown on this plan.

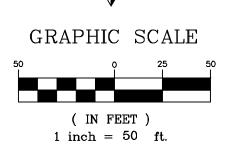

PARKING

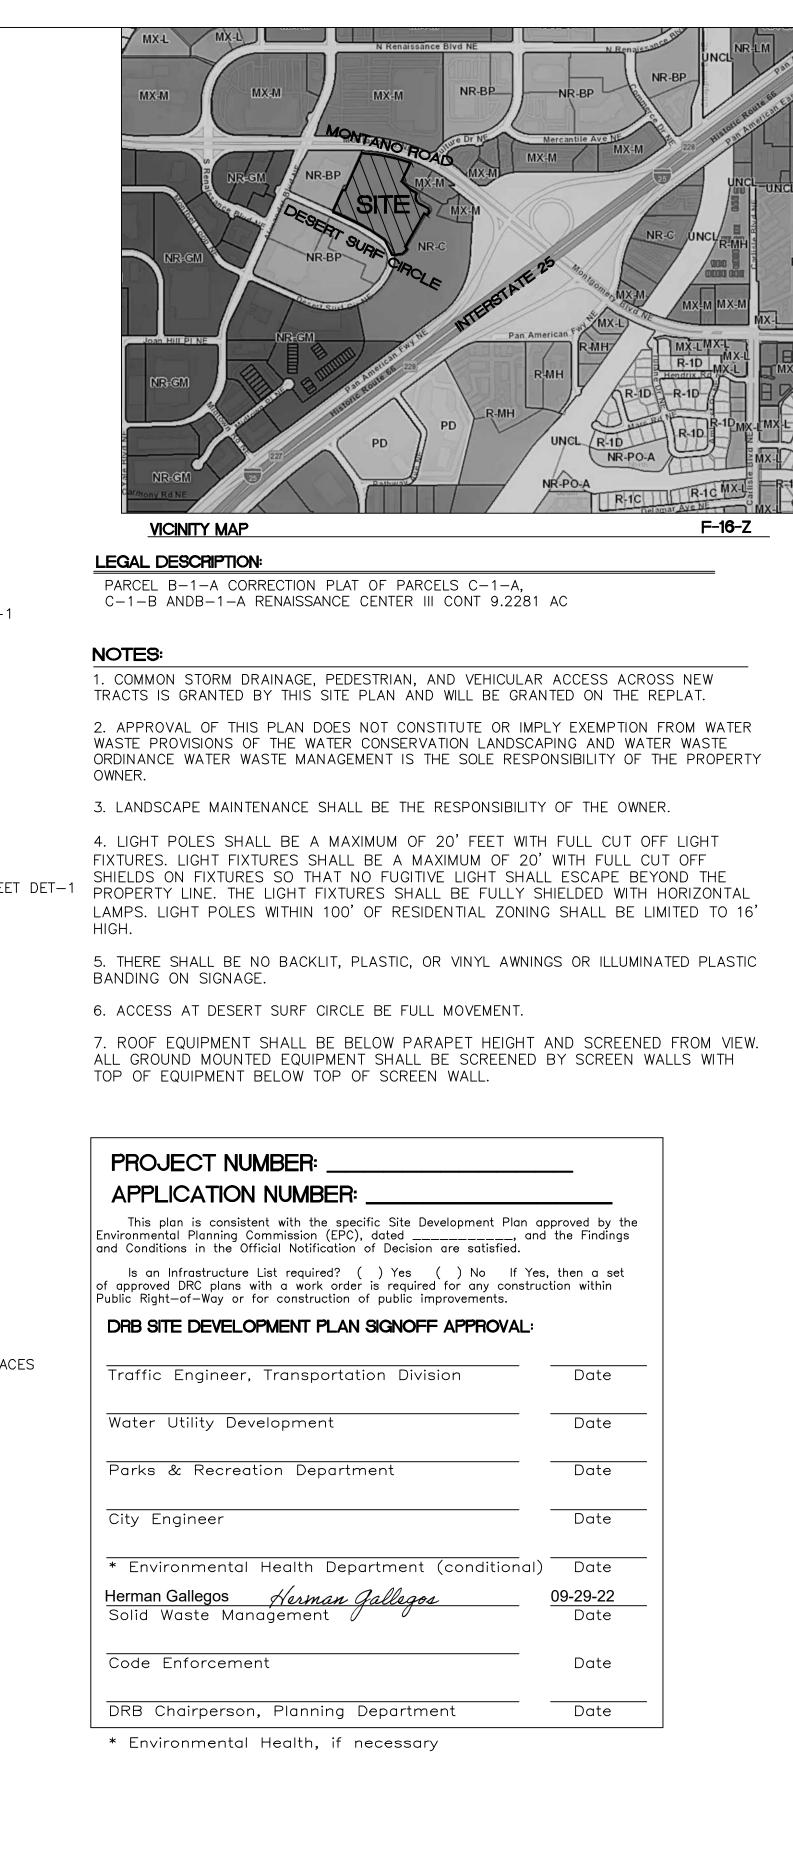

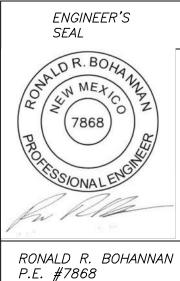

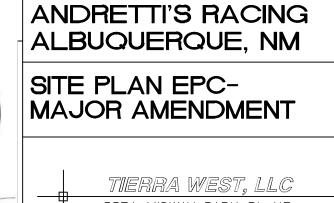


5571 MIDWAY PARK PL NE ALBUQUERQUE, NEW MEXICO 87109 (505) 858-3100 www.tierrawestllc.com

DRAWN BY JL DATE 9-22-22

DRAWING SHEET #

SP-1

JOB # 2022011

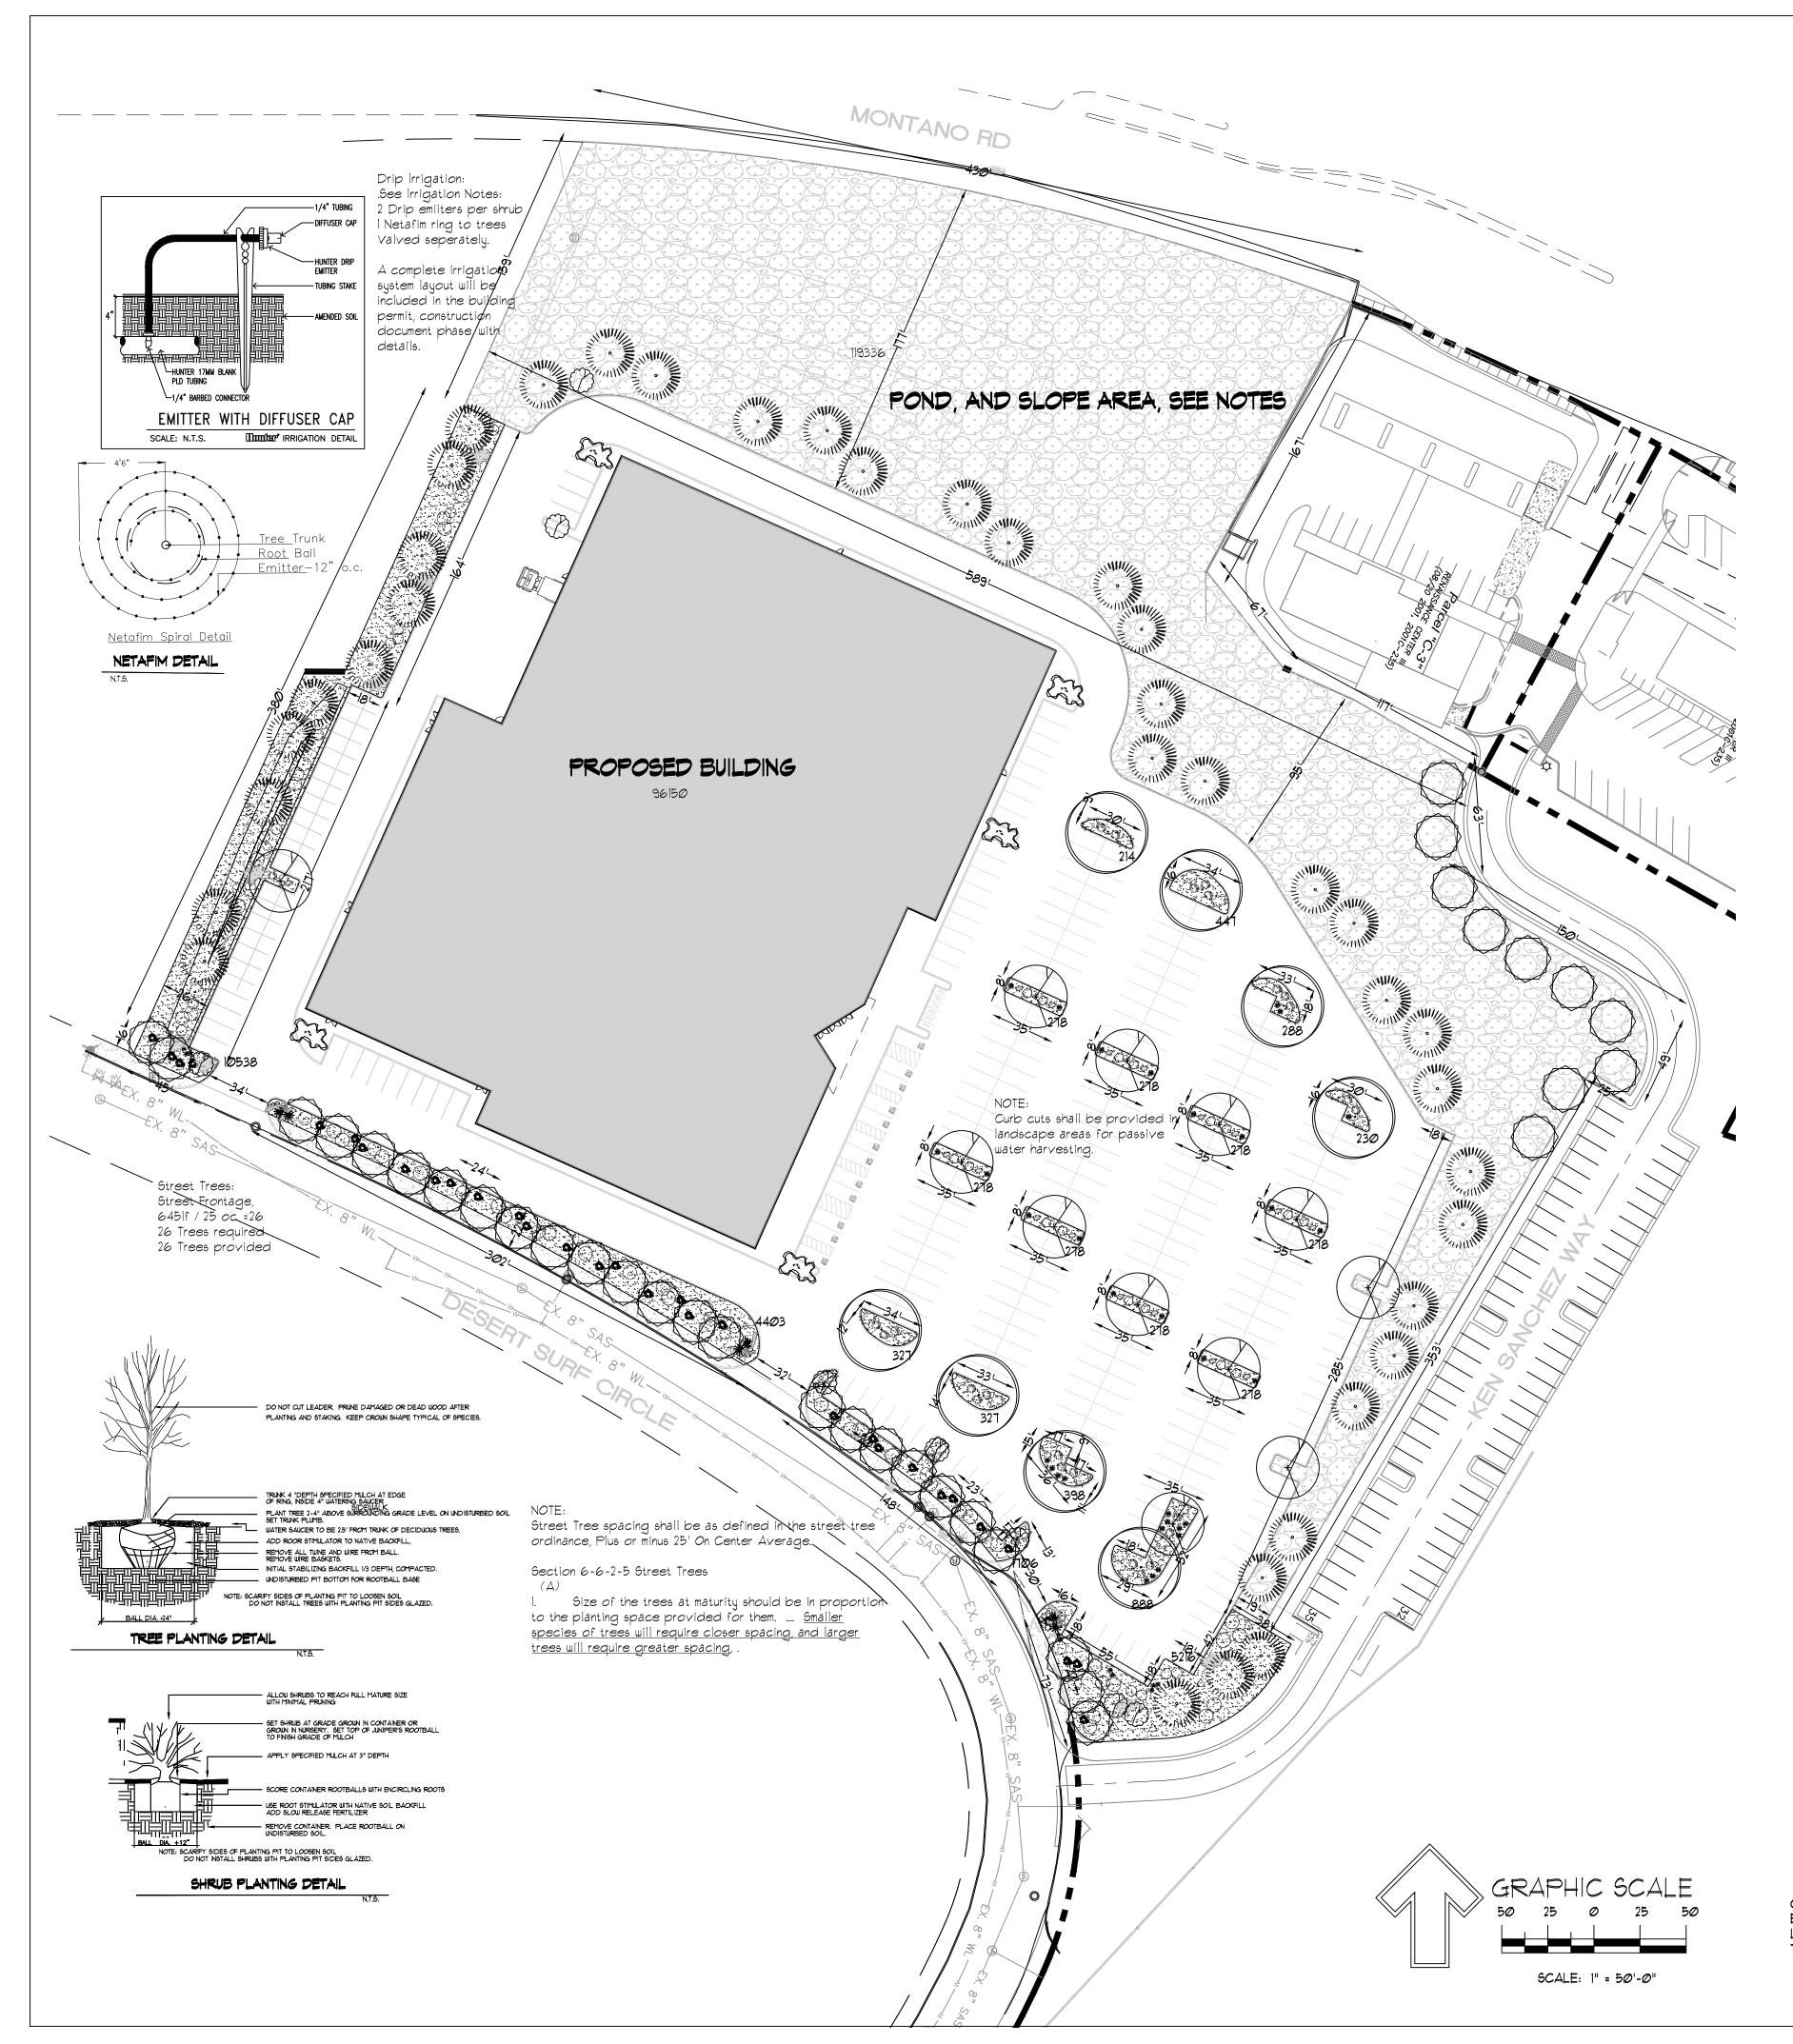

	QTY	SIZE	COMMON/BOTANICAL			H20 USE
$\frown$		Trees				
	12	2" cal	Chinese Pistache 40x35 Pistacia chinensis	1225	14700	M+
	8	2" cal	Honey Locust 50x45 Gleditsia triacanthos	2Ø25	16200	٩M
	38	6 - 8'	Austrian Pine 35x25 Pinus nigra	625	2375Ø	Μ
L'	5	15 Gal	Laaerstroemia indica		2000	М
**	6	4 - 6'	Tree Form, 18'–20' at Palm Yucca 15x6 Yucca faxoniana	mati 36		Μ
$\bigotimes$	8	15 Gal.	Oklahoma Redbud 15x12 Cercis reniformis	144	1152	Μ
$\bigcirc$	3Ø	15 Gal	Desert Willow 20x25 Chilopsis linearis	625	1875Ø	Μ
$\overline{}$		Shrubs &	Groundcovers		76768	3 TREE COVERAGE
\$,, <b>\$</b>	28	5 Gal	Indía Hawthorne 3x5 Raphiolepis indica	25	700	М
凑	10	5 Gal	Feather Reed Grass 2.5x2 Calamogrostis arudinac	4 cea	40	Μ
0	16	5 Gal	-	25	400	Μ
$\bigtriangleup$	4	5 Gal		49	196	Μ
S.C.	22	5 Gal		144	3168	Μ
	8	5 Gal	Buffalo Juniper Ix12 Juniperus sabina 'Buffai	144 10'	1152	Μ
0	8	5 Gal		9	72	Μ
o	٦	5 Gal	Blue Mist 3x3 Caryopteris x clandoner	9 Isis	63	Μ
0	2Ø	5 Gal	Fern Bush 5x6 Chamaebatiaria millefoli	36 um	72Ø	L
$\odot$	26	5 Gal	Apache Plume 6x1 Fallugia paradoxa	49	1274	L
$\odot$	28	5 Gal		4 <b>9</b> sus	1372	L
*	32	5 Gal		9	288 Hamel	M <sub>lin</sub>
¢	17	5 Gal		6	272	L
	32	2-3cf	Boulders To be placed at contr	racto	<b>9645</b> r disc	SHRUB COVERAGE
<u>:</u> 272	06		Landscape Gravel / Filter Fak 3/4" Crushed Grey			
	336		RIP RAP AND SEEDED SLOF REFERENCE GRADING			AINAGE BASIN NOTES


146542 TOTAL LANDSCAPE AREA

Street Tree Notes:

Part 6-2-2 of ROA 1994 (Street Trees)

Section 6-6-2-5 Street Trees (A)

Clear Site Triangle Note: within the clear site triangle.

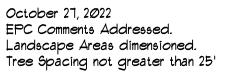



SIN NOTES REFERENCE GRADING PLAN

Per Section 5-6(D)(1)(a) Required Street Trees. Trees are <u>GENERALLY</u> required along street frontages every 25 feet on center unless otherwise specified in

 Size of the trees at maturity should be in proportion to the planting space provided for them. .... Smaller species of trees will require closer spacing, and larger trees will require part of the plan approval process.

possible, or <u>do not conform to the overall design</u> needed. objectives of the site, provided that the number be required if the trees were evenly spaced

Landscaping and signage will not interfere with clear site requirements. Signs, walls, trees and shrubbery between 3 and 8 feet tall, (as measured from the gutter pan) are not included water conservative, environmentally sound landscape principles will be followed in design and installation. Landscape Gravel over Filter Fabric to a minimum depth of 3" shall be placed in all landscape areas. IRRIGATION NOTES: Irrigation system maintenance and operation shall be the sole responsibility of the owner. It shall be the owners responsibility to ensure that fugitive water does not leave the site due to overwatering. Irrigation shall be a complete underground system with Trees to receive 1 Netafim spiral (50' length) with 3 loops at a final radius of 4.5' from tree trunk, pinned in place. Netafim shall have emitters 12" o.c. with a flow of .6 gph. Shrubs to receive (2) 1.0 GPH Drip Emitters. Drip and Bubbler systems to be tied to 1/2" polypipe with flush caps at each end. Run time per each shrub drip valve will be approximately 15 minutes per day. Tree drip valve shall run 1,5 hours, 3 times per week. Run time will be adjusted according to the season. Point of connection for irrigation system is unknown at current time and will be coordinated in the field. Irrigation will be operated by automatic controller. Location of controller to be field determined and power source for controller to be provided by others.

LANDSCAPE NOTES:

condition.

Landscape maintenance shall be the responsibility of

all landscaping in a living, healthy, and attractive

Water management is the sole responsibility of the

Property Owner. All landscaping will be in conformance

with the City of Albuquerque Zoning Code. In general,

the Property Owner. The Property Owner shall maintain

Irrigation maintenance shall be the responsibility of the Property Owner.

Water and Power source shall be the responsibility of the Developer/Builder.

## LANDSCAPE CALCULATIONS

TOTAL LOT AREA (sf)	402105
TOTAL BUILDING AREA (sf)	-96149
TOTAL LOT AREA (sf)	3Ø5956
LANDSCAPE REQUIREMENT	.15
TOTAL LANDSCAPE REQUIRED ( 15% )	45893
TOTAL ON-SITE LANDSCAPE PROVIDED	146542
TOTAL LIVE GROUNDCOVER REQUIRED ( 15% )	109905
TOTAL NATIVE SEED AREA, POND AND SLOPE TOTAL LIVE PLANT COVER PROVIDED	119336 86413
TOTAL LIVE PLANT COVERAGE	2Ø5749

Drainage Basin Treatments Per City of Albuquerque Drainage Basin Treatments

The bottom and sides must be seeded with a native mix per City Standard specification 1012.2 depending on soil type for that City area. Please reference this native seed selection and the section on plan sheet.


For pond bottoms: Gravel ¾ to 1 inch mulch. One layer thick, not stacked

Native grass establishment must be achieved by the greater spacing, . Spacing shall be approved as contractor within a 3 year time frame. Temporary irrigation or water trucks must be used when rain is lacking. Seeds 2. On sites where evenly spaced street trees are not must germinate in one year or reseeding will likely be

of trees equals or exceeds the number that would Maintenance will be per City of Albuquerque Specification 1012.3.9.1 and 1012.3.9.2.


> Contractor must weed the basin during/after the first growing season.

Needs city inspection. Stormwater Quality Ordinance-final stabilization must be accepted by the City.

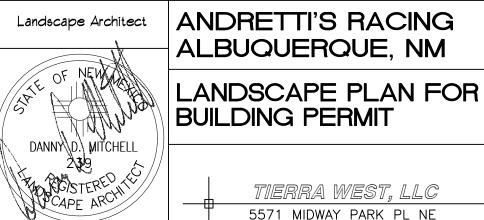

October 27, 2022


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SHEET #

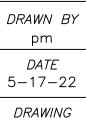2

JOB # 2022011



ELEVATIONS ARE TO FLOWLINE UNLESS OTHERWISE NOTED

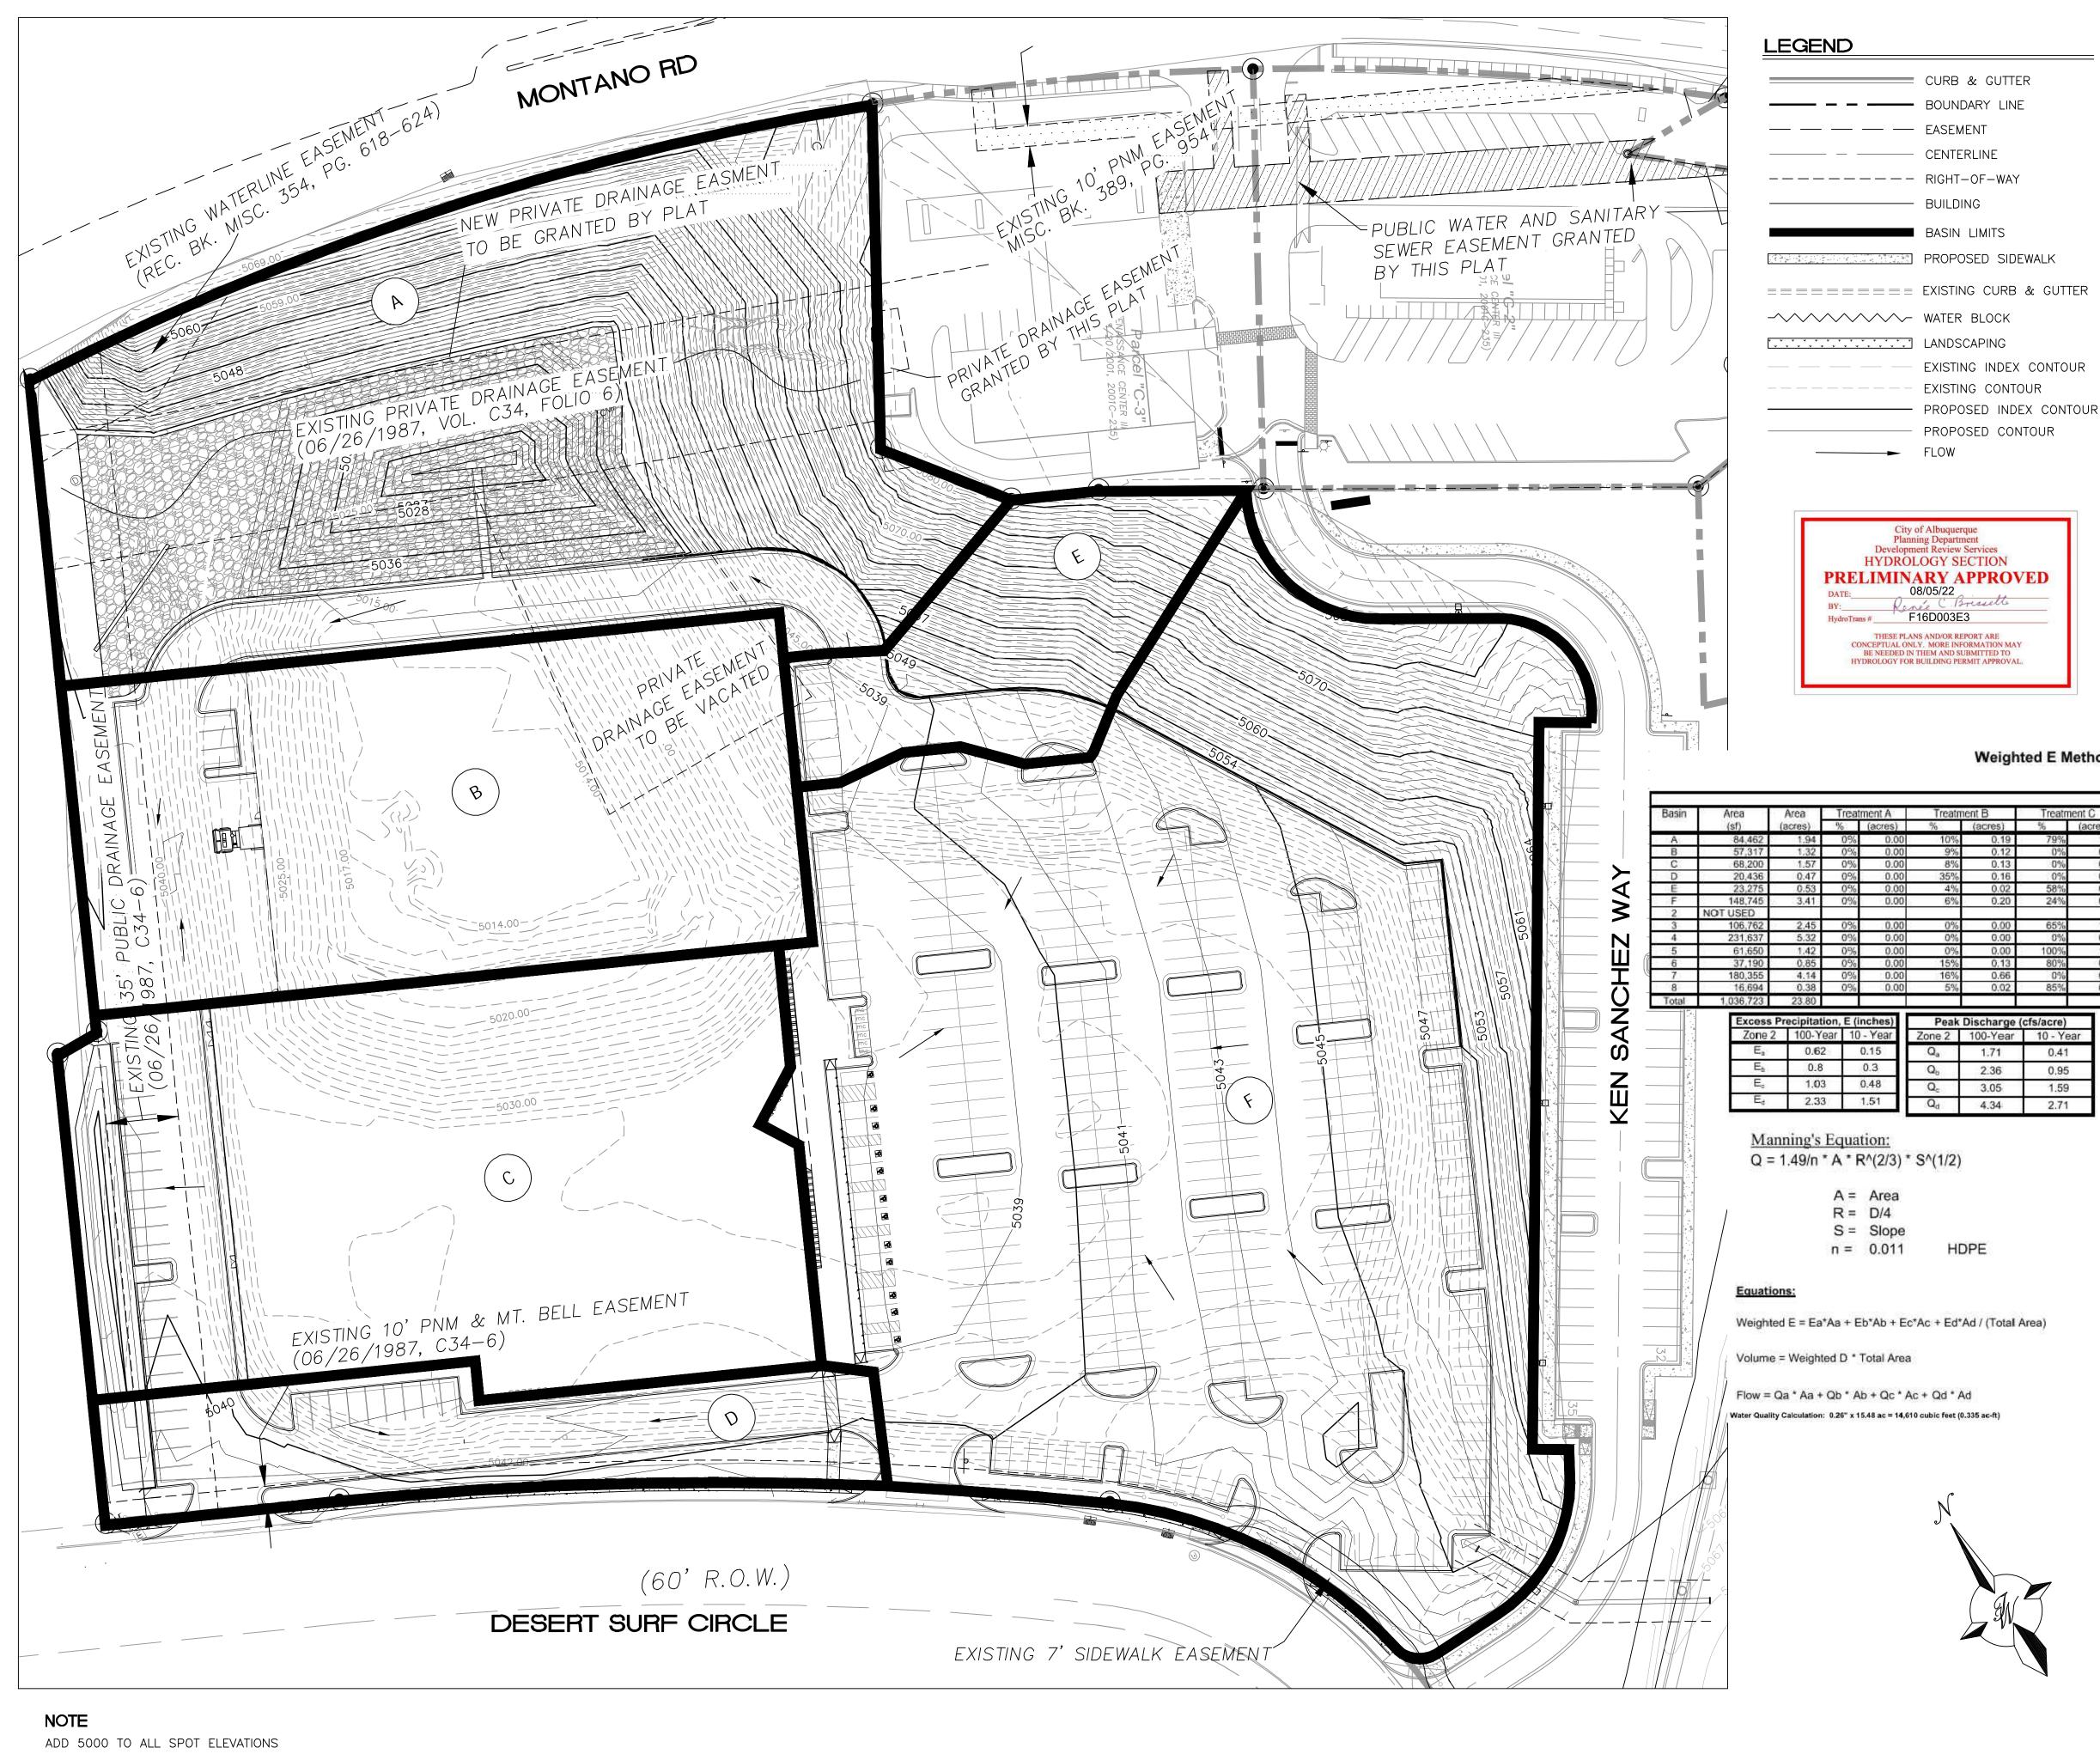

35001C0138H FIRM MAP:

## Weighted E Method

					100-Year, 6-hr		10-Year, 6 hr			100-Year, 10 day				
Treatm	ient B	Treatn	nent C	Treat	ment D	Weighted E	Volume	Flow	Weighted E	Volume	Flow	Weighted E	Volume	Flow
%	(acres)	%	(acres)	%	(acres)		(ac-ft)	cfs		(ac-ft)	cfs		(ac-ft)	cfs
10%	0.19	79%	1.53	11%	0.21	1.150	0.186	6.06	0.575	0.093	3.20	1.150	0.212	6.06
9%	0.12	0%	0.00	91%	1.20	2.192	0.240	5,48	1,401	0.154	3.36	2,192	0.387	5.48
8%	0.13	0%	0.00	92%	1.44	2.208	0.288	6.55	1.413	0.184	4.02	2.208	0.464	6.55
35%	0.16	0%	0.00	65%	0.30	1,795	0.070	1.71	1.087	0.042	0.98	1.795	0.108	1.71
4%	0.02	58%	0.31	38%	0.20	1.515	0.067	1,88	0.864	0.038	1.06	1,515	0.092	1.88
6%	0.20	24%	0.82	70%	2.39	1.926	0.548	13.36	1,190	0.339	7.98	1.926	0.841	13.36
0%	0.00	65%	1.59	35%	0.86	1.485	0.303	8.58	0.841	0.172	4.86	1.485	0.408	8.58
0%	0.00	0%	0.00	100%	5.32	2.330	1.033	23.08	1.510	0.669	14.41	2.330	1.684	23.08
0%	0.00	100%	1.42	0%	0.00	1.030	0.121	4.32	0.480	0.057	2.25	1.030	0.121	4,32
15%	0.13	80%	0.68	5%	0.04	1.061	0.075	2.57	0.505	0.036	1.32	1.061	0.081	2.57
16%	0.66	0%	0.00	84%	3.48	2.085	0.719	16.66	1.316	0.454	10.05	2.085	1.146	16.66
5%	0.02	85%	0.33	10%	0.04	1.149	0.037	1.21	0.574	0.018	0.64	1,149	0.041	1.21
					15,48		3.689	91.43		2.256	54.14		5.586	91.43

Peak Discharge (cfs/acre)				
ne 2	100-Year	10 - Year		
2 <sub>a</sub>	1.71	0.41		
) <sub>b</sub>	2.36	0.95		
۵ <sub>c</sub>	3.05	1.59		
2 <sub>d</sub>	4.34	2.71		

THIS SITE IS CURRENTLY VACANT AND WAS FORMALLY PART OF THE BEACH WATERPARK. THE SITE IS LOCATED WITHIN BASIN 1 OF THE OVERALL TOP GOLF MASTER GRADING AND DRAINAGE PLAN (F16D003E1) COMPLETED BY TIERRA WEST LLC AND APPROVED 10/29/18. THE SITE IS BOUNDED BY REVEL ENTERTAINMENT TO THE WEST, MONTANO ROAD TO THE NORTH, DESERT SURF CIRCLE TO THE SOUTH AND KEN SANCHEZ WAY TO THE EAST. AS PER THE APPROVED OVERALL DRAINAGE PLAN THERE ARE A NUMBER OF PARCELS THAT DRAIN TO THE EXISTING POND LOCATED IN THE NORTHWEST CORNER OF THE SITE. THE SITE IS LOCATED ON FIRM MAP 3500C0138H AS SHOWN ABOVE. THE MAP SHOWS THAT THE SITE DOES NOT LIE WITHIN ANY 100 YEAR FLOOD PLAIN.

## PROPOSED DRAINAGE:


EXISTING DRAINAGE:

THE SITE WILL CONTINUE TO DRAIN AS PER THE APPROVED TOP GOLF DRAINAGE PLAN. ALL OF THE DRAINAGE WILL BE DIRECTED TO THE POND LOCATED IN THE NORTHWEST CORNER OF THE SITE. THE POND IS CURRENTLY A DETENTION POND DUE TO THE DEPTH BUT IT WILL BE RAISED AND CONVERTED BACK TO A RETENTION POND AS IT WAS PREVIOUSLY DESIGNED. ACCORDING TO THE RENAISSANCE CENTER MASTER DRAINAGE PLAN THE DISCHARGE FROM THE POND IS RESTRICTED TO 0.10 CFS PER ACRE THAT DRAINS TO IT. THE POND ACCEPTS DRAINAGE FROM 23.8 ACRES SO THE RELEASE RATE WILL BE 2.38 CFS. THE POND IS SIZED FOR THE 100YR, 6HR STORM AND WILL ALSO RETAIN THE REQUIRED STORM WATER QUALITY VOLUME PER THE DPM. OFF SITE FLOWS ARE ALSO DIRECTED TO THIS POND AND WILL BE RELEASED AT A RATE OF 36.28 CFS WHICH IS THE FLOW IN THE PIPE PRIOR TO THE DIVERSION. THEREFORE THE TOTAL DISCHARGE FROM THE POND WILL BE 38.66 CFS

ENGINEER'S SEAL	ANDRETTI'S RACING ALBUQUERQUE, NM	DRAWN BY JL
	,	DATE
	CONCEPTUAL	6-8-22
	DRAINAGE PLAN	DRAWING
		SHEET #
	TIERRA WEST, LLC	GR-1
	L 5571 MIDWAY PARK PL NE ALBUQUERQUE, NEW MEXICO 87109	
RONALD R. BOHANNAN	(505) 858-3100 www.tierrawestllc.com	JOB #

RUNALD R. BOHANNAN P.E. #7868

2022011

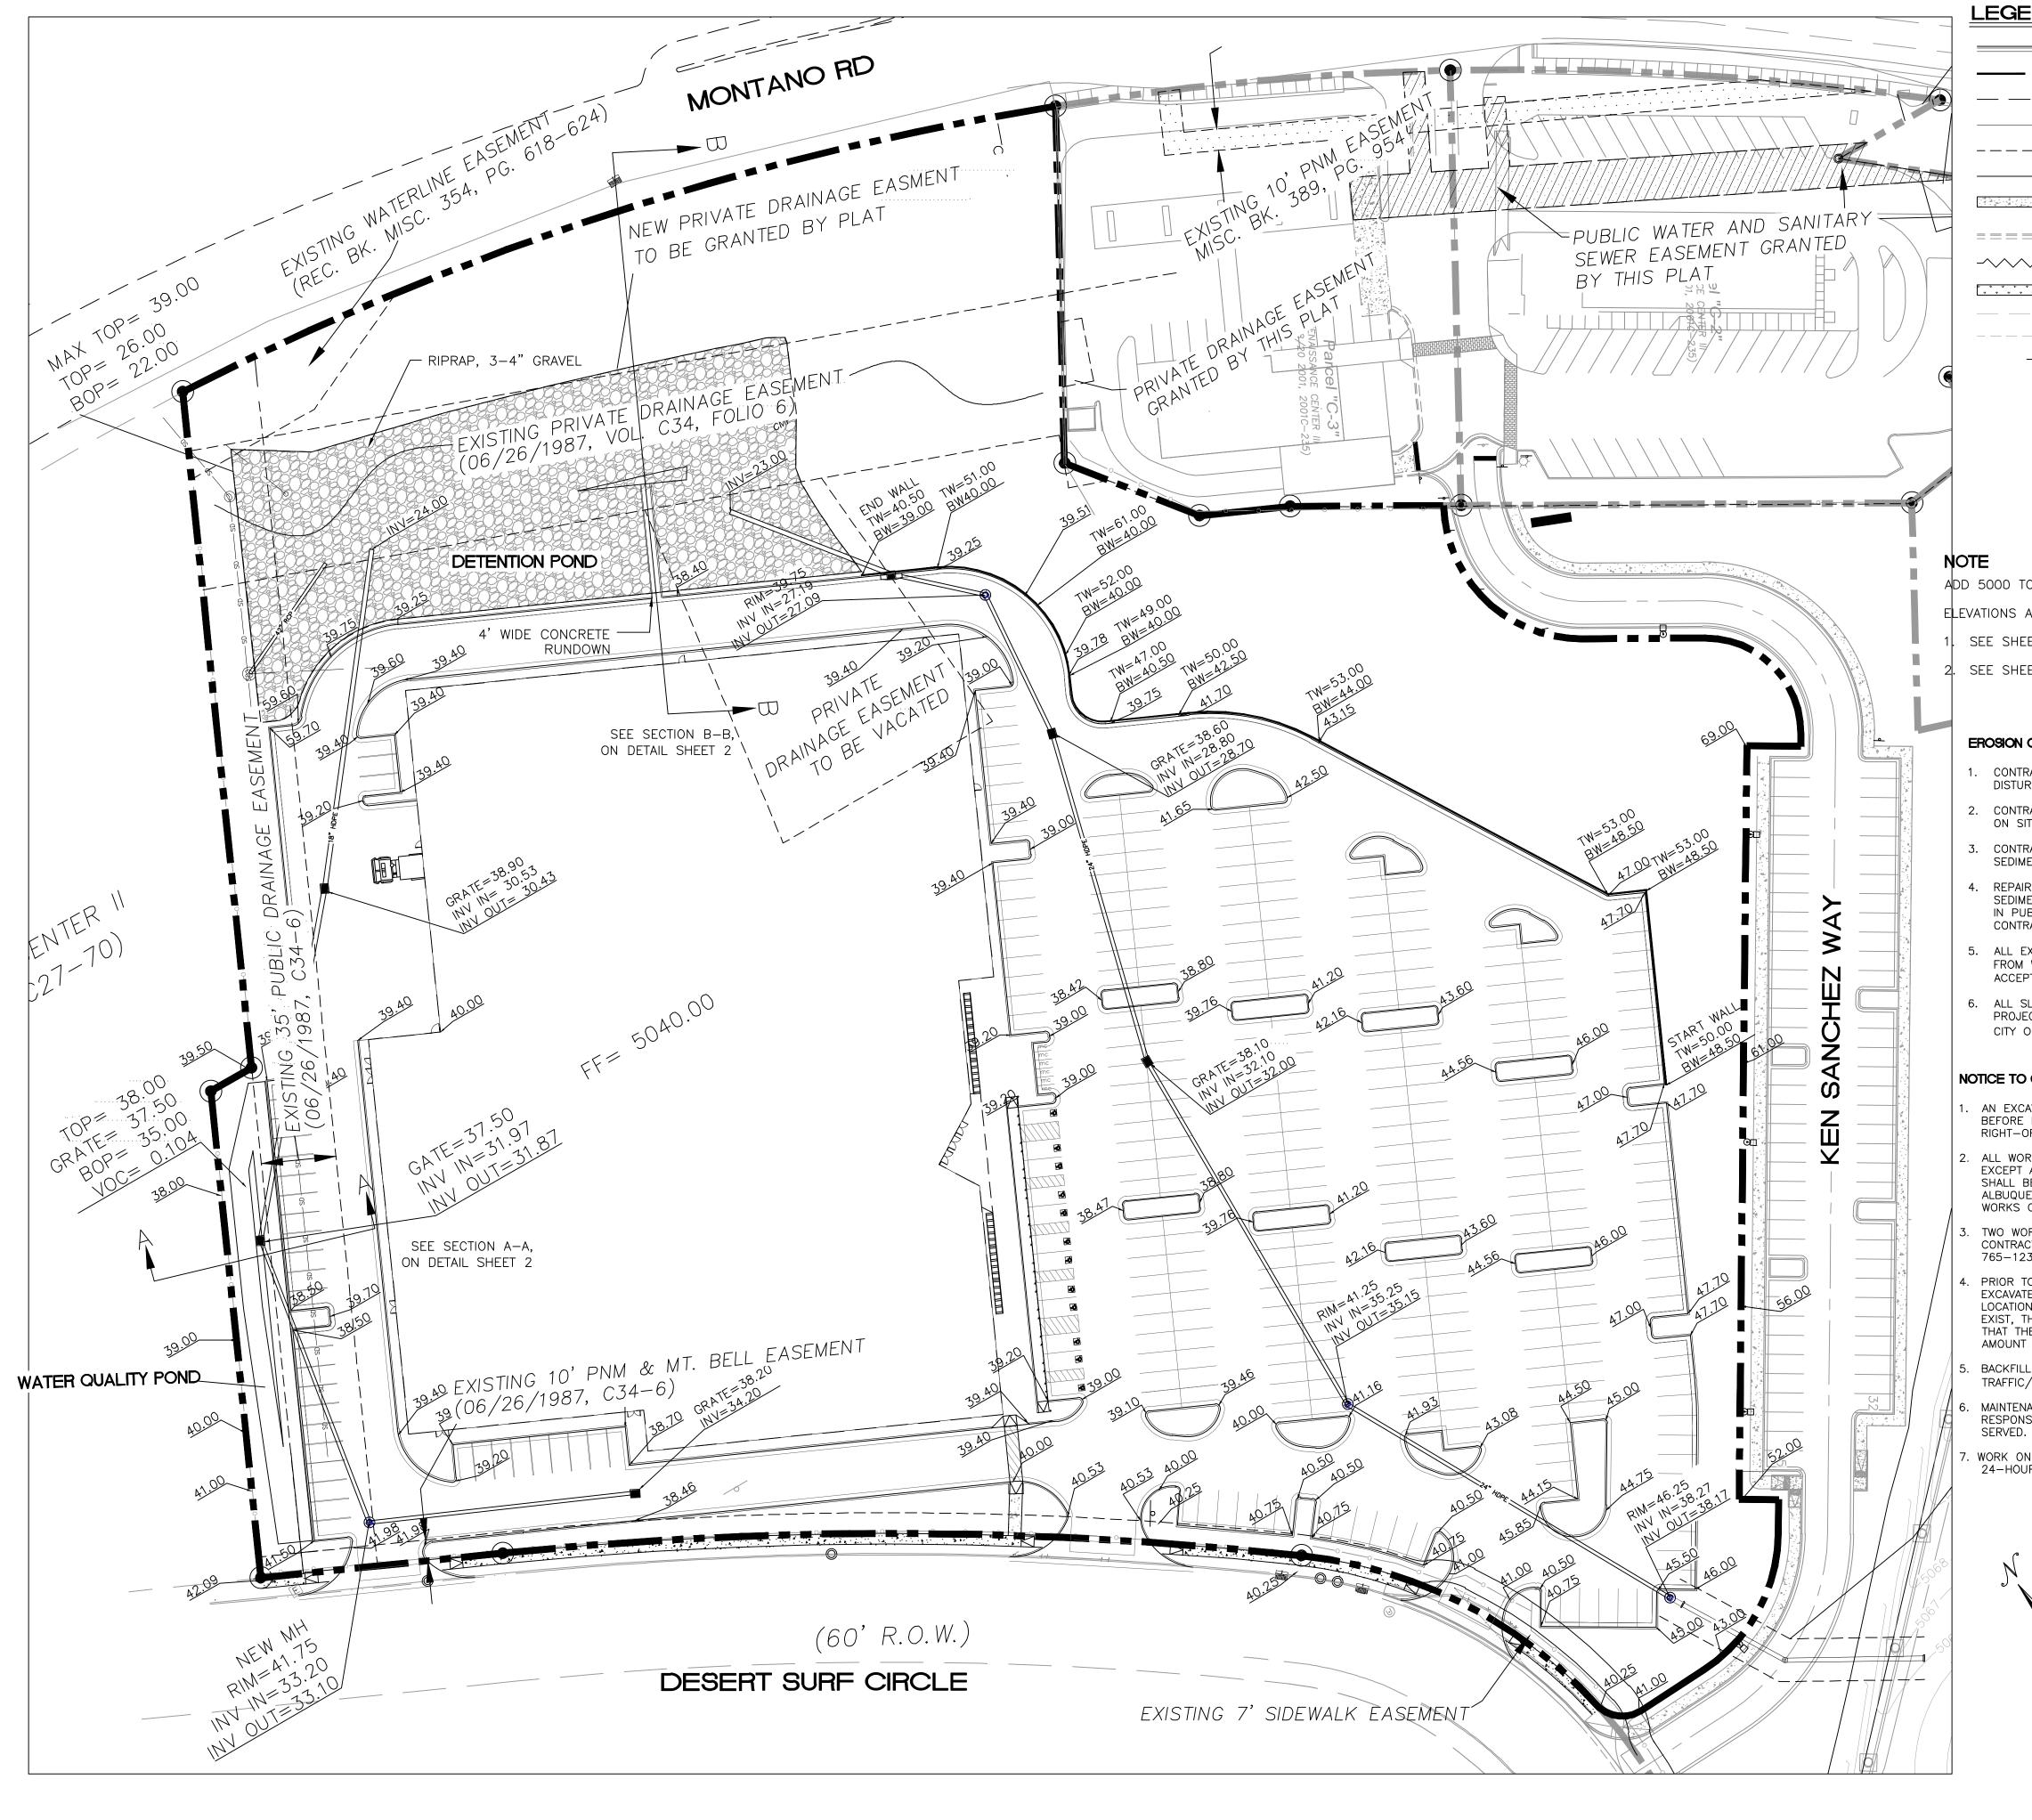

## LEGEND

	CURB & GUTTER
	BOUNDARY LINE
	EASEMENT
	CENTERLINE
	RIGHT-OF-WAY
	BUILDING
	PROPOSED SIDEWALK
	EXISTING CURB & GUTTER
~~~~~~~~~~~~~~~~~~~~~~~~~~~~~~~~~~~~~~~	WATER BLOCK
* * * * * * * * * * * * * * * * * * * *	LANDSCAPING
	EXISTING INDEX CONTOUR
	EXISTING CONTOUR
	FLOW

## VOLUME CALCULATIONS Water Quality Pond

Ab - Bottom Of The Pond Surface Area At - Top Of The Pond Surface Area D - Water Depth Dt - Total Pond Depth C - Change In Surface Area / Water Depth

olume = Ab '	* D + 0.5 * C * D <sup>2</sup>
= (At - Ab)	/ Dt
Ab =	667.00
At =	4,184.00
Dt =	3.00

C = 1172.33

ACTUAL ELEV	DEPTH (FT)	VOLUME (AC-FT)	
5035.00	0.00	0.00	
5035.50	0.50	0.0077	
5036.00	1.00	0.0187	-
5036.50	1.50	0.0364	
5037.00	2.00	0.0609	
5037.50	2.50	0.0921	Grate Elevation
5038.00	3.00	0.1300	

ADD 5000 TO ALL SPOT ELEVATIONS

ELEVATIONS ARE TO FLOWLINE UNLESS OTHERWISE NOTED

SEE SHEET GR-3 FOR STORM SEWER INFORMATION

SEE SHEET GR-4 FOR RETAINING WALL INFORMATION

### EROSION CONTROL NOTES:

CONTRACTOR IS RESPONSIBLE FOR OBTAINING A TOPSOIL DISTURBANCE PERMIT PRIOR TO BEGINNING WORK.

2. CONTRACTOR IS RESPONSIBLE FOR MAINTAINING RUN-OFF ON SITE DURING CONSTRUCTION.

CONTRACTOR IS RESPONSIBLE FOR CLEANING ALL SEDIMENT THAT GETS INTO EXISTING RIGHT-OF-WAY.

REPAIR OF DAMAGED FACILITIES AND CLEANUP OF SEDIMENT ACCUMULATIONS ON ADJACENT PROPERTIES AND IN PUBLIC FACILITIES IS THE RESPONSIBILITY OF THE CONTRACTOR.

5. ALL EXPOSED EARTH SURFACES MUST BE PROTECTED FROM WIND AND WATER EROSION PRIOR TO FINAL (CITY) ACCEPTANCE OF ANY PROJECT.

6. ALL SLOPES NOT STABILIZED AT THE END OF THE PROJECT SHALL BE STABILIZED IN ACCORDANCE WITH THE CITY OF ALBUQUERQUE SPECS OR ₹ GRAVEL

### NOTICE TO CONTRACTORS

AN EXCAVATION/CONSTRUCTION PERMIT WILL BE REQUIRED BEFORE BEGINNING ANY WORK WITHIN CITY RIGHT-OF-WAY.

ALL WORK DETAILED ON THESE PLANS TO BE PERFORMED, EXCEPT AS OTHERWISE STATED OR PROVIDED HERON, SHALL BE CONSTRUCTED IN ACCORDANCE WITH CITY OF ALBUQUERQUE STANDARD SPECIFICATIONS FOR PUBLIC WORKS CONSTRUCTION.


TWO WORKING DAYS PRIOR TO ANY EXCAVATION, CONTRACTOR MUST CONTACT LINE LOCATING SERVICE, 765-1234, FOR LOCATION OF EXISTING UTILITIES.

PRIOR TO CONSTRUCTION, THE CONTRACTOR SHALL EXCAVATE AND VERIFY THE HORIZONTAL AND VERTICAL LOCATIONS OF ALL CONNECTIONS. SHOULD A CONFLICT EXIST, THE CONTRACTOR SHALL NOTIFY THE ENGINEER SO THAT THE CONFLICT CAN BE RESOLVED WITH A MINIMUM AMOUNT OF DELAY.

BACKFILL COMPACTION SHALL BE ACCORDING TO TRAFFIC/STREET USE.

MAINTENANCE OF THESE FACILITIES SHALL BE THE RESPONSIBILITY OF THE OWNER OF THE PROPERTY

WORK ON ARTERIAL STREETS SHALL BE PERFORMED ON A 24-HOUR BASIS.

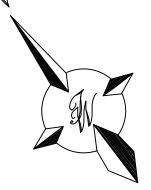

ENGINEER'S SEAL

RONALD R. BOHANNAN P.E. #7868

**VOLUME CALCULATIONS** DETENTION POND

Ab - Bottom Of The Pond Surface Area

At - Top Of The Pond Surface Area

D - Water Depth Dt - Total Pond Depth

C - Change In Surface Area / Water Depth

Volume =	Ab * D + 0.5 * C * D
C = (At -	Ab) / Dt

- (m	- ADJ	1	DI
	Ab =		940


ACT


At	=	29,965.00
Dt	=	16.50


Dt =	16.50	
C =	1759.09	
UAL	DEPTH	V

]	Q (CFS)	VOLUME (AC-FT)	DEPTH (FT)	ACTUAL ELEV.
	0.0000	0.00	0.00	5022.50
1	0.0000	0.0216	1.00	5023.50
	0.0000	0.0634	2.00	5024.50
1	0.0000	0.1455	3.00	5025.50
Water Quality Elevation	0.0000	0.2680	4.00	5026.50
	3.5176	0.4310	5.00	5027.50
1	13.4573	0.6343	6.00	5028.50
1	18.7036	0.8780	7.00	5029.50
1	22.7717	1.1620	8.00	5030.50
1	26.2160	1.4865	9.00	5031.50
1	29.2575	1.8513	10.00	5032.50
1	32.0114	2.2565	11.00	5033.50
1	34.5464	2.7021	12.00	5034.50
1	36.9078	3.1881	13.00	5035.50
100-yr Volume	38.6583	3.5974	13.78	5036.28
- 100000-9940-1009243(49974) -	40.1988	3.9951	14.50	5037.00
1	43.2323	4.8909	16.00	5038.50
1	44.1973	5.2097	16.50	5039.00

## Orifice Equation

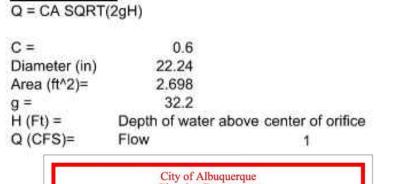

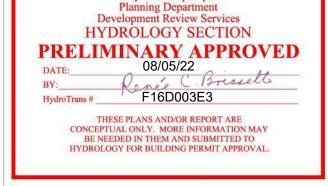

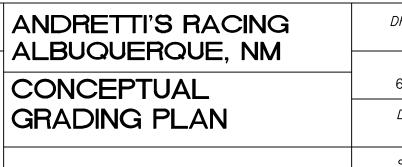

TIERRA WEST, LLC 5571 MIDWAY PARK PL NE ALBUQUERQUE, NEW MEXICO 87109 (505) 858-3100 www.tiérrawestllc.com

CONCEPTUAL


DRAWN BY JL DATE 6-8-22



SHEET #

GR-2

JOB # 2022011

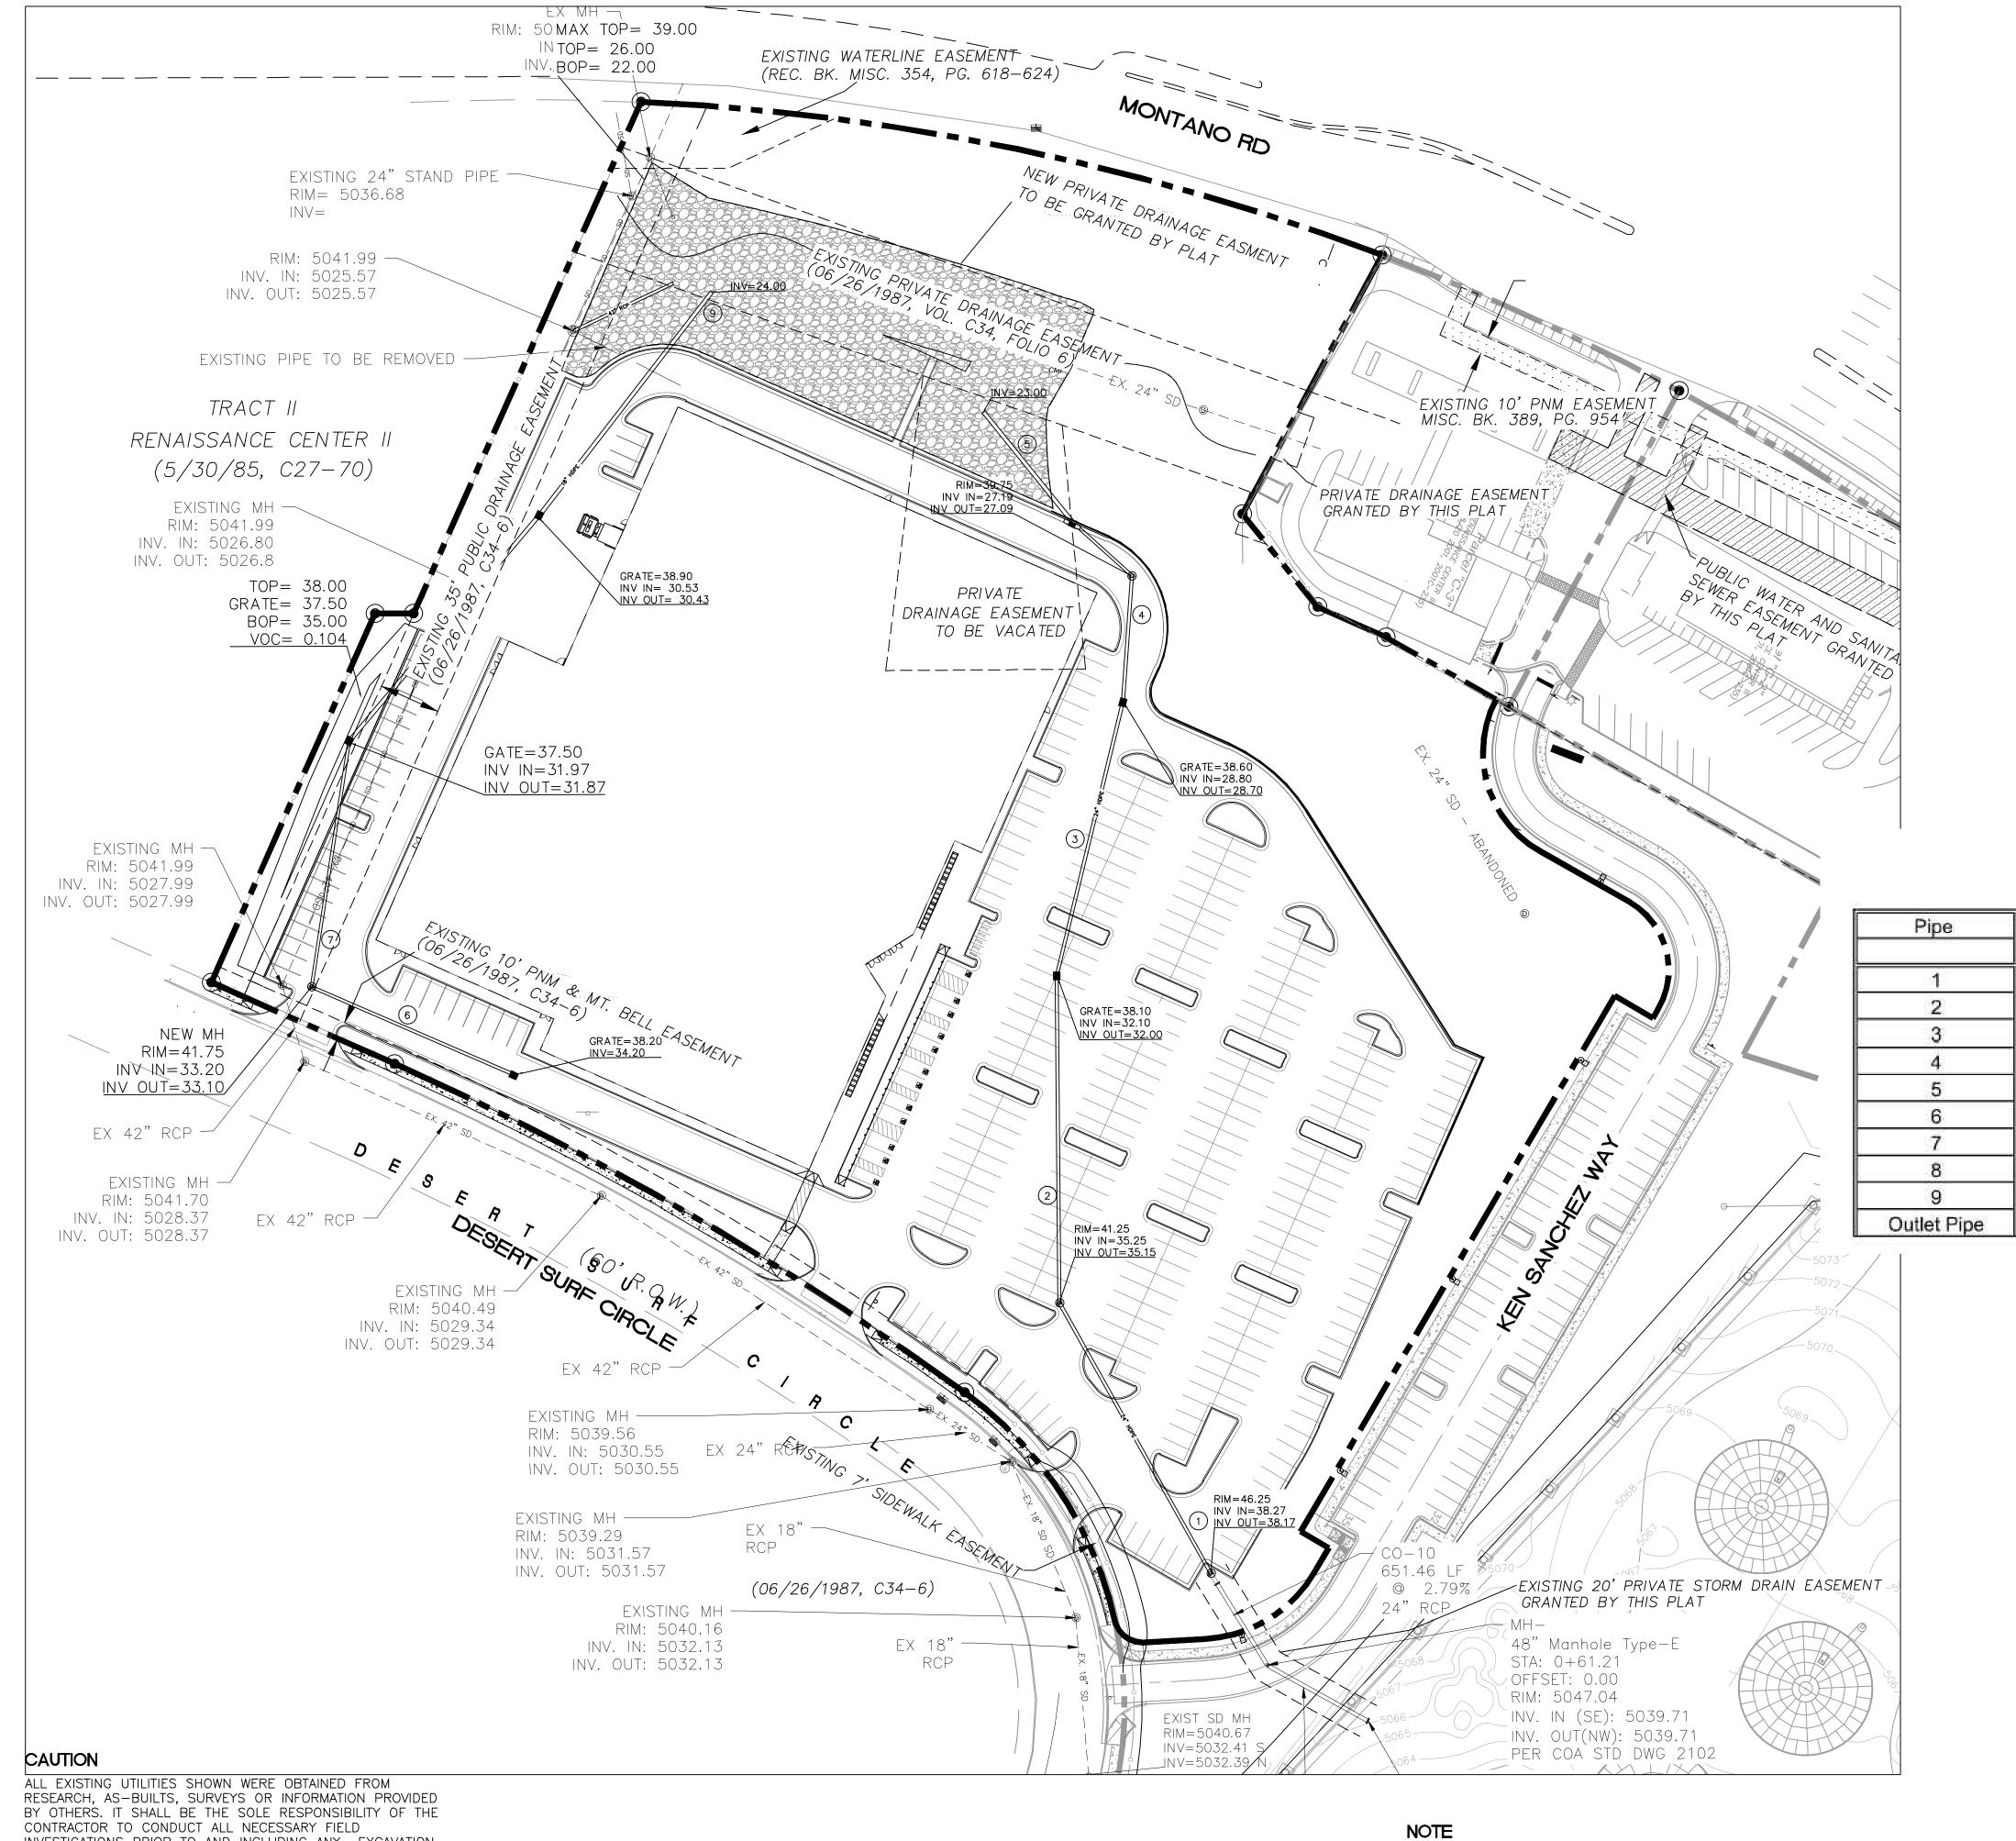

BY OTHERS. IT SHALL BE THE SOLE RESPONSIBILITY OF THE CONTRACTOR TO CONDUCT ALL NECESSARY FIELD INVESTIGATIONS PRIOR TO AND INCLUDING ANY EXCAVATION, TO DETERMINE THE ACTUAL LOCATION OF UTILITIES AND OTHER IMPROVEMENTS, PRIOR TO STARTING THE WORK. ANY CHANGES FROM THIS PLAN SHALL BE COORDINATED WITH AND APPROVED BY THE ENGINEER.


NOTE ADD 5000 TO ALL SPOT ELEVATIONS ELEVATIONS ARE TO FLOWLINE UNLESS OTHERWISE NOTED


## LEGEND


	CURB & GUTTER
	BOUNDARY LINE
	EASEMENT
	CENTERLINE
	RIGHT-OF-WAY
	BUILDING
	PROPOSED STORM DRAIN
	PROPOSED SIDEWALK
=========	EXISTING CURB & GUTTER
	WATER BLOCK
• • • • • • • • • • • • • • • • • • •	LANDSCAPING


## Pipe Capacity

D	Slope	Area	R	Q Provided	Q Required	Velocity
(in)	(%)	(ft^2)		(cfs)	(cfs)	(ft/s)
24	1.66	3.14	0.500	34.54	23.08	7.35
24	1.64	3.14	0.500	34.33	23.08	7.35
24	2.00	3.14	0.500	37.91	36.44	11.60
24	2.10	3.14	0.500	38.85	38.32	12.20
24	2.34	3.14	0.500	41.01	38.32	12.20
18	0.80	1.77	0.375	11.13	1.71	0.97
18	0.80	1.77	0.375	11.13	1.71	0.97
18	0.80	1.77	0.375	11.13	8.26	4.67
18	3.59	1.77	0.375	23.58	13.74	7.78
24	2.08	3.14	0.500	38.66	38.66	12.31

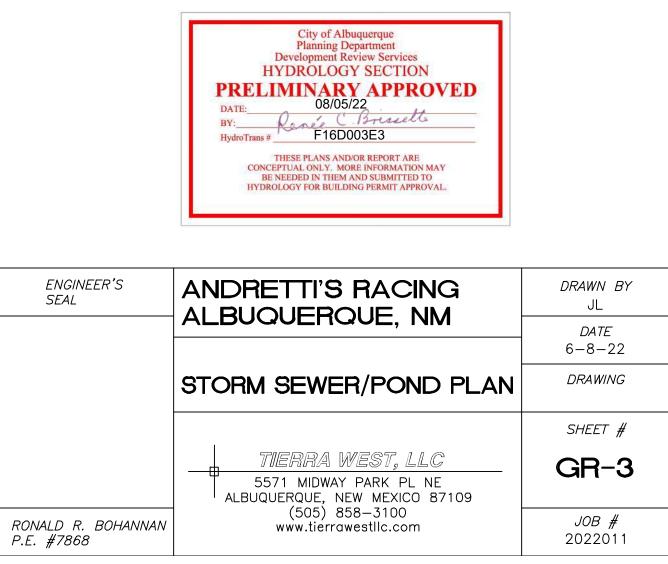


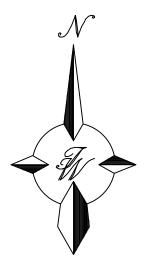


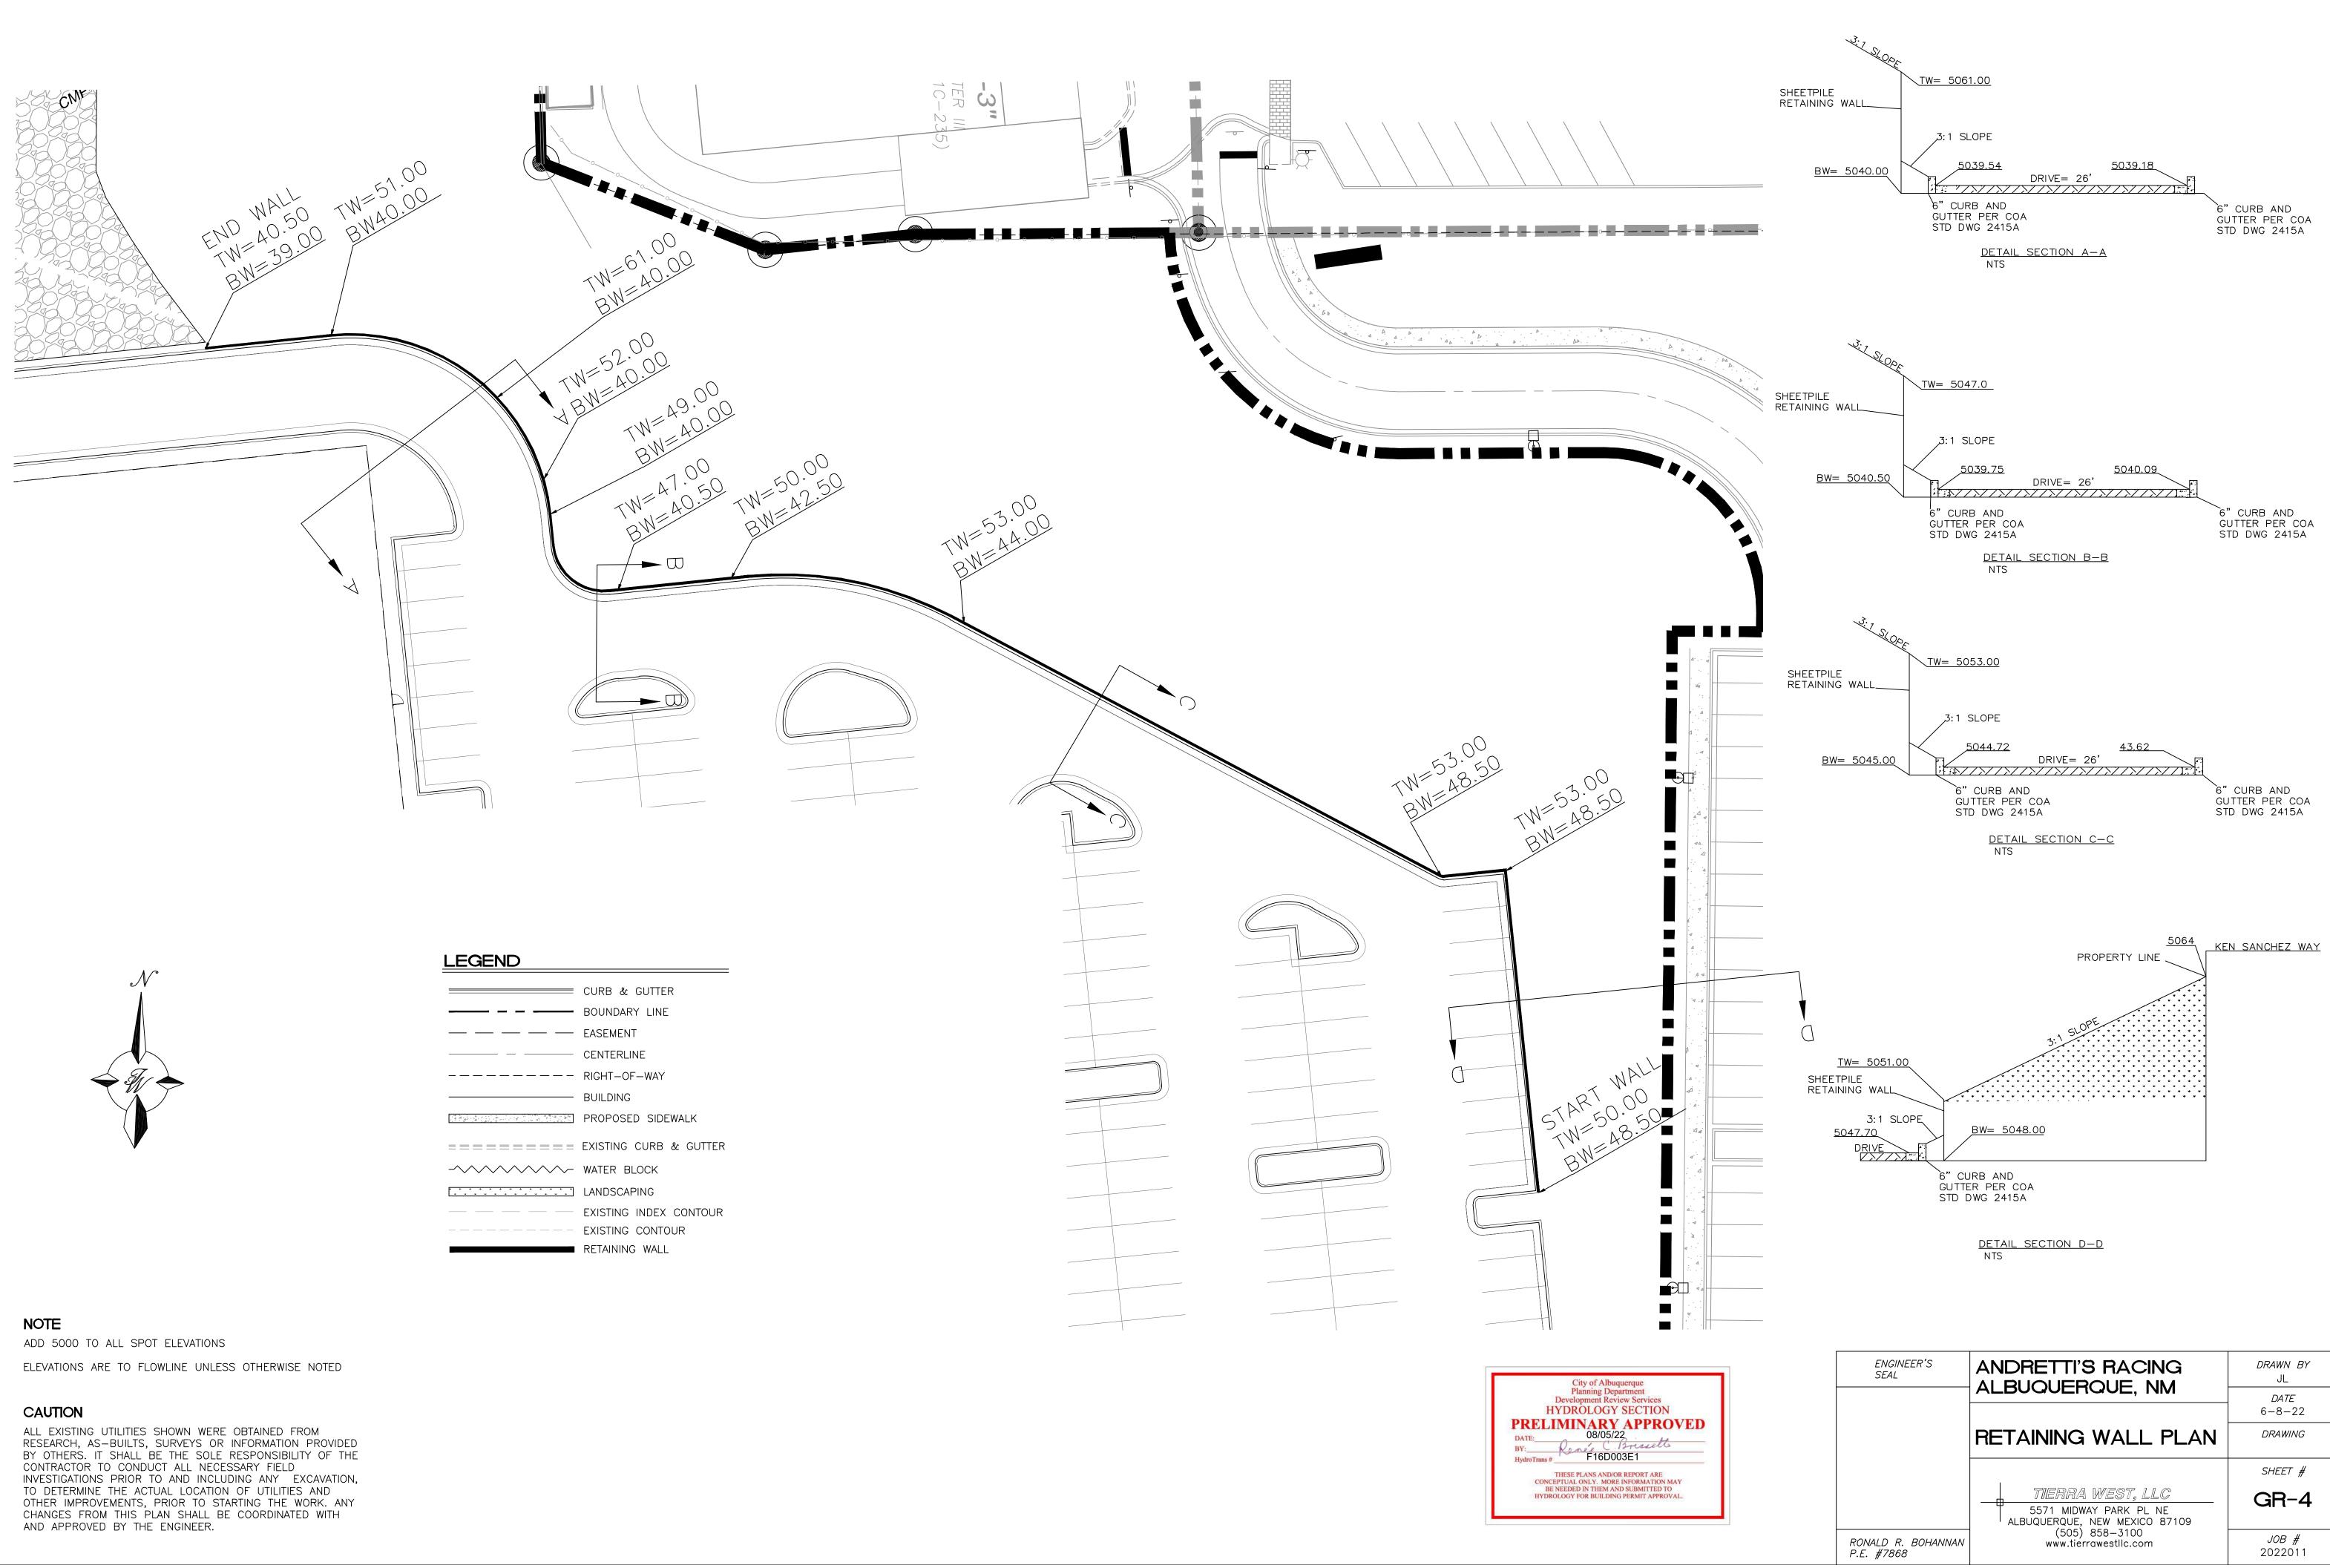

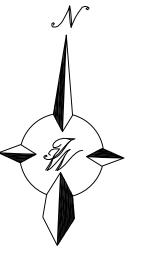

	CURB & GUTTER
	BOUNDARY LINE
	EASEMENT
	CENTERLINE
	RIGHT-OF-WAY
	BUILDING
	PROPOSED SIDEWALK
	EXISTING CURB & GUTTER
	WATER BLOCK
* * * * * * * * * * * * * *	LANDSCAPING
	EXISTING INDEX CONTOUR
	EXISTING CONTOUR
	RETAINING WALL

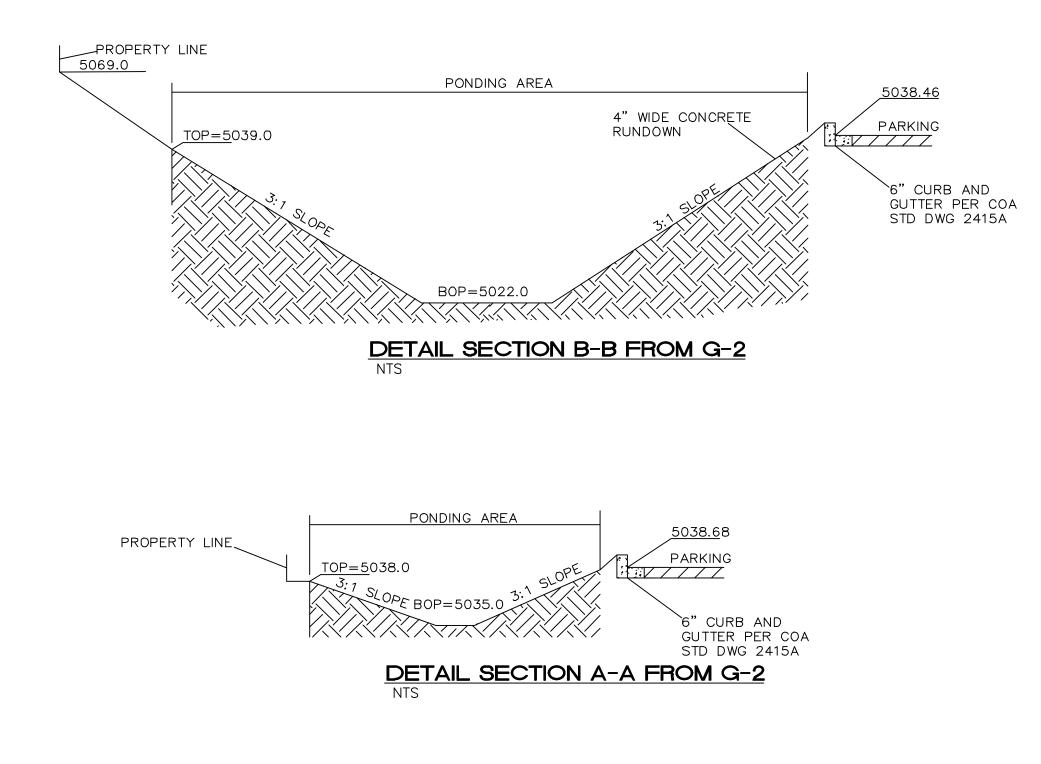

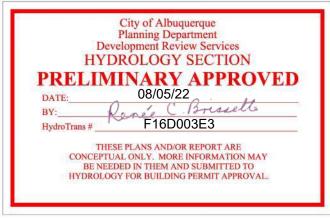

## ANDRETTI'S RACING ALBUQUERQUE, NM

DETAIL


TIERRA WEST, LLC 5571 MIDWAY PARK PL NE ALBUQUERQUE, NEW MEXICO 87109 (505) 858-3100 www.tierrawestllc.com DRAWN BY JL DATE 6-8-22 DRAWING



GR-2

RONALD R. BOHANNAN P.E. #7868

ENGINEER'S SEAL

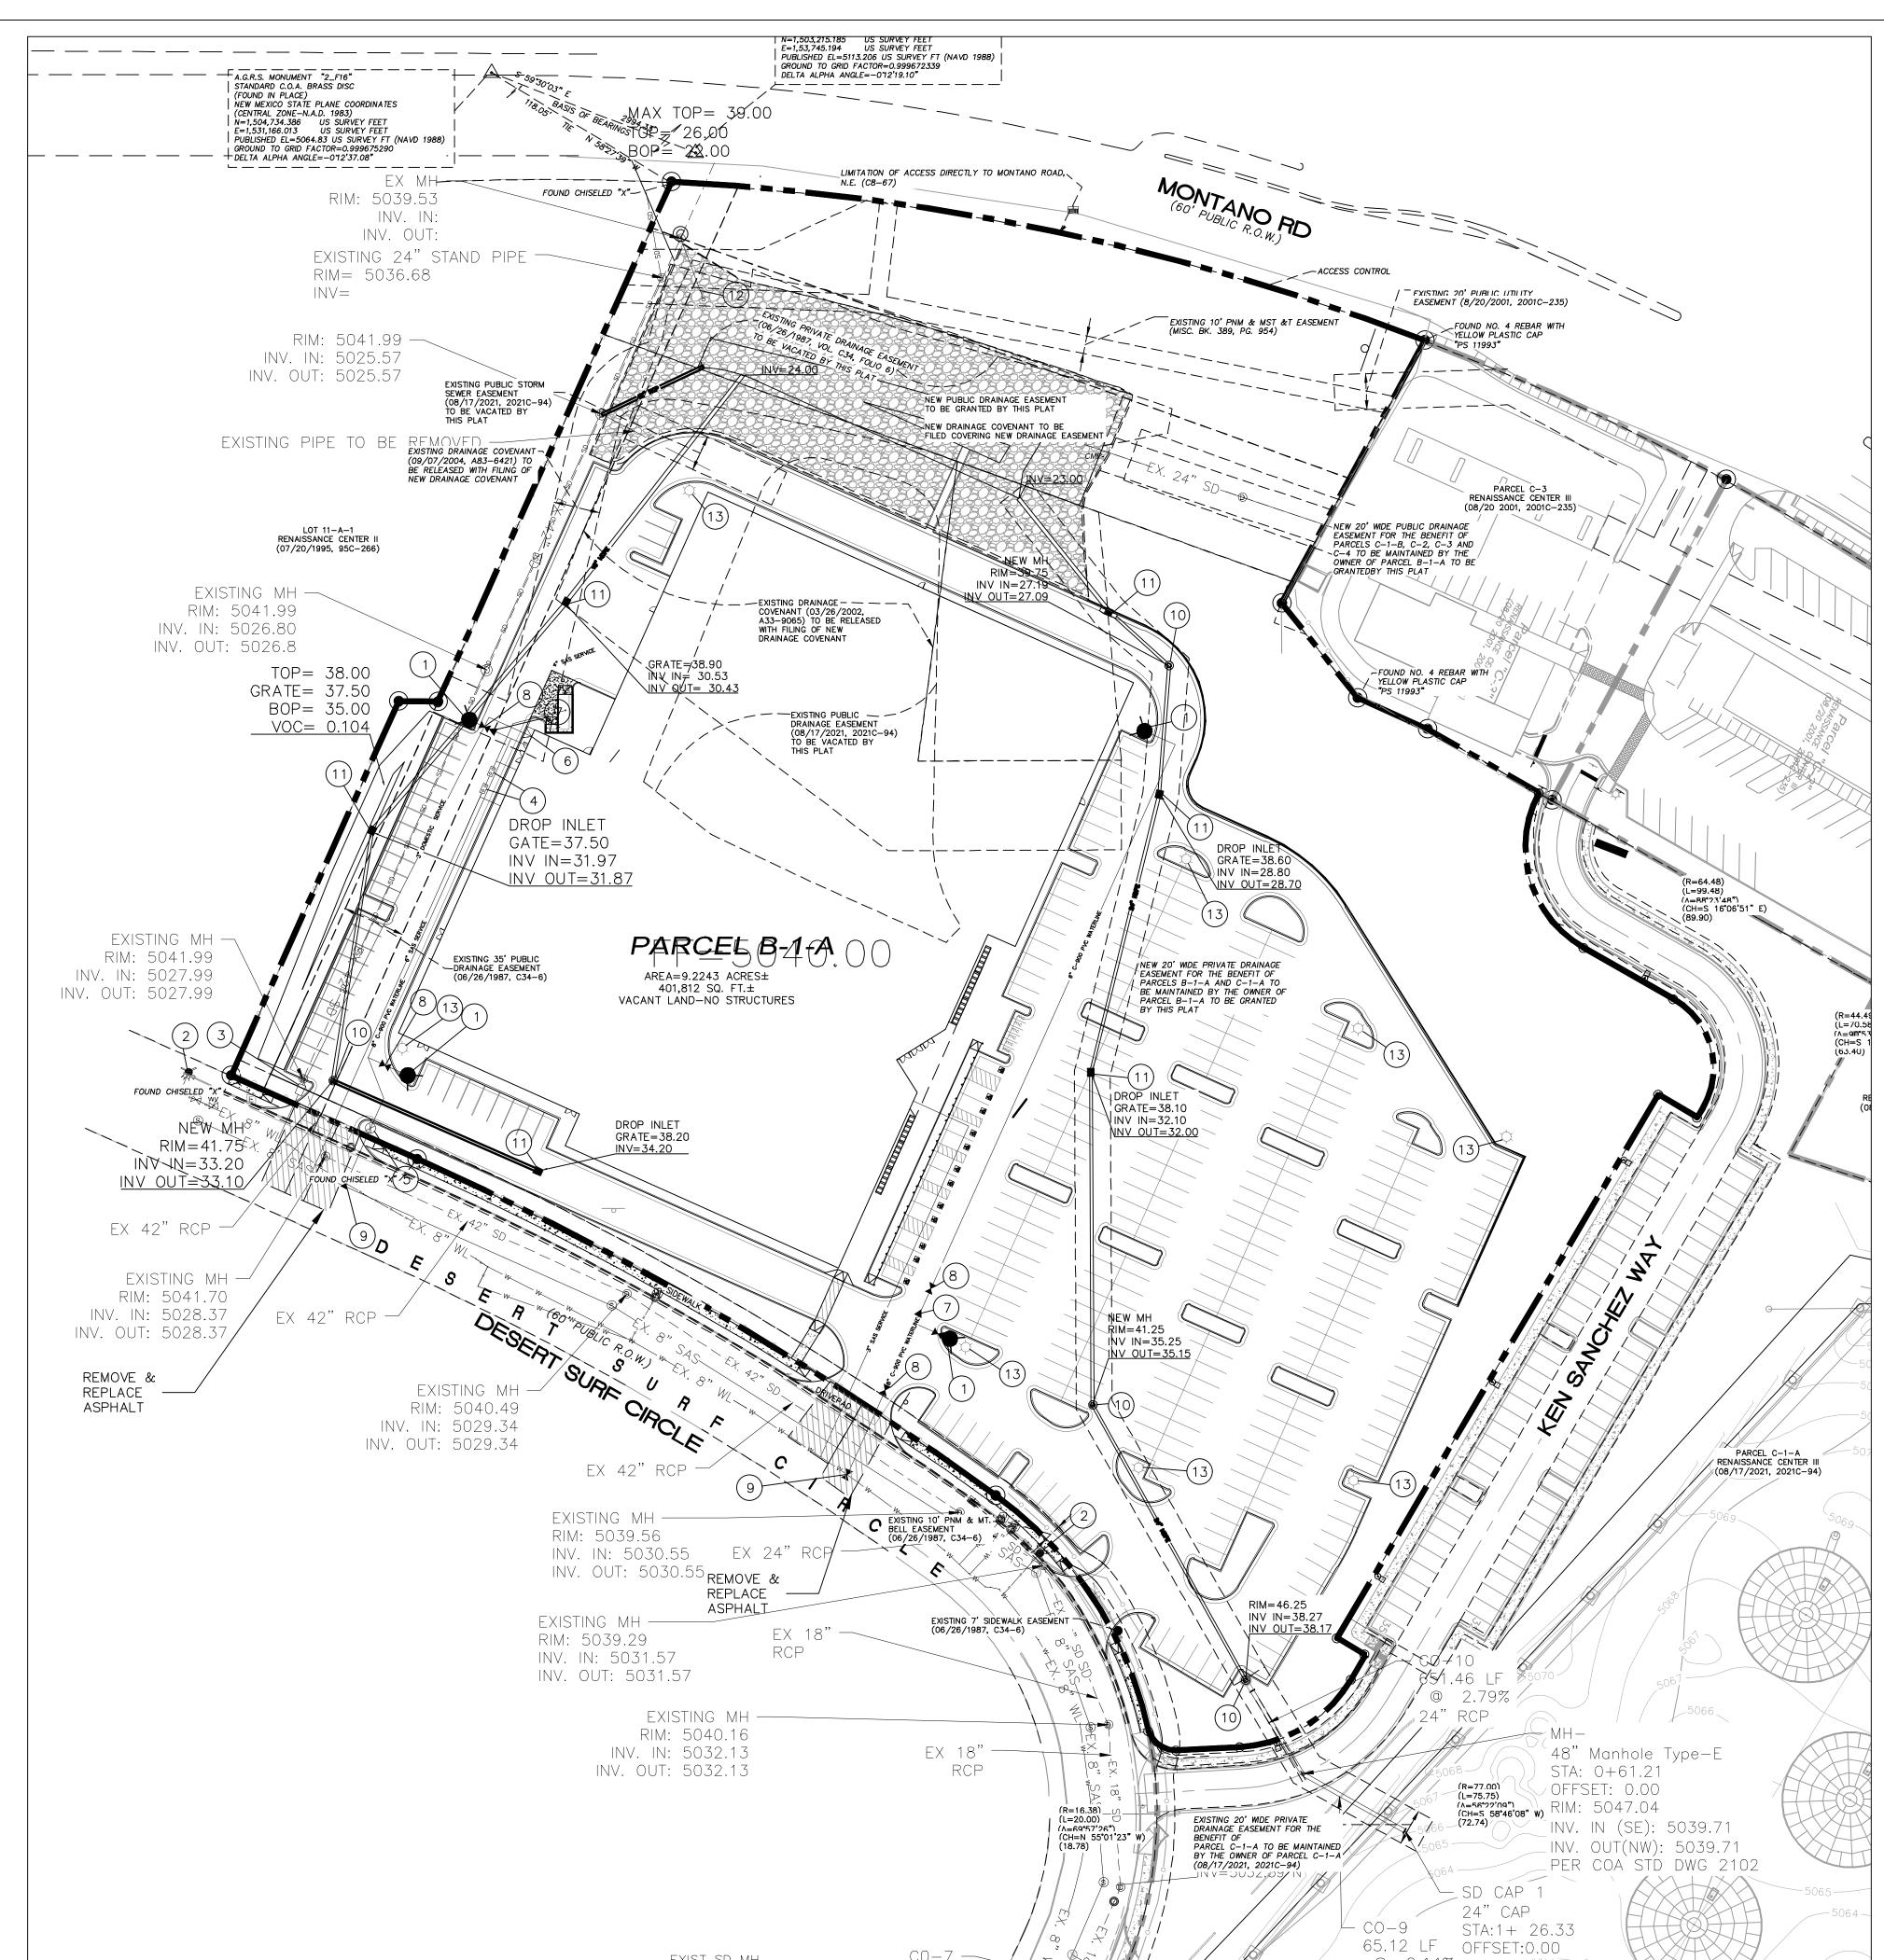

## LEGEND


	CURB
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	EXISTI
	EXISTI
$\mathcal{A}$	LIGHT

## KEYED NOTES

1) PROPOSED FIRE HYDRANT (2) EXISTING FIRE HYDRANT (3) 3" WATER METER PIT (4) PROPOSED GREASE INTERCEPTOR (5) PIV (6) FDC (7) 8"X6" REDUCER

## CAUTION

AND APPROVED BY THE ENGINEER.

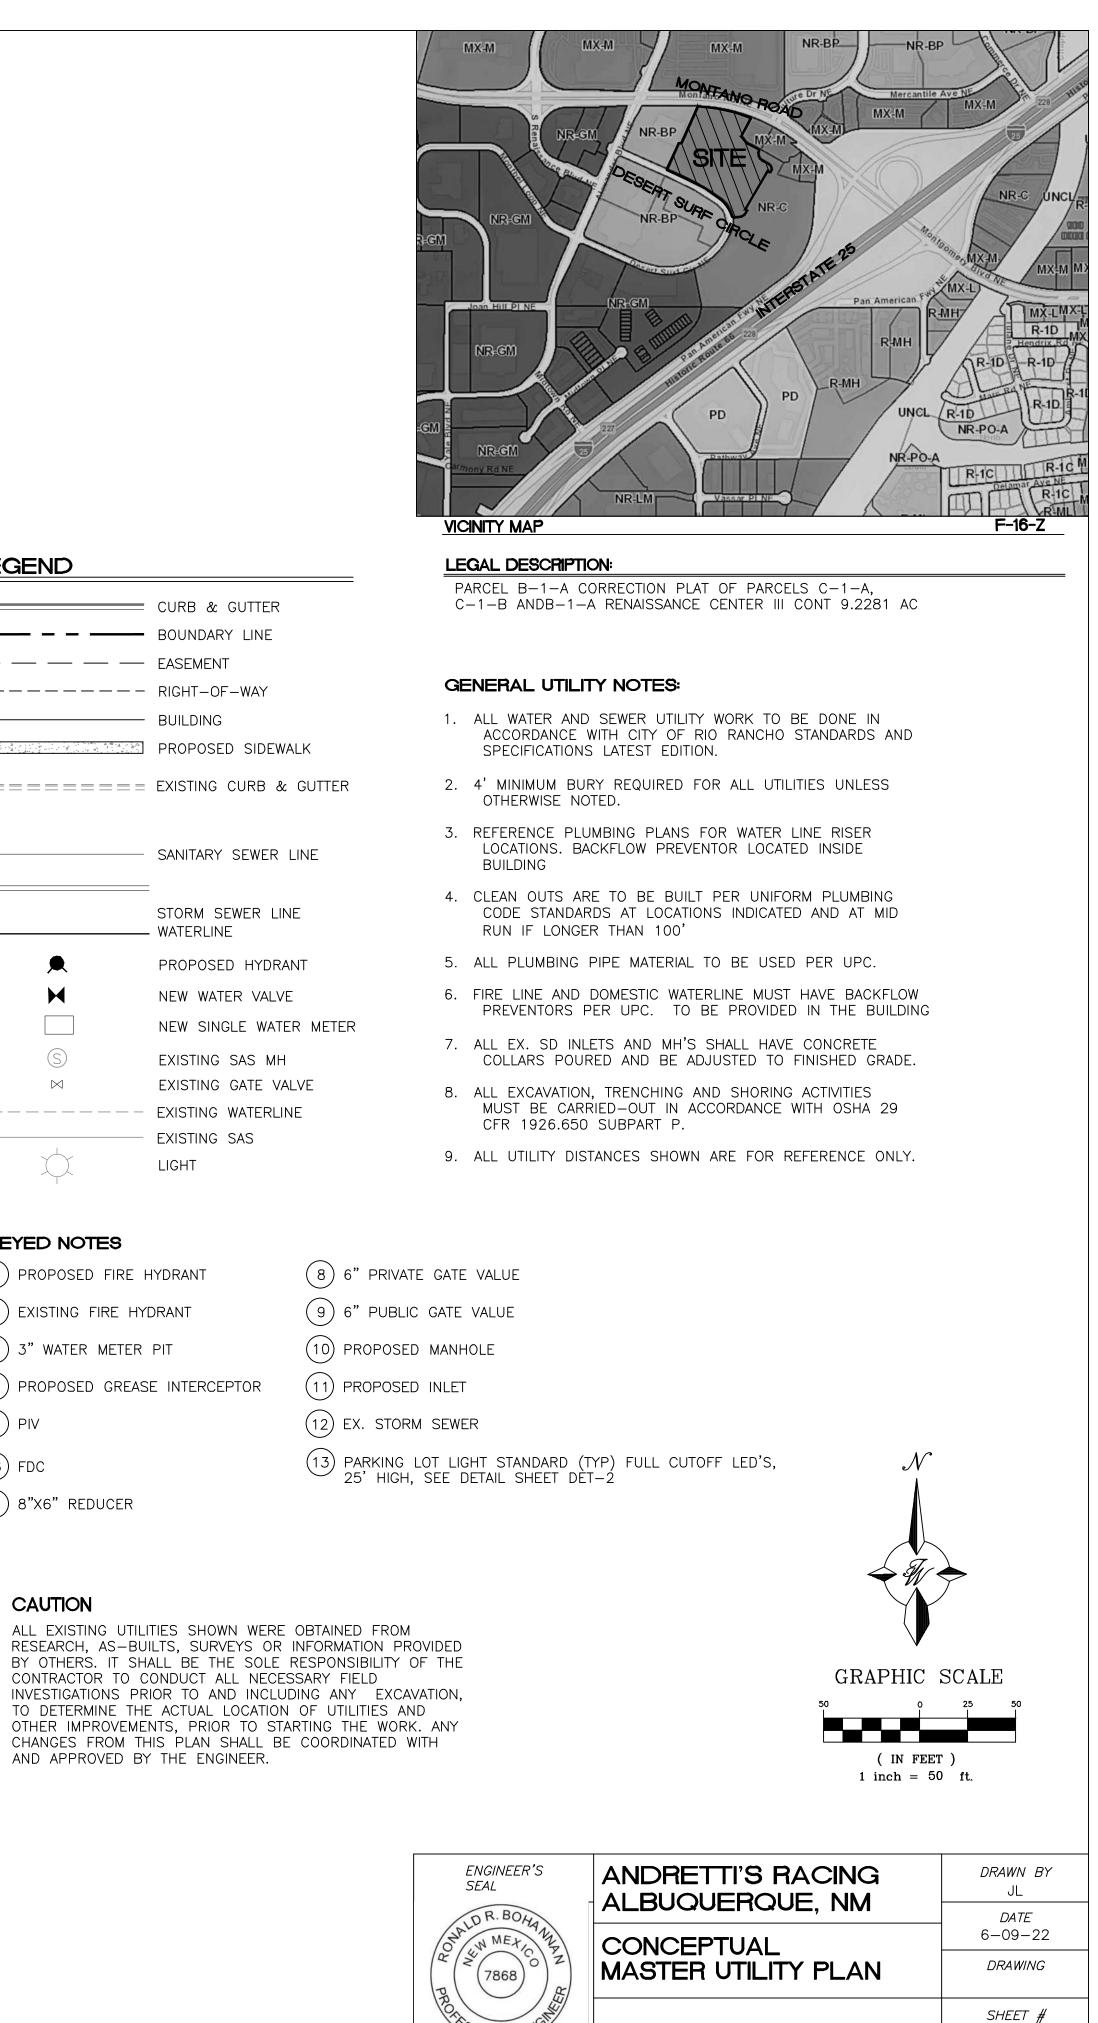

TIERRA WEST, LLC 5571 MIDWAY PARK PL NE ALBUQUERQUE, NEW MEXICO 87109 (505) 858-3100 www.tierrawestllc.com

SONALE


RONALD R. BOHANNAN


P.E. #7868

9/29/2022


MU-1


JOB # 2022011

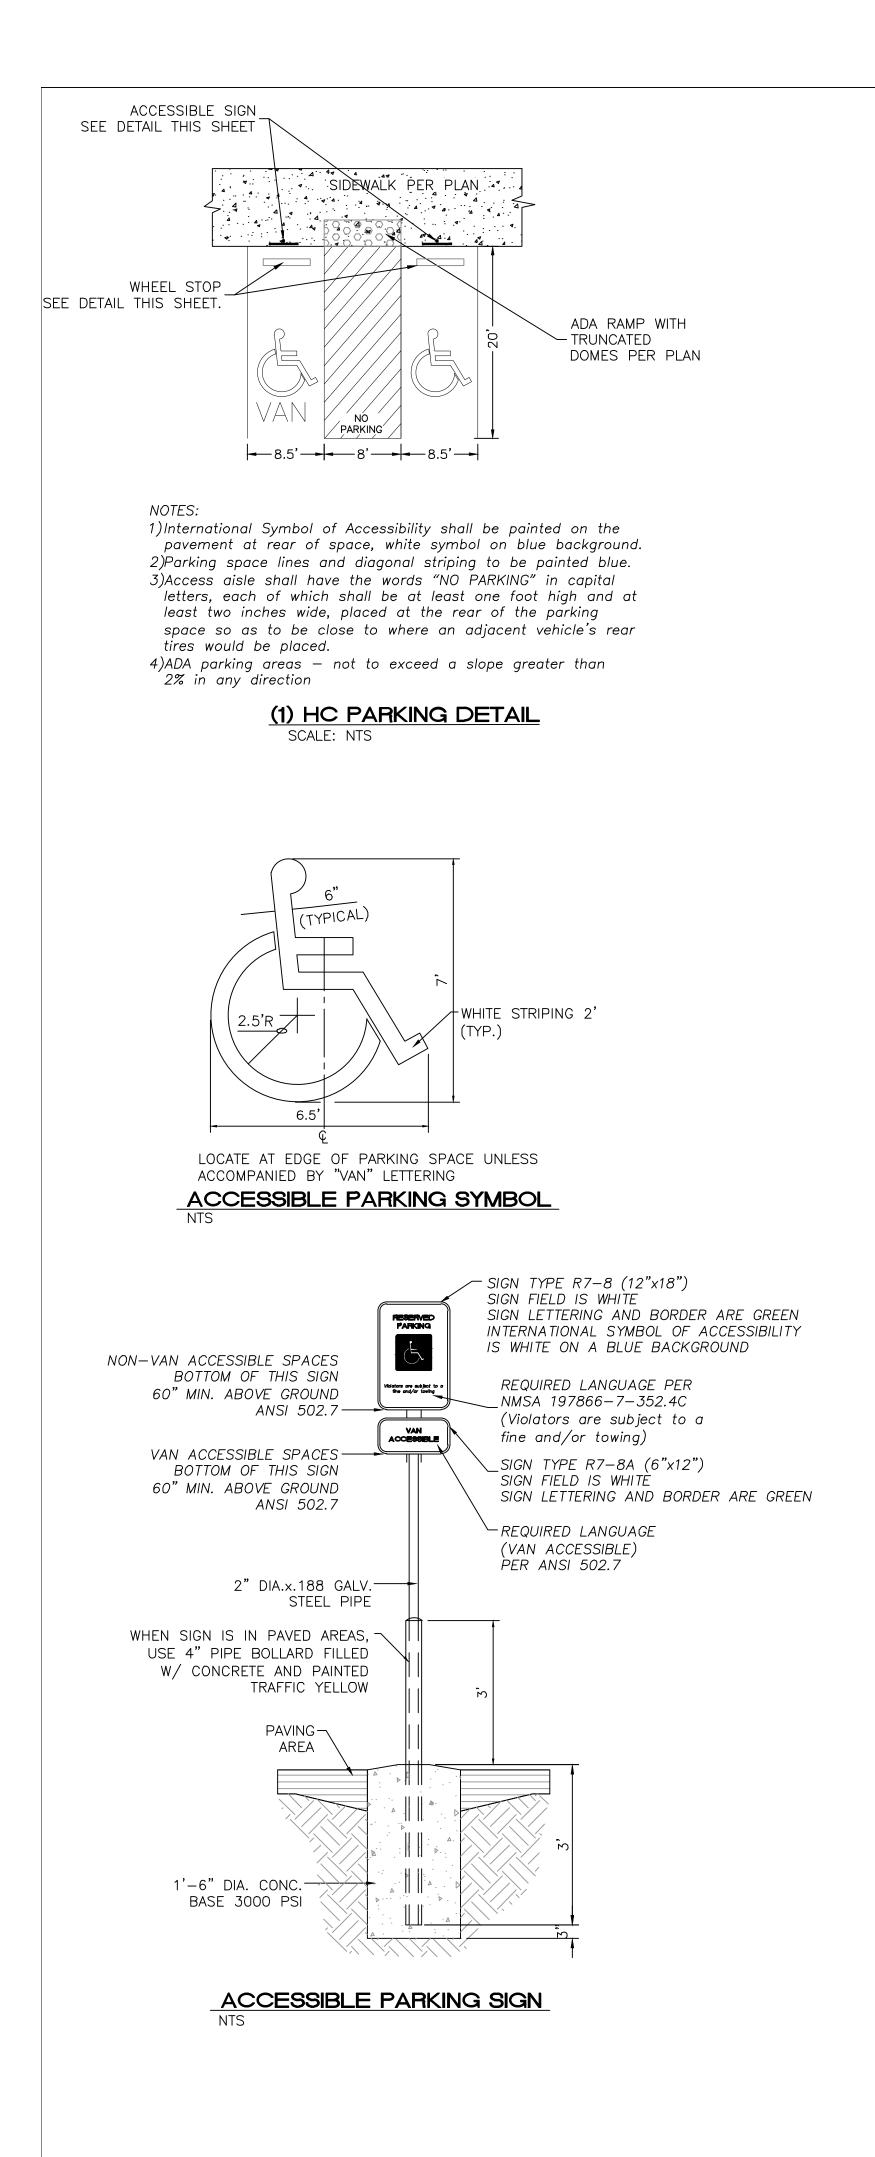

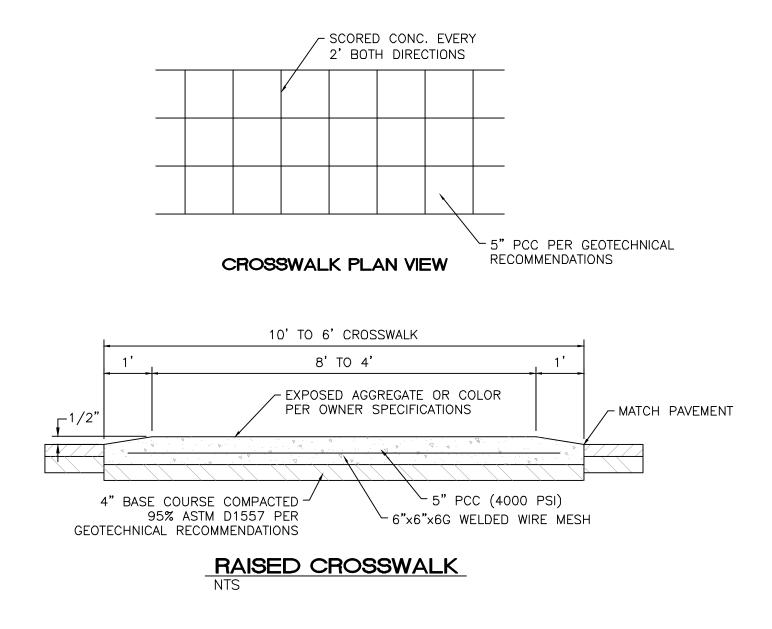




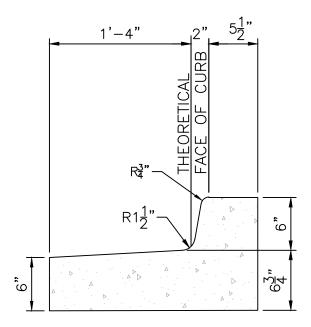


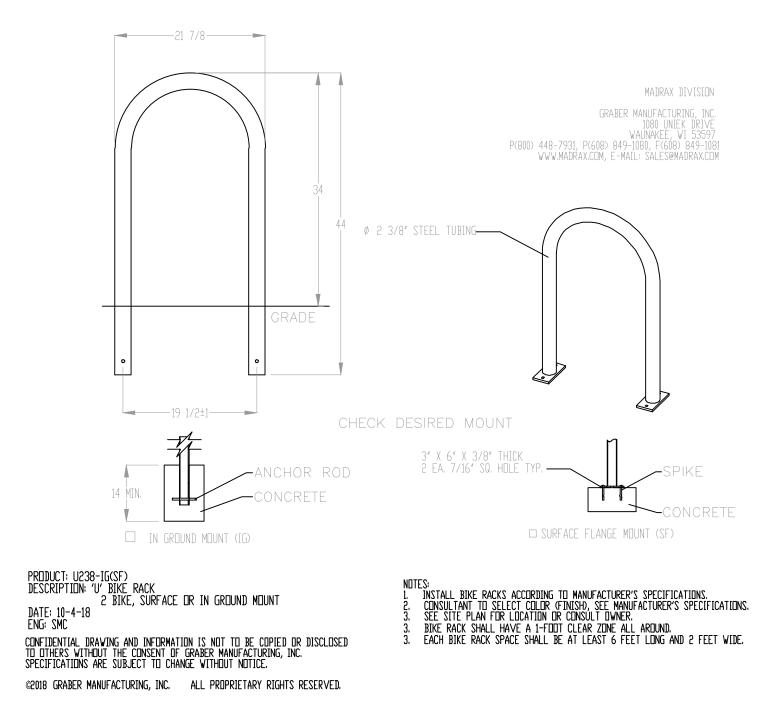

BIKE RACK DETAIL

SCALE: NONE

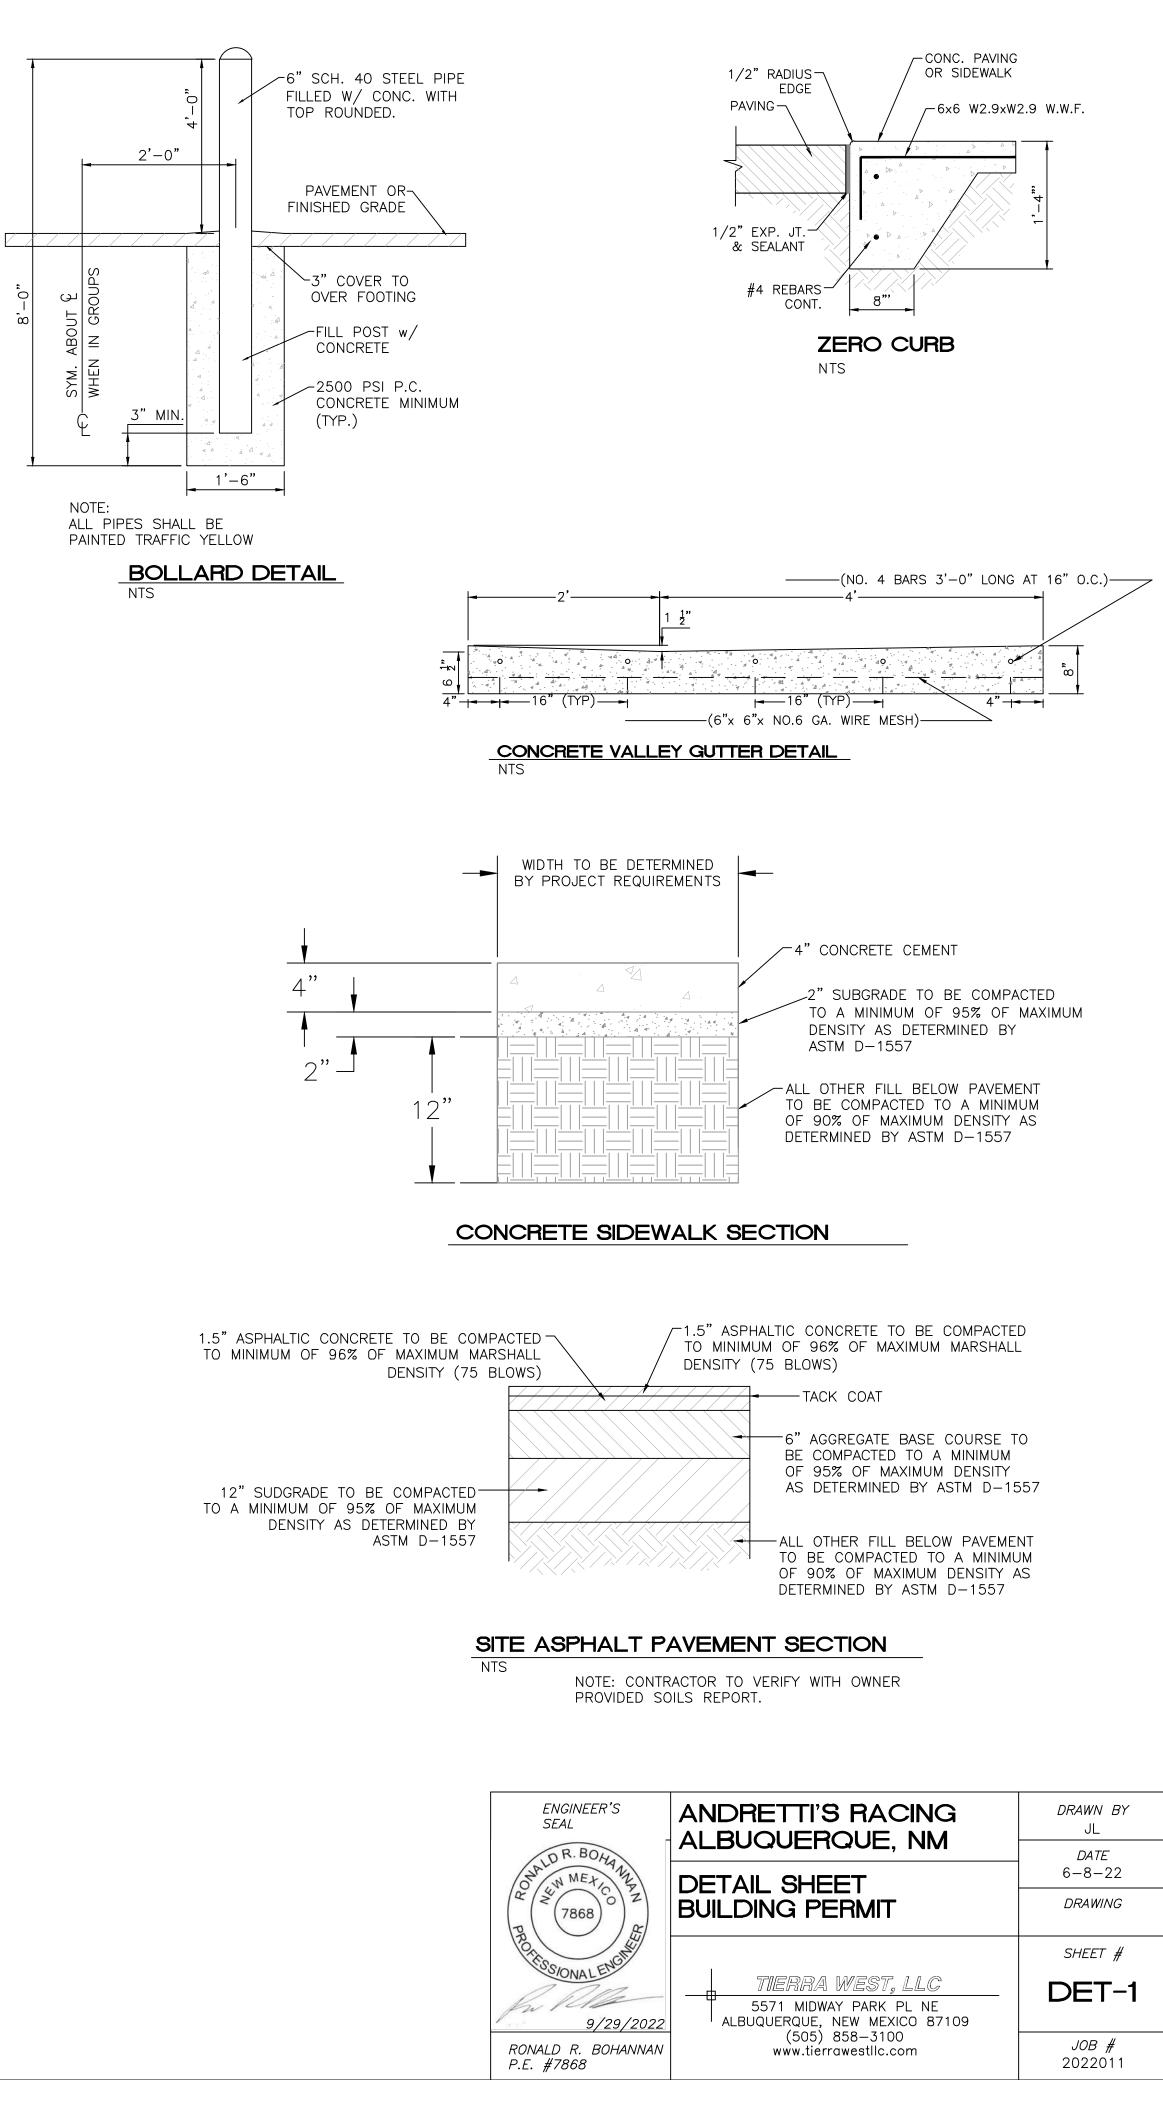

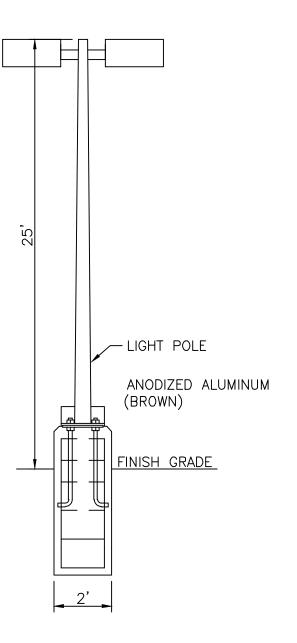


LIGHT POLE DETAIL



LIGHT DETAIL



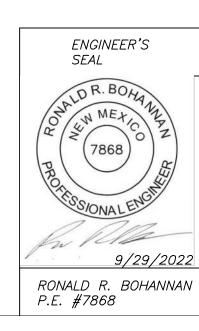







TIERRA WEST, LLC 5571 MIDWAY PARK PL NE ALBUQUERQUE, NEW MEXICO 87109 (505) 858-3100 www.tierrawestllc.com

DRAWN BY JL DATE 6-8-22 DRAWING

SHEET # DET-2 JOB # 2022011

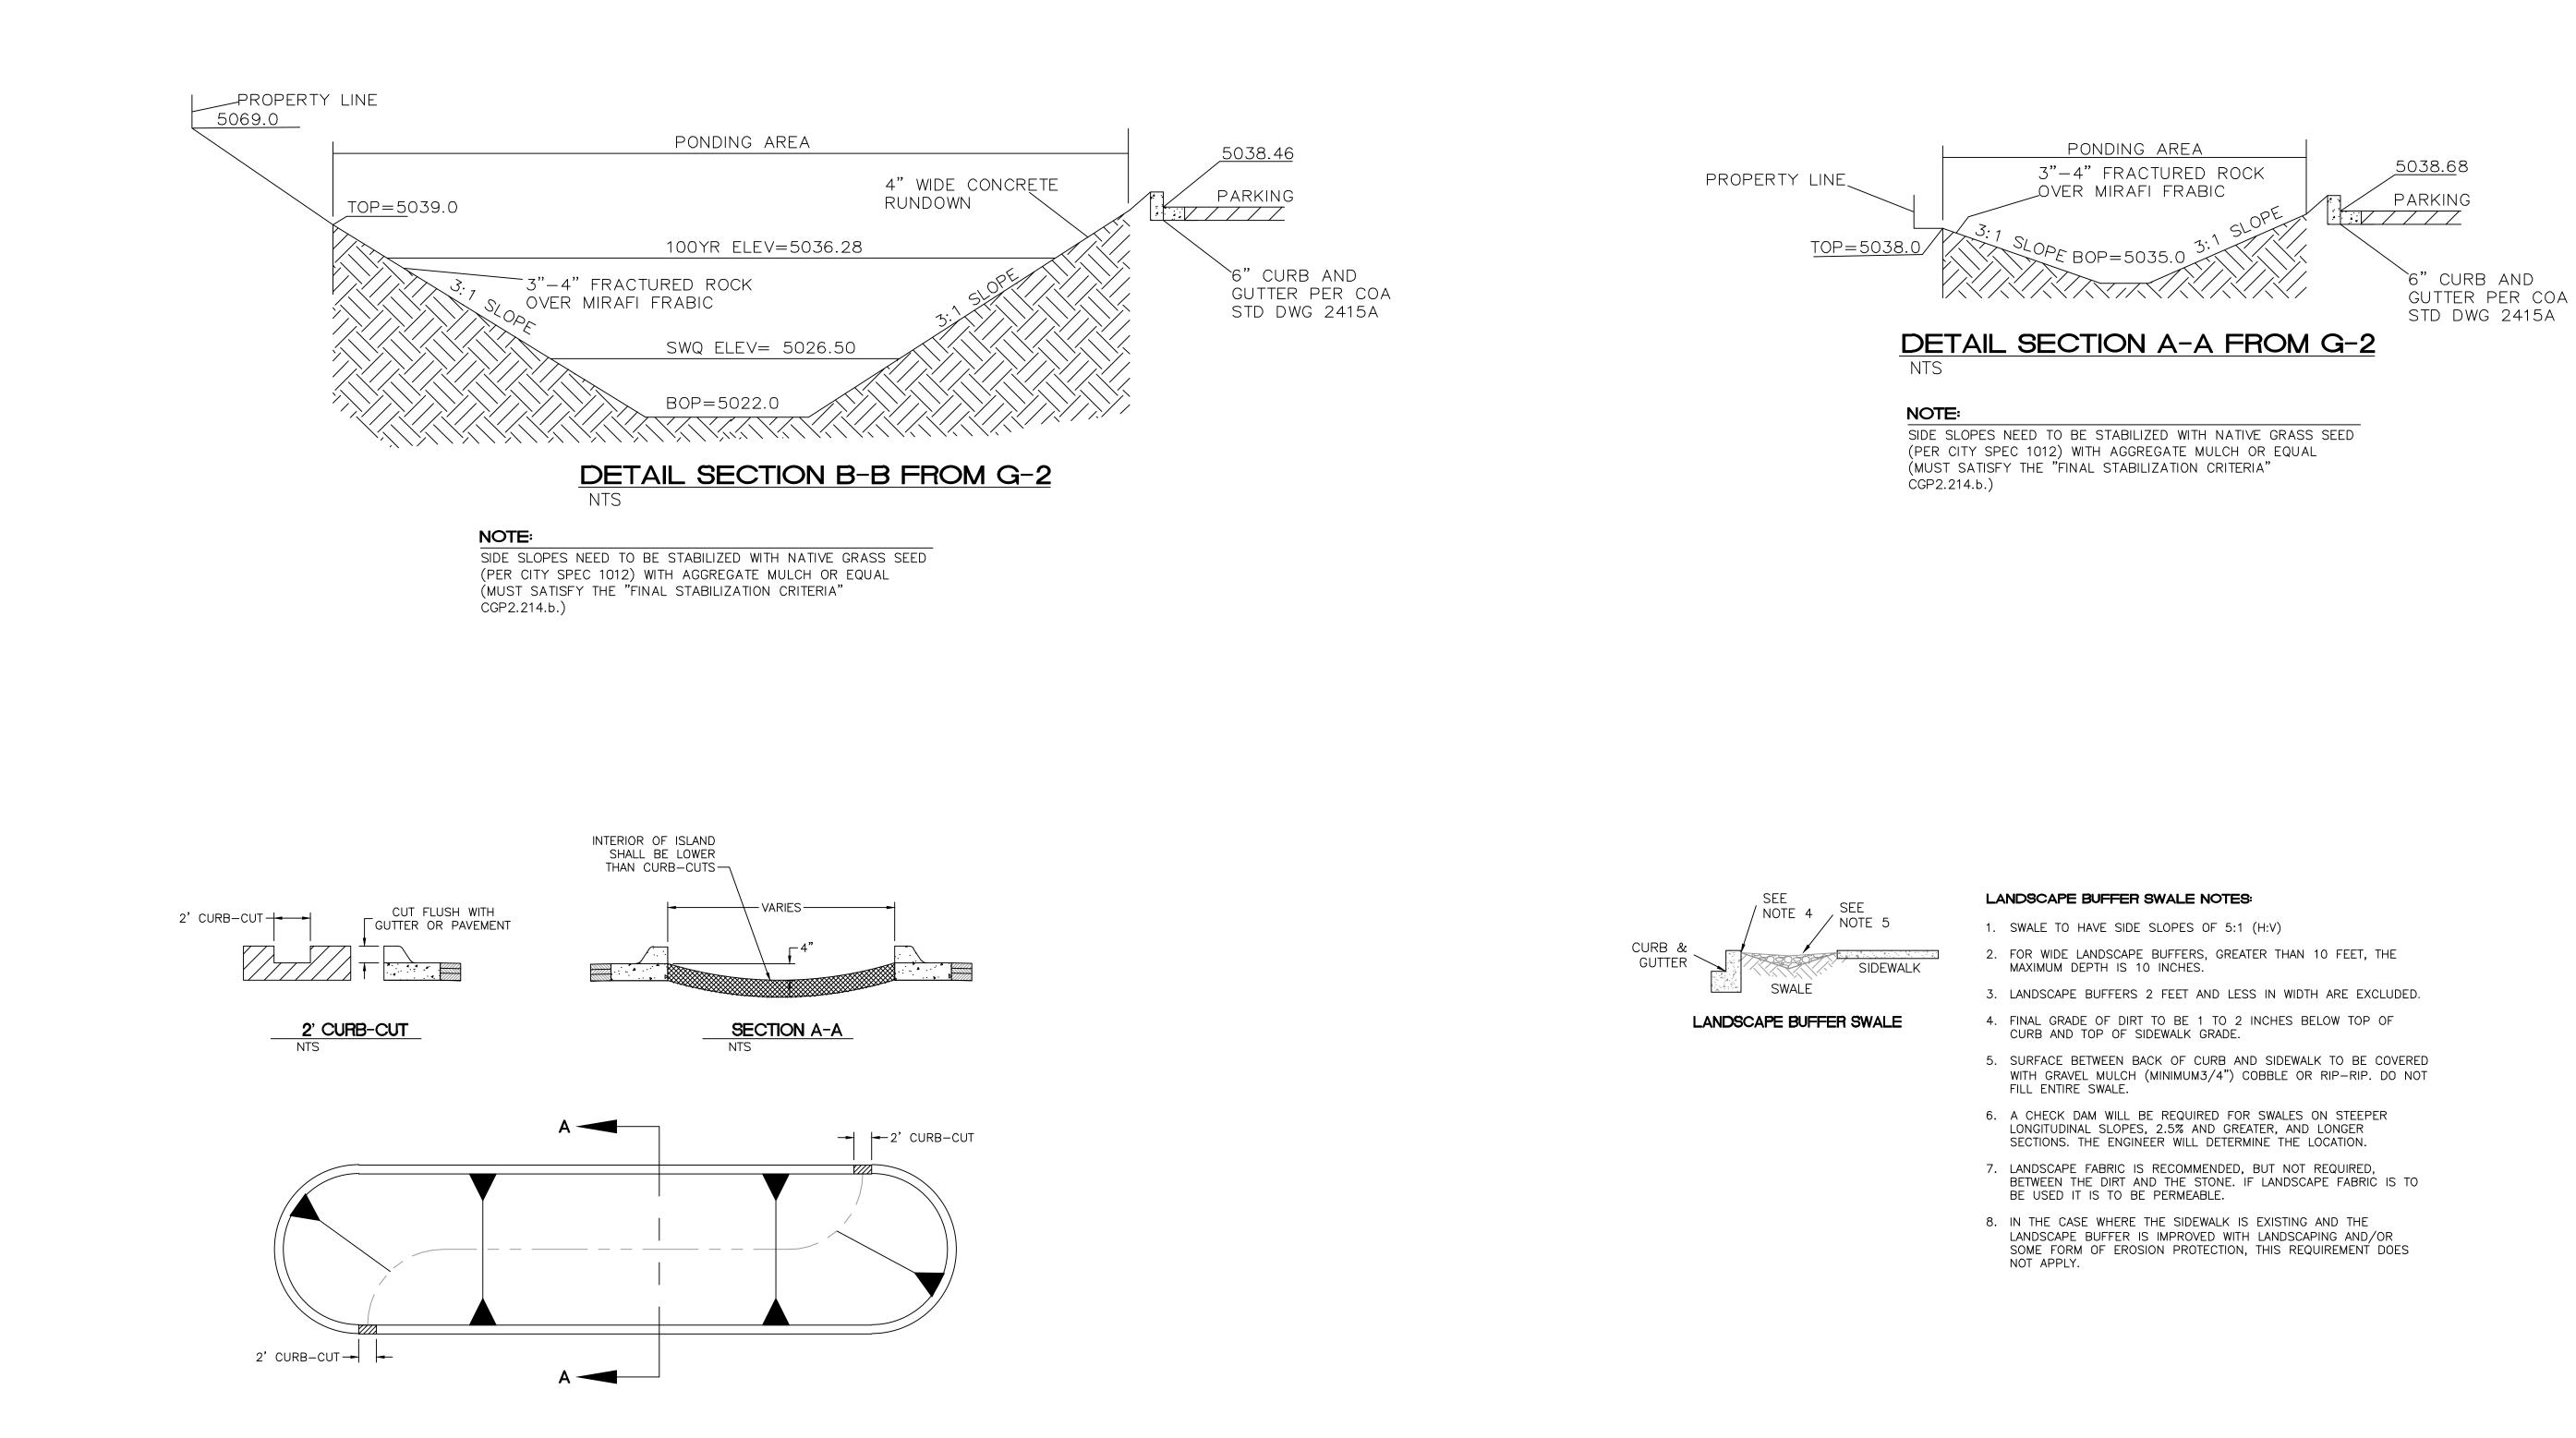

LANDSCAPE ISLAND WATER HARVESTING DETAIL BUILD ISLAND GEOMETRY PER SITE AND GRADING PLAN

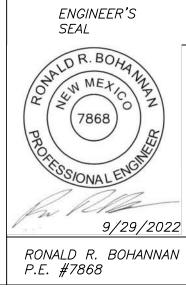






TIERRA WEST, LLC 5571 MIDWAY PARK PL NE ALBUQUERQUE, NEW MEXICO 87109 (505) 858-3100 www.tierrawestllc.com


DRAWN BY JL DATE 6-8-22 DRAWING




2022011

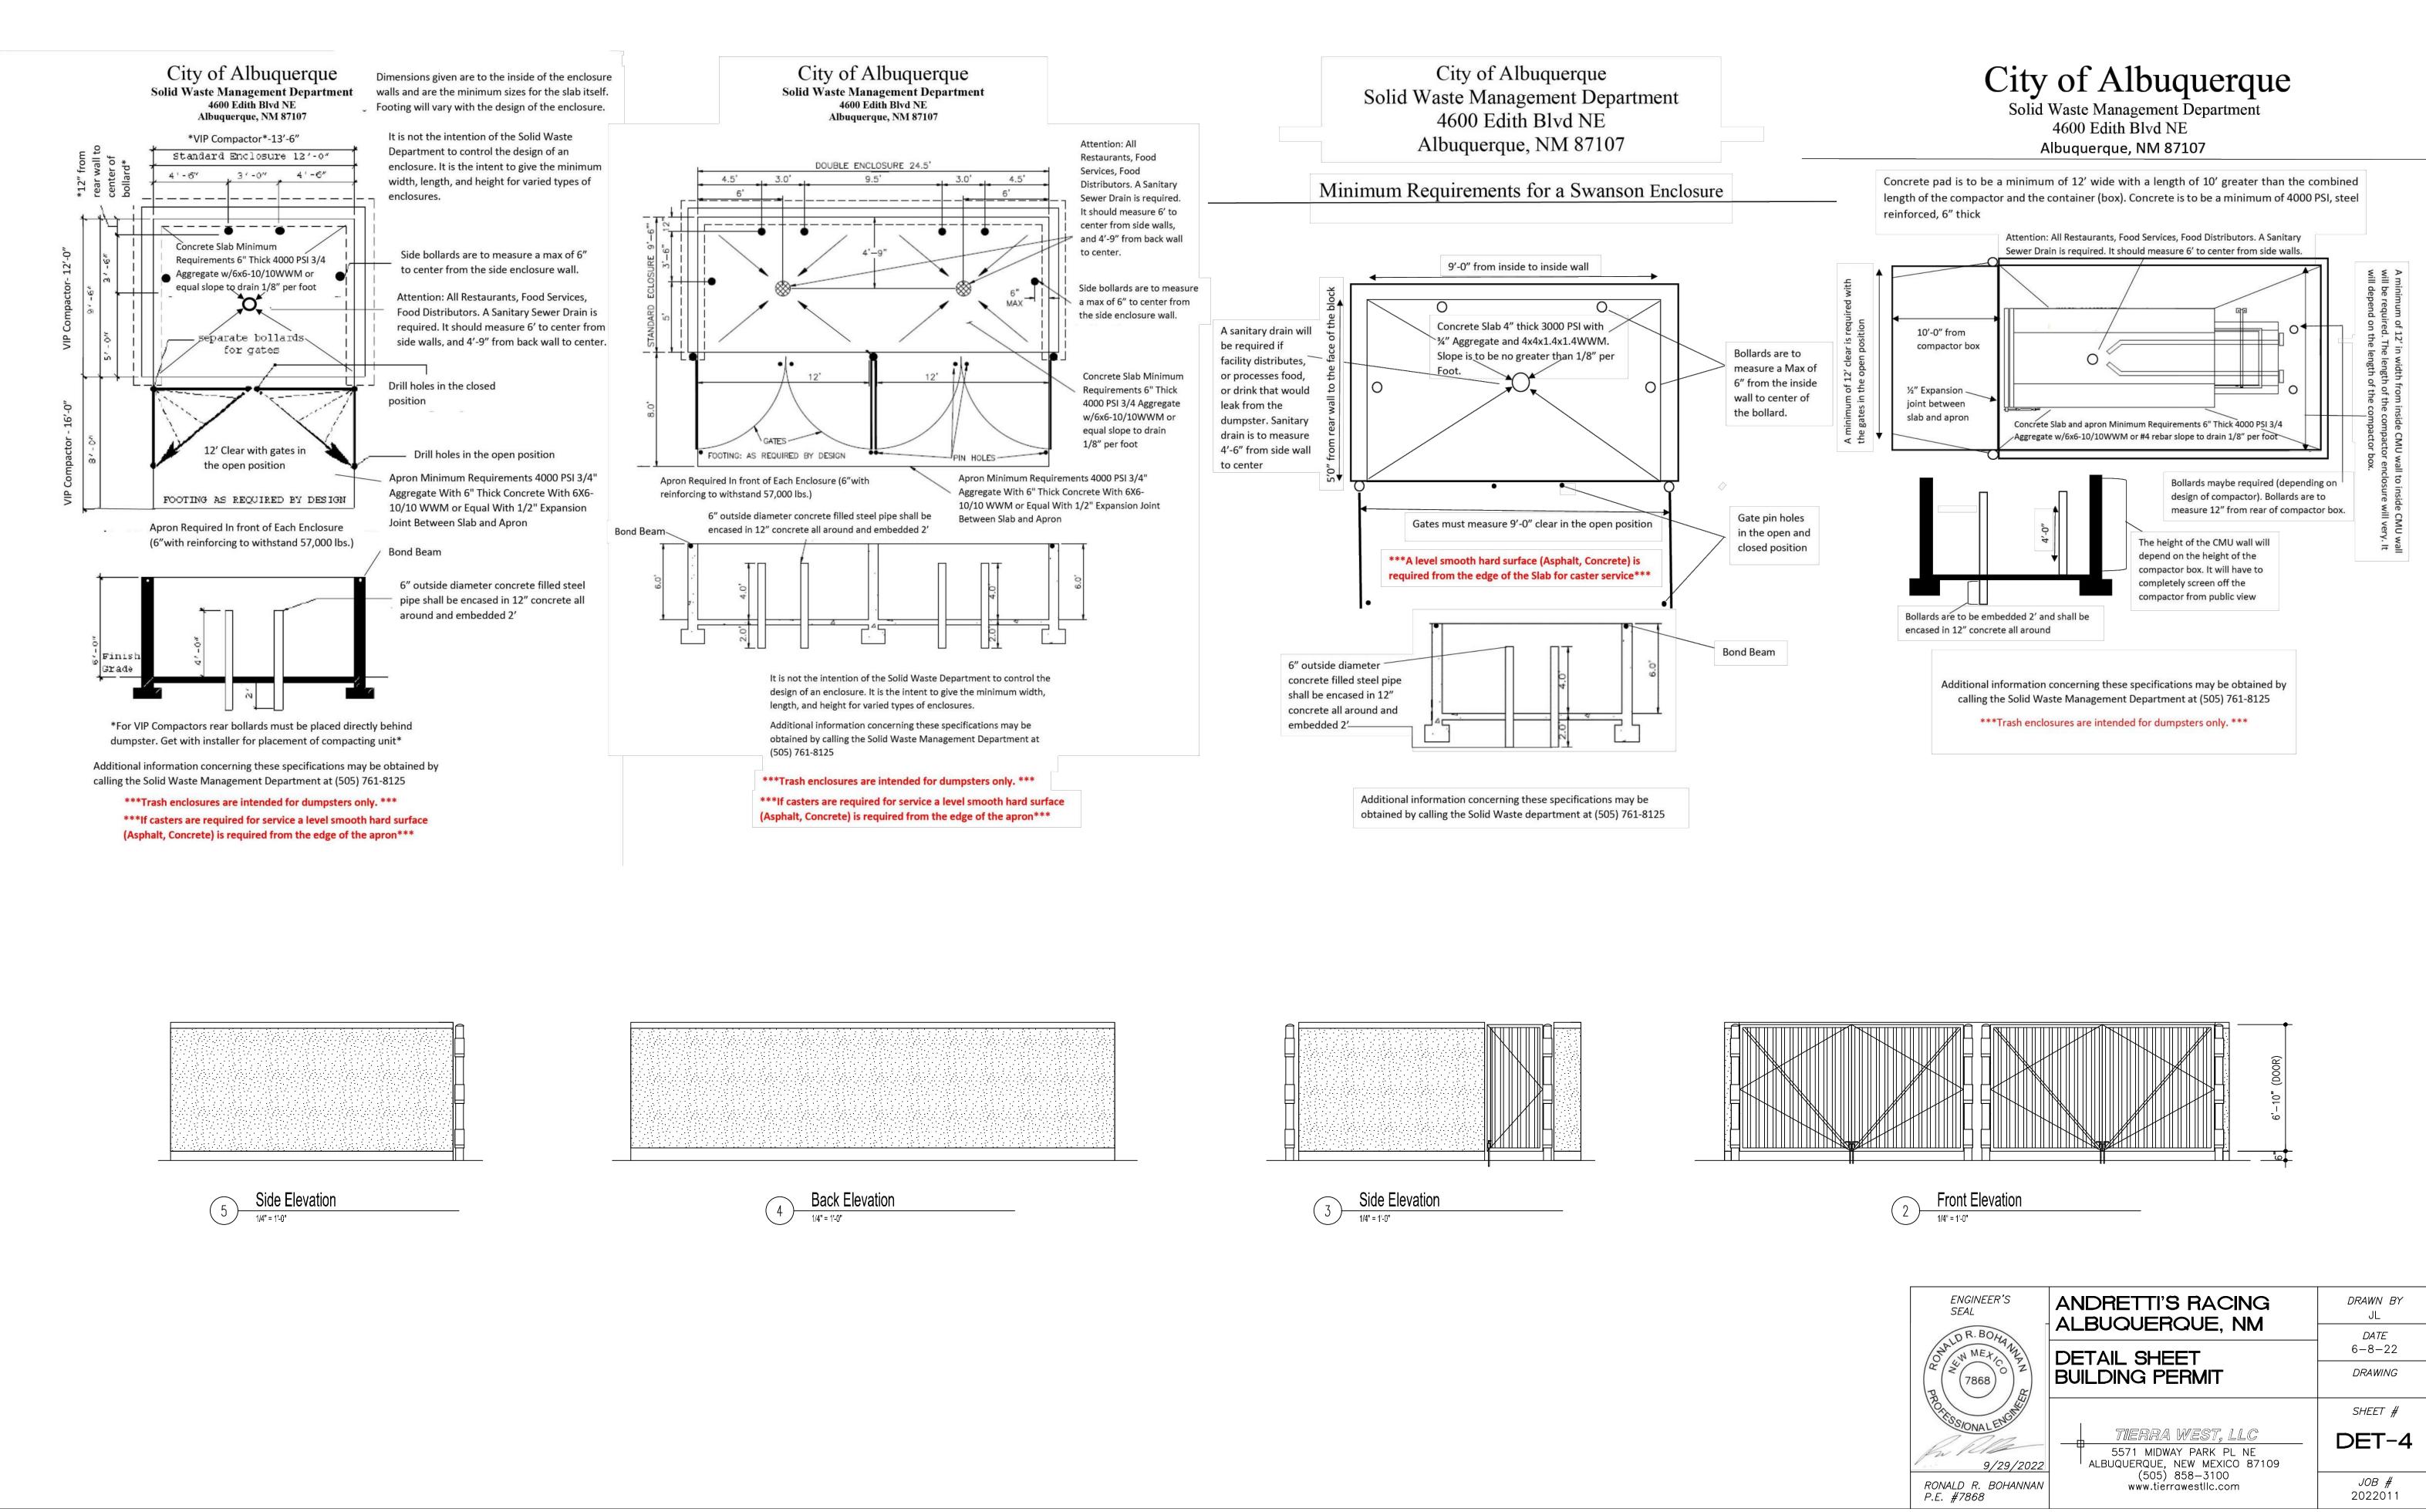



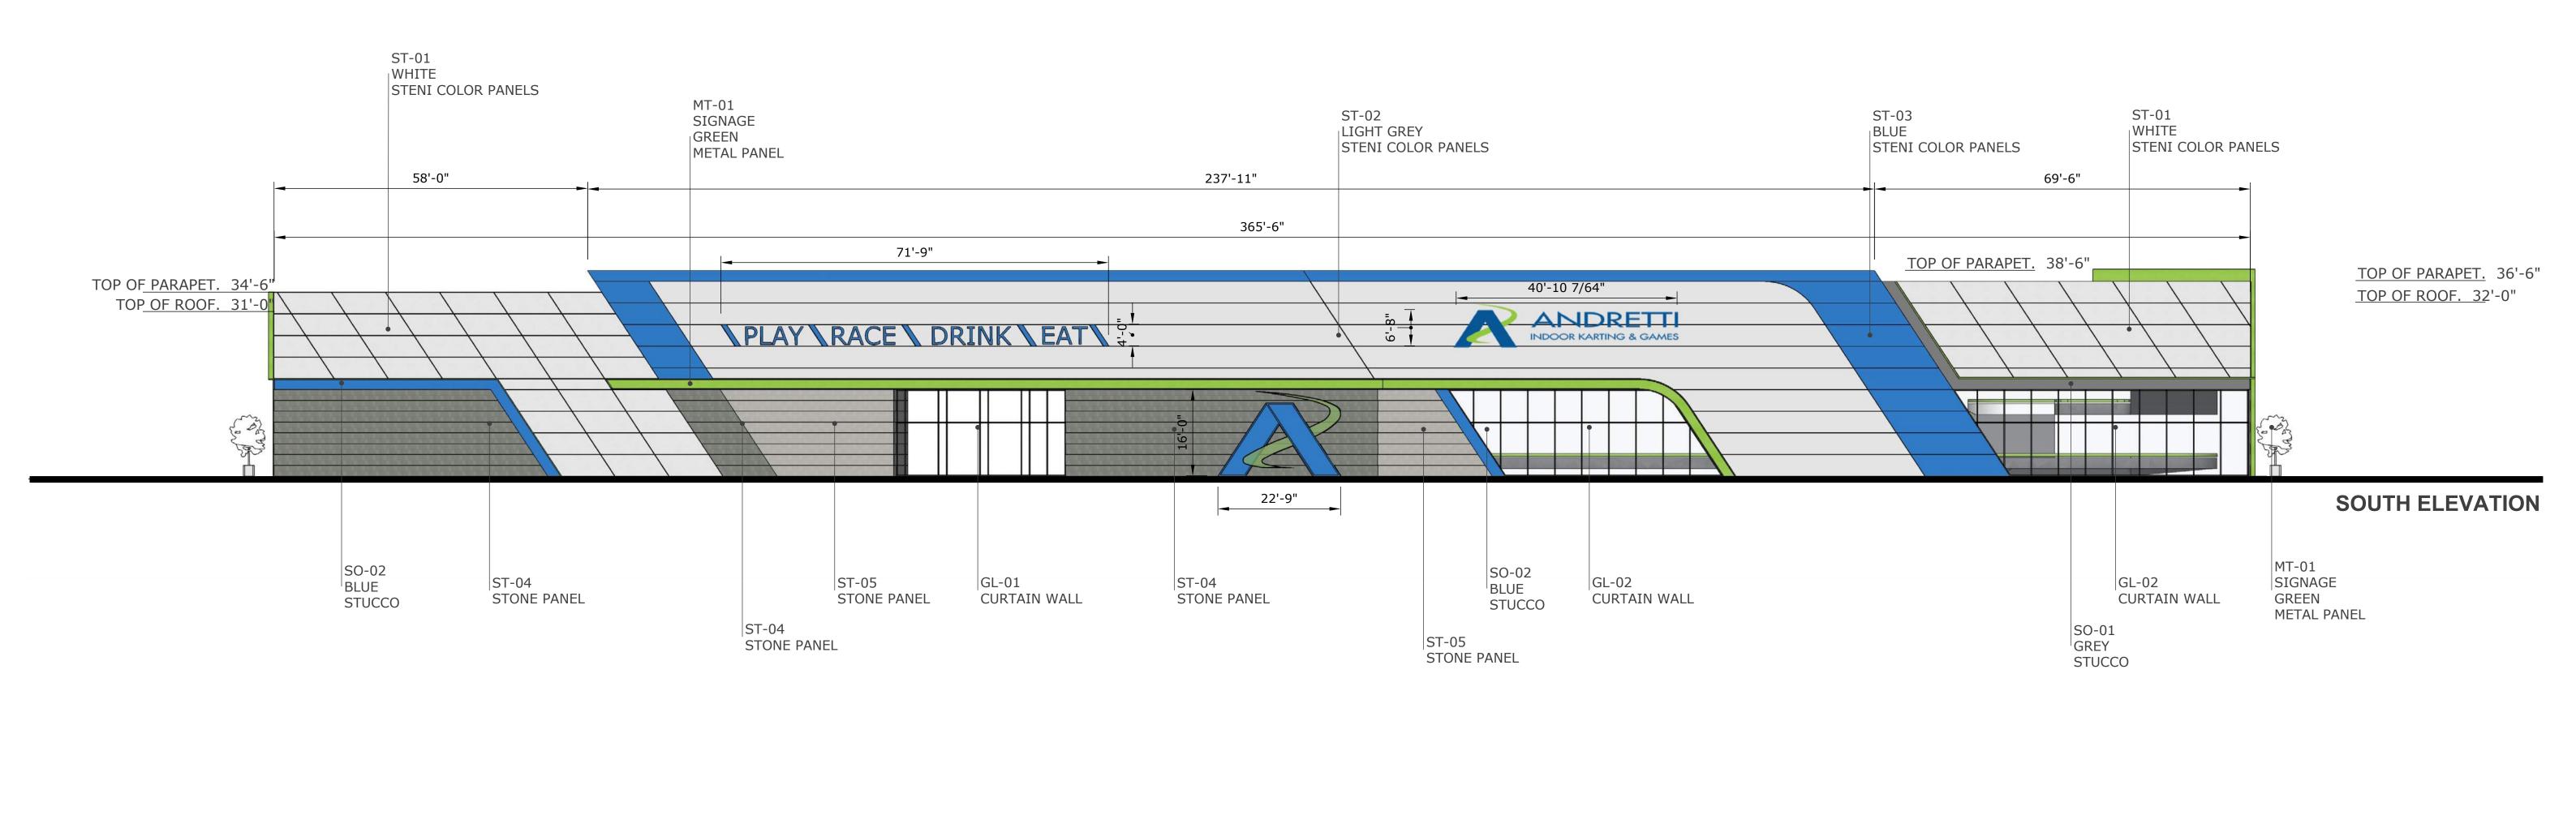


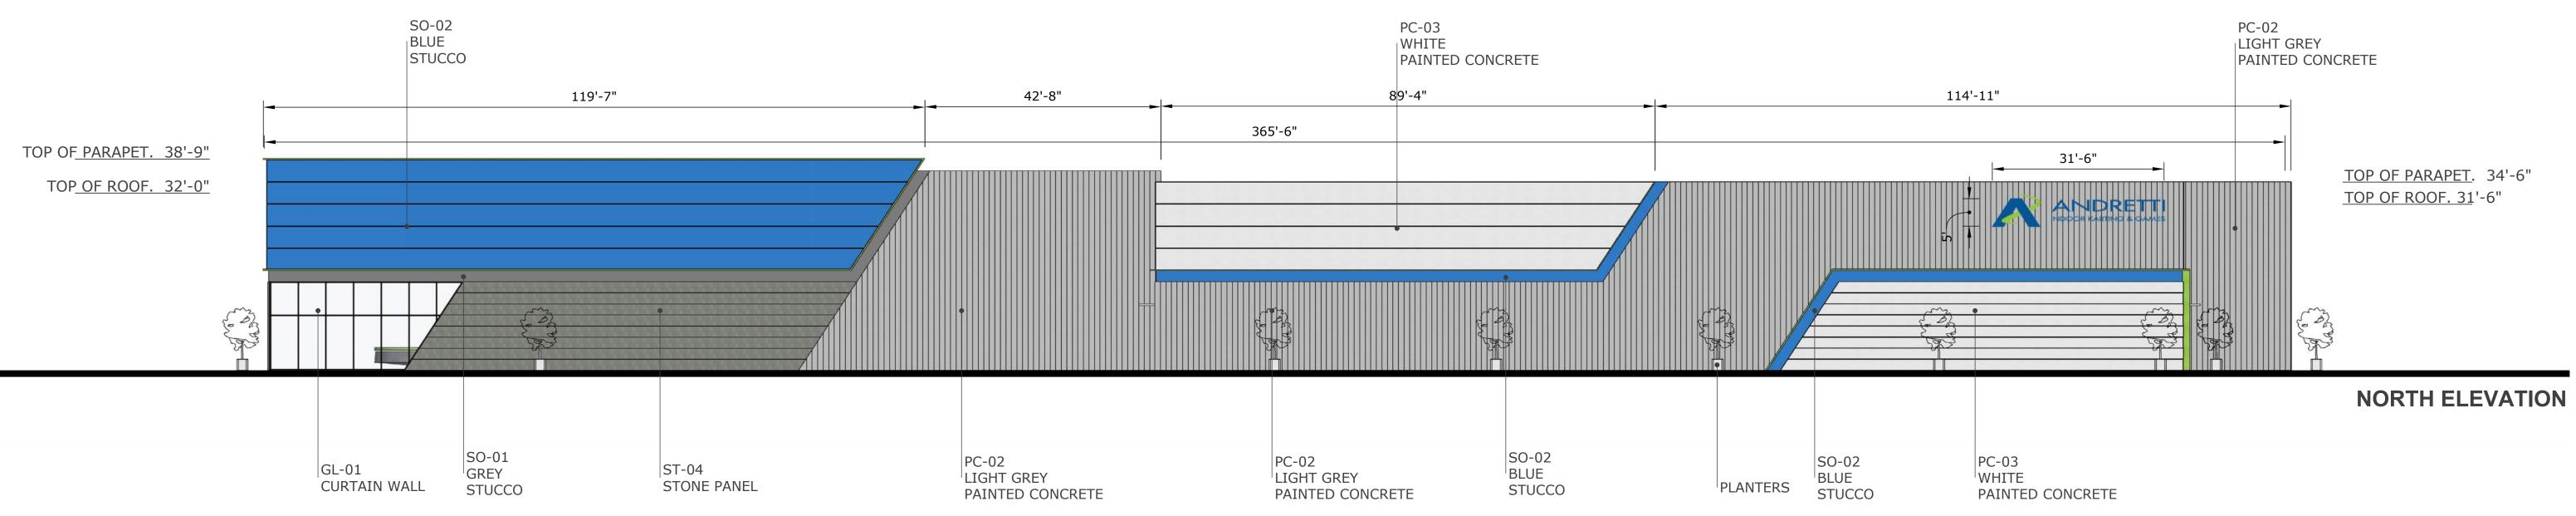




COLORED ELEVATIONS WEST/EAST



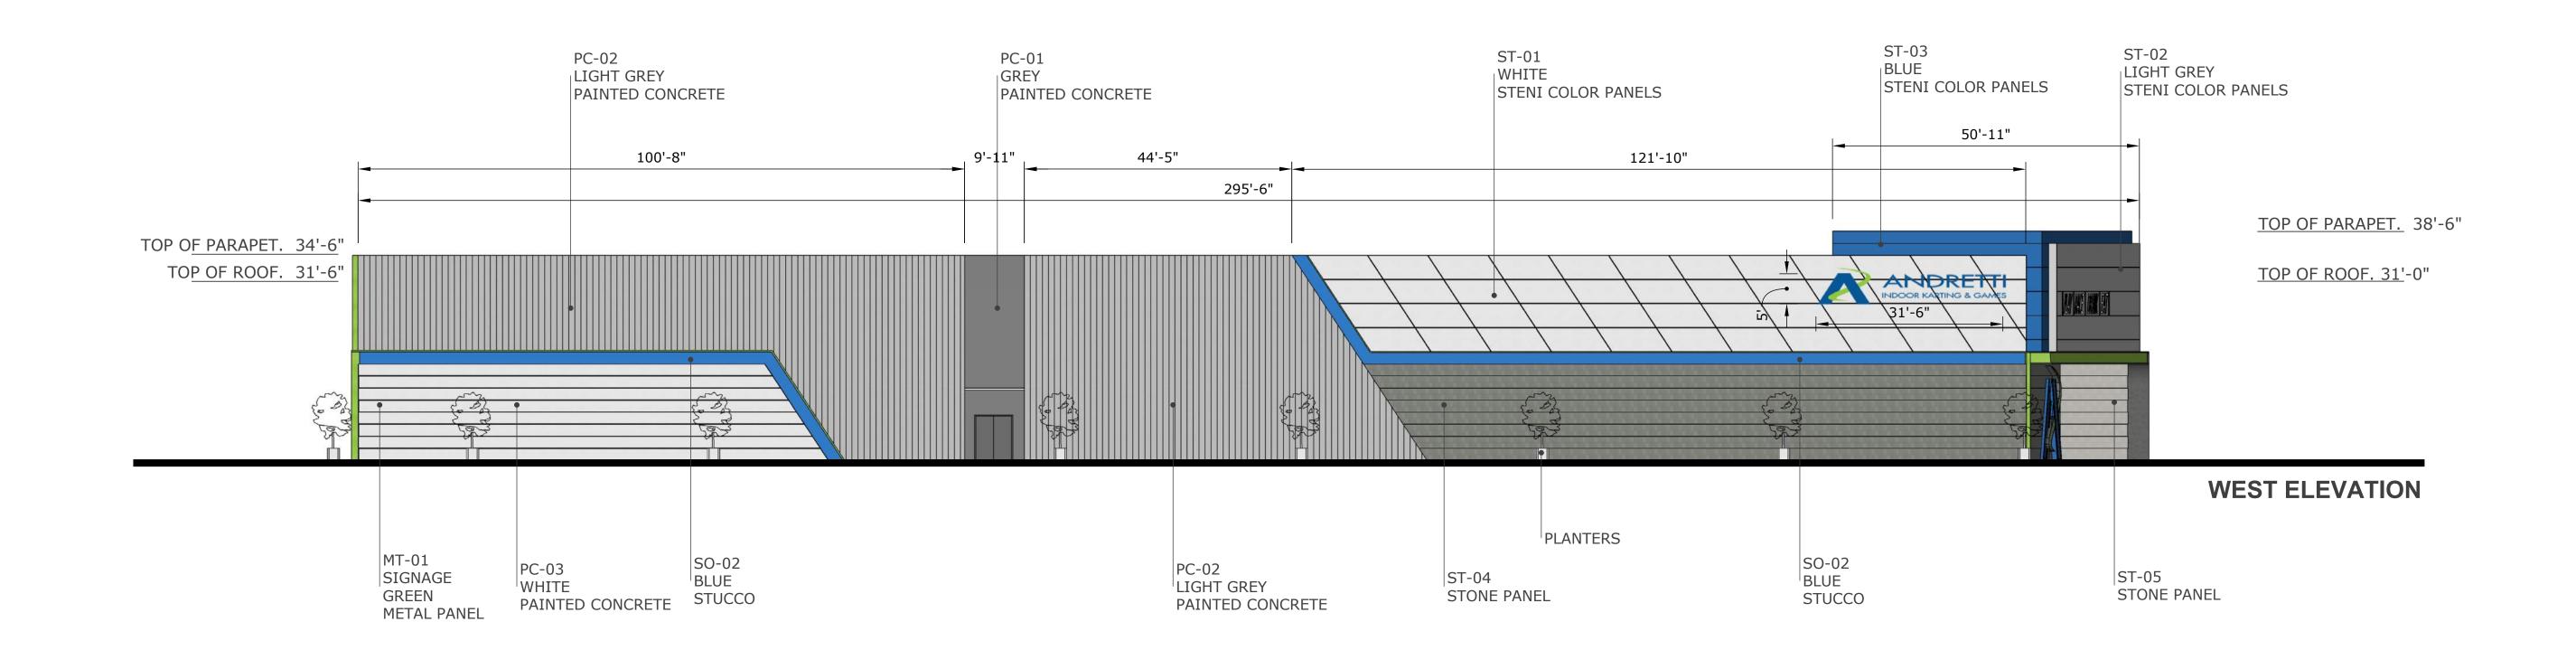

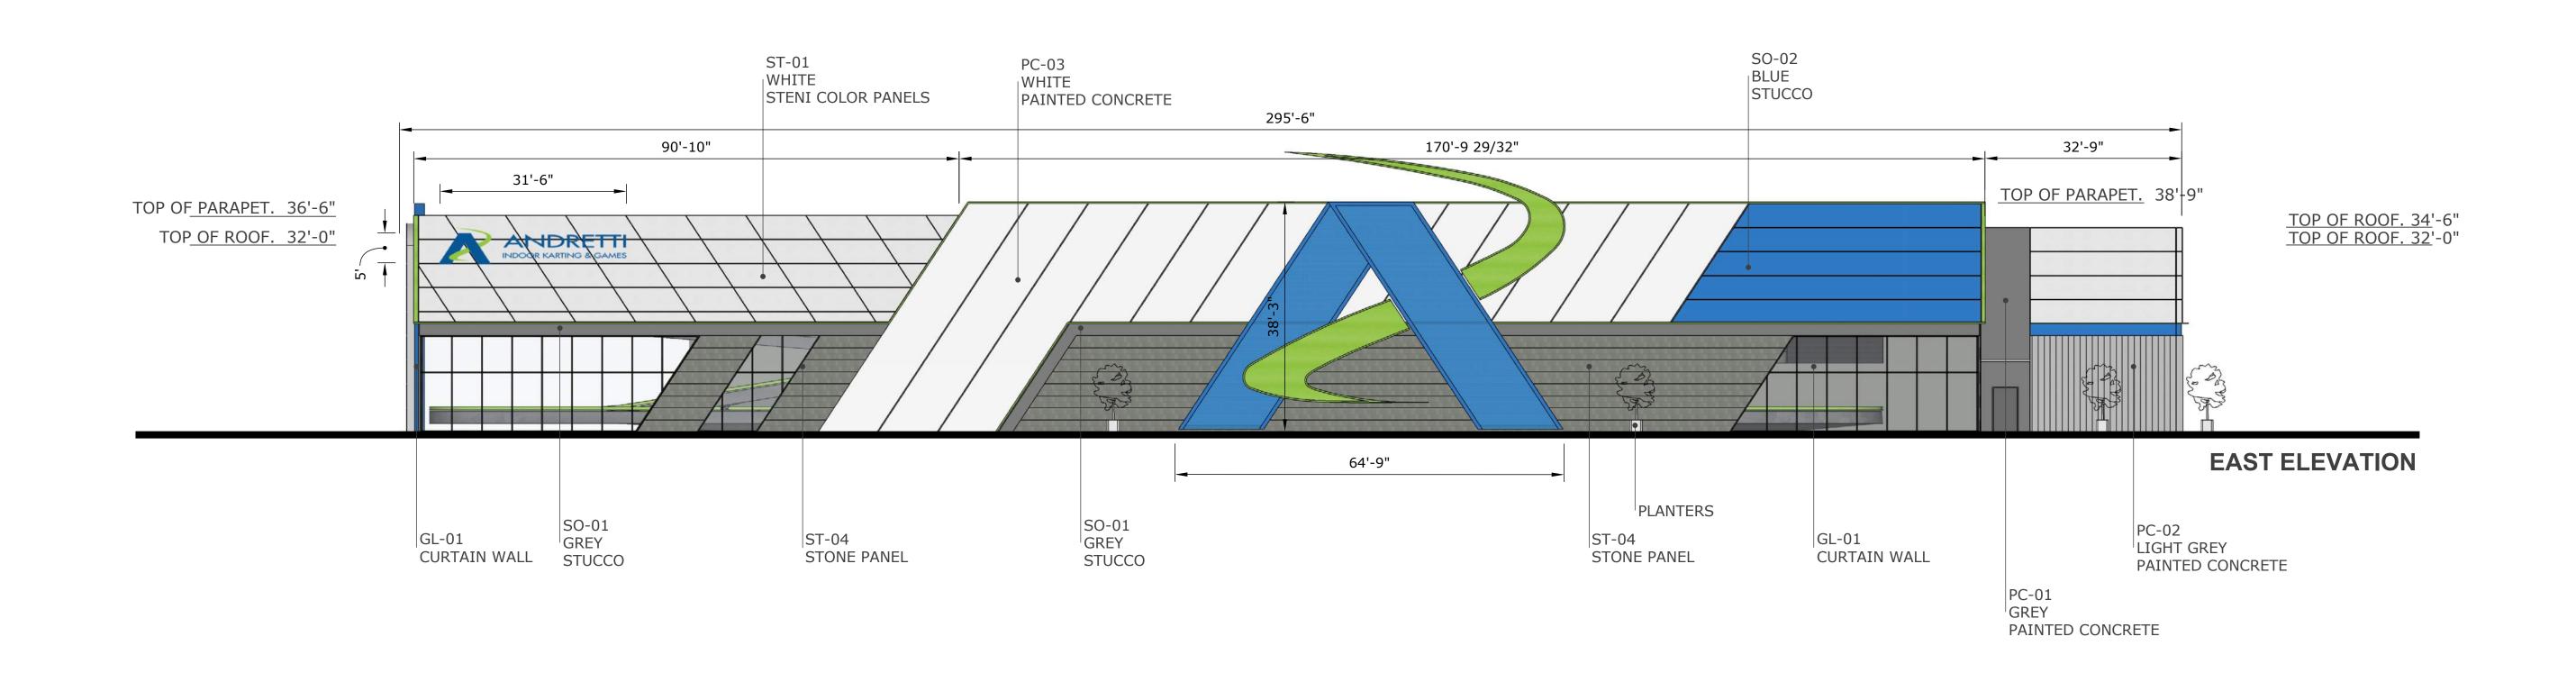





## MATERIAL PALLETTE

ST-01 WHITE STENI COLOR PANELS ST-02 LIGHT GREY STENI COLOR PANELS



ST-03 ANDRETTI BLUE STENI COLOR PANELS

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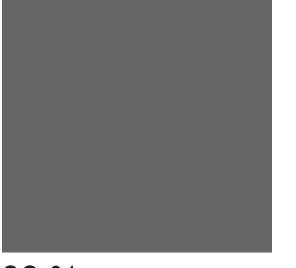
ST-04 ELDORADO STONE LONGITUDE24




PC-01 SW 7068 GRIZZLE GRAY PAINTED CONCRETE PC-02 SW 7663 MONORAIL SILVER PAINTED CONCRETE PC-03 SW 9624 WINSOME GREY

PAINTED CONCRETE

MT-01 SIGNAGE GREEN METAL PANEL



SO-01 DARK GREY SMOOTH STUCCO

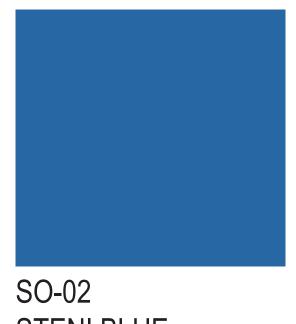

SO-02 STENI BLUE SMOOTH STUCCO




## STENI COLOR PANELS SAMPLE PROJECT





ST-05 ELDORADO STONE ZEN24

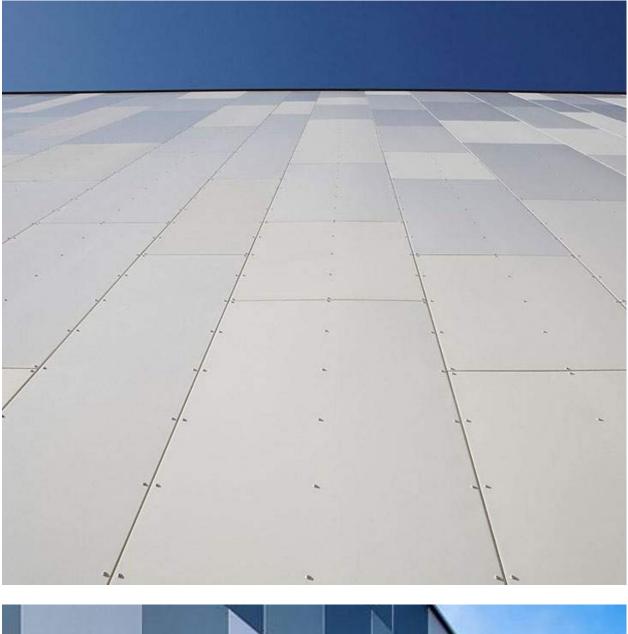

































Andretti Karting-Albuquerque 01 AUGUST 2022









Andretti Karting-Albuquerque 01 AUGUST 2022 BEC<















ALBUQUERQUE, NM EXTERIOR SIGNAGE ORIG. DATE - 10.06.2022 220P7483-5



This sign is intended to be installed in accordance with the requirements of Article 600 of the National Electrical Code and/or other applicable local codes. This includes proper grounding and bonding of the sign. Dimensions are approximate & may change due to construction factors or exact field conditions. Color shown are as close as printing will allow; Always follow written specifications. All rights reserved: This design has been created for you in connection with a project being planned for you by SSC Signs & Lighting. It may not be reproduced in any manner without prior consent.

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	E		
		1111	

LOCATION	QTY	
001	1	L
002	1	
003	1	
004	3	L
005	-	
006	-	



### SIGN SCHEDULE

ITEM DESCRIPTION

LOGO & CHANNEL LETTERS

LOGO CABINET

CHANNEL LETTERS

LOGO & CHANNEL LETTERS

LOGO CABINET

COVE CHANNEL



CLIENT Andretti Indoor Carting & Games

ADDRESS Albuquerque, NM

**DATE** 10.06.22 **DESIGNER -** GO DRAWING NO. 220P7483-5

### REVISION

DATE


<u>1. AM</u> 1	0.10.22
2. REDUCE SIGN #5	10.18.22
OAH	AM
3. GROW SIGN #5	10.21.22
OAH	AM
4. ADD CROSS	10.25.22
SECTION DETAILS	AM
5. ADD CROSS	10.27.22
SECTION DETAILS	AM

APPROVAL DATE -

APPROVED BY -

This sign is intended to be installed in accordance with the requirements of Article 600 of the National Electrical Code and/or other applicable local codes. This includes proper grounding and bonding of the sign. Dimensions are approximate & may change due to construction factors or exact field conditions. Color shown areas close as printing will allow; Always follow written specifications. All rights reserved: This design has been created for you in connection with a project being planned for you by SSC Signs & Lighting. It may not be reproduced in any manner without prior consent. National Electrical Code and/or

PAGE 2 OF 13

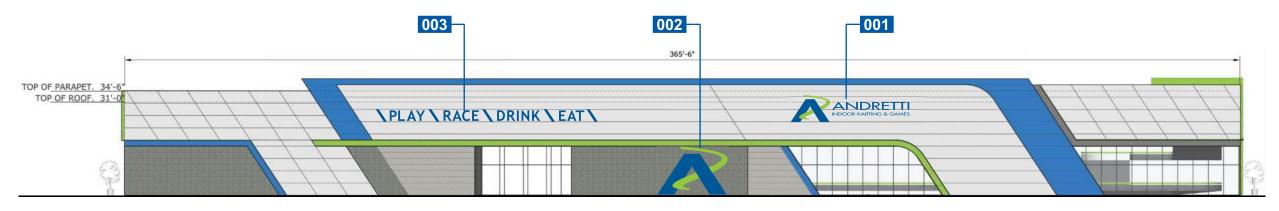

SOUTH ELEVATION SCALE: 1/32" = 1'-0"



NIGHT SIMULATION



CLIENT Andretti Indoor Carting & Games

ADDRESS Albuquerque, NM

DATE 10.06.22
 DESIGNER - GO
 DRAWING NO.
 220P7483-5

### REVISION

DATE


<u>1. AM</u> 1	0.10.22
2. REDUCE SIGN #5	10.18.22
OAH	AM
3. GROW SIGN #5	10.21.22
OAH	AM
4. ADD CROSS	10.25.22
SECTION DETAILS	AM
5. ADD CROSS	10.27.22
SECTION DETAILS	AM

**APPROVAL DATE -**

APPROVED BY -

This sign is intended to be installed in accordance with the requirements of Article 600 of the National Electrical Code and/or other applicable local codes. This includes proper grounding and bonding of the sign. Dimensions are approximate & may change due to construction factors or exact field conditions. Color shown areas close as printing will allow; Always follow written specifications. All rights reserved: This design has been created for you in connection with a project being planned for you by SSC Signs & Lighting. It may not be reproduced in any manner without prior consent.

PAGE 3 OF 13

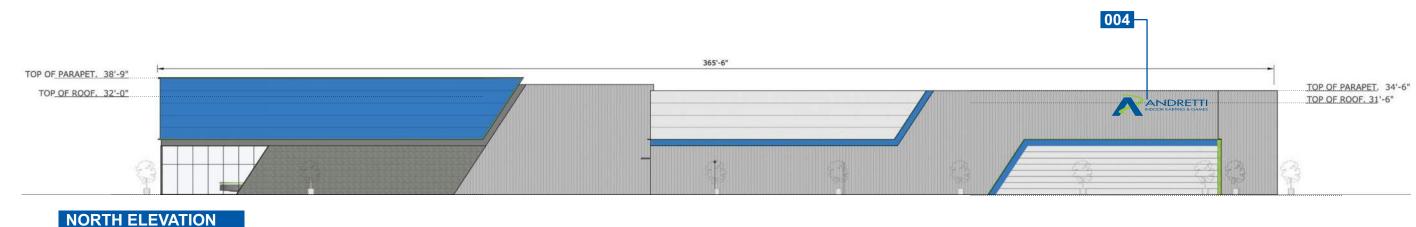

SCALE: 1/32" = 1'-0"



NIGHT SIMULATION





ADDRESS Albuquerque, NM

DATE 10.06.22
 DESIGNER - GO
 DRAWING NO.
 220P7483-5

### REVISION

DATE

1. AM 1	0.10.22
2. REDUCE SIGN #5	10.18.22
OAH	AM
3. GROW SIGN #5	10.21.22
OAH	AM
4. ADD CROSS	10.25.22
SECTION DETAILS	AM
5. ADD CROSS	10.27.22
SECTION DETAILS	AM

APPROVAL DATE -

APPROVED BY -


This sign is intended to be installed in accordance with the requirements of Article 600 of the National Electrical Code and/or other applicable local codes. This includes proper grounding and bonding of the sign. Dimensions are approximate & may change due to construction factors or exact field conditions. Color shown areas close as printing will allow; Always follow written specifications. All rights reserved: This design has been created for you in connection with a project being planned for you by SSC Signs & Lighting. It may not be reproduced in any manner without prior consent.

PAGE 4 OF 13

NIGHT SIMULATION





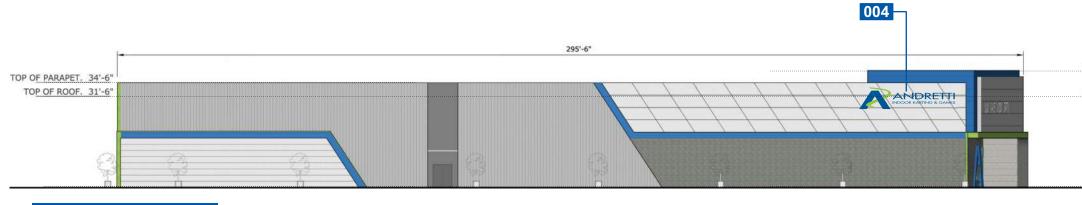

TOP OF PARAPET. 38'-6"

TOP OF ROOF, 31'-0"



CLIENT Andretti Indoor Carting & Games

ADDRESS Albuquerque, NM

**DATE** 10.06.22 **DESIGNER -** GO **DRAWING NO.** 220P7483-5

### REVISION

DATE


<u>1. AM</u> 1	0.10.22
2. REDUCE SIGN #5	10.18.22
OAH	AM
3. GROW SIGN #5	10.21.22
OAH	AM
4. ADD CROSS	10.25.22
SECTION DETAILS	AM
5. ADD CROSS	10.27.22
SECTION DETAILS	AM

APPROVAL DATE -

APPROVED BY -

This sign is intended to be installed in accordance with the requirements of Article 600 of the National Electrical Code and/or other applicable local codes. This includes proper grounding and bonding of the sign. Dimensions are approximate & may change due to construction factors or exact field conditions. Color shown areas close as printing will allow; Always follow written specifications. All rights reserved: This design has been created for you in connection with a project being planned for you by SSC Signs & Lighting. It may not be reproduced in any manner without prior consent.

PAGE 5 OF 13

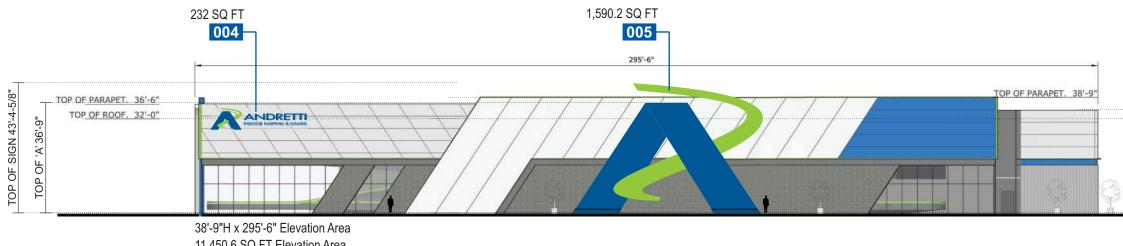

11,450.6 SQ FT Elevation Area 15% of Elevation Area = 1,717.59 Sq Ft Allowed Signage

### EAST ELEVATION

SCALE: 1/32" = 1'-0"



NIGHT SIMULATION



CLIENT Andretti Indoor Carting & Games

ADDRESS Albuquerque, NM

DATE 10.06.22
DESIGNER - GO
DRAWING NO.
220P7483-5

### REVISION

DATE

<u>1. AM</u>	10.10.22
2. REDUCE SIGN #5	10.18.22
OAH	AM
3. GROW SIGN #5	10.21.22
OAH	AM
4. ADD CROSS	10.25.22
SECTION DETAILS	S AM
5. ADD CROSS	10.27.22
SECTION DETAILS	S AM

**APPROVAL DATE -**


APPROVED BY -

This sign is intended to be installed in accordance with the requirements of Article 600 of the National Electrical Code and/or other applicable local codes. This includes proper grounding and bonding of the sign. Dimensions are approximate & may change due to construction factors or exact field conditions. Color shown areas close as printing will allow; Always follow written specifications. All rights reserved: This design has been created for you in connection with a project being planned for you by SSC Signs & Lighting. It may not be reproduced in any manner without prior consent.

PAGE 6 OF 13

WWW.SSCSIGNS.COM

TOP OF ROOF. 34'-6" TOP OF ROOF. 32'-0"

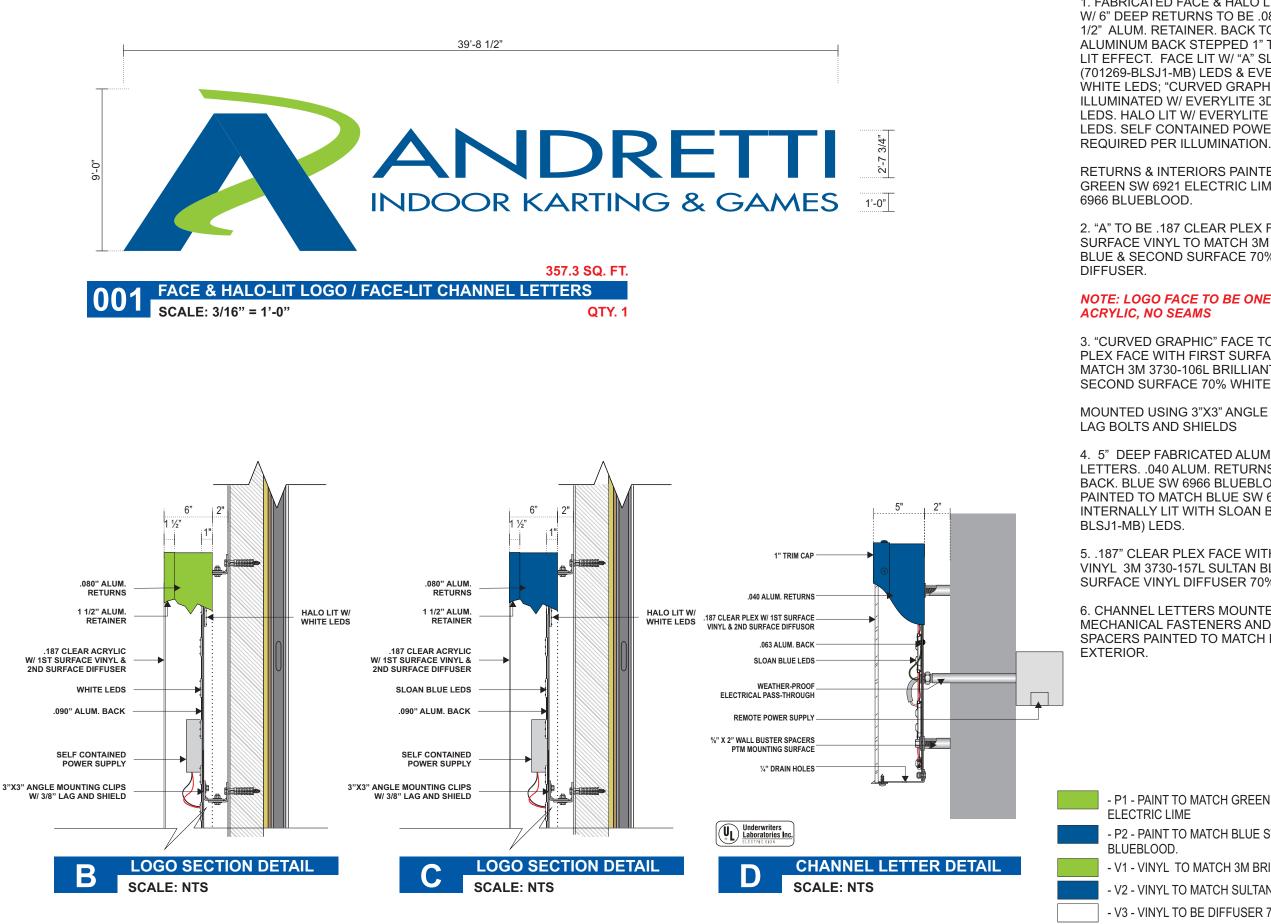

PAINTED TO MATCH BUILDING EXTERIOR

### **SPECIFICATIONS**

1. FABRICATED FACE & HALO LIT CHANNEL LOGO W/ 6" DEEP RETURNS TO BE .080" ALUMINUM & 1 1/2" ALUM. RETAINER. BACK TO BE .090" ALUMINUM BACK STEPPED 1" TO PROVIDE HALO LIT EFFECT. FACE LIT W/ "A" SLOAN BLUE (701269-BLSJ1-MB) LEDS & EVERYLITE 3D 6500 WHITE LEDS; "CURVED GRAPHIC" TO BE ILLUMINATED W/ EVERYLITE 3D 6500 WHITE LEDS. HALO LIT W/ EVERYLITE 3D 6500 WHITE LEDS. SELF CONTAINED POWER SUPPLY AS

**RETURNS & INTERIORS PAINTED TO MATCH** GREEN SW 6921 ELECTRIC LIME AND BLUE SW

2. "A" TO BE .187 CLEAR PLEX FACE WITH FIRST SURFACE VINYL TO MATCH 3M 3730-157L SULTAN **BLUE & SECOND SURFACE 70% WHITE** 

## NOTE: LOGO FACE TO BE ONE PIECE OF

3. "CURVED GRAPHIC" FACE TO BE .187 CLEAR PLEX FACE WITH FIRST SURFACE VINYL TO MATCH 3M 3730-106L BRILLIANT GREEN & SECOND SURFACE 70% WHITE DIFFUSER .

MOUNTED USING 3"X3" ANGLE CLIPS WITH 3/8"

4. 5" DEEP FABRICATED ALUMINUM CHANNEL LETTERS. .040 ALUM. RETURNS AND .063 ALUM BACK. BLUE SW 6966 BLUEBLOOD. 1" TRIM CAP PAINTED TO MATCH BLUE SW 6966 BLUEBLOOD. INTERNALLY LIT WITH SLOAN BLUE (701269-

5. .187" CLEAR PLEX FACE WITH FIRST SURFACE VINYL 3M 3730-157L SULTAN BLUE & SECOND SURFACE VINYL DIFFUSER 70% WHITE.

6. CHANNEL LETTERS MOUNTED WITH MECHANICAL FASTENERS AND 2" SPACERS. SPACERS PAINTED TO MATCH BUILDING

- P1 - PAINT TO MATCH GREEN SW 6921

- P2 - PAINT TO MATCH BLUE SW 6966

- V1 - VINYL TO MATCH 3M BRILLIANT GREEN 3730-106L

- V2 - VINYL TO MATCH SULTAN BLUE 3730-157L

- V3 - VINYL TO BE DIFFUSER 70% WHITE



CLIENT Andretti Indoor Carting & Games

ADDRESS Albuquerque, NM

**DATE** 10.06.22 **DESIGNER -** GO DRAWING NO. 220P7483-5

### REVISION

DATE


<u>1. AM</u> 1	0.10.22
2. REDUCE SIGN #5	10.18.22
OAH	AM
3. GROW SIGN #5	10.21.22
OAH	AM
4. ADD CROSS	10.25.22
SECTION DETAILS	AM
5. ADD CROSS	10.27.22
SECTION DETAILS	AM

**APPROVAL DATE -**

**APPROVED BY -**

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PAGE 7 OF 13

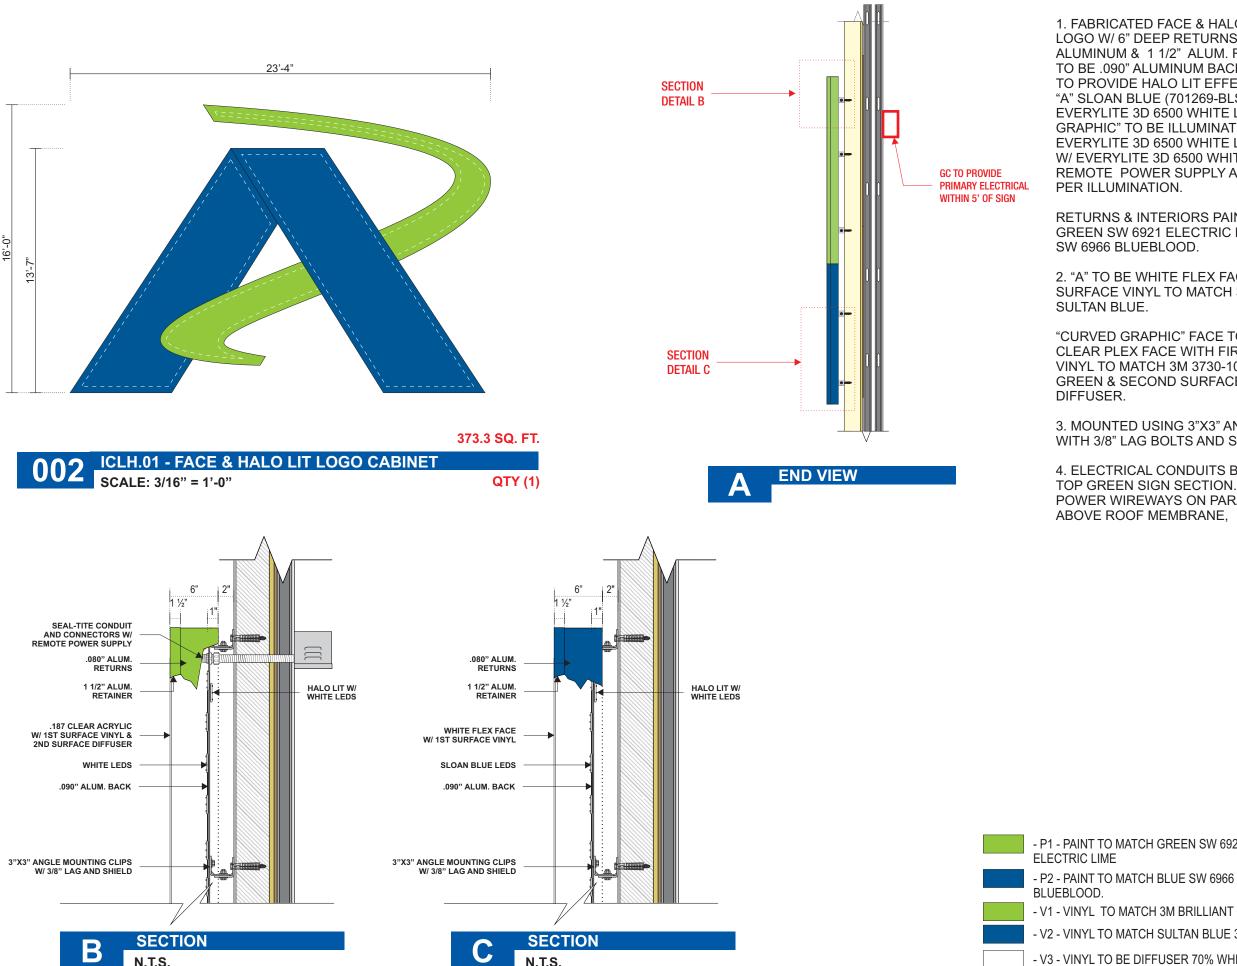

### **SPECIFICATIONS**

1. FABRICATED FACE & HALO LIT CHANNEL LOGO W/ 6" DEEP RETURNS TO BE .080" ALUMINUM & 1 1/2" ALUM. RETAINER. BACK TO BE .090" ALUMINUM BACK STEPPED 1" TO PROVIDE HALO LIT EFFECT. FACE LIT W/ "A" SLOAN BLUE (701269-BLSJ1-MB) LEDS & EVERYLITE 3D 6500 WHITE LEDS; "CURVED GRAPHIC" TO BE ILLUMINATED W/ EVERYLITE 3D 6500 WHITE LEDS. HALO LIT W/ EVERYLITE 3D 6500 WHITE LEDS. REMOTE POWER SUPPLY AS REQUIRED

**RETURNS & INTERIORS PAINTED TO MATCH** GREEN SW 6921 ELECTRIC LIME AND BLUE

2. "A" TO BE WHITE FLEX FACE WITH FIRST SURFACE VINYL TO MATCH 3M 3730-157L

"CURVED GRAPHIC" FACE TO BE .187 CLEAR PLEX FACE WITH FIRST SURFACE VINYL TO MATCH 3M 3730-106L BRILLIANT **GREEN & SECOND SURFACE 70% WHITE** 

3. MOUNTED USING 3"X3" ANGLE CLIPS WITH 3/8" LAG BOLTS AND SHIELDS

4. ELECTRICAL CONDUITS BRIDGED INTO TOP GREEN SIGN SECTION. EXTERIOR POWER WIREWAYS ON PARAPHET WALL ABOVE ROOF MEMBRANE,

- P1 - PAINT TO MATCH GREEN SW 6921

- V1 - VINYL TO MATCH 3M BRILLIANT GREEN 3730-106L

- V2 - VINYL TO MATCH SULTAN BLUE 3730-157L

- V3 - VINYL TO BE DIFFUSER 70% WHITE



CLIENT Andretti Indoor Carting & Games

ADDRESS Albuquerque, NM

**DATE** 10.06.22 **DESIGNER -** GO **DRAWING NO.** 220P7483-5

### REVISION

DATE

1. AM	10.10.22
2. REDUCE SIGN #5	10.18.22
OAH	AM
3. GROW SIGN #5	10.21.22
OAH	AM
4. ADD CROSS	10.25.22
SECTION DETAILS	AM A
5. ADD CROSS	10.27.22
SECTION DETAILS	AM

**APPROVAL DATE -**

**APPROVED BY -**

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PAGE 8 OF 13

1. 5" DEEP FABRICATED ALUMINUM CHANNEL LETTERS. .040 ALUM. RETURNS P.T.M. SW 6966 BLUEBLOOD. 1" TRIM CAP PAINTED TO MATCH RETURNS. INTERNALLY LIT WITH SLOAN BLUE (701269-BLSJ1-MB) LEDS.

2. .187" CLEAR PLEX FACE WITH FIRST SURFACE VINYL 3M 3730-157L SULTAN BLUE & SECOND SURFACE VINYL DIFFUSER 70% WHITE.

3. MOUNTED WITH MECHANICAL FASTENERS AND 2" SPACERS. SPACERS PAINTED TO MATCH BUILDING EXTERIOR.


# PLAY \ RACE \ DRINK \ EAT \

74'-0"

296 SQ. FT.

**QTY.1** 

**003** FACE-LIT CHANNEL LETTERS SCALE: 1/8" = 1'-0"

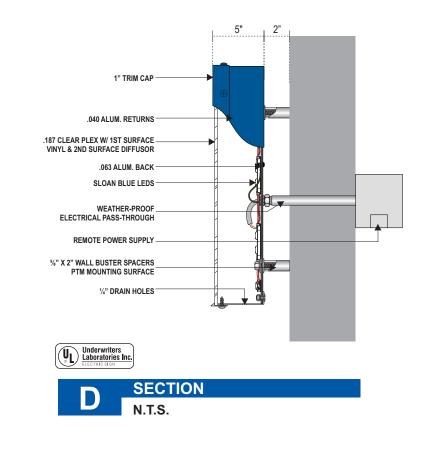

 P2 - PAINT TO MATCH BLUE SW 6966 BLUEBLOOD.
 V2 - VINYL TO MATCH SULTAN BLUE 3730-157L
 V3 - VINYL TO BE DIFFUSER 70% WHITE
 PAINTED TO MATCH BUILDING EXTERIOR

### **SPECIFICATIONS**

SSSC SIGNS&LIGHTING 972.219.2495

**CLIENT** Andretti Indoor Carting & Games

ADDRESS Albuquerque, NM

DATE 10.06.22
DESIGNER - GO
DRAWING NO.
220P7483-5

### REVISION

DATE


<u>1. AM</u> 1	0.10.22
2. REDUCE SIGN #5	10.18.22
OAH	AM
3. GROW SIGN #5	10.21.22
OAH	AM
4. ADD CROSS	10.25.22
SECTION DETAILS	AM
5. ADD CROSS	10.27.22
SECTION DETAILS	AM

**APPROVAL DATE -**

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PAGE 9 OF 13



- PAINTED TO MATCH BUILDING EXTERIOR
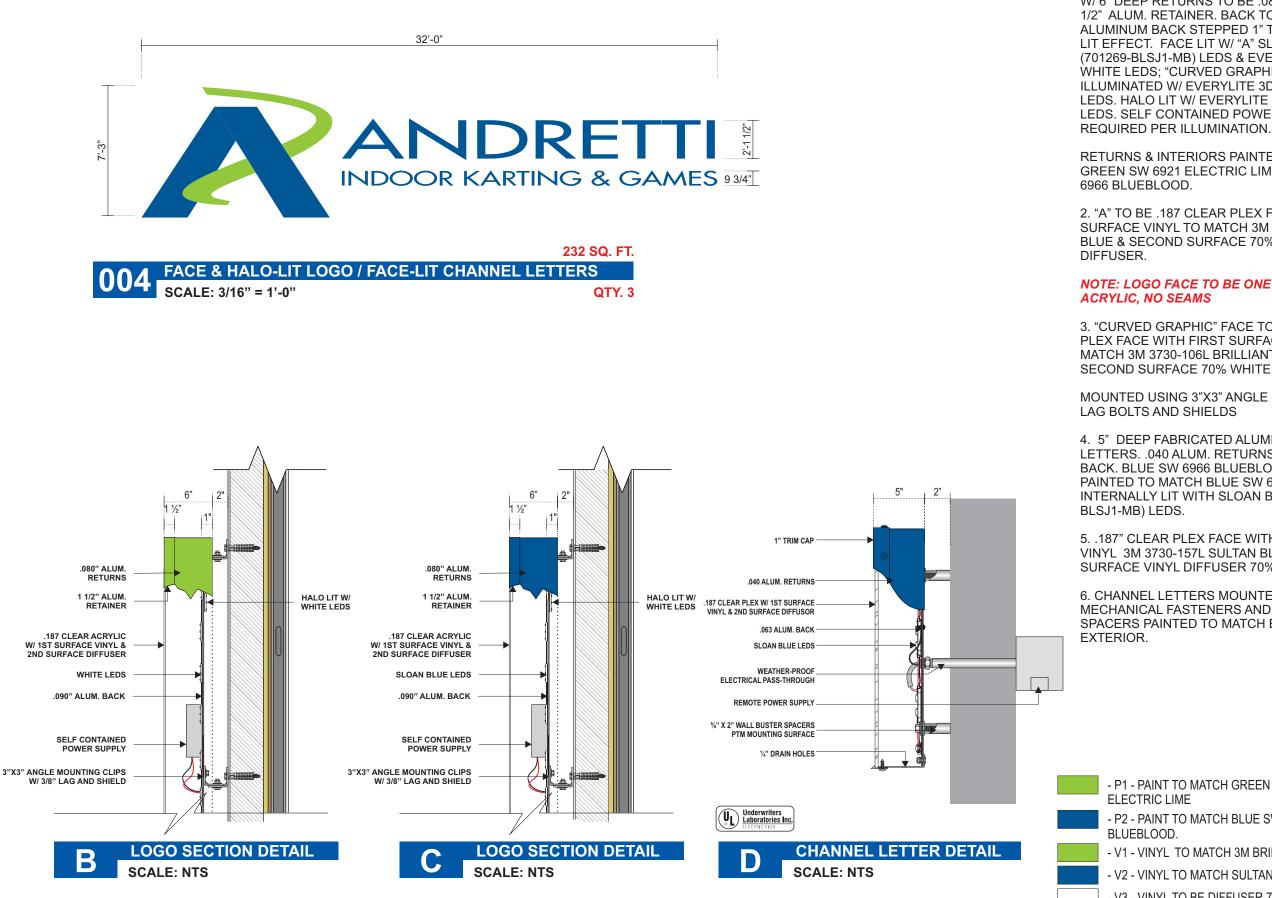
### **SPECIFICATIONS**

1. FABRICATED FACE & HALO LIT CHANNEL LOGO W/ 6" DEEP RETURNS TO BE .080" ALUMINUM & 1 1/2" ALUM. RETAINER. BACK TO BE .090" ALUMINUM BACK STEPPED 1" TO PROVIDE HALO LIT EFFECT. FACE LIT W/ "A" SLOAN BLUE (701269-BLSJ1-MB) LEDS & EVERYLITE 3D 6500 WHITE LEDS; "CURVED GRAPHIC" TO BE ILLUMINATED W/ EVERYLITE 3D 6500 WHITE LEDS. HALO LIT W/ EVERYLITE 3D 6500 WHITE LEDS. SELF CONTAINED POWER SUPPLY AS

**RETURNS & INTERIORS PAINTED TO MATCH** GREEN SW 6921 ELECTRIC LIME AND BLUE SW

2. "A" TO BE .187 CLEAR PLEX FACE WITH FIRST SURFACE VINYL TO MATCH 3M 3730-157L SULTAN **BLUE & SECOND SURFACE 70% WHITE** 

## NOTE: LOGO FACE TO BE ONE PIECE OF

3. "CURVED GRAPHIC" FACE TO BE .187 CLEAR PLEX FACE WITH FIRST SURFACE VINYL TO MATCH 3M 3730-106L BRILLIANT GREEN & SECOND SURFACE 70% WHITE DIFFUSER .

MOUNTED USING 3"X3" ANGLE CLIPS WITH 3/8"

4. 5" DEEP FABRICATED ALUMINUM CHANNEL LETTERS. .040 ALUM. RETURNS AND .063 ALUM BACK. BLUE SW 6966 BLUEBLOOD. 1" TRIM CAP PAINTED TO MATCH BLUE SW 6966 BLUEBLOOD. INTERNALLY LIT WITH SLOAN BLUE (701269-

5. .187" CLEAR PLEX FACE WITH FIRST SURFACE VINYL 3M 3730-157L SULTAN BLUE & SECOND SURFACE VINYL DIFFUSER 70% WHITE.

6. CHANNEL LETTERS MOUNTED WITH MECHANICAL FASTENERS AND 2" SPACERS. SPACERS PAINTED TO MATCH BUILDING

- P1 - PAINT TO MATCH GREEN SW 6921

- P2 - PAINT TO MATCH BLUE SW 6966

- V1 - VINYL TO MATCH 3M BRILLIANT GREEN 3730-106L

- V2 - VINYL TO MATCH SULTAN BLUE 3730-157L

- V3 - VINYL TO BE DIFFUSER 70% WHITE



CLIENT Andretti Indoor Carting & Games

**ADDRESS** Albuquerque, NM

**DATE** 10.06.22 **DESIGNER -** GO DRAWING NO. 220P7483-5

### REVISION

DATE


<u>1. AM</u> 1	0.10.22
2. REDUCE SIGN #5	10.18.22
OAH	AM
3. GROW SIGN #5	10.21.22
OAH	AM
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SECTION DETAILS	AM
5. ADD CROSS	10.27.22
SECTION DETAILS	AM

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### **SPECIFICATIONS**

FABRICATED ALUMINUM SIGN CABINET WITH 2" X 2" STACKED ALUM. SQ. TUBE WITH A 2" X 2" STRUCTURAL SUPPORT FRAME. SIGN COMP RETRO BLEED FRAME #2104 AND BLEED FACE COVERS #2121. BACK PANEL MADE USING .090 ALUM. **INTERNALLY ILLUMINATED & GRAPHIC** EVERYLITE 3D 6500 WHITE LEDS. CURVED GRAPHIC TO BE ILLUMINATED W/ EVERYLITE 3D 6500 WHITE LEDS. SELF CONTAINED POWER SUPPLY AS REQUIRED

BACKS, RETURNS, COVERS & SIGN INTERIORS PAINTED TO MATCH GREEN (3M VINYL 3630-136 LIME GREEN) AND BLUE (3M VINYL 3630-35 PATRIOT BLUE).

"A" TO BE .125 ALUMINUM WITH PAINTED BLUE TO MATCH "3M VINYL 3630-35 PATRIOT BLUE" & ILLUMINATED COVE BORDER.

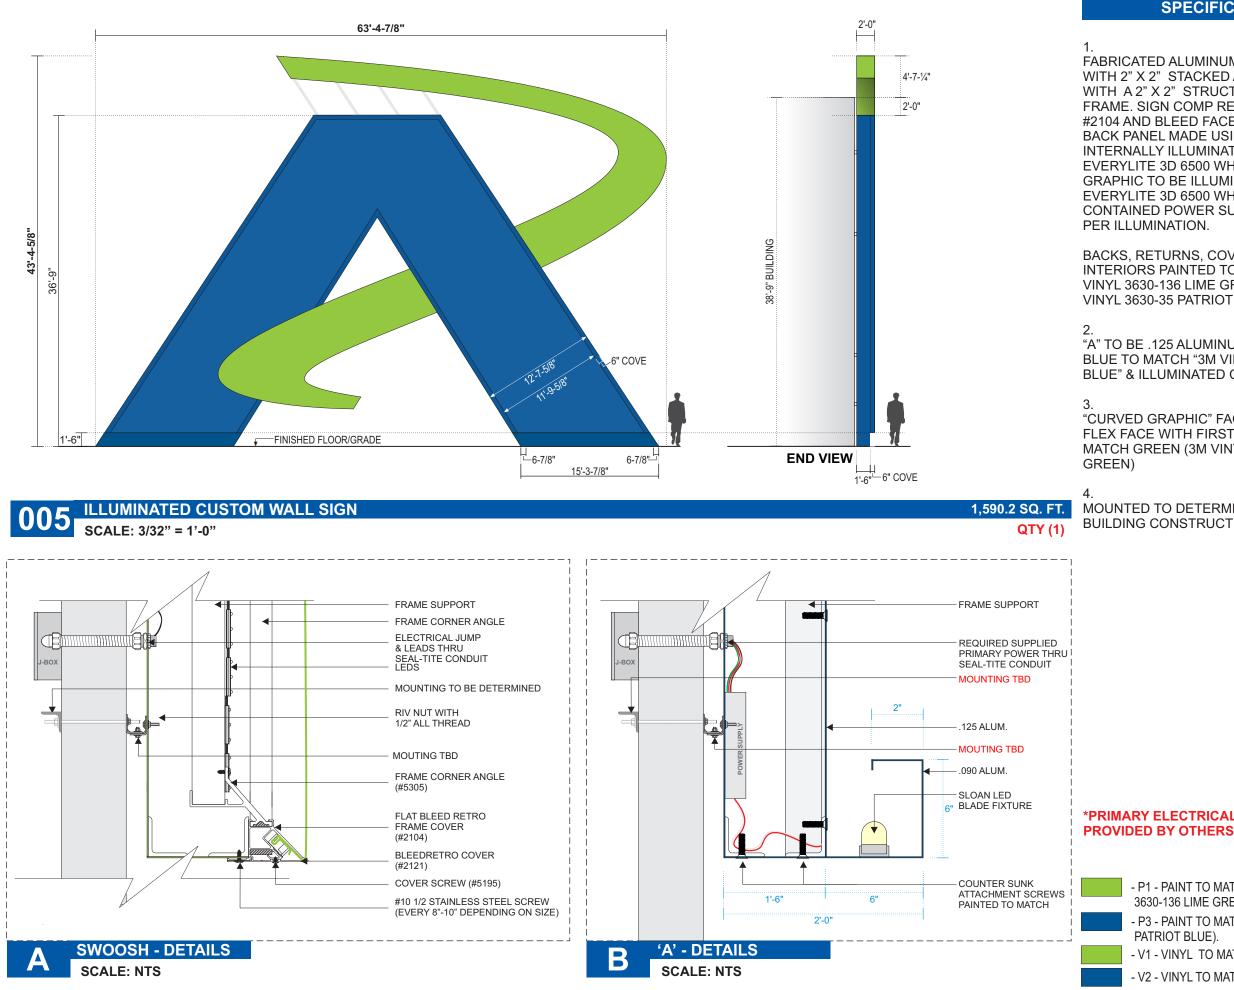"CURVED GRAPHIC" FACE TO BE WHITE FLEX FACE WITH FIRST SURFACE VINYL TO MATCH GREEN (3M VINYL 3630-136 LIME

MOUNTED TO DETERMINED BASE ON BUILDING CONSTRUCTION.

## **\*PRIMARY ELECTRICAL CIRCUIT TO SIGN**

- P1 - PAINT TO MATCH GREEN (3M VINYL 3630-136 LIME GREEN)

- P3 - PAINT TO MATCH BLUE (3M VINYL 3630-35 PATRIOT BLUE).

- V1 - VINYL TO MATCH 3M 3630-136 LIME GREEN

- V2 - VINYL TO MATCH 3630-47 PATRIOT BLUE

- V3 - VINYL TO BE DIFFUSER 70% WHITE



CLIENT Andretti Indoor Carting & Games

**ADDRESS** Albuquerque, NM

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OAH	AM
4. ADD CROSS	10.25.22
SECTION DETAILS	AM
5. ADD CROSS	10.27.22
SECTION DETAILS	AM


**APPROVAL DATE -**


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## LIT COVE CHANNEL






# (1)

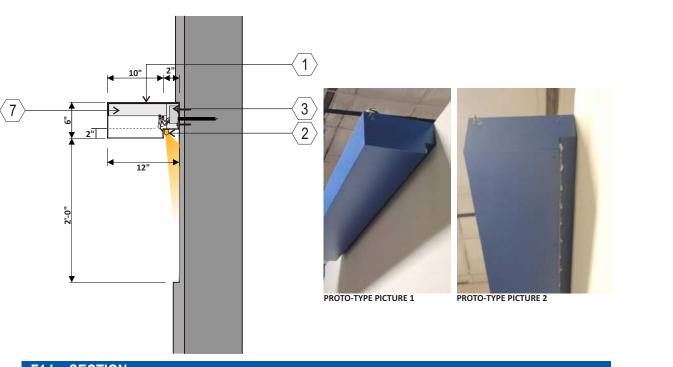
- $\langle 2 \rangle$  PRINCIPAL LED ILLUMINATION
- $\langle 3 \rangle$  LED POWER SUPPLY
- $\langle 5 \rangle$ MOUNTING HARDWARE (TBD)
- 6 PRIMARY POWER (BY OTHERS)
- 7 2" X 2" ALUM. ANGLE FRAME
- 8 DRAIN HOLE

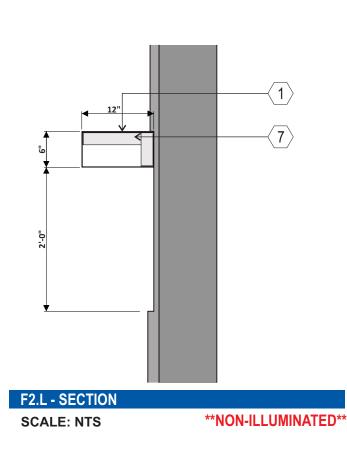NOTE:

- LEAKS.

F1.L - SECTION SCALE: NTS

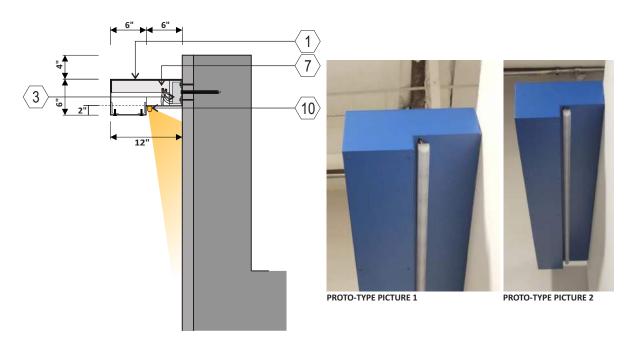

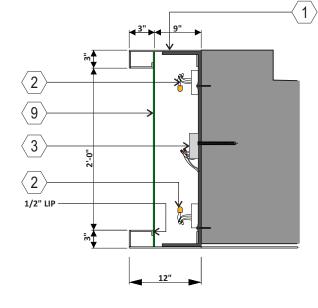



PROTO-TYPE PICTURE 1

F4.L - SECTION SCALE: NTS





## **SPECIFICATIONS**

BREAK-FORMED .090" ALUMINUM PAINTED P1, P2

 $\langle 4 \rangle$  REMOVABLE TOP SECURED WITH COUNTER SUNK SCREW

 $\langle$  9 angle 3/16" ACRYLIC WITH FIRST SURFACE TRANS. VINYL

 $\langle 10 \rangle$  sloan LED blade white illumination

#### ALL SEAMS COVERED AND SEALED FROM INSIDE CHANNEL WITH 2" BREAK- FORMED ALUMINUM CLIP TO PREVENT LIGHT

• SURVEY NEEDED TO DETERMINE LENGTHS AND CORNER DIMS.

- V1 - VINYL TO MATCH 3M BRILLIANT GREEN 3730-106L - P1 - MAP SATIN TO MATCH SW 6966 BLUEBLOOD. - P2 - MAP SATIN TO MATCH SW 6921 ELECTRIC LIME



CLIENT Andretti Indoor Carting & Games

ADDRESS Albuquerque, NM

**DATE** 10.06.22 **DESIGNER -** GO **DRAWING NO.** 220P7483-5

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# CLIENT, MANUFACTURING, AND INSTALLATION NOTES FOR ALL DESIGNS

# **CLIENT NOTES:**

1) CLIENT TO PROVIDE VECTOR ARTWORK INCLUDING CORRECT FONTS.

2) CLIENT TO PROVIDE ALL COLORS FOR SIGNS WITHIN DESIGN INCLUDING RACEWAY COLORS. COLORS TO BE PROVIDED ARE TO BE IN A SHERWIN WILLIAMS OR PANTONE / PMS COLORS. CMYK COLORS ARE NOT USABLE.

3) CLIENT TO APPROVE AND INITIAL DESIGNS THEN RETURN TO SSC SIGNS & LIGHTING ONCE APPROVED.

4) CLIENT TO PROVIDE ELECTRICAL TO ALL ILLUMINATED SIGNS. ELECTRICAL TO BE WITHIN 5'-0" OF SIGNAGE PRIOR TO INSTALL DATE.

5) ALL ELECTRICAL SCOPE TO BE INSTALLED BY TENANT CONTRACTOR

# **MANUFACTURING NOTES:**

1) IF SIGN NEEDS TO BE PERMITTED, MANUFACTURING WILL START AS SOON AS PERMITS ARE APPROVED BY CITY.

- 2) MANUFACTURING TO SUPPLY ALL NEEDED HARDWARE AND ELECTRICAL COMPONENTS NEEDED FOR INSTALLATION OF SIGN.
- 3) A MINIMUM OF 6'-0" WHIPS FROM THE BACK OF EACH CHANNEL LETTERS FOR INSTALLATION WHEN NEEDED.

# **INSTALLATION NOTES:**

1) INSTALLER TO INSPECT SIGN UPON RECEIPT AND REPORT ANY ISSUES OR DAMAGED ITEMS. INSTALLER WILL BE HELD LIABLE FOR ANY DAMAGES OR ISSUES REPORTED AFTER DAY SIGN IS RECEIVED.

- 2) INSTALLER TO VERIFY WITH CLIENT THAT SIGN IS BEING INSTALLED IN CORRECT LOCATION.
- 3) INSTALLER TO VERIFY ALL SERVICE IS COMPLETE PRIOR TO LEAVING THE SITE FOR THAT DAY AND/OR NIGHT INCLUDING COMPLETION PHOTOS OF SIGNS INSTALLED AND ILLUMINATED.

4) INSTALLER TO CLEAN UP ALL TRASH AND DEBRIS. ALSO, CLEAN ALL SIGNS AS NEEDED INCLUDING FACES.



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SECTION DETAILS	AM


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PLANNING DEPARTMENT URBAN DESIGN & DEVELOPMENT DIVISION 600 2nd Street NW, 3rd Floor, Albuquerque, NM 87102 P.O. Box 1293, Albuquerque, NM 87103 Office (505) 924-3860 Fax (505) 924-3339



## OFFICIAL NOTIFICATION OF DECISION

August 18, 2022

Albuquerque Investors LLC Woodsonia Real Estate Inc. 20010 Manderson St., Suite 101 Elkhorn, NE 68022-1264 Project #2019-002284 SI-2022-01301- Site Plan- Major Amendment

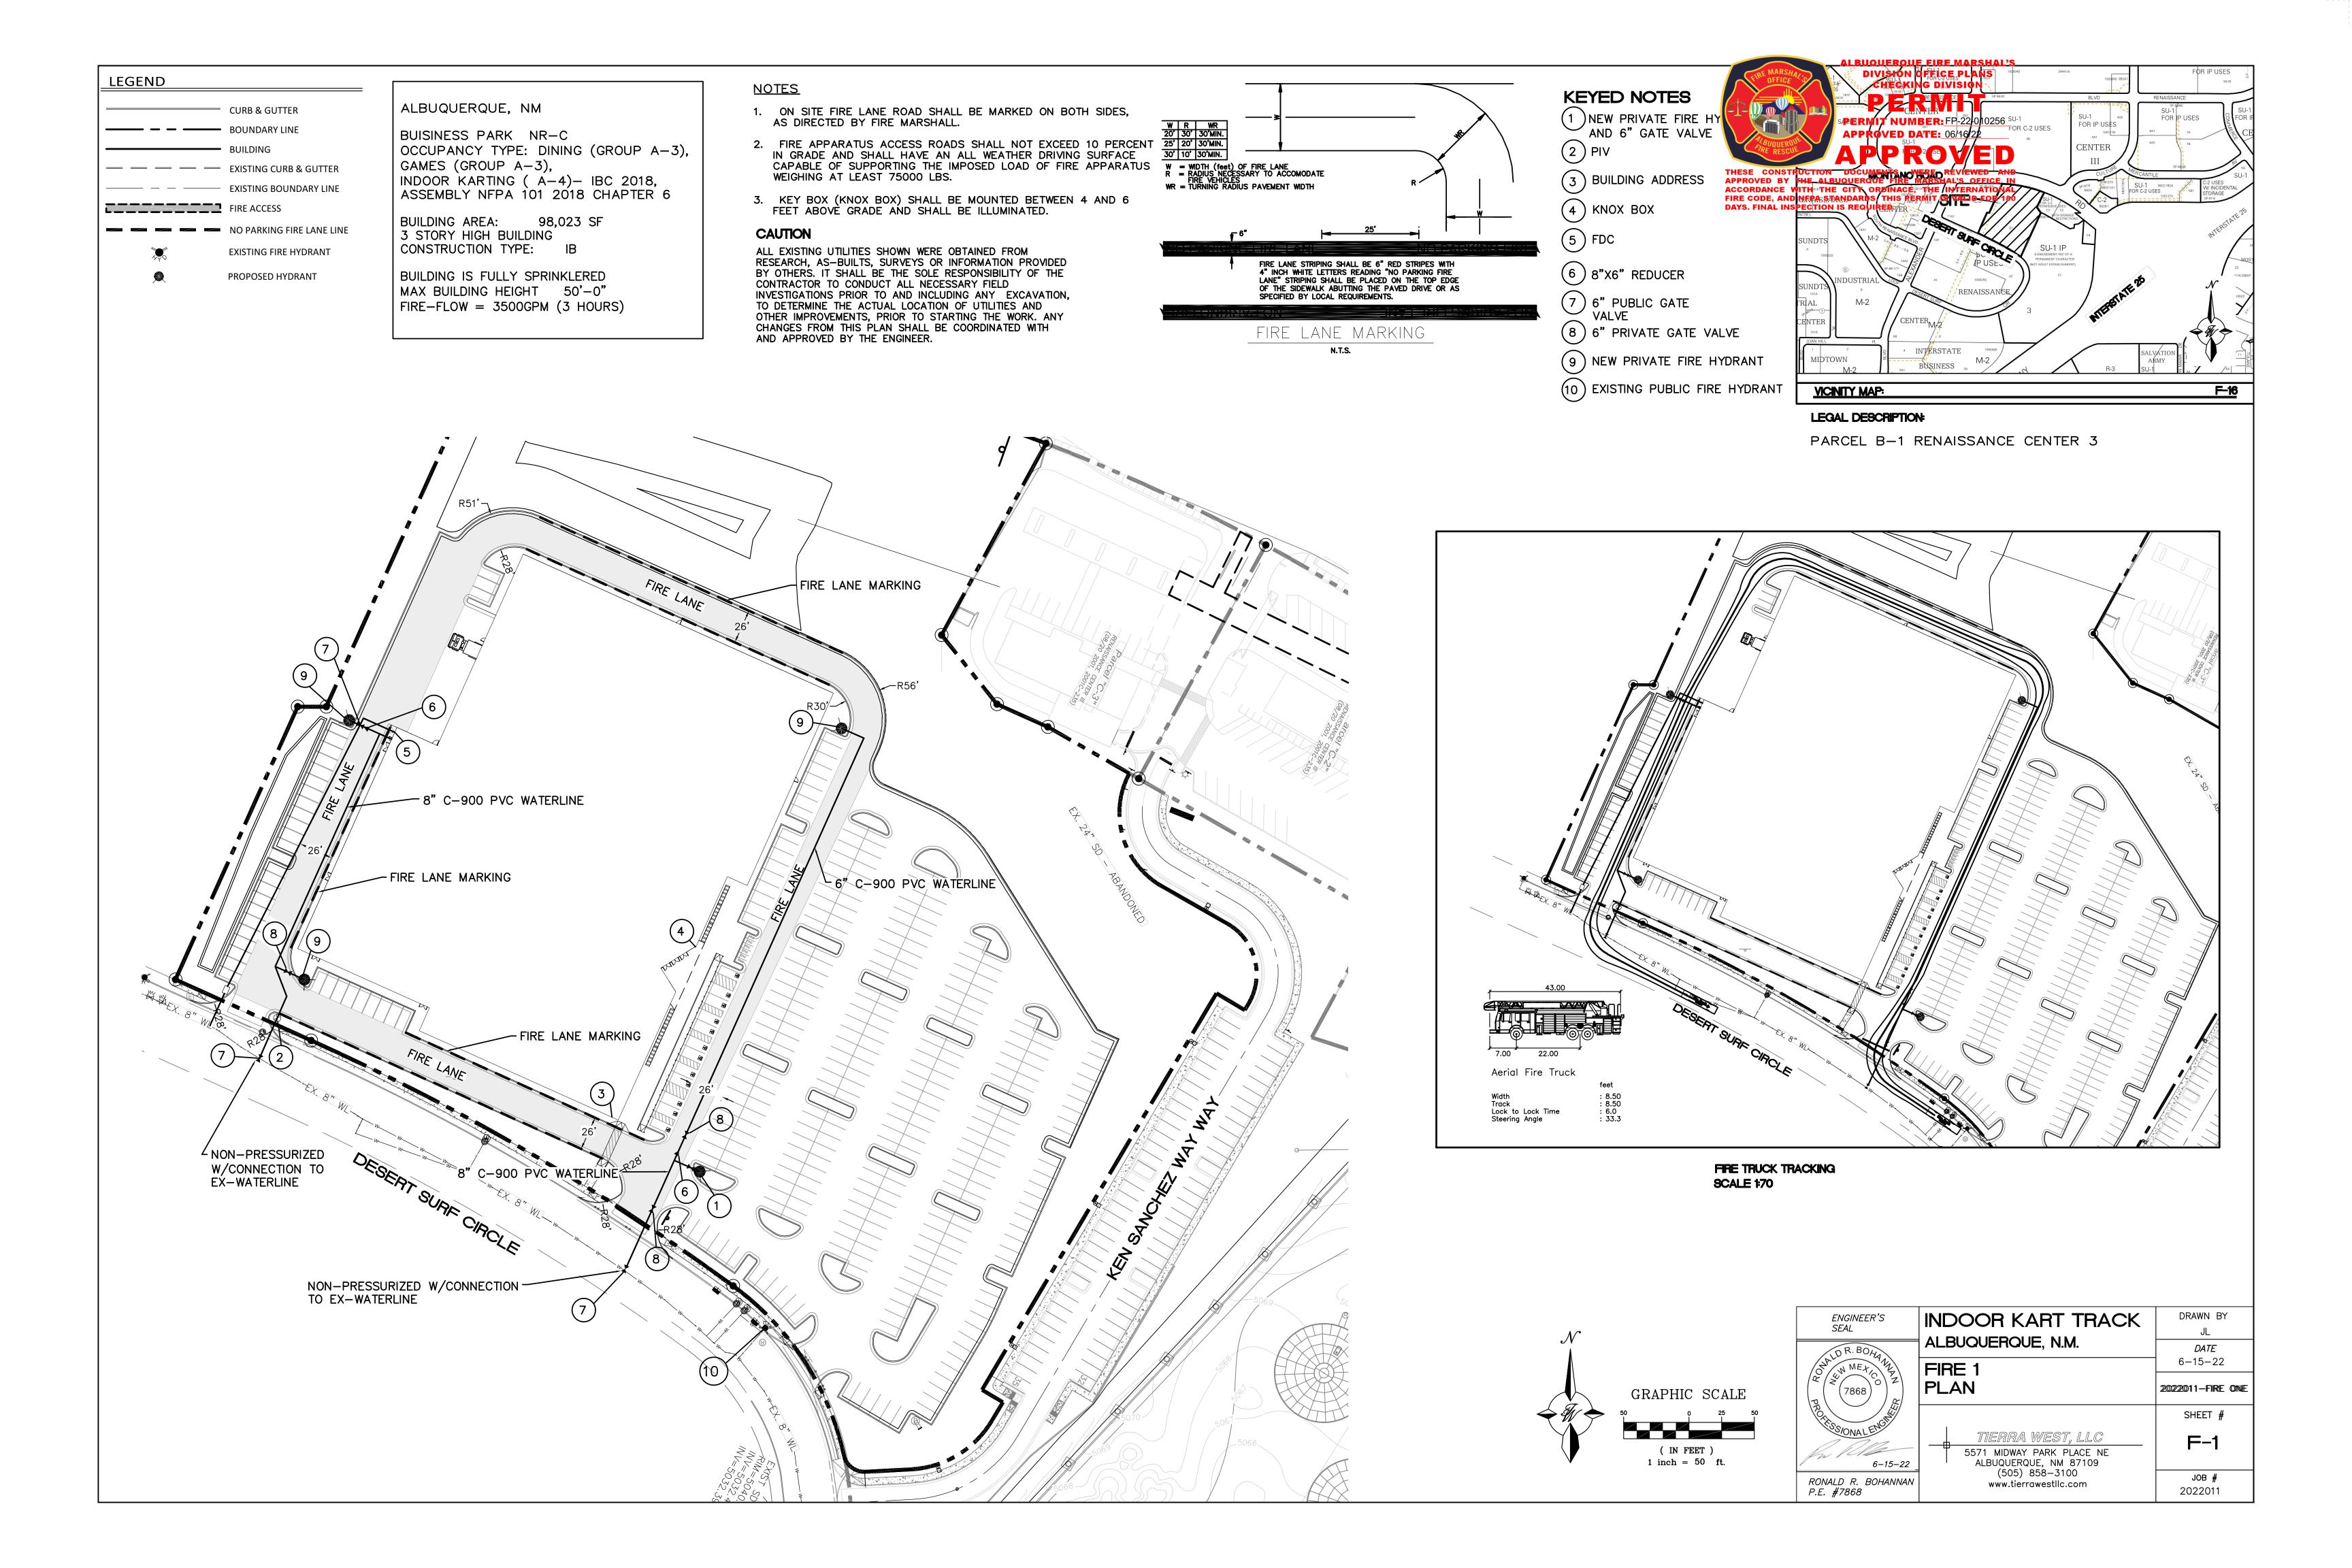**LEGAL DESCRIPTION:** 

Tierra West LLC, agent for Albuquerque Investors LLC, Woodsonia Real Estate Inc, requests a Site Plan- Major Amendment for all or a portion of Parcels C-1-A, C-1-B, and B-1-A (correction plat of parcels C-1-A, C-1-B and B-1-A) Renaissance Center III, located on Desert Surf Circle NE, between Alexander Blvd. NE, and Montano Rd. NE, approximately 24 acres (F-16-Z). Staff Planner: Megan Jones

On August 18, 2022, the Environmental Planning Commission (EPC) voted to APPROVE Project #2019-002284, SI-2022-01301- Site Plan- Major Amendment, based on the following Findings and subject to the following Conditions of Approval:

### Findings:

- 1. The request is for a Site Plan EPC-Major Amendment of a Pre IDO-Approval for an approximately 24-acre site legally described as all or a portion of Parcels C-1-A, C-1-B and B-1-A Renaissance Center III, Located on Desert Surf Circle NE, between Alexander Blvd NE, and Montano Rd. ("the subject site").
- 2. The subject site is zoned NR-C (non-residential Commercial), a zoning designation received upon adoption of IDO in May 2018. The subject site was formerly zoned SU-1 for SU-1 IP for Water Park and related facilities of a permanent character.
- 3. The subject site is within the boundaries of the 24-acre Beach Water Park Site Plan (Z-86-66). The subject site is controlled by an Administrative Amendment approved in 2019, (PR #2019-002284) for Tracts C-1-A, C-1-B and B-1-A, which was an amendment to the original controlling Site Development Plan.
- 4. The EPC is hearing this request because IDO Section 14-16-1-10(A) Pre-IDO Approvals states that any approvals granted prior to the effective date of the IDO shall remain valid, subject to expiration.

Major Amendments of Pre-IDO Approvals return to the original decision-making body pursuant to 14-16-6-4(Z)(1)(b).

- 5. The applicant wishes to amend the controlling Site Development Plan (PR # 2019-002284) to allow a 97,000 square foot Indoor Entertainment facility on tract B-1-A.
- 6. The subject site is located in the Renaissance Employment Center, within 660-feet of the Montano Rd. Major Transit Corridor, and in an Area of Change as designated by the Comprehensive Plan. It is in the Northwest Mesa Community Planning Area (CPA).
- 7. The Albuquerque/Bernalillo County Comprehensive Plan and the Integrated Development Ordinance (IDO) are incorporated herein by reference and made part of the record for all purposes.
- 8. The request is consistent with the following Comprehensive Plan Goals and Policies regarding Centers and Corridors from Chapter 5: Land Use
  - A. <u>Goal 5.1- Centers and Corridors</u>: Grow as a community of strong Centers connected by a multimodal network of Corridors.

The subject site is located in the Renaissance Employment Center and within 660' of the Montano Rd. Major Transit Corridor as designated by the Comprehensive Plan. The request would facilitate development of an Indoor Entertainment facility. Employment Centers are intended to remain predominately retail centers, while Major Transit Corridors are intended to be walkable and accessible along the Corridors and the Centers they connect. The proposed amendment is generally consistent with this goal by providing an additional commercial use in the center that has the infrastructure capacity to remain a walkable/accessible place, therefore strengthening the center.

B. <u>Policy 5.1.1 – Desired Growth</u>: Capture regional growth in Centers and Corridors to help shape the built environment into a sustainable development pattern.

The request would generally facilitate the capture of regional growth in Centers and Corridors by allowing the proposed development of an Indoor Entertainment facility that would attract residents from the greater Albuquerque area. The subject site is served by local transit with proposed bike lanes. Additionally, subject site is located in an Area of Change which allows for development that benefits the surrounding community in a designated Center accessible by pedestrians, transit and vehicles. The request would continue to shape the surrounding center and corridor into a sustainable development pattern.

C. <u>Policy 5.1.1, Subpolicy c</u>: Encourage employment density, compact development, redevelopment, and infill in Centers and Corridors as the most appropriate areas to accommodate growth over time and discourage the need for development at the urban edge

The subject site is located in the Renaissance Employment Center and within 660' of the Montano Rd. Major Transit Corridor as designated by the Comprehensive Plan. The request would facilitate redevelopment of Tract B-1-A on an infill location within the Center, which would create more opportunities for employment.

D. <u>Policy 5.1.1, Subpolicy h</u>: Encourage all new development, especially in designated Centers and Corridors, to address transit connections, linkages, and opportunities within the proposed development.

The request would allow Tract B-1-A to be redeveloped as an Indoor Entertainment facility in a designated Center and Corridor. The applicant has generally addressed transit connections, linkages, and opportunities within the proposed development. The proposed Site Plan that shows vehicular and pedestrian access points, although does not provide a direct connection to transit. The subject site has existing and proposed sidewalks that connect to transit along Montano Rd.

- 9. The request is consistent with the following Comprehensive Plan Goals and Policies regarding Efficient Development Patterns and Infill from Chapter 5: Land Use
  - A. <u>Policy 5.2.1 Land Uses</u>: Create healthy, sustainable, and distinct communities with a mix of uses that are conveniently accessible from surrounding neighborhoods.

<u>Subpolicy (a)</u>: Encourage development and redevelopment that brings goods, services, and amenities within walking and biking distance of neighborhoods and promotes good access for all residents.

The request would generally contribute to a healthy and sustainable community because it would facilitate development in an Employment Center that includes a mix of uses including retail, services, office, industrial and some residential. The subject site is within 660' of a Major Transit Corridor that has a proposed bike lane and existing sidewalks, as well as transit, making it conveniently accessible by pedestrians, transit and motor vehicles to neighborhoods outside of the Center.

B. <u>Policy 5.2.1, Subpolicy h:</u> Infill development that adds complementary uses and is compatible in form and scale to the immediately surrounding development.

The request would allow the development of an Indoor Entertainment use on a vacant lot that functions as an existing drainage pond within the Beach Water Park Site Plan. The proposed use would be complementary to the surrounding Employment Center, which is intended to be maintained a primarily retail area. Future development would be generally compatible in form and scale because Tract B-1-A is zoned NR-C and would be developed based on those standards. An indoor Entertainment use would be compatible with the other permitted uses within the subject site and surrounding area.

C. <u>Goal 5.3 – Efficient Development Patterns:</u> Promote development patterns that maximize the utility of existing infrastructure and public facilities and the efficient use of land to support the public good.

<u>Policy 5.3.1 Infill Development:</u> Support additional growth in areas with existing infrastructure and public facilities.

The subject site is located in an Area of Change and in a designated center, which are desired infill development locations. The proposed redevelopment on Tract B-1-A of the subject site would be served by existing infrastructure and public facilities. Future development made possible by the request would promote efficient development patterns and use of land.

D. <u>Goal 5.6 – City Development Areas</u>: Encourage and direct growth to Areas of Change where it is expected and desired to ensure that development in and near Areas of Consistency reinforces the character and intensity of the surrounding area.

The subject site is located in an Area of Change, where growth is expected and desired. The request would encourage enable and direct growth to it.

E. <u>Policy 5.6.2 – Areas of Change:</u> Direct growth and more intense development to Centers, Corridors, industrial and business parks, and Metropolitan Redevelopment Areas where change is encouraged.

The intent is to direct growth and more intense development to Centers, Corridors, and industrial and business parks. The request would further this policy as it is located in the renaissance Employment Center and within 660' of a Major Transit Corridor, where more intense development and growth is encouraged.

F. <u>Policy 5.6.2</u>, <u>Subpolicy b</u>): Encourage development that expands employment opportunities.

The Comprehensive Plan highlights Corridors within Areas of Change as areas where growth is desired and where additional residents, services, and jobs can be accommodated in locations ready for new development (Comp Plan pg. 5-23). The request would facilitate the development of an Indoor Entertainment facility in the Renaissance Employment Center, within 660' of a Major Transit Corridor, and in an Area of Change. A new Entertainment facility would create more jobs in a Center that is designated for high employment density.

- 10. The request is consistent with the following Comprehensive Plan Goals and Policies from chapter 7: Urban Design
  - A. <u>Policy 7.2.1 Walkability:</u> Ensure convenient and comfortable pedestrian travel. Subpolicy c: Ensure the location and design of sidewalks reflects the existing or planned character and intensity of surrounding land uses.

Policy 7.2.1, Subpolicy j: Emphasize pedestrian connections between buildings on a site and to adjacent uses.

The proposed Site Plan follows the design standards within the NR-C zone district and DPM, therefore provides pedestrian access points at appropriate locations on the Site Plan. It is located within 660' of the Montano Major Transit Corridor, which has a planned bike route and two transit routes with parallel stops near the subject site. The development of the site will ensure sidewalk construction along the frontage of the site ensuring convenient pedestrian travel between Tract B-1-A and the greater subject site.

B. <u>Policy 7.3.4 Infill:</u> Promote infill that enhances the built environment or blends in style and building materials with surrounding structures and the streetscape of the block in which it is located.

The request is for the development of a Indoor Entertainment use on Tract B-1-A of the subject site, which is currently vacant. The request would promote infill that blends in style with the surrounding structures and the streetscape by following design standards in the IDO for the NR-c zone district, Employment Centers, and Major Transit areas.

- 11. The request is consistent with the following Comprehensive Plan Goals and Policies from Chapter 8: Economic Development
  - A. <u>Goal 8.1- Placemaking: Create</u> places where business and talent will stay and thrive.

The Comprehensive Plan states that infill of vacant land is crucial to economic development and will help provide attractive, well-connected urban places that attract knowledge-based employers and the workforce they need (Comp Plan pg. 8-15). The subject site zoned NR-C and in the Renaissance Employment Center, which the comprehensive plan designates as a high employment density area near transit. The request would help contribute to this.

B. <u>Policy 8. 1. 2 - Resilient Economy:</u> Encourage economic development efforts that improve quality of life for new and existing residents and foster a robust, resilient, and diverse economy.

The request would facilitate the development of a new Indoor Entertainment Facility in a designated Employment Center on an infill site. The development could result in a new employment opportunity for new and existing residents in the surrounding area, which is accessible by all transportation modes. The request could foster a robust, resilient, and diverse economy by providing a new Indoor Entertainment facility in an established Employment Center and within 660' of a Major transit Corridor.

- 12. The request meets the Site Plan-EPC Review & Decision Criteria in IDO Section 14-16-6-6(J)(3) as follows:
  - A. 14-16-6-6(J)(3)(a) As demonstrated by the policy analysis of the site plan, the request is consistent with applicable Comprehensive Goals and Policies.
  - B. <u>14-16-6-6(J)(3)(b)</u> The subject site is zoned NR-C; therefore, this criterion does not apply.
  - C. <u>14-16-6-6(J)(3)(c)</u> The proposed major amendment would allow an approximately 97,000 SF Indoor Entertainment facility on Tract B-1-A of the controlling Site Plan. The proposed site plan would comply with all applicable provisions of the IDO, DPM and any other adopted City regulations.
  - D. 14-16-6-6(J)(3)(d) The City's existing infrastructure has adequate capacity for the proposed development made possible by this request. The applicant has stated that the developer is responsible for mitigating any potential negative impacts to any existing infrastructure.

- E. <u>14-16-6-6(J)(3)(e)</u> The applicant has demonstrated that the request would not negatively impact the surrounding area based on their responses to applicable Comp Plan Goals and Policies. The applicant has stated that the proposed development would comply with the IDO mitigating any significant adverse impacts on the surrounding area to the maximum extent practicable.
- F. <u>14-16-6-6(J)(3)(f)</u> The subject property is not within a Master Development Plan. It is within the boundaries of the beach Water Park Site Plan and is zoned NR-C. The request for Indoor Entertainment uses is permissible under this zone district pursuant to the IDO.
- G. 14-16-6-6(J)(3)(g) The subject property is not within the Railroad and Spur Area and no cumulative impact analysis is required.
- 13. There are not any affected, registered neighborhood organizations for the subject site. Property owners within 100 feet of the subject site were notified, as required.
- 14. A pre-submittal neighborhood meeting and a facilitated meeting were offered, but not held.
- 15. Staff has crated conditions of approval to ensure applicable IDO regulations are met prior to DRB final sign-off.
- 16. As of this writing, Staff is not aware of any support or opposition to the request.
- 17. Once the EPC has approved the Major Amendment request, the applicant is required to submit to the DRB for final sign-off of the associated, proposed site plan. After December 25th, 2022 the applicant would instead go to the Development Hearing Officer (DHO).
- 18. The associated site plan shows less parking than what is required pursuant to IDO Table 5-5-1 for the Other Indoor Entertainment use. Staff cannot overlook IDO requirements and, therefore, has conditioned that the parking requirement be met. However, in the future the applicant may request a Waiver-DRB pursuant to IDO 14-16-6-6(P) to allow the desired amount of parking or consider a shared parking agreement.

### Conditions:

- 1. The EPC delegates final sign-off authority of this site plan to the Site Plan- DRB Process as per IDO Section 14-16-6-6(I). The reviewer will be responsible for ensuring that the EPC Conditions have been satisfied and that other applicable City requirements have been met.
- 2. The applicant shall coordinate with the Staff planner prior to submitting to the DRB for final signoff.
- 3. Site Plan (Sheet SP-1):
  - A. Show location of Keyed Note 13.
  - B. Parking Calculations must be shown and pursuant to IDO Table 5-5-1 for Other Indoor Entertainment, which is listed as 1 space / 3 persons design capacity, or IDO Table 5-5-2,

whichever is greater. Table 5-5-2 does not have this use listed, so the former applies, unless the applicant obtains a waiver from the DRB or presents a shared parking agreement.

- 4. Landscape Plan (Sheet 2)
  - A. Provide dimensions for all plant beds, distances between trees, etc. Street frontage trees must be 25-feet apart pursuant to IDO 5-6(D)(1).
  - B. Show all curb cuts pursuant to IDO section 14-16-5-6(C)(13).
- 5. Lighting:
  - A. Show locations of light poles on the site plan.
  - B. Provide light pole detail indicating height, color, and finish.
- 6. Detail Sheet (Sheet Det-1): Standard Curb General note 1: should state COA specs, not Wal-Mart specs in the body.
- 7. Elevation Sheets/Signage:
  - A. Max building height in NR-C is 38-feet. The top of parament exceeds this max by 9" and must be reduced to 38-feet.
  - B. Signage area calculations shall be provided
  - C. Building mounted signs shall not exceed 15% of façade area in which it is located in the NR-C zone district, pursuant to IDO Table 5-12-2.
  - D. Add sign details to elevations.
  - E. Sign permits shall be acquired for all monument signs as well as wall signs greater than 24 square feet, pursuant to IDO 5-12(D)(1).
- 8. Condition from Solid Waste Management Department:

A single enclosure will not suffice for a proposed 96,000 SF building. A sanitary drain will be required for the trash enclosure, along with a site plan approved by the Solid Waste Department.

- 9. Conditions from PNM:
  - A. Applicant will coordinate with PNM regarding any existing easements that have to be revisited and/or new easements that need to be created for any electric facilities as determined by PNM.
  - B. Any existing and/or new PNM easements and facilities need to be reflected on any resulting future Site Plan or Plat.

- C. Typical electric utility easement widths vary depending on the type of facility. On-site transformers should have a ten-foot clear area around them to allow for access and maintenance. Structures, especially those made of metal like storage buildings and canopies, should not be within or near PNM easements.
- D. Perimeter and interior landscape design should abide by any easement restrictions and not impact PNM facilities. Any trees within or near PNM easements including any required Street Trees should comply with IDO Section 5-6(C)(10) as applicable.
- 10. Condition from AMAFCA:

AMAFCA will need to review the grading and drainage plan and drainage report for this site. AMAFCA recommends that none of the existing drainage easements or covenants be vacated/released prior to approval of the grading and drainage plan and drainage report.

<u>APPEAL</u>: If you wish to appeal this decision, you must do so within 15 days of the EPC's decision or by **September 2, 2022**. The date of the EPC's decision is not included in the 15-day period for filing an appeal, and if the 15<sup>th</sup> day falls on a Saturday, Sunday or Holiday, the next working day is considered as the deadline for filing the appeal.

For more information regarding the appeal process, please refer to Section 14-16-6-4(V) of the Integrated Development Ordinance (IDO), Administration and Enforcement. A Non-Refundable filing fee will be calculated at the Land Development Coordination Counter and is required at the time the appeal is filed. It is not possible to appeal an EPC Recommendation to the City Council since this is not a final decision.

You will receive notification if any person files an appeal. If there is no appeal, you can receive Building Permits at any time after the appeal deadline quoted above, provided all conditions imposed at the time of approval have been met. Successful applicants are reminded that other regulations of the IDO must be complied with, even after approval of the referenced application(s).

Sincerely,

Catalina Lehner

for Alan M. Varela, Planning Director

AV/CL/MJ

cc: Albuquerque Investors LLC Attn: Woodsonia Real Estate Inc, 20010 Manderson St Suite 101, Elkhorn, NE 68022-1264 Tierra West, LLC, 5571 Midway Park Place NE, Albuquerque NM, 87109 Legal, <u>dking@cabq.gov</u> EPC File



June 3, 2022

Ms. Jolene Wolfley, Chair

**Development Review Board** 

City of Albuquerque

P.O. Box 1293

Albuquerque, NM 87103

RE: ANDRETTI RACING – ENTERTAINMENT FACILITY DESERT SURF CIR NE UPC: 101606122811730119 PARCEL B-1-A CORRECTION PLAT OF PARCELS C-1-A

C-1-B AND B-1-A RENAISSANCE CENTER III

**ZONE ATLAS PAGE: F-16-Z** 

Dear Ms. Wolfley:

The purpose of this letter is to authorize Tierra West LLC to act as agent on behalf of Woodsonia Real Estate, Inc. C/O Drew Snyder pertaining to any and all submittals made to the City of Albuquerque for the above-referenced site.

Drew Snyber

Print Name

On n

Signature

Prop Owner 022

Title

Date

### FORM P: PRE-APPROVALS/SIGNATURES

Please refer to the DRB public meeting schedule for meeting dates and deadlines. Your attendance is required.

Legal Description & Location: Parcel B-1-A Correction Plat of Parcels C-1-A, C-1-Band B-1-A Renaissance Center III

Job Description:	Andretti	
☑ <u>Hydrology:</u>		
<ul> <li>Grading and Drainage Plan</li></ul>	K     Approved     NA       Approved     X     NA       12/20/2022     Date	
□ <u>Transportation:</u>		
<ul> <li>Traffic Circulations Layout (TCL)</li> <li>Traffic Impact Study (TIS)</li> <li>Neighborhood Impact Analysis (NIA</li> <li>Bernalillo County</li> <li>MRCOG</li> <li>NMDOT</li> <li>MRGCD</li> </ul>	X       Approved       NA         X       Approved       NA         Approved       X       NA	
	12/20/2022 Date	
Albuquerque Bernalillo County Water Utility Authority (ABCWUA): #220616		
<ul> <li>Water/Sewer Availability Statement/Serviceability Letter <u>x</u> Approved <u>NA</u></li> <li>ABCWUA Development Agreement <u>Approved</u> <u>x</u> NA</li> <li>ABCWUA Service Connection Agreement <u>Approved</u> <u>x</u> NA</li> </ul>		
<u>Sarah Luckia</u> ABCWUA	<u>11/2/2022</u> Date	
<ul> <li>Infrastructure Improvements Agreeme</li> <li>Solid Waste Department Signature on</li> <li>Fire Marshall Signature on the plan</li> </ul>		
Hydrology Department         □       Transportation:         •       Traffic Circulations Layout (TCL)         •       Traffic Impact Study (TIS)         •       Neighborhood Impact Analysis (NIA         •       Bernalillo County         •       MRCOG         •       NMDOT         •       MRGCD         Emest Emijo         Transportation Department         ✓       Albuquerque Bernalillo County Wate         •       Water/Sewer Availability Statement         •       ABCWUA Development Agreement         •       ABCWUA Service Connection Agreement         •       ABCWUA         •       Infrastructure Improvements Agreement         •       Solid Waste Department Signature ont	A) $\begin{array}{c ccccccccccccccccccccccccccccccccccc$	

\* Prior to Final Site Plan approval submittals (include a copy of the recorded IIA)

#### POST EPC MEMORANDUM

TO: Tierra West, LLC

DRB Chair, Jolene Wolfley

FROM: Megan Jones, Current Planner

DATE: 10-31-2022

RE: The Beach MA Andretti PR-2019-00284, Post EPC Conditions

The applicant, Tierra West, has worked with Staff to fulfill post EPC requirements to meet Conditions of Approval, 1-10, for SI-2022-01301.

The applicant provided a detailed letter (see attached), describing how each condition has been met in regards to the Site Plan, Landscaping Plan, Parking, Lighting and Landscaping. The Site Plan Includes a note stating that a Parking Study Reduction has been approved.

- The applicant has stated that they will be: 1) Applying for a building height reduction at the time of DRB application.
  - 2) Applying for Sign Permits at the time of construction in order to meet IDO 14-16-5-12(D)91) requirements.
  - 3) Working with PNM on conditions at the time a service request is submitted.

Tierra West, LLC, Agent for Albuquerque Investors, LLC, has adequately satisfied Conditions for NOD dated August 18, 2022 (PR# 2019-002284, SI-2022-01301) Site Plan EPC, Major Amendment.

Megan Jones

Megan Jones, Current Planner

# TIERRA WEST, LLC

October 27, 2022

Mr. Alan M. Varela Planning Department Urban Design & Development Division 600 2<sup>nd</sup> Street NW, 3<sup>rd</sup> Floor Albuquerque, NM. 87102

### RE: 2022011 ANDRETTI RACING EPC CONDITIONS RESPONSE LETTER

Dear Mr. Varela:

Per the correspondence dated August 18, 2022, please find the following response addressing the comments listed below:

#### Conditions:

 The EPC delegates final sign-off authority of this site plan to the Site Plan – DRB Process as per IDO Section 14-16-6-6(I). The reviewer will be responsible for ensuring that the EPC Conditions have been satisfied and that other applicable City requirements have been met.

Plans to be submitted to DRB once Planner concurs all conditions are addressed. We believe we have met all of the conditions.

2. The applicant shall coordinate with the Staff planner prior to submitting to the DBR for final sign-off.

That is the purpose of this letter and attached plans and believe we have met all of the conditions

- 3. Site Plan (Sheet SP-1):
  - A. Show location of Keyed Note 13. Keyed Note 13 can be found near the front doors of the facility.
  - B. Parking Calculations must be shown and pursuant to IDO Table 5-5-1 for Other Indoor Entertainment, which is listed as 1 space / 3 persons design capacity, or IDO Table 5-5-2, whichever is greater. Table 5-5-2 does not have this use listed, so the former applies, unless the applicant obtains a waiver from the DRB or presents a shared parking agreement.

We presented a minimum parking requirement study that was approved by the Planning Director and is attached.

- 4. Landscape Plan (Sheet 2)
  - A. Provide dimensions for all plant beds, distances between trees, etc. Street frontage trees must be 25-feet apart pursuant to IDO 5-6(D)(1). This information was added to the Plan.
  - B. Show all curb cuts pursuant to IDO section 14-16-5-6(C)(13).

Providing a call out for all island curb cuts were clutter the plans. Instead, we have added a typical detail found on Sheet DET-3.

- 5. Lighting:
  - A. Show locations of light poles on the site plan. The locations of the site lighting are shown by a symbol, which is listed in the Legend.

B. Provide light pole detail indicating height, color, and finish.

The light pole information can be found on Sheet DET-2

6. Detail Sheet (Sheet Det-1):

Standard Curb General note 1: should state COA specs, not Wal-Mart specs in the body.

This note was deleted from the detail.

- 7. Elevation Sheets/Signage:
  - A. Max building height in NR-C is 38-feet. The top of parament exceeds this max by 9" and must be reduced to 38-feet. We have confirmation from the DRB Chair that we may request a deviation for the proposed height per the IDO. We will be pursuing a deviation for this minor exceedance.
  - B. Signage are calculations shall be provided. The signage calculations are shown on the attached signage package.
  - C. Building mounted signs shall not exceed 15% of facade area in which it is located in the NR-C zone district, pursuant to IDO Table 5-12-2. All of the signage on each building façade meets this requirement.
  - D. Add sign details to elevations. A sign package is added to the set showing all of the signage details and area.
  - E. Sign permits shall be acquired for all monument signs as well as wall signs greater than 24 square feet, pursuant to IDO 5-12(D)(1). This is understood and the contractor will apply for the permit when under construction
- 8. Condition from Solid Waste Management Department:

A single enclosure will not suffice for a proposed 96,000 SF building. A sanitary drain will be required for the trash enclosure, along with a site plan approved by the Solid Waste Department.

The trash enclosure was coordinated with Solid Waste and the plan with their signature is enclosed.

- 9. Conditions from PNM:
  - A. Applicant will coordinate with PNM regarding any existing easements that have to be revisited and/or new easements that need to be created for any electric facilities as determined by PNM. This is understood and will be completed at the time a service request is entered into the PNM web site.
  - B. Any existing and/or new PNM easements and facilities need to be reflected on any resulting future Site Plan or Plat. **This is understood.**
  - C. Typical electric utility easement widths vary depending on the type of facility. Onsite transformers should have a ten-foot clear area around them to allow for access and maintenance. Structures, especially those made of metal like storage buildings and canopies, should not be within or near PNM easements. **This is understood and will be coordinated with PNM.**
  - D. Perimeter and interior landscape design should abide by any easement restrictions and not impact PNM facilities. Any trees within or near PNM easements including any required Street Trees should comply with IDO Section 5-6(C)(10) as applicable. This is understood.
- 10. Condition from AMAFCA:

AMAFCA will need to review the grading and drainage plan and drainage report for this site. AMAFCA recommends that none of the existing drainage easements or covenants be vacated/released prior to approval of the grading and drainage plan and drainage report.

A Conceptual Grading and Drainage Plan was approved by the City and that was sent to AMAFCA for review and comment. Any comments will be address when the plans are submitted for Building Permit.

If you have any questions or need additional information regarding this matter, please do not hesitate to contact me.

Sincerely,

11/1

Ronald R. Bohannan, P.E

JN: 2022011 RRB/jn/ca