



E
Chick-fil-A
5200 Buffington Road
Atlanta, Georgia
30349-2998



D
1700 INDUSTRIAL DRIVE
SUITE B
ROGERS, AR 72756
479.986.440
www.core-eng.com

CHICK-FIL-A ALBUQUERQUE, NM

4001 COORS BLVD
ALBUQUERQUE, NM 87120

FSR#04107

BUILDING TYPE / SIZE: P12 SE LRG
RELEASE: v2.18.08

REVISION SCHEDULE
NO. DATE DESCRIPTION
10/30/18 SCHEMATIC DESIGN ISSUE

CONSTRUCTION DOCUMENTS


CONSULTANT PROJECT #	25779
PRINTED FOR CONSTRUCTION DOCUMENTS	
DATE	06/26/19
DRAWN BY	C. ELIAS
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SHEET	COVER SHEET
SHEET NUMBER	G-01



5200 BRUFFINGTON ROAD
ATLANTA, GEORGIA 30349-2998
PHONE: (404) 765-8000
FAX: (404) 684-8550

COORS BLVD AND ST JOSEPH'S DR ALBUQUERQUE, NM 87120

VICINITY MAP

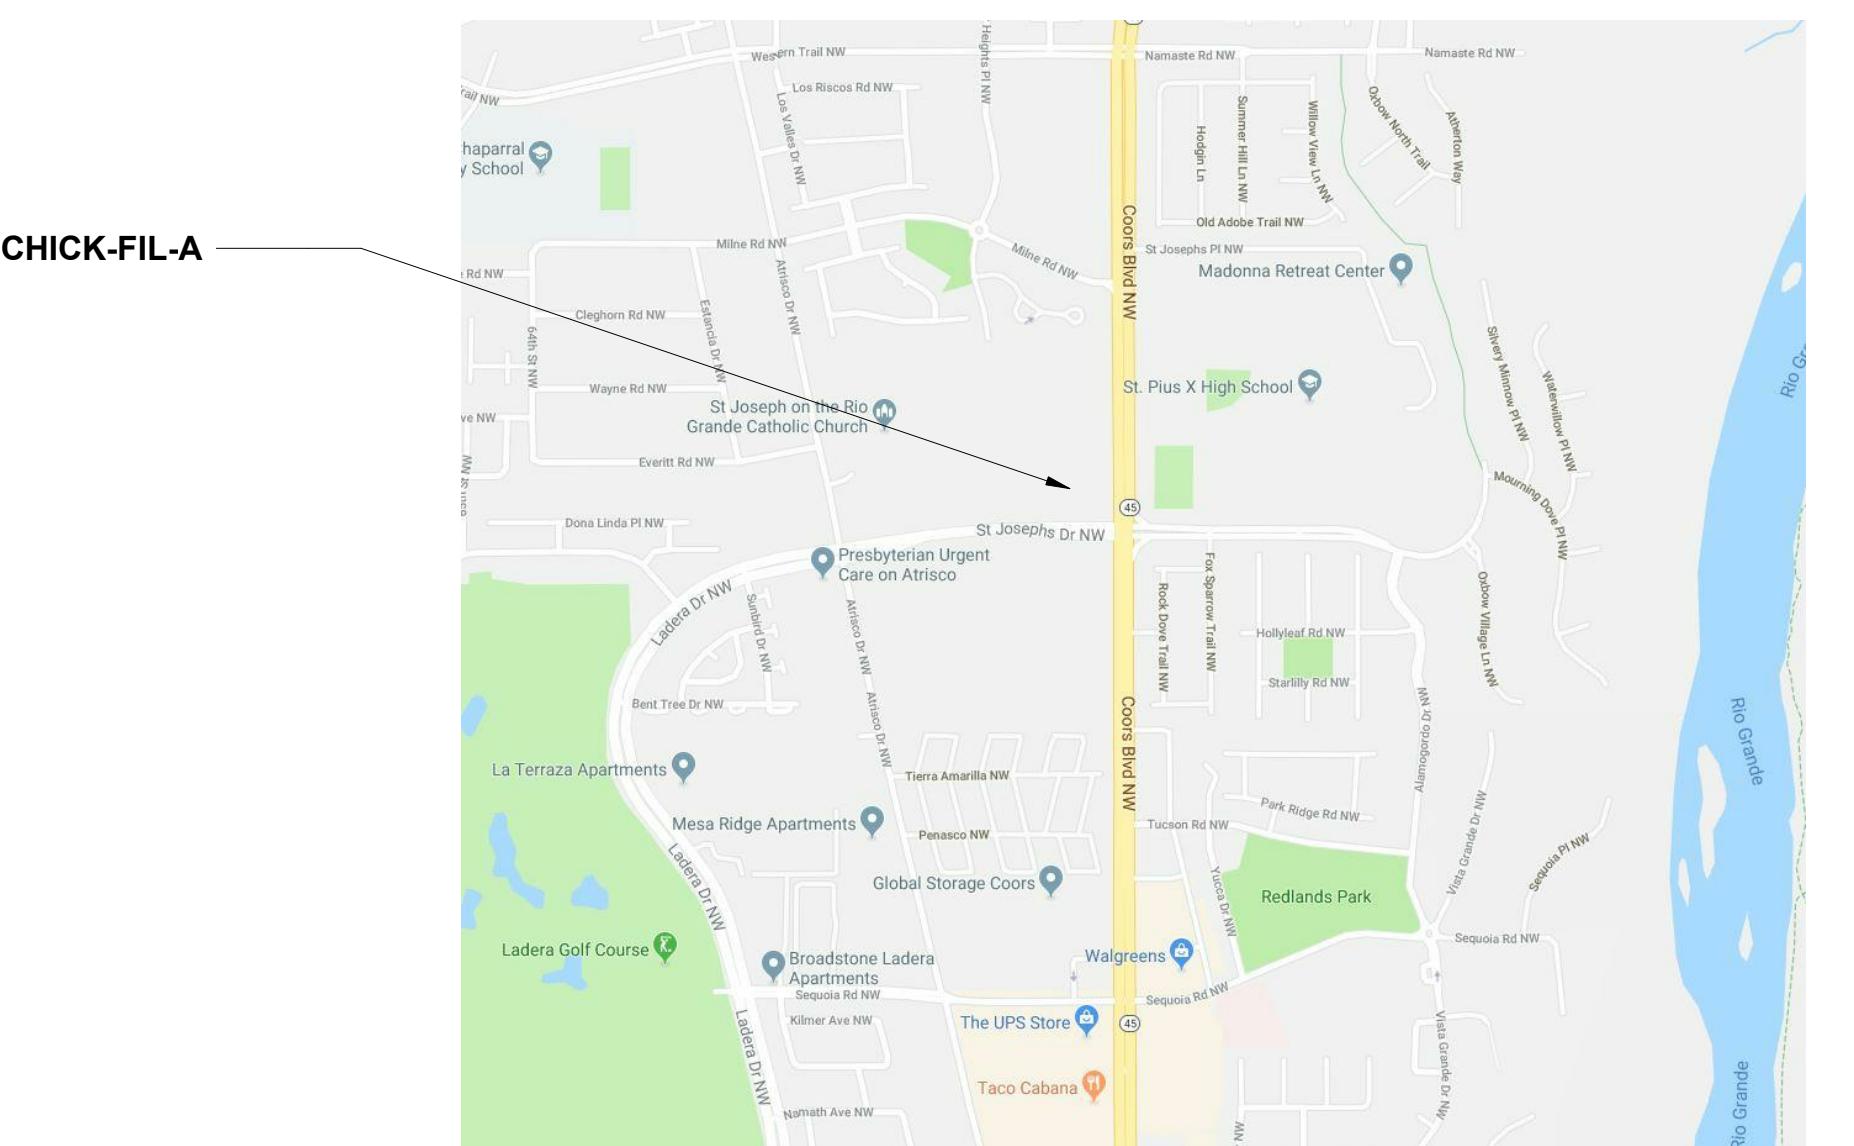

CODE INFORMATION

BUILDING CODE:
(2015) International Building Code

PLUMBING CODE:
(2015) International Plumbing Code

MECHANICAL CODE:
(2015) International Mechanical Code

ELECTRICAL CODE:
(2017) National Electric Code

ENERGY CODE:
(2009) New Mexico Energy Conservation Code

FIRE CODE:
(2015) International Fire Code with

ACCESSIBILITY CODE:
(2009) ICC/ANSI

BUILDING DATA

1. OCCUPANCY A2
2. CONSTRUCTION TYPE VB - SPRINKLERED
3. ALLOWABLE AREA 6,000 SQ. FT.
4. SITE AREA 1.16 ACRE 50,690 S.F.
5. ZONING: C-2 (COMMUNITY COMMERCIAL ZONE)

PARKING DATA

- | | | |
|---------------------|-------------------------|--------------------|
| 1. PARKING REQUIRED | STANDARD SPACES | 1 PER 125 G.S.F. |
| | REQUIRED SPACES | 5,014 / 125 = 40.1 |
| | | (41 SPACES) |
| 2. PARKING PROVIDED | OUTDOOR SPACES | 1 PER 200 G.S.F. |
| | REQUIRED SPACES | 591 / 200 = 2.9 |
| | | (3 SPACES) |
| | TOTAL REQUIRED SPACES = | (44 SPACES) |
| | STANDARD SPACES | 48 |
| | COMPACT SPACES | 00 |
| | ACCESS SPACES | 00 |
| | MOTORCYCLE SPACES | 02 |
| | TOTAL PROVIDED SPACES | 53 SPACES |

LEGAL DESCRIPTION

AS CONTAINED IN THE TITLE COMMITMENT PREPARED FOR THIS PROPERTY BY FIRST AMERICAN TITLE INSURANCE COMPANY, COMMITMENT FILE NO: 2216027-AL01, EFFECTIVE DATE: MAY 19, 2017.

LOT NUMBER SIX (6) OF THE PLAT OF LOTS 1 THRU 9, COORS PAVILION (BEING A REPLAT OF TRACT X-1A2, UNIVERSITY OF ALBUQUERQUE URBAN CENTER), WITHIN THE TOWNSHIP OF ALBUQUERQUE, GRANT IN PROJECTED SECTION 2, TOWNSHIP 10 NORTH, RANGE 10 WEST, PROJECTED PARCEL 100, CITY OF ALBUQUERQUE, BERNALILLO COUNTY, NEW MEXICO FILED ON APRIL 11, 2017, AS DOCUMENT NO. 2017033051, RECORDS OF BERNALILLO COUNTY, NEW MEXICO.

FLOODZONE DETERMINATION:

THE SURVEY AREA (AS SHOWN HEREON) APPEARS TO LIE WITHIN "ZONE X" (AREAS DETERMINED TO BE OUTSIDE THE 0.2% ANNUAL CHANCE FLOODPLAIN) AS SHOWN ON NATIONAL FLOOD INSURANCE PROGRAM FLOOD INSURANCE RATE MAP NUMBER 35001C0114H, MAP REVISED AUGUST 16, 2012.

SHEET INDEX

- | | |
|--------|------------------------|
| G-01 | COVER SHEET |
| SP-01 | SITE PLAN |
| L-1.0 | LANDSCAPE PLAN |
| L-2.0 | LANDSCAPE DETAILS |
| C-3.30 | GRADING PLAN |
| PS-1.0 | UTILITY PLAN |
| E-110 | PHOTOMETRICS SITE PLAN |
| FIRE 1 | FIRE 1 |
| 6 | DELIVERY TRUCK ROUTE |

- | | |
|------|---------------------|
| A-02 | EXTERIOR ELEVATIONS |
| A-03 | COLOR RENDERINGS |

DEVELOPER

CHICK-FIL-A, INC.
5200 BUFFINGTON ROAD
ATLANTA, GA 30349-2732
Phone: (404) 305-4407
Contact Name: Don Ikeler
Contact Email: don.ikeler@chick-fil-a.com

ARCHITECT


CORESTATES INC.
201 SOUTH MAPLE AVE SUITE 300
AMBLER, PA 19002
Phone: (215) 630-5137
Contact Name: Ken Mackenzie
Contact Email: kmackenzie@core-eng.com


CIVIL ENGINEER

MERRICK & COMPANY
5970 GREENWOOD PLAZA BLVD.
GREENWOOD VILLAGE, CO 80014
Phone: (303) 751-0741
Contact Name: Troy Kelts
Contact Email: troy.kelts@merrick.com

APPLICANT NAME

4G DEVELOPMENT AND CONSULTING, INC.
P.O. BOX 270571
SAN DIEGO, CA 92198
Phone: (858) 231-0071
Contact Name: Robert Lombardi
Contact Email: rlombardi@4gdev.com

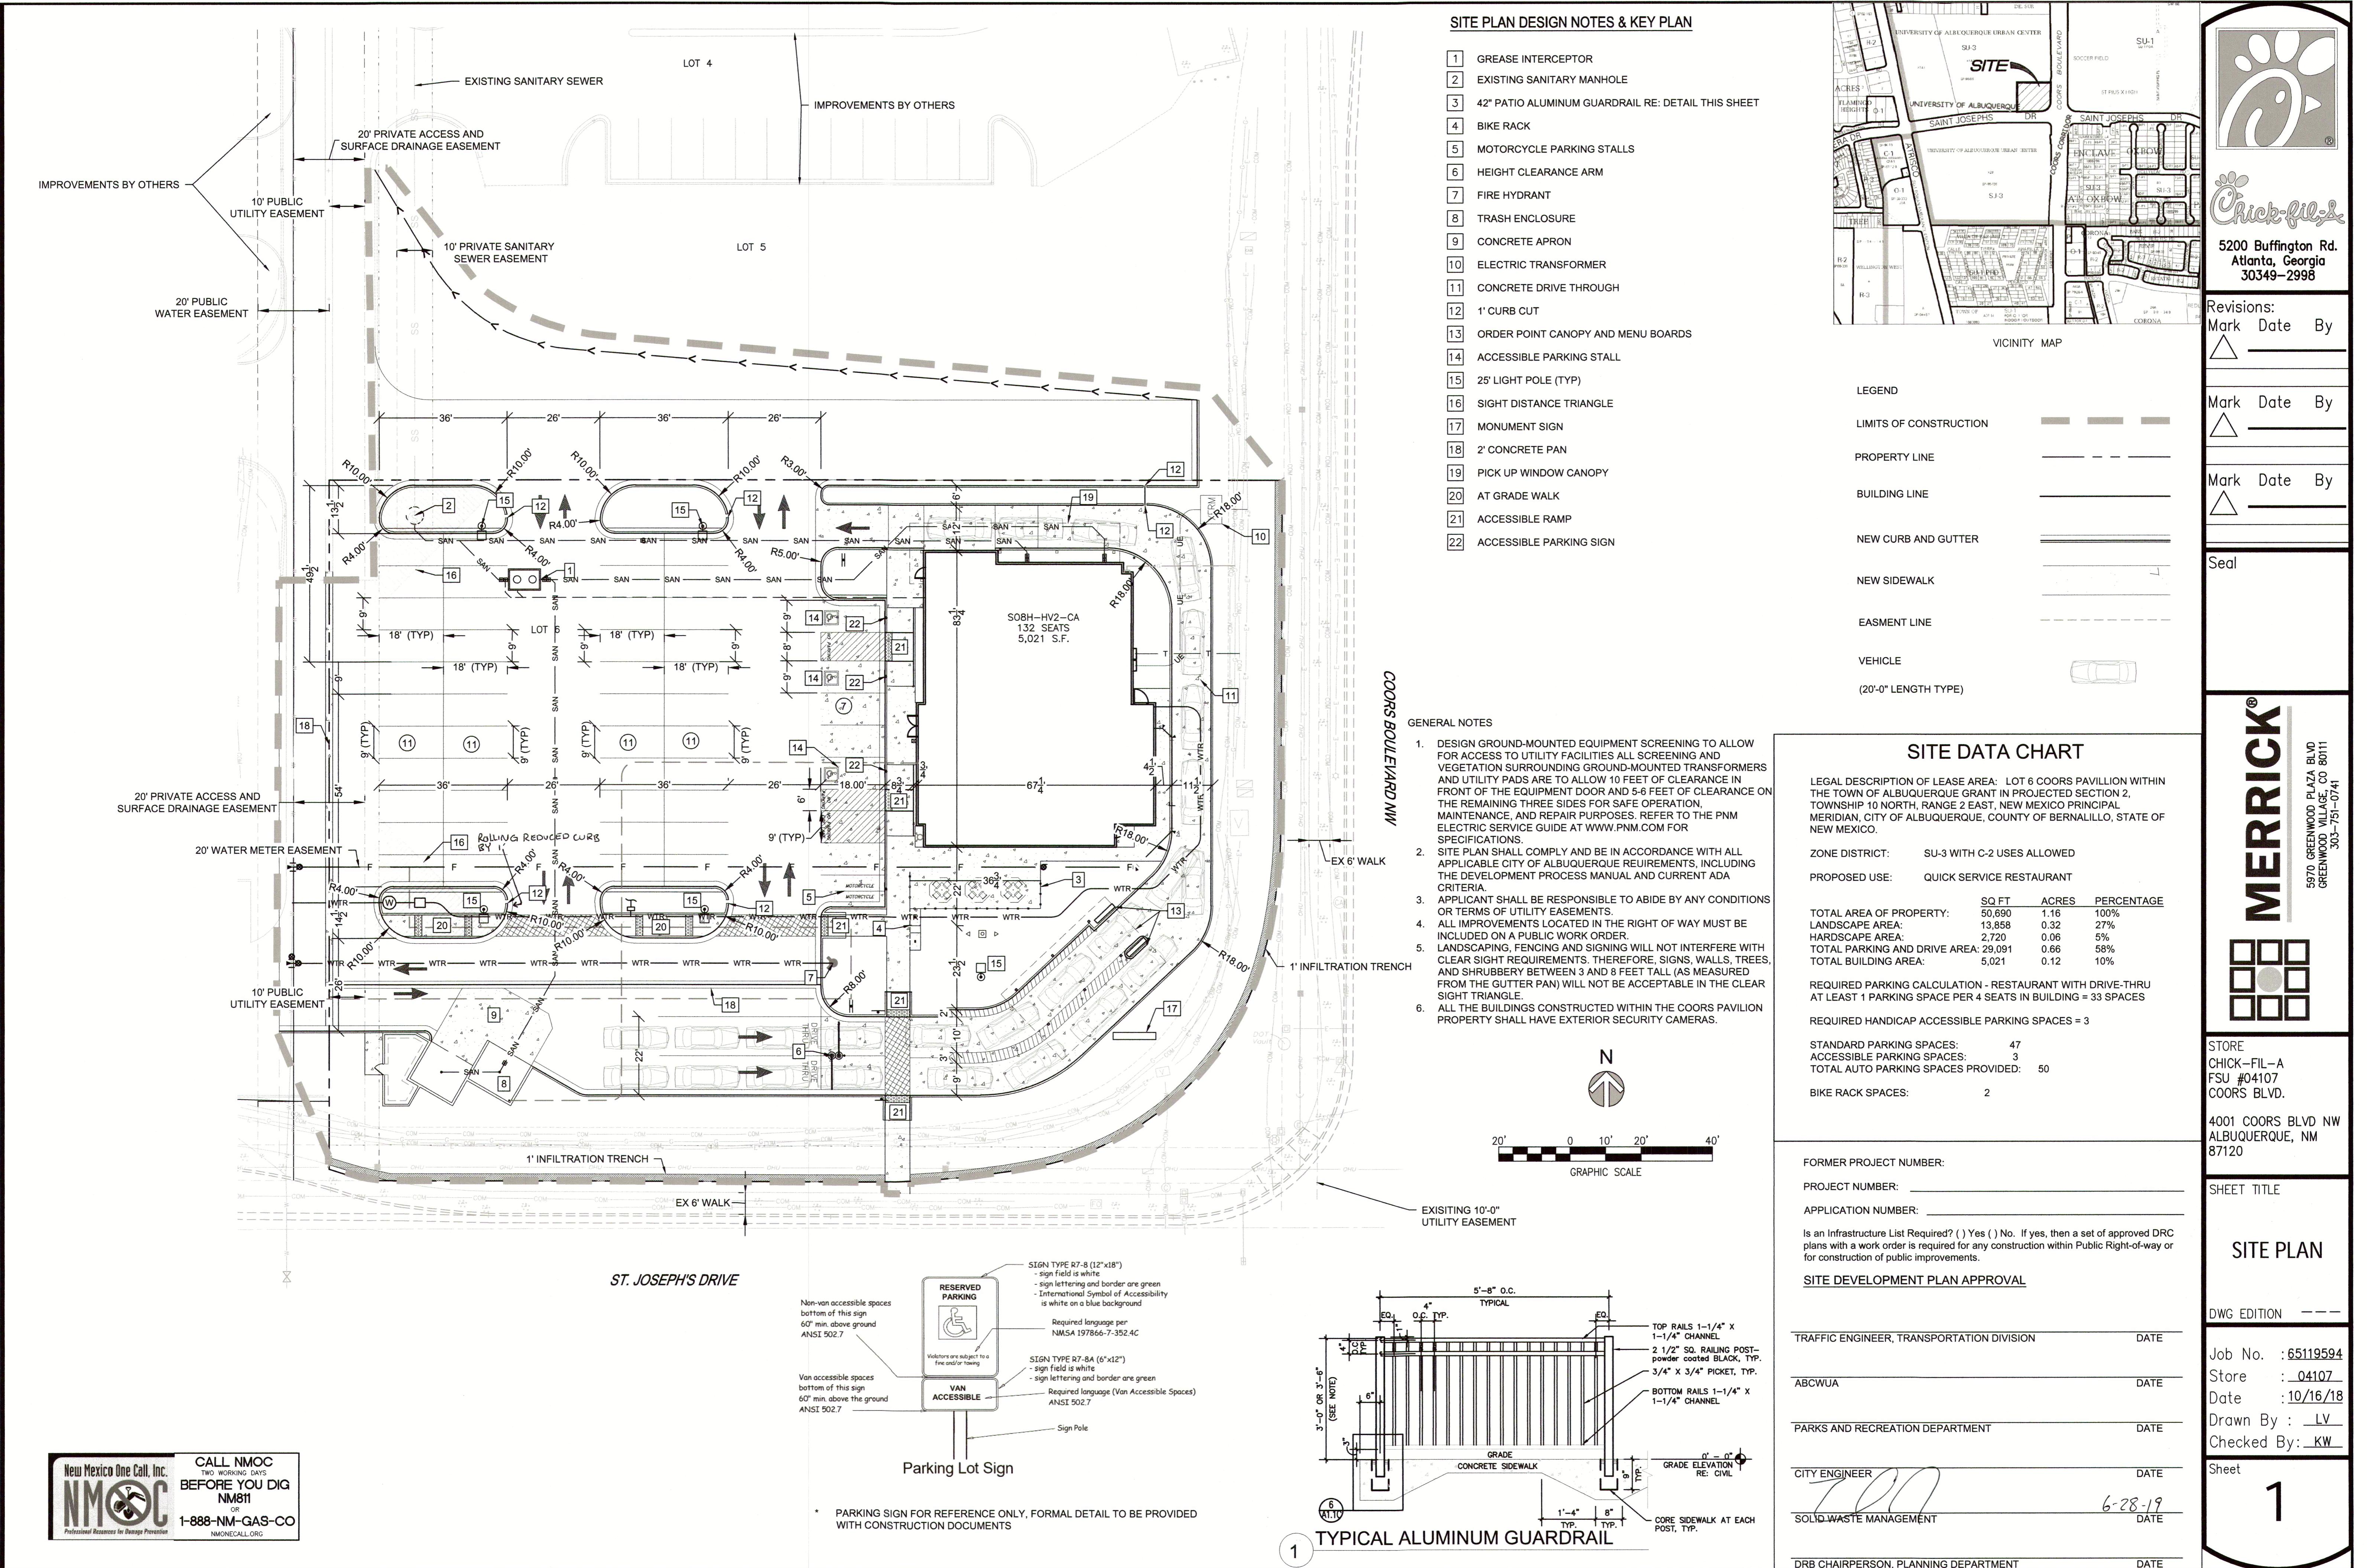

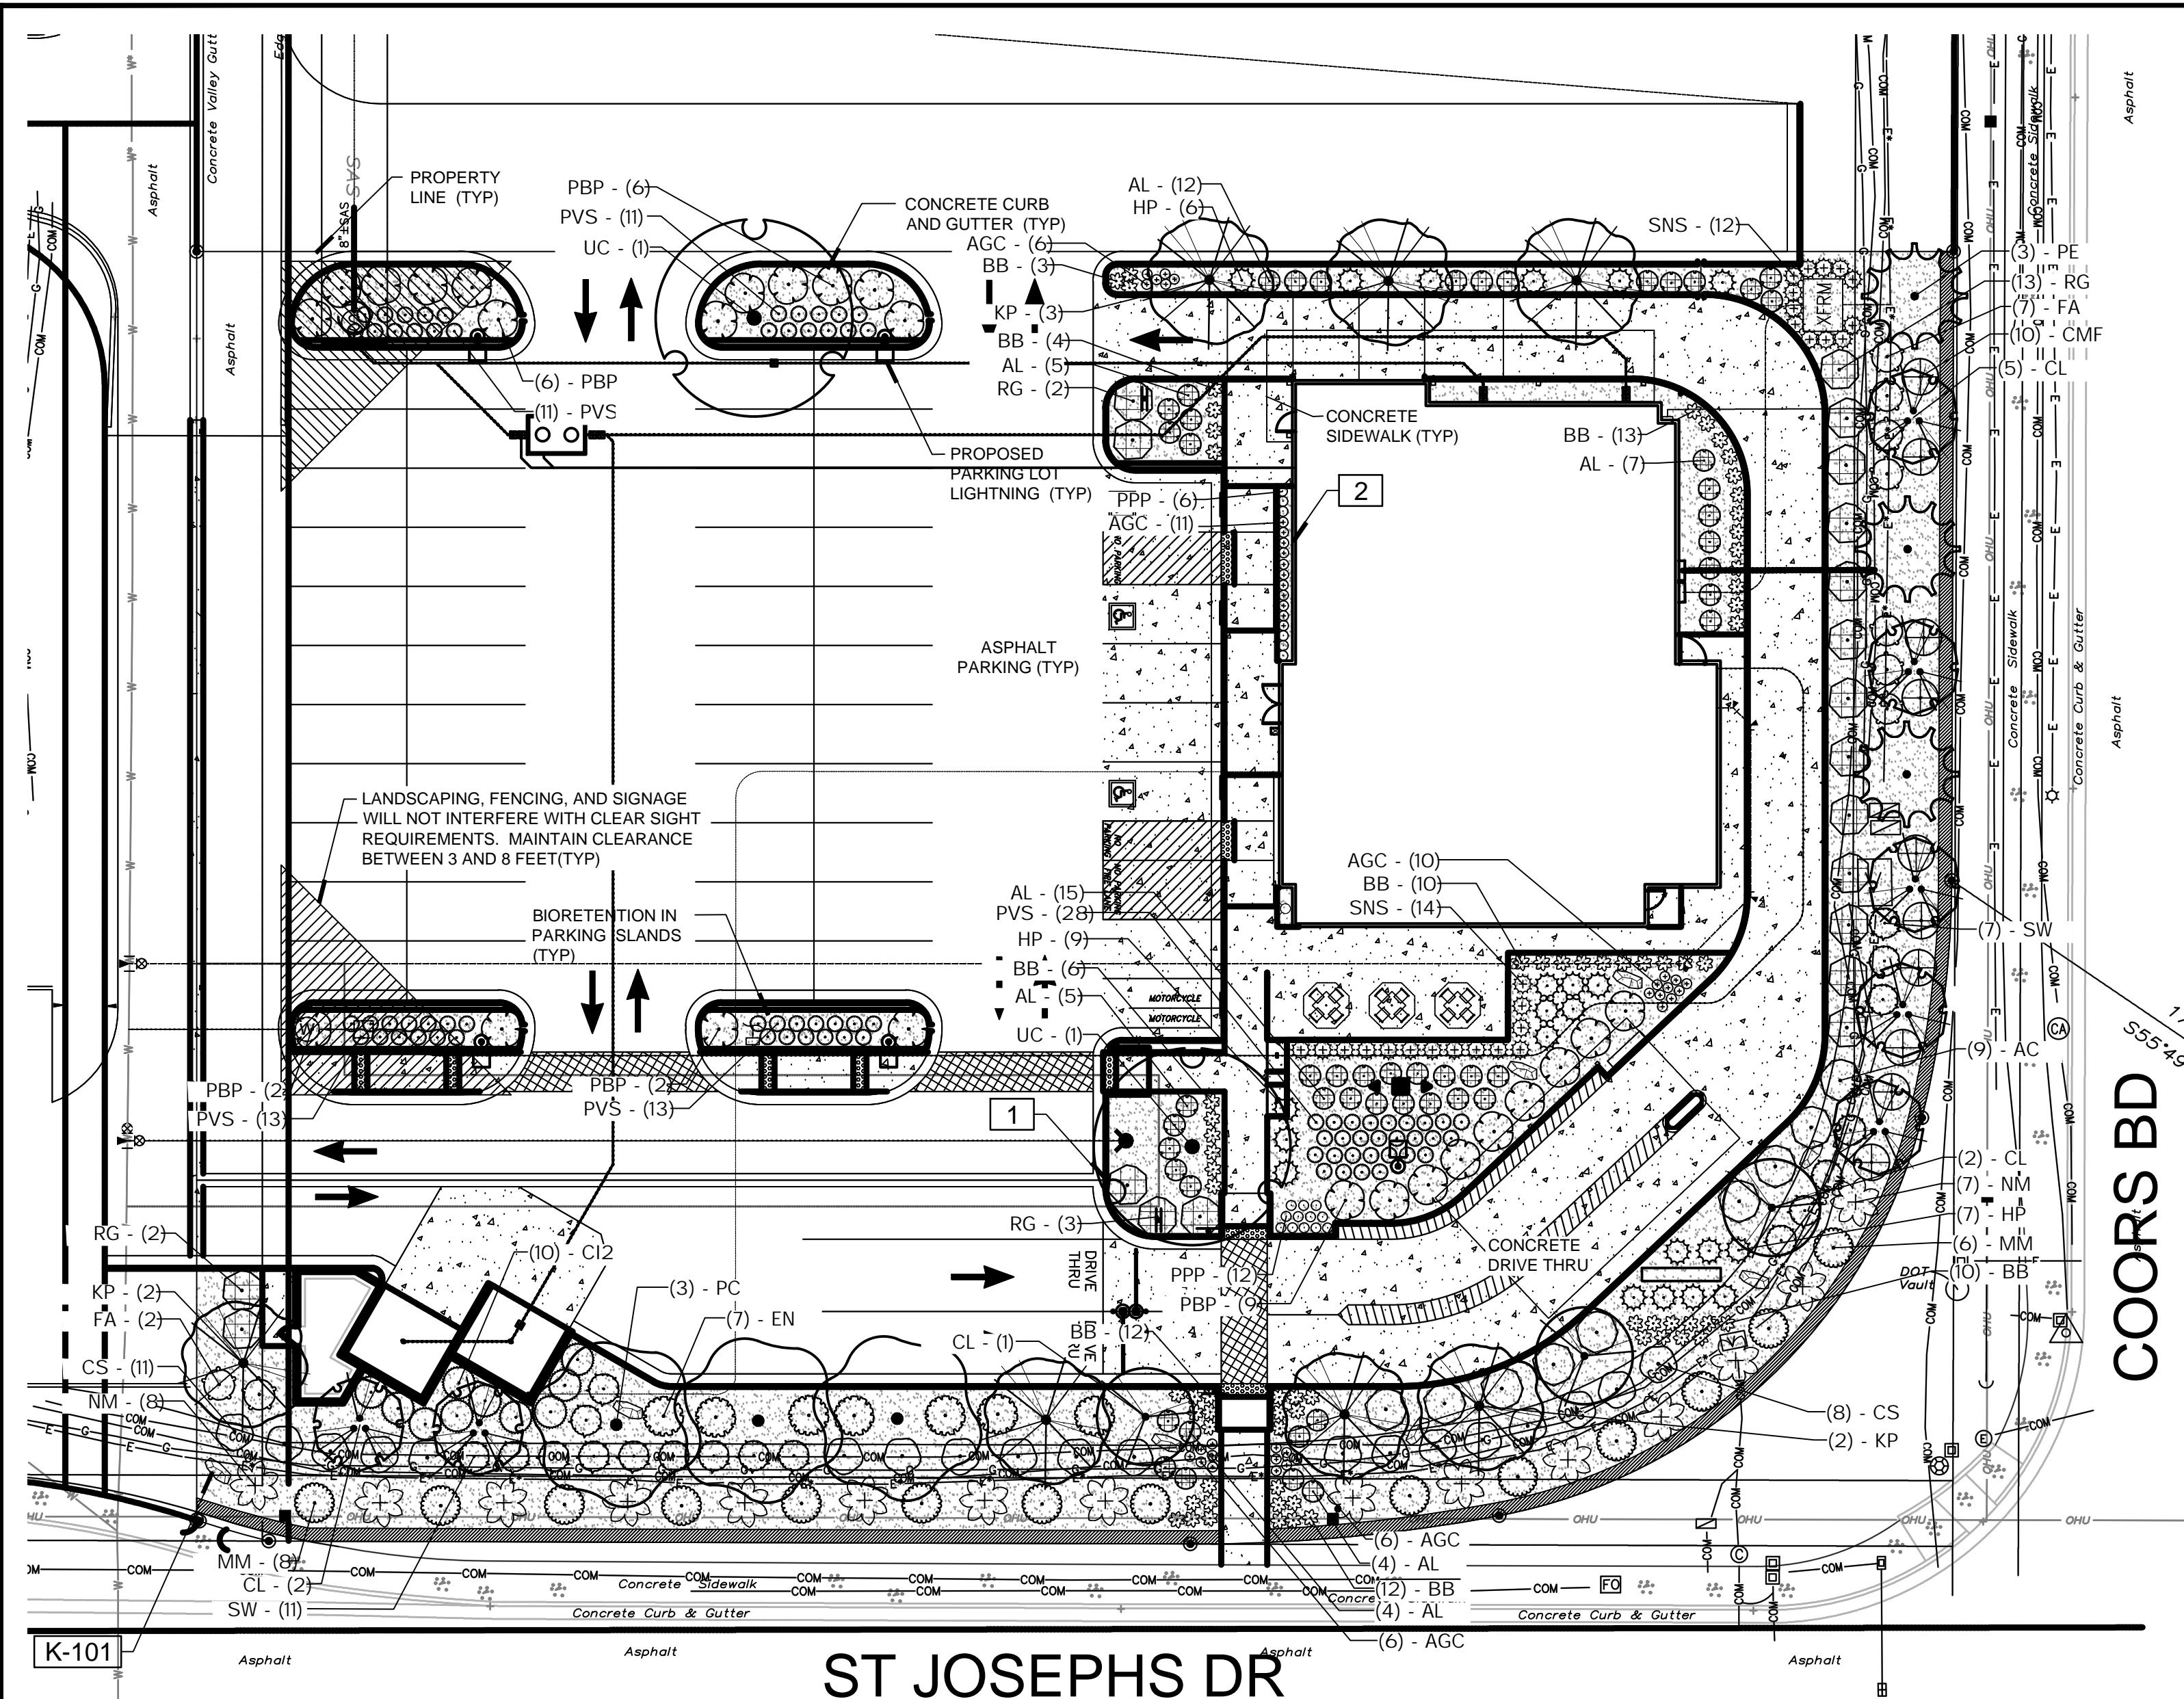

LANDSCAPE PLAN

SCALE: 1" = 20'

PLANT SCHEDULE ON-SITE


TREES	CODE	QTY	BOTANICAL NAME / COMMON NAME	CONT	CAL
CL	CL	10	CHILOPSIS LINEARIS / DESERT WILLOW	B&B	2.0" CAL MULTISTEM
KP	KP	7	KOELREUTERIA PANICULATA / GOLDEN RAIN TREE	B&B	2" CAL
PE	PE	3	PINUS EDULIS / PINION PINE	10-12' HT	
PC	PC	3	PISTACHIA CHINENSIS / CHINESE PISTACHE	B & B	2" CAL
UC	UC	2	ULMUS 'ACCOLADE' / ACCOLADE ELM	B & B	2" CAL
SHRUBS	CODE	QTY	BOTANICAL NAME / COMMON NAME	SIZE	FIELD2
AL	AL	52	AMORPHA CANESCENS / LEADPLANT	2 GAL	
AC	AC	9	ARCTOSTAPHYLOS X COLORADOENSIS 'CHIEFTAIN' / MANZANITA	5 GAL	
CI2	CI2	10	CERCOCARPUS INTRICATUS / LITTLE LEAF MOUNTAIN MAHOGANY	5 GAL	
CMF	CMF	10	CHAMAEBATIARIA MILLEFOLIUM 'FERNBUSH' / FERNBUSH	5 GAL	
CS	CS	19	CYTISUS SCOPARIUS 'MOONLIGHT' / MOONLIGHT SCOTCH BROOM	5 GAL	
EN	EN	7	ERICAMERIA NAUSEOSA / RUBBER RABBITBRUSH	5 GAL	
FA	FA	9	FALLUGIA PARADOXA / APACHE PLUME 12356D	5 GAL	
HP	HP	22	HESPERALOE PARVIFOLIA / RED YUCCA	5 GAL	
PBP	PBP	25	PRUNUS BESSEYI 'PAWNEE BUTTES' / SAND CHERRY	5 GAL	
RG	RG	20	RHUS TRILOBATA 'AUTUMN AMBER' / AUTMN AMBER SUMAC	5 GAL	
GRASSES	CODE	QTY	BOTANICAL NAME / COMMON NAME	SIZE	FIELD2
BB	BB	70	BOUTELOUA GRACILIS 'BLONDE AMBITION' / BLUE GRAMA	1 GAL	
NM	NM	15	NOLINA MICROCARPA / SACAHUITA	1 GAL	
PVS	PVS	76	PANICUM VIRGATUM 'SHENENDOAH' / BURGUNDY SWITCH GRASS	1 GAL	
SNS	SNS	26	SORGHASTRUM NUTANS 'SIOUX BLUE' / INDIAN GRASS	1 GAL	
SW	SW	18	SPOROBOLUS WRIGHTII / BIG SACATON	1 GAL	
PERENNIALS	CODE	QTY	BOTANICAL NAME / COMMON NAME	SIZE	FIELD2
AGC	AGC	39	AGASTACHE CANA 'SONORAN SUNSET' / SONORAN SUNSET HYSSOP	1 GAL	
MM	MM	14	MIRABILIS MULTIFLORA / COLORADO FOUR O'CLOCK	1 GAL	
PPP	PPP	18	PENSTEMON PINIFOLIUS / THREADLEAF BEARDTONGUE	4" POT	
MULCHES	CODE	QTY	BOTANICAL NAME / COMMON NAME	CONT	FIELD2
RM	RM	12, 454 SF	ROCK MULCH / RIVER ROCK MIXTURE PER OWNER APPROVAL. PLACE TO A UNIFORM DEPTH OF 3" OVER PERMEABLE WEED BARRIER FABRIC.	MULCH	

REFERENCE NOTES SCHEDULE

SYMBOL	DESCRIPTION	QTY	DETAIL
[1]	PLACE SHREDDED CEDAR MULCH AROUND BASE OF ALL PERENNIALS AND GRASSES IN LARGE COBBLE AREAS. MASSED PERENNIALS TO RECEIVE LARGE RING AROUND ENTIRE GROUP (TYP).		
[2]	MINIMUM 3' ROOTBALL OFFSET FROM BUILDING, TYP.		

SYMBOL	DESCRIPTION	QTY	DETAIL
K-101	GRANITE/MOSS ROCK BOULDER-DECORATIVE. 1/2 TON AVG SIZE	12	

1. STREET TREE PROVIDED PER SECTION 6-1-1-1.
 2. NO SOD IS PROPOSED.
 3. PROVIDE A 2' PARKING OVERHANG FOR ALL PLANTS WHERE APPLICABLE.
 4. LANDSCAPING AND SIGNING WILL NOT INTERFERE WITH CLEAR SIGHT REQUIREMENTS. THEREFORE, SIGNS, WALLS, TREES, AND SHRUBBERY BETWEEN 3 AND 8 FEET TALL (AS MEASURED FROM THE GUTTER PAN) WILL NOT BE ACCEPTABLE IN THESE AREAS.
 5. ALL IRRIGATION TO COMPLY WITH WATER CONSERVATION LANDSCAPING AND WATER WASTE ORDINANCE FOR ALBUQUERQUE.
 6. PROPOSED LANDSCAPING COMPLIES WITH CITY OF ALBUQUERQUE WATER CONSERVATION ORDINANCE (RE: SEC. 6-1-1)
 7. LANDSCAPE BEDS TO BE DEPRESSED AT LEAST 6" BELOW GRADE TO ALLOW FOR RAINWATER HARVESTING.
 8. THIS PLAN COMPLIES WITH CITY CODE 14-16-3-10, GENERAL LANDSCAPING REGULATIONS, WITH THE INCLUSION OF REQUIREMENTS TABLE AND REQUIRED LANDSCAPE MATERIAL SIZE AND LOCATIONS AS SPECIFIED IN AFOREMENTIONED CODE.
- (1) Landscaping shall be installed according to the approved plan; installation shall be completed within 60 days of the related building's occupancy.
(2) Any damage to utility lines resulting from the negligence of the abutting landowner, his agents, or employees in the installation or maintenance of the landscaping in the public right-of-way shall be the responsibility of such owner. Any damage to utility lines resulting from the growth of plant materials, which have been approved by the applicable public utility as part of a plan for landscaping on the public right-of-way, shall be the responsibility of such public utility. If a public utility disturbs a landscaped area in the public right-of-way, it shall make every reasonable effort to preserve the landscaping materials and return them to their prior locations after the utility work. If, nonetheless some plant materials die, it is the obligation of the abutting landowner to replace the plant materials.
(3) Landscaping shall have adequate maintenance. Landscaping which dies shall be replaced by the owner as expeditiously as possible, but in no case longer than 60 days after notification.

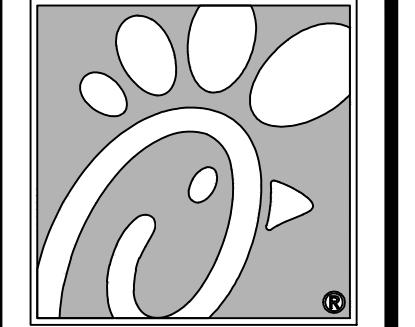

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Revisions:
Mark Date By

11.12.18 J0
CD ISSUE

Mark Date By

Mark Date By

Seal



5970 GREENWOOD PLAZA BLVD
GREENWOOD VILLAGE, CO 80111
303-751-0741

STORE
CHICK-FIL-A
FSU #04107
COORS BLVD.

COORS BLVD. NW
& ST. JOSEPHS DR. NW
ALBUQUERQUE, NM
87120

SHEET TITLE

LANDSCAPE
PLAN

DWG EDITION

Job No. : 65119594

Store : 04107

Date : 07/18/17

Drawn By : JRO

Checked By: NAM

Sheet

L1.0

GENERAL NOTES

(Note: All references to "Contractor" are specific to "Landscape Contractor" unless notified as "General or other type of Contractor")

- CONTRACTOR IS RESPONSIBLE FOR VERIFYING QUANTITIES OF MATERIALS NEEDED TO COMPLETE THIS PLAN IN THE FIELD. NOTIFY LANDSCAPE ARCHITECT OF ANY DISCREPANCIES BETWEEN THE DRAWINGS AND CONDITIONS IN THE FIELD. GRAPHIC QTY'S. PREVAIL OVER WRITTEN QTY'S. PRIOR TO COMMENCEMENT OF WORK THE LANDSCAPE CONTRACTOR SHALL CONTACT OWNERS REPRESENTATIVE FOR SPECIFIC INSTRUCTIONS RELEVANT TO THE SEQUENCING AND SCOPE OF WORK.
- CONTRACTOR IS RESPONSIBLE FOR INSTALLING ALL LANDSCAPE SHOWN ON THIS PLAN. ANY DEFICIENCIES OR DEVIATIONS FROM THIS PLAN ARE TO BE APPROVED BY OWNER'S REPRESENTATIVE OR LANDSCAPE ARCHITECT. ANY CHANGES FROM THE APPROVED PLANS MAY REQUIRE APPROVAL FROM THE CITY OR COUNTY PLANNING DEPARTMENTS.
- LANDSCAPE CONTRACTOR TO PROVIDE ALL LABOR AND MATERIALS NECESSARY TO FURNISH SCOPE OF WORK AS SHOWN PER PLAN.
- EXISTING TOPSOIL IS TO BE STOCKPILED AND USED TO ESTABLISH FINAL GRADES WITHIN LANDSCAPE AREAS. ALL STOCKPILED SOIL MUST BE CLEAR OF ROCKS, ROCKS AND DEBRIS BEFORE REUSE. ALL BERMED PLANTING BEDS TO BE CREATED WITH IMPORTED TOPSOIL.
- GENERAL CONTRACTOR TO RE-SPREAD STOCKPILED SOIL AND ESTABLISH ROUGH GRADE CONDITIONS TO THE FOLLOWING SPECIFICATIONS:
A. 1" BELOW CURB FOR ALL SODDED AREAS.
B. 2.5" BELOW CURB FOR ALL SODDED AREAS.
C. 4" BELOW CURB FOR ALL PLANTING, ROCK AND MULCH BEDS. CONTRACTOR TO TILL PARKING LOT ISLANDS TO A DEPTH OF 30".
- AMEND ALL PLANTING BEDS WITH CLASS 1 COMPOST. APPLY AT RATE OF 3 CYDS. PER 1000 SQUARE FEET TO ALL PLANTING BEDS AND MANICURED LAWN AREAS, AND 2 CYDS. PER 1000 SQUARE FEET FOR SEeded AREAS. TILL, MIXING THOROUGHLY, INTO THE UPPER 8" OF SOIL.
- FINE GRADE TO BE ESTABLISHED BY LANDSCAPE CONTRACTOR. FINE GRADE SHALL BE FREE OF ROCKS AND DEBRIS. FINE GRADE IN SEED AREAS SHALL BE FREE FROM ROCKS AND DEBRIS 1/2" AND GREATER. FINE GRADE IN SODDED AREAS SHALL BE FREE FROM ROCKS AND DEBRIS 1/4" AND GREATER. CONTRACTOR TO REPORT ANY POOR DRAINAGE CONDITIONS PRIOR TO CONSTRUCTION.
- CONTRACTOR IS TO PROVIDE VERIFICATION THAT ALL SOD IS OF THE SPECIES SHOWN ON THIS PLAN. NO SUBSTITUTIONS WILL BE ALLOWED. SOD TO BE LAID WITH TIGHT STAGGERED EDGES AND BE ROLLED AFTER INSTALLATION. SEeded AREAS CANNOT BE SUBSTITUTED WITH SOD.


- MULCHES: ALL PLANTING BEDS THAT CALL FOR WOOD/ORGANIC MULCH TO RECEIVE 4" ORGANIC SHREDDED BARK MULCH. SHREDDED MULCH IS TO BE OF FIBROUS MATERIAL, NOT CHIPS OR CHUNKS. NO FABRIC IS TO BE PLACED UNDER WOOD/ORGANIC MULCH. TREES IN TURF AND NATIVE GRASS AREAS TO RECEIVE 4" DIAMETER OF WOOD MULCH, 3" DEPTH. ALL MULCHED BEDS ARE TO BE SPRAYED WITH WATER AFTER INSTALLATION TO HELP MULCH TO MAT DOWN.

USE PERMEABLE FABRIC UNDERLAYMENT FOR ALL COBBLE/AGGREGATE AREAS WITH SLOPES 3:1 AND LESS. USE QUICK RELEASE ORGANIC PRE-EMERGENT HERBICIDE FOR ALL MULCHED AND PERENNIAL/PLANTING BEDS (AND FOR COBBLE/AGGREGATE AREAS WITH SLOPES EXCEEDING 3:1 GRADE).

SHRUBS AND GROUNDCOVERS IN NATIVE GRASS AREAS TO RECEIVE 3" DIAMETER OF WOOD MULCH, 3" DEEP.
TREES IN COBBLE/ROCK MULCH TO RECEIVE 4" DIAMETER OF WOOD MULCH, 3" DEEP. SHRUBS AND GROUNDCOVERS IN COBBLE/ROCK MULCH AREAS TO RECEIVE 3" DIAMETER OF WOOD MULCH, 3" DEEP. NO FABRIC UNDERLAYMENT IN WOOD MULCH AREAS.


- SEED MIX INSTALLATION: CONTRACTOR TO DRILL SEED WITH BRILLION TYPE APPLICATOR AND APPLY 'SOIL GUARD' BONDED FIBER MATRIX (BFM), WHERE INDICATED PER PLAN AND SCHEDULES. APPLY SEED IN TWO DIRECTIONS (PERPENDICULAR OF THE OTHER). ADD SOIL GUARD BFM FOR DRILL SEEDING WHERE NOTED PER PLAN AND ON ALL SLOPES 5:1 TO 3:1 FOR AREAS WITH 3:1 SLOPES OR GREATER CONTRACTOR TO USE SOIL GUARD APPLICATION ONLY (IN LIEU OF HYDROMULCH) CONTRACTOR TO SPOT SEED NON-GERMINATING AREAS (3) MONTHS AFTER INITIAL SEED APPLICATION. CONTRACTOR TO RE-SEED ALL BARE AREAS (6"x6") AND GREATER AFTER (6) MONTHS FROM SEED GERMINATION OR AT THE BEGINNING OF THE FOLLOWING GROWING SEASON. PRIOR TO THE 1-MONTH WARRANTY INSPECTION, RE-APPLY SOIL GUARD AND SEED MIX TO ALL BARE AREAS (6"x6" OR GREATER) AND TO ALL BARE AREAS (4"x4" OR GREATER) ON ALL SLOPES 3:1 AND GREATER.
- REMOVED DEAD TWIGS AND BRANCHES FROM ALL NEW AND EXISTING PLANT MATERIAL IN A MANNER THAT DOES NOT CHANGE THE NATURAL HABIT OF THE PLANT MATERIAL. SCARFS OF 1" OR MORE SHALL BE PAINTED WITH ORGANIC TREE PAINT. CENTRAL LEADERS SHALL NOT BE REMOVED AT ANY TIME. NEWLY PLANTED TREES WITHOUT CENTRAL LEADERS WILL BE REJECTED.
- CONTRACTOR TO APPLY FERTILIZER IN SPRING & LATE SEPTEMBER. WATER THOROUGHLY AFTER APPLICATION OF FERTILIZERS.
- ALL SEEDED AND SODDED AREAS TO HAVE RECOMMENDED FERTILIZER APPLICATIONS ADDED 2 TO 3 WEEKS AFTER SEEDING EMERGENCE. AND ONCE IN MID TO LATE JUNE, IN EARLY TO MID AUGUST, AND ONCE IN LATE SEPTEMBER. SEDED AND SODDED AREAS ARE ALSO TO RECEIVE .5 LB. OF ELEMENTAL SULFUR (OR EQUIVALENT MATERIAL) PER 1,000 S.F. APPLIED IN LATE SEPTEMBER. WATER THOROUGHLY AFTER APPLICATION OF FERTILIZERS.
- ALL PLANT MATERIALS AND UTILITIES ARE SHOWN AT AN APPROXIMATE LOCATIONS. THE CONTRACTOR MAY NEED TO ADJUST LOCATIONS OF PLANT MATERIAL TO ADHERE TO SPECIFIC ON-SITE CONDITIONS AND CODE REQUIREMENTS. ALL TREES AND SHRUBS TO BE PLACED AT 2' MINIMUM BACK OF CURB. CONTRACTOR TO CALL FOR UTILITY LOCATES BEFORE PLANTING (TPR) 1-800-922-1987, OR CALL 811 BEFORE YOU DIG!
- COORDINATION WITH PNM IS NECESSARY FOR THIS PROJECT REGARDING PROPOSED TREE SPECIES, THE HEIGHT AT MATURITY AND TREE PLACEMENT, SIGN LOCATION AND HEIGHT, AND LIGHTING HEIGHT IN ORDER TO ENSURE SUFFICIENT SAFETY CLEARANCES TO AVOID INTERFERENCE WITH THE EXISTING ELECTRIC OVERHEAD AND UNDERGROUND DISTRIBUTION LINES ALONG THE EAST SIDE OF EUBANK BOULEVARD NEAR THE PROJECT SITE BOUNDARY. PNM'S LANDSCAPING PREFERENCE IS FOR TREES AND SHRUBS TO BE PLANTED OUTSIDE THE PNM EASEMENT; HOWEVER, IF WITHIN THE EASEMENT, TREES AND SHRUBS SHOULD BE PLANTED TO MINIMIZE EFFECTS ON ELECTRIC FACILITY MAINTENANCE AND REPAIR. NEW TREES PLANTED NEAR PNM FACILITIES SHOULD BE NO TALLER THAN 25 FEET IN HEIGHT AT MATURITY TO AVOID CONFLICTS WITH EXISTING ELECTRIC INFRASTRUCTURE.
- STEEL EDGING TO BE USED TO SEPARATE ALL TURF AND/OR SEDED AREAS FROM PLANTING BEDS. USE PERFORATED EDGING SEGMENTS TO OBTAIN POSITIVE DRAINAGE FOR ALL DRAINAGE SWALES OR AREAS OF STANDING WATER.
- CONTRACTOR TO PROVIDE COBBLE & UNDERLAYMENT FOR BUILDING DRAINS AND SWALES THROUGH LANDSCAPED AREAS.

- NOTES:
1. PRUNE ONLY DEAD OR BROKEN BRANCHES AND WEAK OR NARROW CROTCHES.
2. KEEP PLANTS MOIST AND SHADED UNTIL PLANTING.
3. DO NOT FERTILIZE FOR AT LEAST ONE GROWING SEASON.
4. AMENDED BACKFILL SHALL BE 1/3 COMPOST (PREFERABLY CLASSIFIED) AND 2/3 NATIVE AND/OR IMPORTED TOPSOIL.
5. ALL SHRUBS IN ROCK AREAS TO RECEIVE SHREDDED MULCH RINGS.
6. DEEP WATER ALL PLANTS AT TIME OF PLANTING.


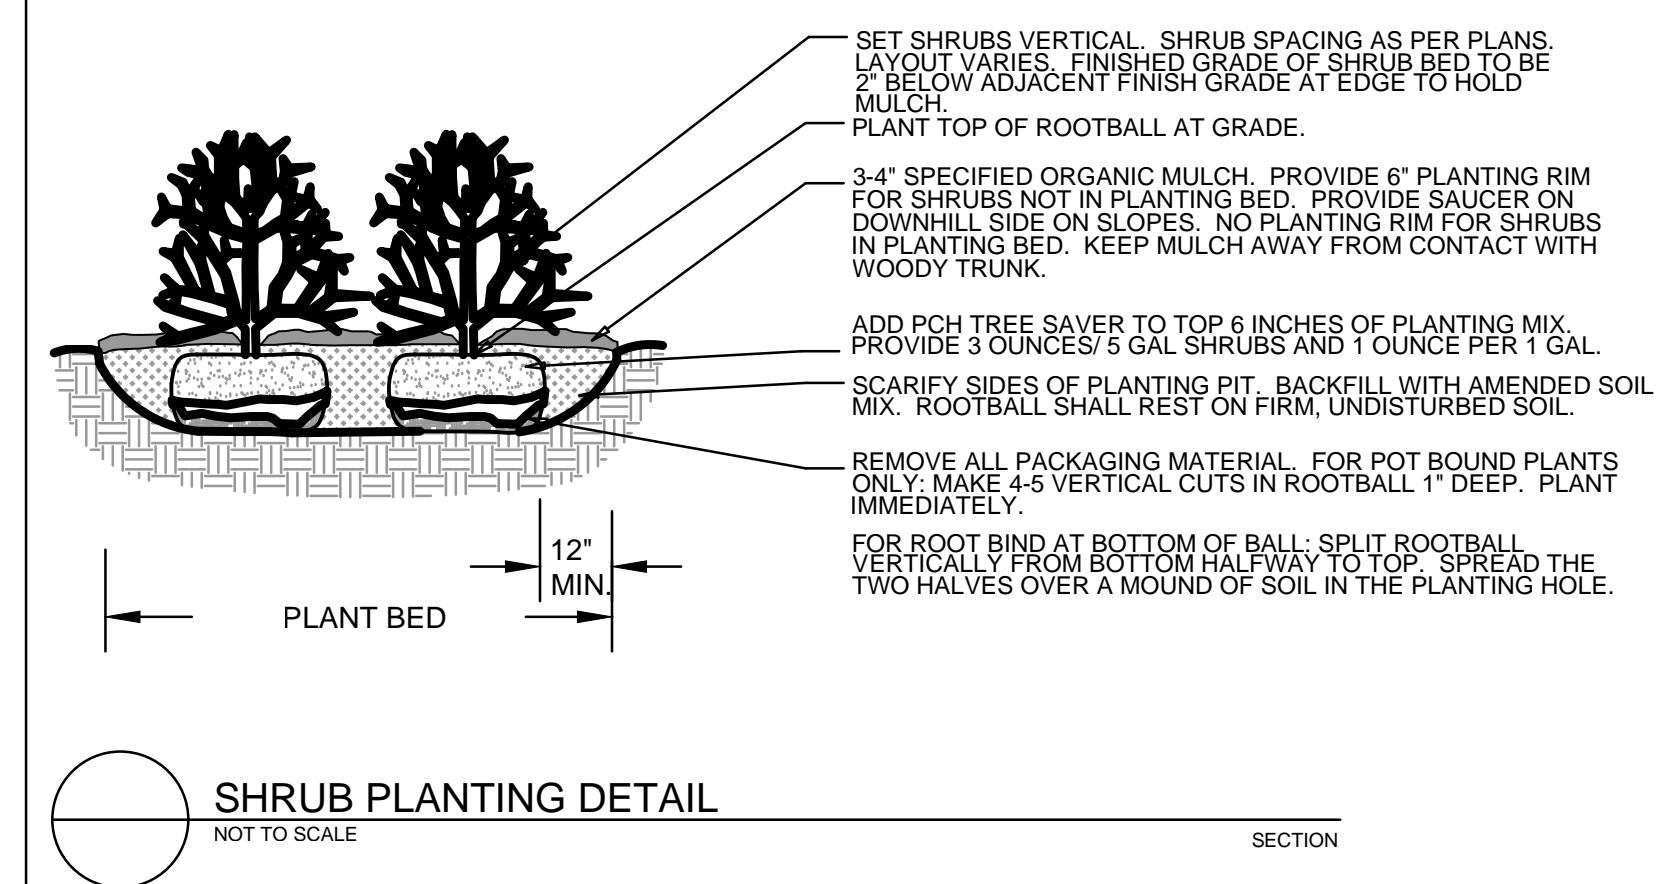


ALL PLANTS TO BE PLANTED TO ACCOMMODATE AND MAXIMIZE RAINWATER HARVESTING DEPRESSIONS IN LANDSCAPE BEDS.

- NOTES:
1. DO NOT REMOVE OR CUT LEADER.
2. PRUNE ONLY DEAD OR BROKEN BRANCHES IMMEDIATELY PRIOR TO PLANTING.
3. DO NOT REMOVE ANY DOUBLE LEADER, UNLESS OTHERWISE DIRECTED BY OWNERS REPRESENTATIVE.
4. KEEP PLANTS MOIST AND SHADED UNTIL PLANTING.
5. AMENDED BACKFILL SHALL BE 1/3 COMPOST (PREFERABLY CLASSIFIED) AND 2/3 NATIVE AND/OR IMPORTED TOPSOIL.
6. MARK THE NORTH SIDE OF TREE IN THE NURSERY, AND ROTATE TREE TO FACE NORTH AT THE SITE WHENEVER POSSIBLE.
7. PINE AND SPRUCE TREES TO BE SPRAYED FOR IPS BARK BEETLE PRIOR TO PLANTING. COORDINATE WITH CITY FORESTRY FOR CURRENT INSECT AND DISEASE RECOMMENDATIONS PRIOR TO PLANTING.
8. ALL TREES TO BE DEEP WATERED AT TIME OF PLANTING.

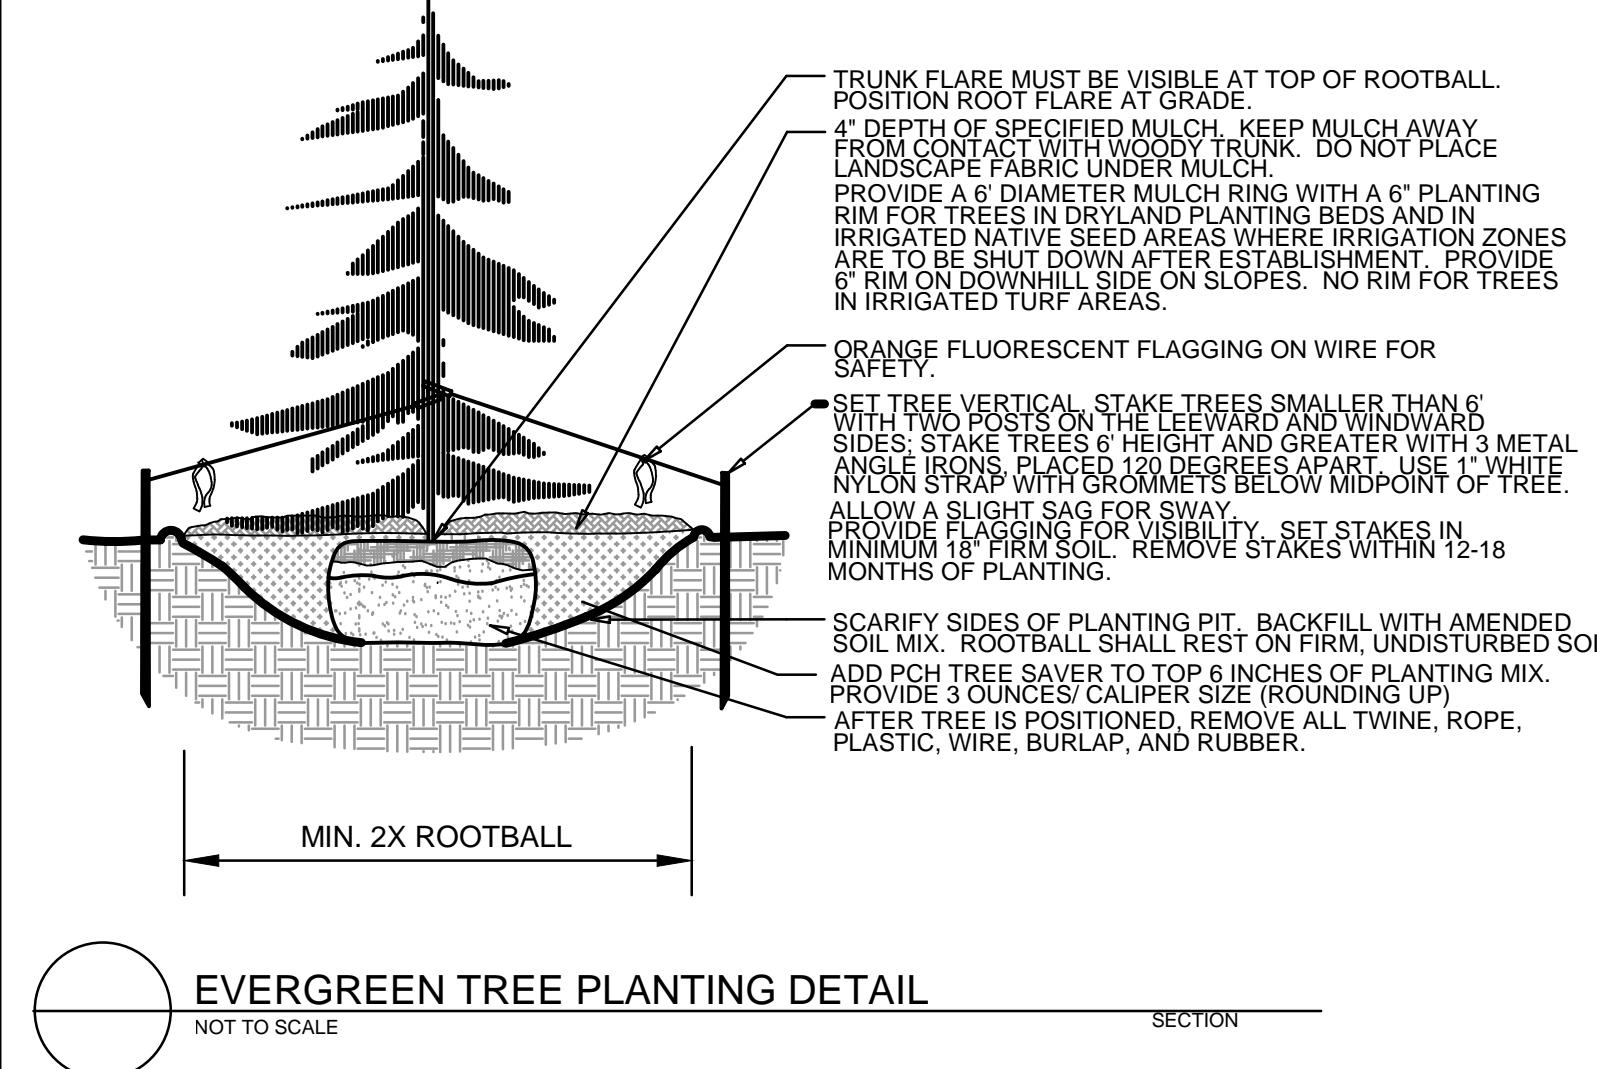

- NOTES:
1. MARK THE NORTH SIDE OF TREE IN THE NURSERY, AND ROTATE TREE TO FACE NORTH AT THE SITE WHENEVER POSSIBLE.
2. AT TIME OF PLANTING, DO NOT REMOVE OR CUT LEADER AND PRUNE ONLY DEAD OR BROKEN BRANCHES, CROSS OVER BRANCHES, AND BREAK OR MARRON CROTCHES. SOME INTERIOR TWIGS AND LATERAL BRANCHES MAY BE PRUNED. HOWEVER, DO NOT REMOVE THE TERMINAL BUDS OR BRANCHES THAT EXTEND TO THE EDGE OF THE CROWN.
3. STRUCTURAL PRUNING SHOULD NOT BEGIN UNTIL AFTER ESTABLISHMENT PERIOD, USUALLY TWO GROWING SEASONS.
4. KEEP PLANTS MOIST AND SHADED UNTIL PLANTING.
5. DO NOT FERTILIZE FOR AT LEAST ONE GROWING SEASON.
6. AMENDED BACKFILL SHALL BE 1/3 COMPOST (PREFERABLY CLASSIFIED) AND 2/3 NATIVE AND/OR IMPORTED TOPSOIL.
7. WRAP TRUNK ON EXPOSED SITES AND SPECIES WITH THIN BARK. USE ELECTRICAL OR DUCT TAPE, NOT TWINE.
8. COORDINATE WITH CITY FORESTRY FOR CURRENT INSECT AND DISEASE RECOMMENDATIONS PRIOR TO PLANTING.
9. DEEP WATER ALL PLANTS AT TIME OF PLANTING.

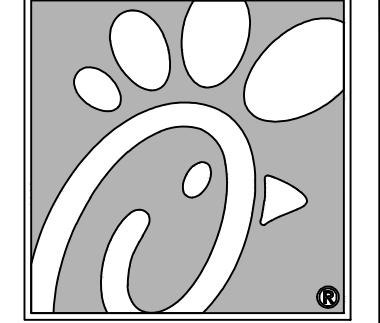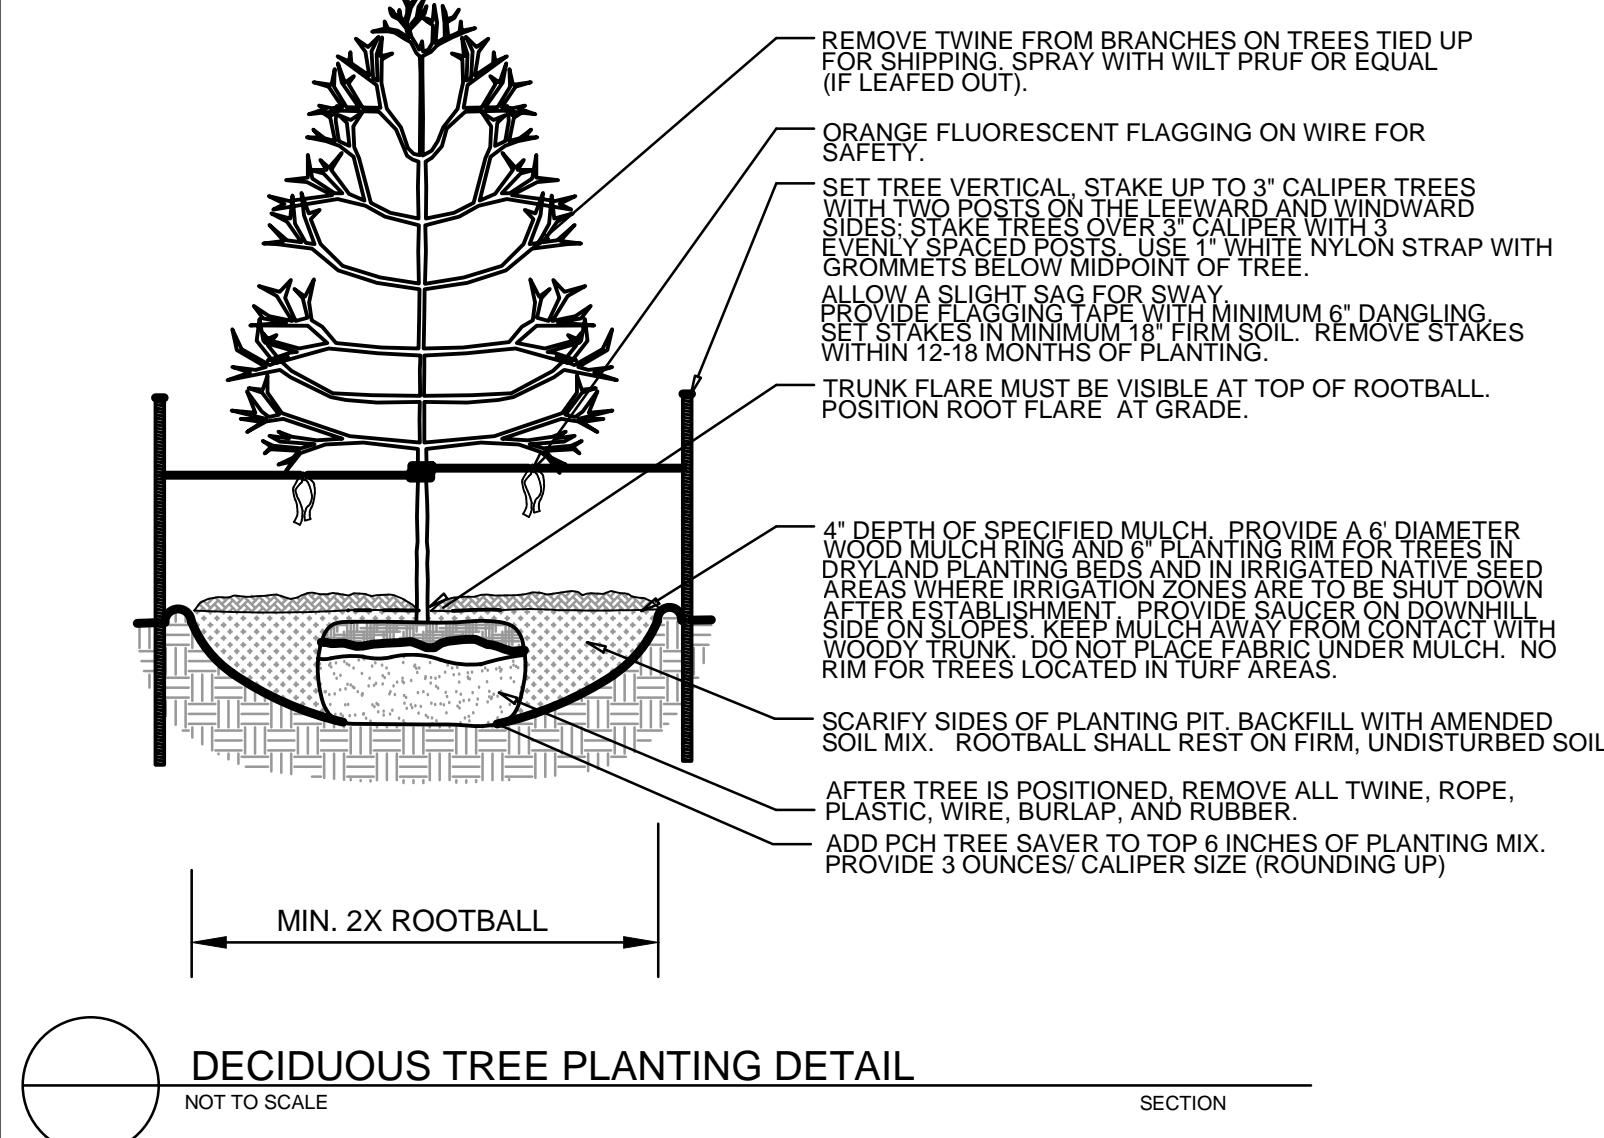

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Revisions:
Mark Date By
11.12.18 JO
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Seal

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& COMPANY
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STORE
CHICK-FIL-A
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COORS BLVD.
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& ST. JOSEPH'S DR NW
ALBUQUERQUE, NM
87120

SHEET TITLE
LANDSCAPE
PLAN
DETAILS


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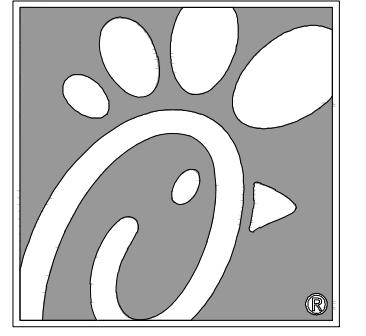
Job No. : 65119594
Store : 04107
Date : 07/18/17
Drawn By : JRO
Checked By : NAM

Sheet

L2.0

NDS
NATURAL DESIGN SOLUTIONS
Landscape Architecture
Land Planning · Irrigation Design
5539 Colt Drive, Longmont, CO 80503
(303) 443-0388 · neil@ndscolorado.com



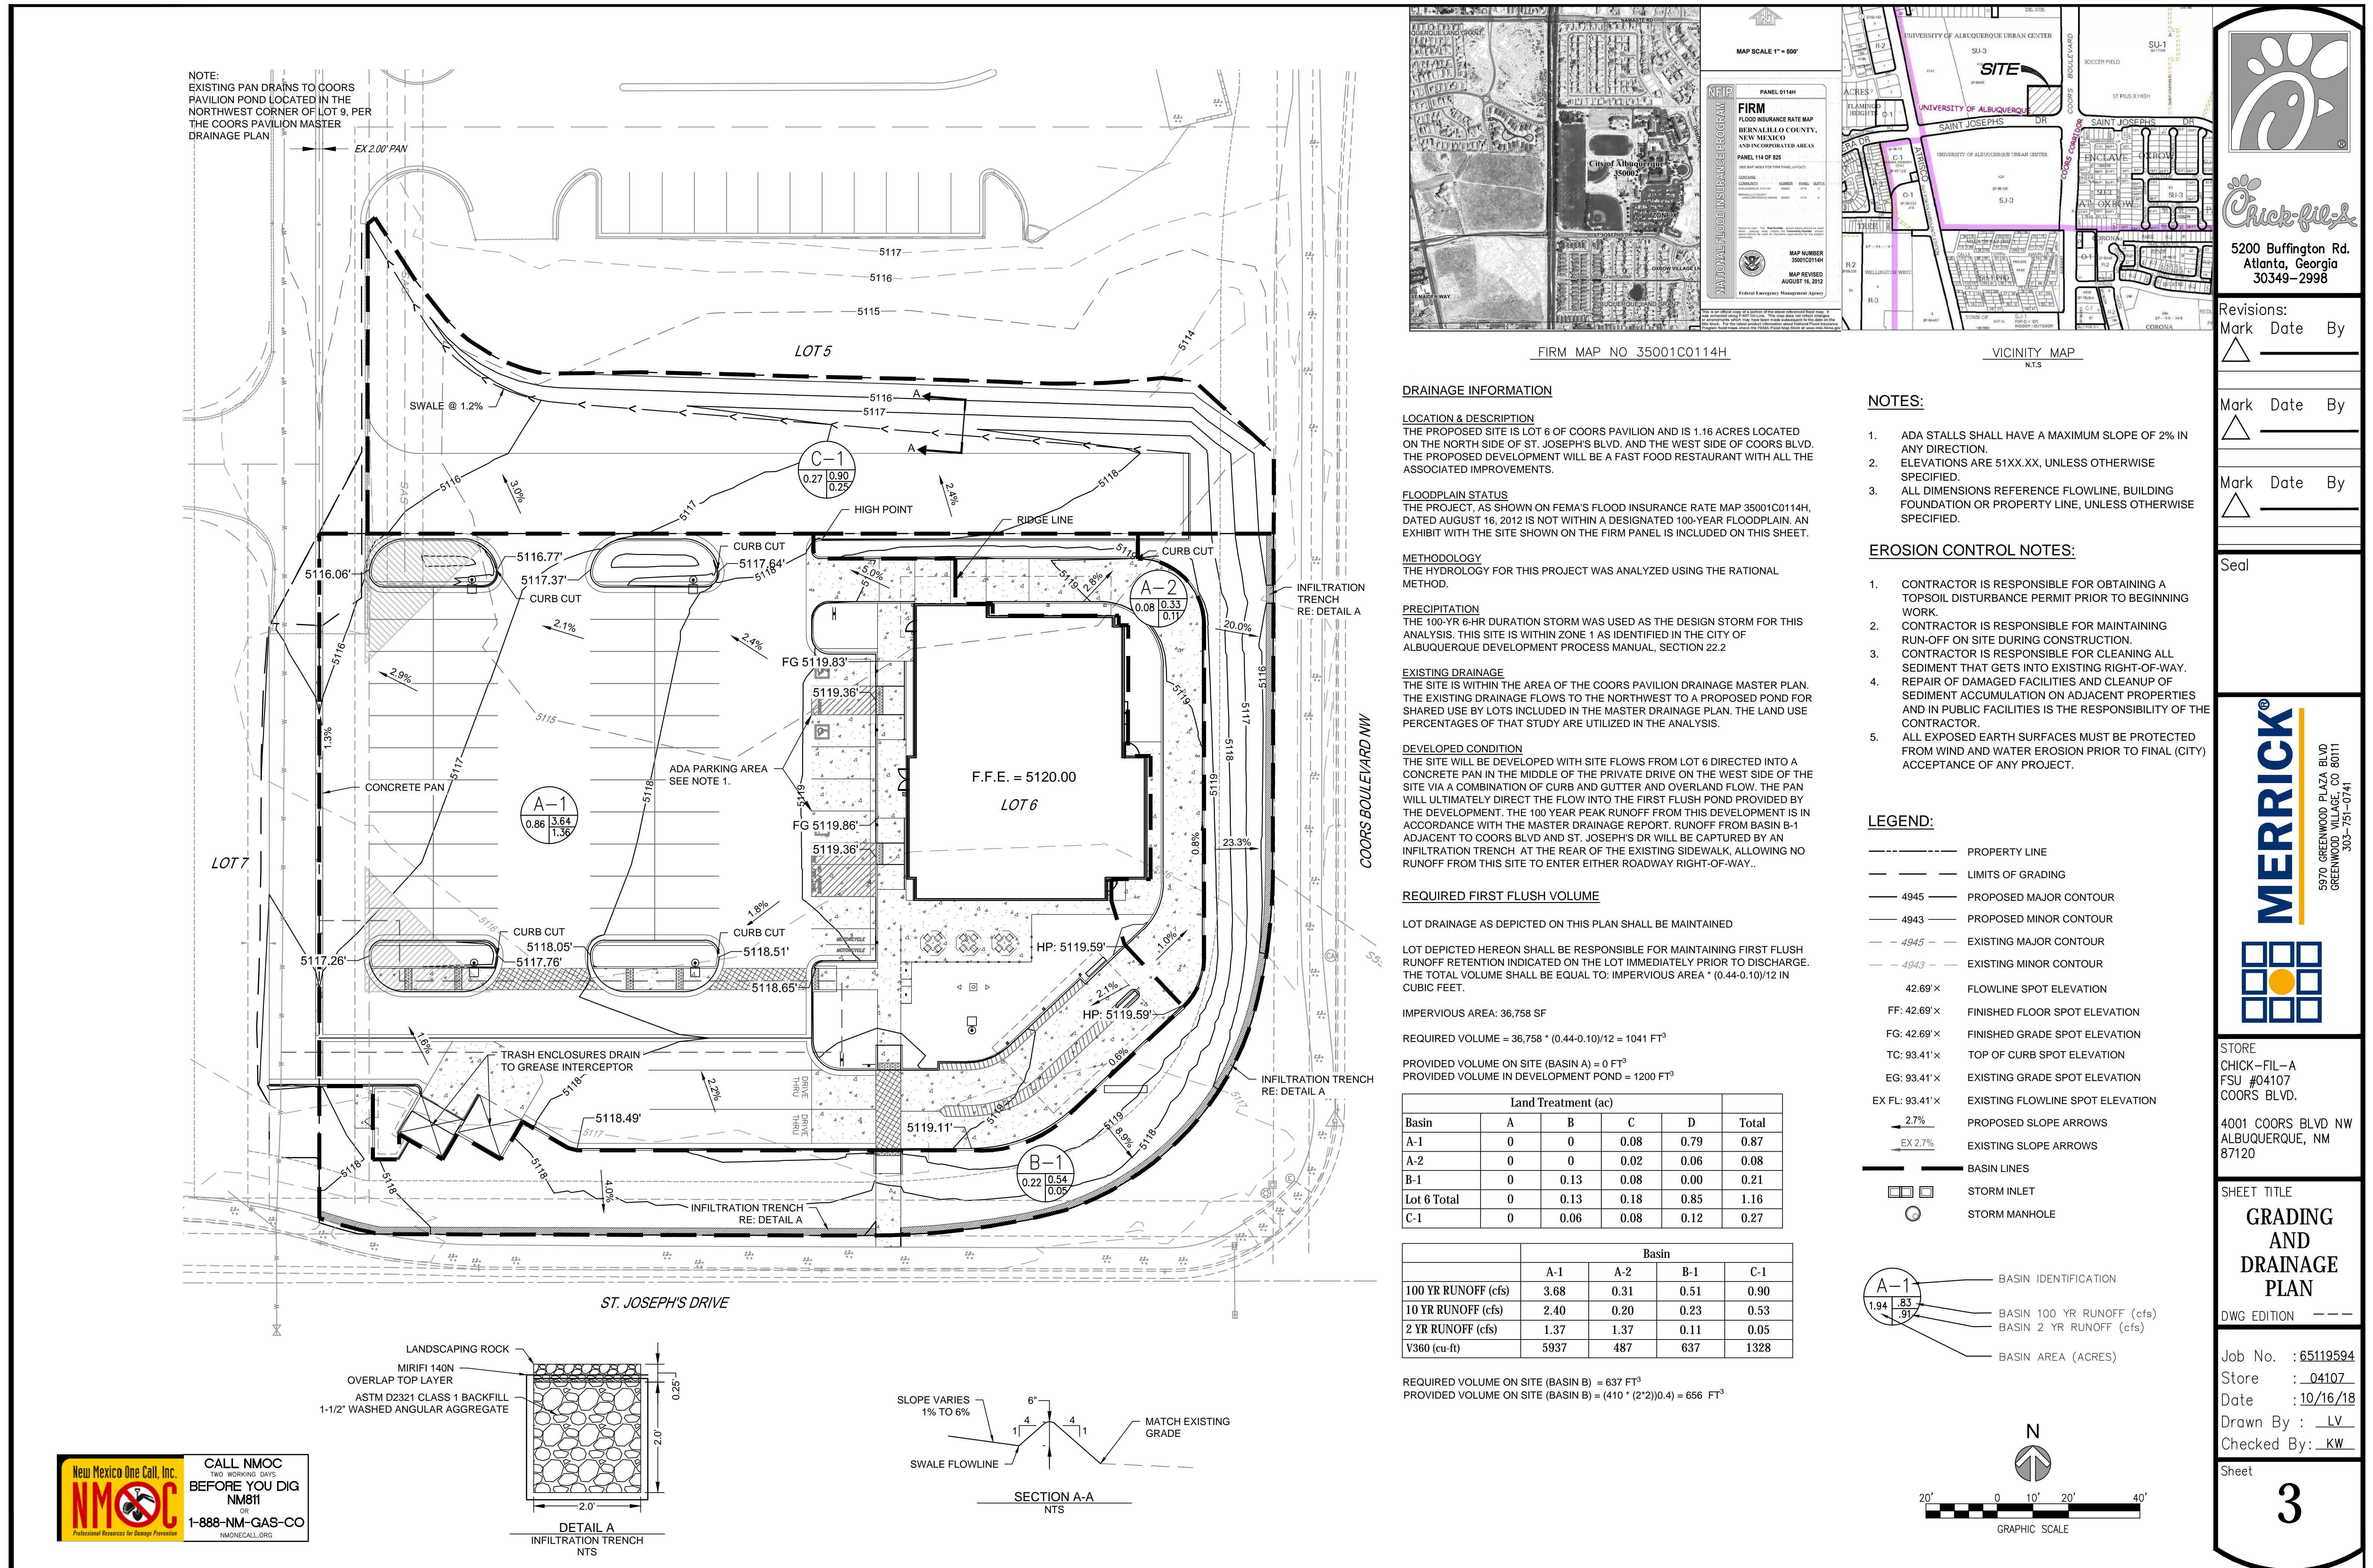

Chick-fil-A

5200 Buffington Rd.
Atlanta, Georgia
30349-2998

Revisions:
Mark Date By


Mark Date By

Mark Date By

Seal

MERRICK®

590 GREENWOOD PLAZA BLVD
GREENWOOD VILLAGE, CO 80111
303-751-0741

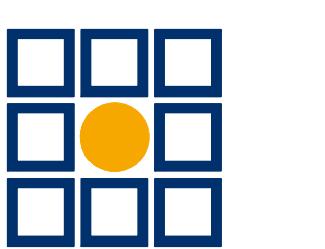

STORE
CHICK-FIL-A
FSU #04107
COORS BLVD.
4001 COORS BLVD NW
ALBUQUERQUE, NM
87120

SHEET TITLE


UTILITY PLAN

DWG EDITION

Job No. : 65119594
Store : 04107
Date : 10/16/18
Drawn By : LV
Checked By : KW

Sheet


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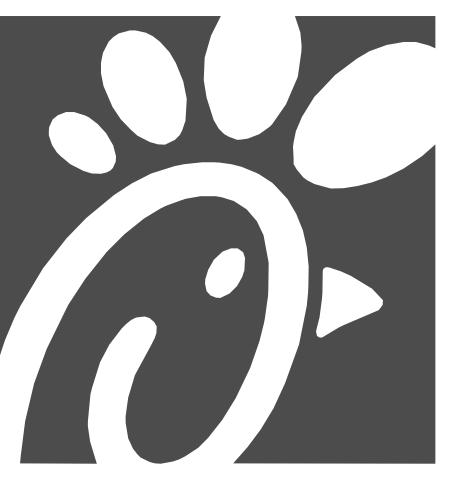


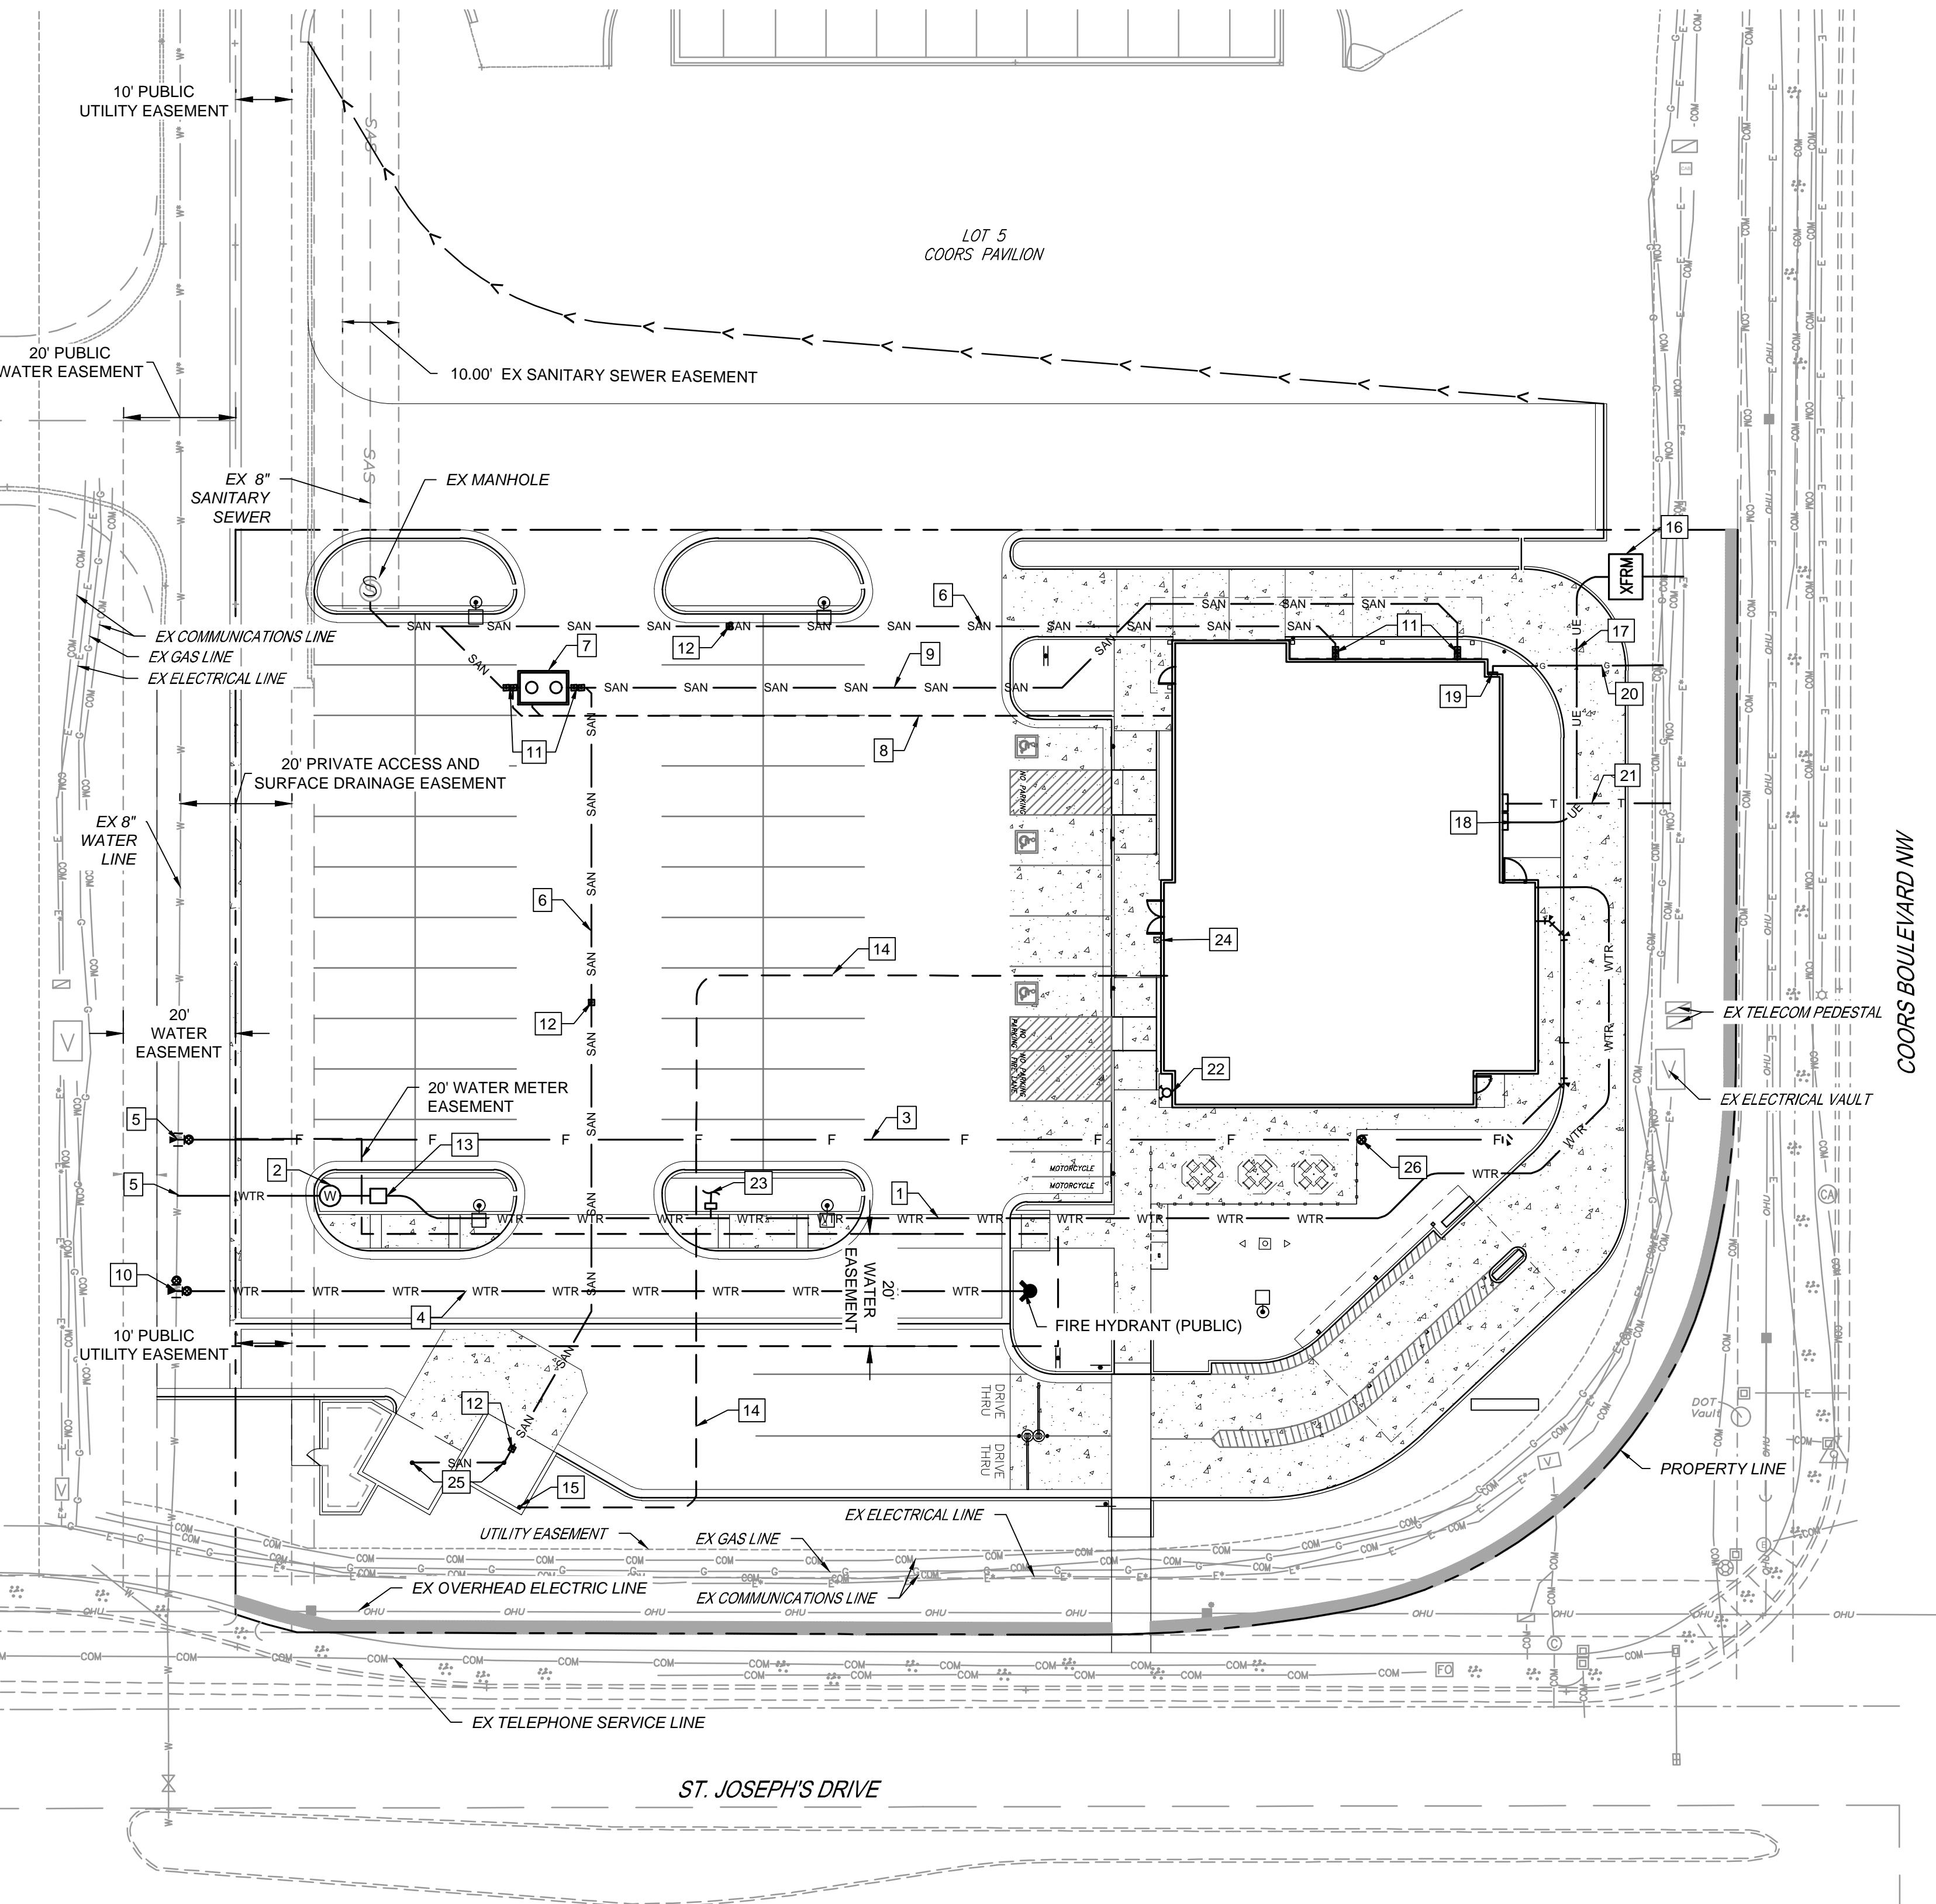PLUMBING SITE PLAN DESIGN NOTES & KEY PLAN

1	2" TYPE K COPPER DOMESTIC WATER SERVICE (PRIVATE)
2	2" WATER METER (PRIVATE)
3	4" D.I.P. FIRE LINE (PRIVATE)
4	6" D.I.P. FIRE SERVICE (PUBLIC)
5	CONNECT TO EXISTING WATER MAIN
6	4" PVC WASTEWATER SERVICE LINE (PRIVATE)
7	GREASE INTERCEPTOR (PRIVATE)
8	3" VENT LINE (PRIVATE)
9	4" PVC KITCHEN WASTE LINE (PRIVATE)
10	6" FIRE SERVICE CONNECTION (PUBLIC)
11	4" TWO-WAY CLEANOUT (TRAFFIC RATED) (PRIVATE)
12	4" ONE-WAY CLEANOUT (TRAFFIC RATED) (PRIVATE)
13	2" REDUCED PRESSURE PRINCIPLE BACKFLOW PREVENTION ASSEMBLY (RPBA)
14	3/4" TYPE K COPPER WATER SERVICE TO YARD HYDRANT (PRIVATE)
15	3/4" YARD HYDRANT (PRIVATE)
16	ELECTRIC TRANSFORMER
17	ELECTRIC SERVICE LINE
18	ELECTRIC METER AND DISTRIBUTION PANEL
19	GAS METER
20	GAS SERVICE LINE
21	TELEPHONE SERVICE LINE
22	FIRE DEPARTMENT CONNECTION
23	CONNECT TO IRRIGATION SYSTEM
24	KNOX BOX
25	TRASH ENCLOSURE AREA DRAIN, CONNECT TO PROPOSED SANITARY SEWER LINE.
26	POST INDICATOR VALVE

N



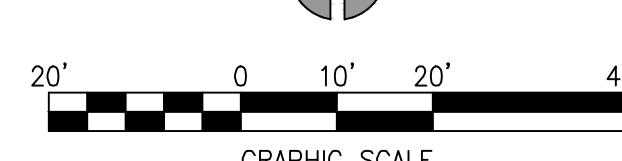

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ALBUQUERQUE, NM

COORS BLVD AND ST JOSEPH'S DR
ALBUQUERQUE, NM 87120

FSR#04107

BUILDING TYPE / SIZE:
P12 SE LRG
RELEASE:
v2_18.08

REVISION SCHEDULE
NO. DATE DESCRIPTION

CONSTRUCTION DOCUMENTS


CONSULTANT PROJECT # 25779
PRINTED FOR CONSTRUCTION DOCUMENTS
DATE 11/05/18
DRAWN BY K.HUNG

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SHEET PHOTOMETRICS SITE PLAN

SHEET NUMBER

E-110

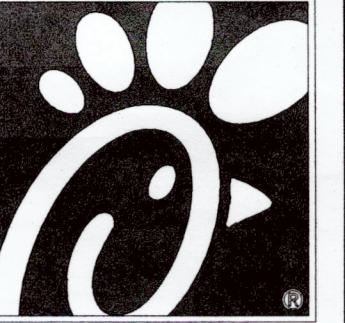

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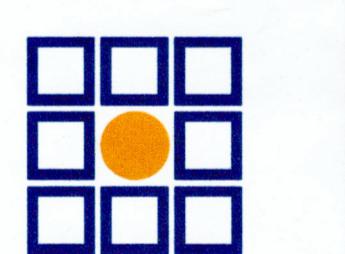
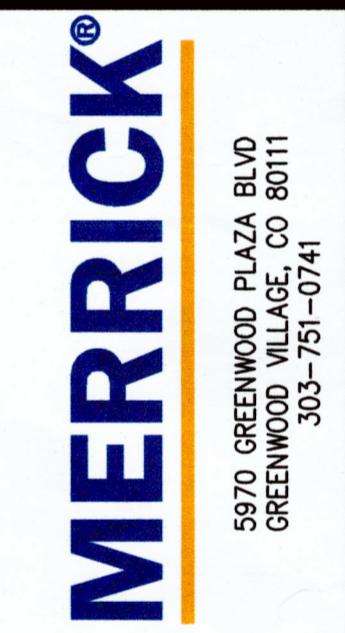
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Revisions:
Mark Date By

Mark Date By

Mark Date By

Seal



STORE
CHICK-FIL-A
FSU #04107
COORS BLVD.

4001 COORS BLVD NW
ALBUQUERQUE, NM
87120

SHEET TITLE



FIRE 1

DWG EDITION

Job No. : 65119594
Store : 04107
Date : 10/16/18
Drawn By : LV
Checked By : KW

Sheet

FIRE 1

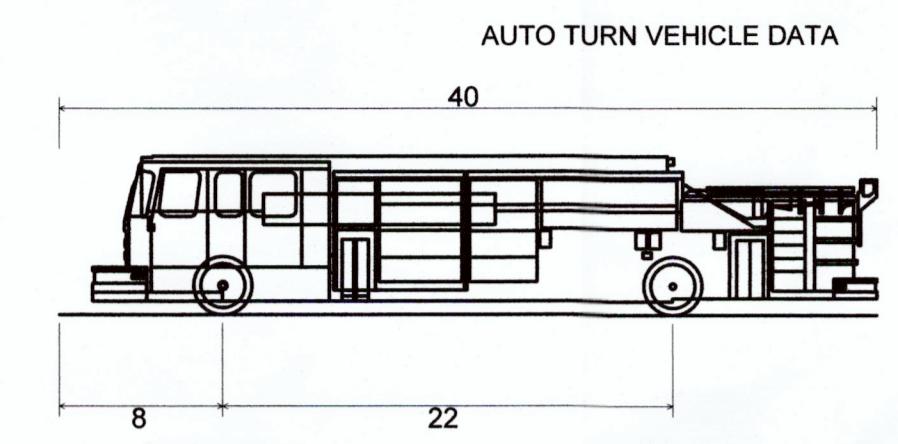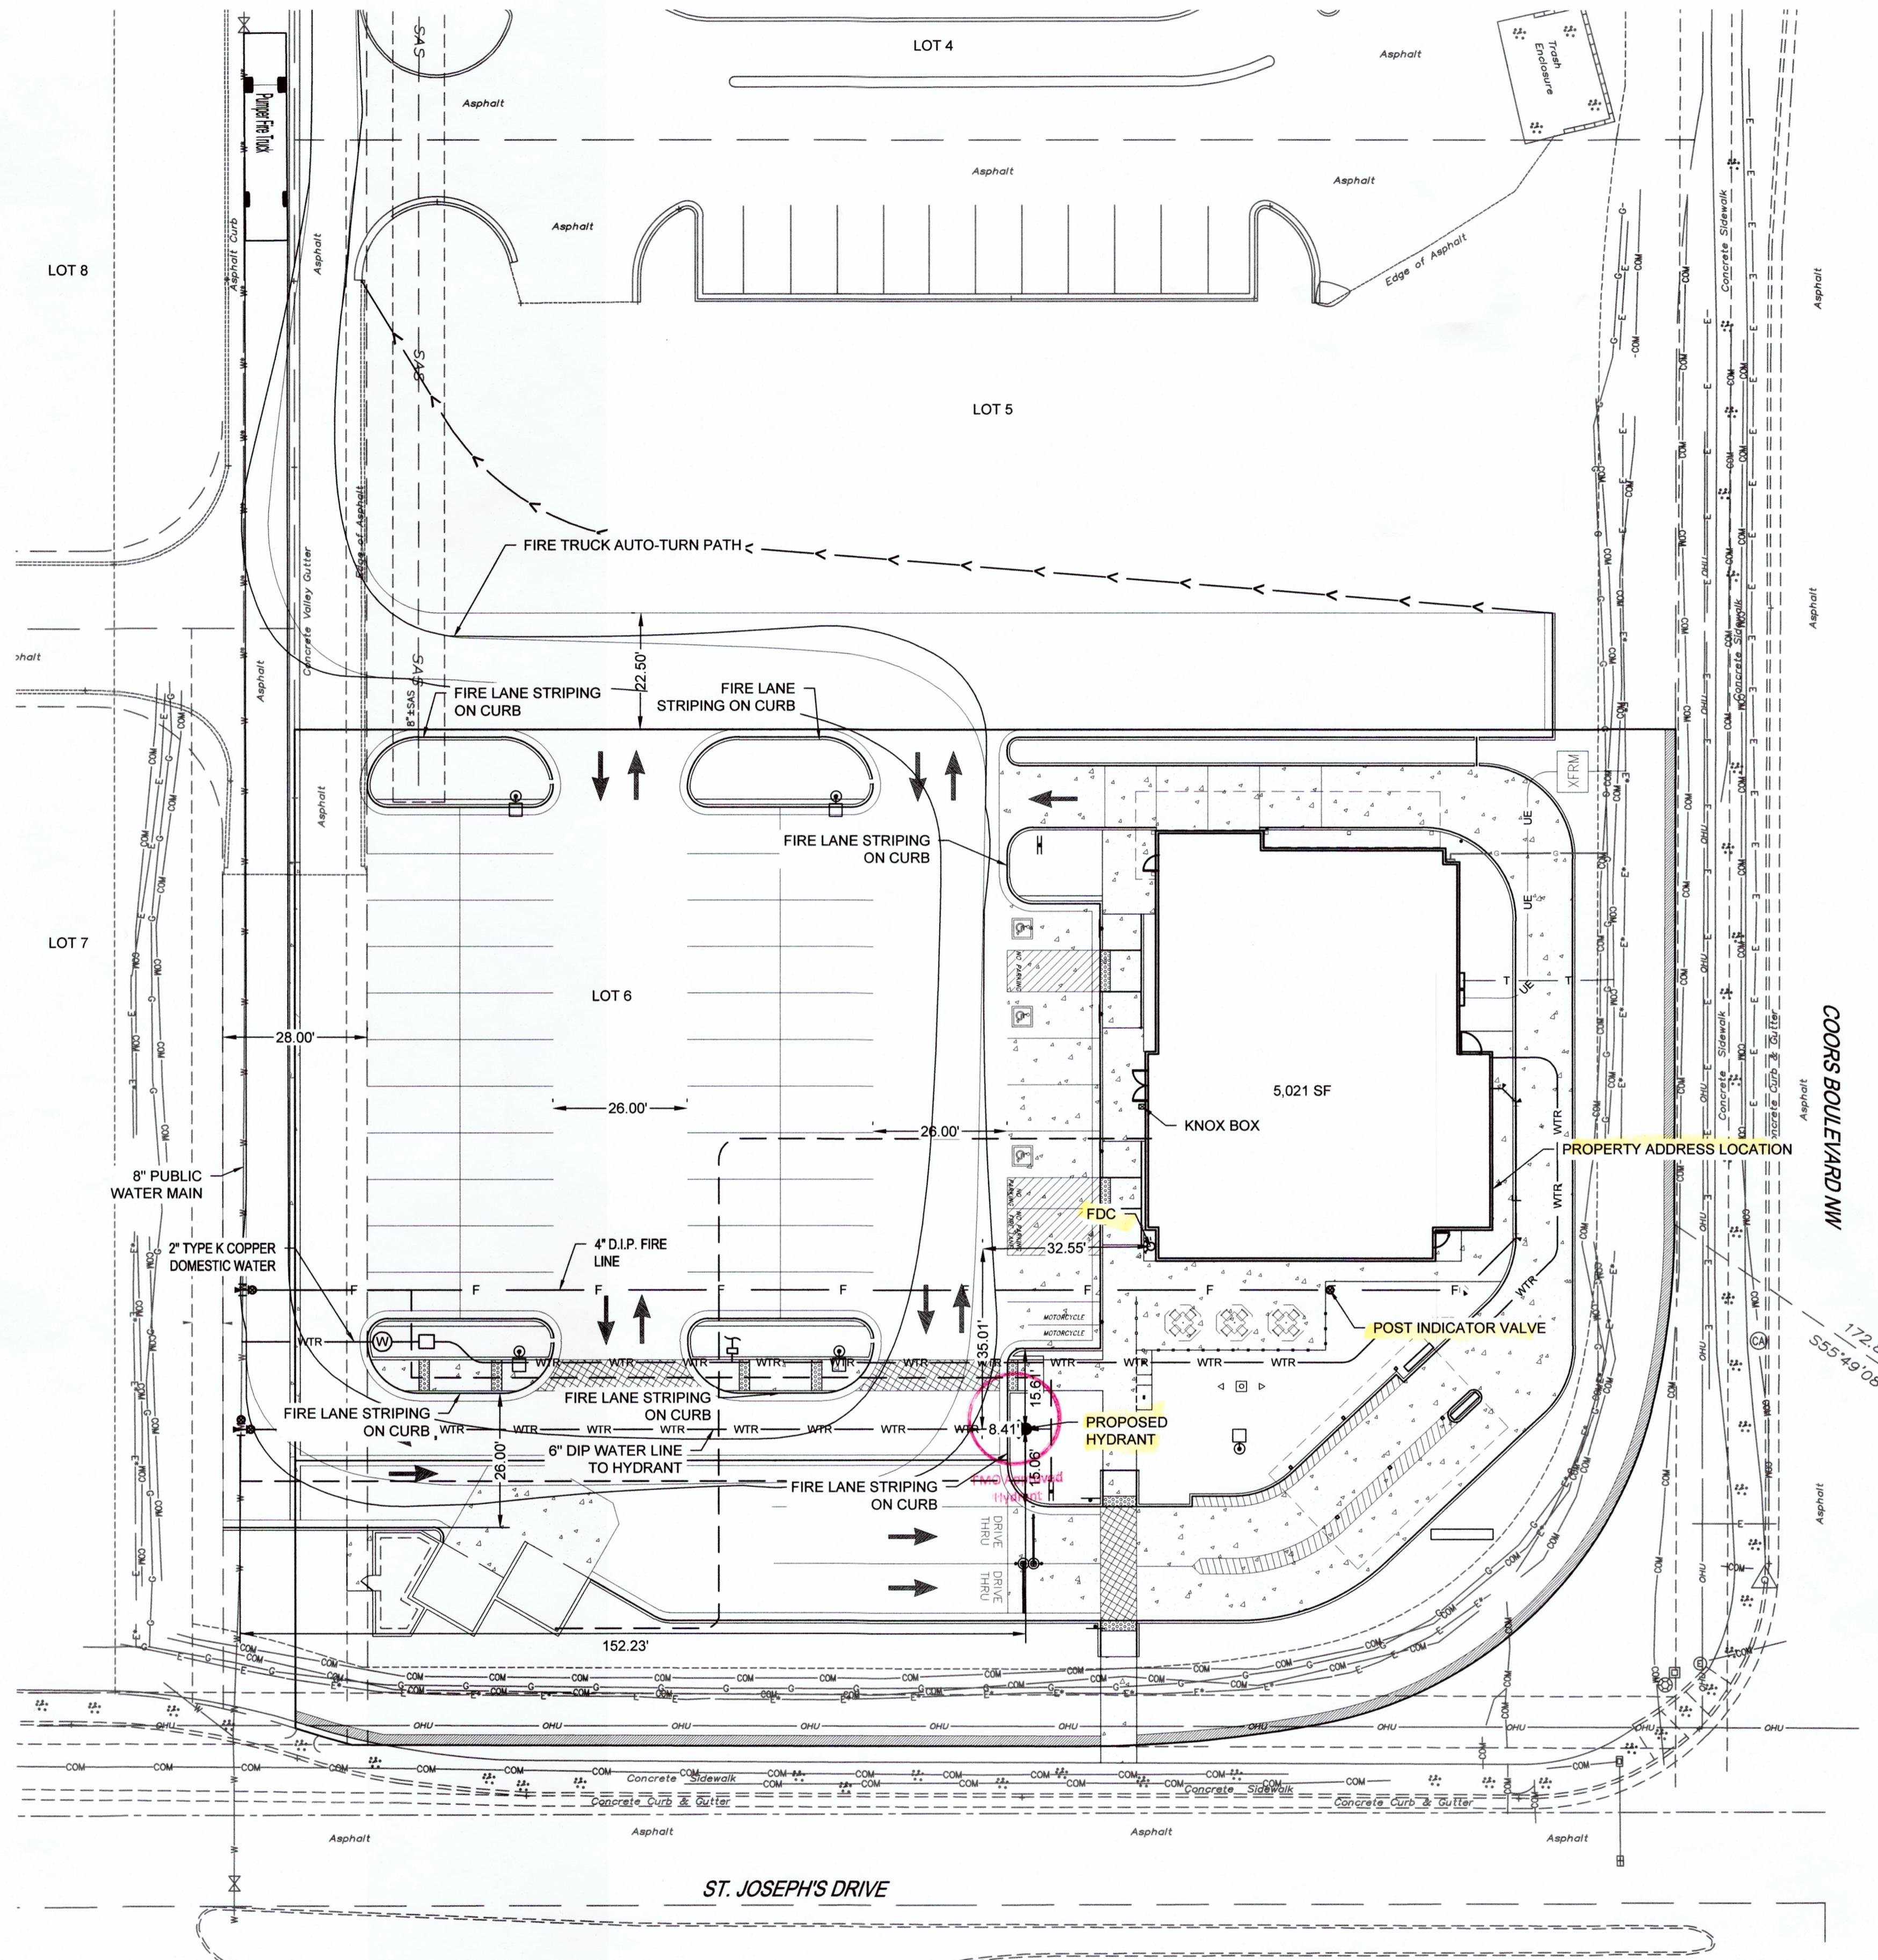

Pumper Fire Truck
Overall Length
Overall Width
Overall Body Height
Min Body Ground Clearance
Track Width
Lock-to-lock time
Max Wheel Angle

40.000ft
8.167ft
7.745ft
0.656ft
8.167ft
5.00s
45.00°


GENERAL NOTES

1. PAVEMENT SECTION IS BASED ON AN ESTIMATED 18,000-POUND EQUIVALENT SINGLE AXLE LOADS. CONCRETE SHALL HAVE A MINIMUM 28-DAY COMPRESSIVE STRENGTH OF 4,000 PSI. ACCESS AND LOADING SHALL SUPPORT 75,000 POUNDS AND WILL NOT EXCEED 10% IN GRADE.
2. BUILDING WILL BE SPRINKLED, SEE ARCHITECTURAL PLANS.
3. PER 2015 IBC, NO SEPARATION IS NEEDED WITH THIS BUILDING.
4. FIRE FLOW DATA
 - CODE FOR ANALYSES: 2015 IFC
 - CONSTRUCTION TYPE: V-B
 - BUILDING AREA: 5,021 SF
 - FIRE FLOW: 2000 GPM
 - 50% REDUCTION FOR FULLY SPRINKLED: 1000 GPM
 - MINIMUM FIRE FLOW REQUIREMENT: 1000 GPM
5. NUMBER OF FIRE HYDRANTS REQUIRED PER APPENDIX C:1 OF 2015 IFC.
6. ALL REQUIRED FIRE HYDRANTS SHALL BE INSTALLED AND OPERATE BEFORE ANY BUILDING (OR PORTION OF THE BUILDING) IS OCCUPIED. AN APPROVED AND ADEQUATE WATER SUPPLY SHALL BE PROVIDED BEFORE AND COMBUSTIBLE MATERIALS ARE DELIVERED TO THE BUILDING SITE. IT SHALL BE UNLAWFUL TO OCCUPY ANY PORTION OF THE BUILDING OR STRUCTURE UNTIL THE REQUIRED FIRE DETECTION, ALARM, AND SUPPRESSION SYSTEMS HAVE BEEN TESTED AND APPROVED.



GRAPHIC SCALE



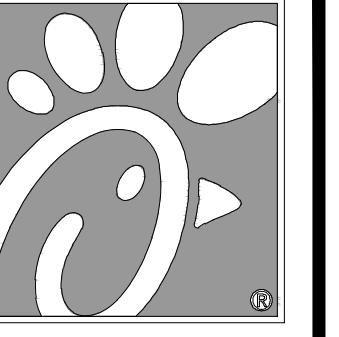

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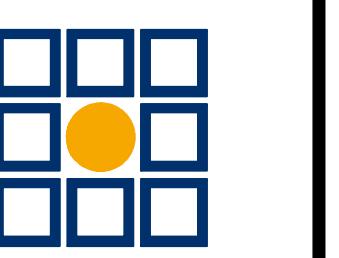
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STORE
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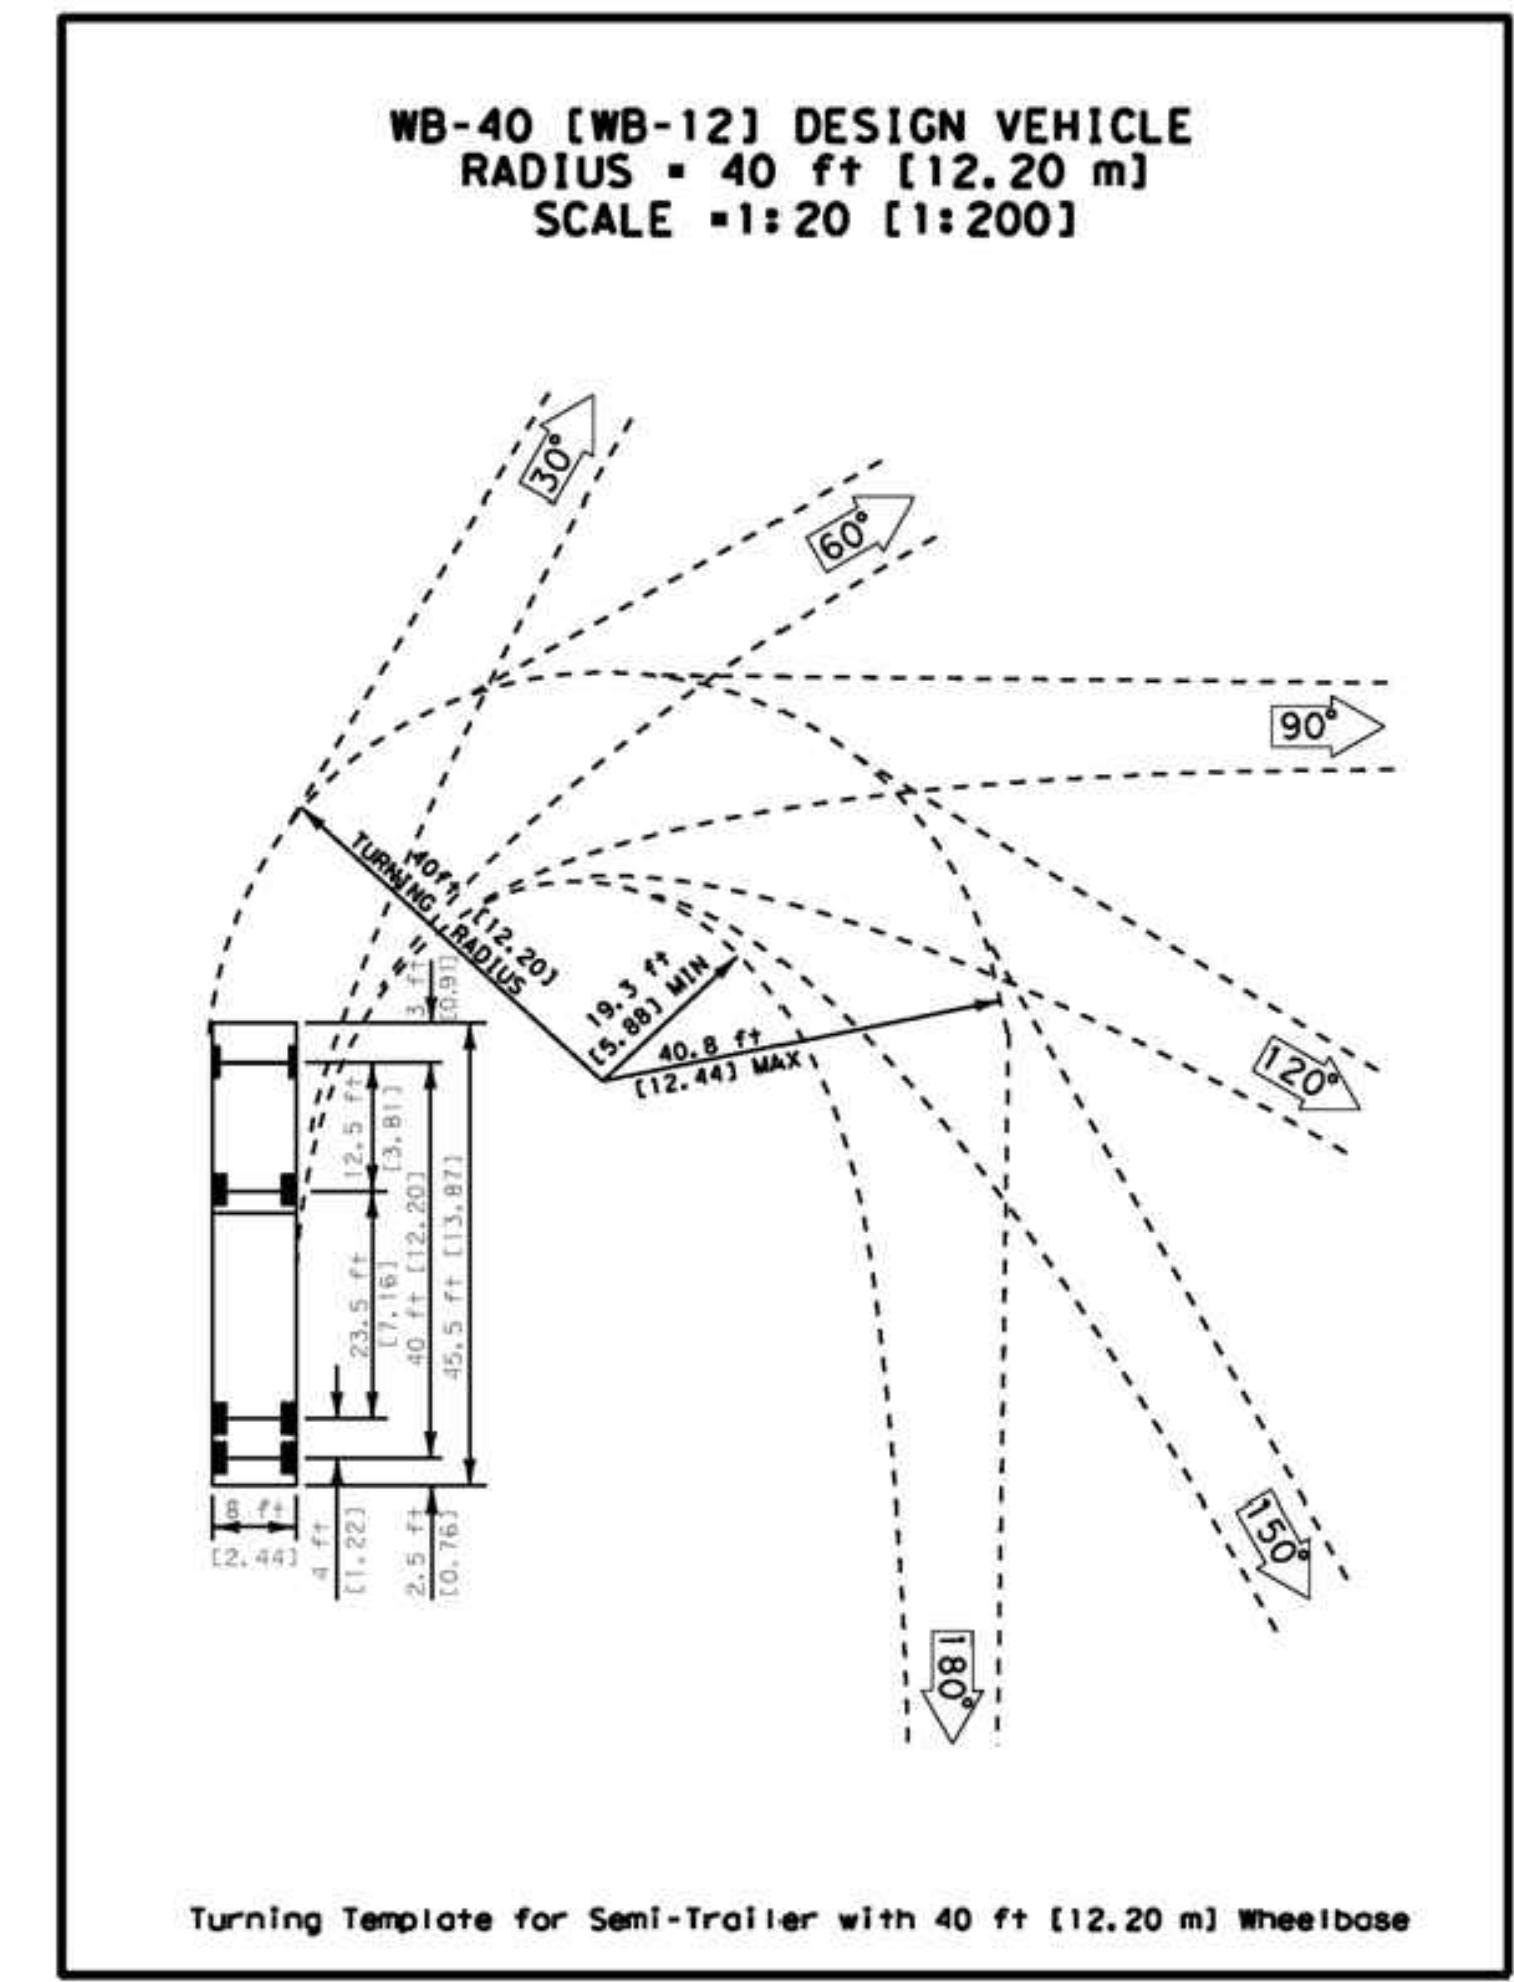
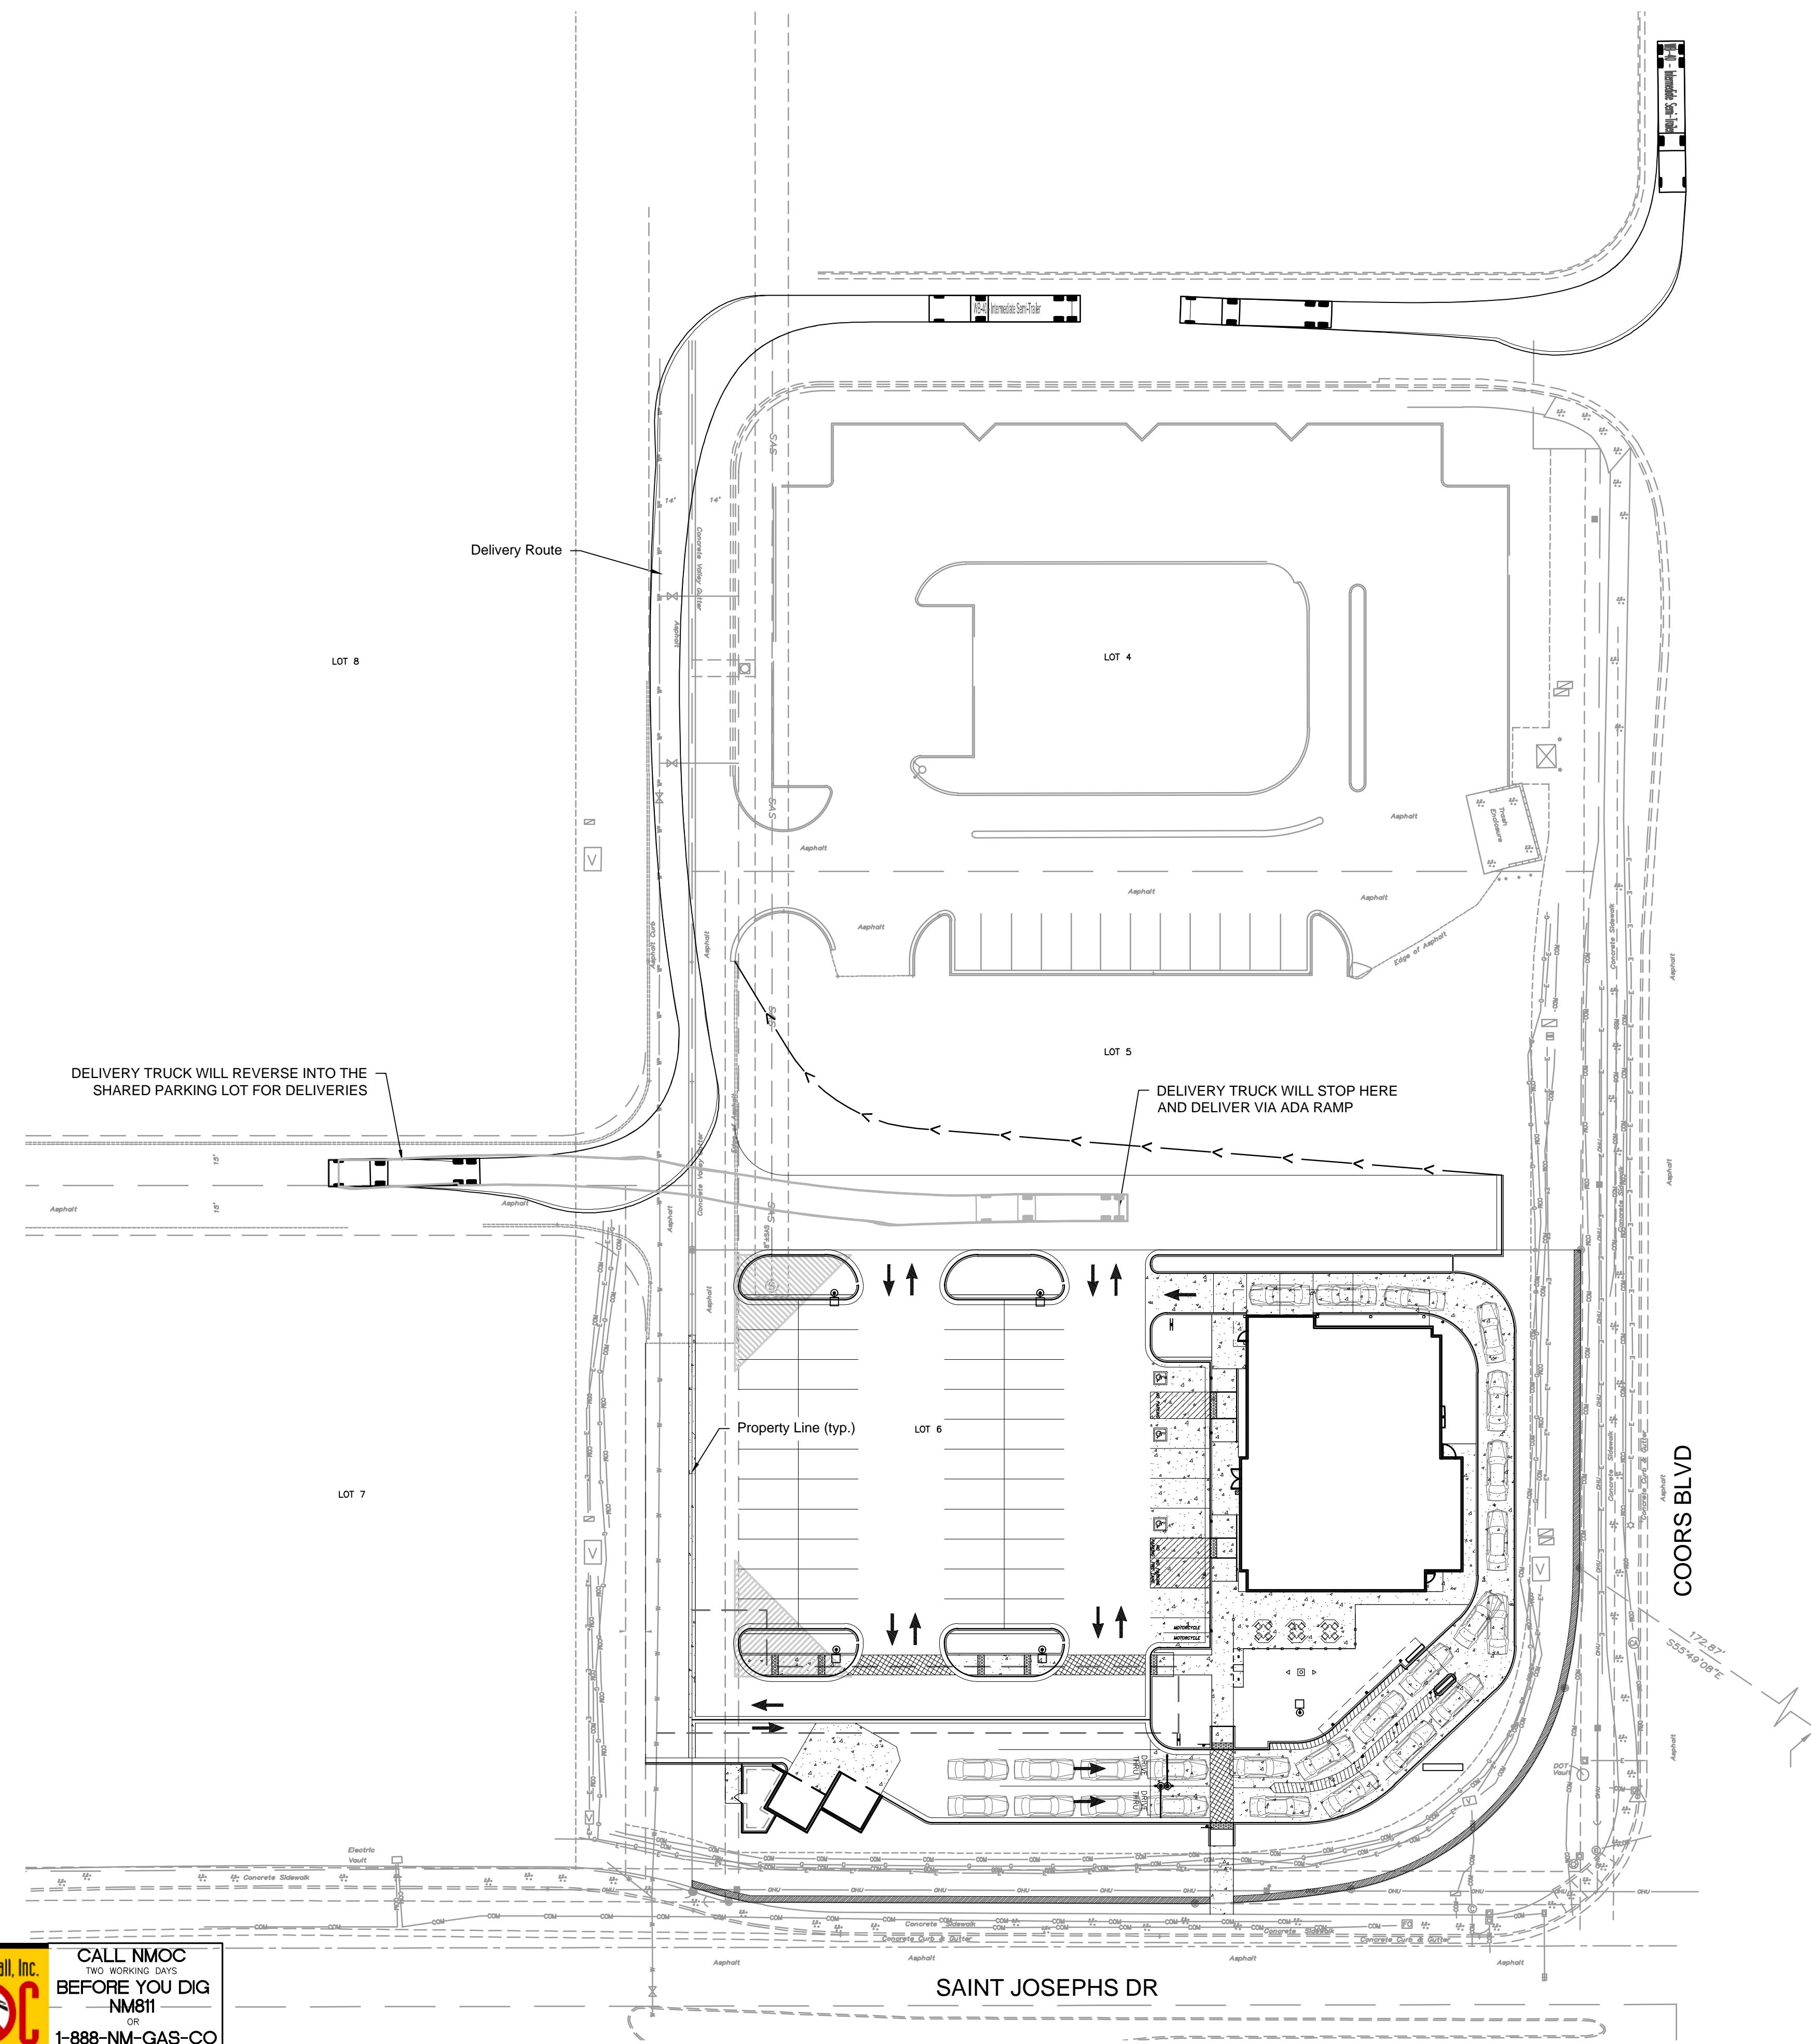
SHEET TITLE
DELIVERY TRUCK ROUTE

DWG EDITION

Job No. : 65119594
Store : 04107
Date : 10/16/18
Drawn By : LV
Checked By: KW

Sheet

6





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ALBUQUERQUE, NM 87120

FSR#04107

BUILDING TYPE / SIZE:
P12 SE LRG
v2.18.08

RELEASE:
v2.18.08

REVISION SCHEDULE
NO. DATE DESCRIPTION
10/30/18 SCHEMATIC DESIGN ISSUE


SCHEMATIC DESIGN

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DATE 10/16/17
DRAWN BY C. ELIAS

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SHEET EXTERIOR ELEVATIONS
SHEET NUMBER

A-02



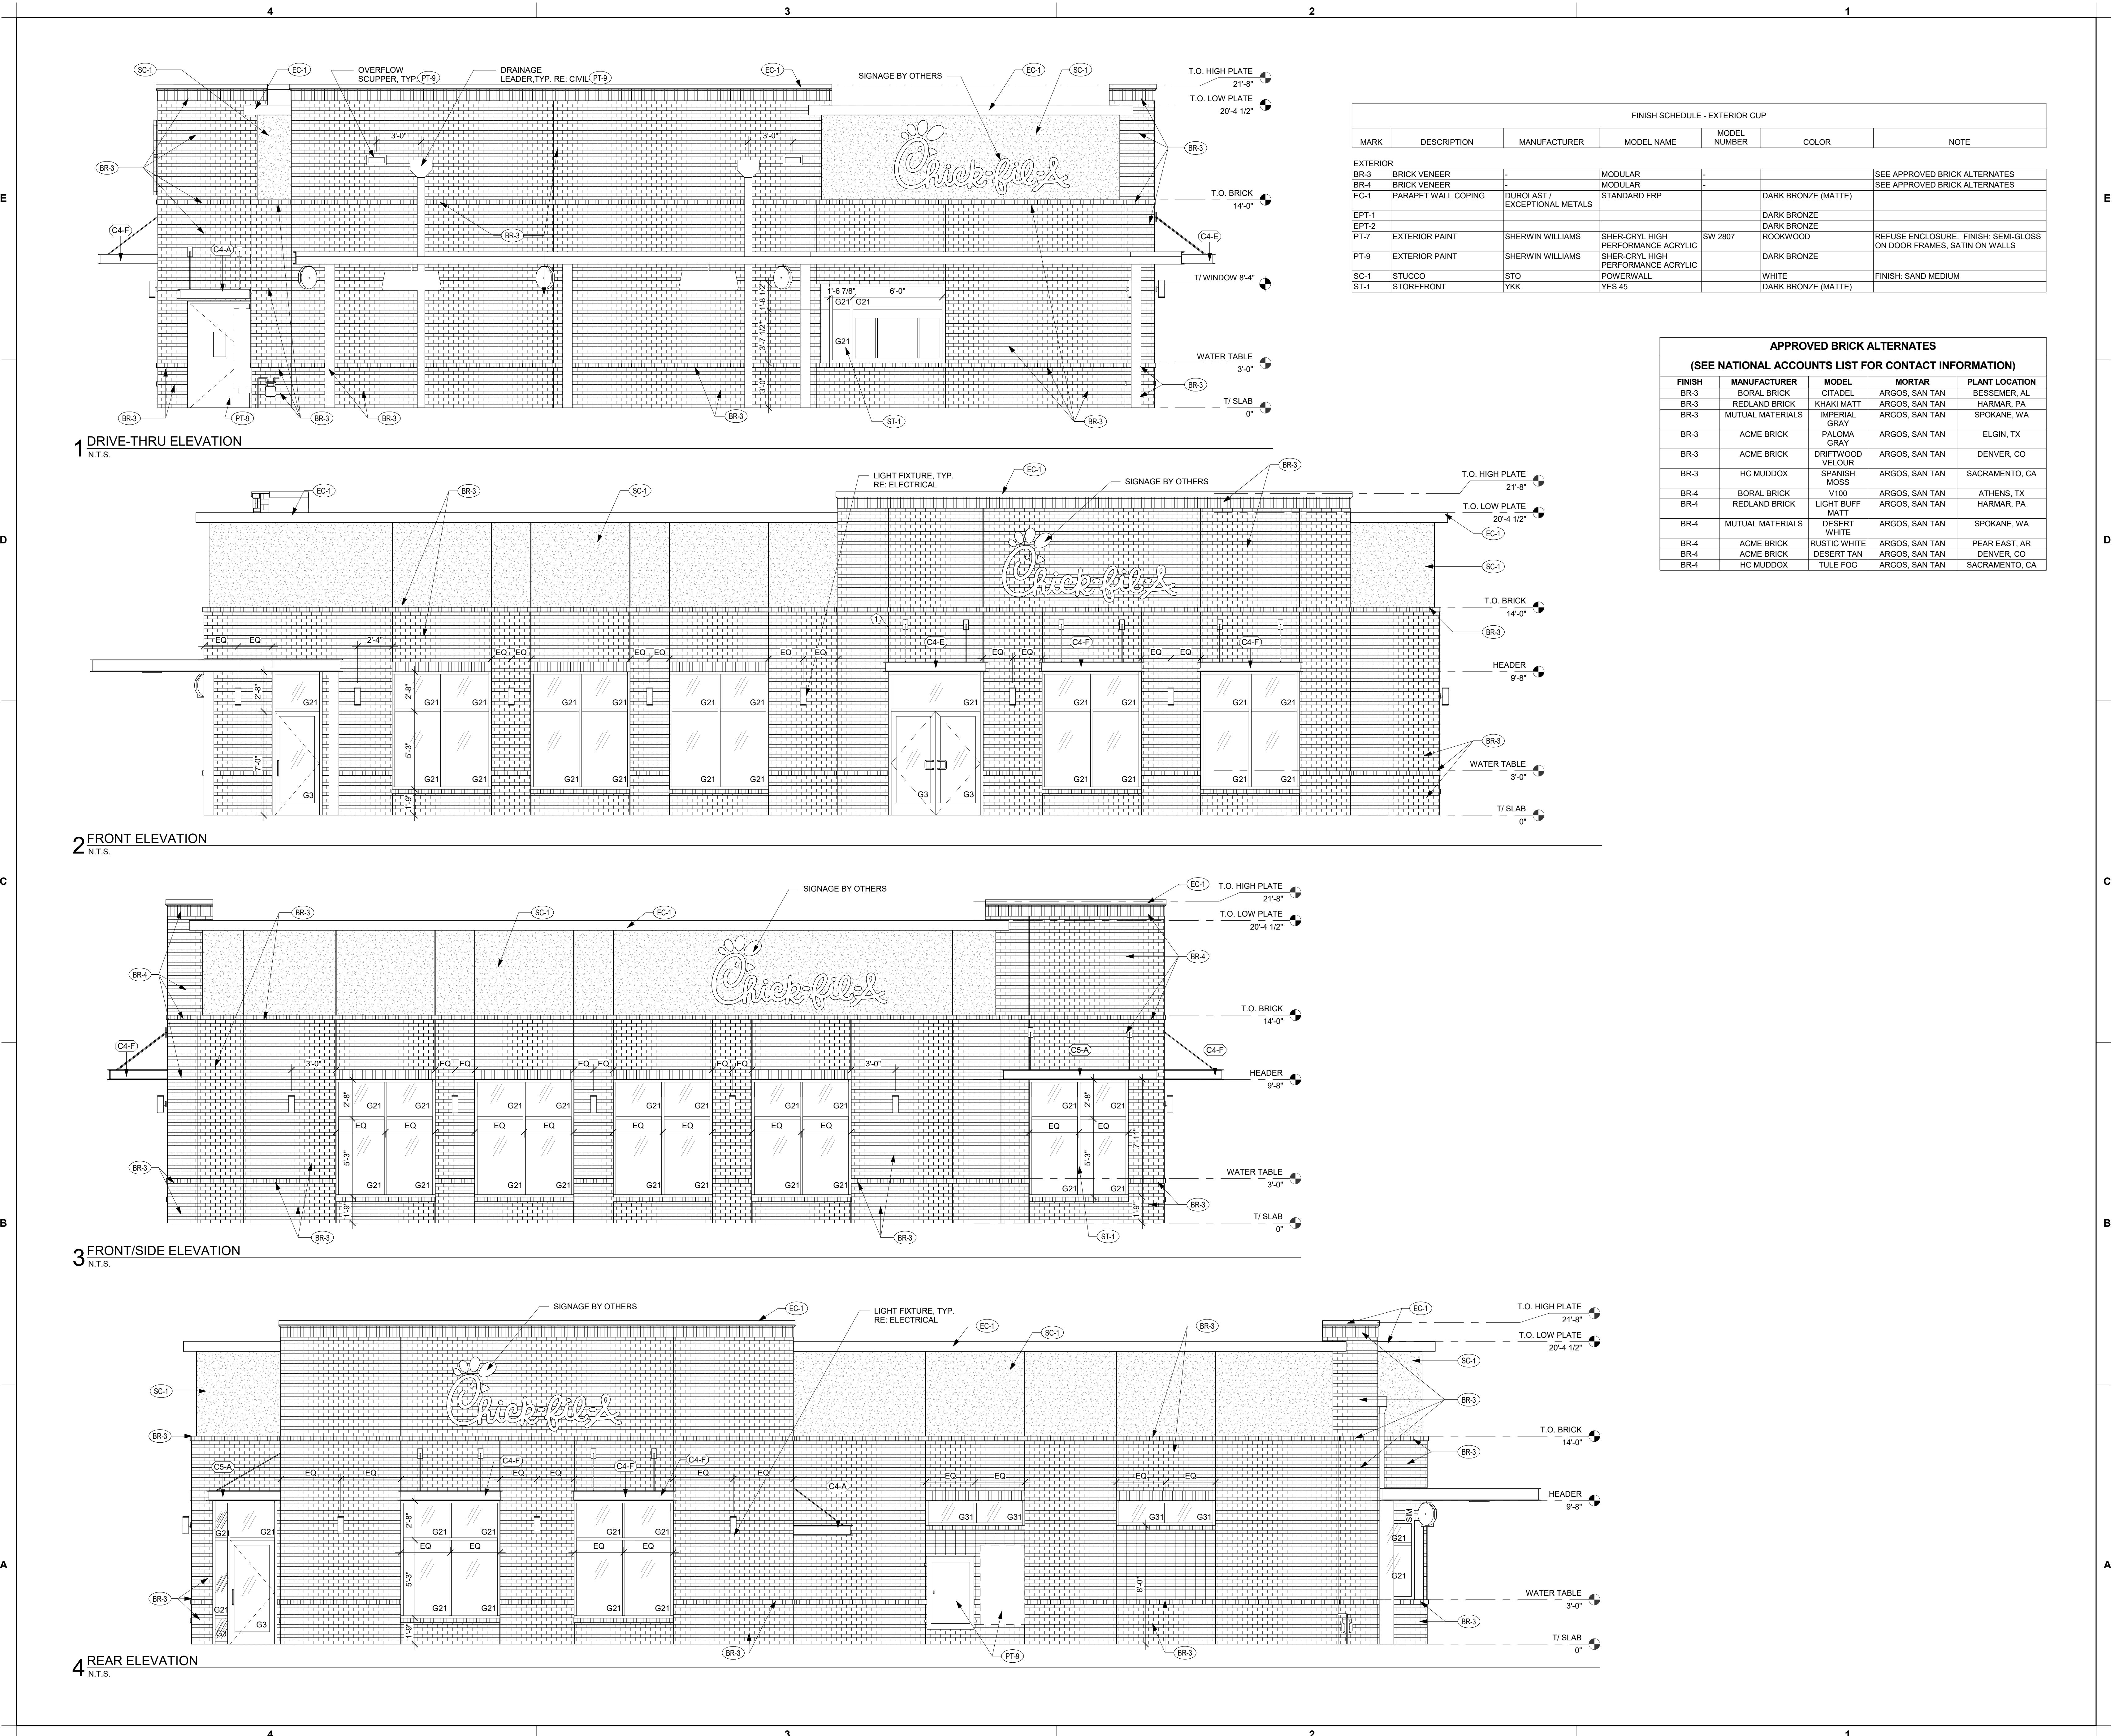

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FSR#04107

BUILDING TYPE / SIZE: P12 SE LRG
RELEASE: v2.18.08

REVISION SCHEDULE
NO. DATE DESCRIPTION
10/30/18 SCHEMATIC DESIGN ISSUE

CONSTRUCTION DOCUMENTS

CONSULTANT PROJECT # 25779
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DATE 06/26/19
DRAWN BY C. ELIAS

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SHEET
PERSPECTIVE VIEWS

SHEET NUMBER

A-04



1 PERSPECTIVE VIEW - Stucco - REAR RIGHT Copy 1
N.T.S.



2 PERSPECTIVE VIEW - Stucco - REAR LEFT Copy 1
N.T.S.



3 PERSPECTIVE VIEW - Stucco - FRONT LEFT Copy 1
N.T.S.