
AA APPLICATION

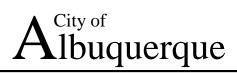



DEVELOPMENT REVIEW APPLICATION

Effective 4/17/19

Please check the appropriate box and refer to supplemental forms for submittal requirements. All fees must be paid at the time of application.								
Administrative Decisions	D	ecisio	ns Requiring a Pul	olic Meeting or Hearing	Policy	Decisions		
☐ Archaeological Certificate (Form P3		☐ Site Plan – EPC including any Variances – EPC (Form P1)				☐ Adoption or Amendment of Comprehensive Plan or Facility Plan (Form Z)		
☐ Historic Certificate of Appropriatene (Form L)	ess – Minor	☐ Master Development Plan (Form P1)				☐ Adoption or Amendment of Historic Designation (Form L)		
☐ Alternative Signage Plan (Form P3) ☐ Historic Certificate of Appropriateness – Major (Form L)					□ Ame	☐ Amendment of IDO Text (Form Z)		
☑ Minor Amendment to Site Plan (Form P3) ☐ Demolition Outside of HPO (Form L)					□ Ann	☐ Annexation of Land <i>(Form Z)</i>		
□ WTF Approval (Form W1) □ Historic Design Standards and Guidelines (Form L)					□ Ame	endment to Zoning Map	– EPC (Form Z)	
	☐ Wireless Telecommunications Facility Waiver (Form W2)					☐ Amendment to Zoning Map – Council (Form Z)		
					Appea	ls		
					□ Dec <i>A)</i>	ision by EPC, LC, ZHE	, or City Staff (Form	
APPLICATION INFORMATION								
Applicant: Presbyterian Healthcare Services Phone: 505.841.1234								
Address: P.O. Box 26666					Em	ail:		
City: Albuquerque				State: NM	Zip	: 87125		
Professional/Agent (if any): Will Gleason, Dekker Perich Sabatini					Ph	one: 505.761.9700		
Address: 7601 Jefferson NE Suite 100 Email: willg@dpsdesign.org							org	
City: Albuquerque State: N				State: NM	Zip	: 87109		
Proprietary Interest in Site: List <u>all</u> owners:								
BRIEF DESCRIPTION OF REQUEST								
Minor Amendment to approved Site Development Plan to facilitate site improvements for the approved hospital addition. Site improvements include modifications to landscape areas due to accidental removal of existing landscaping.								
modifications to landscape areas due to	o accidental ren	novai c	or existing landscap	ing.				
SITE INFORMATION (Accuracy of the	ne existing lega	ıl desc	cription is crucial!	Attach a separate sheet if	necessa	ry.)		
Lot or Tract No.: See Attached Site In	nformation			Block:	Un	t:		
Subdivision/Addition:				MRGCD Map No.:	UP	C Code:		
Zone Atlas Page(s): K-15		Exist	ting Zoning: MX-H	1	Pro	posed Zoning: MX-H		
# of Existing Lots: 9 # of Proposed Lots: 9					Tot	al Area of Site (acres):	27	
LOCATION OF PROPERTY BY STRE	ETS				Ţ			
Site Address/Street: 1100 Central Ave	e SE	Betw	veen: Oak St. SE		and: S	ycamore St. SE		
CASE HISTORY (List any current or	prior project a	nd cas	se number(s) that	may be relevant to your re	quest.)			
1000575, 1001620, 1010958, 1011126	6							
Signature:					Da	te: May 27, 2022		
Printed Name: Will Gleason ☐ Applicant or ☒ Agent								
FOR OFFICIAL USE ONLY								
Case Numbers	Action		Fees	Case Numbers		Action	Fees	
			_					
Meeting/Hearing Date:					Fee	e Total:		
Staff Signature: Da				Date:	Project #			

FORM P3

FORM P3: ADMINISTRATIVE DECISIONS AND MINOR AMENDMENTS

A single PDF file of the complete application including all plans and documents being submitted must be emailed to PLNDRS@cabq.gov prior to making a submittal. Zipped files or those over 9 MB cannot be delivered via email, in which case the PDF must be provided to City Staff using other on-line resources such as Dropbox or FTP.

☑ INFORMATION REQUIRED FOR ALL ADMINISTRATIVE DECISIONS OR AMENDMEI

- X Letter of authorization from the property owner if application is submitted by an agent
 X Zone Atlas map with the entire site clearly outlined and label

□ ARCHEOLOGICAL CERTIFICATE

Landscape Plan

- ___ Archaeological Compliance Documentation Form with property information section completed
- Only the information above is required unless the City Archaeologist determines that the application does not qualify for a Certificate of No Effect, in which case a treatment plan prepared by a qualified archaeologist that adequately mitigates any archeological impacts of the proposed development must be submitted and reviewed for a Certificate of Approval per the criteria in IDO Section 14-16-6-5(A)(3)(b)

MINOR AMENDMENT TO SITE PLAN - ADMIN, EPC, or DRB

- X Justification letter describing, explaining, and justifying the request per the criteria in IDO Section 14-16-6-4(Y)(2)
- x The approved Site Plan being amended
- X Copy of the Official Notice of Decision associated with the prior approval
- X The proposed Site Plan, with changes circled and noted
 - Refer to the Site Plan Checklist for information needed on the proposed Site Plan.
- N/A Completed Site & Building Design Considerations Form in accordance with IDO Section 5-2(D) for new commercial and multifamily development except if the development is industrial or the multifamily is less than 25 units

Minor Amendments must be within the thresholds established in IDO TABLE 6-4-4. Any amendment beyond these thresholds is considered a Major Amendment and must be processed through the original decision-making body for the request.

MINOR AMENDMENT TO SITE DEVELOPMENT PLAN APPROVED PRIOR TO THE EFFECTIVE DATE OF THE IDO Justification letter describing, explaining, and justifying the request per the criteria in IDO Section 14-16-6-4(Z)(1)(a) The approved Site Development Plan being amended Copy of the Official Notice of Decision associated with the prior approval The proposed Site Development Plan, with changes circled and noted Refer to the Site Plan Checklist for information needed on the proposed Site Plan. Completed Site & Building Design Considerations Form in accordance with IDO Section 5-2(D) for new commercial and multifamily development except if the development is industrial or the multifamily is less than 25 units
Minor Amendments must be within the thresholds established in IDO TABLE 6-4-4. Any amendment beyond these thresholds is considered a Major Amendment and must be processed through the original decision-making body for the request.
ACCELERATED EXPIRATION SITE PLAN Justification letter describing, explaining, and justifying the request per the criteria in IDO Section 14-16-6-4(X)(2)(c) Site Plan to be Expired
ALTERNATIVE SIGNAGE PLAN Proposed Alternative Signage Plan compliant with IDO Section 14-16-5-12(F)(5) Justification letter describing, explaining, and justifying the request per the criteria in IDO Section 14-16-6-5(C)(3)(b) Required notices with content per IDO Section 14-16-6-4(K) Office of Neighborhood Coordination notice inquiry response and proof of emailed notice to affected Neighborhood Association representatives Sign Posting Agreement
ALTERNATIVE LANDSCAPE PLAN

Justification letter describing, explaining, and justifying the request per the criteria in IDO Section 14-16-5-6(C)(16)

LETTER OF AUTHORIZATION



Healthcare Services

May 20, 2022

Mr. Anthony Santi Dekker/Perich/Sabatini LLC 7601 Jefferson NE, Suite 100 Albuquerque, NM 87109

Zoning Enforcement Officer (ZEO), City of Albuquerque Planning Department 600 Second Street NW | Albuquerque, NM 87102

RE: Request for a Minor Amendment of a Site Development Plan
Landscape and Irrigation Improvements
Presbyterian Healthcare Services
Presbyterian Main Hospital Campus located at 1100 Central Ave SE, Albuquerque, NM 87106
(Tracts 1-9 Presbyterian Hospital – Main Campus Phase 1 Replat)

Dear ZEO:

This Letter authorizes Dekker/Perich/Sabatini LLC to represent Presbyterian Healthcare Services with regard to the design and approval of all necessary steps related to the regulatory and permitting process with the city of Albuquerque. This letter authorizes Dekker/Perich/Sabatini LLC to act as Presbyterian Healthcare Services' agent as necessary with the permitting and associated approval processes required for the proposed Improvements on the property referenced above.


Please contact me at 563-6635 if there are any questions.

Sincerely,


Eric Cornish

Vice President Real Estate

ZONE ATLAS MAP

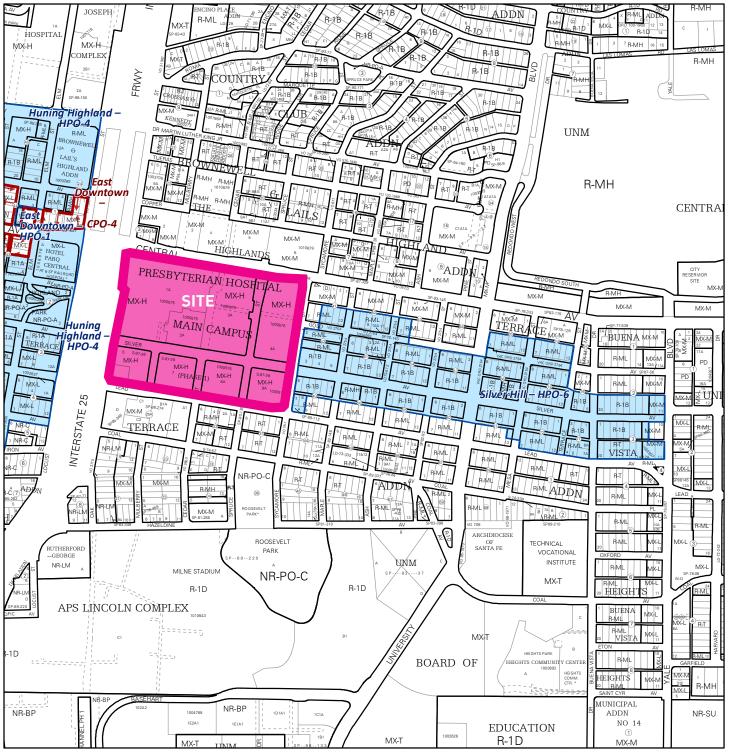

For more details about the Integrated Development Ordinance visit: http://www.cabq.gov/planning/codes-policies-regulations/integrated-development-ordinance

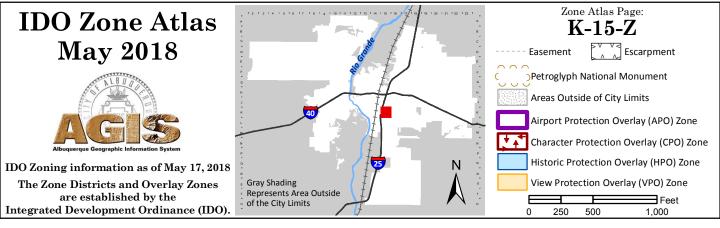

JUSTIFICATION LETTER



May 27, 2022

Zoning Enforcement Officer (ZEO)
City of Albuquerque Planning Department
600 Second Street NW | Albuquerque, NM 87102

Re: Request for Administrative Amendment of a Site Development Plan
Presbyterian Healthcare Services, Project #2019-002661

Dear ZEO,

Presbyterian Healthcare Services, owner of the subject property, is seeking to amend the existing site development plan (approved in 2006) for Presbyterian Hospital located at 1100 Central Ave SE in order to replace landscaping that was accidentally disturbed during construction of a new hospital tower addition approved by the EPC on September 12, 2019 (Project #2019-002661).

This proposed amendment encompasses replacement of landscaping in several areas that include the following:

- 5,277 sf of streetscape landscaping along Silver Ave between Oak St to about 110 feet east of Mulberry St will be replaced
- 1,135 sf of streetscape landscaping along the west side of Mulberry St from Silver Ave to the driveway approximately 157 feet south of Silver Ave will be replaced
- 712 sf of streetscape landscaping along the east side of Mulberry St from Silver Ave to the driveway approximately 122 feet south of Silver Ave will be replaced
- 1,796 sf of interior landscape at the northeast corner of the energy center at Silver Ave and Mulberry St will be replaced
- 3,868 sf of interior landscape at the GI Lab parking lot at Silver Ave and Mulberry St will be replaced

The table below summarizes the changes that would result from the site plan modifications.

Comparison Item	Approved Plan	Proposed AA	Proposed Change	% Change
Total landscaping	42,502 sf	46,459 sf	3,957 sf	9.31

The requested landscaping replacements outlined above equate to a 9.31 percent change and therefore fall within the allowable 10% threshold for minor Administrative Amendments established in Table 6-4-5 which can be approved administratively by the Zoning Enforcement Officer (ZEO).

The proposed site plan amendment complies with all applicable standards of the IDO, the DPM, and other adopted city regulations per the review and decision criteria of Section 6-5(G)(3).

Based upon the rationale presented in this letter, we respectfully request administrative approval of the proposed Site Development Plan Amendment to facilitate the expansion of the Presbyterian Downtown campus. Upon completion, we feel that this project will contribute to the goals and growth policies of the Comprehensive Plan and ensure that Presbyterian is able to offer top quality healthcare services to the greater Albuquerque community. If you have any questions or need clarification of anything contained herein, please contact me at (505)761-9700.

Sincerely,

Will Gleason, AICP

Principal, Dekker Perich Sabatini

Agent for Presbyterian Healthcare Services

06 PREVIOUS APPROVED SITE PLAN

SIDEWALK RAMP (ARROW POINTS DOWN)

FIRE HYDRANT

T/C

LOCATION

ACCESSIBLE PARKING

TRASH COMPACTOR

SOLID WASTE MANAGEMENT

CODE ENFORCEMENT

DRE CHAIRPERSON, PLANNING DEPT.

EXISTING PARKING GARAGE - SOUTH

CENTRAL PLANT

NEW 3-STORY D&T ADDITION

NEW 8-STORY PATIENT TOWER

NEW PARKING GARAGE

TOTAL PREMISE BUILDING AREA

PERCENT CHANGE

262,213 S.F.

16,850 S.F.

1,569,615 S.F.

1,569,615 S.F. - 61,000 = 1,508,615 S.F.

2,750 S.F.

118,752 S.F.

214,690 S.F.

405,276 S.F.

741,468 S.F.

741,468/1,508,615 = 49%

- 60,697 S.F.

- 61,000 S.F.

4,430 S.F.

120,607 S.F.

125,037 S.F.

866,505/1,447,918 = 59.8%

ARCHITECTURE / DESIGN / INSPIRATION

PERICH SABATINI

505.761.9700 / DPSDESIGN.ORG

() 9 $\overline{\mathbf{m}}$ PRE SITE

Albuque

100

REVISIONS

DRAWN BY

REVIEWED BY DATE 10/14/2019 PROJECT NO. 19-0010.001

DRAWING NAME

SITE PLAN

1.06.19

DATE:


1.06.20

12.1.19

DATE:

DATE:

SHEET NO.

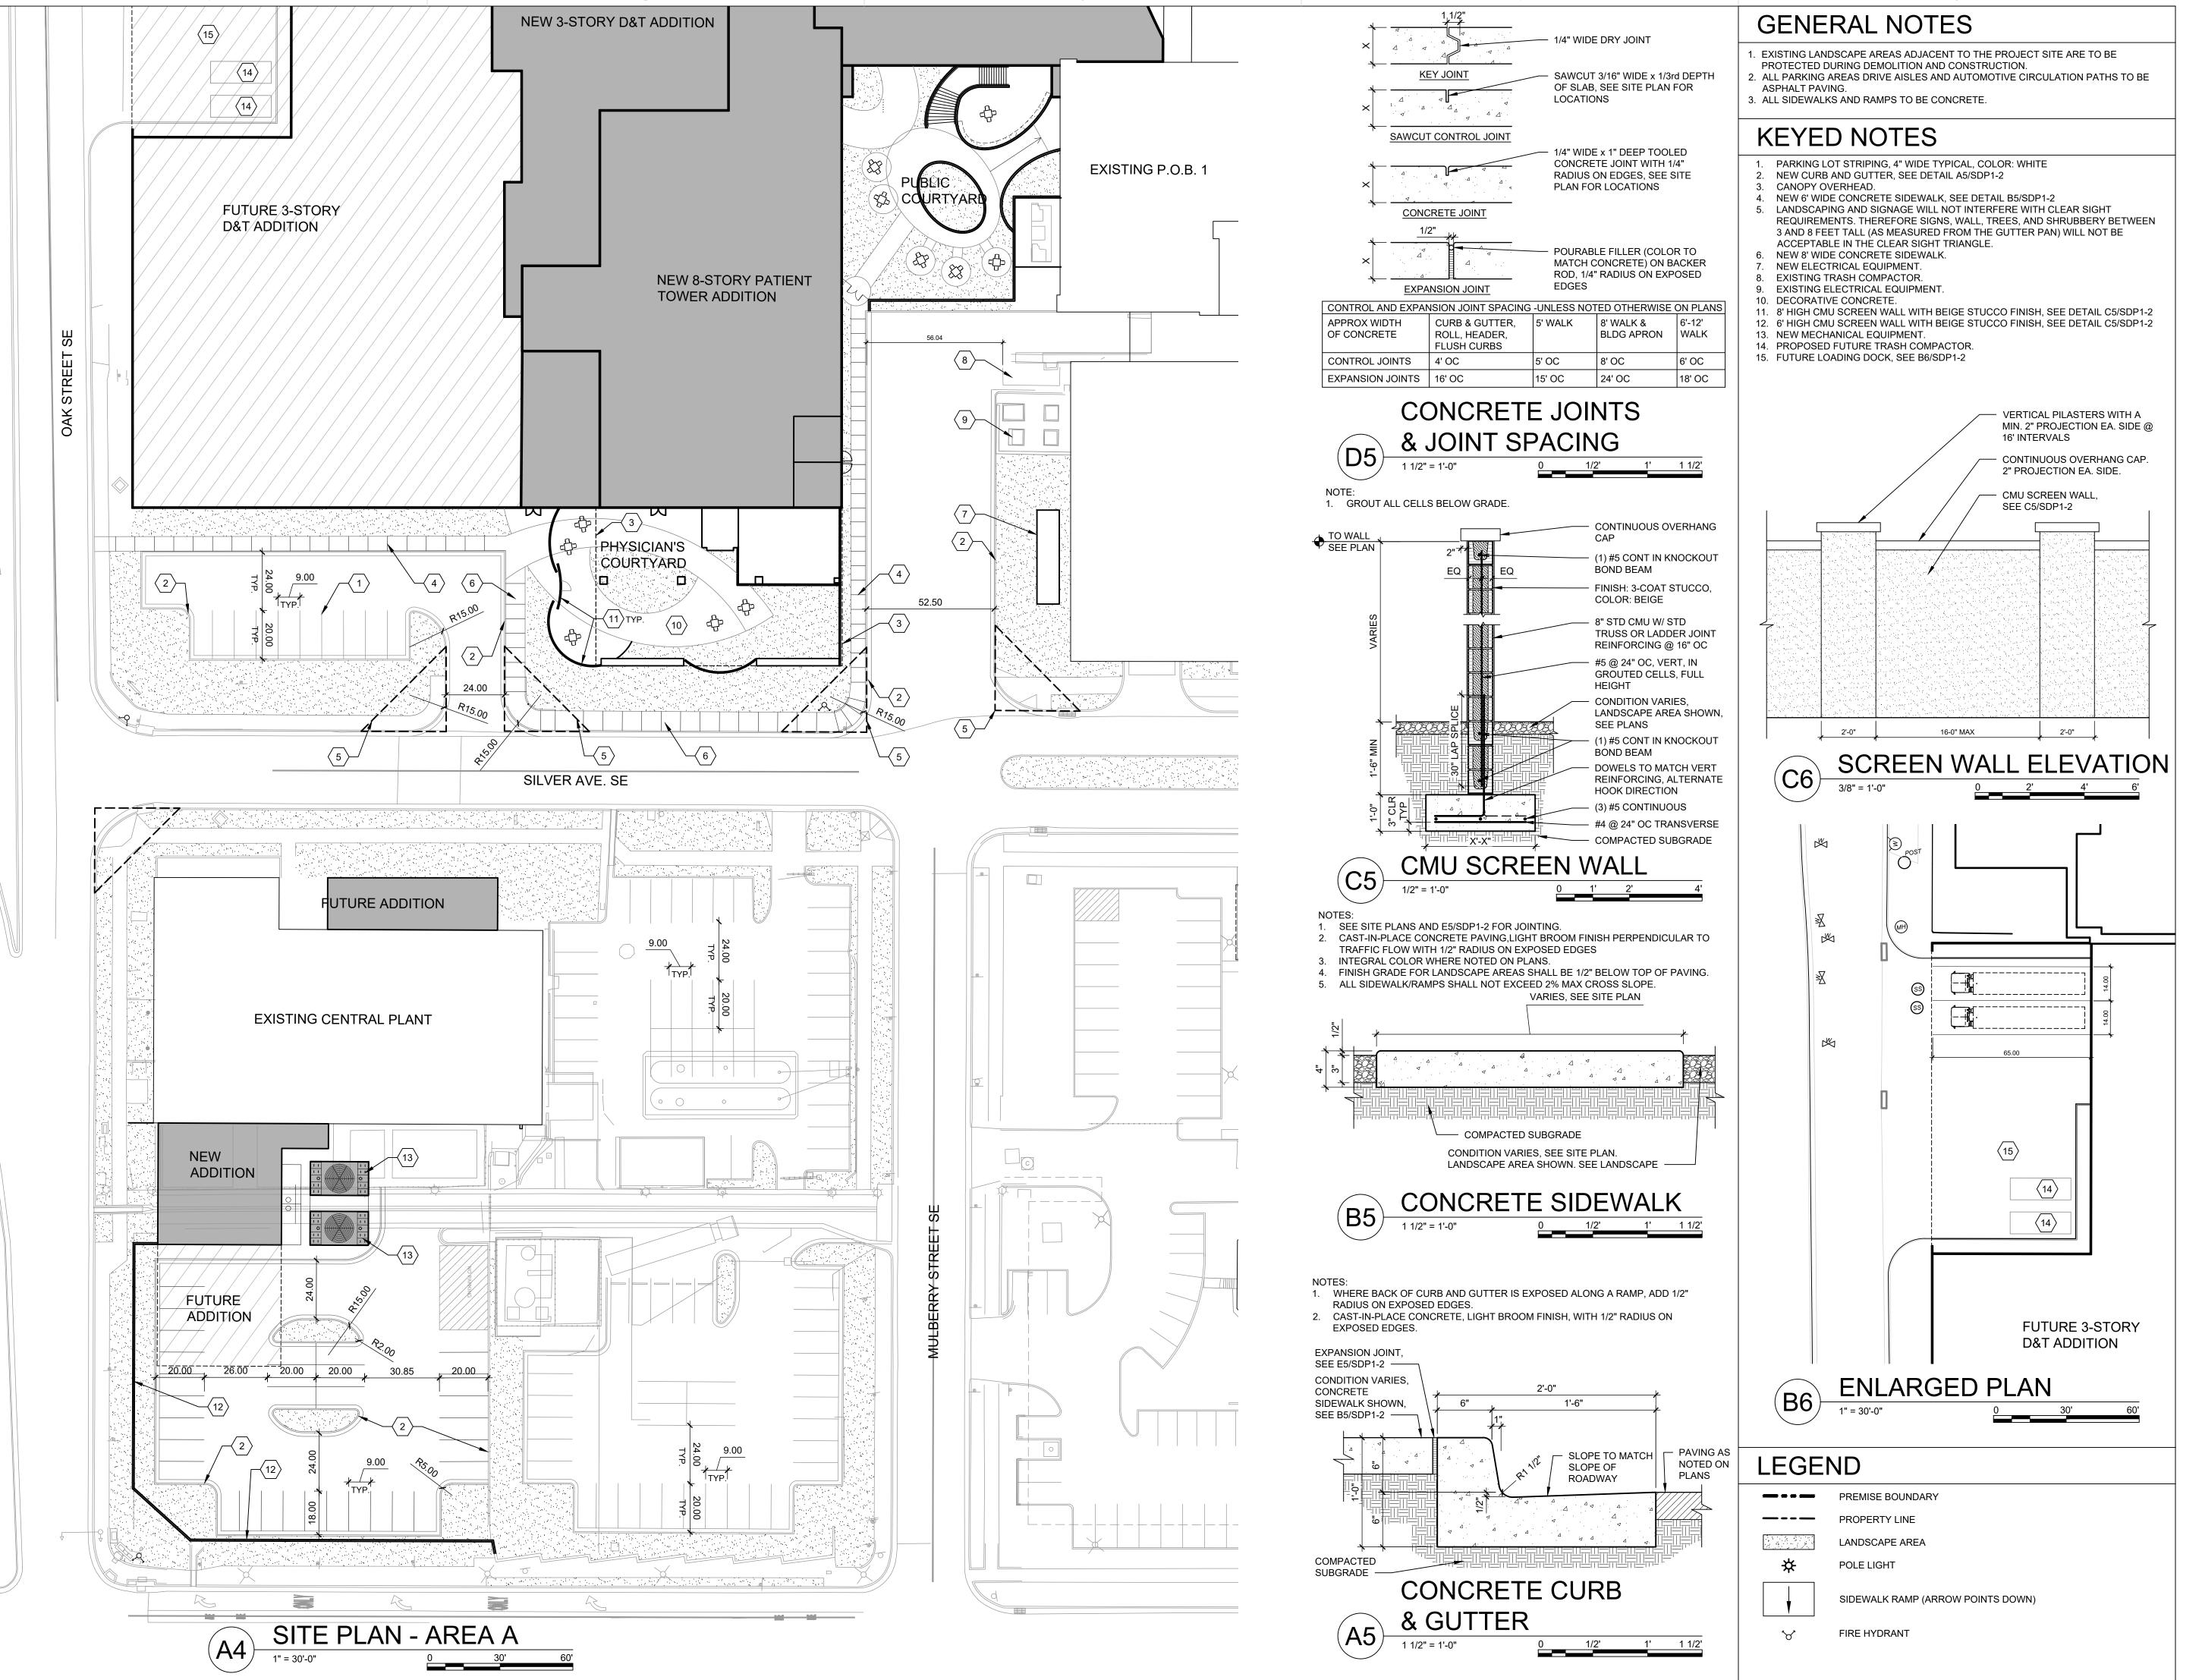

ARCHITECTURE / DESIGN / INSPIRATION

DEKKER PERICH SABATINI

7601 JEFFERSON NE, SUITE 100 ALBUQUERQUE, NM 87109

505.761.9700 / DPSDESIGN.ORG

SEAL

PROJECT

PRESBYTERIAN HOSPITAL
DEVELOPMENT PLAN FOR BUILDING PERMIT

1100 Central Ave SE

Albuquerqu


DRAWN BY
REVIEWED BY

DATE

DATE 10/14/2019
PROJECT NO. 19-0010.001
DRAWING NAME

SITE PLAN - AREA A

SDP1-2

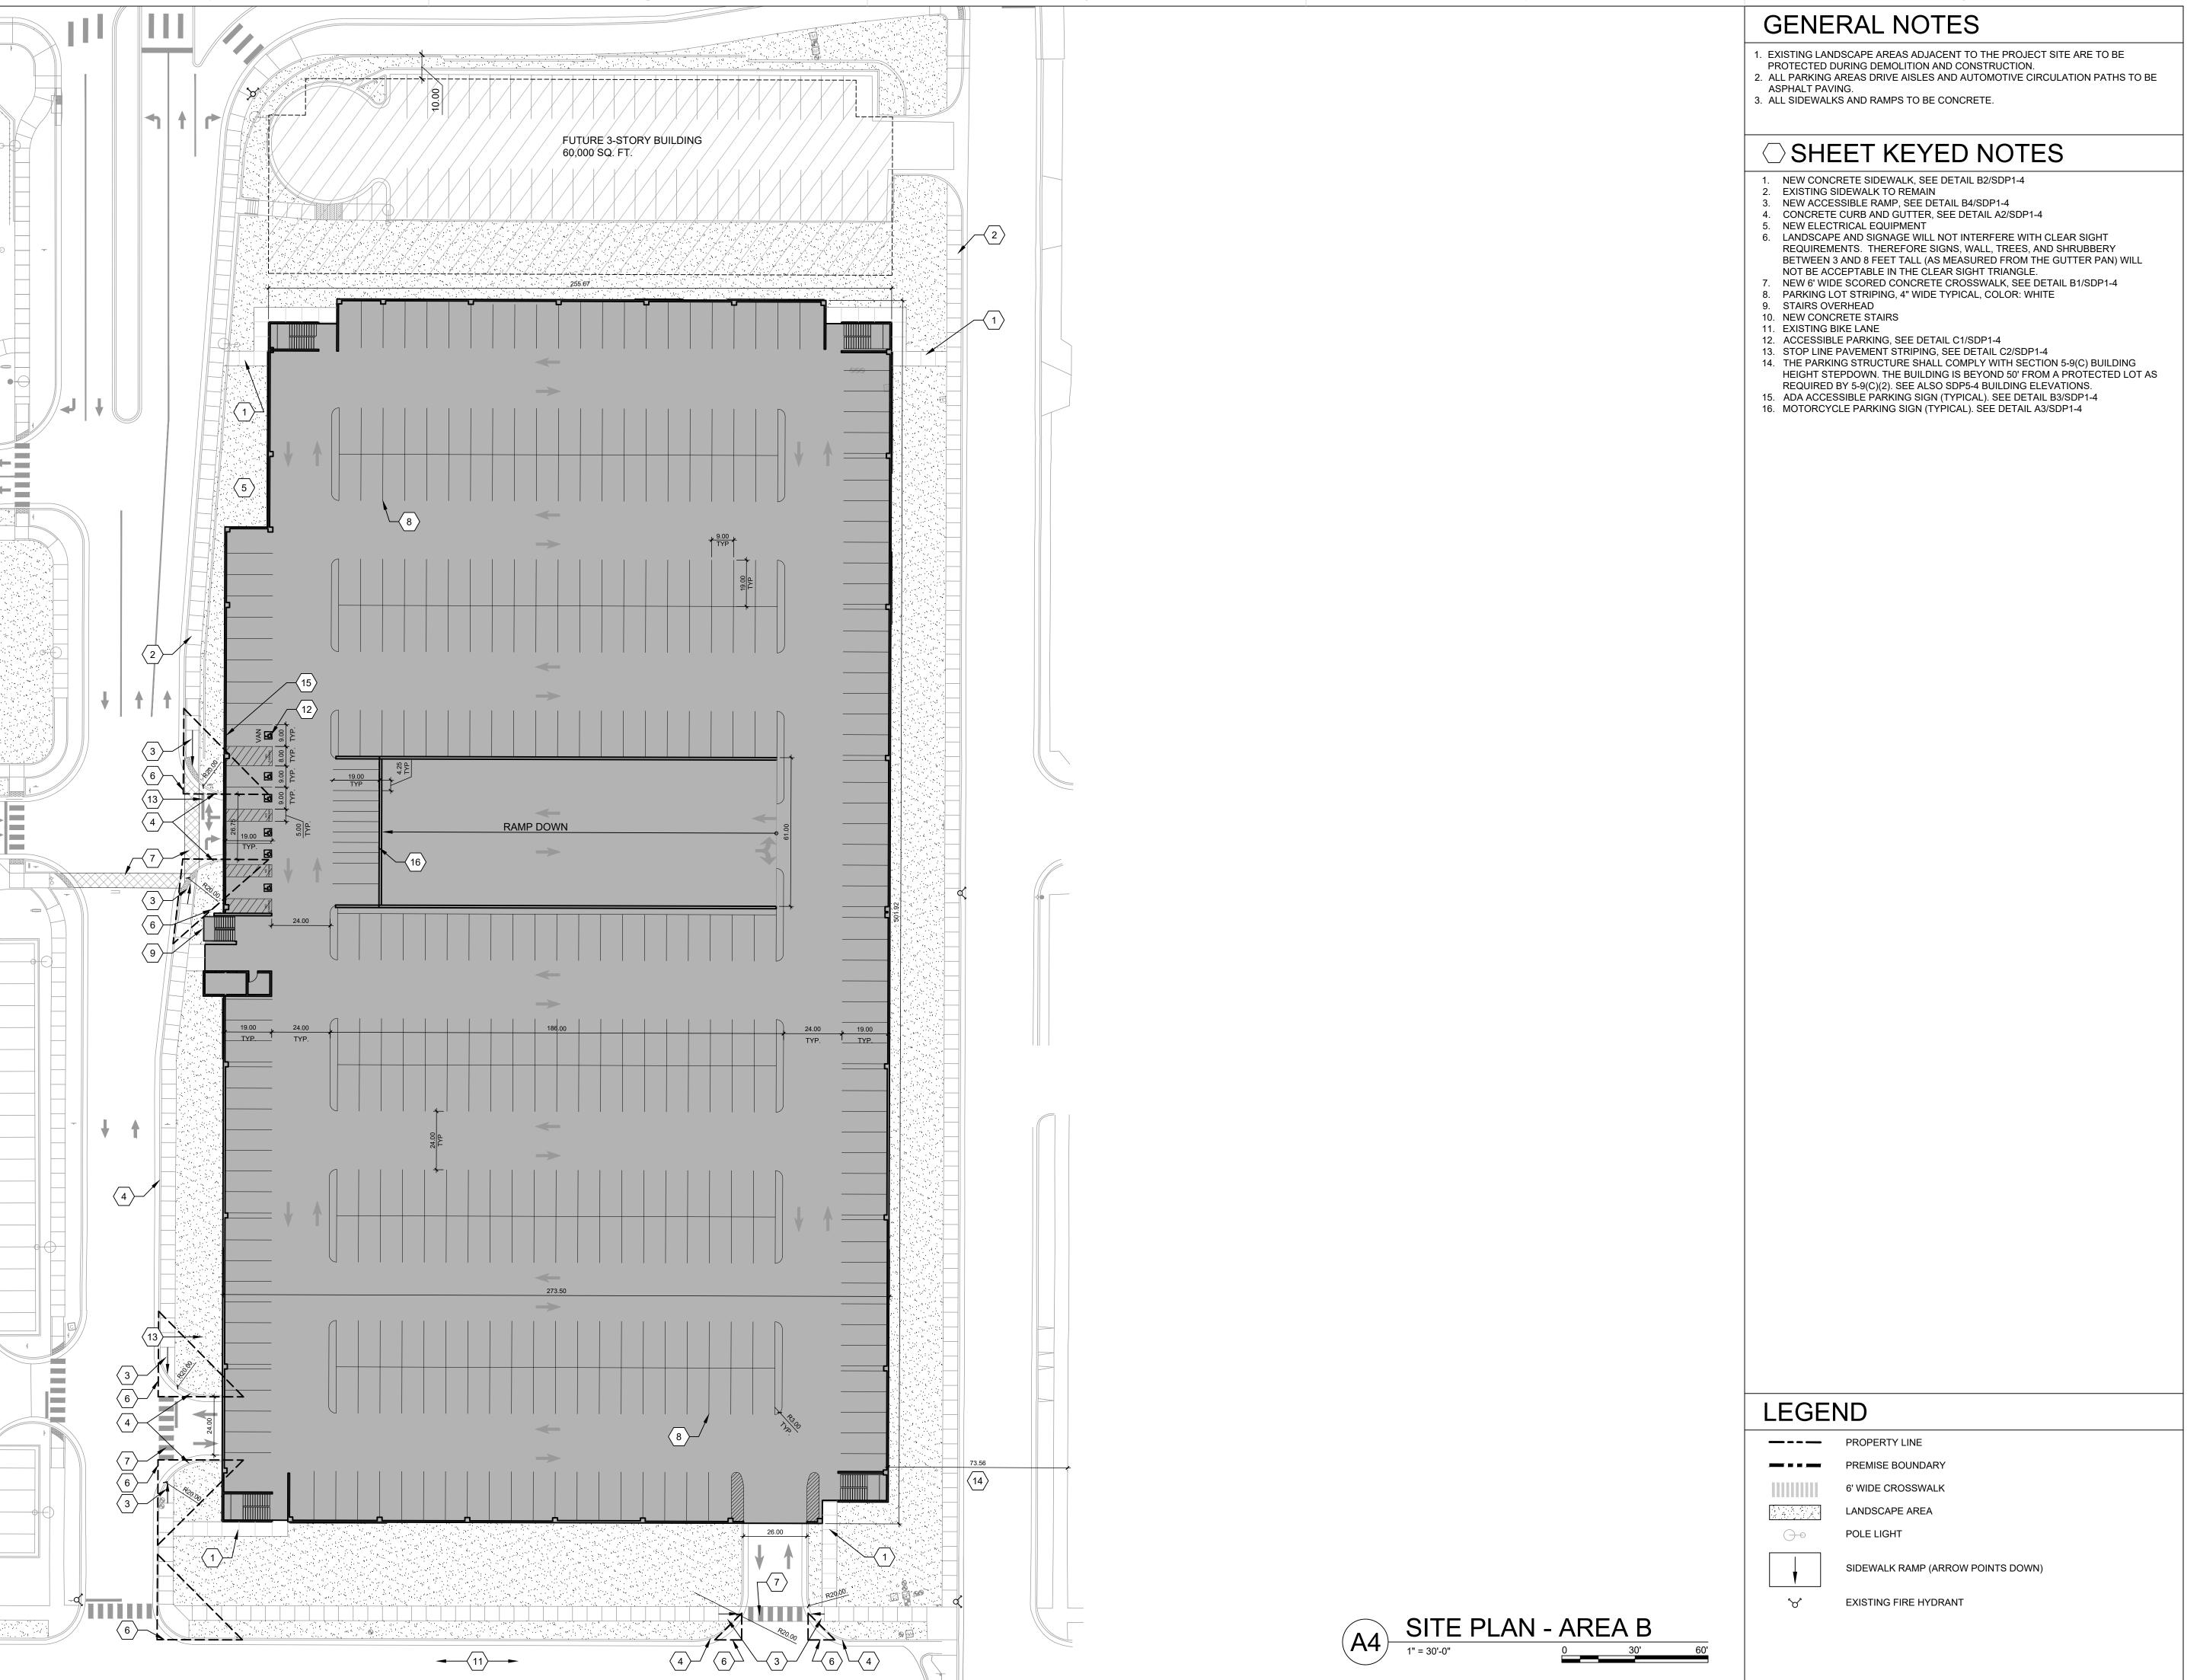

ARCHITECTURE / DESIGN / INSPIRATION

DEKKER
PERICH
SABATINI

7601 JEFFERSON NE, SUITE 100 ALBUQUERQUE, NM 87109

505.761.9700 / DPSDESIGN.ORG

PROJECT

PRESBYTERIAN HOSPITAL
TE DEVELOPMENT PLAN FOR BUILDING PERMIT 1100 Central Ave SE

REVISIONS

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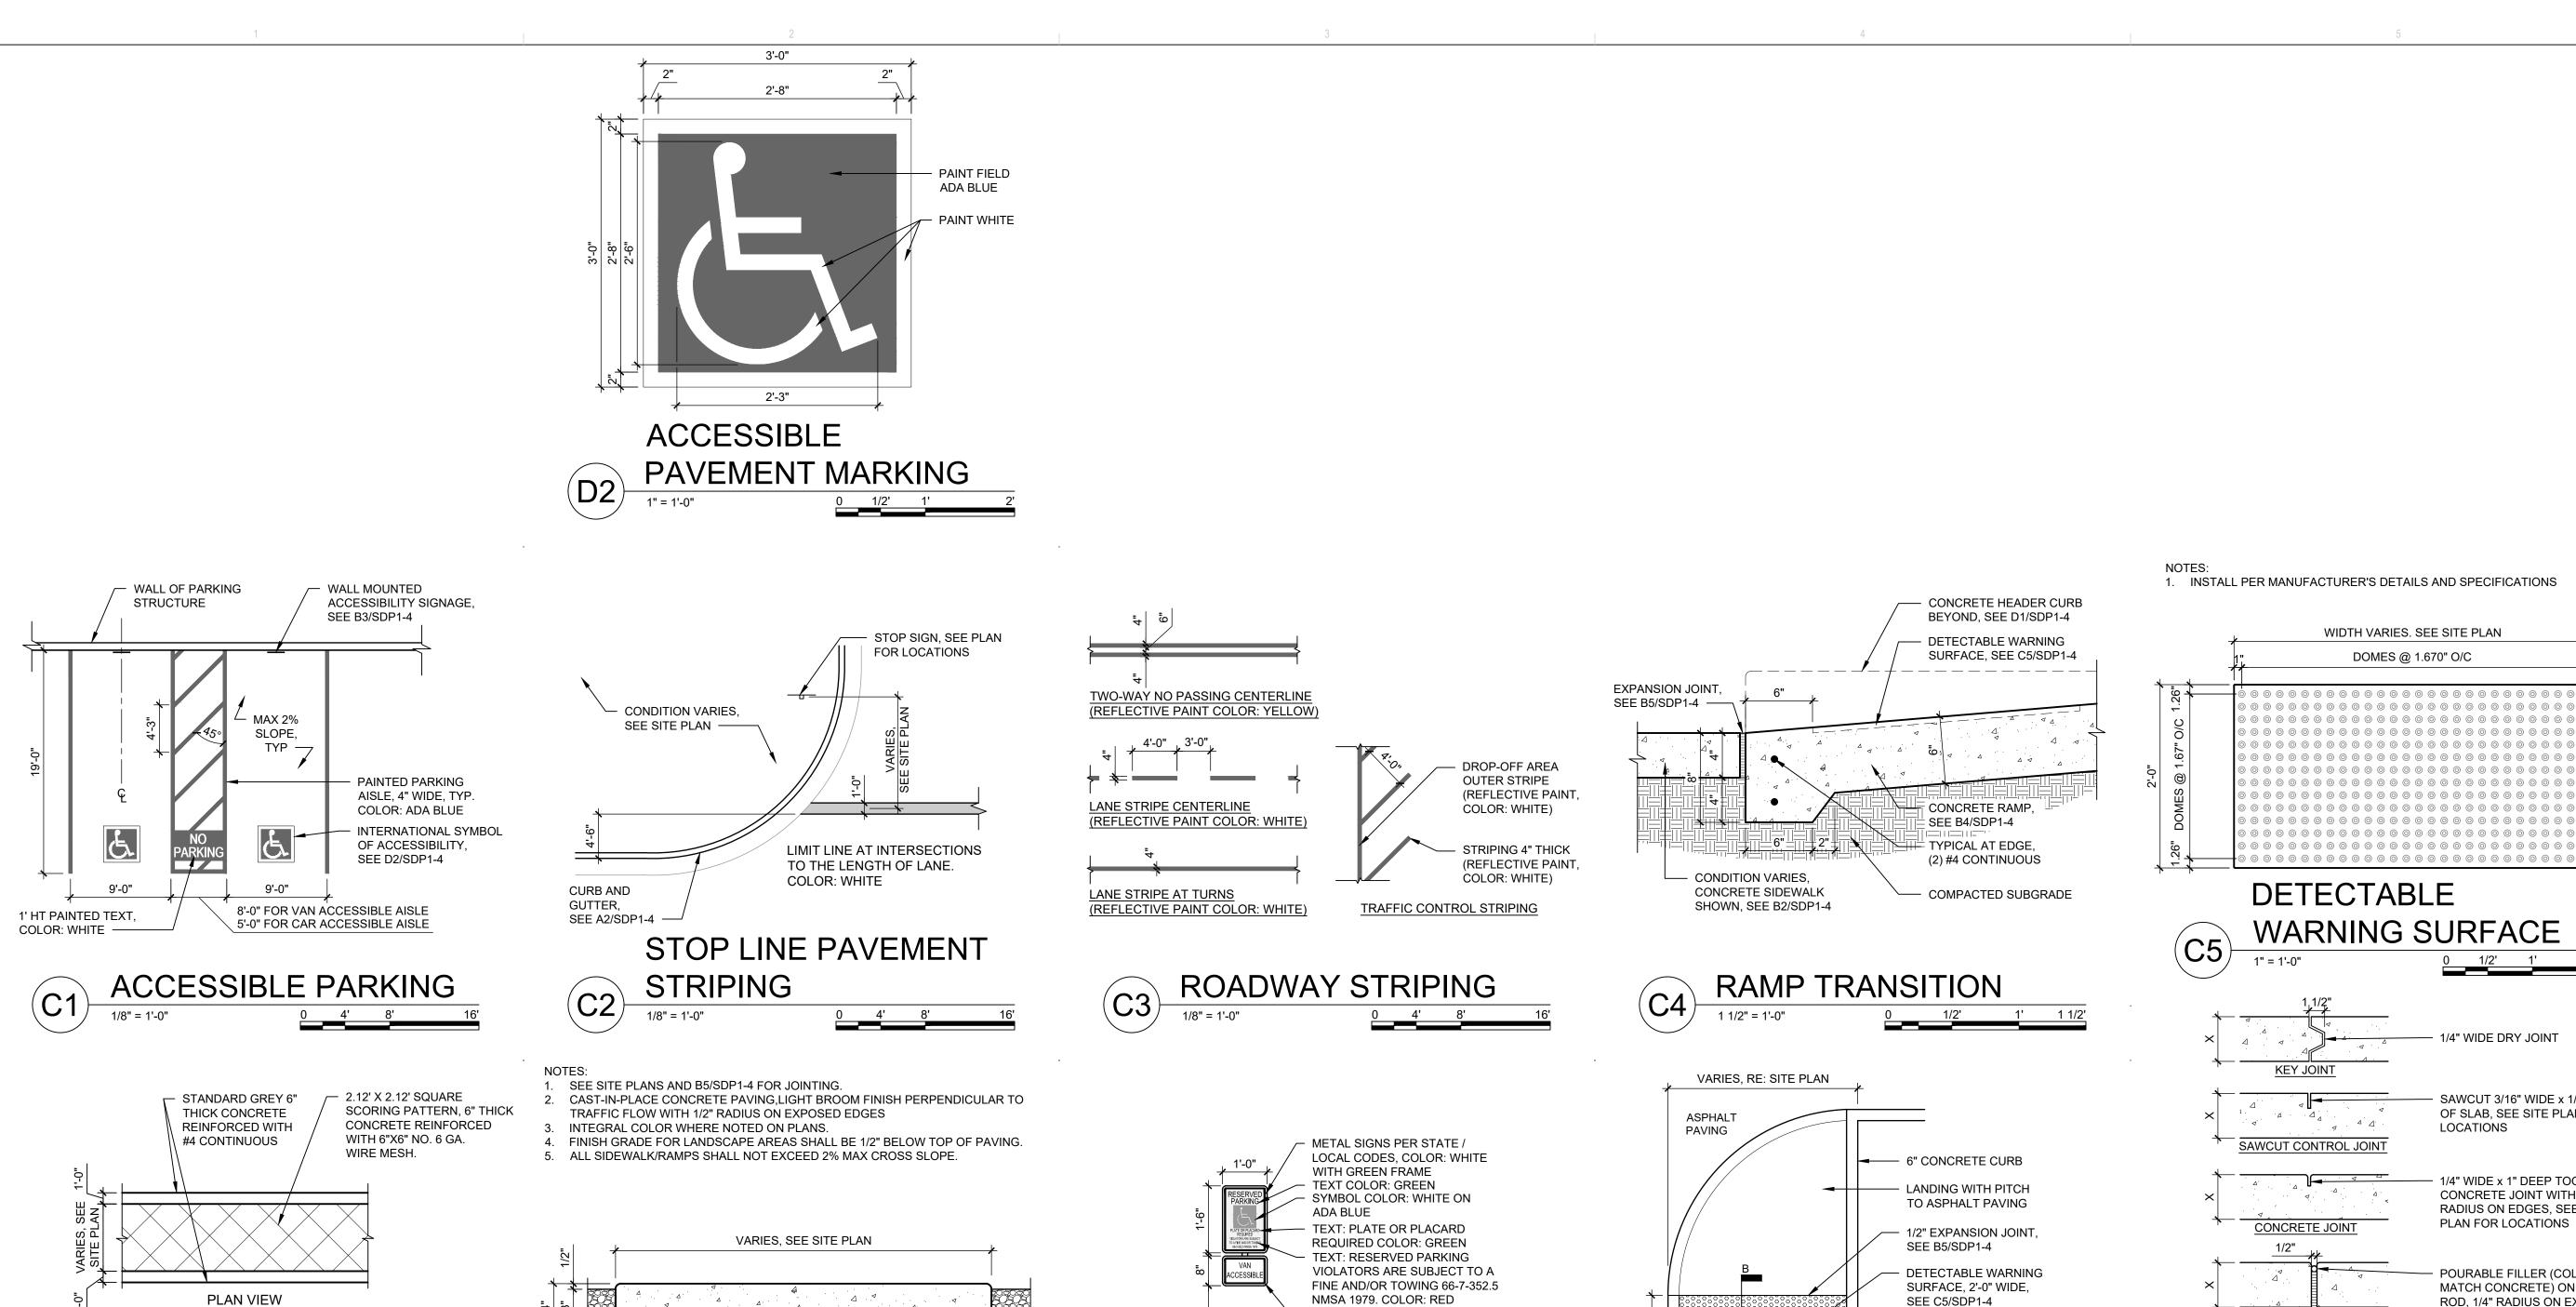
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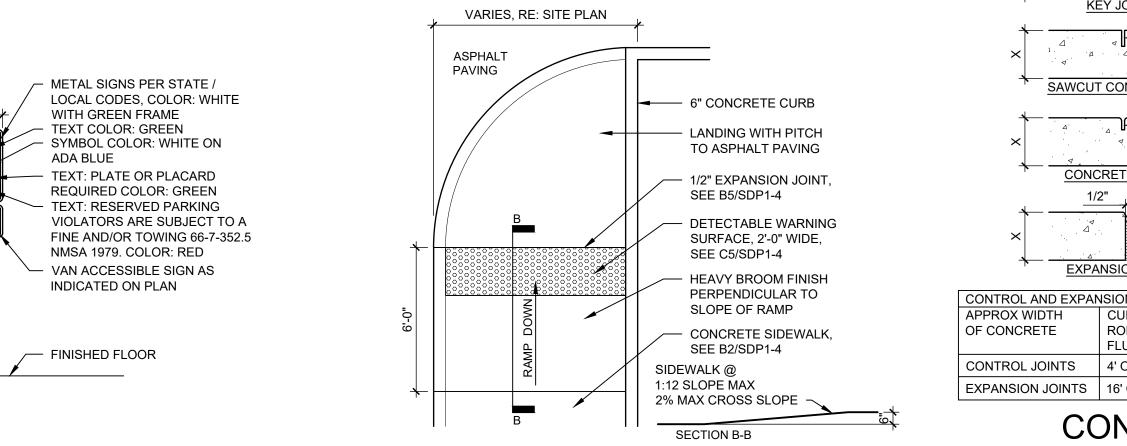
DATE

DATE 10/14/2019
PROJECT NO. 19-0010.001
DRAWING NAME


SITE PLAN - AREA B


SDP1-3






ACCESSIBLE RAMP

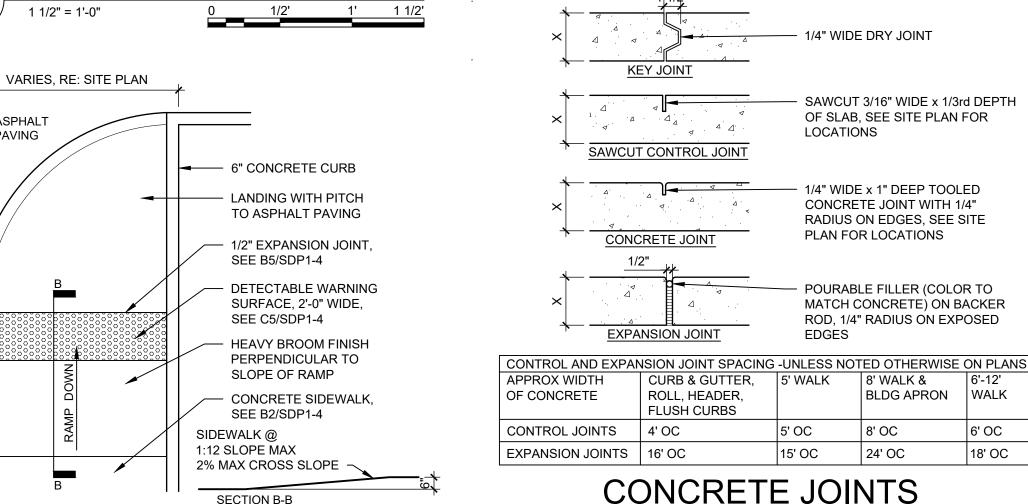

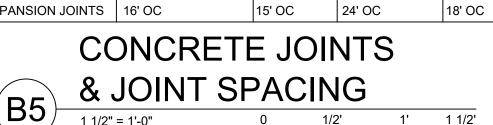


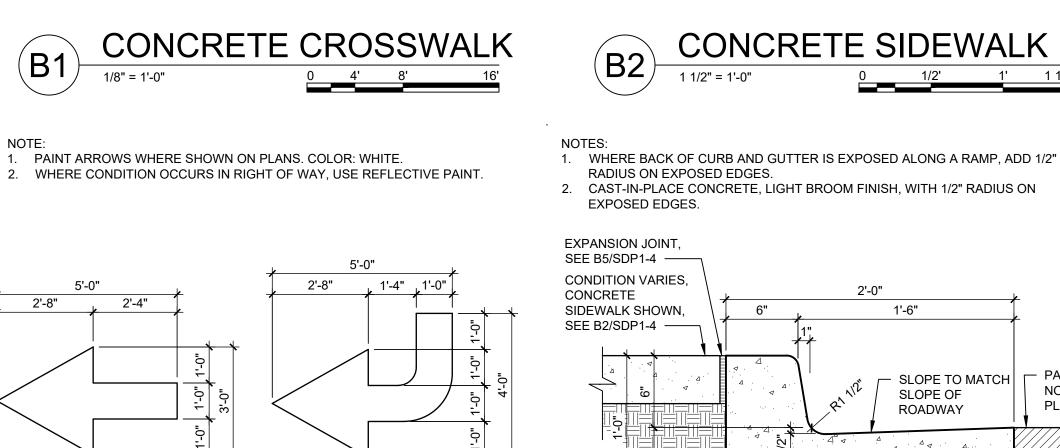

PATTERN GROOVE

DIRECTIONAL

PAVEMENT ARROW

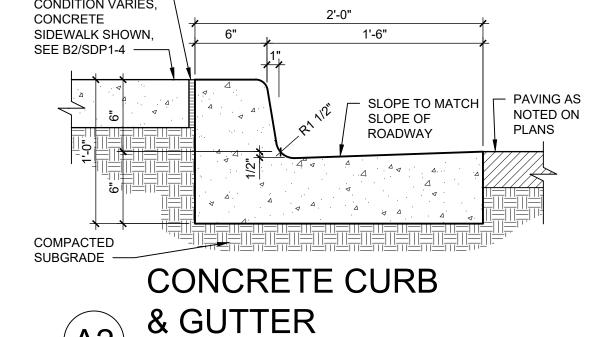


- COMPACTED SUBGRADE

CONDITION VARIES, SEE SITE PLAN.

LANDSCAPE AREA SHOWN.

SEE LANDSCAPE -

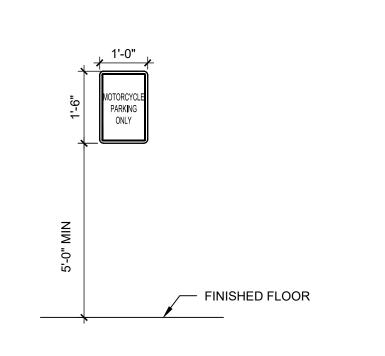




H.C. SIGN

1/2" = 1'-0"

(B3)

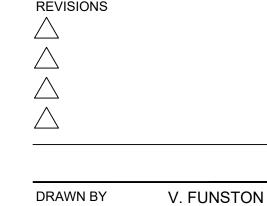

Albuque

100

ARCHITECTURE / DESIGN / INSPIRATION

DEKKER

PERICH

SABATINI

7601 JEFFERSON NE, SUITE 100 ALBUQUERQUE, NM 87109

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ARCHITECT


ENGINEER

PROJECT

PRE

DRAWN BY	V. FUNSTON
REVIEWED BY	A. SANTI
DATE	07/25/2019
PROJECT NO.	19-0010.001
DRAWING NAME	

SITE DETAILS

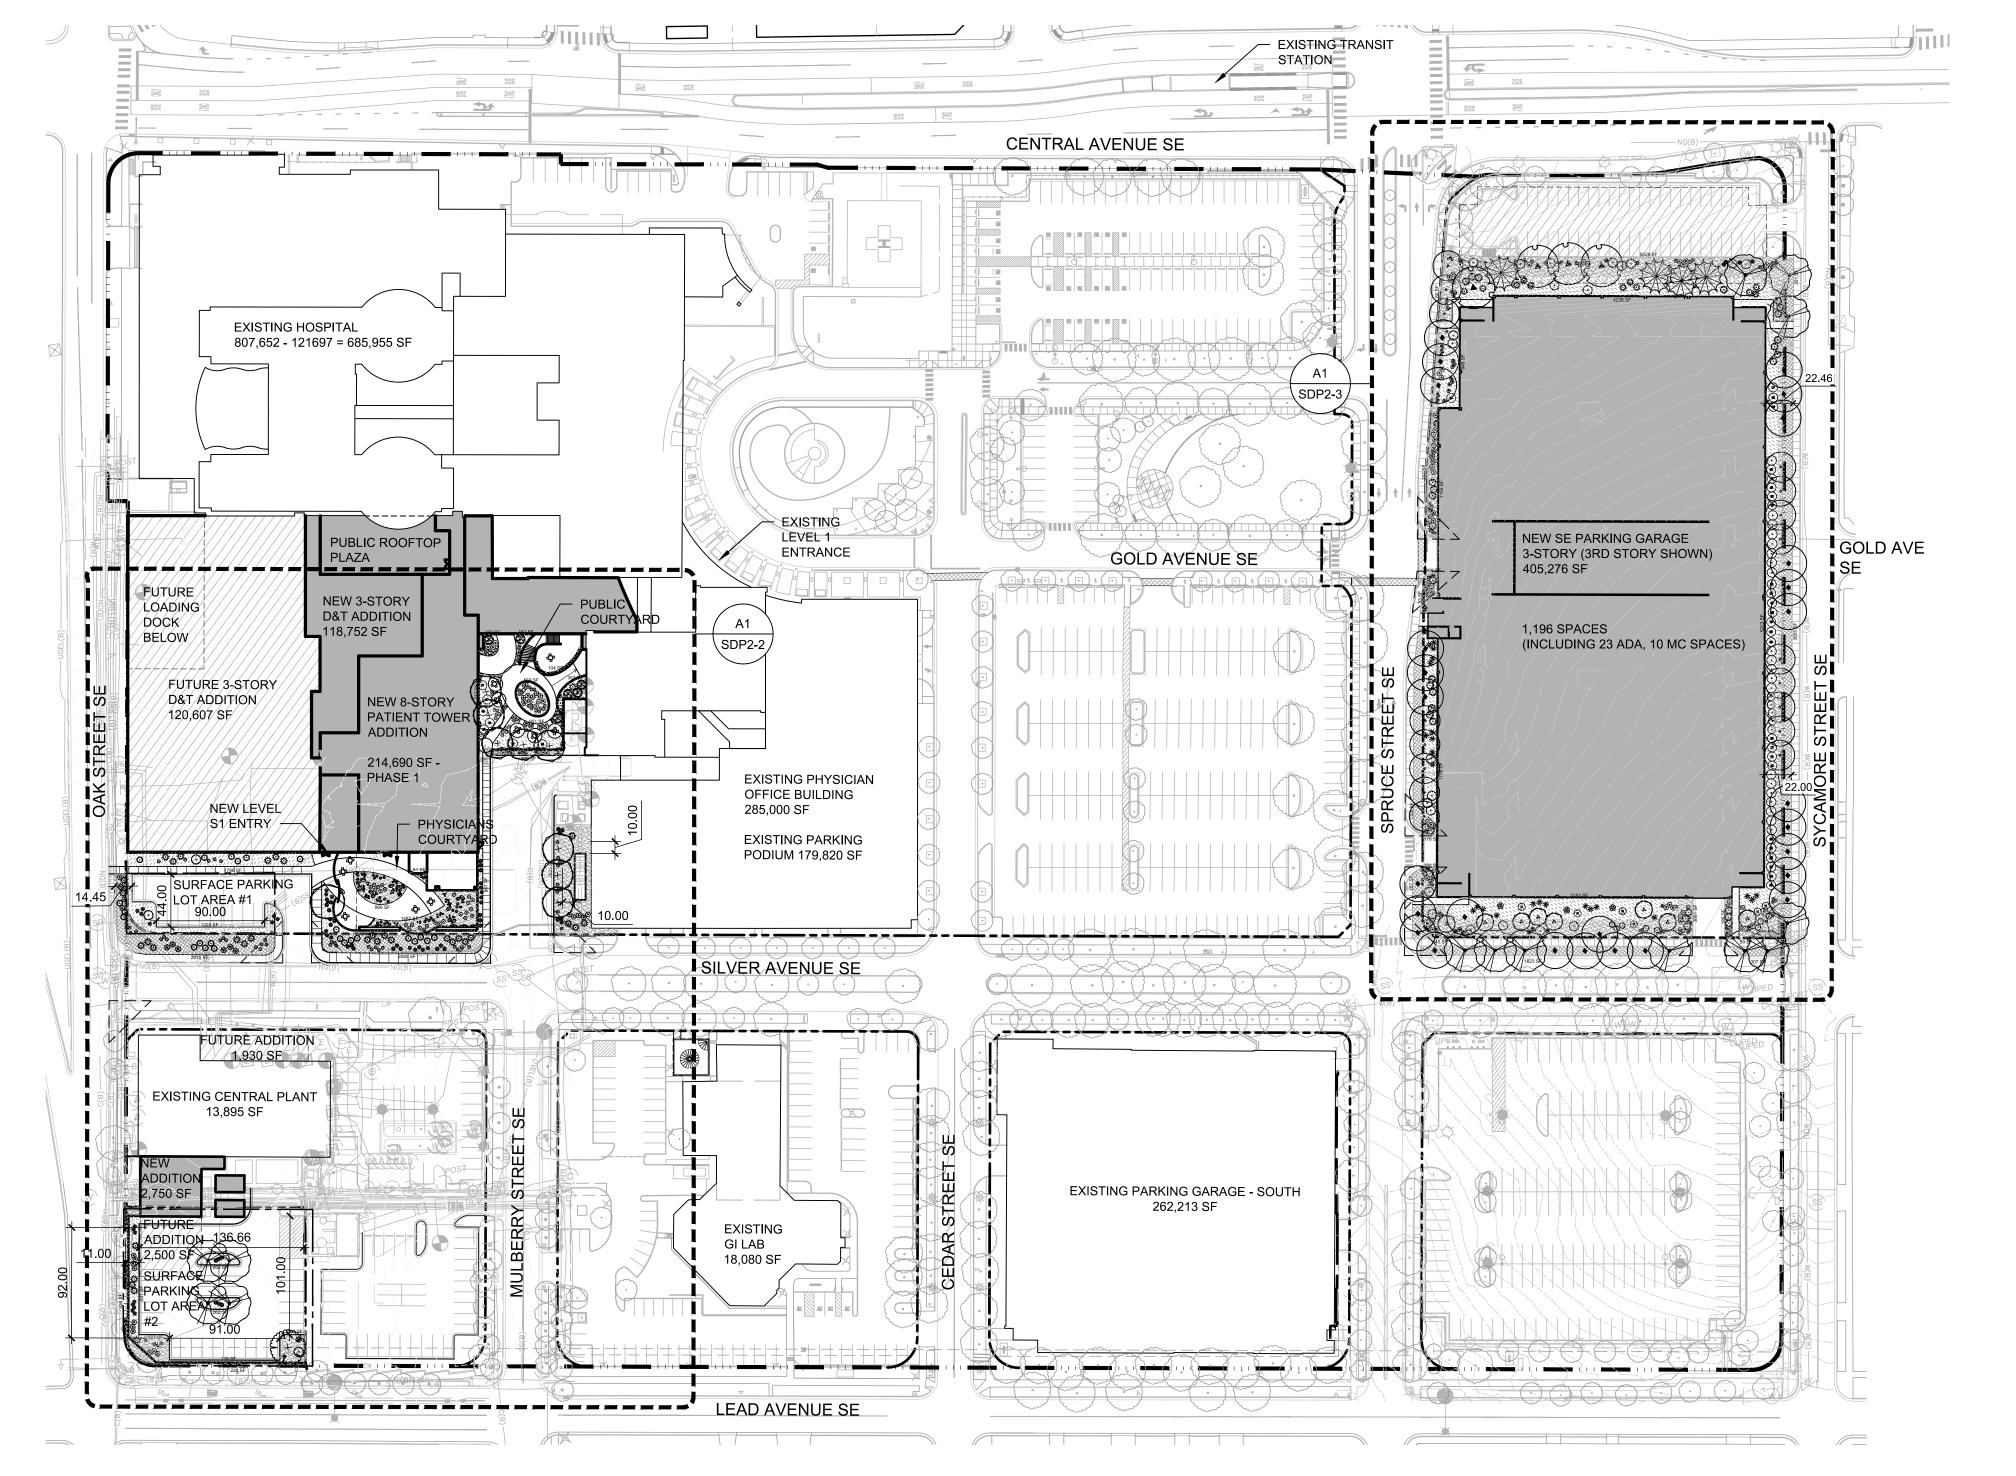

LANDSCAPE PLAN

GENERAL NOTES

- A. RESPONSIBILITY FOR MAINTENANCE: THE CONTRACTOR WILL BE RESPONSIBLE FOR MAINTENANCE OF THE LANDSCAPE DURING CONSTRUCTION AND DURING A 90 DAY-MAINTENANCE PERIOD FOLLOWING SUBSTANTIAL COMPLETION. THE OWNER WILL BE RESPONSIBLE FOR MAINTENANCE FOLLOWING THE 90-DAY MAINTENANCE
- STATEMENT OF COMPLIANCE WITH CITY OF ALBUQUERQUE: THE LANDSCAPE DESIGN WILL COMPLY WITH THE CITY OF ALBUQUERQUE'S GENERAL LANDSCAPING
- REGULATIONS AND WATER CONSERVATION ORDINANCES. TIMING OF LANDSCAPE INSTALLATION: INSTALLATION OF THE LANDSCAPING SHALL BE COMPLETE WITHIN 60 DAYS OF THE RELATED BUILDING'S OCCUPANCY. . SURFACE TREATMENT: ALL LANDSCAPE AREAS SHALL BE COVERED WITH MULCH.
- E. LANDSCAPE, FENCING, AND SIGNING WILL NOT INTERFERE WITH CLEAR SIGHT REQUIREMENTS. THEREFORE, SIGNS, WALLS, TREES, AND SHRUBBERY BETWEEN 3' AND 8' (AS MEASURED FROM THE GUTTER PAN) WILL NOT BE ACCEPTABLE IN THIS
- MINIMUM PLANT SIZES ARE AS PER CITY OF ALBUQUERQUE STANDARDS: 2" CALIPER TREES, 6' HEIGHT CONIFERS, AND 1 GALLON SHRUBS.
- 3. ALL AREAS DISTURBED DURING CONSTRUCTION, INCLUDING AREAS NOT WITHIN THE PROPERTY LINE, WILL BE STABILIZED.
- . ROOF DRAINS: SURFACE DRAINAGE OFF DOWNSPOUTS SHALL BE DIRECTED AWAY FROM BUILDINGS INTO LANDSCAPE AREAS OR ENGINEERED DRAINAGE SYSTEM. REFER TO CIVIL. VEGETATIVE SCREENING SURROUNDING GROUND-MOUNTED TRANSFORMERS AND
- UTILITY PADS SHALL ALLOW 10' OF CLEARANCE IN FRONT OF THE EQUIPMENT DOOR AND 5' OF CLEARANCE ON THE REMAINING SIDES FOR SAFE OPERATION AND MAINTENANCE
- . CONTRACTOR IS TO VERIFY ALL EXISTING UTILITY LOCATIONS BEFORE EXCAVATION
- AND PLANTING. . NEW PLANTINGS DO NOT INCLUDE HIGH WATER TURF.
- THE ABILITY TO PROVIDE STREET TREES IS LIMITED BY UTILITY EASEMENTS AND EXISTING UTILITIES.
- M. ORGANIC BARK MULCH IS PROVIDED AT EACH TREE FROM ROOT BALL EXTENDING OUT TO DRIPLINE PER CITY OF ALBUQUERQUE IDO 14-16-5-6(C)(5)(b) N. LANDSCAPE BEDS SHALL BE DEPRESSED BELOW ADJACENT SIDEWALK GRADE.

IRRIGATION NOTES

- ALL PLANTINGS SHALL BE IRRIGATED BY AUTOMATED IRRIGATION SYSTEMS, WITH PROGRAMMABLE SETTINGS, AUTOMATED SMART CONTROLLER, AND MOISTURE SENSOR TO AVOID OVERWATERING.
- 2. IRRIGATION TO EXISTING PLANTINGS TO REMAIN SHALL REMAIN OPERATIONAL. 3. THE IRRIGATION SYSTEMS SHALL NOT IRRIGATE IMPERVIOUS SURFACES, INCLUDING
- SIDEWALKS, DRIVEWAYS, STREETS AND PARKING OR LOADING AREAS. . IRRIGATION POINTS OF CONNECTION TO THE CITY WATER WILL BE LOCATED WITHIN PROPERTY LIMITS AND SHALL COMPLY WITH THE CITY OF ALBUQUERQUE REDUCED
- PRESSURE BACKFLOW PREVENTER STANDARDS AND SPECIFICATIONS. 5. RUN TIMES AND IRRIGATION ZONES SHALL BE BASED UPON PLANT SPECIES AND
- THEIR ESTABLISHMENT. RUN TIMES SHALL BE REGULARLY ADJUSTED ACCORDING TO PLANT MATURITY, SEASON, LOCATION AND PERFORMANCE.
- WHERE POSSIBLE NEW IRRIGATION WILL BE CONNECTED TO AN EXISTING SYSTEM. THERE ARE MULTIPLE IRRIGATION SYSTEMS ACROSS THE CAMPUS.
- IRRIGATION SYSTEM CONNECTIONS AND MAINLINES WILL BE LOCATED OUTSIDE OF
- 8. PER CITY OF ALBUQUERQUE STANDARD IRRIGATION SPECIFICATIONS, THERE WILL BE (3) 0.25 GPM BUBBLERS PER TREE AND (1) 0.25 GPM BUBBLER PER SHRUB.

LEGEND

PERVIOUS AREAS

<u>SYMBOL</u>

GRAVEL MULCH LANDSCAPE AREA

ORGANIC MULCH LANDSCAPE AREA

GRAVEL MULCH LANDSCAPE AREA IN R.O.W (EXCLUDED FROM LANDSCAPE CALCULATIONS)

*GRAVEL MULCH WILL NOT EXCEED 50% OF PLANTING BED COVERAGE PER CITY OF ALBUQUERQUE IDO 14-16-5-6(C)(5)(c)

EXISTING TREE TO REMAIN TABLE AND SEATING

PROPERTY LINE

CAMPUS BOUNDARY PARKING LOT BOUNDARY

LANDSCAPE CALCULATIONS

GROSS LOT AREA = 26.33 AC = 1,147,082 SF AREA OF LOT COVERED BY BUILDING FOOTPRINT = 536,715 SF NET LOT AREA = 610,367 SF

REQUIRED LANDSCAPE AREA = 61,037 SF (10% OF NET LOT AREA) EXISTING LANDSCAPE AREA = 156,093 SF LANDSCAPE BEING REMOVED = 47,341 SF

LANDSCAPE BEING ADDED = 45,608 SF PROVIDED LANDSCAPE AREA EXISTING TO REMAIN + NEW = 154,360 SF (25% OF NET LOT AREA) (see hatch legend for exclusions from landscape areas)

REQUIRED STREET TREES = 1 TREE PER 25' LINEAR FEET OF STREET FRONTAGE STREET TREES =

SCYAMORE STREET FRONTAGE = 567' TREES REQUIRED = 23 TREES PROVIDED = 23 SPRUCE STREET FRONTAGE = 569' TREES REQUIRED = 23

TREES PROVIDED = 17 (9 ADDITIONAL TREES SHOWN NORTH OF STRUCTURE) SILVER AVE FRONTAGE (NORTH SIDE, OAK TO MULBERRY) = 300' TREES REQUIRED = 12

TREES PROVIDED = 0, NEW UTILITY EASEMENT THROUGH THIS AREA SILVER AVE FRONTAGE (NORTH SIDE, SPRUCE TO SYCAMORE) = 300' TREES REQUIRED = 12 TREES PROVIDED = 12

SILVER AVE FRONTAGE (SOUTH SIDE, OAK TO MULBERRY) = 300' TREES REQUIRED = 12 TREES PROVIDED = 0 (1 EXISTING TREE TO REMAIN)

FOTAL VEGETATIVE COVER REQUIRED = 34,206 SF (75% OF NEW LANDSCAPE AREA) TOTAL VEGETATIVE COVER PROVIDED = 42,502 SF (94% OF NEW LANDSCAPE AREA)

TOTAL GROUND-LEVEL PLANT COVER REQUIRED = 11,402 SF (25% OF LANDSCAPE AREA) TOTAL GROUND-LEVEL PLANT COVER PROVIDED = 11,571 SF (25% OF LANDSCAPE AREA)

TOTAL ROCK MULCH COVER ALLOWED = 22,804 SF (50% OF LANDSCAPE AREA) TOTAL ROCK MULCH COVER PROVIDED = 22,448 SF (49% OF LANDSCAPE AREA)

SURFACE PARKING LOT AREA #1 TOTAL AREA = 6,247 SF TOTAL # OF SPACES = 10 TREE REQUIRED:1 TREES PROVIDED:1

SURFACE PARKING LOT AREA #2 TOTAL AREA = 20,411 SF TOTAL # OF SPACES = 33 TREE REQUIRED:4 TREES PROVIDED:5

PERICH

ARCHITECTURE / DESIGN / INSPIRATION

505.761.9700 / DPSDESIGN.ORG

ARCHITECT

ENGINEER

PROJECT

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Albuqu


REVISIONS

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DRAWN BY REVIEWED BY MB DATE 10/01/2019 PROJECT NO. 19-0010.001

LANDSCAPE PLAN

DRAWING NAME

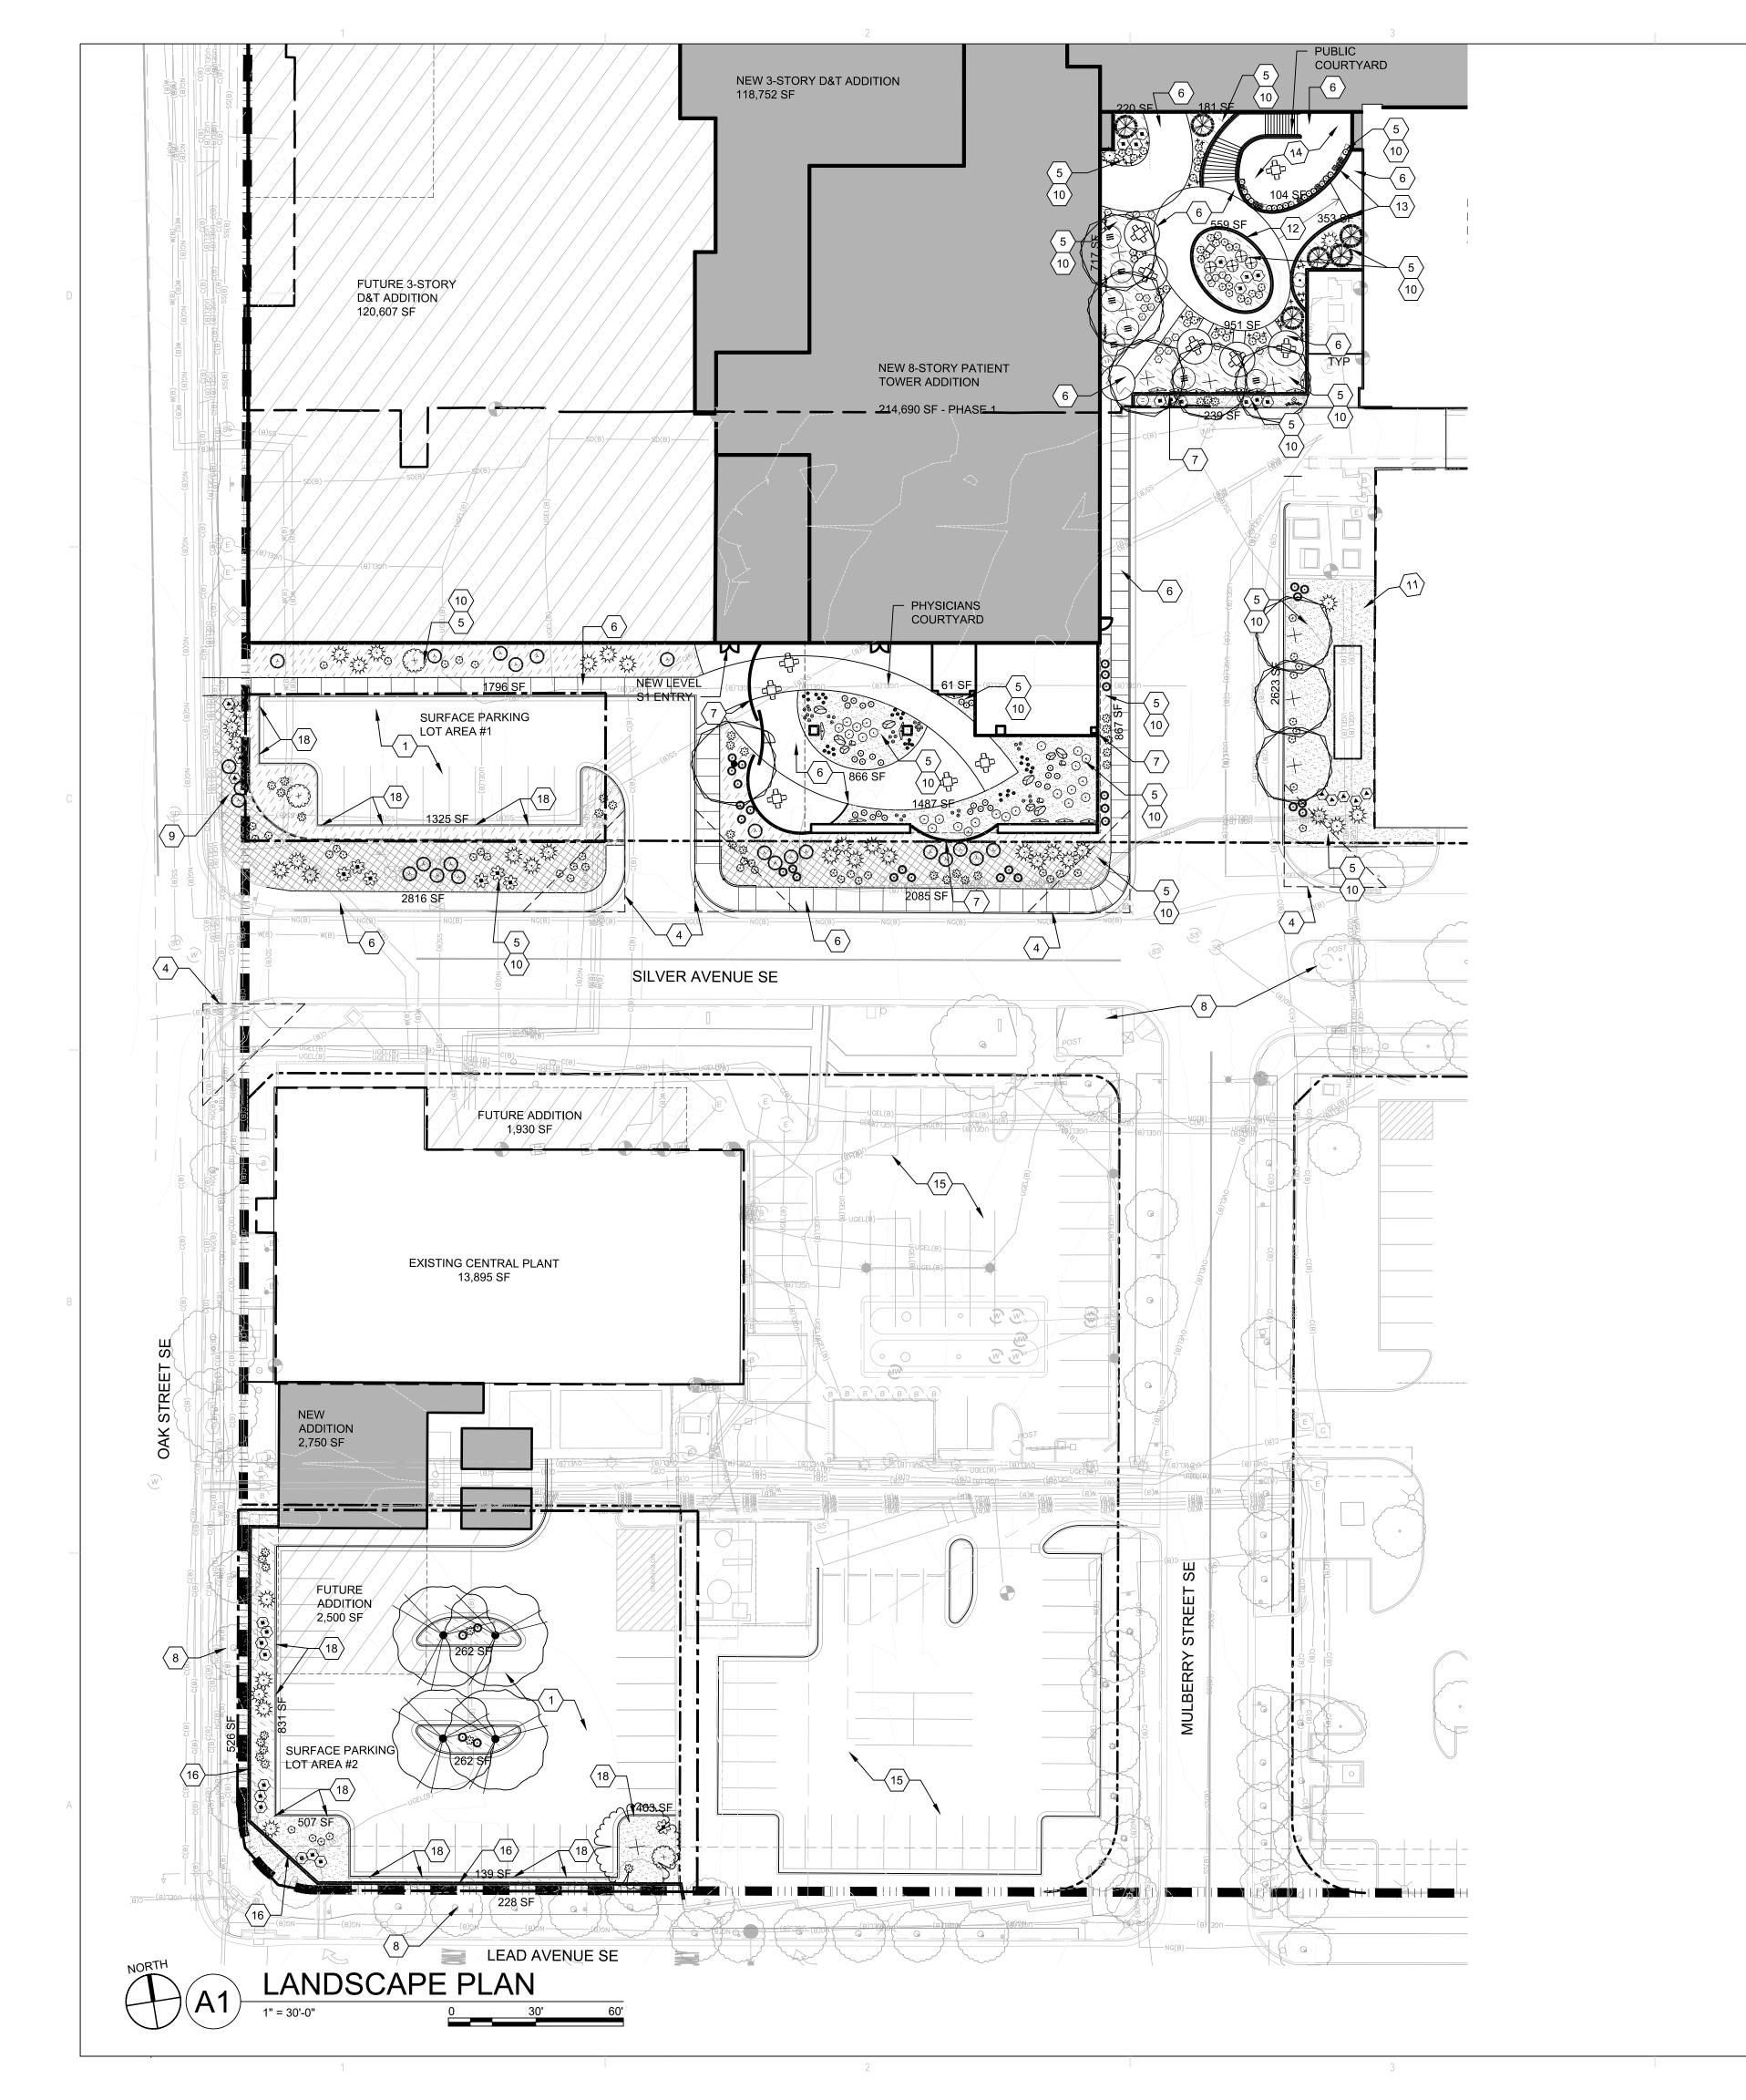

GENERAL NOTES

A. FOR MAINTENANCE STATEMENT AND IRRIGATION SYSTEM INFORMATION, SEE SDP 2-1.

B. MINIMUM PLANT SIZES ARE AS PER CITY OF ALBUQUERQUE STANDARDS: 2" CALIPER TREES, 6' HEIGHT CONIFERS, AND 1 GALLON SHRUBS.

○ SHEET KEYNOTES

9. NEW PLANTINGS FOR SCREENING / 1. SURFACE PARKING AREA 2. EXISTING EASEMENT BUFFERING

3. NEW EASEMENT 4. CLEAR SIGHT TRIANGLE 5. PERVIOUS AREA

6. IMPERVIOUS AREA 12. SEAT WALL 7. 6'-8' TALL SCREEN WALL OR FENCE W/ GATE
8. EXISTING PLANTINGS TO REMAIN
13.3' MAX LANDSCAPE RETAINING WALL
14.BALCONY WITH SEATING ABOVE AND B

15.EXISITING SURFACE PARKING LOT TO REMAIN 10.NEW PLANTING FOR GENERAL LANDSCAPING 16.SITE WALL FOR SCREENING

11. CLEARANCE AROUND GROUND MOUNTED 17.6' TALL VEGETATIVE BUFFER PER IDO COA IDO 14-16-5-6(E)2(b), BUFFER DESIGNED TO BE 75% OPAQUE AT MATURITY 18. CURB CUT, SEE D2/SDP2-1

14.BALCONY WITH SEATING ABOVE AND BELOW PLANT LEGEND **BOTANICAL NAME** COMMON NAME JUNIPERUS SCOPULORUM 'MOONGLOW' MOONGLOW JUNIPER ROBINIA PSEUDOACACIA 'PURPLE ROBE' PURPLE ROBE LOCUST ULMUS X 'ACCOLADE' ACCOLADE ELM ULMUS X 'FRONTIER' FRONTIER ELM ZELKOVA SERRATA 'GREEN VASE' GREEN VASE ZELKOVA COMMON NAME <u>SHRUBS</u> **BOTANICAL NAME** BACCHARIS X 'STARN' THOMPSON BROOM CARYOPTERIS X CLANDONENSIS BLUE MIST SHRUB CHAMAEBATIARIA MILLEFOLIUM **FERNBUSH ELAEAGNUS PUNGENS** SILVERBERRY ERICAMERIA NAUSEOSA CHAMISA JUNIPERUS SABINA 'BUFFALO' **BUFFALO JUNIPER** *ALL JUNIPER SPECIES TO BE FEMALE ONLY MAHONIA REPENS CREEPING MAHONIA ROSA BANKSIAE YELLOW LADY BANKS ROSE ROSMARINUS OFFICINALIS 'TUSCAN BLUE' TUSCAN BLUE ROSEMARY SALVIA GREGGII 'FURMANS RED' FURMAN'S RED SALVIA GRASSES **BOTANICAL NAME** COMMON NAME BOUTELOUA 'BLONDE AMIBITION' BLONDE AMBITION BLUE GRAMA CAREX APPALACHICA APPALACHIAN SEDGE HELICTOTRICHON SEMPERVIRENS **BLUE AVENA GRASS** SORGHASTRUM NUTANS INDIAN GRASS <u>PERENNIALS</u> **BOTANICAL NAME** COMMON NAME ANEMOPSIS CALIFORNICA YERBA MANSA AQUILEGIA CHRYSANTHA GOLDEN SPUR COLUMBINE ECHINACEA PURPUREA PURPLE CONEFLOWER LAVANDULA X INTERMEDIA 'GROSSO' GROSSO LAVENDER **COMMON NAME BOTANICAL NAME** HESPERALOE PARVIFLORA RED YUCCA NOLINA MICROCARPA **BEARGRASS** COMMON NAME <u>VINE</u> **BOTANICAL NAME** TRUMPET VINE CAMPSIS RADICANS **ENGLISH IVY** HEDERA HELIX **BOSTON IVY** PARTHENOCISSUS TRICUSPIDATA WISTERIA SINENSIS WISTERIA

LEGEND

<u>SYMBOL</u>

3/4"Ø ROCK MULCH

3" DEPTH OVER FILTER FABRIC

3/4"Ø ROCK MULCH AMARETTO BROWN 3" DEPTH OVER FILTER FABRIC IN R.O.W. NOT INCLUDED IN LANDSCAPE CALCULATIONS



SHREDDED SCREENED BARK MULCH

AMARETTO BROWN 3" DEPTH OVER FILTER FABRIC

EXISTING TREE TO REMAIN

PROPERTY LINE PARKING LOT BOUNDARY

TABLE AND SEATING CAMPUS BOUNDARY

PERICH SABATINI

ARCHITECTURE / DESIGN / INSPIRATION

7601 JEFFERSON NE, SUITE 100 ALBUQUERQUE, NM 87109

505.761.9700 / DPSDESIGN.ORG

ARCHITECT

ENGINEER

PROJECT

SPITAL 9 100 PRE

REVISIONS


DRAWN BY REVIEWED BY 10/01/2019

PROJECT NO. 19-0010.001 DRAWING NAME LANDSCAPE PLAN

MB

ENLARGMENT

SHEET NO.

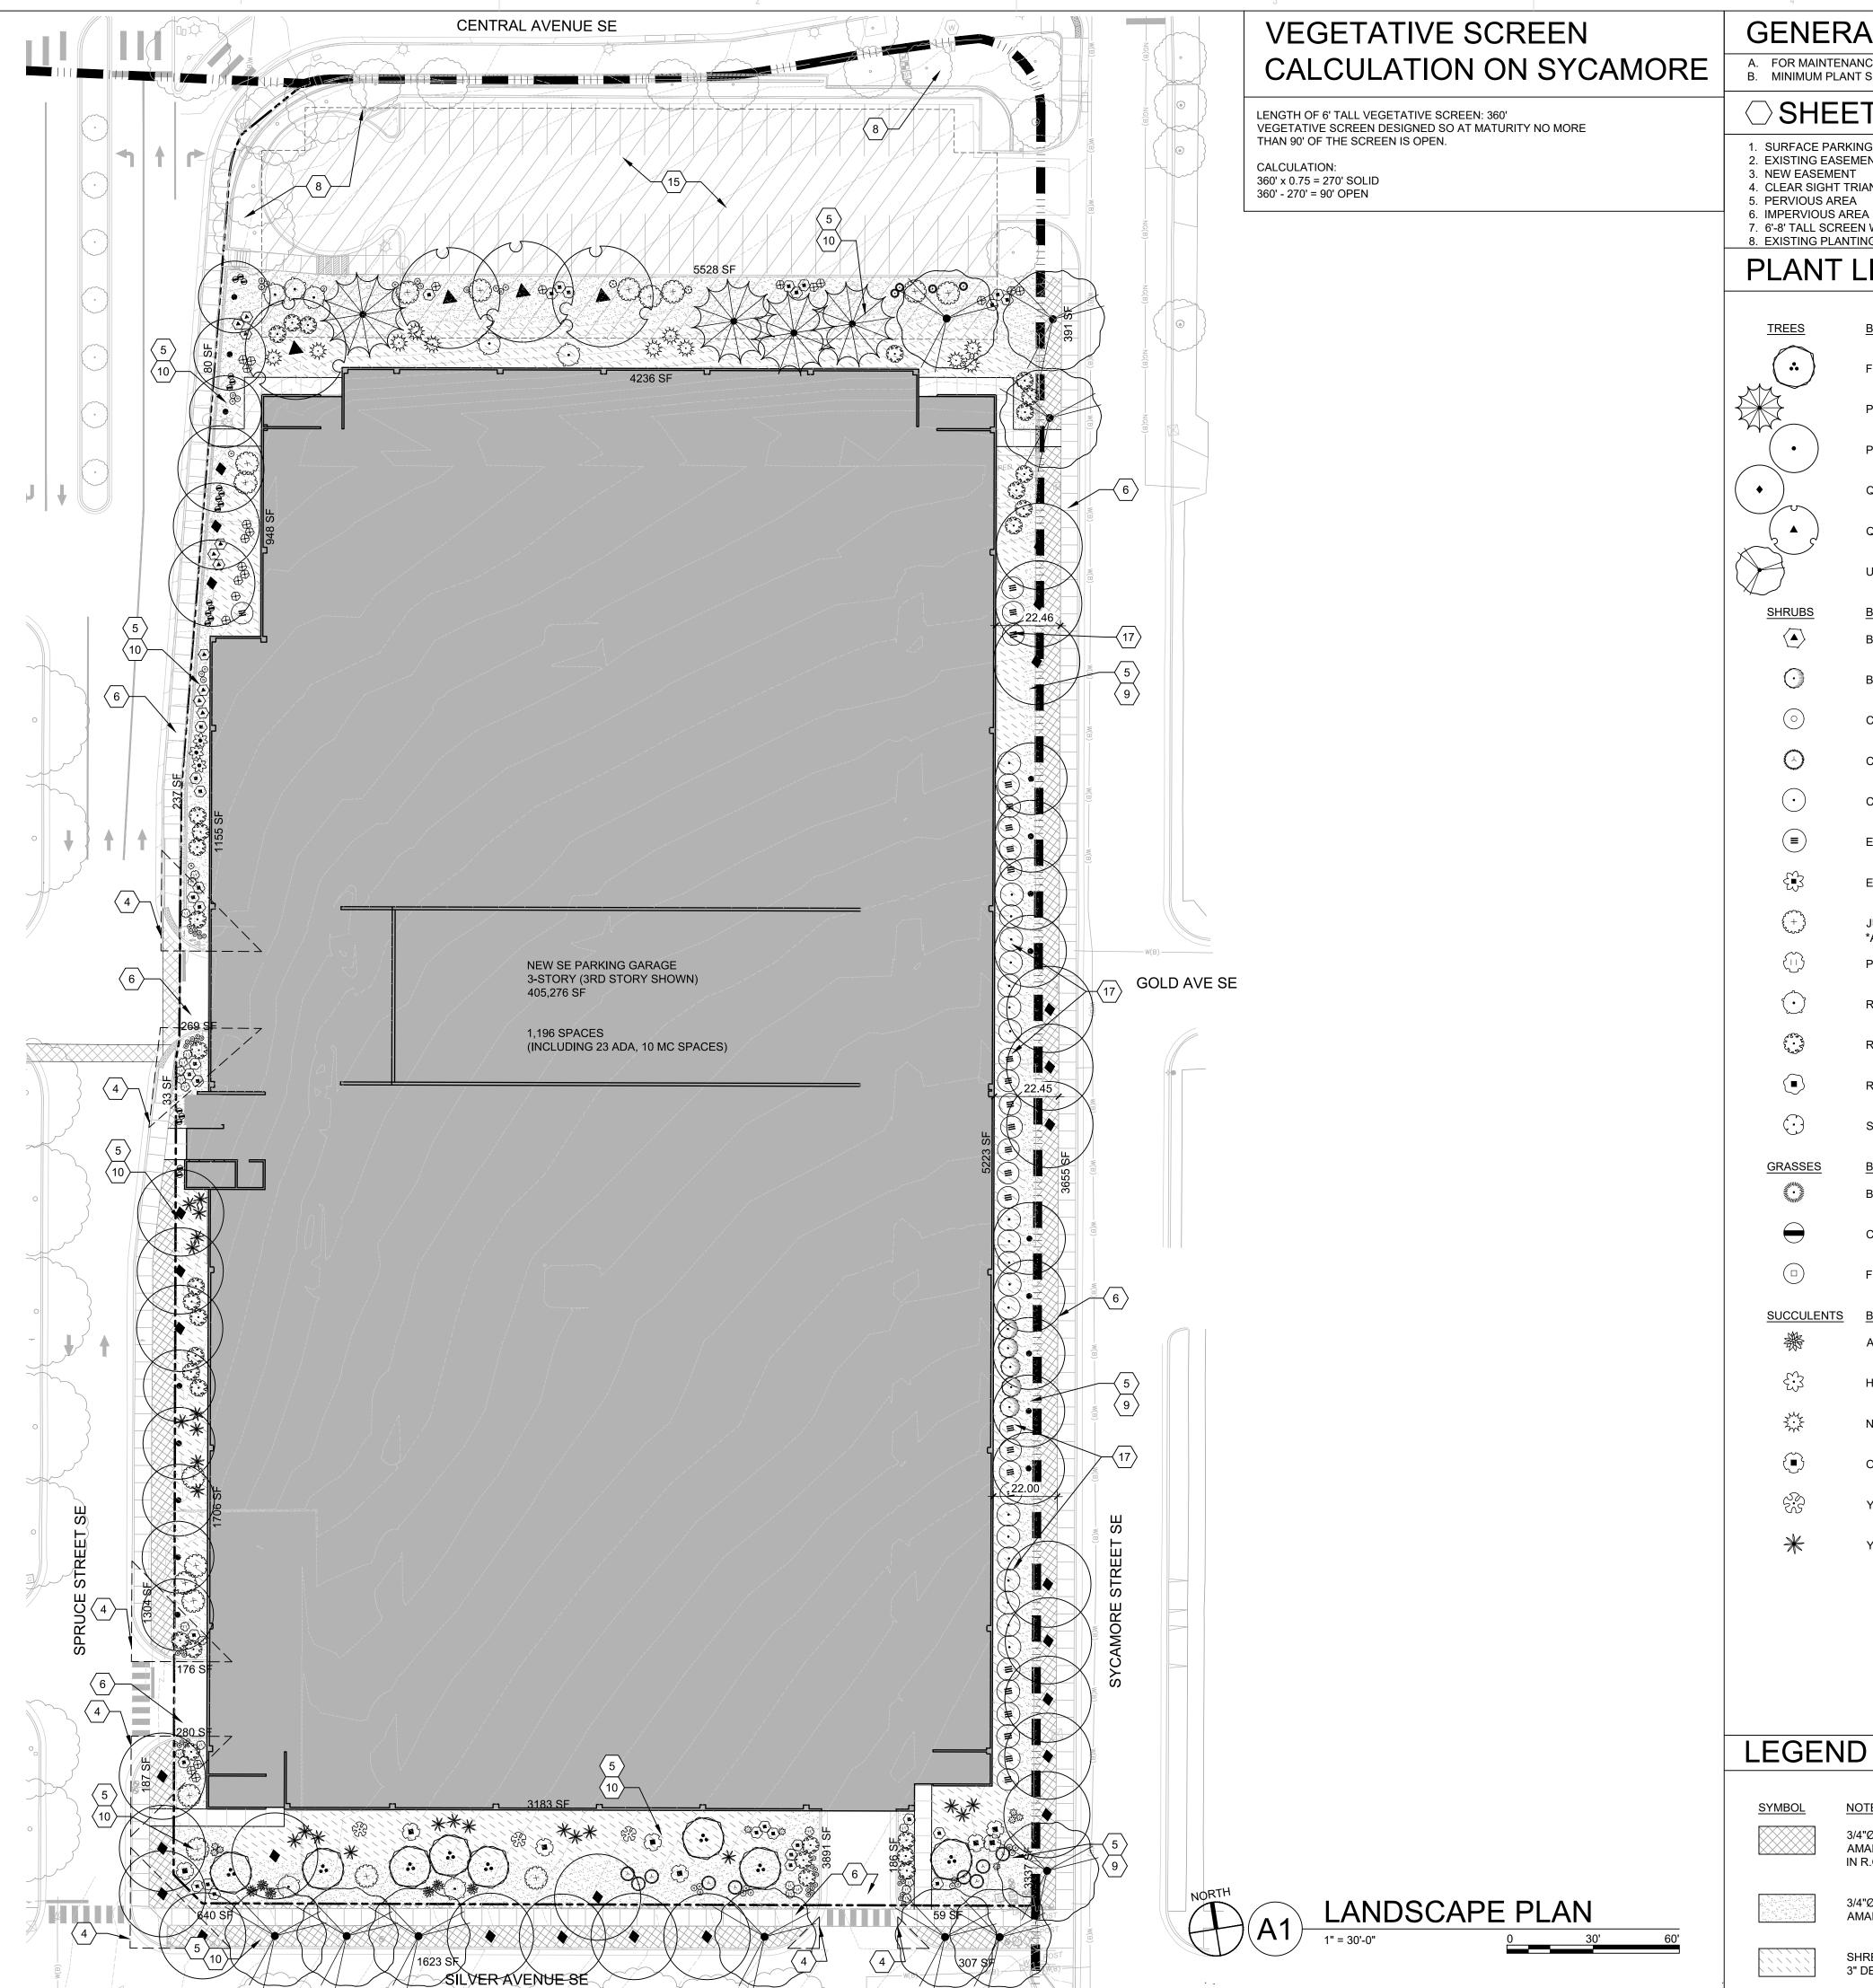

GENERAL NOTES


A. FOR MAINTENANCE STATEMENT AND IRRIGATION SYSTEM INFORMATION, SEE SDP 2-1. B. MINIMUM PLANT SIZES ARE AS PER CITY OF ALBUQUERQUE STANDARDS: 2" CALIPER TREES, 6' HEIGHT CONIFERS, AND 1 GALLON SHRUBS.

○ SHEET KEYNOTES

- 1. SURFACE PARKING AREA 9. NEW PLANTINGS FOR SCREENING / 2. EXISTING EASEMENT BUFFERING
- 4. CLEAR SIGHT TRIANGLE UTILITY 12. SEAT WALL 7. 6'-8' TALL SCREEN WALL OR FENCE W/ GATE 13.3' MAX LANDSCAPE RETAINING WALL 8. EXISTING PLANTINGS TO REMAIN 14.BALCONY WITH SEATING ABOVE AND B
- REMAIN 10.NEW PLANTING FOR GENERAL LANDSCAPING
 11.CLEARANCE AROUND GROUND MOUNTED
 17.6' TALL VEGETATIVE BUFFER PER IDO COA
- IDO 14-16-5-6(E)2(b), BUFFER DESIGNED TO BE 75% OPAQUE AT MATURITY 18. CURB CUT, SEE D2/SDP2-1 14. BALCONY WITH SEATING ABOVE AND BELOW

15.EXISITING SURFACE PARKING LOT TO

PLANT LEGEND

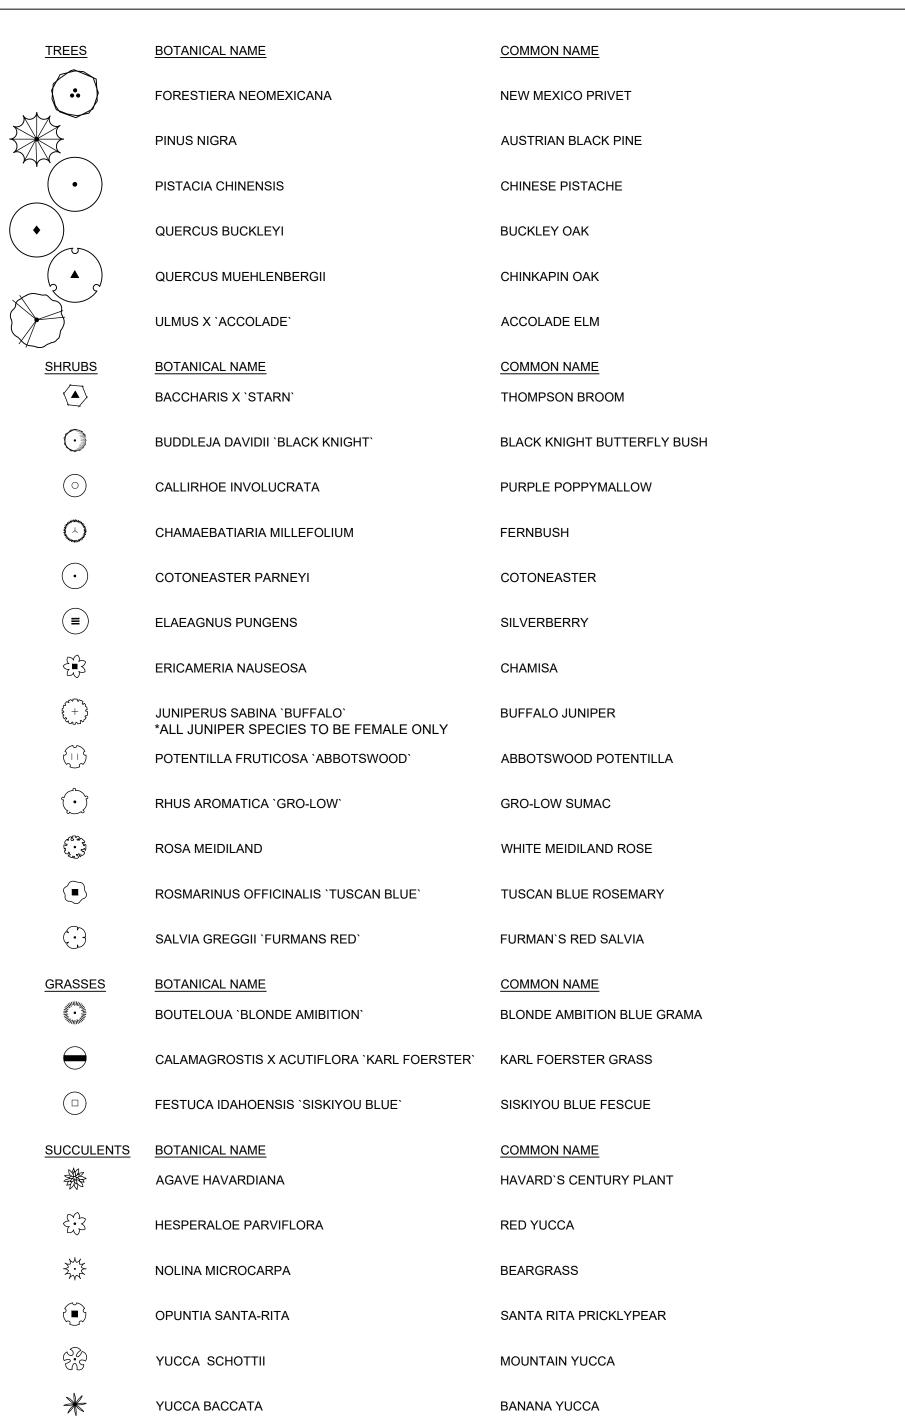


LEGEND

<u>NOTES</u>

3/4"Ø ROCK MULCH AMARETTO BROWN 3" DEPTH OVER FILTER FABRIC IN R.O.W. NOT INCLUDED IN LANDSCAPE CALCULATIONS

3/4"Ø ROCK MULCH AMARETTO BROWN 3" DEPTH OVER FILTER FABRIC

SHREDDED SCREENED BARK MULCH 3" DEPTH OVER FILTER FABRIC

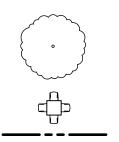

EXISTING TREE TO REMAIN

TABLE AND SEATING PROPERTY LINE

CAMPUS BOUNDARY

SHEET NO. PARKING LOT BOUNDARY

ARCHITECTURE / DESIGN / INSPIRATION

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ARCHITECT

ENGINEER

PROJECT

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REVISIONS

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DRAWN BY **REVIEWED BY** MB 10/01/2019 PROJECT NO. 19-0010.001

LANDSCAPE PLAN **ENLARGEMENT**


DRAWING NAME

SDP2-3



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PROJECT

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REVISIONS

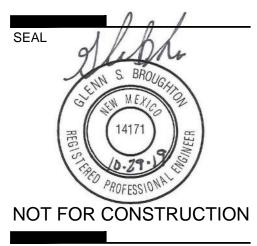
DRAWN BY REVIEWED BY GSB 10/29/2019


PROJECT NO. 19-0010.001 DRAWING NAME

CONCEPTUAL

OVERALL GRADING AND DRAINAGE PLAN

SHEET NO.

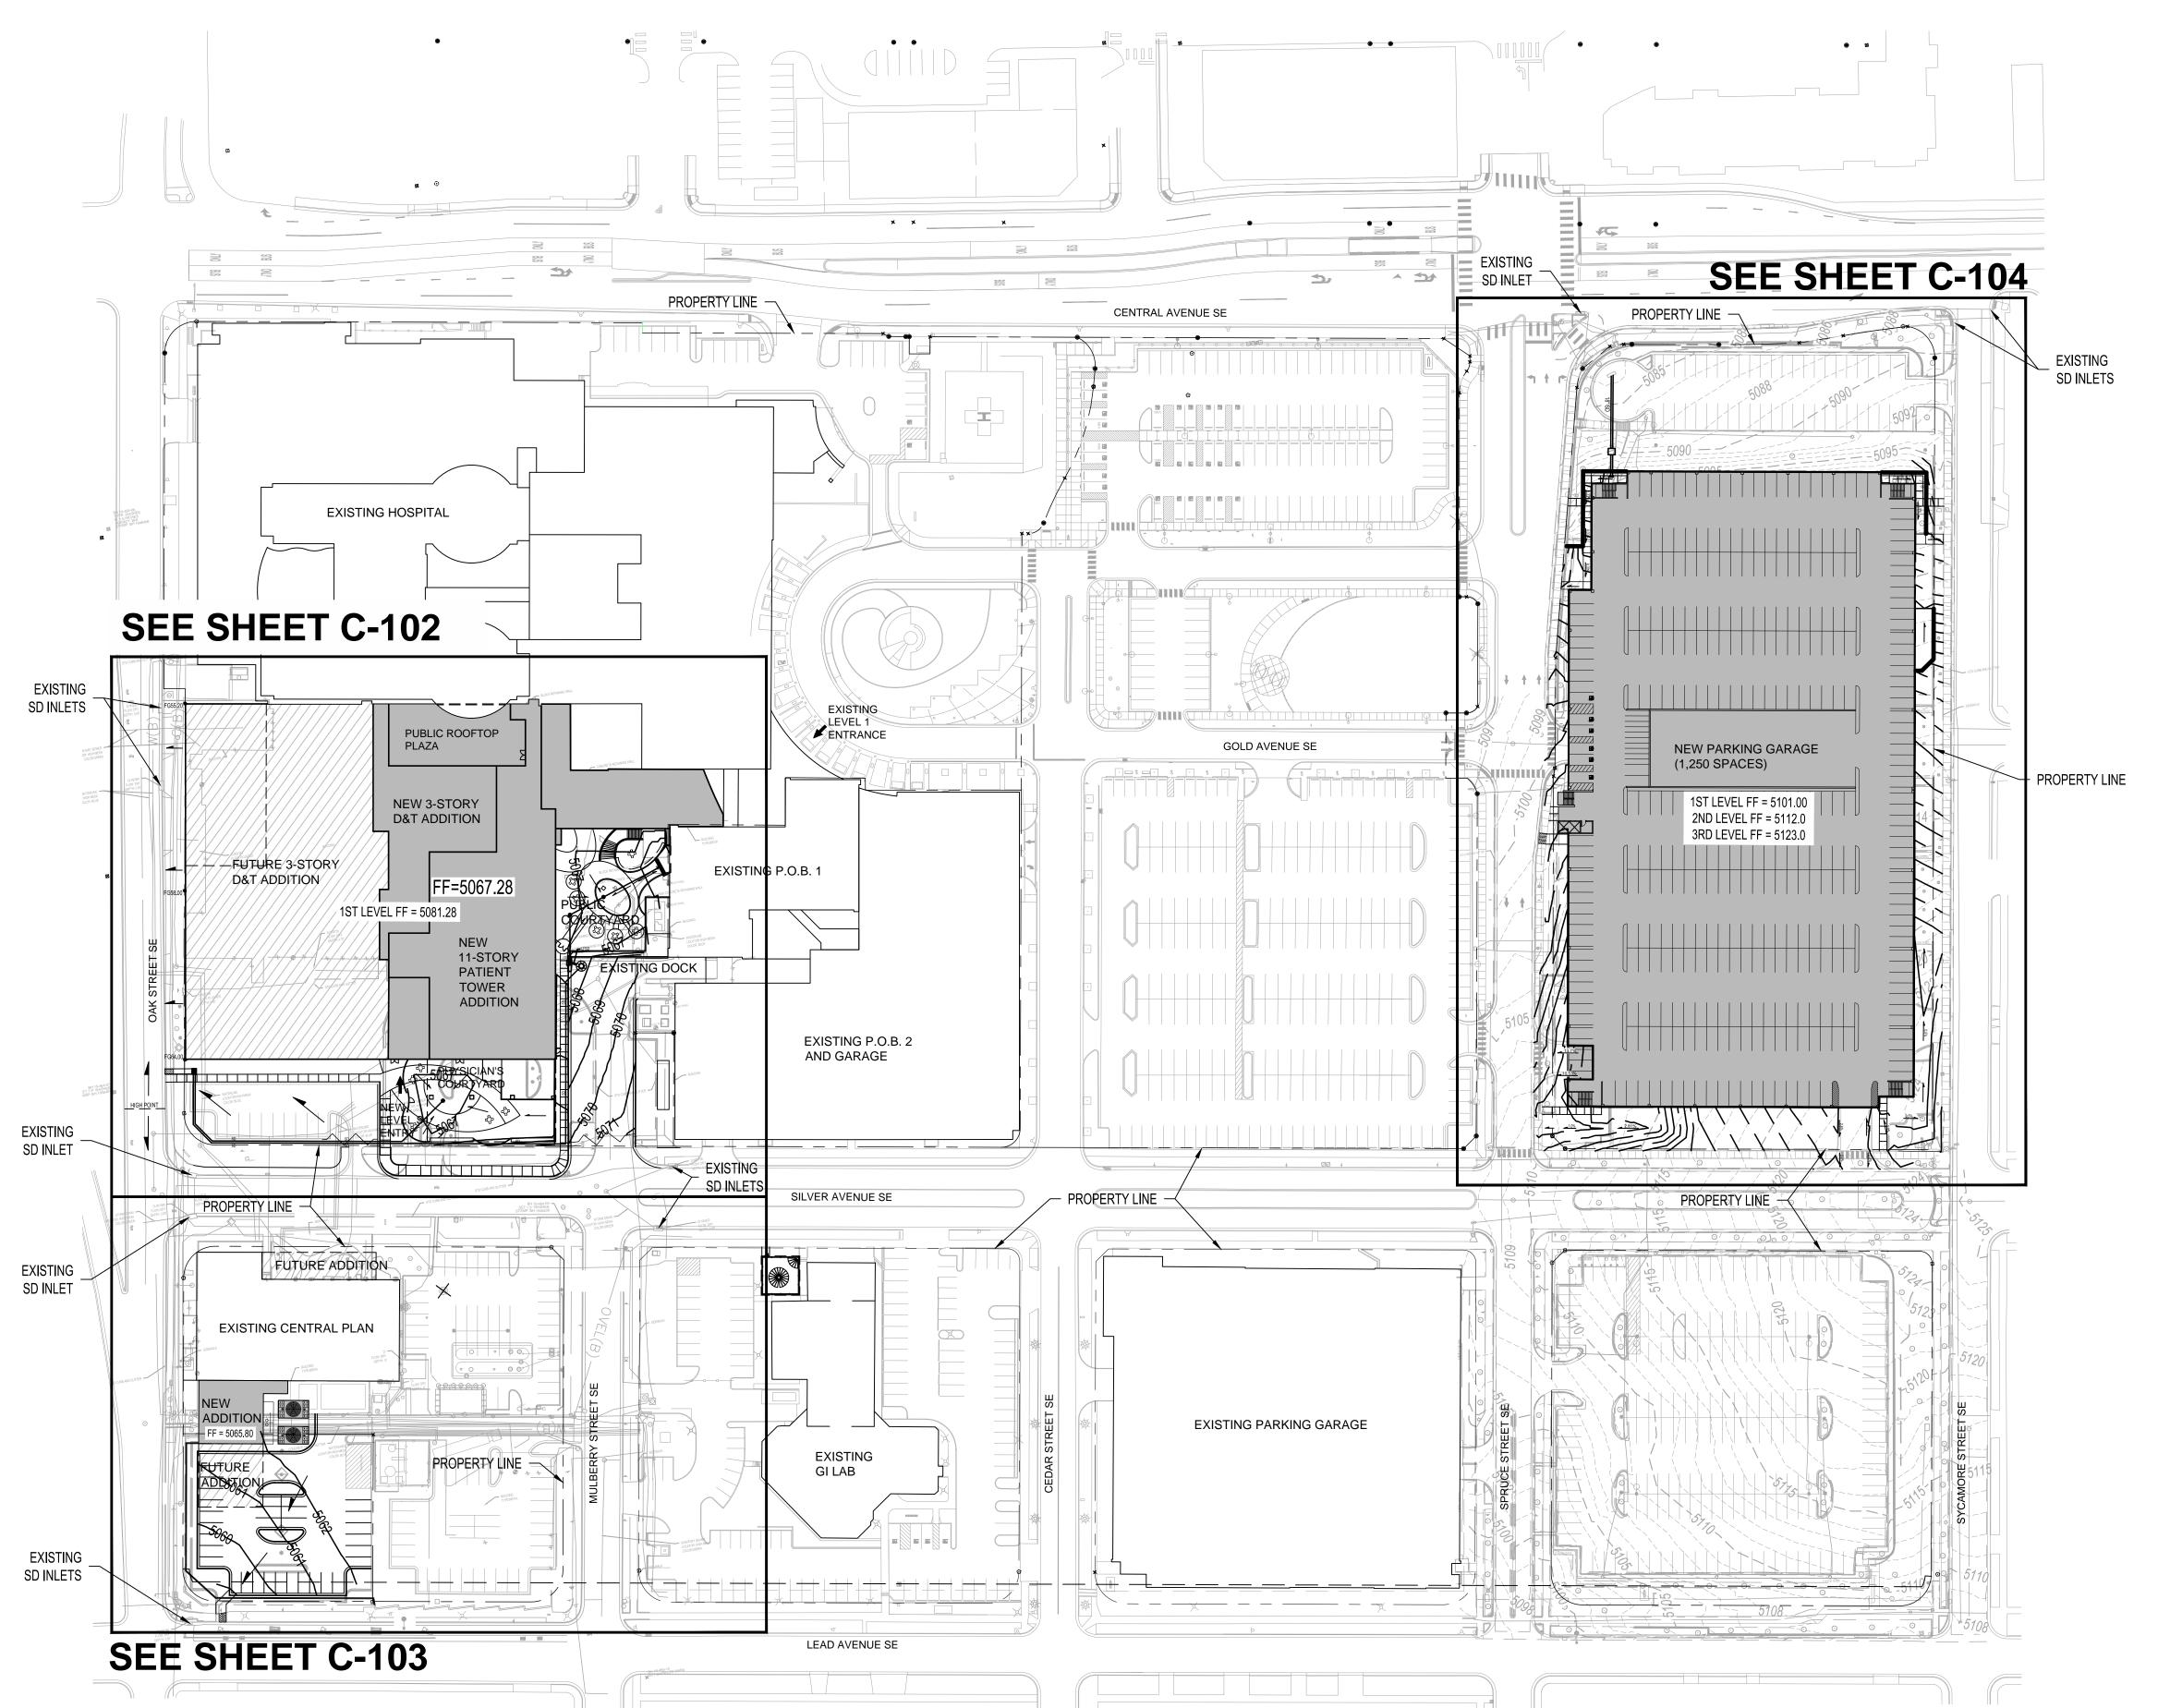

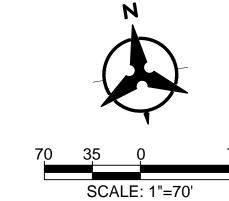

PROJECT

DRAWN BY	Е
REVIEWED BY	G
DATE	10/29/20
PROJECT NO.	19-0010.0
DRAWING NAME	

CONCEPTUAL GRADING AND DRAINAGE PLAN AREA A

SHEET NO.

C-102

GENERAL NOTES


1. CURB CUTS SHOWN ON THE PLAN HAVE BEEN LOCATED TO DIRECT SITE RUNOFF TO LANDSCAPE WATER HARVESTING AREAS. THE LOCATIONS WILL BE REFINED AS THE DESIGN DEVELOPS.

KEYED NOTES


- 1. CURB CUT.
- 2. STORM DRAIN.
- 3. AREA DRAIN.
- 4. STORM DRAIN LIFT STATION.
- 5. RETAINING WALL.
- 6. 3 24" WIDE SIDEWALK CULVERTS & CONCRETE RIBBON CHANNEL.
- 7. PUMP DISCHARGE / OVERFLOW INLET.

GRADING LEGEND

2.0%	DIRECTION OF FLOW
23.00	PROPOSED SPOT ELEVATION
5100	PROPOSED INDEX CONTOUR
5101	PROPOSED INTERMEDIATE CONTOUR
-^	WATER BLOCK

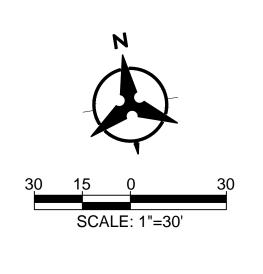



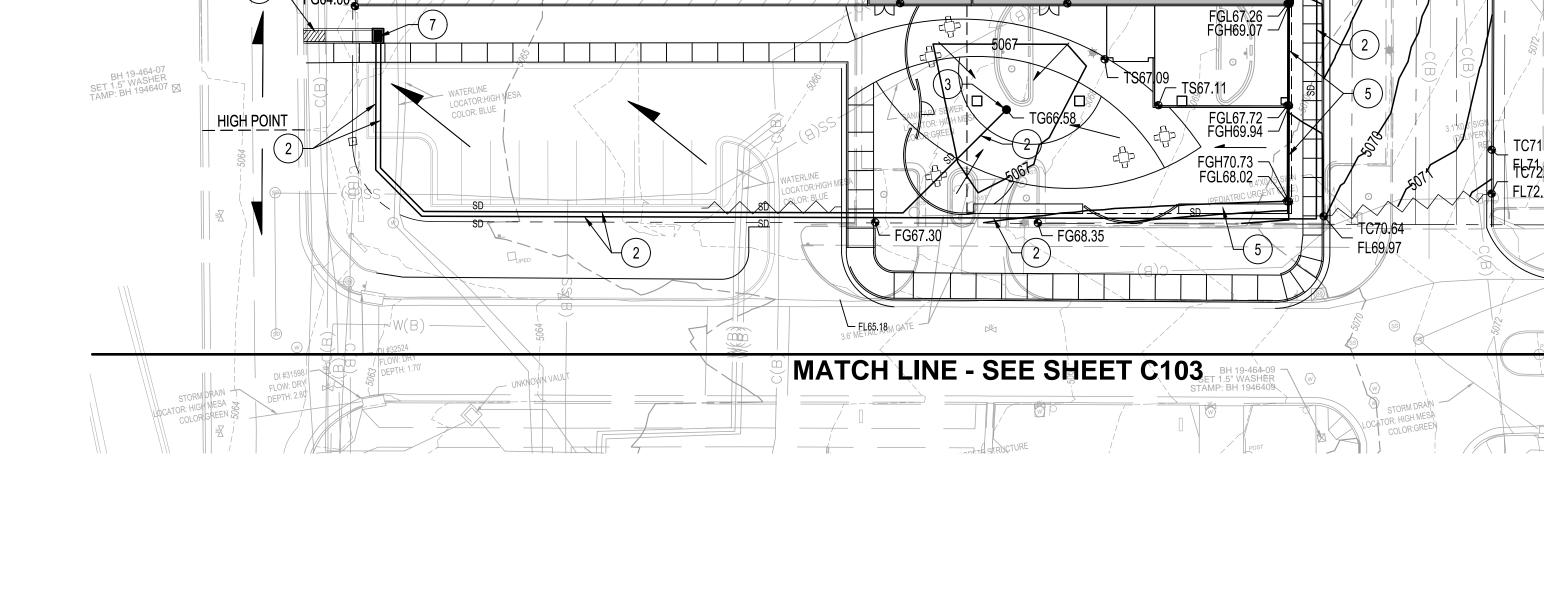

FF=5067.28

1ST LEVEL FF = 5081.28

FG67.48 -

TC67.60 FL67.10

WATERLINE — IR:HIGH MESA COLOR: BLUE

FG58.00

S)

ST

KEYED NOTES

1. CURB CUT.

2. STORM DRAIN.

3. AREA DRAIN.

5. RETAINING WALL.

6. SIDEWALK CULVERT.

7. PUMP DISCHARGE.

4. STORM DRAIN LIFT STATION.

2.0%

3 23.00

-^__

GRADING LEGEND

DIRECTION OF FLOW

WATER BLOCK

PROPOSED SPOT ELEVATION


PROPOSED INDEX CONTOUR

PROPOSED INTERMEDIATE CONTOUR

ARCHITECTURE / DESIGN / INSPIRATION

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NOT FOR CONSTRUCTION
PROJECT

RESBYTERIAN HOSPITAL

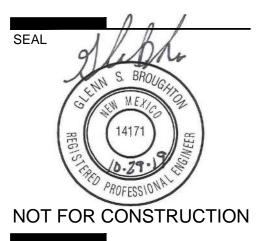VELOPMENT PLAN FOR BUILDING PERMIT

1100 Central Ave SE


Alburghering NIM 87106

DRAWN BY	В
REVIEWED BY	GS
DATE	10/29/20
PROJECT NO.	19-0010.0
DRAWING NAME	

CONCEPTUAL GRADING AND DRAINAGE PLAN AREA A

SHEET NO.

C-103

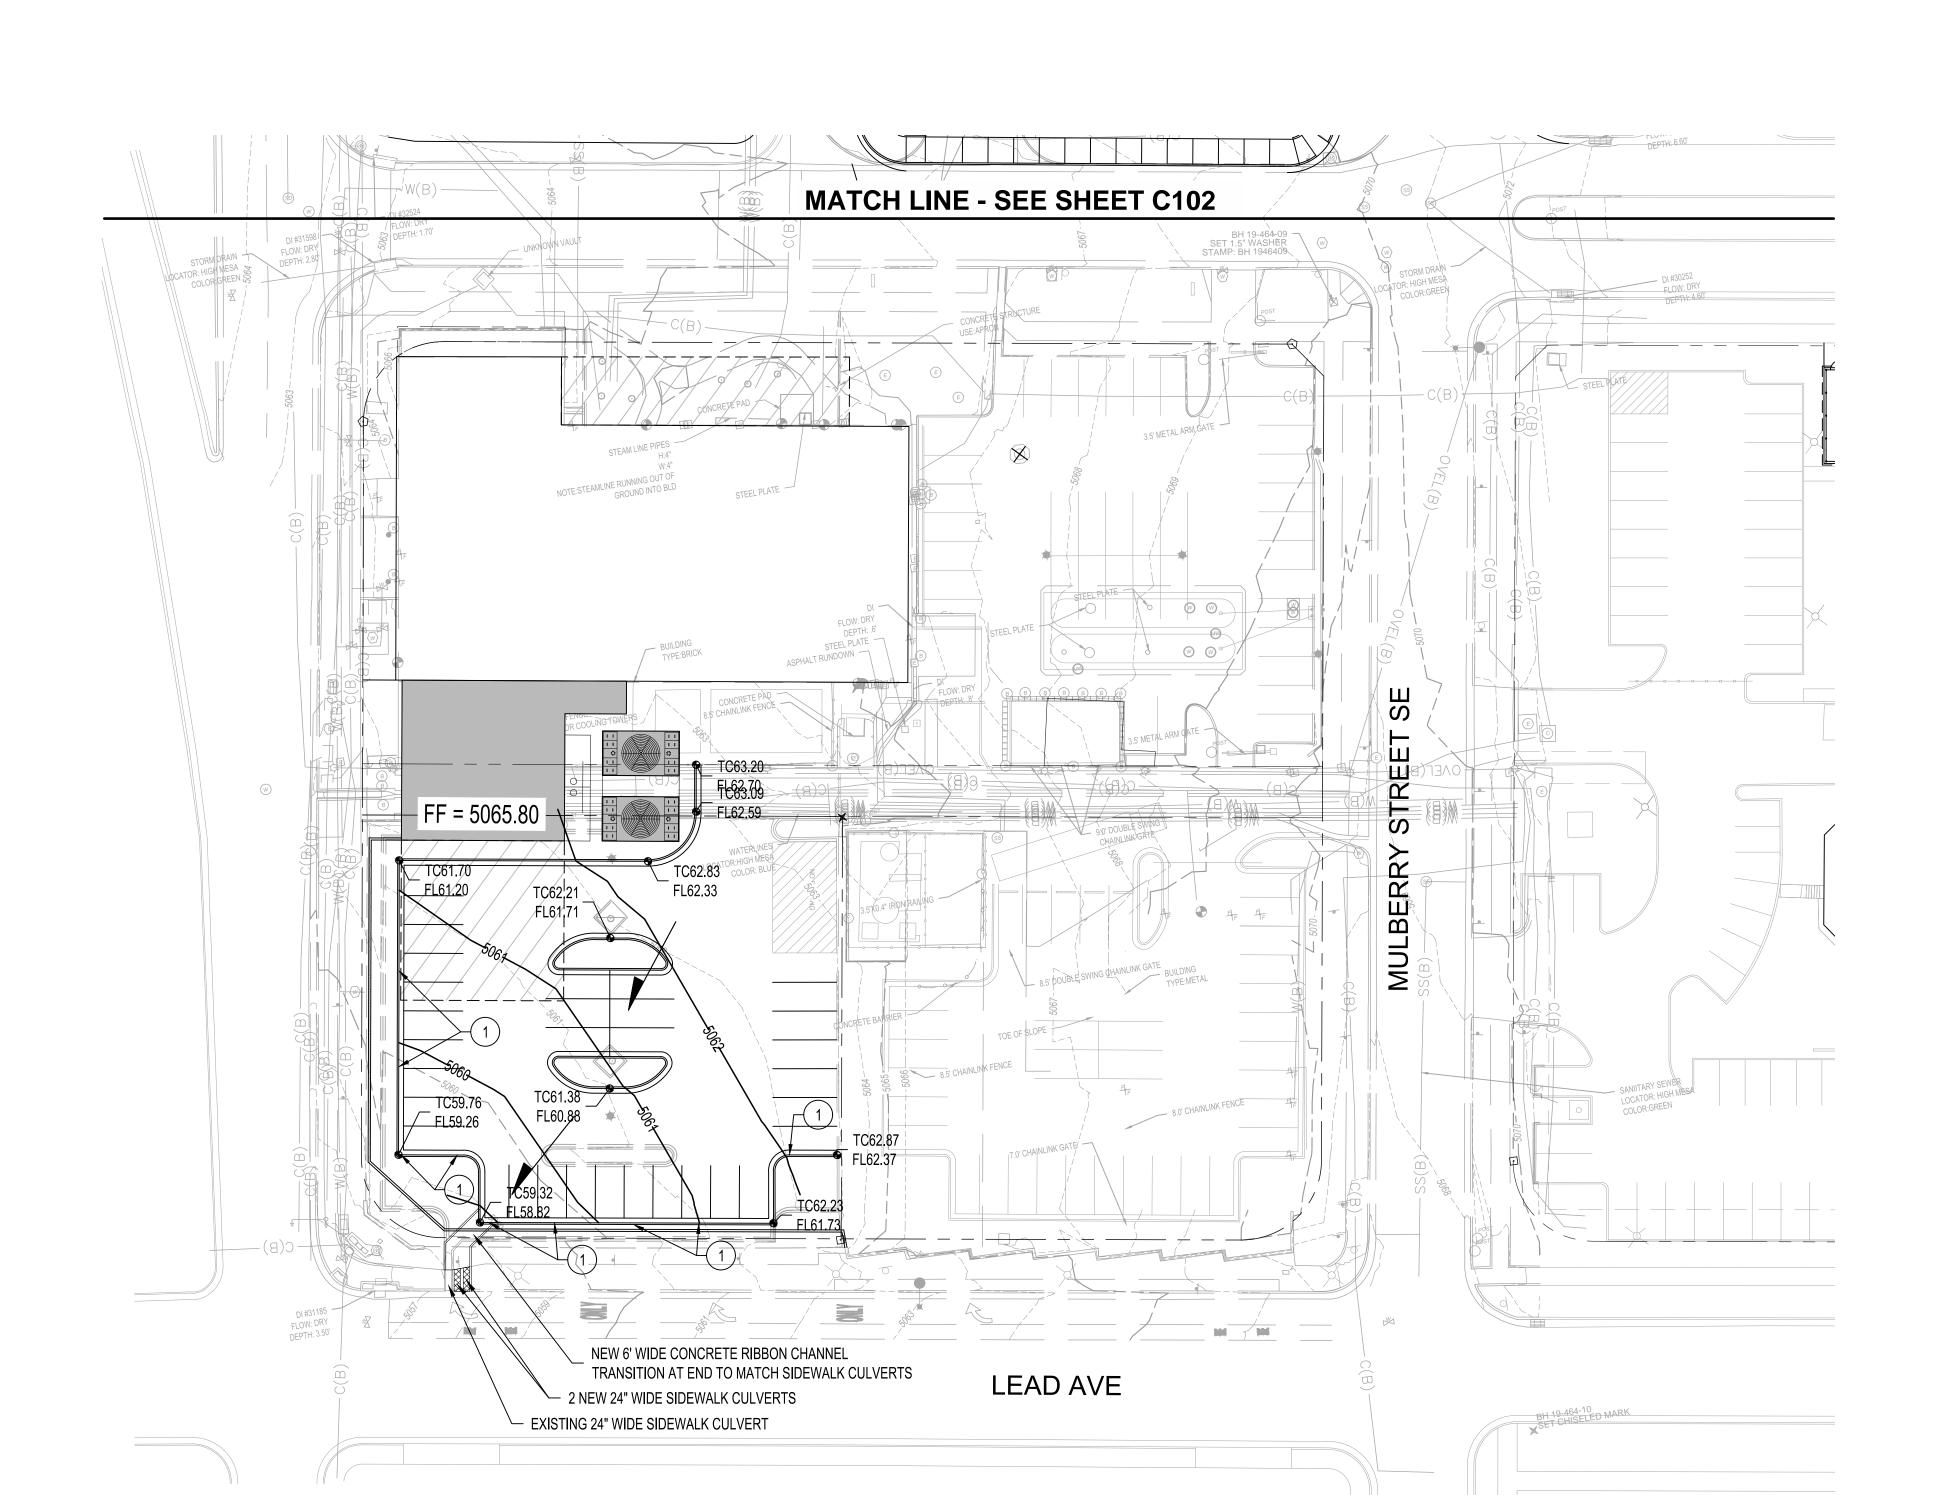

100

DRAWN BY	ВО
REVIEWED BY	GSB
DATE	10/29/2019
PROJECT NO.	19-0010.001

CONCEPTUAL GRADING AND DRAINAGE PLAN AREA B

SHEET NO.

DRAWING NAME

°. C-104



1. NEW STORM DRAIN PIPE.

2. CONNECT TO EXISTING PRIVATE STORM DRAIN INLET.

3. SAND / OIL INTERCEPTOR.


4. EXISTING RETAINING WALL TO BE REMOVED.

5. NEW RETAINING WALL.


6. 3 - 24" WIDE SIDEWALK CULVERTS & CONCRETE RIBBON CHANNEL.

GRADING LEGEND

2.0%	DIRECTION OF FLOW
2 3.00	PROPOSED SPOT ELEVATION
 5100 	PROPOSED INDEX CONTOUR
 5101	PROPOSED INTERMEDIATE CONTOUR

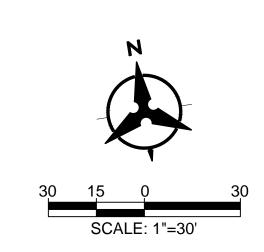



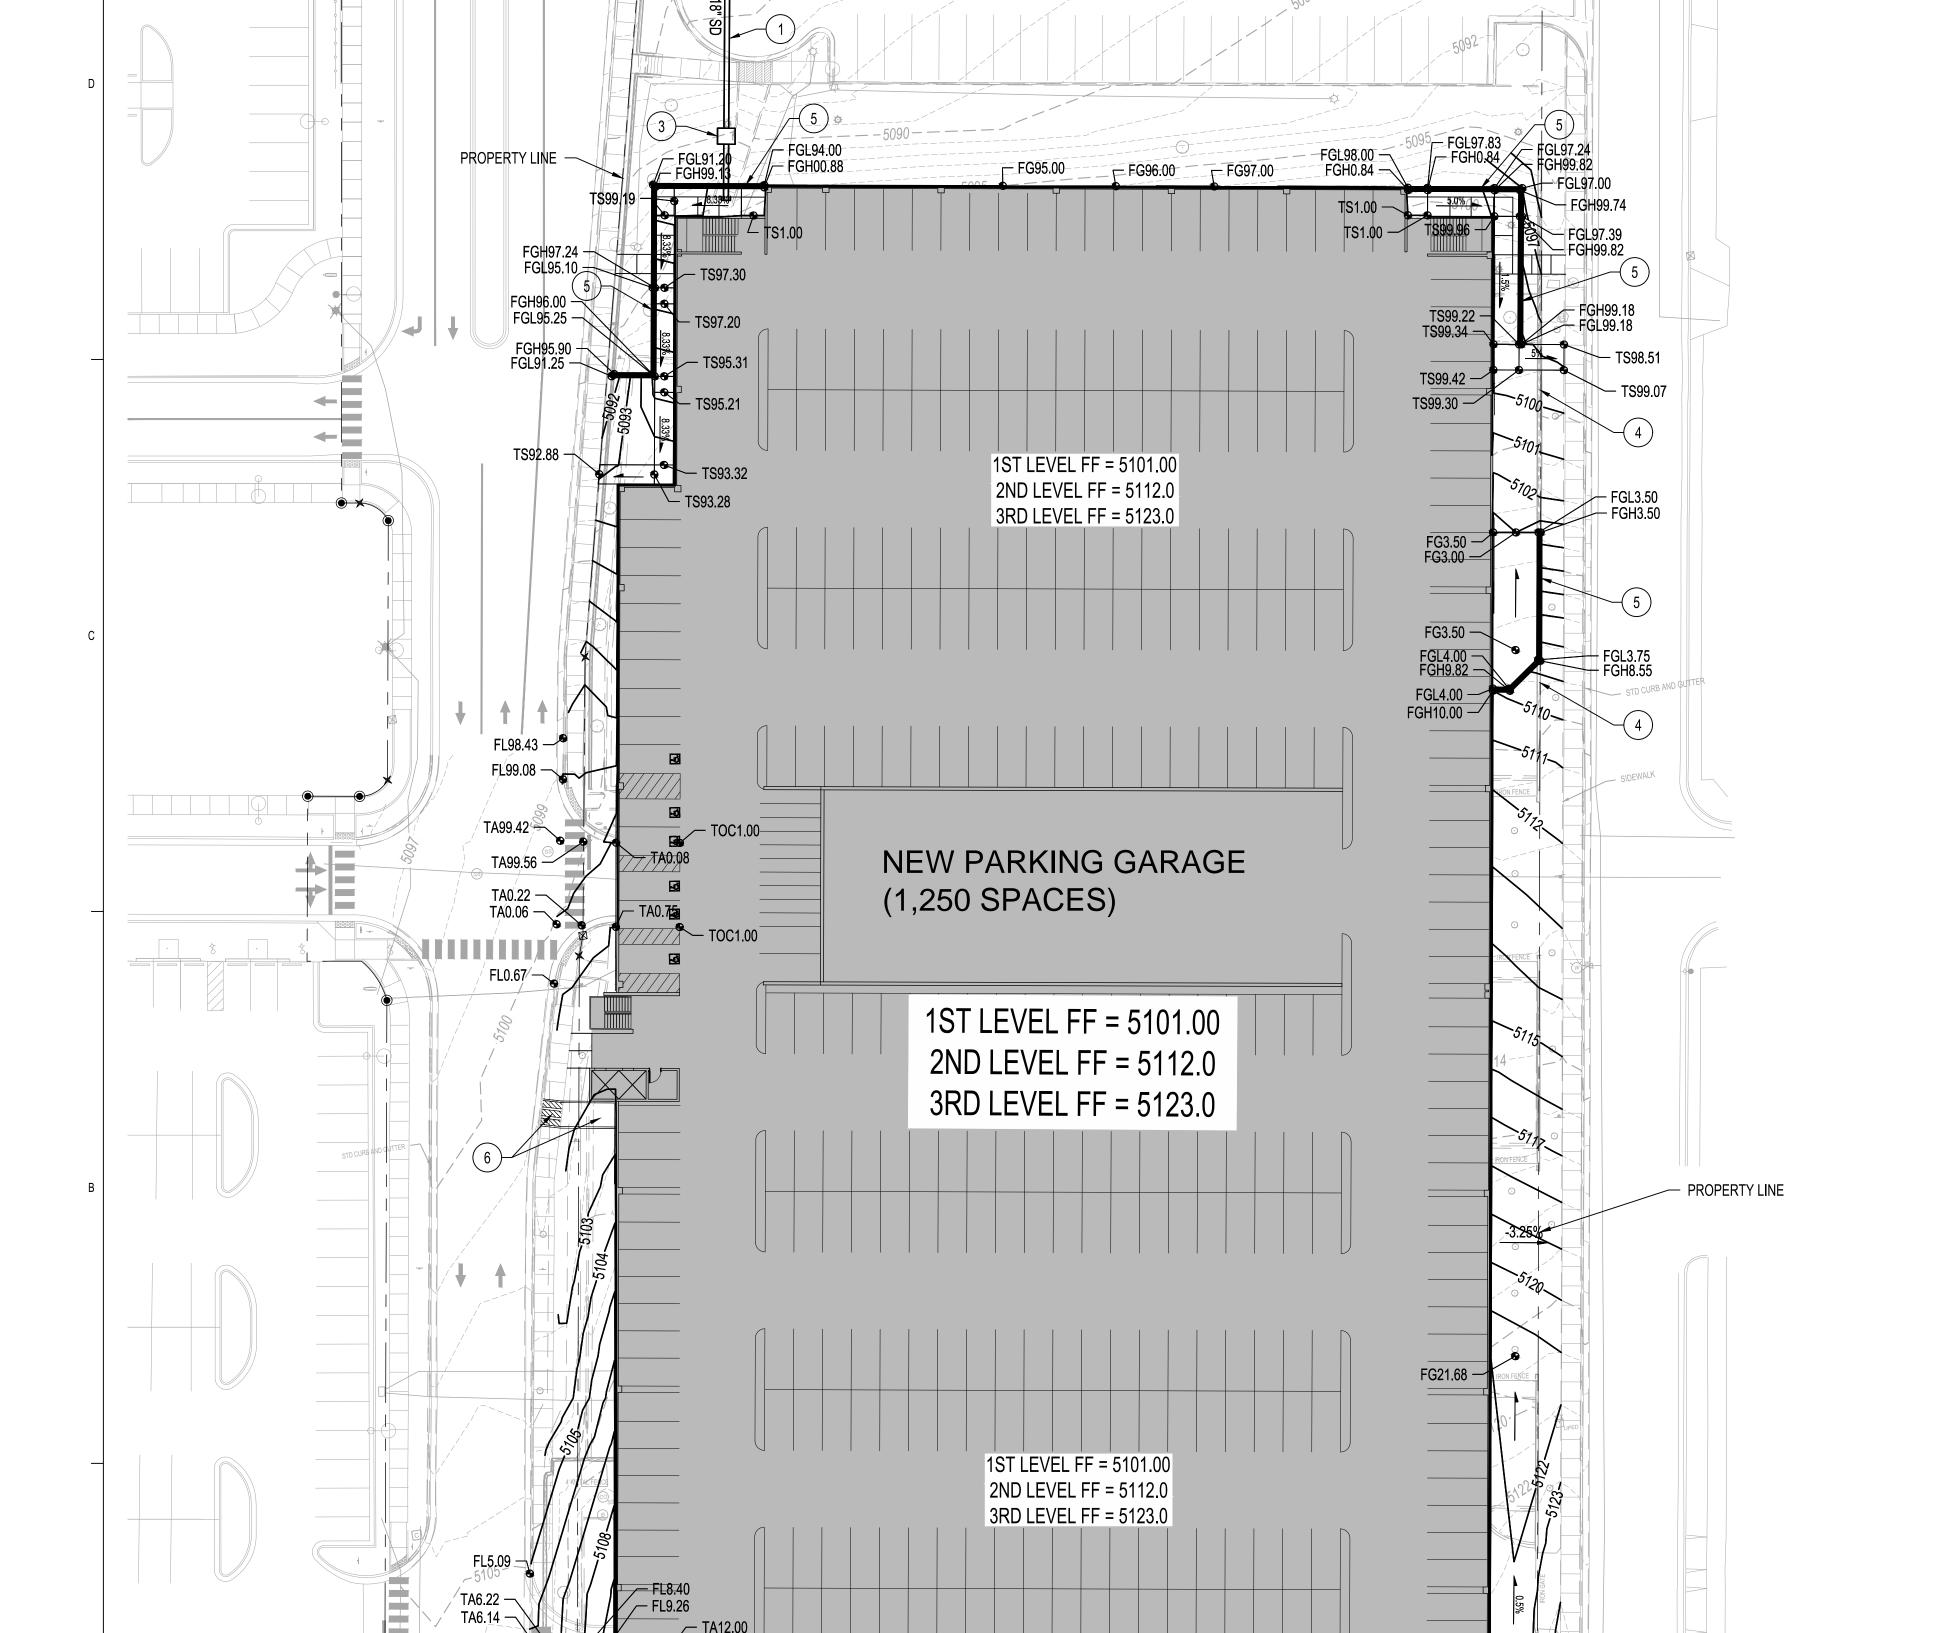

TC10.06 _ FL9.39 / TC10,14 _ FL9.47

Tue, 29-Oct-2019 - 8:43:am, Plotted by: BORTEGA P:\20190464\CDP\Plans\General\DRB\20190464 GP04 - DRB.dwg TS23.00 — TA23.00 TA23.00

EX TS21.08 EX TS18.96

⊃\— EX T\$17.31

TA21.89



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PROJECT

SPITAL UILDING PE 100

Albuquerque


REVISIONS

DRAWN BY GSB REVIEWED BY 10/01/2019 PROJECT NO. 19-0010.001

DRAWING NAME CONCEPTUAL

UTILITY PLAN



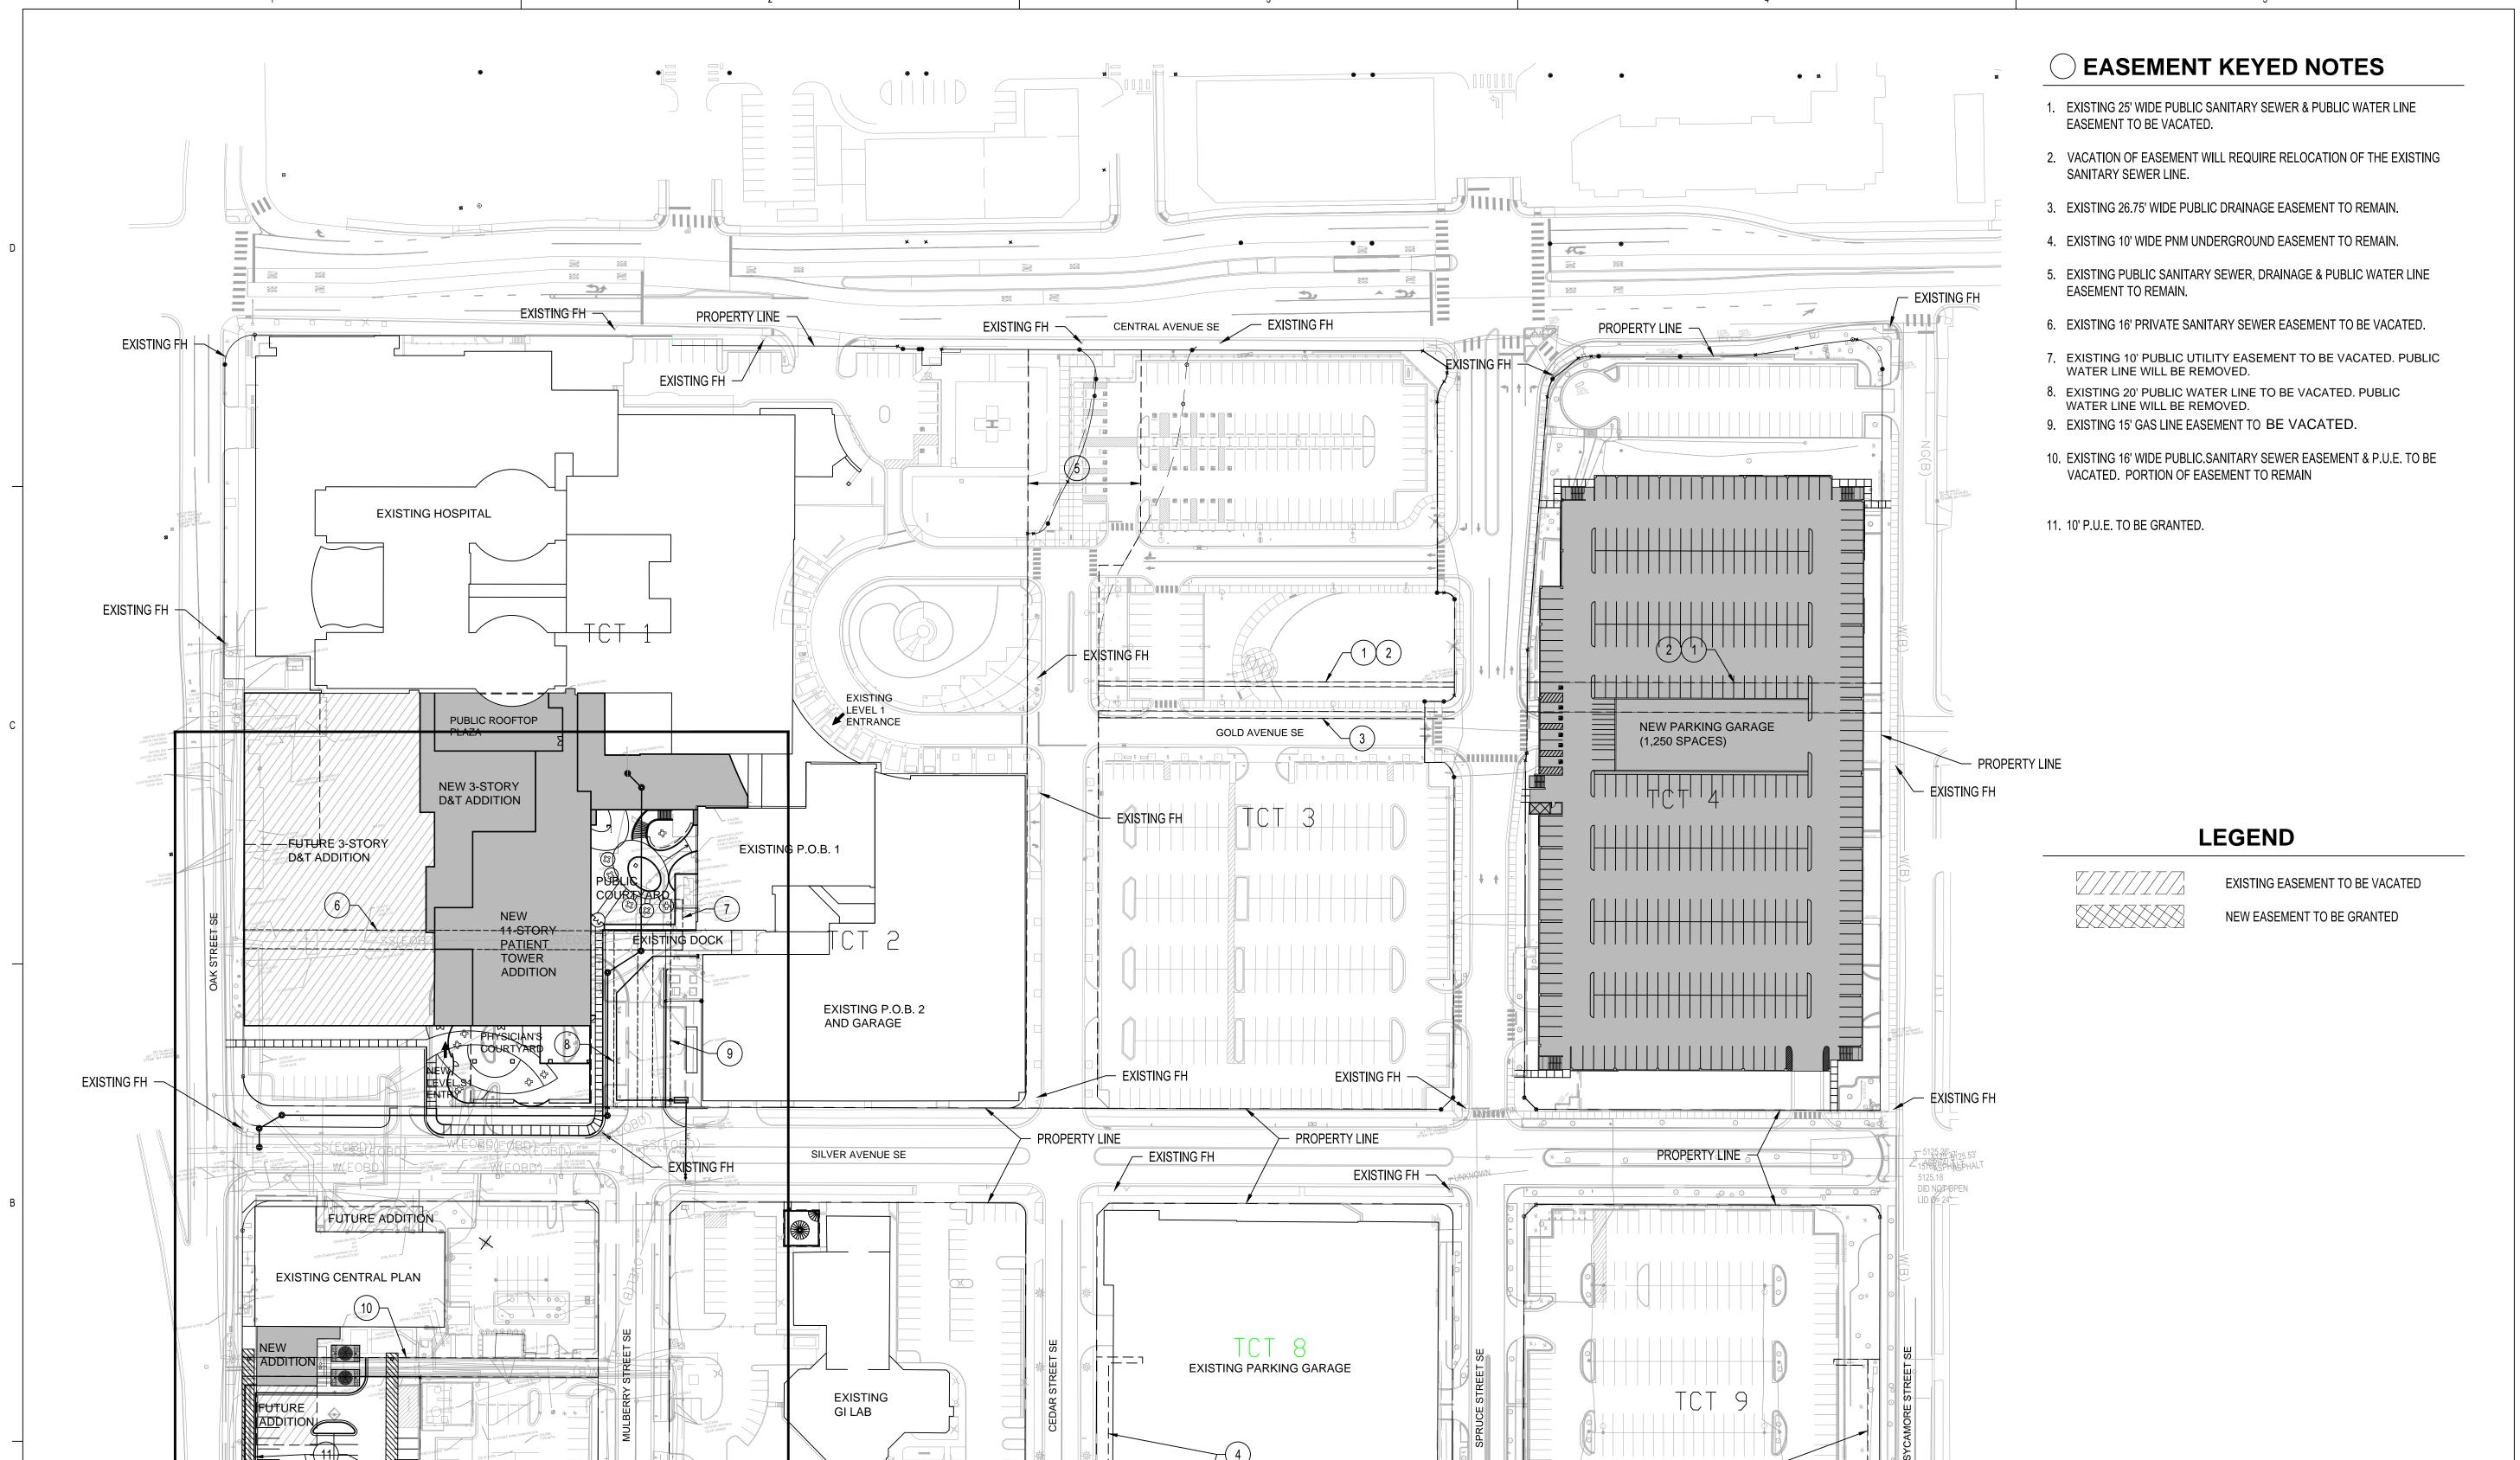

EXISTING FH —

LEAD AVENUE SE

EXISTING FH

EXISTING FH -

SEE SHEET C-202

EXISTING FH

DEKKER PERICH SABATINI

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PROJECT


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REVISIONS

DRAWN BY	В
REVIEWED BY	GS
DATE	10/01/201
PROJECT NO.	19-0010.00
DRAWING NAME	

CONCEPTUAL

UTILITY PLAN

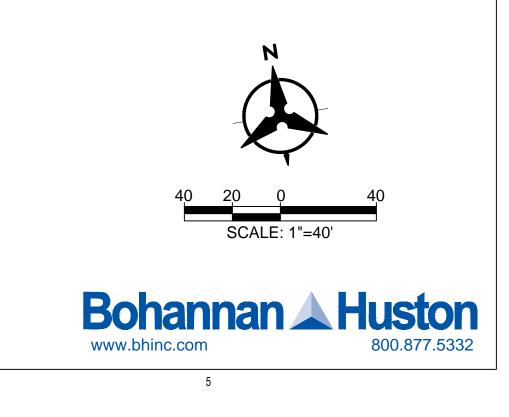


KEYED NOTES

3. NEW PRIVATE 10" SANITARY SEWER LINE.

2. NEW BACK FLOW PREVENTER IN HEATED ENCLOSURE.

1. NEW PRIVATE 8" FIRE LINE.

4. NEW PUBLIC 8" FIRE LINE.

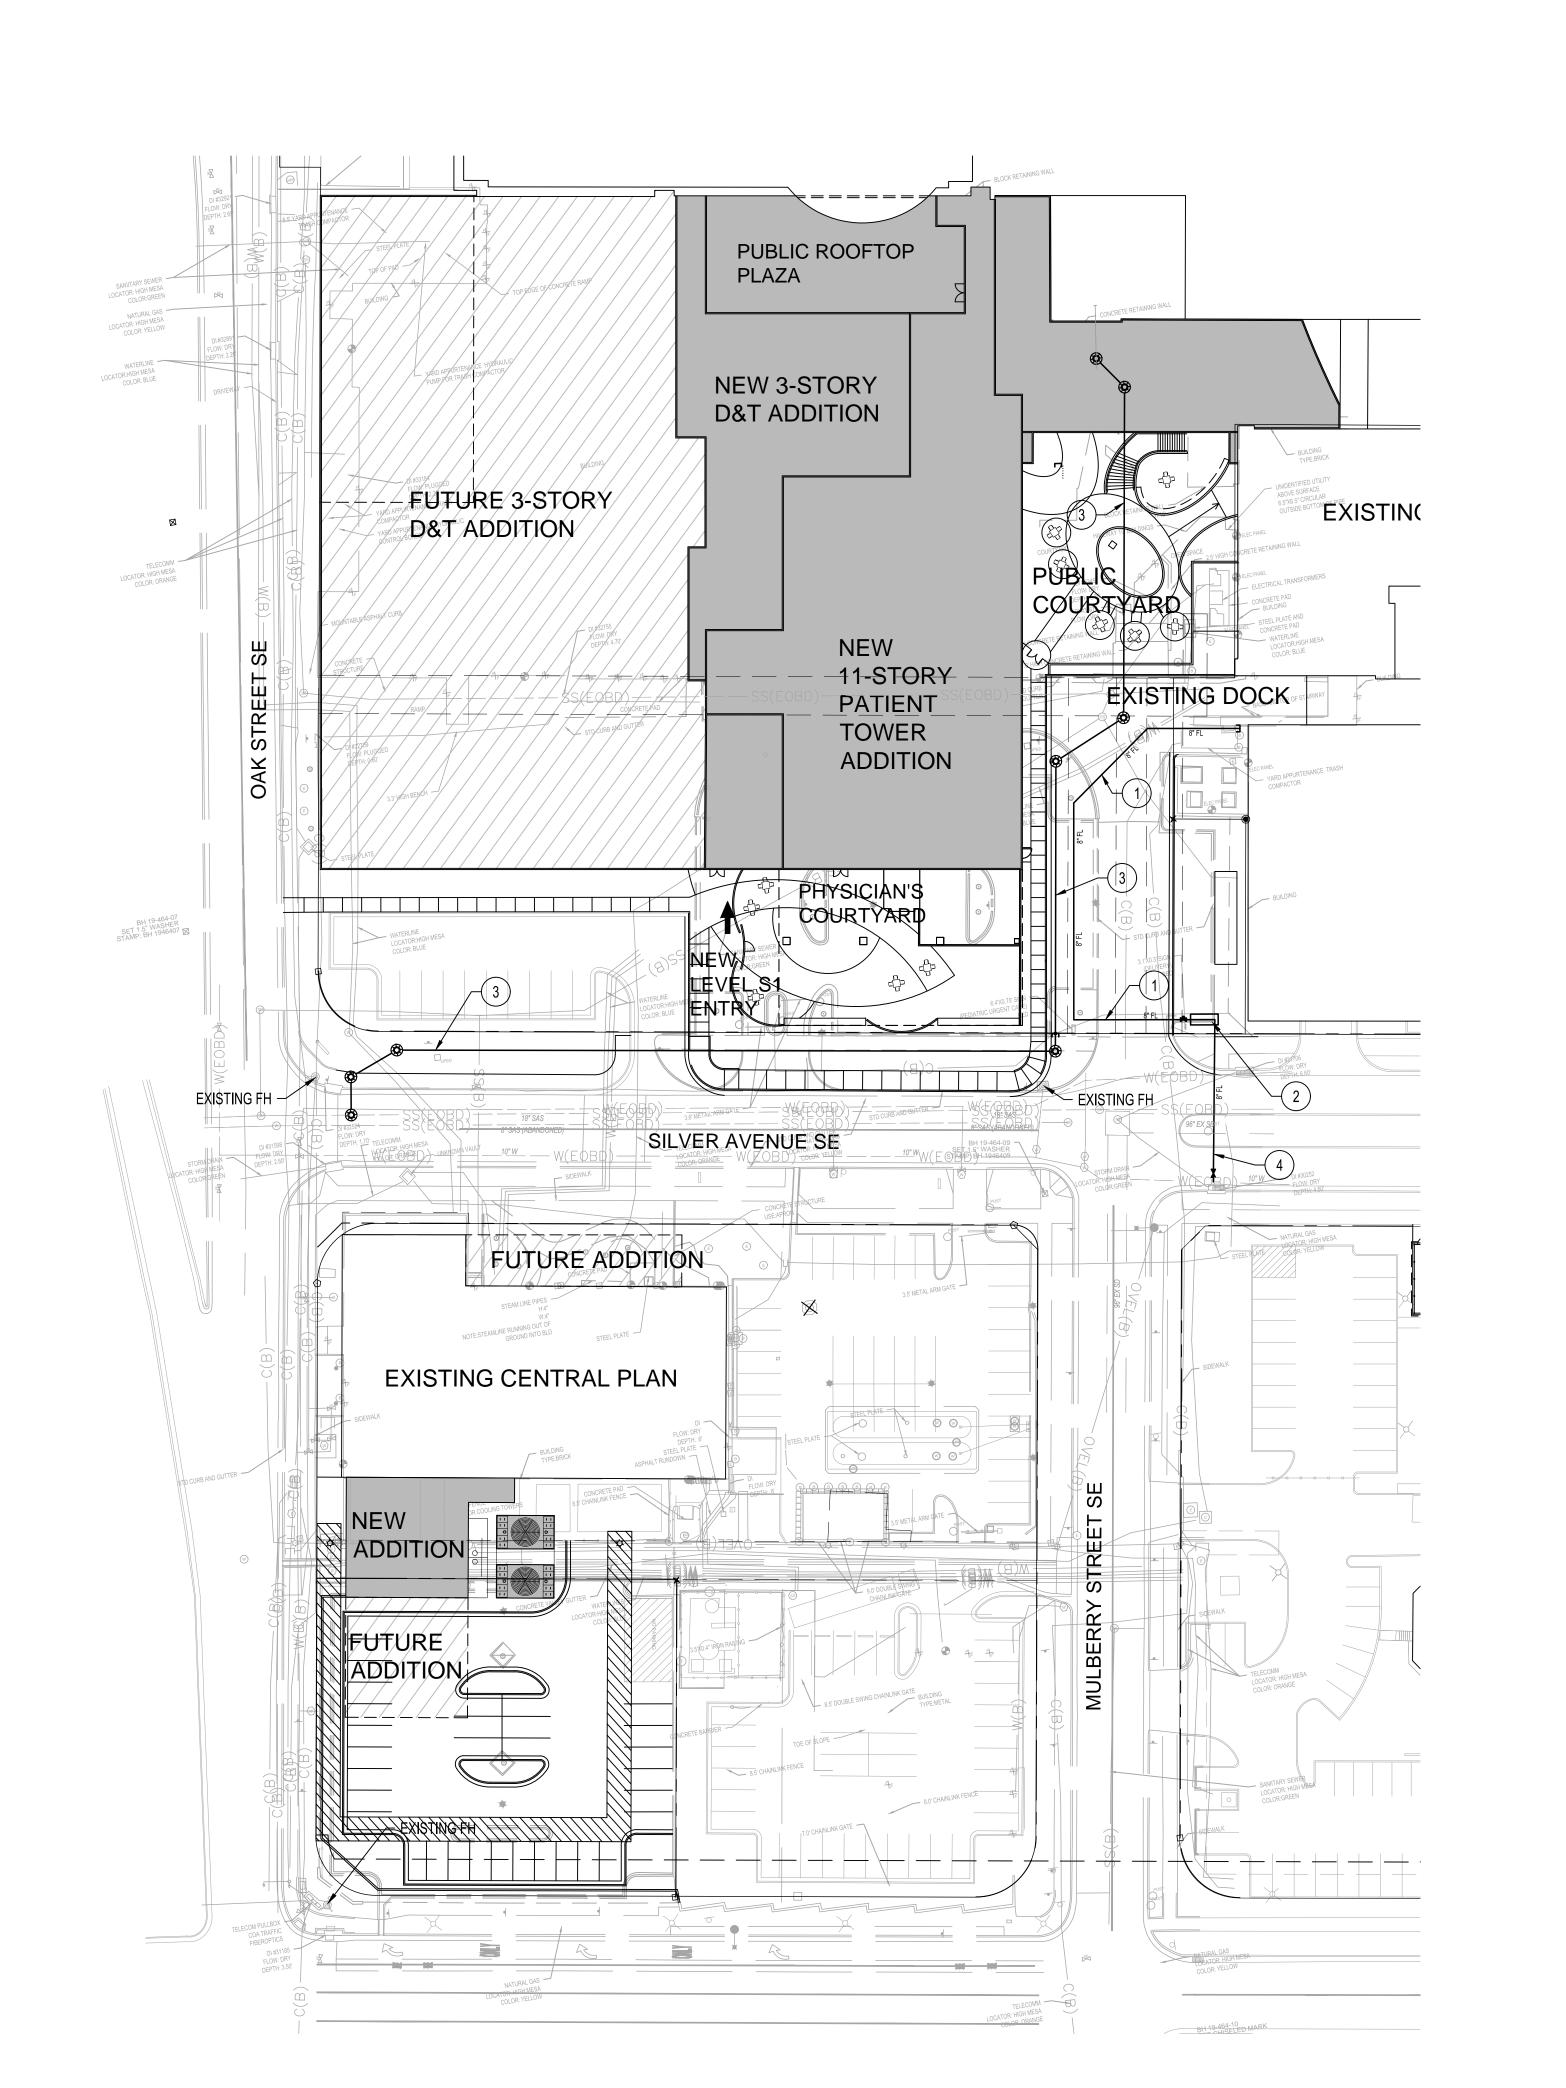

GENERAL NOTES


1. REFER TO ARCHITECTURAL FOR BUILDING MOUNTED SIGNAGE LOCATIONS.

○ SHEET KEYED NOTES


- 1. APPROXIMATE LOCATION OF ELECTRICAL SERVICE GEAR INCLUDING PAD MOUNT TRANSFORMERS AND SWITCHGEAR.
- 2. MOUNTING HEIGHT FOR BUILDING MOUNTED LIGHTING AT 10'.

LIGHTING FIXTURE SCHEDULE						
TYPE	DESCRIPTION	MOUNTING	WATTS/VOLTAGE	MANUFACTURER/MODEL	LUMENS	
A1 (E)	FULL CUT OFF LED POLE MOUNT, SINGLE HEAD, EXISTING RELOCATED.	20' POLE ON 3' CONCRETE STRUCTURAL BASE.	76 WATTS/277V	GE	8110	
A2	FULL CUT OFF LED POLE MOUNT, SINGLE HEAD, EXISTING RELOCATED.	12' POLE ON FLUSH CONCRETE BASE.	76 WATTS/277V	GARDCO #P26-140L-1675-NWG2- AR3	8110	
A3	FULL CUT OFF LED WALL MOUNT	WALL MOUNT. MOUNTING HEIGHT10'	30 WATTS/277V	STONCO #PW30-NW-G1-277V	3090	

NOTE: ALL FIXTURE COLORS TO BE SELECTED BY ARCHITECT.

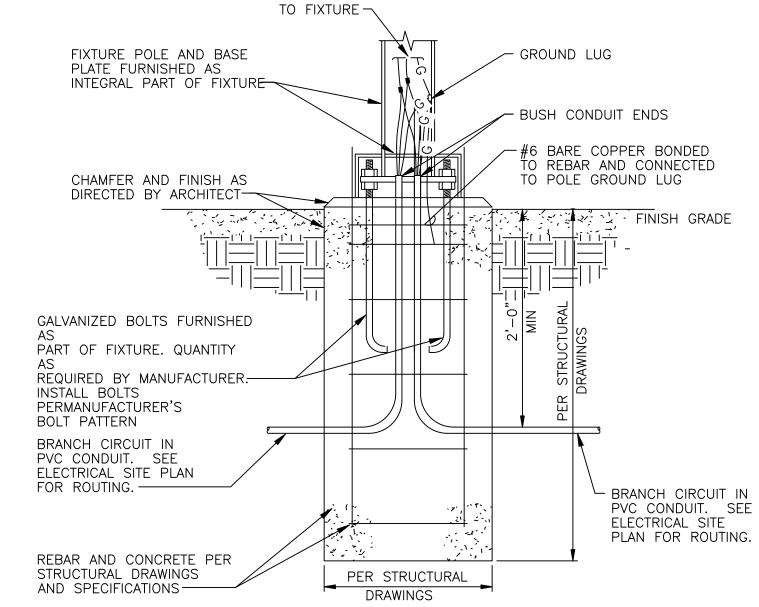



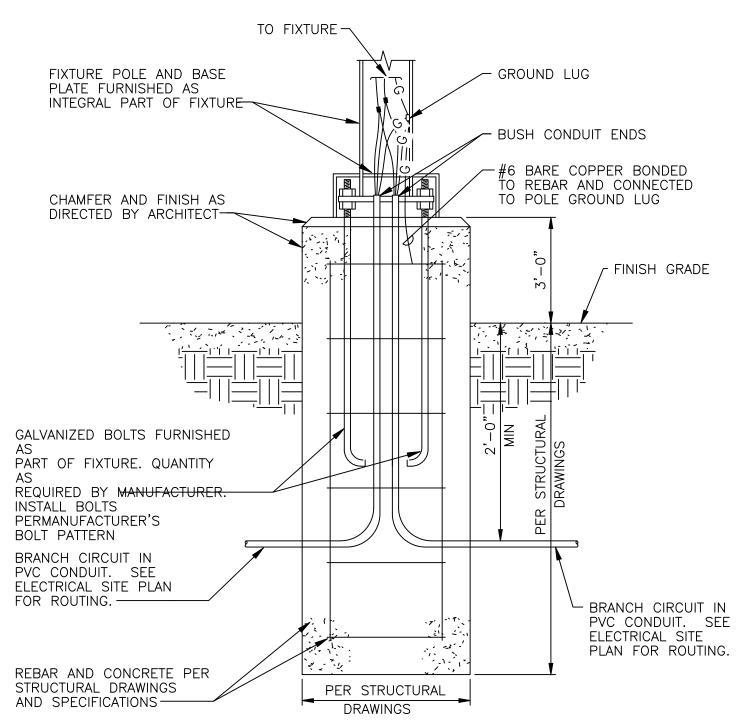

POLE BASE DETAIL

SCALE: NONE

SCALE: 1" = 30'-0"

ARCHITECTURE / DESIGN / INSPIRATION

DEKKER PERICH SABATINI

7601 JEFFERSON NE, SUITE 10 ALBITOLIFROLF NM 8710

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ARCHITECT



ENGINEER

PROJECT

SBYTERIAN HOSPITAL

PENENT PLAN FOR BUILDING PERMIT

100 Central Ave SE

Albuquerque

PRE

DRAWN BY _ REVIEWED BY - DATE 10/01/2019

PROJECT NO. 19-0010.001

DRAWING NAME

EPC ELECTRICAL SITE PLAN

SHEET NO.

ES101

OF

A1/HS

A1/HS

A1/HS A

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A1/HS A3

A1/HS

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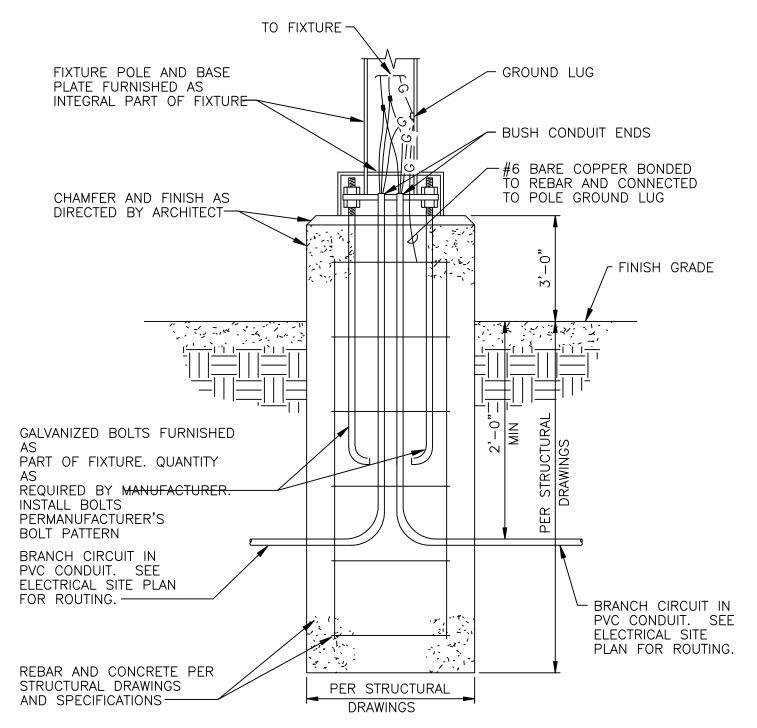
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2 (TYP.)

LIGHTING FIXTURE SCHEDULE						
TYPE	DESCRIPTION	MOUNTING	WATTS/VOLTAGE	MANUFACTURER/MODEL	LUMENS	NOTES
A1	FULL CUT OFF LED POLE MOUNT, SINGLE HEAD, COMFORT OPTICS. TYPE 3 DIST	12' POLE ON 3' CONCRETE STRUCTURAL BASE.	76 WATTS/277V	GARDCO #P26-140L-1675-NWG2-AR3-DIM	8110	"HS" INDICATES HOUSE SIDE SHIELD.
A2	FULL CUT OFF LED POLE MOUNT, SINGLE HEAD, COMFORT OPTICS. TYPE 5 DIST	12' POLE ON 3' CONCRETE STRUCTURAL BASE.	76 WATTS/277V	GARDCO #P26-140L-1675-NWG2-AR5-DIM	8168	"HS" INDICATES HOUSE SIDE SHIELD.
А3	FULL CUT OFF LED WALL MOUNT	WALL MOUNT. MOUNTING HEIGHTS NOT LESS THAN 9'	30 WATTS/277V	STONCO #PW30-NW-G1-277V	3090	

NOTE: ALL FIXTURE COLORS TO BE SELECTED BY ARCHITECT.



FREE STANDING POLE BASE DETAIL

SCALE: NONE (APPLIES TO FIXTURES NOT MOUNTED IN PARKING STRUCTURE.)


FREE STANDING POLE DETAIL

- HOUSING PER MANUFACTURER SINGLE HEAD

ROUND ALUMINUM POLE COLOR; BLACK

FINISH GRADE

SCALE: 1"= 30'-0"

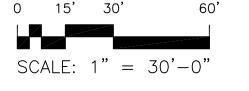

ARCHITECTURE / DESIGN / INSPIRATION

DEKKER PERICH SABATINI

7601 JEFFERSON NE, SUITE 10 ALBUQUERQUE, NM 87109

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ARCHITECT



ENGINEER

PROJECT

PRESBYTERIAN HOSPITAL
DEVELOPMENT PLAN FOR BUILDING PERMIT 1100 Central Ave SE
Albuquerque, NM 87106


EPC ELECTRICAL SITE PLAN


SHEET NO.


DRAWING NAME

ES102

• OF

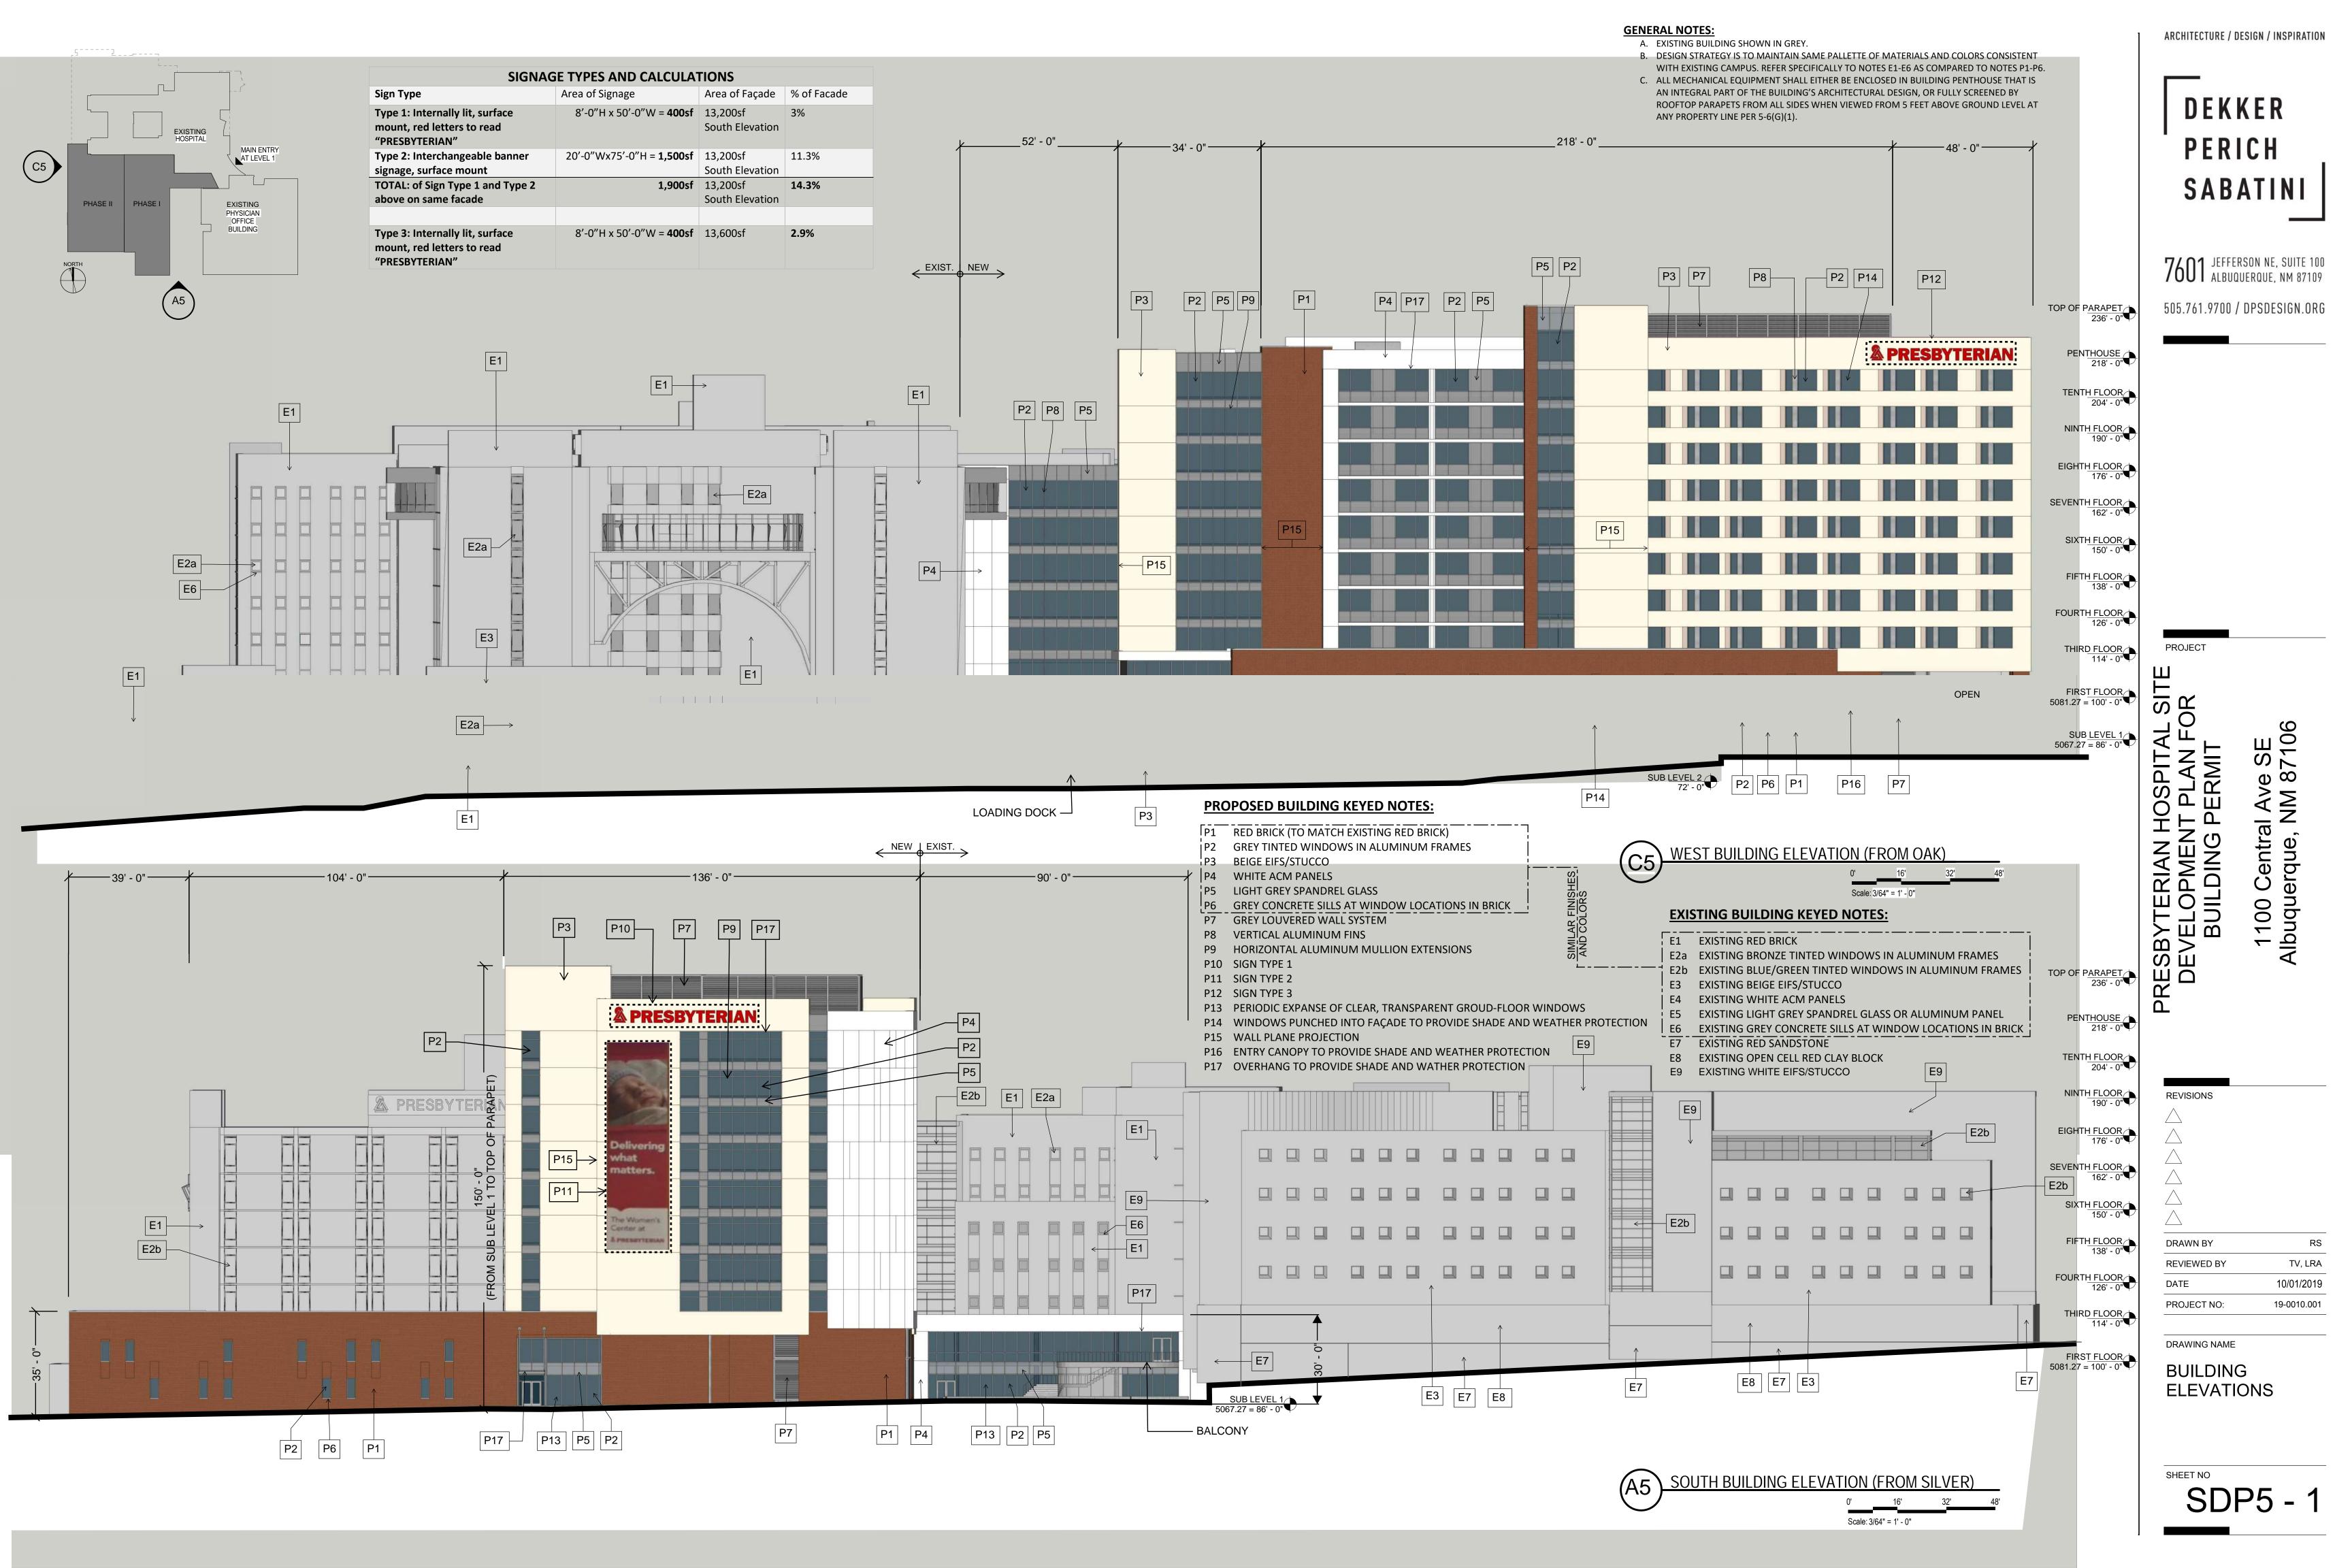

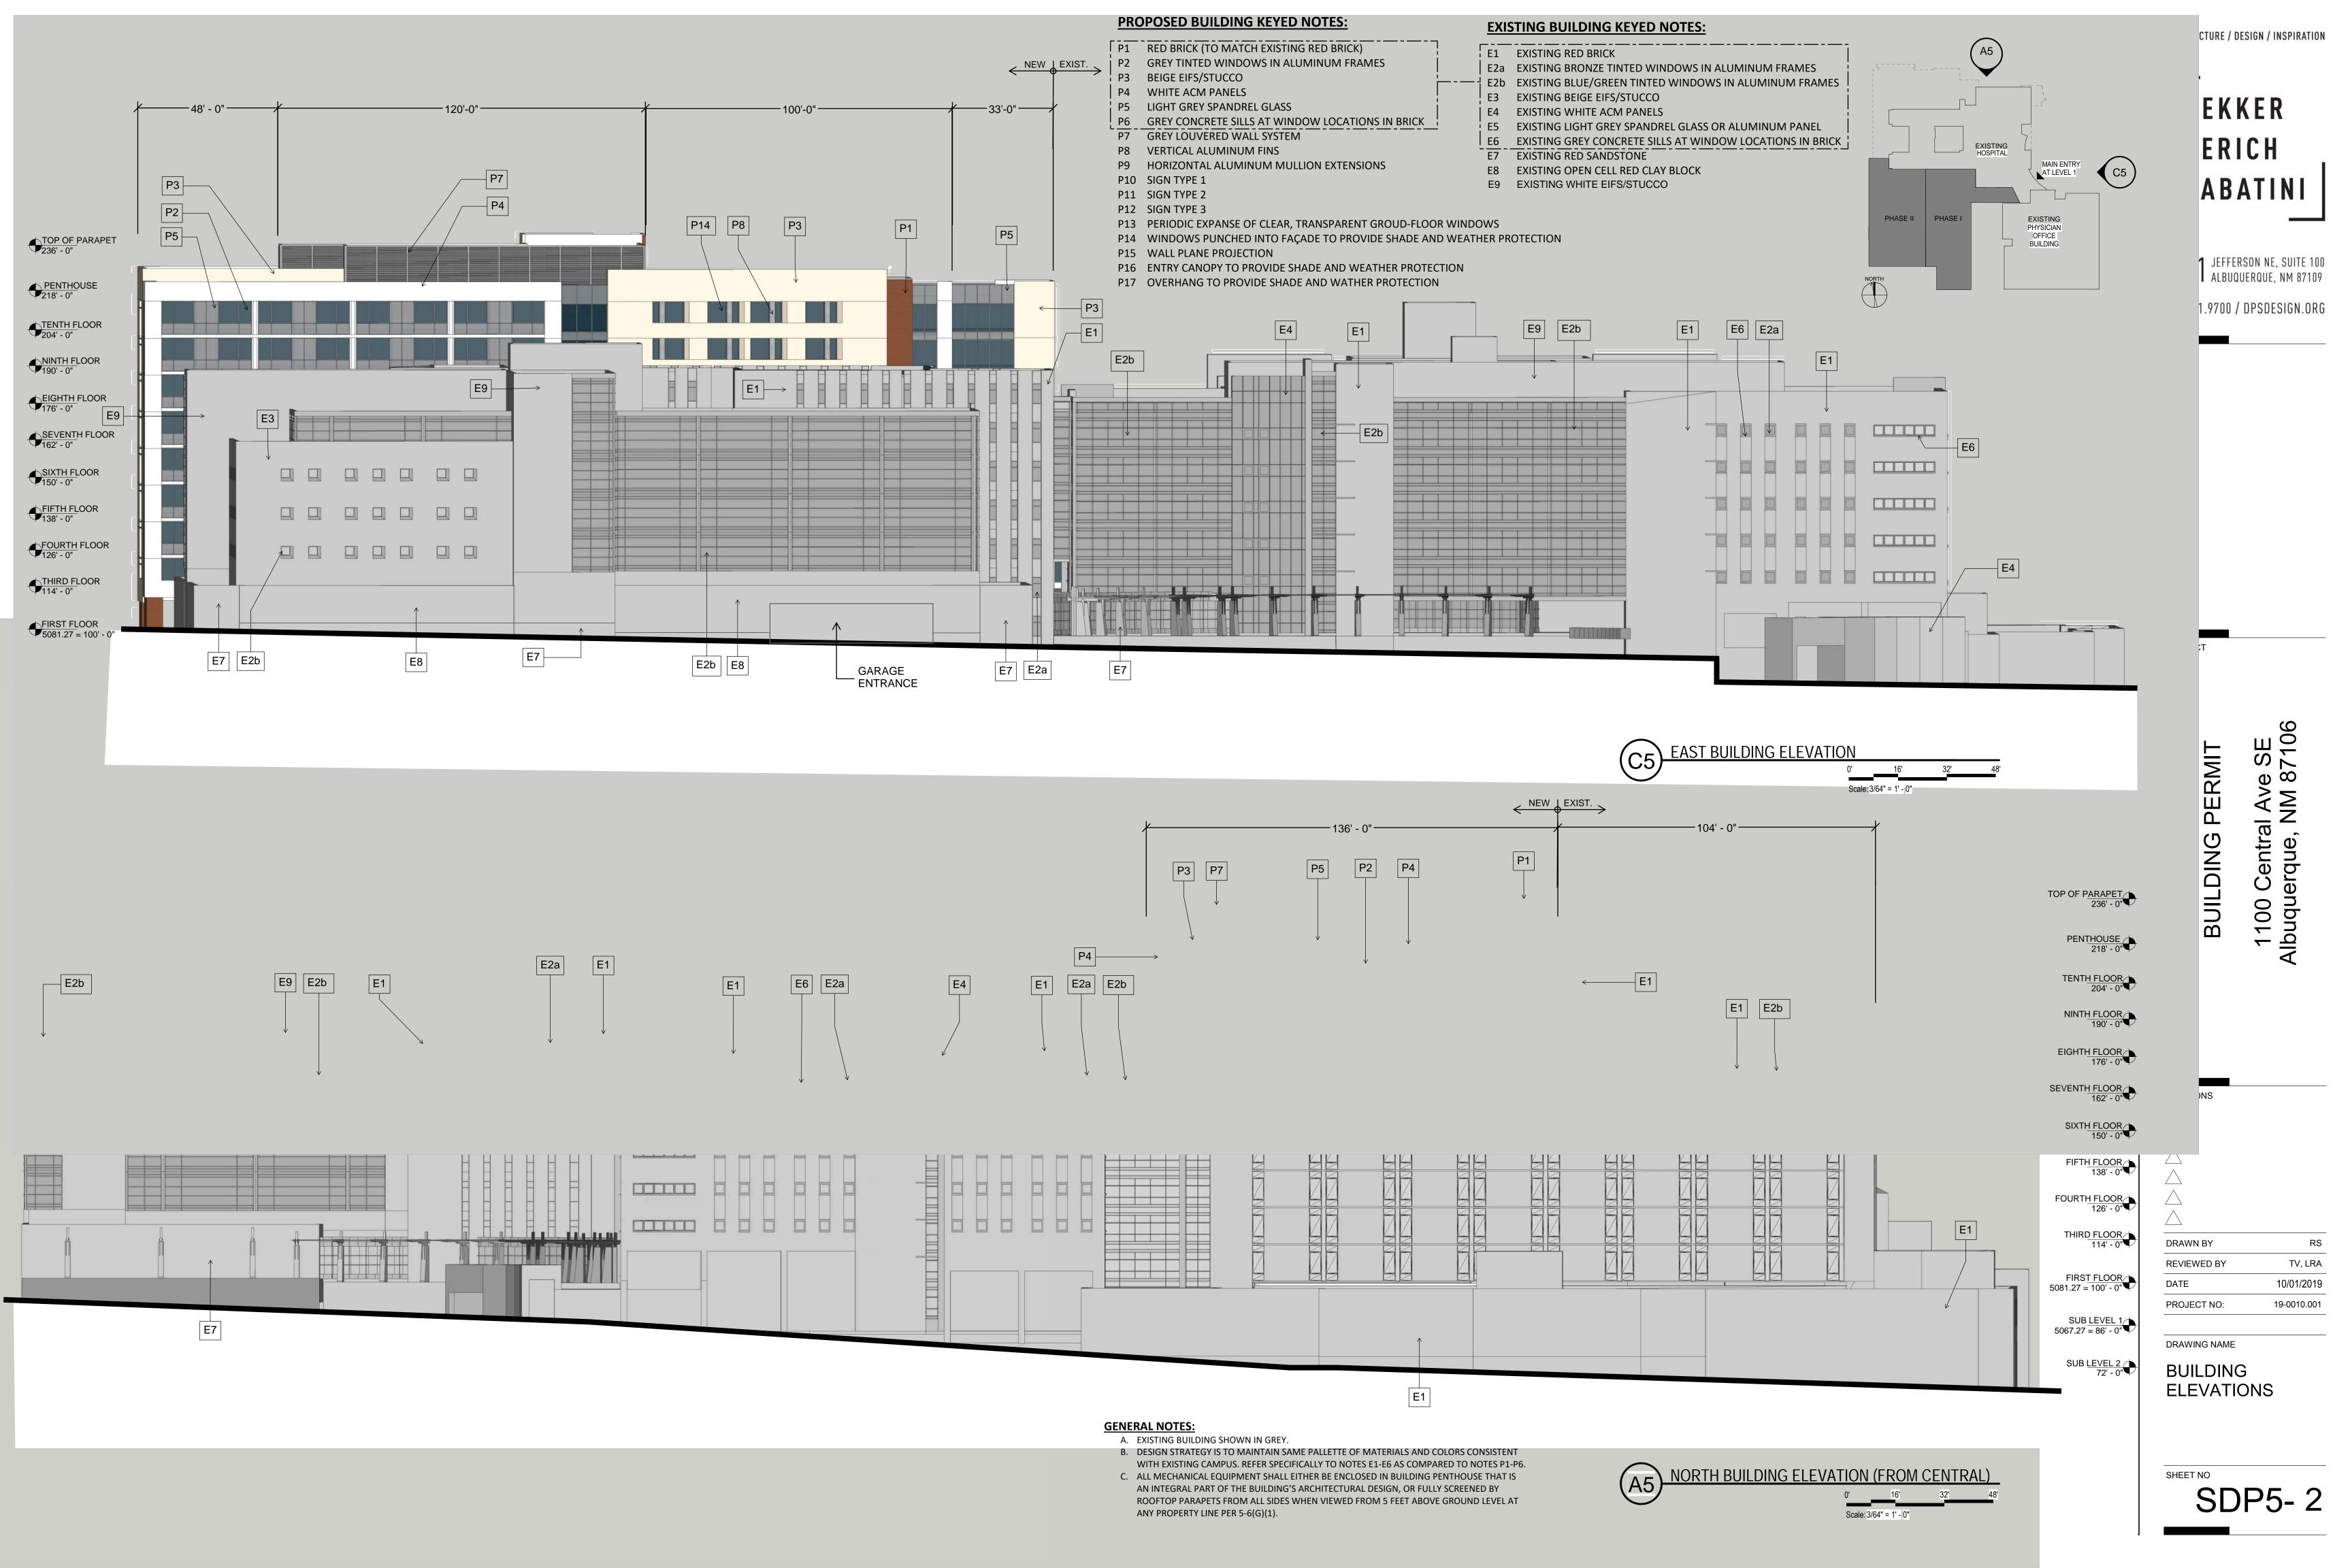

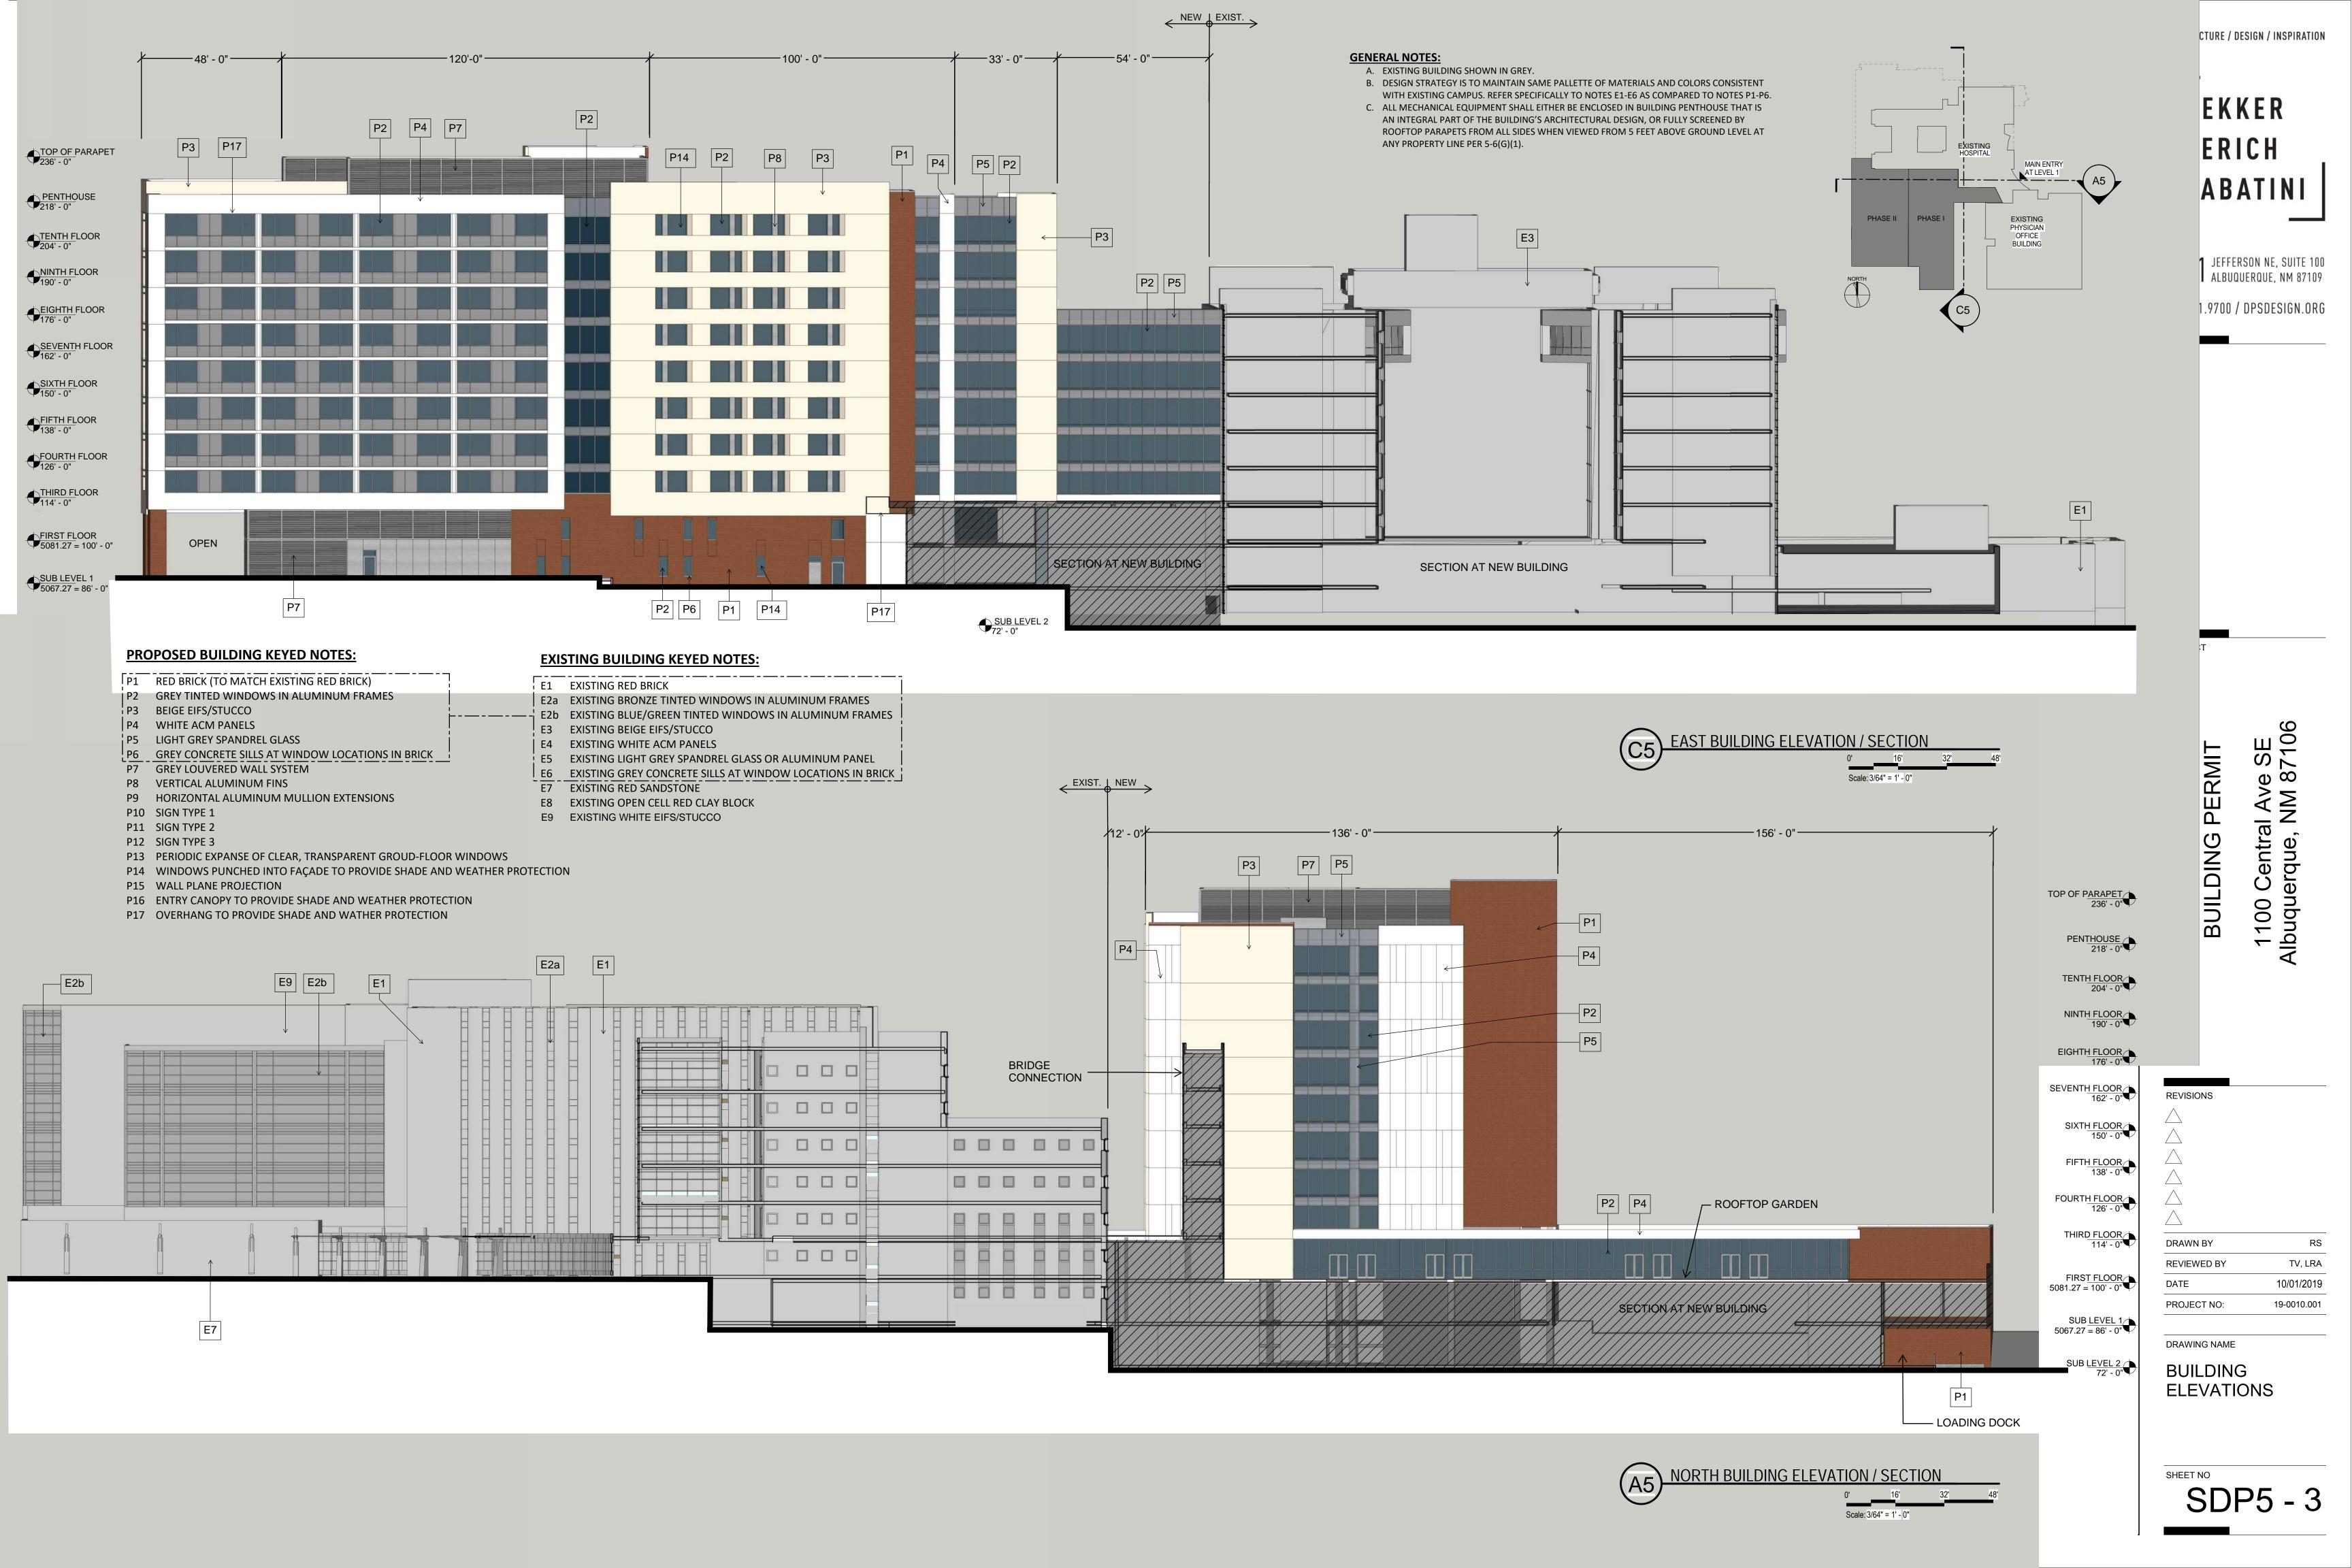

DEKKER PERICH

ARCHITECTURE / DESIGN / INSPIRATION

SABATINI

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PROJECT

PRESBYTERIAN HOSPITAL SITE DEVELOPMENT PLAN FOR BUILDING PERMIT

e SE 87106

1100 Central Ave Albuquerque, NM

REVISIONS

DRAWN BY

V. FUNSTON

DRAWED BY

M. HARREDTS

 REVIEWED BY
 M. HARBERTS

 DATE
 10/01/2019

 PROJECT NO:
 19-0006.001

DRAWING NAME

BUILDING ELEVATIONS

SDP5-4

DEKKER PERICH SABATINI

ARCHITECTURE / DESIGN / INSPIRATION

7601 JEFFERSON NE, SUITE 100 ALBUQUERQUE, NM 87109

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PROJECT

PRESBYTERIAN HOSPITAL SITE DEVELOPMENT PLAN FOR BUILDING PERMIT

'e SE 87106

1100 Central Ave Albuquerque, NM 8

DRAWING NAME

BUILDING ELEVATIONS


SDP5-5


DEKKER
PERICH
SABATINI

ARCHITECTURE / DESIGN / INSPIRATION

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WEST BUILDING ELEVATION - SPRUCE

3/32" = 1'-0"

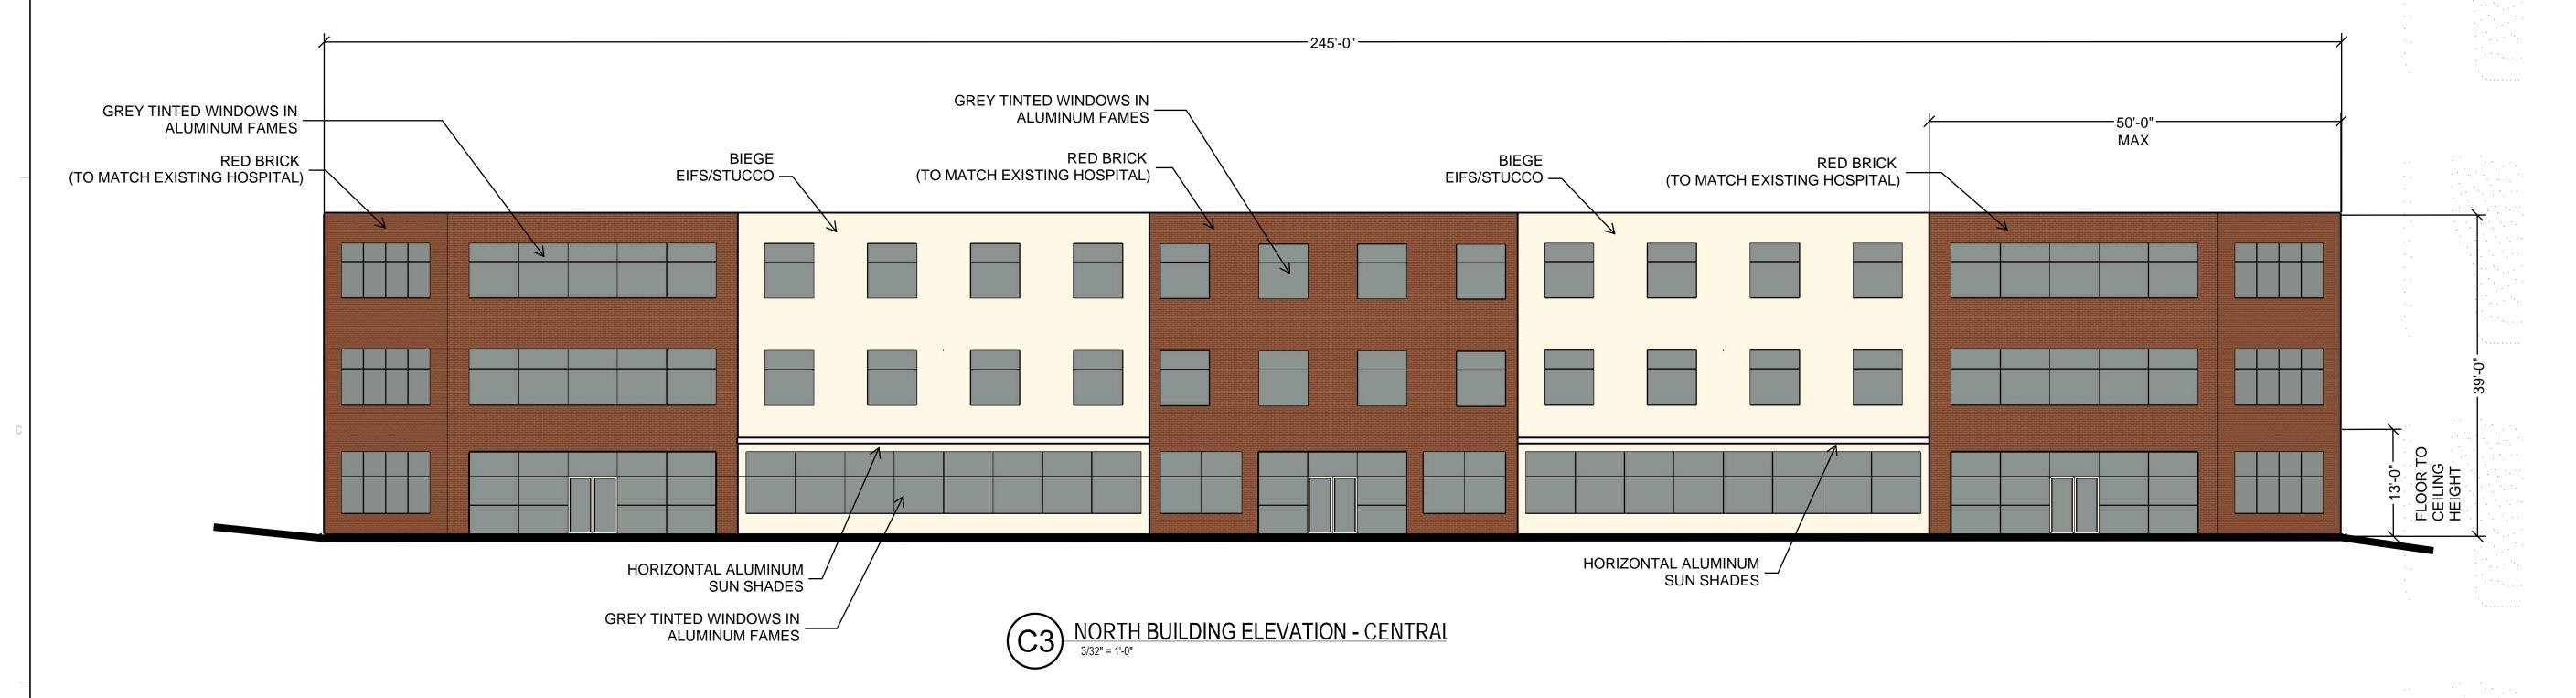PRESBYTERIAN HOSPITAL SITE DEVELOPMENT PLAN FOR BUILDING PERMIT

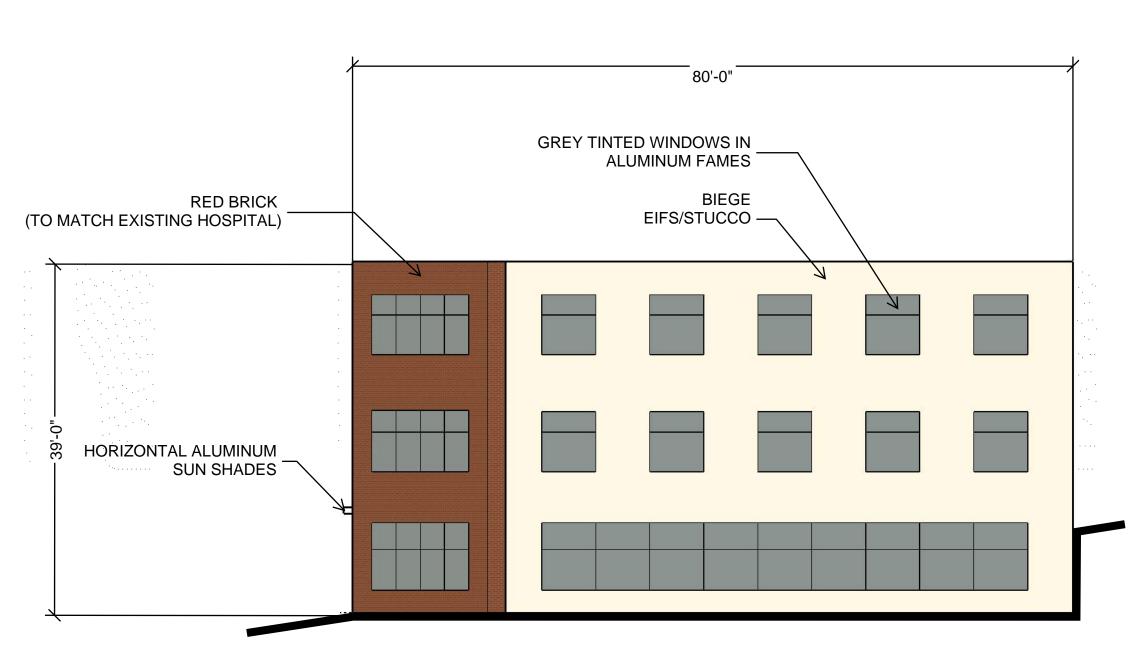/e SE | 87106

1100 Central Ave Albuquerque, NM 8

10/01/2019

19-0010.001

PROJECT

REVISIONS

A

DRAWN BY

P. MOORE

REVIEWED BY

A. SANTI

PROJECT NO:

DRAWING NAME

DATE

BUILDING ELEVATIONS

SCALE: 3/32" = 1'-0"

SDP5-6

GENERAL NOTES

- 1. ALL ACCESS ROADS AND FIRE LANES SHALL BE CAPABLE OF SUPPORTING AN IMPOSED LOAD OF A FIRE APPARATUS WEIGHING 75,000 LBS.
- 2. THE MINIMUM DRIVE ISLE WIDTH SHALL BE 24' UNLESS NOTED OTHERWISE. 3. ALL ACCESS ROADS AND FIRE LANES SHALL ACCOMMODATE A 28' MINIMUM
- INSIDE TURNING RADIUS. 4. BUILDINGS SHALL HAVE APPROVED ADDRESS NUMBERS OR BUILDING IDENTIFICATION PLACED IN A POSITION PLAINLY LEGIBLE AND VISIBLE FROM THE
- 5. ALL DRIVING SURFACES SHALL NOT EXCEED 10 PERCENT IN GRADE. 6. FIRE DEPARTMENT CONNECTIONS SHALL BE LOCATED WITHIN 100' OF A
- HYDRANT AND BE UNOBSTRUCTED FROM ANY OBJECT FOR A MINIMUM DISTANCE 7. POST INDICATOR VALVES SHALL BE PROVIDED PER NFPA 13.
- 8. A KNOX BOX SHALL BE PROVIDED AT THE ENTRANCE OF THE PROPOSED
- 9. CLASS 1 STANDPIPE SYSTEM SHALL BE INSTALLED THROUGHOUT AND THE STANDPIPE FDC SHALL BE LOCATED WITHIN 100' OF A HYDRANT.

PROJECT DATA

HOSPITAL AREA PHASE I ADDITION: 333,442 SQ. FT.

FIRE FLOW CALCULATION AREA: 835,845 SQ. FT. TOTAL AREA OF LARGEST 3 SUCCESSIVE FLOORS (IFC B104.3)

CONSTRUCTION TYPE: IA, SPRINKLERED OCCUPANCY TYPE: I-2, HOSPITAL

AN AUTOMATIC SPRINKLER AND SMOKE DETECTION SYSTEM SHALL BE INSTALLED THROUGHOUT THE BUILDING. SPRINKLER CONTRACTOR TO SUBMIT SHOP DRAWINGS TO THE AUTHORITY HAVING JURISDICTION. FIRE ALARM SYSTEM TO BE PROVIDED.

FIRE FLOW: IFC TABLE B105.1(2) AND B105.2 FIRE FLOW CALCULATION AREA: 835,845 SQ. FT. = 6,000(.5) = 3,000 GPM

FIRE HYDRANTS:

REQUIRED 8 (AVERAGE 400' SPACING)

OPEN GARAGE AREA FIRE FLOW CALCULATION AREA: 135,214 SQ. FT. TOTAL AREA OF THE LARGEST FLOOR (IFC B104.3)

CONSTRUCTION TYPE: 1B, NON-SPRINKLERED

FIRE FLOW: IFC TABLE B105.1(2)

FIRE FLOW CALCULATION AREA: 135,214 SQ. FT. = 4,000 GPM

FIRE HYDRANTS:

5 (AVERAGE 350' SPACING)

CENTRAL PLANT

FIRE FLOW CALCULATION AREA: 21,727 SQ. FT.

CONSTRUCTION TYPE: 1A, SPRINKLERED

FIRE FLOW: IFC TABLE B105.1(2) AND B105.2 FIRE FLOW CALCULATION AREA: 21,727 SQ. FT. = 1,500(.5) = 750 GPM THE REDUCED FIRE-FLOW SHALL NOT BE LESS THAN 1,000 GPM

FIRE HYDRANTS:

3 (AVERAGE 500' SPACING)

SHEET KEYED NOTES

- EXISTING AMBULANCE/LOADING AREA
- **EXISTING LOADING DOCK EXISTING PATIENT DROP-OFF**
- 4. PROPOSED POST INDICATOR VALVE (PIV)
- 5. FIRE LANE MARKINGS TO BE APPLIED TO CURBS BOTH SIDES OF THE INDICATED FIRE LANE AND SHALL COMPLY WITH FIRE ORDINANCE 503.3 AND 503.3.1
- EXISTING FIRE HYDRANT LOCATION EXISTING FIRE DEPARTMENT CONNECTION (FDC)
- 8. EXISTING POST INDICATOR VALVE (PIV) PROPOSED KNOX BOX LOCATION
- PROPOSED BACKFLOW PREVENTER 11. PROPOSED FIRE COMMAND CENTER
- 12. PROPOSED FIRE PUMP ROOM
- 13. SECONDARY WATER SUPPLY FOR HIGH RISE
- 14. THE FIRE DEPARTMENT CONNECTION SHALL BE 3' CLEAR OF PARKING. THERE SHALL BE A 5' SEPARATION BETWEEN THE FIRE DEPARTMENT CONNECTION AND THE HYDRANT. THE HYDRANT SHALL BE 3' CLEAR OF PARKING 15. EXISTING 2-HR RATED FIRE SEPARATION
- 16. EXISTING 3-HR RATED FIRE SEPARATION
- 17. PROPOSED 2-HR RATED FIRE SEPARATION
- 18. PROPOSED FIRE DEPARTMENT CONNECTION (FDC)
- 19. EXISTING COMBINED STANDPIPE/SPRINKLER FDC (C TOWER) 20. EXISTING COMBINED STANDPIPE/SPRINKLER FDC (B TOWER AND MAYTAG)
- 21. EXISTING STANDPIPE FDC (D&E TOWERS)
- 22. EXISTING SPRINKLER FDC (D&E TOWERS)

LEGEND

EXISTING FIRE ACCESS LANE PROPOSED FIRE ACCESS LANE

FIRE HYDRANT

FDC FIRE DEPARTMENT CONNECTION (FDC) POST INDICATOR VALVE (PIV)

HEIGHT HEIGHT AS MEASURED FROM THE HIGHEST OCCUPIABLE FLOOR TO THE LOWEST ADJACENT GRADE

EXISTING 2-HR RATED FIRE SEPARATION

EXISTING 3-HR RATED FIRE SEPARATION

PROPOSED 2-HR RATED FIRE SEPARATION

VICINITY MAP




DEKKER PERICH

ARCHITECTURE / DESIGN / INSPIRATION

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PROJECT

PITAL

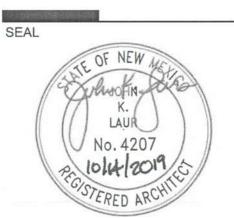REVISIONS

PRESB

DRAWN BY

REVIEWED BY DATE 10/14/2019

PROJECT NO. DRAWING NAME

FIRE 1 PLAN 19-000907 (PHASE 1)

19-0010.011

SIGNATURE / MAN NI IMPER / DATE

07 PREVIOUS APPROVAL NOD

06 PREVIOUS APPROVAL NOD

CITY OF ALBUQUERQUE

PLANNING DEPARTMENT URBAN DESIGN & DEVELOPMENT DIVISION 600 2nd Street NW, 3rd Floor, 87102 P.O. Box 1293, Albuquerque, NM 87103 Office (505) 924-3860 Fax (505) 924-3339



OFFICIAL NOTIFICATION OF DECISION

September 13, 2019

RECEIVED
SEP 1 6 2019

Presbyterian Healthcare Services P.O. Box 26666 Albuquerque, NM 87125-6666

Project #2019-002661 SI-2019-00250 — Site Plan

Dekker/Perich/Sabatini

LEGAL DESCRIPTION:

The above action for Tracts 1-A, 2-A, 3-A, 4-A and 9-A, Plat of Tract 1-A, 2-A, 3-A, 4-A and 9-A Presbyterian Hospital-Main Campus; Tracts 5, 6, and 7 Plat of Tracts 1 thru 9 Presbyterian Hospital- Main Campus Phase One; Tract 8-A Correction Plat of Tract 8-A Presbyterian Hospital- Main Campus Phase One, zoned MX-H, located south of Central Ave. SE, north of Lead Ave. SE, east of Oak St. SE, and west of Sycamore St. SE (1100 Central Ave. SE), containing approximately 28 acres. (K-15). Staff Planner: Catalina Lehner

PO Box 1293

AlbuquerqueOn September 12, 2019 the Environmental Planning Commission (EPC) voted to APPROVE Project 2019-002661/SI-2019-00250, a Site Plan-EPC Major Amendment, based on the following Findings and subject to the following Conditions of Approval:

NM 87103 FINDINGS:

- 1. The request is for a Major Amendment of a Prior Approval of a Site Development Plan for a property known as the Presbyterian Downtown Hospital Campus, located south of Central Avenue SE, north of Lead Avenue SE, east of Oak Street SE, and west of Sycamore Street SE (1100 Central Avenue SE- the "subject site"). The subject site is approximately 28 acres and is owned by Presbyterian Healthcare Services.
 - 2. The request consists of the following four major changes to the existing, governing site development plan:
 - 1. Additional square footage of 454,000 sf for hospital support and patient rooms in two phases
 - o Phase I: a 3-story addition (118,752 square feet)
 - o Phase I: an 8-story patient tower on top of the 3-story addition (214,690 square feet); 2-stories/20-feet higher than highest point on existing hospital located directly to the south of the existing hospital.
 - o Phase II: addition to 3-story (120,607 square feet)
 - 2. Additional square footage of 8,000 sf to the Central Plant mechanical area-

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- o Phase I: addition (2,750 square feet)
- o Phase II: addition (4,430 square feet)
- 3. Additional square footage of 405,276 sf for a three-story parking garage with 1196 spaces, Phase I
- 4. Associated, ancillary site work
- 3. The request exceeds the thresholds for a Minor Amendment, and therefore is being considered pursuant to Section 14-16-6-4(Y)(1)(b)1, which states that Major Amendments shall be reviewed and decided by the decision-making body that issued the approval being amended. The EPC approved the existing site development plan for the subject site prior to effective date of the IDO. Pursuant to IDO Section 14-6-4(P)(2), the decision-making body may impose conditions necessary to bring the application into compliance with the requirements of this IDO.
- 4. The subject site is located in an Area of Change area as designated by the Comprehensive Plan. Located along Central Ave., the subject site is along a Main Street Corridor and is in a Premium Transit Area. Central Ave. is the only street that is currently designated a Premium Transit Corridor.
- 5. The Albuquerque/Bernalillo County Comprehensive Plan, the Integrated Development Ordinance (IDO), and the Sycamore Metropolitan Redevelopment Plan are incorporated herein by reference and made part of the record for all purposes.
- 6. The request generally furthers the following, applicable Goal and policies regarding Centers and Corridors:
 - A. Goal 5.1-Centers & Corridors: Grow as a community of strong Centers connected by a multi-modal network of Corridors.
 - <u>Policy 5.1.1-Desired Growth:</u> Capture regional growth in Centers and Corridors to help shape the built environment into a sustainable development pattern.
 - The request would allow new infill development and well-paying employment opportunities to located along a designated Corridor, a location that is deemed appropriate area to accommodate higher density and intensity of growth over time to facilitate the City's vision for sustainable growth patterns, while reducing development pressures on the urban fringe and established neighborhoods.
 - B. <u>Policy 5.1.2-Development Areas:</u> Direct more intense growth to Centers and Corridors and use Development Areas to establish and maintain appropriate density and scale of development within areas that should be more stable.
 - As stated above, directing intense healthcare uses into a long established medical campus within a designated Premium Transit Corridor and an Area of Change would ensure that the higher density and intensity of development is absorbed in areas deemed appropriate by the Comprehensive Plan, thereby protecting the stability, density, and scale of established residential neighborhoods and Areas of Consistency.
 - C. <u>Policy 5.1.8-Premium Transit Corridors</u>: Foster corridors that prioritize high capacity, high-frequency transit service, with mixed-use, transit oriented development within walking

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distance of transit stations.

The request is a proposed expansion on a designated Main Street and Premium Transit Corridor which promotes higher-density development near the street as intended and transit, thereby helping to shape the environment into a sustainable development pattern. The request increases density, intensity, and capacity along a high-frequency transit service, the Albuquerque Rapid Transit (ART) by providing additional uses to include more health-related services within walking distance of a transit station. The location of the increased capacity across from the expected hotel, multi-family, commercial mixed-use development should deliver a synergy intended along this corridor.

7. The request furthers the following Comprehensive Plan Goals and policies pertaining to development patterns:

Goal 5.3-Efficient Development Patterns: Promote development patterns that maximize the utility of existing infrastructure and public facilities and the efficient use of land to support the public good.

Policy 5.3.1-Infill Development: Support additional growth in areas with existing infrastructure and public facilities.

Infilling more intense healthcare services into an established medical campus with existing city infrastructure, which can be easily served by transit, leverages public and private investments.

<u>Policy 5.3.3-Compact Development:</u> Encourage development that clusters buildings and uses in order to provide landscaped open space and/or plazas and courtyards.

The request proposes an increase in density and services along existing high-capacity corridors including Central Avenue and Interstate-25, which promotes a development pattern that maximizes these existing public facilities and infrastructure. In addition, this request encourages the clustering of buildings and increases the height of existing buildings in order to provide landscaped open space on-site.

8. The request generally furthers Goal 5.6, Policy 5.6.2, and Policy 5.6.4 as follows:

Goal 5.6-City Development Areas: Encourage and direct growth to Areas of Change where it is expected and desired and ensure that development in and near Areas of Consistency reinforces the character and intensity of the surrounding area.

<u>Policy 5.6.2-Areas of Change:</u> Direct growth and more intense development to Centers, Corridors, industrial and business parks, and Metropolitan Redevelopment Areas where change is encouraged.

Policy 5.6.4 -Appropriate Transitions: Provide transitions in Areas of Change for development abutting Areas of Consistency through adequate setbacks, buffering, and limits on building height and massing.

The subject site is located in a designated Area of Change, identified by the Comp Plan as an appropriate location for the development of higher density and intensity growth that can be supported by multi-modal transportation. The intent is specifically to focus on "new urban-scale development that benefits job creation and expanded housing options" so that additional

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residents, services, and jobs can be accommodated in locations ready for new development.

The request directs more intense healthcare services to a designated Premium Transit Corridor in an Area of Change, areas where higher density and intensity development is desired and encouraged, and best-served with transit and other infrastructure. Allowing healthcare services within these areas encourages development that expands well-paying employment opportunities that are easily accessed by a variety of travel modes.

The subject site is also located in, and encouraging development and change in, the Sycamore Metropolitan Redevelopment Area. The subject site provides an appropriate transition from Central Avenue where Areas of Change are largely located to the Areas of Consistency in the surrounding neighborhoods through setbacks buffering and limiting the height of the proposed parking garage. Because the subject site is located near many intense uses including a Premium Transit Corridor, Interstate-25, Downtown, UNM, and CNM, it is an appropriate location for higher development and density.

9. The request furthers the following Goal and policies regarding Transportation:

Goal 6.1-Transportation Integration: Plan, develop, operate, and maintain a transportation system to support the planned character of existing and future land uses.

<u>Policy 6.1.3-Auto Demand:</u> Reduce the need for automobile travel by increasing mixed-use development, infill development within Centers, and travel demand management (TDM) programs.

<u>Policy 6.1.2-Transit-Oriented Development:</u> Prioritize transit-supportive density, uses, and building design along Transit Corridors.

The subject site is located on Central Avenue, currently the only Premium Transit Corridor in the City. Therefore, increasing transit-supportive density, intensity, and capacity, including jobs and hospital users in this location, as opposed to locations on other corridors, generally reduces the need for automobile travel and increases infill development.

- 10. The request furthers the following Goal and policy pairs regarding Urban Design:
 - A. <u>Goal 7.3-Sense of Place:</u> Reinforce sense of place through context-sensitive design of development and streetscapes.

Policy 7.3.5-Development Quality: Encourage innovative and high quality design in all development.

The project will reinforce the streetscape with the architectural additions and will provide open space through the interior of the campus which provides a sense of place. Though the applicant is generally proposing high quality materials, IDO requirements regarding provision of outdoor space and building façade design are not met.

B. <u>Goal 7.4-Context-Sensitive Parking:</u> Design parking facilities to match the development context and complement the surrounding built environment.

<u>Policy 7.4.1-Parking Strategies:</u> Provide parking options, optimize parking efficiencies, and plan for parking as essential infrastructure.

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The project will include context sensitive parking by providing a parking garage with high quality materials that will complement the surrounding built environment, though façade design needs to meet IDO requirements. The structure will provide parking options by providing essential parking infrastructure to support the hospital functions.

11. The request does not further the following Goal and policy regarding walkability:

Goal 7.2 Pedestrian-Accessible Design: Increase walkability in all environments, promote pedestrian-oriented development in urban contexts, and increase pedestrian safety in auto-oriented contexts.

Policy 7.2.1 Walkability: Ensure convenient and comfortable pedestrian travel.

The project will increase development in a generally walkable environment; however, proposed crosswalks are striped and do not meet IDO requirements. The project also includes a large parking garage near Central Avenue, which creates a "dead" use in a Premium Transit area significant for pedestrians. The IDO requires a maximum setback of 15-feet from Central Avenue, a Main Street Corridor, to promote walkability but the applicant is proposing an unspecified future commercial building that may not be developed.

- 12. Conditions of approval are needed to create compliance with applicable IDO regulations and to provide clarification and to ensure that all applicable requirements are met.
- 13. The applicant notified the Silver Hill Neighborhood Association, the Spruce Park Neighborhood Association, the Sycamore Neighborhood Association, the University Heights Neighborhood Association, the Victory Hills Neighborhood Association, the Edo Neighborhood Association, and the Huning Highland Historic District Association, as required. The applicant also notified property owners within 100-feet of the subject site's boundaries, as required. Staff has not been contacted as of this writing.
- 14. The applicant conducted three neighborhood meetings on June 26th, July 1st, and July 17th of 2019 prior to application. Most of the concerns focused on the proposed parking garage, as well as general safety, noise, and traffic impacts to the adjacent neighborhoods.

CONDITIONS OF APPROVAL:

- 1. The EPC delegates final sign-off authority of this site development plan to the Development Review Board (DRB) to ensure all technical issues are resolved. The DRB is responsible for ensuring that all EPC Conditions have been satisfied and that other applicable City requirements have been met. A letter shall accompany the submittal, specifying all modifications that have been made to the site plan since the EPC hearing, including how the site plan has been modified to meet each of the EPC conditions. Unauthorized changes to this site plan, including before or after DRB final sign-off, may result in forfeiture of approvals.
- 2. The applicant shall meet with the Staff planner prior to applying to the DRB to ensure that all conditions of approval are met. Upon receiving final approvals, the applicant shall submit a finalized version of the site plan for filing at the Planning Department.

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3. Setbacks:

The request shall comply with the Mixed-Use Zone District Dimensional Standards in Table 5-1-2, particularly the maximum front setback of 15-feet along Central Avenue, by doing one of the following: A Variance-EPC, moving the parking garage to meet the requirement, or including a structure (that meets the IDO definition of a structure) that will be constructed as part of the site plan.

4. Neighborhood Edges:

- A. The parking garage shall comply with Section 5-9-(C), Building Height Stepdown, and not exceed 30 feet in height.
- B. A note shall be added to the site plan to explain how the compliance is shown on the elevations.

5. Pedestrian Circulation:

- A. The crosswalks shall comply with Section 5-3-(D)(3)(C) regarding appropriate materials for crosswalks.
- B. The crosswalk detail shall be updated accordingly.

6. Parking Calculations:

- A. The parking calculations shall be revised to incorporate the appropriate parking provision rates in the IDO.
- B. The accessible parking calculations shall be revised to include the accessible parking with the regular parking pursuant to 5-5(C)(7).
- C. The motorcycle parking calculations shall be redone and the required motorcycle parking provided pursuant to IDO 5-5(D).

7. Parking Area Design:

- A. The parking structure shall be designed using CEPTED principles as required in Section 5-5(G); see conditions from the Police Department.
- B. Loading spaces shall be shown on the site plan and compliance with the requirements in Section 5-5(H), regarding layout and design of loading areas, demonstrated.

8. Walls:

- A. The proposed, new walls shall comply with the wall design requirements in 5-7(E).
- B. A front-facing wall detail shall be provided.
- 9. Lighting: The maximum, allowable height for light poles in the mixed-use zone districts, 20 feet pursuant to IDO 5-8-(D)(7), shall be indicated on the light pole detail.

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10. Outdoor Gathering Areas:

- A. The applicant shall provide outdoor gathering areas required in PT areas pursuant to Section 5-11(E)(3).
- B. Calculations for the outdoor gathering areas shall be provided.

11. Landscaping:

- A. A calculation shall be provided demonstrate compliance with the definition of Vegetative Screen, which is required pursuant to Section 5-6(E)(2)(b), in PT areas. Additional plants shall be added if the vegetative screen is less than 75% opaque, as required.
- B. The width of the landscape buffer along Lead Ave. SE shall be clarified and meet applicable requirements, including amount of plant material.
- C. Only female juniper shall be used (Pollen Ordinance).
- D. Landscaping beds shall be depressed below grade.
- E. A curb cut detail shall be provided.
- F. Curb cuts shall be labeled and match locations on the grading and drainage plan(s).

12. Street Trees:

- A. The applicant shall coordinate with the City Forester regarding street trees, especially along Silver Ave., including a survey of street trees, removal of dead or near-dead trees, and evaluation of the irrigation system to ensure tree health over time.
- B. Street trees shall be replaced as necessary and comply with the IDO and the Street Tree Ordinance.

13. Façade Design

- A. The proposed parking garage shall incorporate additional design elements to comply with Section 5-5(G)(3) and 5-5(G)(4).
- B. The color of the panels on the parking garage shall be specified (not earthtone).

14. CONDITIONS FROM THE CITY ENGINEER/TRANSPORTATION:

- Developer is responsible for permanent improvements to the transportation facilities adjacent to the proposed development site plan, as required by the Development Review Board (DRB).
- Site plan shall comply and be in accordance with all applicable City of Albuquerque requirements, including the Development Process Manual and current ADA criteria.

The following comments need to be addressed prior to DRB:

• Please list the width and length for all existing and proposed parking spaces. If they are all the same list as typical.

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- The ADA accessible spaces must include an access aisle. Van accessible aisles should be 8ft wide; all others should be 5ft wide.
- The ADA parking spaces should each have an accessible parking sign and must have the required language per 66-7-352.4C NMSA 1978 "Violators Are Subject to a Fine and/or Towing." Please call out detail and location of HC signs.
- The ADA access aisles shall have the words "NO PARKING" in capital letters, each of which shall be at least one foot high and at least two inches wide, placed at the rear of the parking space so as to be close to where an adjacent vehicle's rear tire would be placed. (66-1-4.1.B NMSA 1978)
- List radii for all curves shown; for passenger vehicles, the minimum end island radius for passenger vehicles is 15 ft. Radius for delivery trucks, fire trucks, etc. is 25 ft. or larger.
- Per DPM, a 6 ft. wide ADA accessible pedestrian pathway is required from the HC parking stall access aisles to the building entrances. Please clearly show this pathway and provide details.
- Please provide a copy of approval from Solid Waste.

On the west side of Mulberry Street just south of Silver Avenue, provide sidewalk connection around power pole at the driveway access and a new 4-foot ADA pathway. Reconstruct this access prior to final plat approval or provide infrastructure list showing improvement.

15. CONDITION FROM NMDOT:

Possible Impacted NMDOT roadway(s): I-25 & Central Interchange & Oak St Department. The NMDOT is requiring the owner and engineering consultant to continue coordination with NMDOT Assistant Traffic Engineer Margaret Haynes 505-288-2086 Margaret.haynes@state.nm.us on the proposed improvements and potential offsite improvements.

16. CONDITIONS FROM HYDROLOGY:

- A. Hydrology recommends that final signoff of this Site Plan be delegated to the Development Review Board in order to identify Infrastructure requirements, project phasing, and conformance with the Flood Hazard and Drainage Control Ordinance.
- B. The grading plan included in the Site Plan is insufficient in addressing the above concerns; a more detailed plan will be required prior to DRB approval.

17. CONDITION FROM THE SOLID WASTE MANAGEMENT DIVISION:

Clearly indicate all existing refuse areas within the proposed addition areas on Site Plan (Pg. SDP 1-1) to verify continued, safe refuse truck access.

18. CONDITIONS FROM THE POLICE DEPARTMENT:

- A. Ensure adequate lighting throughout the project exterior lighting on the Community Center and any future building(s).
- B. Ensure adequate lighting throughout the project, to include parking areas, pedestrian

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walkways, and courtyards.

- C. Ensure natural surveillance and clear lines of sight throughout the facility. Natural surveillance requires a space free from natural and physical barrier (i.e. open picket vs. solid fences). Establish a clear line of sight from the parking areas to the street and the buildings and from the buildings and street the parking areas.
- D. Limit and clearly delineate access to the property; i.e. Employee Parking, Visitor Parking, Deliveries.
- E. Clearly delineate public, semi-public, semi-private, and private space throughout the project.
- F. Install No Trespassing signs that cite the City Ordinance so that they are visible immediately upon entering the property.
- G. Consider installing electronic surveillance (cameras) to monitor entrance and exit points, parking areas, Central Plant and other potential high theft areas.

19. CONDITIONS FROM PNM:

A. This project may impact electric substation capacity needs for the surrounding area.

As a condition, it is necessary for the developer to contact PNM's New Service Delivery Department early in the process to coordinate electric service regarding the project to avoid potential delays in meeting in-service target dates. Contact:

Andrew Gurule, PNM Service Center 4201 Edith Boulevard NE Albuquerque, NM 87107 Phone: (505) 241-0589

- B. There is an existing overhead electric distribution line and an underground distribution line located along the north side of the alley between Silver SE and Lead SE within the area of the proposed new addition to the Central Plant. The electric lines should be indicated on Sheet SDP1-2.
- C. Any relocation, changes or realignment regarding existing electric utilities will be the developer's expense. In some cases, relocation or changes to existing facilities may not be feasible due to physical, use or safety clearance constraints. PNM will review all technical needs, issues and safety clearances for its electric systems.
- D. It is necessary for the applicant to coordinate with PNM's New Service Delivery to ensure that compliance with the National Electrical Safety Code for both horizontal and vertical clearances are met between the existing distribution line and the proposed building footprint. The customer must also ensure applicable OSHA safe working clearance requirements for employees and equipment with respect to PNM's lines are met during and after construction of the building.

For relocations of overhead and underground electrical equipment, please contact:

Mike Moyer, PNM Service Center 4201 Edith Boulevard NE, Albuquerque, NM 87107, Phone: (505) 241-3697.

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SEP **16** 2019

Dekker/Perion/Sabatini

APPEAL: If you wish to appeal this decision, you must do so within 15 days of the EPC's decision or by SEPTEMBER 27, 2019. The date of the EPC's decision is not included in the 15-day period for filing an appeal, and if the 15th day falls on a Saturday, Sunday or Holiday, the next working day is considered as the deadline for filing the appeal.

For more information regarding the appeal process, please refer to Section 14-16-6 of the IDO, Administration and Enforcement. A Non-Refundable filing fee will be calculated at the Land Development Coordination Counter and is required at the time the appeal is filed. It is not possible to appeal EPC Recommendations to City Council; rather, a formal protest of the EPC's Recommendation can be filed within the 15 day period following the EPC's recommendation.

You will receive notification if any person files an appeal. If there is no appeal, you can receive Building Permits at any time after the appeal deadline quoted above, provided all conditions imposed at the time of approval have been met. Successful applicants are reminded that other regulations of the City Zoning Code must be complied with, even after approval of the referenced application(s).


Sincerely,

Brennon Williams Planning Director

BW/CL

cc: Presbyterian Healthcare Services, P.O. Box 26666, ABQ, NM 87125-6666 Dekker/Perich/Sabtini (DPS), Attn: Will Gleason, 7601 Jefferson NE, Suite 100, ABQ, NM 87109 Silver Hill NA, James Montalbano, 1409 Silver Ave. SE, ABQ, NM 87106 Silver Hill NA, Jill Marley Berry, 1906 Silver Ave. SE, ABQ, NM 87106 Spruce Park NA, Peter Feibelman, 1401 Sigma Chi Rd. NE, ABQ, NM 87106 Spruce Park NA, James Tolbert, 424 Spruce St. NE, ABQ, NM 87106 Sycamore NA, Peter Schilke, 1217 Coal Ave. SE, ABQ, NM 87106 Sycamore NA, Mardon Gardelia, 411 Maple St. NE, ABQ, NM 87106 University Heights NA, Julie Kidder, 120 Vassar Dr. SE, ABQ, NM 87106 University Heights NA, Don Hancock, 105 Stanford Dr. SE, ABQ, NM 87106 Victory Hills NA, Patricia Wilson, 505 Dartmouth Dr. SE, ABQ, NM 87106 Victory Hills NA, Erin Engelbrecht, P.O. Box 40298, ABQ, NM 87196 Edo NA, Inc., Rob Dickson, P.O. Box 27439, ABQ, NM 87125 Edo NA, Inc., Vince DiGregory, P.O. Box 14616, ABQ, NM 87191 Huning Highland Historic Dist. Association, Bonnie Anderson, 321 High St. SE, ABQ, NM 87102 Huning Highland Historic Dist. Association, Ann Carson, 416, Walter St. SE, ABQ, NM 87102 Alan Varela, avarela@cabq.gov

PROPOSED SITE PLAN - APPLICABLE SHEETS

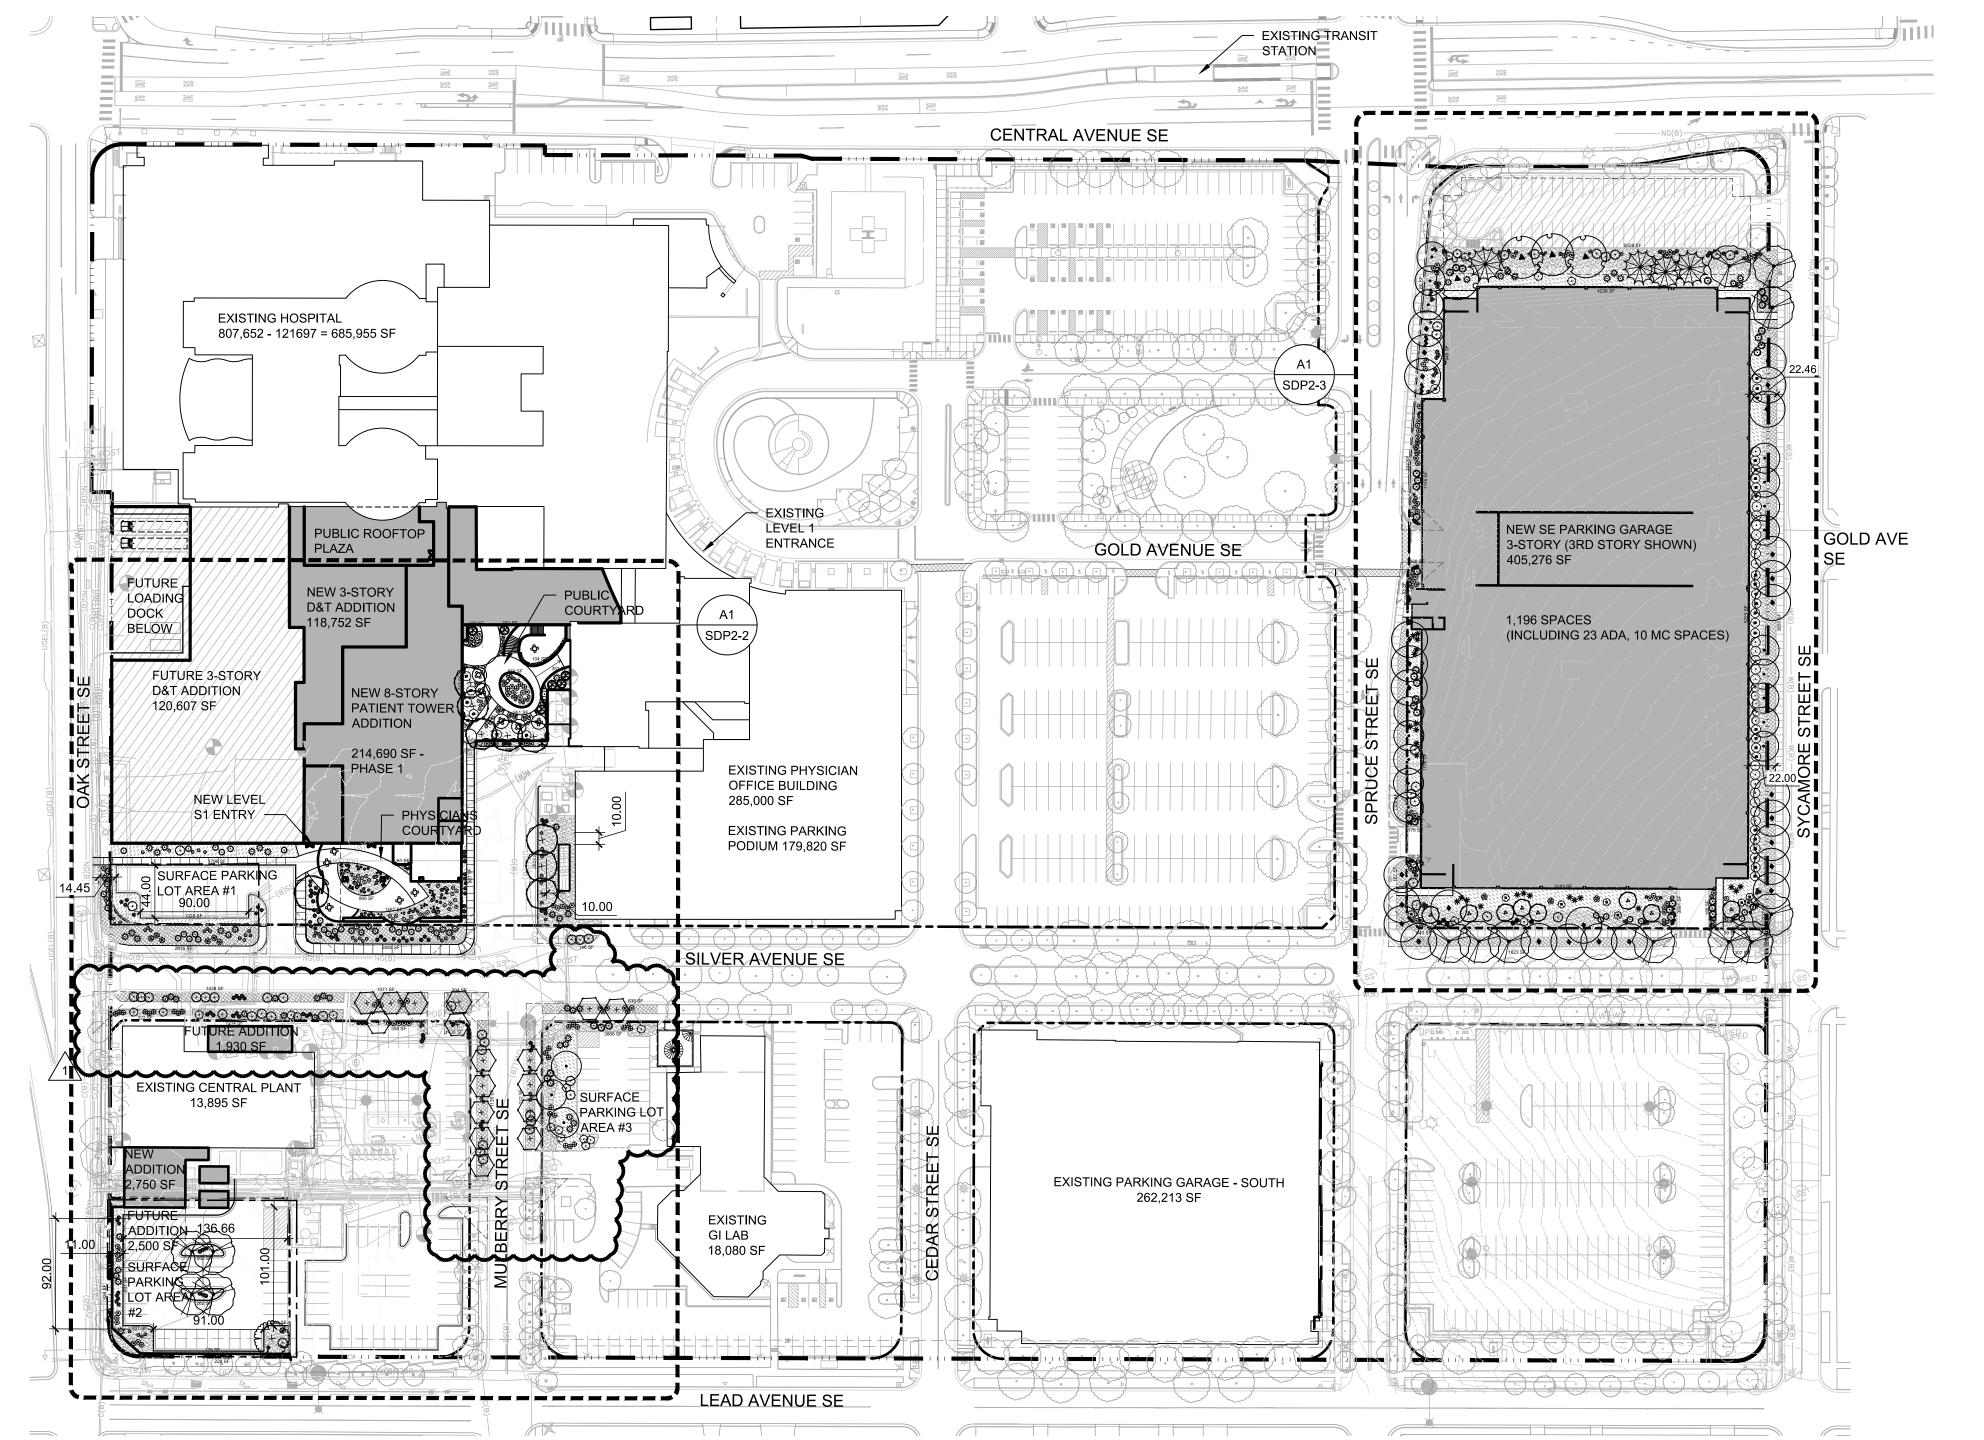

LANDSCAPE PLAN

GENERAL NOTES

- A. RESPONSIBILITY FOR MAINTENANCE: THE CONTRACTOR WILL BE RESPONSIBLE FOR MAINTENANCE OF THE LANDSCAPE DURING CONSTRUCTION AND DURING A 90 DAY-MAINTENANCE PERIOD FOLLOWING SUBSTANTIAL COMPLETION. THE OWNER WILL BE RESPONSIBLE FOR MAINTENANCE FOLLOWING THE 90-DAY MAINTENANCE
- STATEMENT OF COMPLIANCE WITH CITY OF ALBUQUERQUE: THE LANDSCAPE DESIGN WILL COMPLY WITH THE CITY OF ALBUQUERQUE'S GENERAL LANDSCAPING REGULATIONS AND WATER CONSERVATION ORDINANCES.
- TIMING OF LANDSCAPE INSTALLATION: INSTALLATION OF THE LANDSCAPING SHALL BE COMPLETE WITHIN 60 DAYS OF THE RELATED BUILDING'S OCCUPANCY. . SURFACE TREATMENT: ALL LANDSCAPE AREAS SHALL BE COVERED WITH MULCH. E. LANDSCAPE, FENCING, AND SIGNING WILL NOT INTERFERE WITH CLEAR SIGHT
- REQUIREMENTS. THEREFORE, SIGNS, WALLS, TREES, AND SHRUBBERY BETWEEN 3' AND 8' (AS MEASURED FROM THE GUTTER PAN) WILL NOT BE ACCEPTABLE IN THIS MINIMUM PLANT SIZES ARE AS PER CITY OF ALBUQUERQUE STANDARDS: 2" CALIPER
- TREES, 6' HEIGHT CONIFERS, AND 1 GALLON SHRUBS. 3. ALL AREAS DISTURBED DURING CONSTRUCTION, INCLUDING AREAS NOT WITHIN THE PROPERTY LINE, WILL BE STABILIZED.
- . ROOF DRAINS: SURFACE DRAINAGE OFF DOWNSPOUTS SHALL BE DIRECTED AWAY FROM BUILDINGS INTO LANDSCAPE AREAS OR ENGINEERED DRAINAGE SYSTEM. REFER TO CIVIL.
- VEGETATIVE SCREENING SURROUNDING GROUND-MOUNTED TRANSFORMERS AND UTILITY PADS SHALL ALLOW 10' OF CLEARANCE IN FRONT OF THE EQUIPMENT DOOR AND 5' OF CLEARANCE ON THE REMAINING SIDES FOR SAFE OPERATION AND MAINTENANCE
- . CONTRACTOR IS TO VERIFY ALL EXISTING UTILITY LOCATIONS BEFORE EXCAVATION AND PLANTING.
- . NEW PLANTINGS DO NOT INCLUDE HIGH WATER TURF.
- THE ABILITY TO PROVIDE STREET TREES IS LIMITED BY UTILITY EASEMENTS AND EXISTING UTILITIES.
- M. ORGANIC BARK MULCH IS PROVIDED AT EACH TREE FROM ROOT BALL EXTENDING OUT TO DRIPLINE PER CITY OF ALBUQUERQUE IDO 14-16-5-6(C)(5)(b) N. LANDSCAPE BEDS SHALL BE DEPRESSED BELOW ADJACENT SIDEWALK GRADE.

IRRIGATION NOTES

- ALL PLANTINGS SHALL BE IRRIGATED BY AUTOMATED IRRIGATION SYSTEMS, WITH PROGRAMMABLE SETTINGS. AUTOMATED SMART CONTROLLER. AND MOISTURE SENSOR TO AVOID OVERWATERING.
- 2. IRRIGATION TO EXISTING PLANTINGS TO REMAIN SHALL REMAIN OPERATIONAL 3. THE IRRIGATION SYSTEMS SHALL NOT IRRIGATE IMPERVIOUS SURFACES, INCLUDING SIDEWALKS, DRIVEWAYS, STREETS AND PARKING OR LOADING AREAS.
- . IRRIGATION POINTS OF CONNECTION TO THE CITY WATER WILL BE LOCATED WITHIN PROPERTY LIMITS AND SHALL COMPLY WITH THE CITY OF ALBUQUERQUE REDUCED PRESSURE BACKFLOW PREVENTER STANDARDS AND SPECIFICATIONS.
- EXAMPLE AND IRRIGATION ZONES SHALL BE BASED UPON PLANT SPECIES AND THEIR ESTABLISHMENT. RUN TIMES SHALL BE REGULARLY ADJUSTED ACCORDING TO PLANT MATURITY, SEASON, LOCATION AND PERFORMANCE.
- WHERE POSSIBLE NEW IRRIGATION WILL BE CONNECTED TO AN EXISTING SYSTEM. THERE ARE MULTIPLE IRRIGATION SYSTEMS ACROSS THE CAMPUS. IRRIGATION SYSTEM CONNECTIONS AND MAINLINES WILL BE LOCATED OUTSIDE OF FUTURE WORK ZONES.
- 8. PER CITY OF ALBUQUERQUE STANDARD IRRIGATION SPECIFICATIONS, THERE WILL BE (3) 0.25 GPM BUBBLERS PER TREE AND (1) 0.25 GPM BUBBLER PER SHRUB.

LEGEND

PERVIOUS AREAS

<u>SYMBOL</u> GRAVEL MULCH LANDSCAPE AREA ORGANIC MULCH LANDSCAPE AREA GRAVEL MULCH LANDSCAPE AREA IN R.O.W (EXCLUDED FROM LANDSCAPE CALCULATIONS) *GRAVEL MULCH WILL NOT EXCEED 50% OF PLANTING BED COVERAGE PER CITY OF ALBUQUERQUE IDO 14-16-5-6(C)(5)(c) EXISTING TREE TO REMAIN TABLE AND SEATING PROPERTY LINE

LANDSCAPE CALCULATIONS

GROSS LOT AREA = 26.33 AC = 1,147,082 SF AREA OF LOT COVERED BY BUILDING FOOTPRINT = 536,715 SF NET LOT AREA = 610.367 SF

CAMPUS BOUNDARY

PARKING LOT BOUNDARY

REQUIRED LANDSCAPE AREA = 61,037 SF (10% OF NET LOT AREA)

LANDSCAPE BEING ADDED = 52,687 SF

PROVIDED LANDSCAPE AREA EXISTING TO REMAIN + NEW = 157,571 SF (25% OF NET LOT AREA) (see hatch legend for exclusions from landscape areas) COURSED STREET TREES REQUIRED STREET TREES = 1 TREE PER 25' LINEAR FEET OF STREET FRONTAGE

STREET TREES = SYCAMORE STREET FRONTAGE = 567' TREES REQUIRED = 23

TREES PROVIDED = 23 SPRUCE STREET FRONTAGE = 569'

TREES REQUIRED = 23 TREES PROVIDED = 17 (9 ADDITIONAL TREES SHOWN NORTH OF STRUCTURE) SILVER AVE FRONTAGE (NORTH SIDE, OAK TO MULBERRY) = 300'

TREES REQUIRED = 12 TREES PROVIDED = 0, NEW UTILITY EASEMENT THROUGH THIS AREA SILVER AVE FRONTAGE (NORTH SIDE, SPRUCE TO SYCAMORE) = 300'

TREES REQUIRED = 12 TREES PROVIDED = 12 SILVER AVE FRONTAGE (SOUTH SIDE, OAK TO MULBERRY, UTILITIES NEAR CORNER) = 300

TREES PROVIDED = 4 (UTILITIES UNDER PARKWAY LANDSCAPE AREA) SILVER AVE FRONTAGE (SOUTH SIDE, MULBERRY TO EAST LIMIT OF DISTURBANCE) = 109' TREES REQUIRED = 5 TREES PROVIDED = 2 (+1 EXISTING TREE TO REMAIN, UTILITIES NEAR CORNER)

MULBERRY ST (WEST SIDE, PARKING LOT ENTRY TO SILVER AVE) = 156' TREES REQUIRED = 7 TREES PROVIDED = 5 (UTILITIES NEAR CORNER OF MULBERRY & SILVER)

MULBERRY ST (EAST SIDE, PARKING LOT ENTRY TO SILVER AVE) = 122' TREES REQUIRED = 5

TREES PROVIDED = 5 (UTILITIES NEAR CORNER OF MULBERRY & SILVER) FOTAL VEGETATIVE COVER REQUIRED = 37,495 SF (75% OF NEW LANDSCAPE AREA) TOTAL VEGETATIVE COVER PROVIDED = 46,459 SF (92% OF NEW LANDSCAPE AREA)

TOTAL GROUND-LEVEL PLANT COVER REQUIRED = 12,498 SF (25% OF LANDSCAPE AREA) TOTAL GROUND-LEVEL PLANT COVER PROVIDED = 15,119 SF (30% OF LANDSCAPE AREA)

TOTAL ROCK MULCH COVER ALLOWED = 24,997 SF (50% OF LANDSCAPE AREA) TOTAL ROCK MULCH COVER PROVIDED = 24,849 SF (49% OF LANDSCAPE AREA)

TREES PROVIDED:1

SURFACE PARKING LOT AREA #1 SURFACE PARKING LOT AREA # TOTAL AREA = 6,247 SF TOTAL # OF SPACES = 10 TREE REQUIRED:1

TOTAL AREA = 20,411 SF TOTAL # OF SPACES = 33 TREE REQUIRED:4 TREES PROVIDED:5

RFACE PARKING LOT AREA # TOTAL AREA = 5,306 SF TOTAL # OF SPACES = 18 TREE REQUIRED:2 TREES PROVIDED:2 ARCHITECTURE / DESIGN / INSPIRATION

PERICH

7601 JEFFERSON NE, SUITE 100 ALBUQUERQUE, NM 87109

505.761.9700 / DPSDESIGN.ORG

ARCHITECT



ENGINEER

PROJECT

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Albuqu

REVISIONS 1 05/27/2022 AA REVISION

DRAWN BY **REVIEWED BY** MB 07/25/2019 PROJECT NO. 19-0010.001

LANDSCAPE PLAN

DRAWING NAME

GENERAL NOTES

A. FOR MAINTENANCE STATEMENT AND IRRIGATION SYSTEM INFORMATION, SEE SDP 2-1. B. MINIMUM PLANT SIZES ARE AS PER CITY OF ALBUQUERQUE STANDARDS: 2" CALIPER TREES, 6' HEIGHT CONIFERS, AND 1 GALLON SHRUBS.

○ SHEET KEYNOTES

9. NEW PLANTINGS FOR SCREENING /

BUFFERING


12. SEAT WALL 7. 6'-8' TALL SCREEN WALL OR FENCE W/ GATE
8. EXISTING PLANTINGS TO REMAIN
13.3' MAX LANDSCAPE RETAINING WALL
14. BALCONY WITH SEATING ABOVE AND B 14. BALCONY WITH SEATING ABOVE AND BELOW

15.EXISITING SURFACE PARKING LOT TO

REMAIN 10. NEW PLANTING FOR GENERAL LANDSCAPING
11. CLEARANCE AROUND GROUND MOUNTED
17. 6' TALL VEGETATIVE BUFFER PER IDO COA

IDO 14-16-5-6(E)2(b), BUFFER DESIGNED TO BE 75% OPAQUE AT MATURITY 18. CURB CUT, SEE D2/SDP2-1


PLANT LEGEND

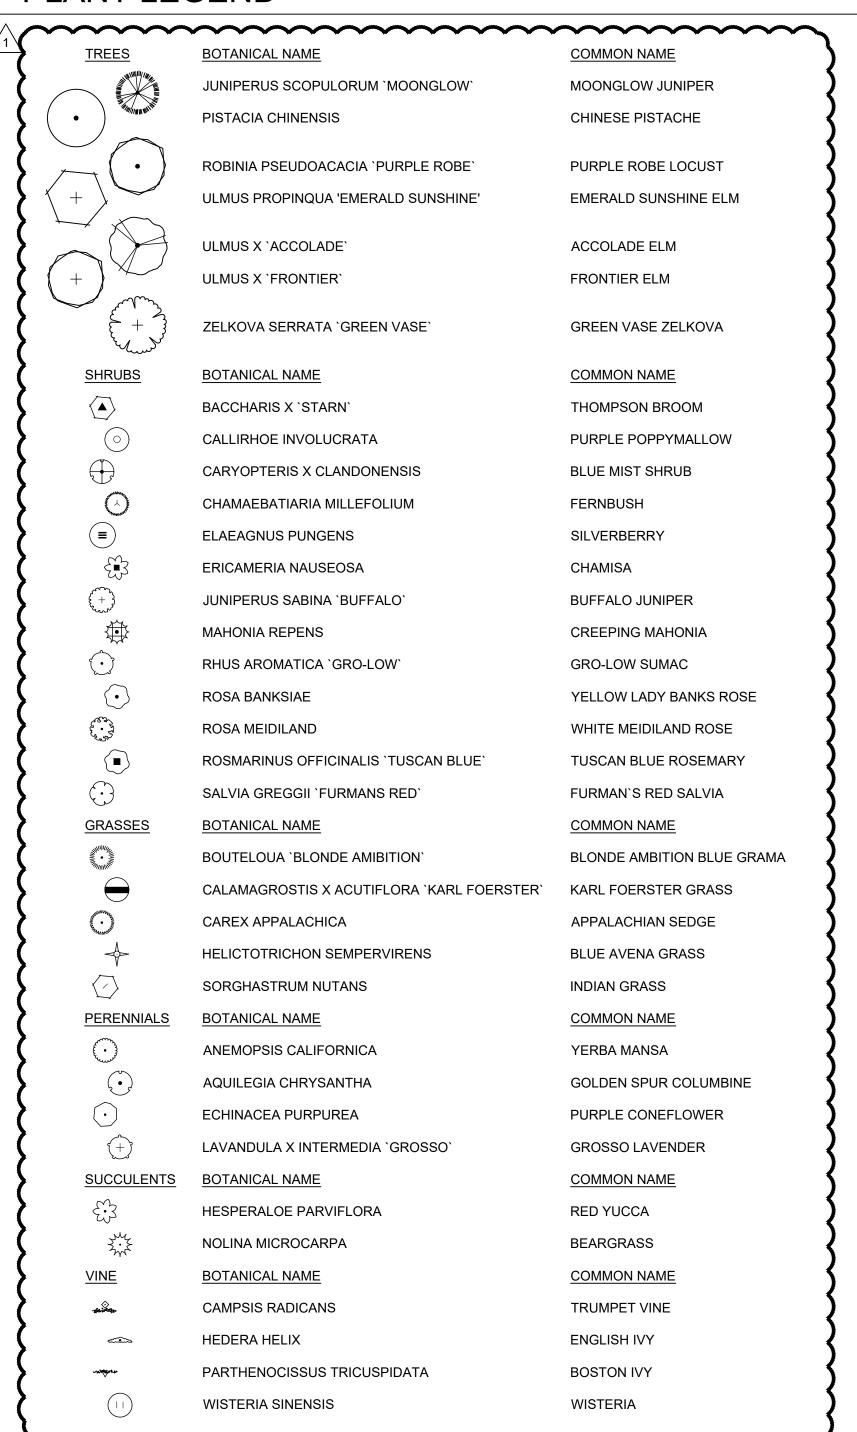

3/4"Ø ROCK MULCH AMARETTO BROWN 3" DEPTH OVER FILTER FABRIC IN R.O.W. NOT INCLUDED IN LANDSCAPE CALCULATIONS

AMARETTO BROWN 3" DEPTH OVER FILTER FABRIC

SHREDDED SCREENED BARK MULCH 3" DEPTH OVER FILTER FABRIC

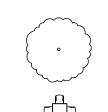

EXISTING TREE TO REMAIN

PROPERTY LINE

TABLE AND SEATING **CAMPUS BOUNDARY**

SHEET NO. PARKING LOT BOUNDARY

ARCHITECTURE / DESIGN / INSPIRATION

DEKKER PERICH SABATINI

7601 JEFFERSON NE, SUITE 100 ALBUQUERQUE, NM 87109

505.761.9700 / DPSDESIGN.ORG

ARCHITECT



ENGINEER

PROJECT

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LANDSCAPE PLAN **ENLARGMENT**

SDP2-2