
# DRAWING INDEX

SDP 1.1	SITE PLAN
SDP 1.2	SITE DETAILS
SDP 1.3	SITE DETAILS
SDP 1.4	ELECTRICAL SITE LIGHTING PLAN
SDP 1.5	ELECTRICAL SITE LIGHTING PLAN
SDP 2.1	LANDSCAPE PLAN
SDP 3.1	DRAINAGE PLAN
SDP 3.2	GRADING PLAN
SDP 3.3	UTILITY PLAN
SDP 5.1	EXTERIOR BUILDING ELEVATIONS
SDP 5.2	EXTERIOR BUILDING ELEVATIONS
SDP 5.3	EXTERIOR BUILDING ELEVATIONS
SDP 6.1	APPROVED FIRE ONE FOR REFERENCE
SDP 6.2	APPROVED WASTE MANAGEMENT FOR REFERENCE

# VICINITY MAP

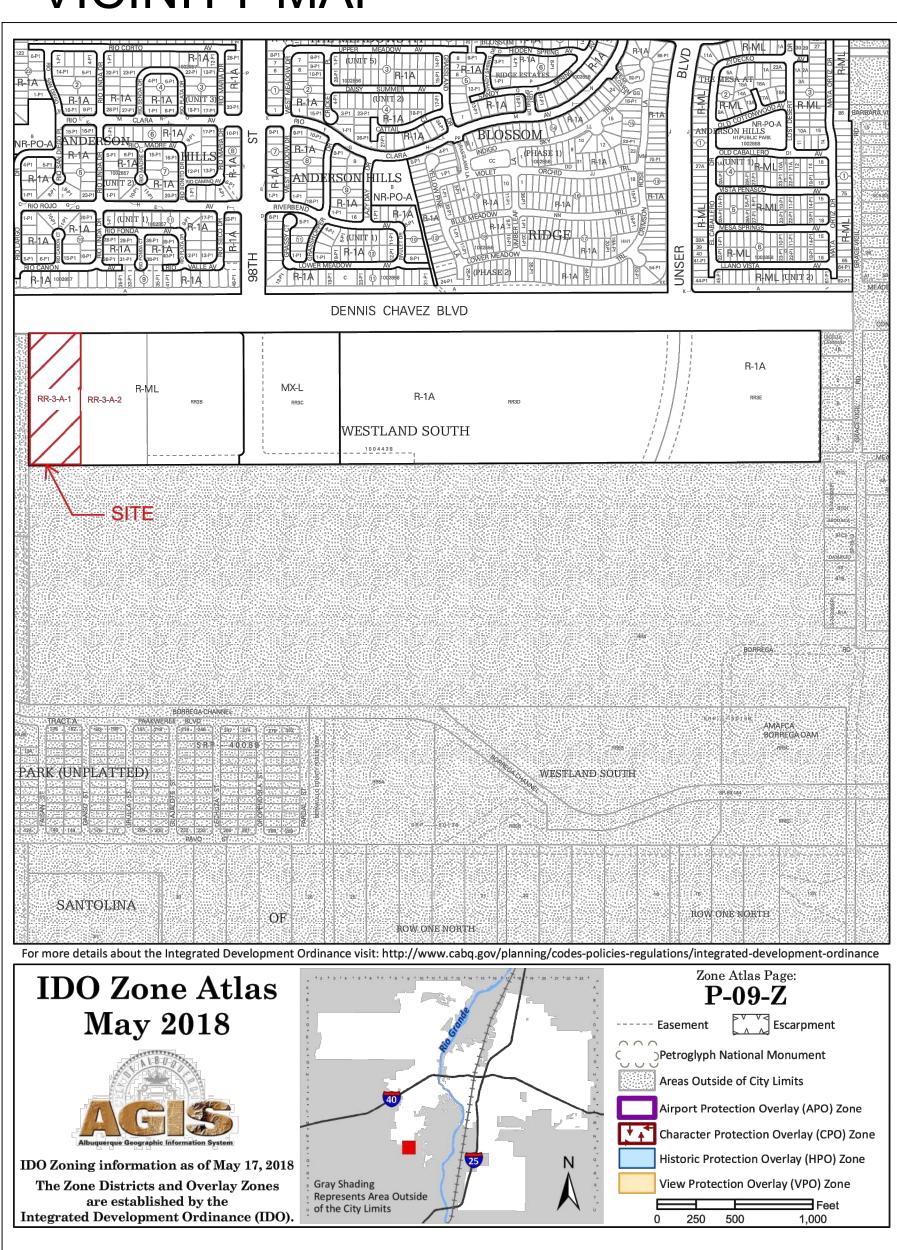

# CEJA VISTA

PROJECT TEAM

#### OWNER/CONTRACTOR

DGB PROPERTIES 2164 W. PARK PLACE PORTLAND, OR 87205-1125 PHONE: 505.402.0091

## ARCHITECT/LANDSCAPE

DEKKER/PERICH/SABATINI, LTD. 7601 JEFFERSON ST. NE, SUITE 100 ALBUQUERQUE, NM 87109 PHONE: 505.761.9700

#### CIVIL

333 RIO RANCHO DR. NE SUITE 101

## MECHANICAL ENGINEER

ARSED ENGINEERING GROUP, LLC. 4700 LINCOLN RD. NE ALBUQUERQUE, NM 87109 PHONE: 505.761.3100

## ELECTRICAL


AC ENGINEERING ENTERPRISES, LLC. 120 ALISO DR. SE ALBUQUERQUE, NM 87108 PHONE: 505.842.5787

DEKKER PERICH SABATINI

ARCHITECTURE / DESIGN / INSPIRATION

7601 JEFFERSON NE, SUITE 100 ALBUQUERQUE, NM 87109

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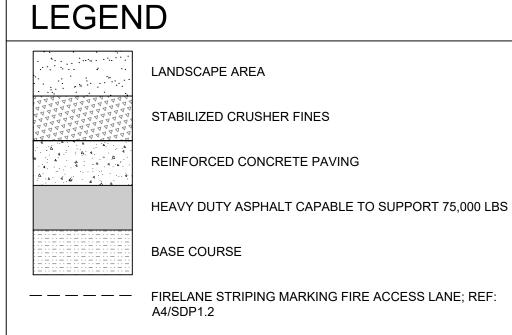
ENGINEER

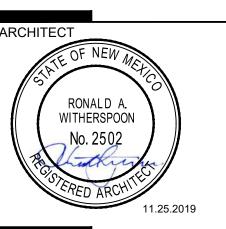CEJA VISTA 10001 CEJA VISTA ROAD SW ALBUQUERQUE, NEW MEXICO 8712

11/25/2019 19-0019

SDP FOR BUILDING **PERMIT** 

HUITT-ZOLLARS INC. RIO RANCHO, NM 87124 505.892.5141



PROPERTY LINE

○¹ FIRE HYDRANT

POST INDICATOR VALVE, RE: CONCEPTUAL UTILITY PLAN

FIRE DEPARTMENT CONNECTION

○ ♀ □ SITE LIGHTING

RAISED PLANTING BEDS

BIKE RACK

□□ 🗘 🐧 OUTDOOR FURNITURE

SIDEWALK RAMP (ARROW POINTS DOWN)

☐ TRANSFORMER WITH SAFETY BOLLARDS & 6" THICK

COMPACT PARKING; REF: D5/SDP1.3

PERICH SABATINI

ARCHITECTURE / DESIGN / INSPIRATION

505.761.9700 / DPSDESIGN.ORG



**ENGINEER** 

DATE:

DATE:

DATE:

DATE:

DATE:

DATE:

DATE:

DATE:

10001 CEJA BUQUERQUE

REVISIONS

DRAWN BY AG, RM REVIEWED BY RAW, JM 11/25/2019 PROJECT NO. 19-0019

SITE PLAN FOR BUILDING

DRAWING NAME

PERMIT

SHEET NO.

**GENERAL SHEET NOTES** SHEET KEYED NOTES A. DIMENSIONS ARE TO FACE OF CURB, OR WALL, OR EDGE OF BUILDING IDENTIFICATION PER REQUIREMENTS IN SECTION 505 OF 21. ELECTRICAL TRANSFORMER (ON 6" CONCRETE PAD) THE 2009 IFC PAVEMENT UNLESS OTHERWISE NOTED.

D. ALL LIGHT FIXTURES AND DESIGN SHALL COMPLY WITH THE

ORDINANCE (IDO): SECTION 14-16-5-8 OUTDOOR LIGHTING.

STREETS, PARKING SPACES AND ASSOCIATED DRIVES TO

PROVIDE POURABLE SEALANT AT ALL EXPANSION JOINTS IN

CONCRETE SIDEWALK, WHERE EXPANSION JOINT MATERIAL

PROVIDED BETWEEN WALLS AND SIDEWALKS AND BETWEEN

PROVIDE AIR ENTRAINED CONCRETE WITH MEDIUM BROOM

SOLID WASTE CONNECTION IS THE RESPONSIBILITY OF THE

CLEAR SIGHT REQUIREMENTS. THEREFORE SIGNS, WALLS

FINISH AT ALL SITE CONCRETE. SLOPE ALL CONCRETE

CITY OF ALBUQUERQUE SOLID WASTE DEPARTMENT.

MEASURED FROM THE GUTTER PAN) WILL NOT BE

PERMITTED IN THE CLEAR SIGHT TRIANGLE.

LANDSCAPE AND SIGNAGE WILL NOT INTERFERE WITH

AND PLANTING BETWEEN 3 FEET AND 8 FEET TALL (AS

SIDEWALKS TO DRAIN, TYP. RE: CIVIL FOR SPOT

CITY OF ALBUQUERQUE INTEGRATED DEVELOPMENT

BE ASPHALT UNLESS NOTED OTHERWISE.

ASPHALT AND CONCRETE JOINTS.

ELEVATIONS, GRADING AND DRAINAGE.

FIRE HYDRANT. PAINT SAFETY ORANGE. SEE CIVIL B. SITE PLAN SHALL COMPLY WITH LOCAL, FEDERAL ADA TRASH COMPACTOR AND RECYCLING ENCLOSURE WITH GATE, REF: 24. PERIMETER (MASONRY) WALL, TO MATCH ADJACENT, REF: STANDARDS & GUIDELINES, INCLUDING THE INTERNATIONAL A2/SDP1.3, A3/SDP1.3 & A4/SDP1.3. FIRE CODE (IFC) 2015. WALKWAY CONNECTION TO DENNIS CHAVEZ BLVD. 12'-0" TRAIL, A C. ALL CURBS AND ACCESSIBLE RAMPS WILL BE DESIGNED PAVED MULTI-USE TRAIL CLOSED TO AUTOMOTIVE TRAFFIC. AND BUILT ACCORDING TO THE CITY OF ALBUQUERQUE DEVELOPER TO COORDINATE WITH NMDOT ASSISTANT TRAFFIC STANDARDS.

ENGINEER ON TRAIL CONNECTION; WITH GATE REF: B2/SDP1.2. ACCESSIBLE PARKING WITH ACCESSIBLE SIGNAGE AND STRIPING, REF: A3/SDP1.2, A4/SDP1.2 & B4/SDP1.2.

ACCESSIBLE RAMP, REF: C1/SDP1.2, C2/SDP1.2, C3/SDP1.2, C4/SDP1.2 30. STABILIZED BASE COURSE DEFINED BY EDGE TRANSITION & C5/SDP1.2. MOTORCYCLE PARKING; REF: B3/ASP1.2

BIKE LOCKING, REF: A1/SDP1.3. ACCESSIBLE AISLE WITH STRIPING 10. MONUMENT SIGN PER IDO REQUIREMENTS, REF: C4/SDP1.3 11. SHADE STRUCTURE

12. RAISED GARDEN BEDS 13. POTTING STATION TABLE. 14. 6' WIDE CONCRETE SIDEWALK PER COA IDO STANDARDS, REF:

B5/SDP1.2. 15. 4' WIDE SIDEWALK CONCRETE, REF: B5/SDP1.2. 16. CONCRETE CURB AND GUTTER, REF: A2/SDP1.2 17. FLUSH CONCRETE SIDEWALK, REF: D4/SDP1.2

18. FIRE RISER ROOM 19. FIRE ACCESS GATE & KNOX BOX (LOCATE PER FIRE ONE PLAN) 20. FIRE DEPARTMENT CONNECTION (FDC) FREE STANDING

22. PARKING STRIPING 4" WIDE, COLOR WHITE 23. PROPERTY LINE

B1/SDP1.2.

B3/SDP1.2

34. MAINTENANCE EQUIPMENT ROOM

36. SOUTH PERIMETER WALL

CLEAR SIGHT TRIANGLE.

42. SPEED LIMIT SIGN; REF: B3/SDP1.2

38. CONCRETE MOUNTABLE CURB; REF:D5/SDP1.2

40. CONCRETE HEADER CURB; REF D2/SDP1.2

41. SPEED TABLE RAMP; REF: B3/SDP1.3 & B2/SDP1.3

PLAT 1004428 PR-2018-001345 DATED 08/15/2018

25. WEST MSE RETAINING WALL 26. PEDESTRIAN GATE 27. DEDICATED RESERVED CARPOOL PARKING WITH SIGNAGE, REF: B3/SDP1.2

WALLS, TREES, AND SHRUBBERY BETWEEN 3 AND 8 FEET TALL (AS

28. POOL SCREEN WALL SPRINKLED: FULLY SPRINKLED 29. SIDEWALK WITH TURNDOWN EDGE, REF: D3/SDP1.2. FIRE FLOW: 4,500 GPM HYDRANTS REQUIRED: 5 TOTAL 31. VANPOOL PARKING WITH SIGNAGE; B3/SDP1.2 32. GATE ENTRY PAD/ POST WITH CONTROL ACCESS FOB BIKE RACK/PARKING PER IDO AND DPM STANDARD WITH TWO-POINT 33. POOL EQUIPMENT ENCLOSURE

**BUILDING SF:** BUILDING A 20,777 GSF FIRST LEVEL 35. ELECTRIC VEHICLE CHARGING STATION WITH SIGNAGE; REF SECOND LEVEL 20,296 GSF

LEGAL DESCRIPTION:

60,985 GSF 37. CLEAR SIGHT TRIANGLE; LANDSCAPING, FENCING AND SIGNING WILL NOT **BUILDING B** INTERFERE WITH CLEAR SIGHT REQUIREMENTS. THEREFORE, SIGNS, 20,777 GSF FIRST LEVEL SECOND LEVEL MEASURED FROM THE GUTTER PAN) WILL NOT BE ACCEPTABLE IN THE 19,912 GSF 60,985 GSF THIRD LEVEL

CLUBHOUSE 125,128 GSF

**PARKING CALCULATION: (TABLE 5-5-1)** (RM-L) RESIDENTIAL - MULTI-FAMILY LOW DENSITY ZONE DISTRICT REQUIRED: MULTI FAMILY = 1.5 / DU REQUIRED: 156 UNITS x 1.5 SPACES = 234 SPACES TRACT RR-3-A-1, LOCATED ON DENNIS CHAVEZ BLVD. SW, BETWEEN PROVIDED CARPOOL PARKING: 1 = 4 PARKING CREDIT SPACES

98TH ST. SW & 118TH ST. SW PROVIDED VANPOOL PARKING: 1 = 7 PARKING CREDIT SPACES SITE AREA: 5.423 ACRES PROVIDED ELECTRIC VEHICLE CHARGING STATION: 2% OF 234 = 5 ELECTRIC CHARGING ZONE ATLAS: P-09-Z STATIONS CREDIT SPACES / EACH ELECTRIC CHARGING STATION SHALL COUNT AS 2 SETBACKS: FRONT= 15', SIDE= STREET 10', INTERIOR= 5', REAR= 15' SPACES. 5 ELECTRIC CHARGING STATIONS X 2 = 5 CREDIT SPACES **BUILDING HEIGHT:** 35'-0"+10% WAIVER @ 3'-0" = 38'-0"

**BUILDING OCCUPANCY:** R-2, 156 APARTMENTS CONSTRUCTION TYPE: V-A, FULLY SPRINKLED THIRD LEVEL 19,912 GSF


20,296 GSF 39. EXISTING PRIVATE ACCESS EASEMENT (03-15-11,2011C-20) GRANTED PER 3,158 GSF

REQUIRED:  $0.25 \times 156 = 39$ PROVIDED: 40 20% SECURED LONG TERM STORAGE: 8 EXTERIOR BIKE PARKING: 32 MOTORCYCLE PARKING REQUIRED AND PROVIDED = 5 SPACES FOR 51-300 TOTAL PARKING SPACES PROVIDED = 5 SPACES

REQUIRED: 234 SPACES - 4 CARPOOL CREDIT - 7 VANPOOL CREDIT - 5 ELECTRIC CHARGING STATION CREDIT = 218 TOTAL: 218 SPACES PROVIDED: 218 PARKING SPACES 25% OF 218 REQUIRED PARKING MAY BE COMPACT

PROVIDED COMPACT PARKING: 3 SPACES @ 9'-0" x 16'-0" PROVIDED STANDARD PARKING: 215 SPACES @ 9'-0" x 18'-0" STANDARD ACCESSIBLE SPACES: REQUIRED: 2 STANDARD SPACES & 8 VAN ACCESSIBLE PROVIDED: 10 TOTAL SPACES; 8 VAN ACCESSIBLE AND 2 STANDARD BIKE PARKING: 00.25 PER UNIT

CONCRETE PAD PER PNM STANDARDS POOL PERIMETER FENCE PRIVATE SIDEWALK EASEMENT PER DOC #2019023680 DATED & ACCESSIBLE PARKING WITH ACCESSIBLE SIGNAGE AND STRIPING, REF: A3/SDP1.2, A4/SDP1.2 & B4/SDP1.2.

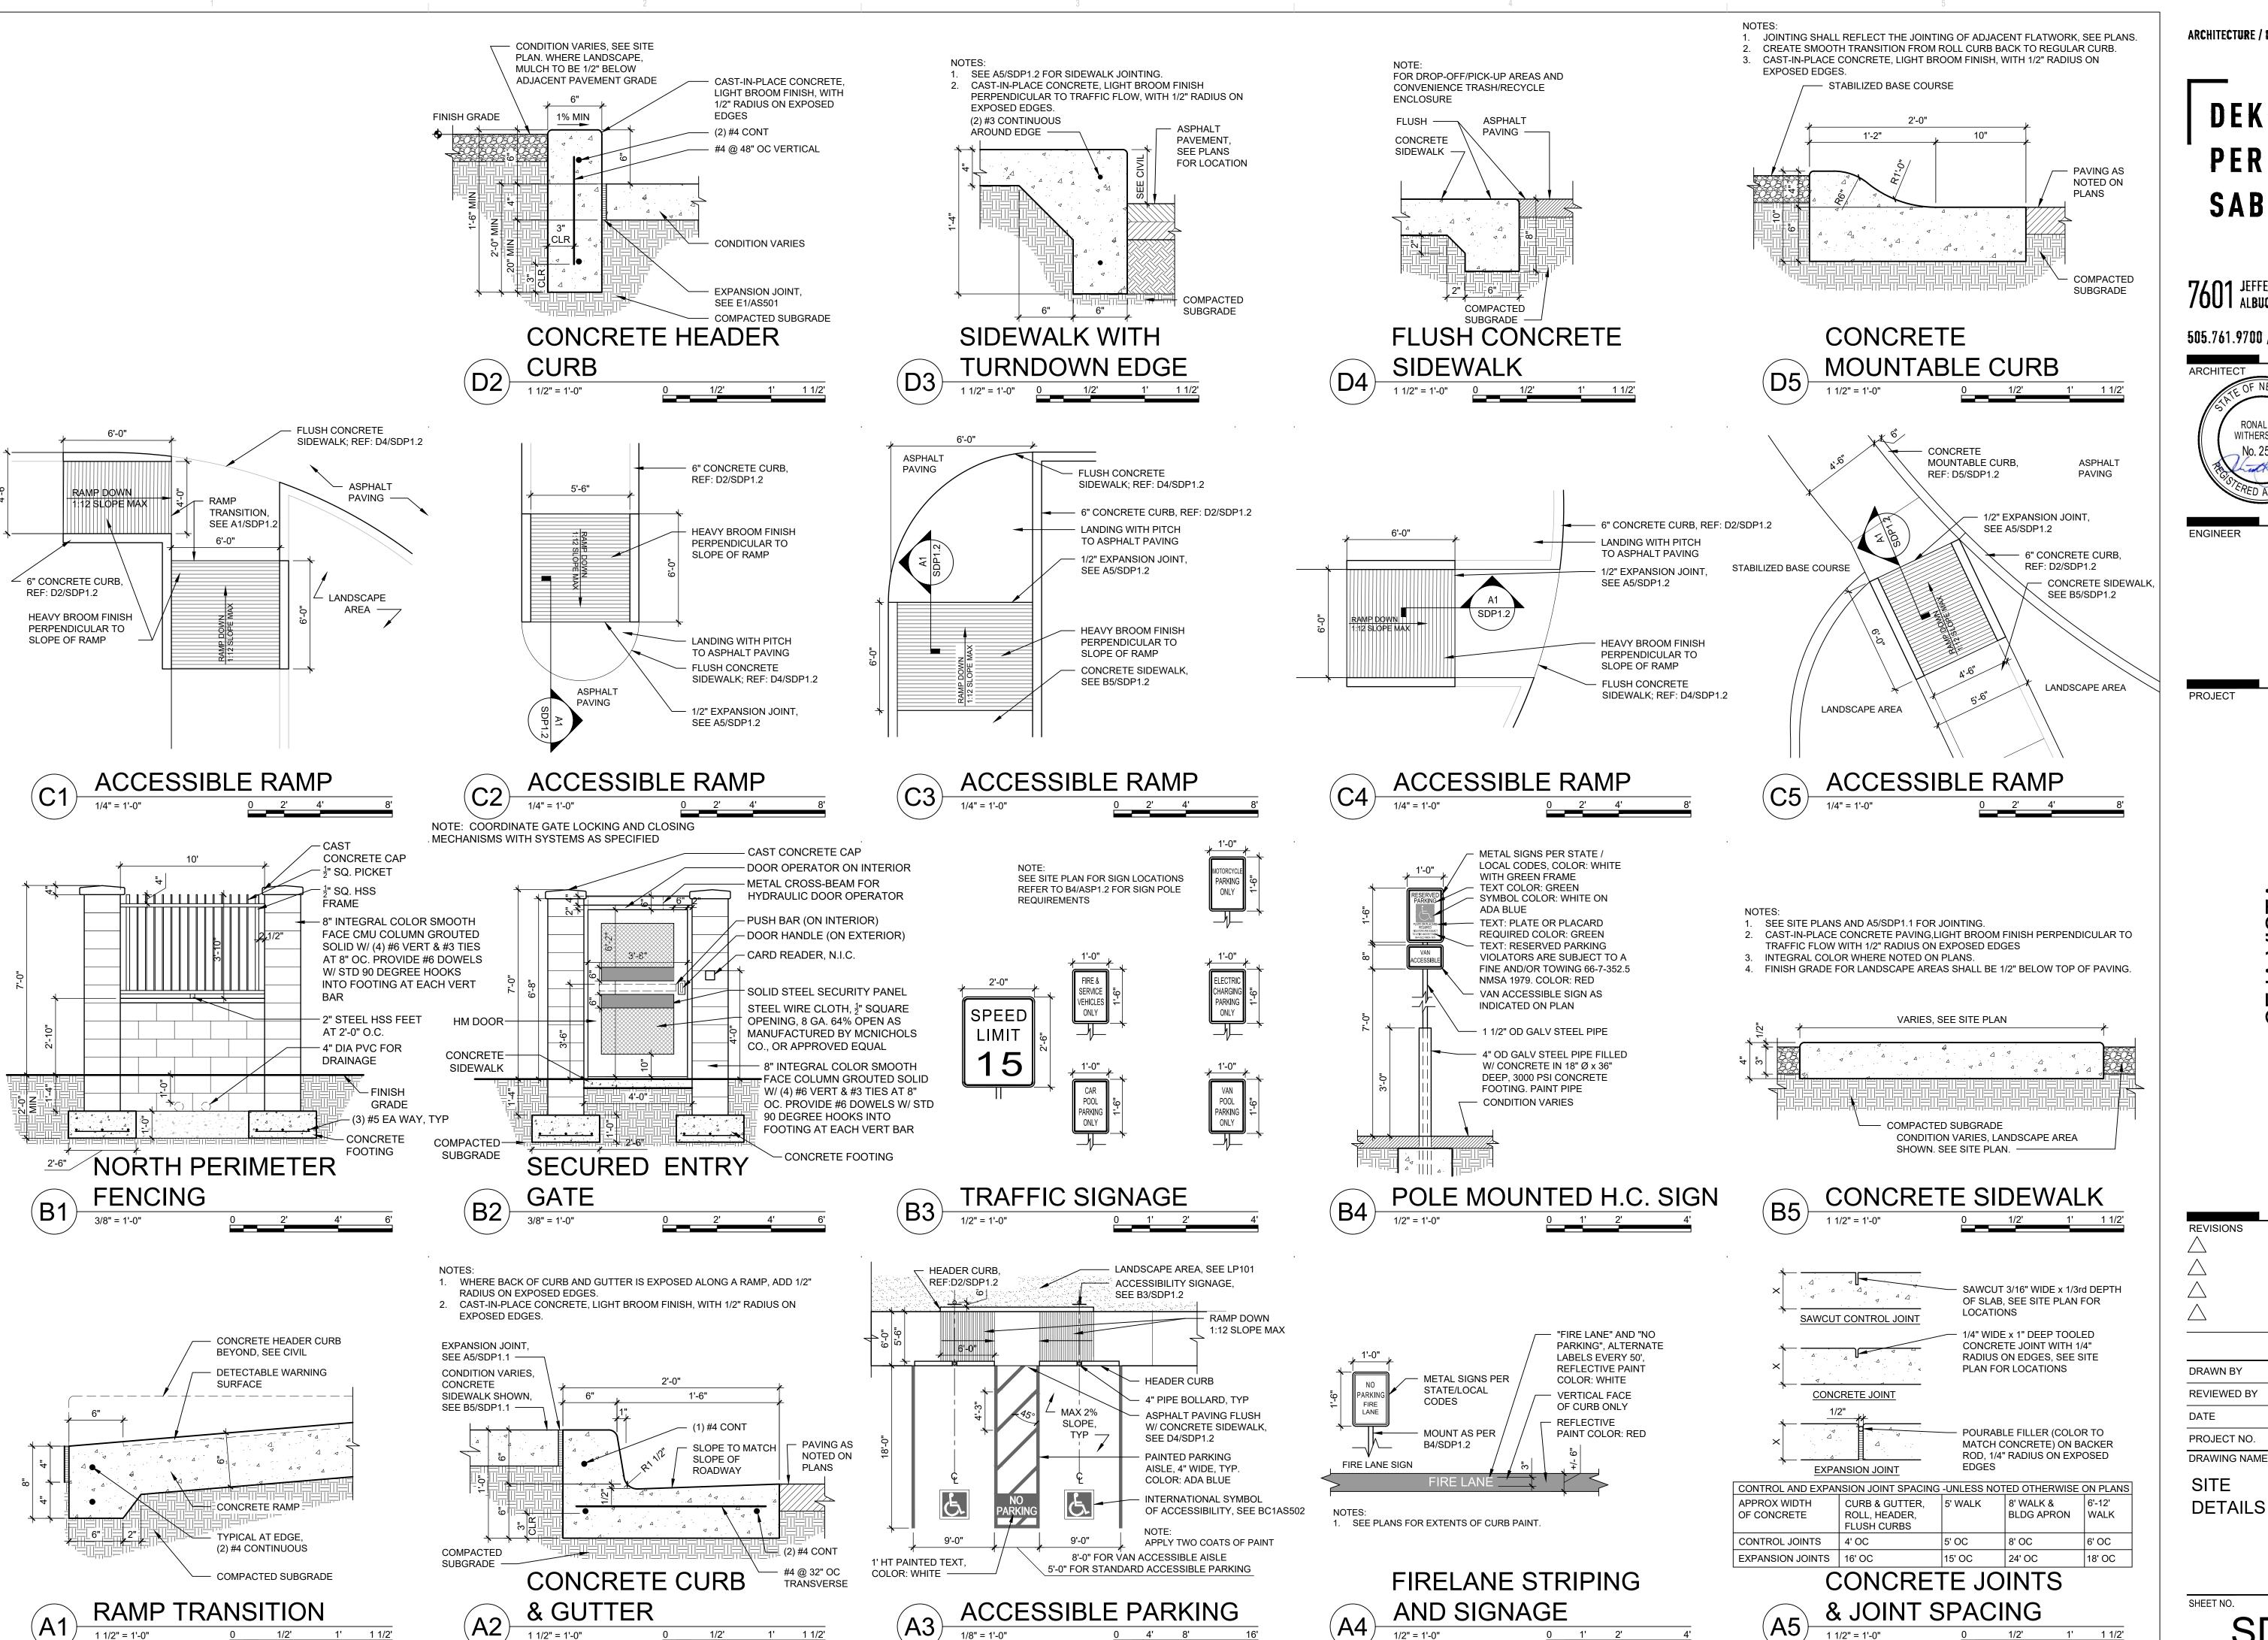

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**ENGINEER** 

PROJECT


CEJA VISTA 10001 CEJA VISTA ROAD SW ALBUQUERQUE, NEW MEXICO 8712

REVISIONS

DRAWN BY AG REVIEWED BY RAW, JM 11/25/2019 PROJECT NO. 19-0019

SITE **DETAILS** 

SHEET NO. **SDP1.2** 

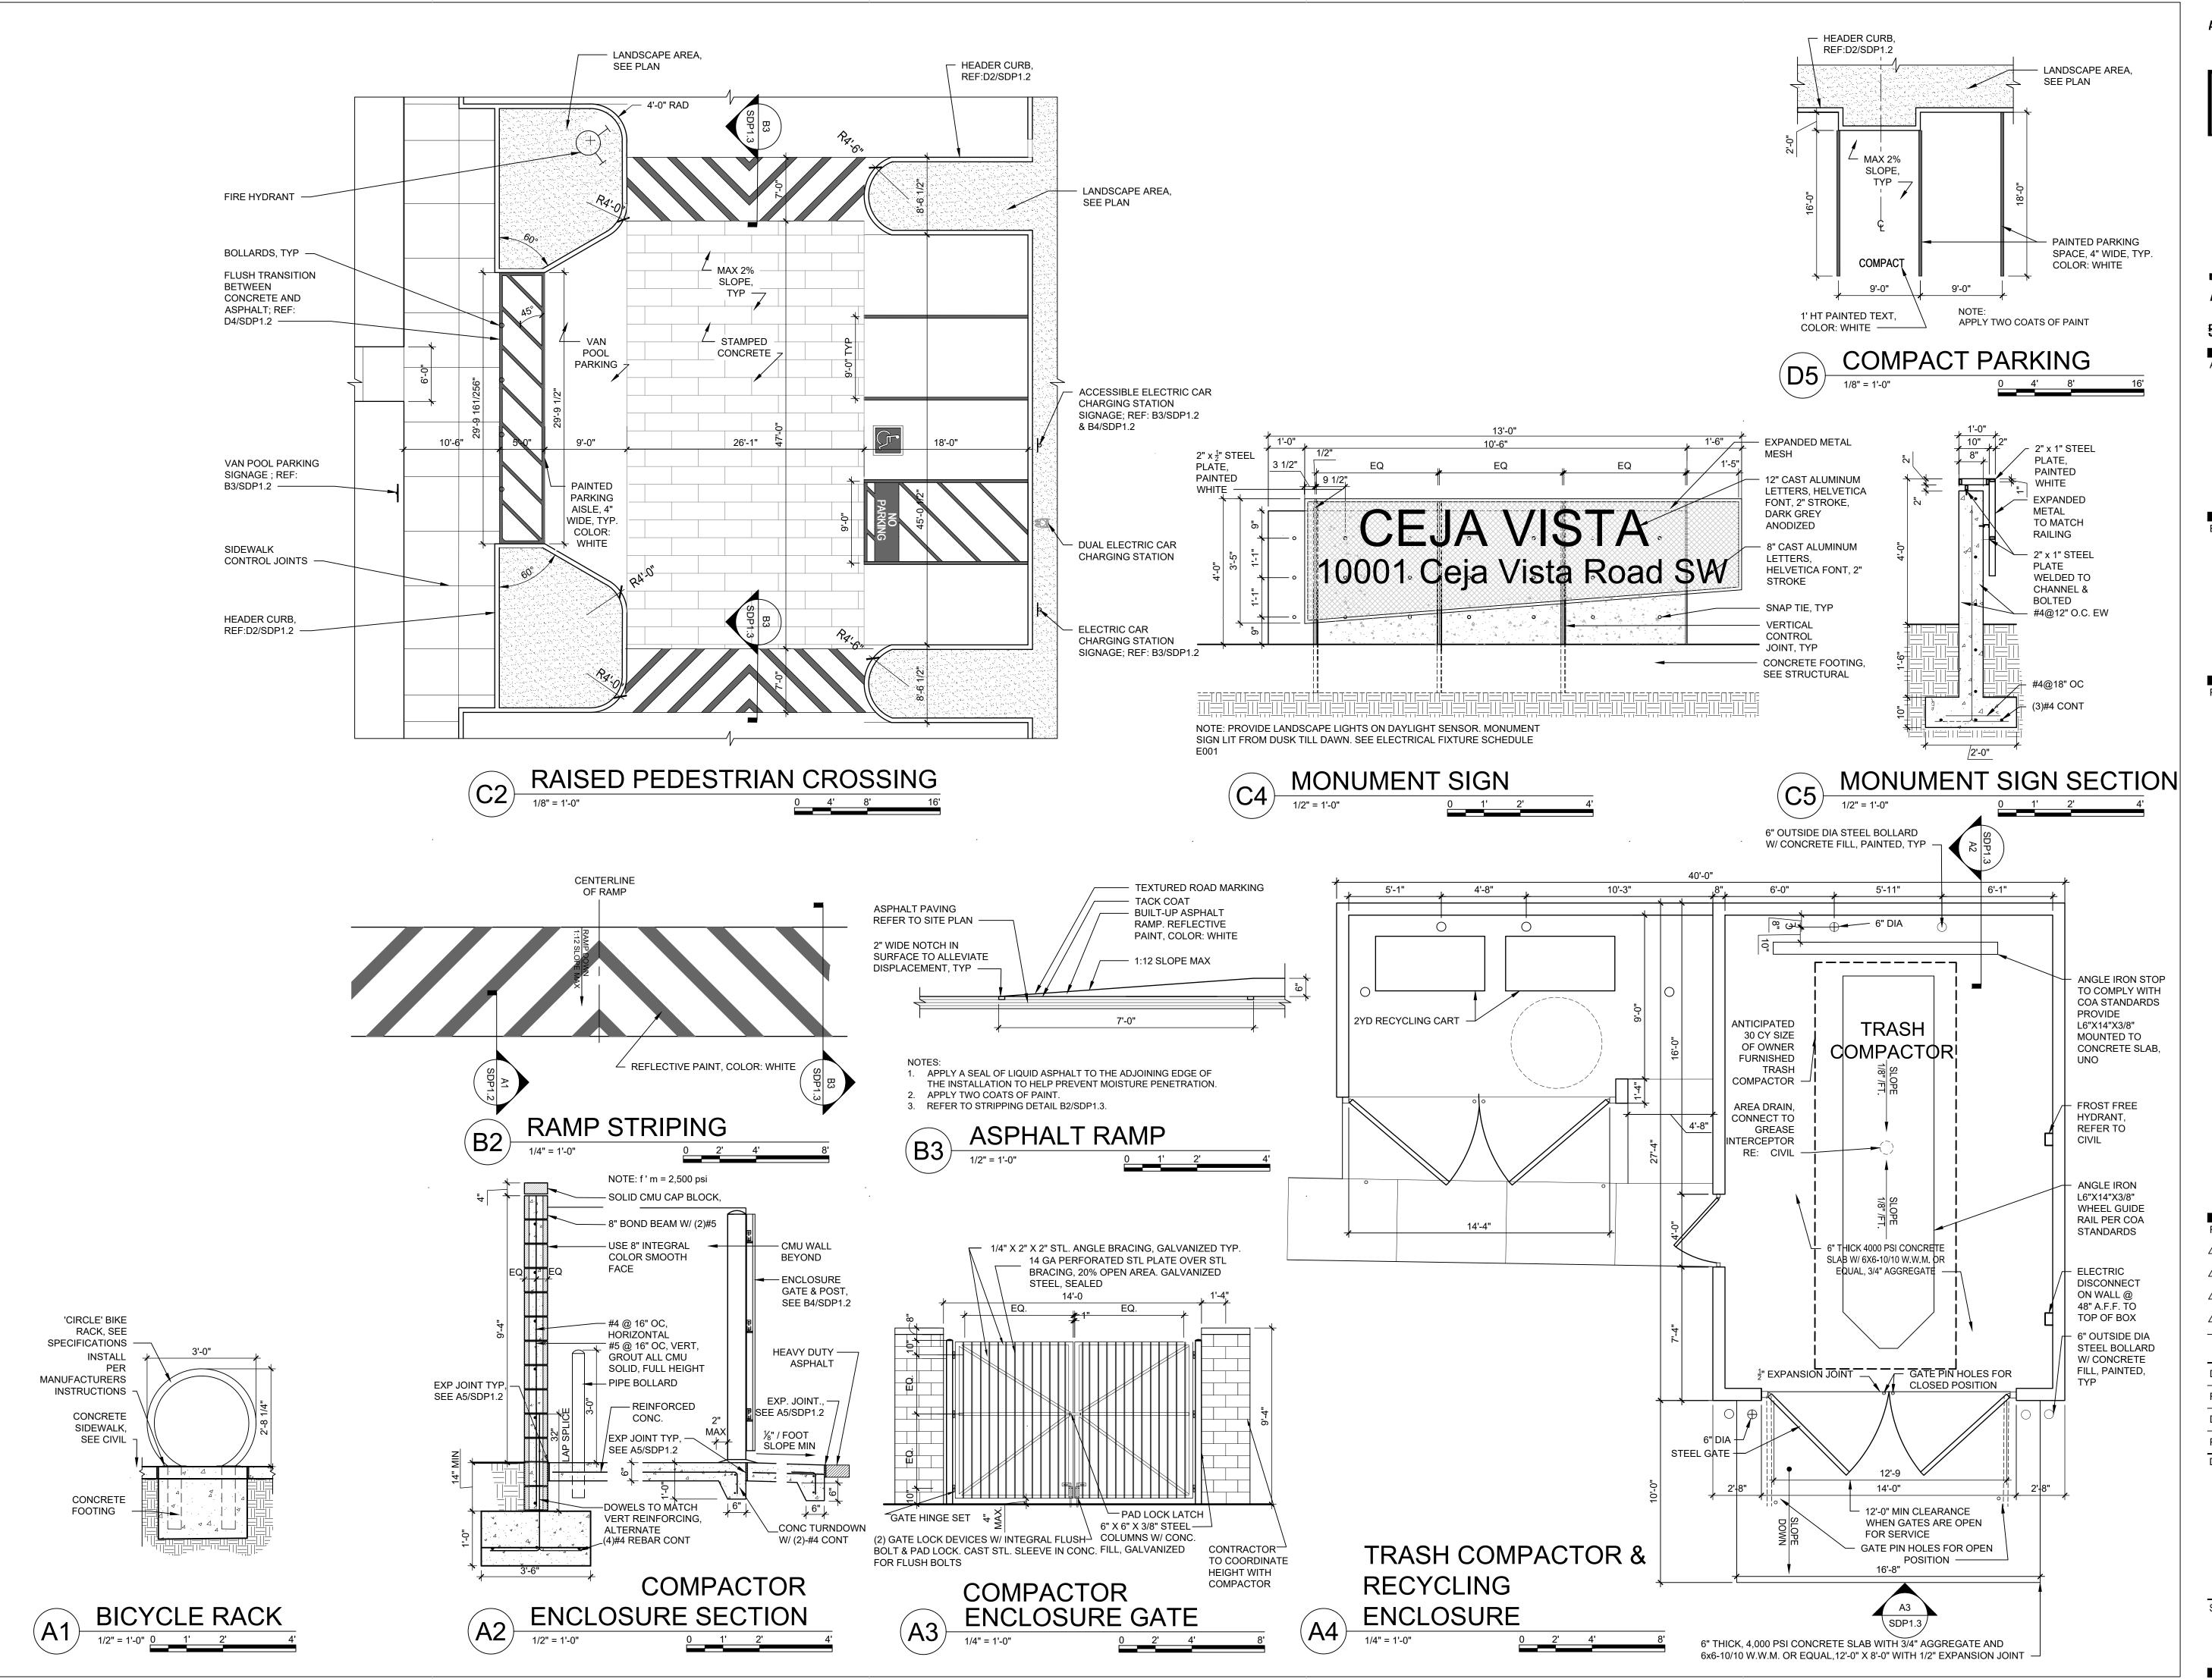

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SABATINI

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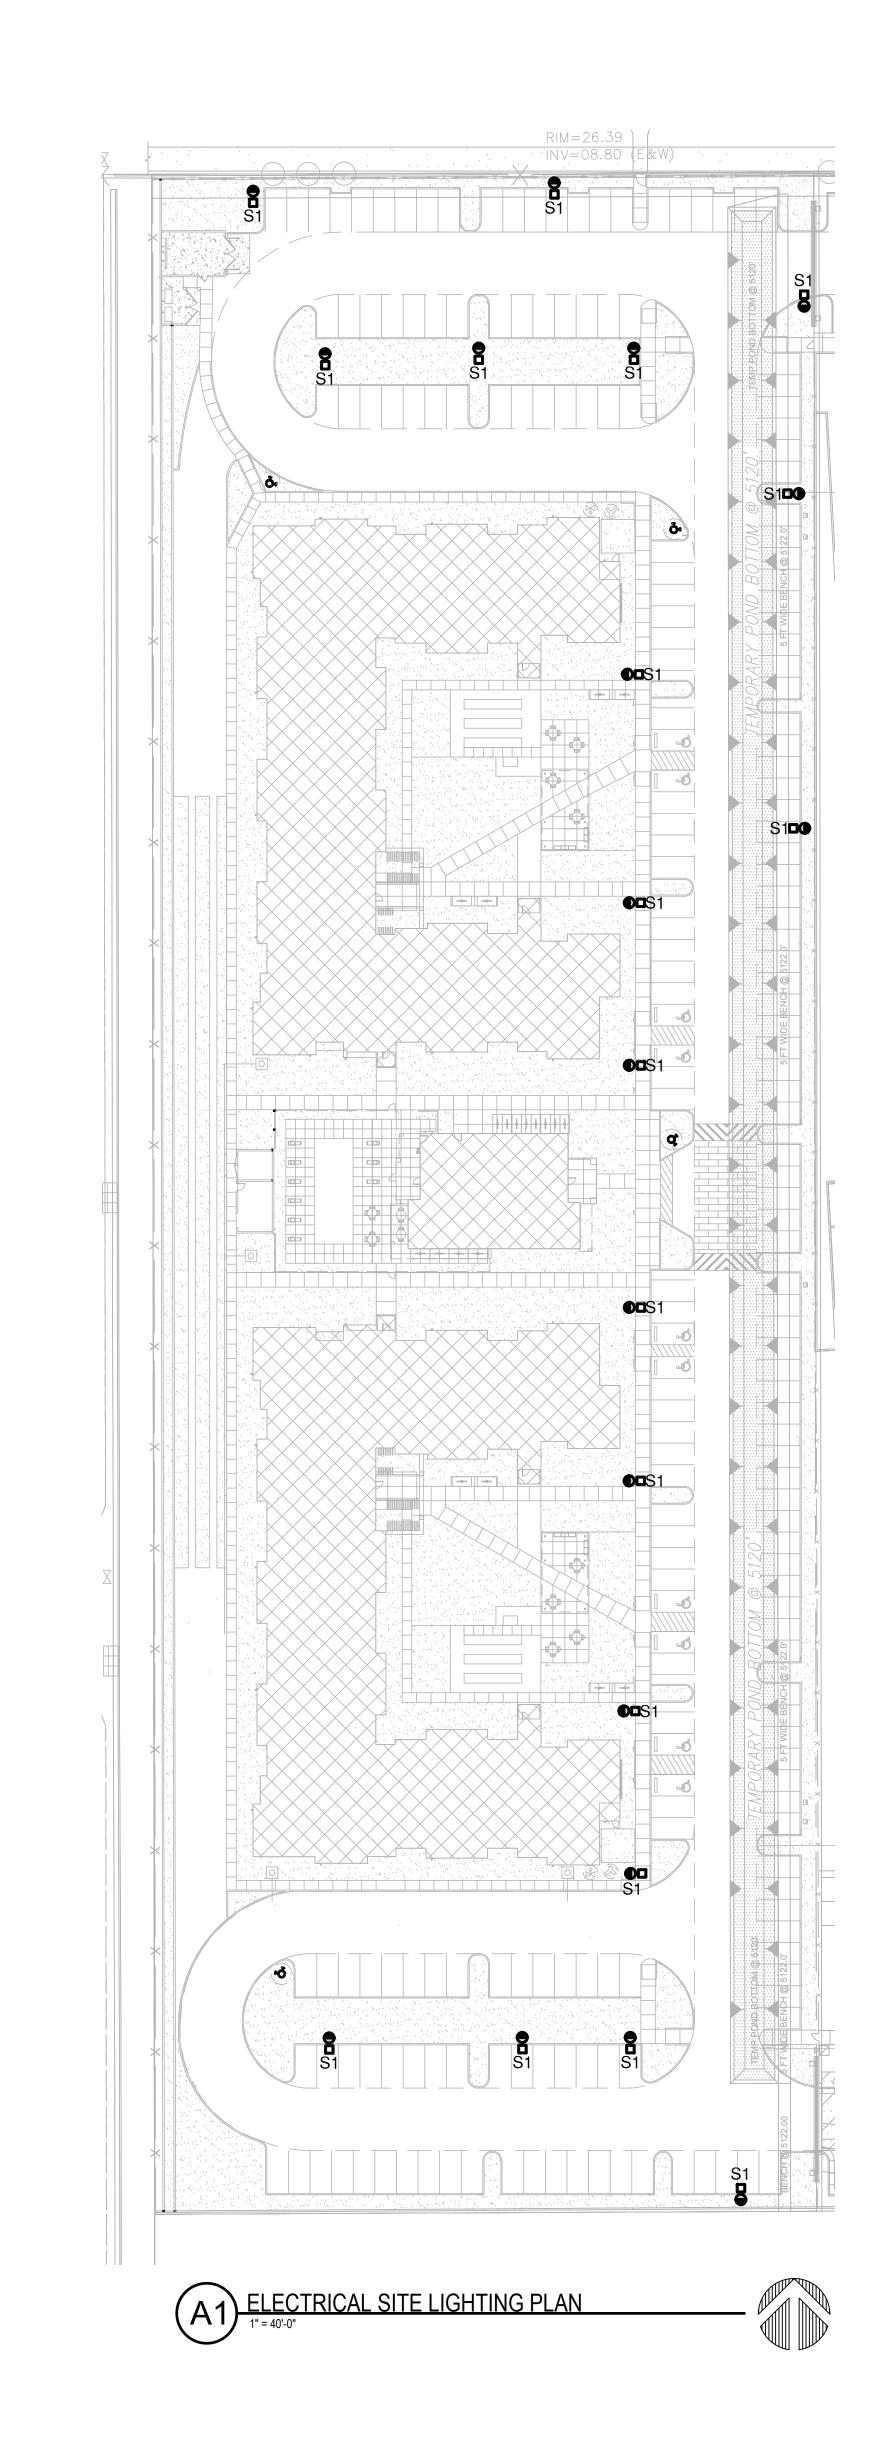
PROJECT

CEJA VISTA 10001 CEJA VISTA ROAD SW ALBUQUERQUE, NEW MEXICO 87121

DRAWN BY AG
REVIEWED BY RAW, JM
DATE 11/25/2019
PROJECT NO. 19-0019
DRAWING NAME

SITE DETAILS

SDP1.3



DEKKER PERICH SABATINI

**GENERAL SHEET NOTES** 

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ARCHITECT



ENGINEER

CLUB CK J. TELO

RECK J. TELO

REC

CEJA VISTA 10,001 CEJA VISTA ROAD SW ALBUQUERQUE, NEW MEXICO

REFERENCE KEYNOTES

REVISIONS

DRAWN BY	ACE
REVIEWED BY	FJT
DATE	10/10/2019
PROJECT NO.	17-0017
DRAWING NAME	
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ELECTRICAL SITE LIGHTING PLAN


SHEET NO.
SDP 1.4

Schedule											
Symbol	Label	Quantity	Manufactur er	Catalog Number	Description	Lamp	Number Lamps	Filename	Lumens Per Lamp	Light Loss Factor	Wattage
	S1	13	Lithonia Lighting	RSX1 LED P2 40K R4	RSX Area Fixture Size 1 P2 Lumen Package 4000K CCT Type R4 Distribution		1	RSX1_LED_P 2_40K_R4.ie s	9972	1	72.95
	S1 2	6	Lithonia Lighting	RSX1 LED P2 40K R5	RSX Area Fixture Size 1 P2 Lumen Package 4000K CCT Type R5 Distribution		1	RSX1_LED_P 2_40K_R5.ie s	10106	1	72.95

Statistics		ı				
Description	Symbol	Avg	Max	Min	Max/Min	Avg/Min
PARKING LOT GRADE LEVEL	+	1.7 fc	6.3 fc	0.1 fc	63.0:1	17.0:1

## Note

1.ALL FIXTURES MOUNTED ON A 16' POLE, ON A 2.5' BASE FOR A TOTAL MOUNTING HEIGHT OF 18.5'

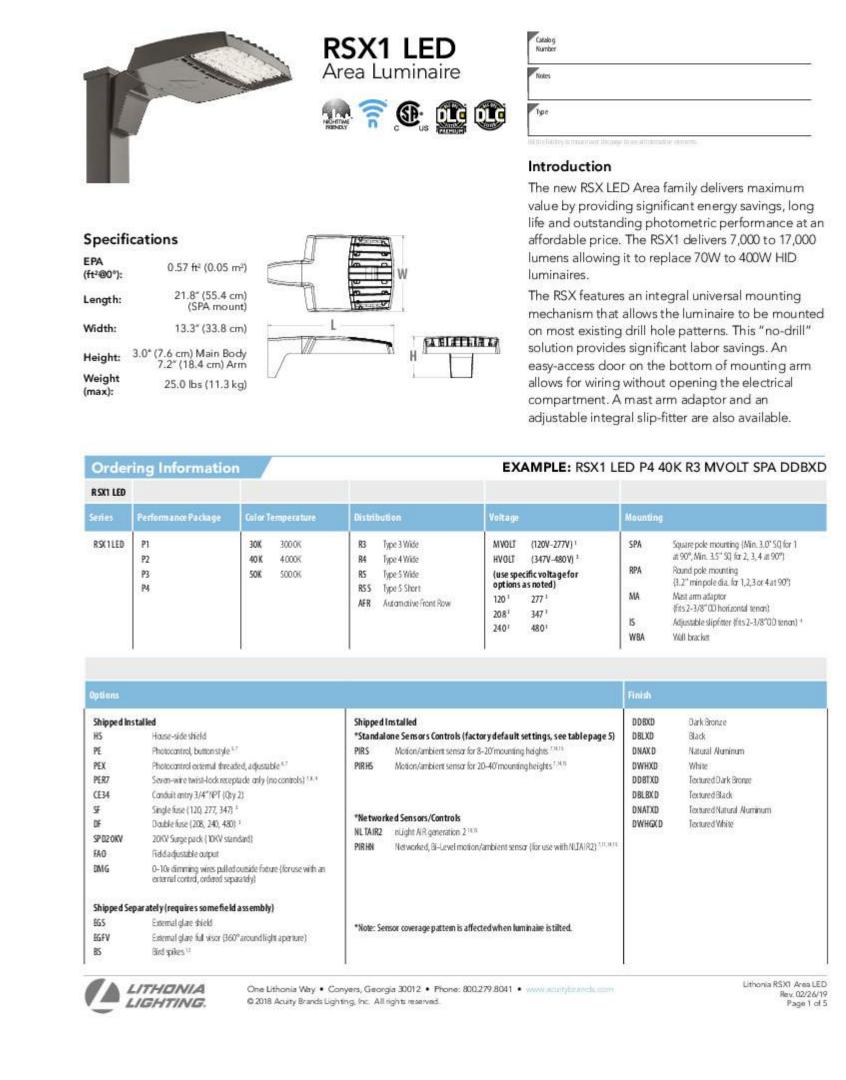

A1) ELECTRICAL SITE LIGHTING PLAN	
1" = 40'-0"	

0.60 80.9 1 1 1 4 1 .6 1 .8 2 .4 3 .2 3 .7 3 2

0.70.91.01.21.41.51.72.12.52.82.4 1.01. 1.21.41.51.51.72.08.12.21/8 1.31.41.51.51.61.71.71.81.71. 1,71.81.71. 1.61.51.51.51.41.31

2.22 11.91.7 151.41.3 21.10.80 7 2.82.52.11.71.51.41.21.00.90.70 4.94.12.92.01.71.41.00.80.60.40.3 005.03.32.21.81.41.00.80.50.40.3 5.74.83.32.21.91.51.10.80.60.50.4

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3,23,02.62,32.42,62.52,83.54.14,0 433.83.12.62.52.52.32.42.83.13.0 5.65.03.72.82.62.42.22.22.32.32.2 5.356.4.02.92.62.42.12.02.01.81.6 5.54.83.72.72.52.21.91.81.61.41.1 4.43.83.12.52.22.11.81.51.31.10.8 3.63.32.82.32.1 91.6 .4 1 0.9016 3.13.12.82.42.01.71.5 (.20.90.70.4

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0.30,30,40,40,40,40,50,50,50,50,50,50,50,60,60,60,60,70,70,70,70,80,91,01,11,31,62,02,42,83,54,64

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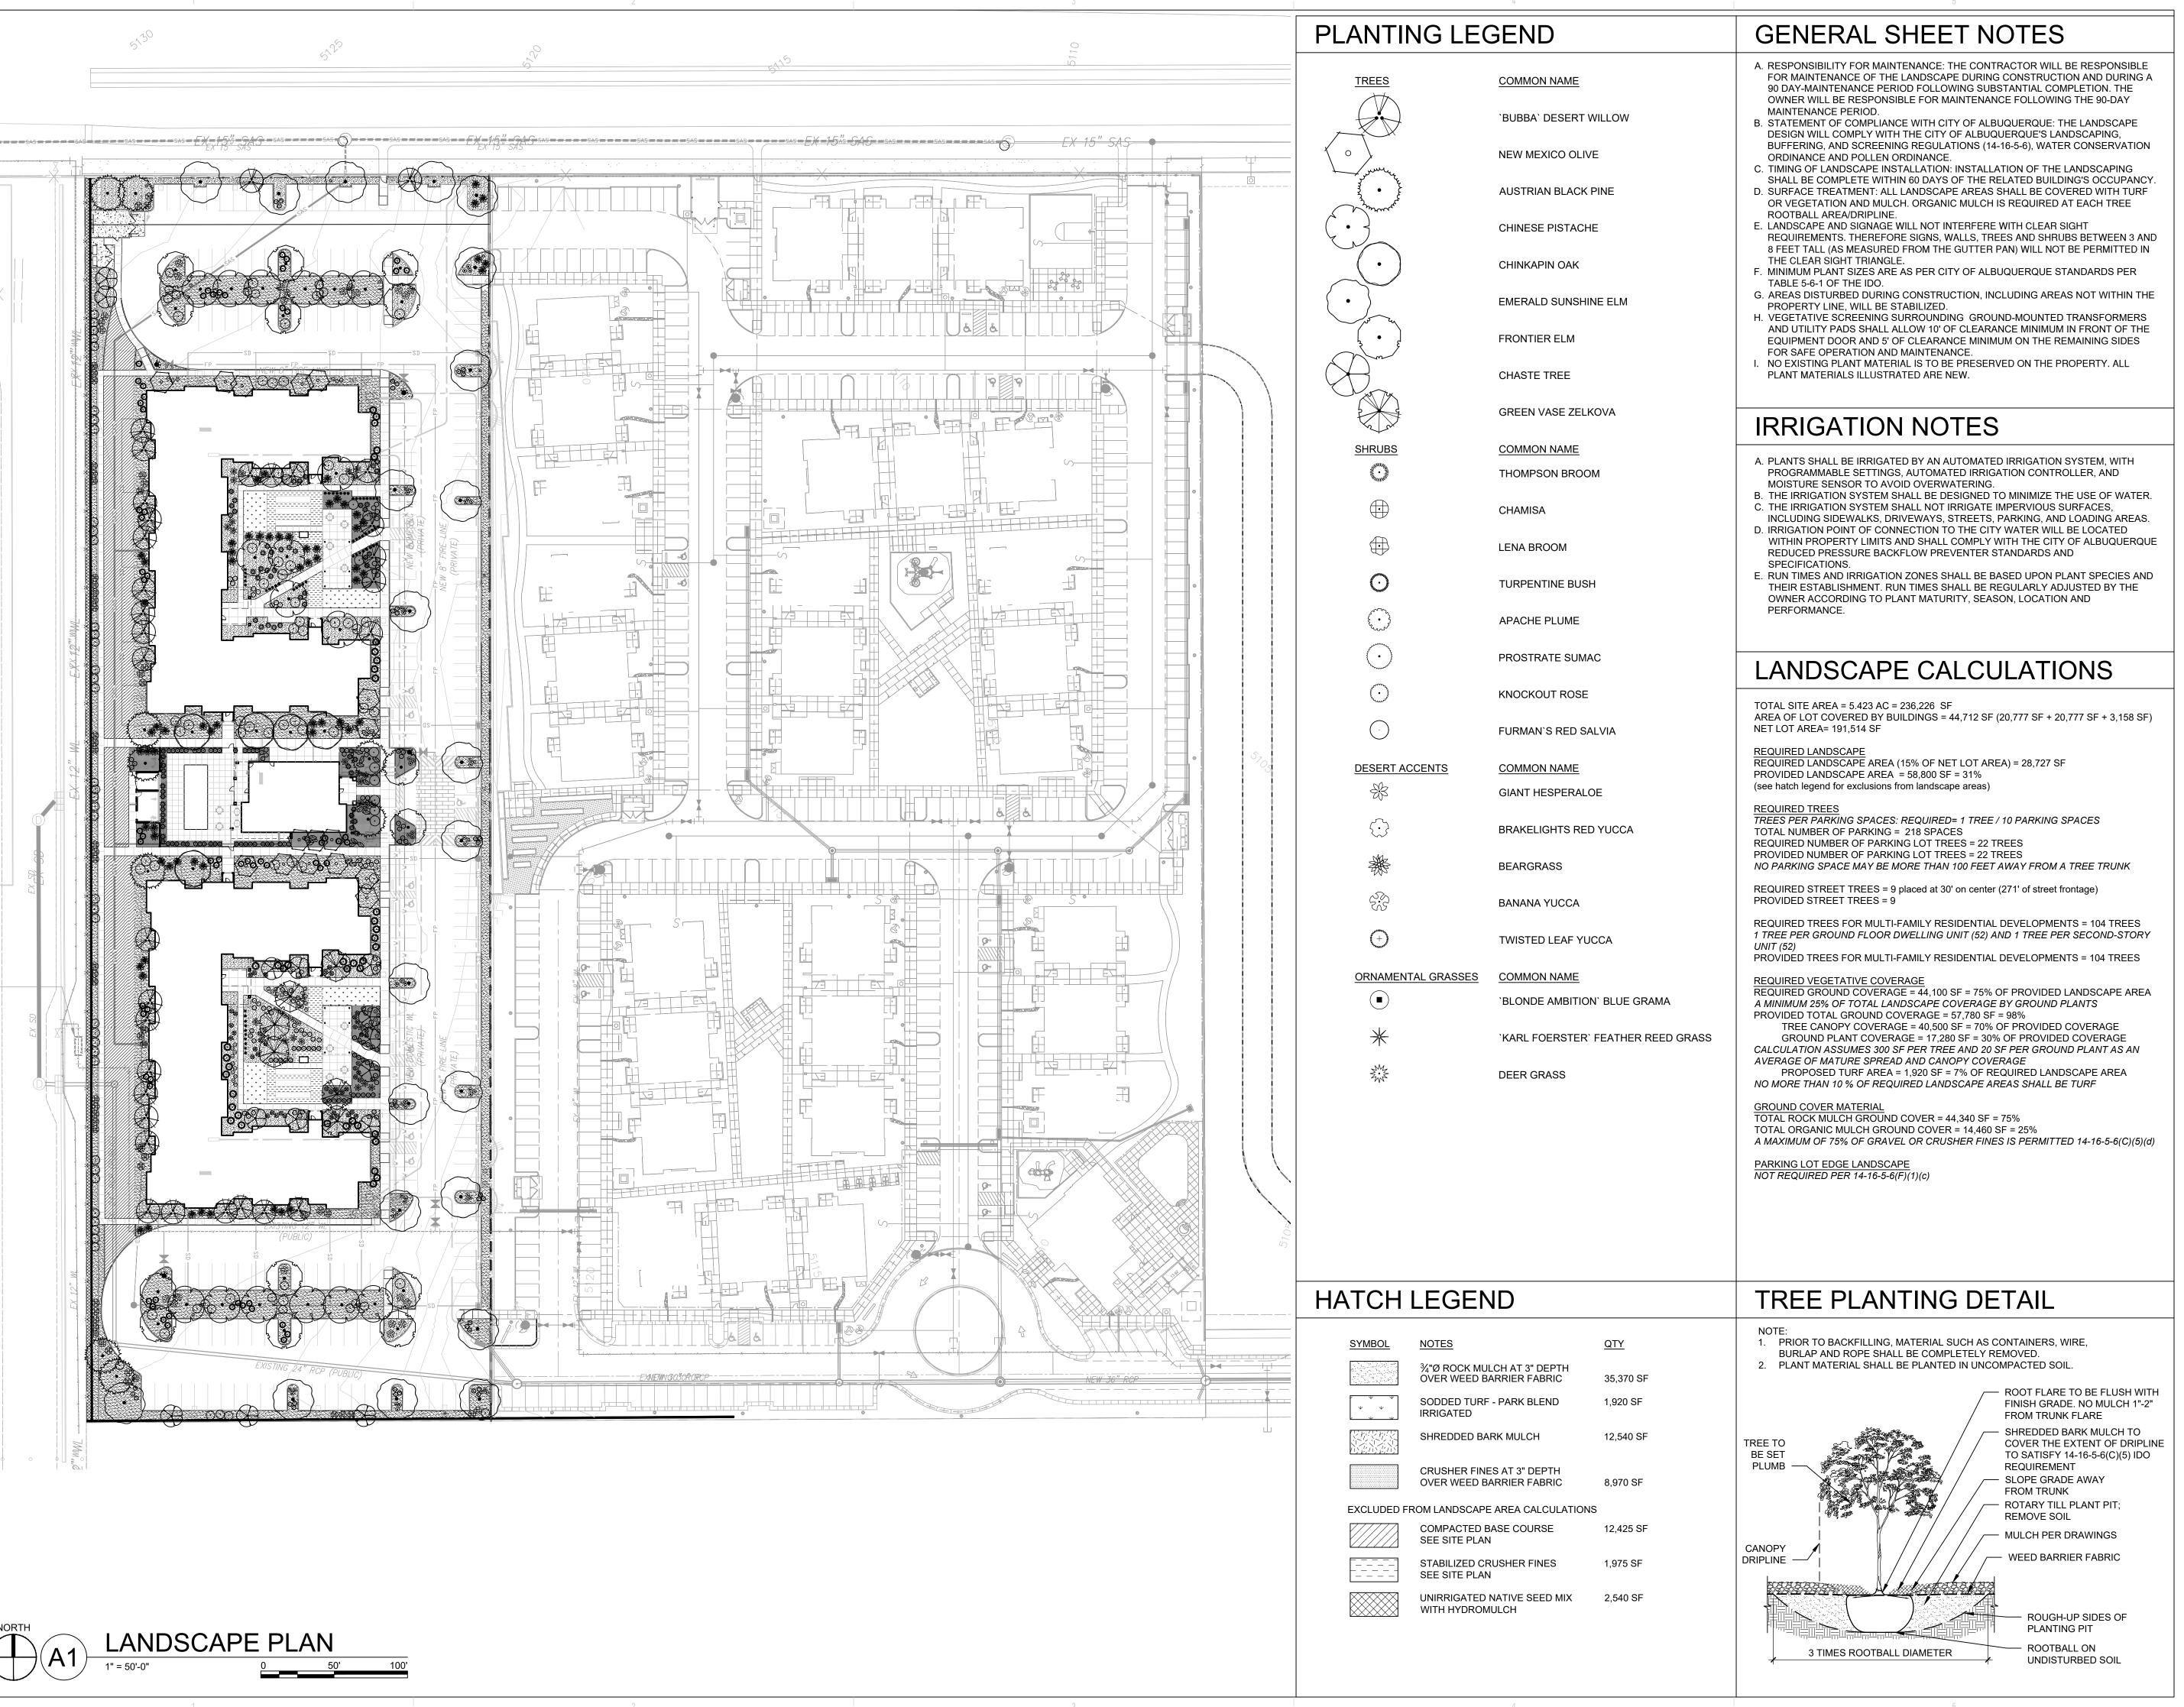
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> Designer Date 8/6/2019 Scale Not to Scale Drawing No. Summary



DEKKER PERICH SABATINI

7601 JEFFERSON NE, SUITE 100 ALBUQUERQUE, NM 87109

505.761.9700 / DPSDESIGN.ORG

ARCHITECT



ENGINEER

PROJECT

O 001 CEJA VISTA BUQUERQUE, NEW MEXICO

DRAWN BY

REVIEWED BY

D/P/S

DATE

10.25.2019


PROJECT NO.

19-0019

DRAWING NAME

LANDSCAPE PLAN

SHEET NO.
SDP2.1

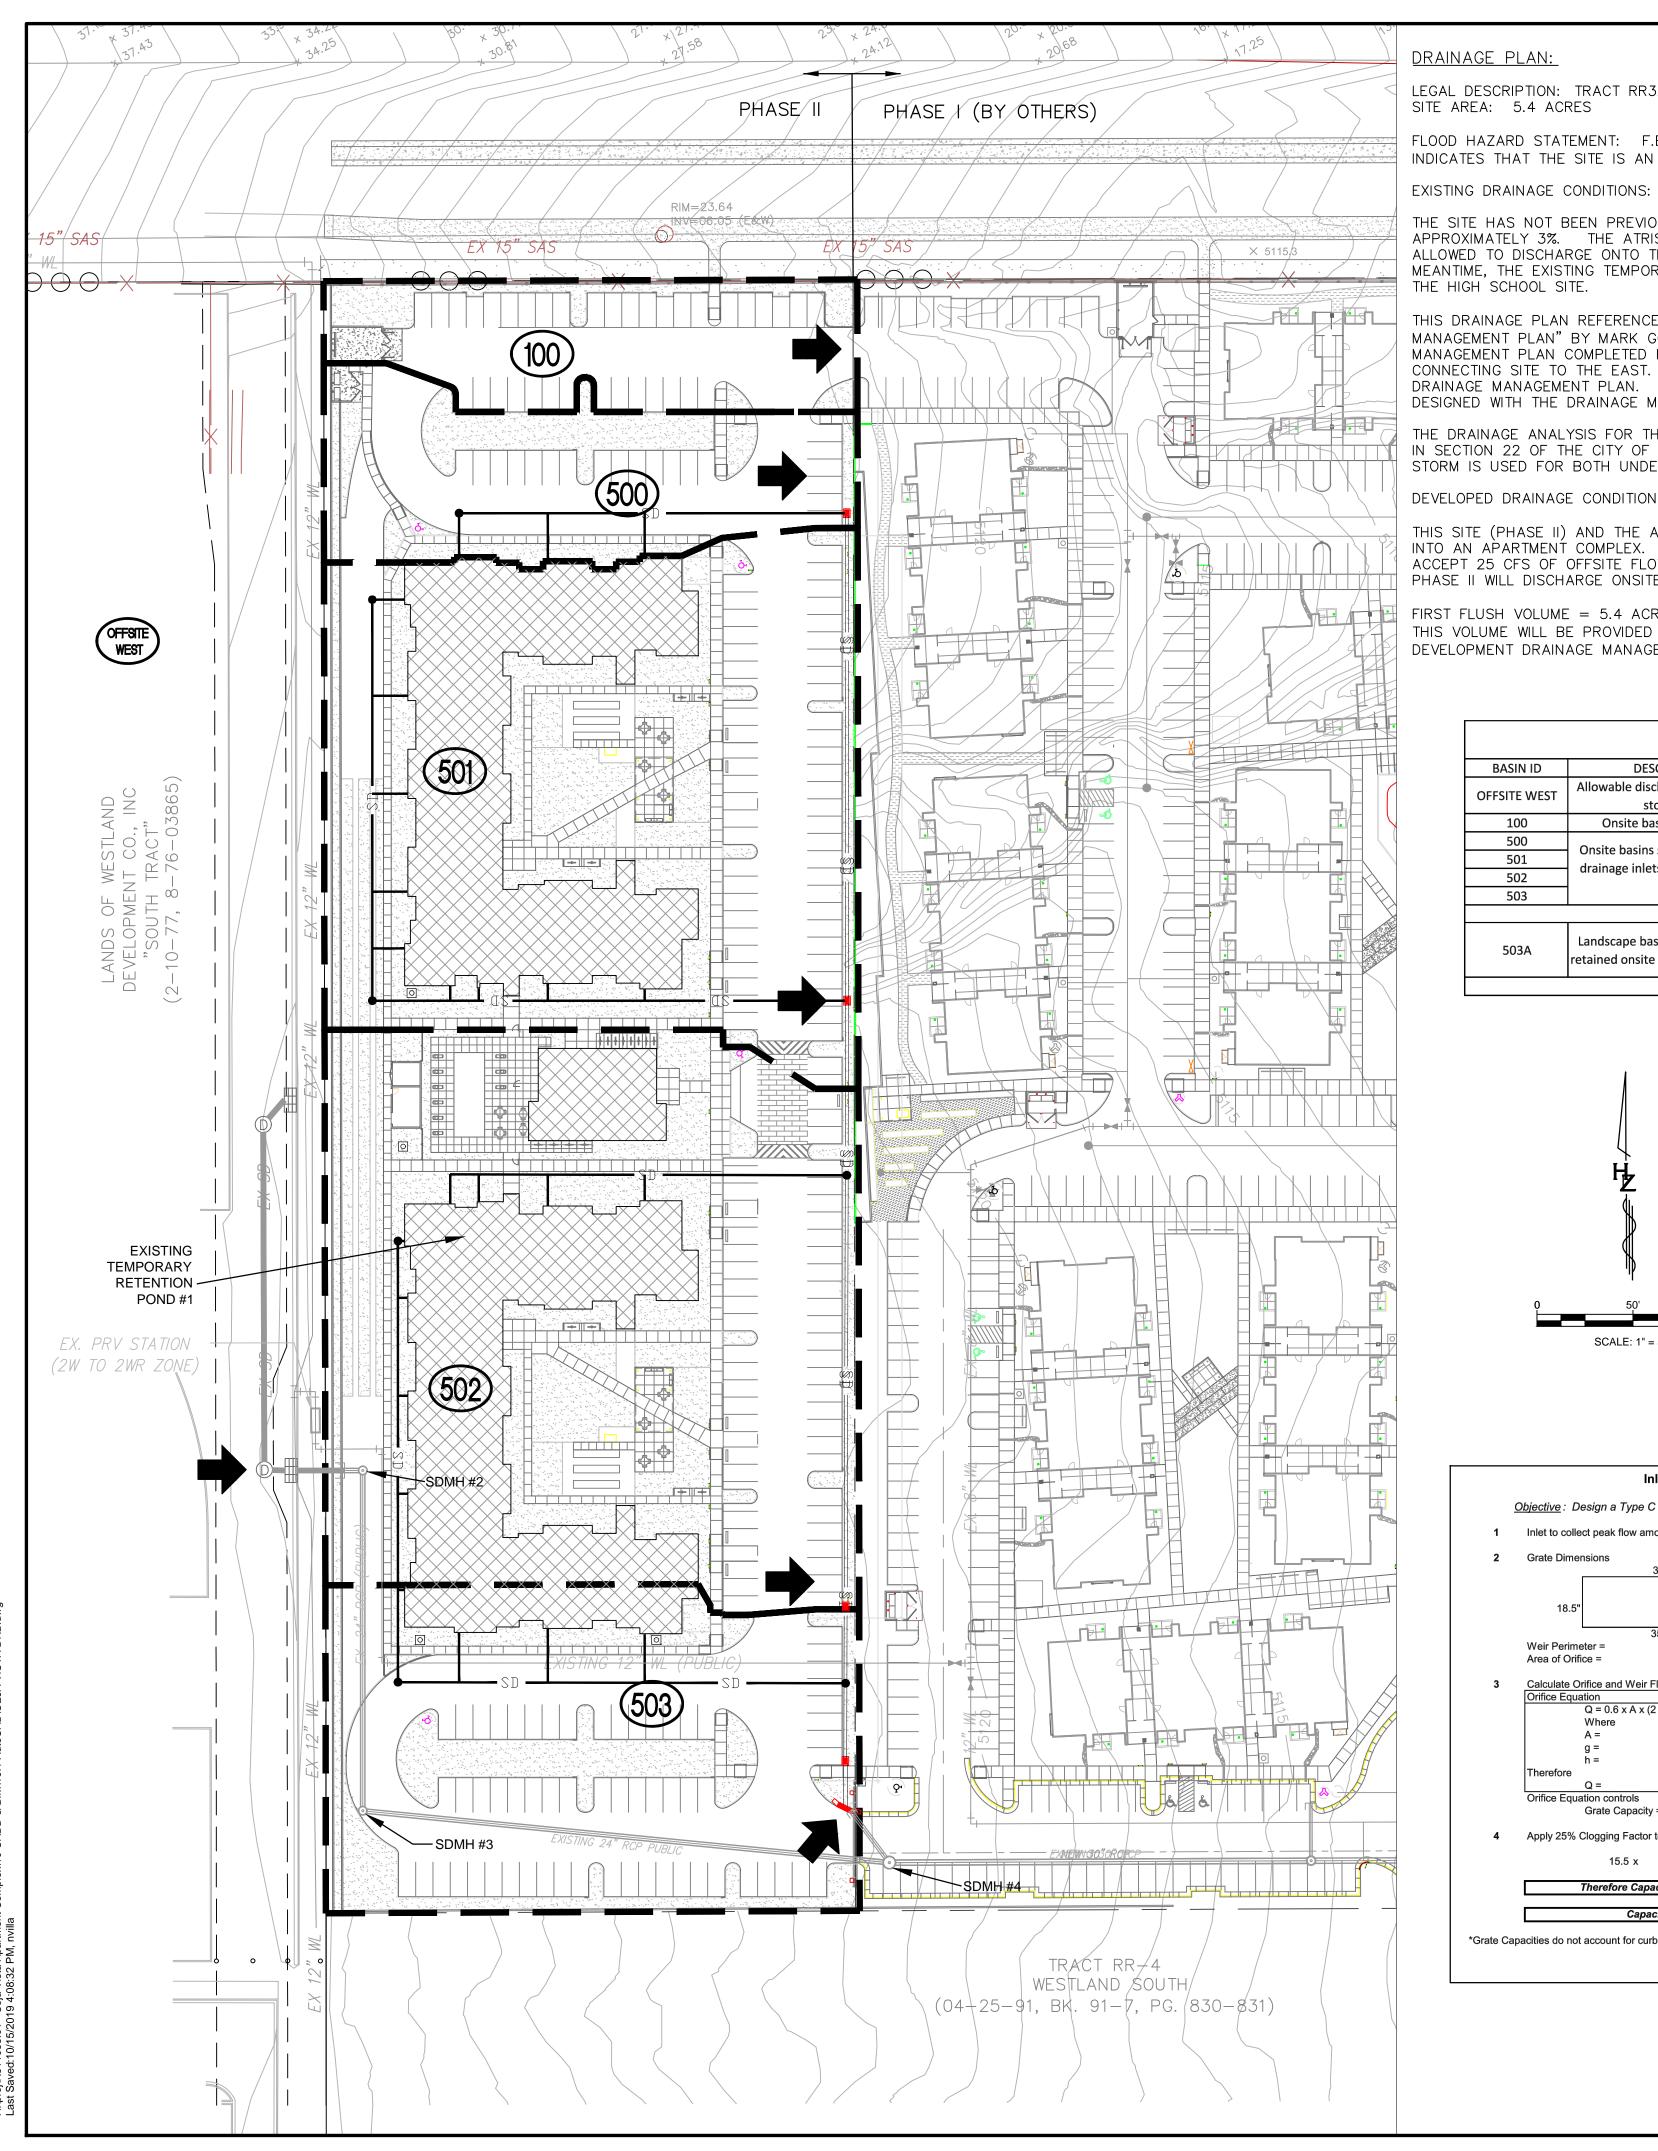

LEGAL DESCRIPTION: TRACT RR3A1 PLAT FOR WESTLAND SOUTH

FLOOD HAZARD STATEMENT: F.E.M.A. FIRM MAP DATED AUGUST 16, 2012 (MAP NUMBER 35001C0338H)

INDICATES THAT THE SITE IS AN AREA OF MINIMAL FLOOD HAZARD (ZONE X).

THE SITE HAS NOT BEEN PREVIOUSLY DEVELOPED. THE EXISTING LAND SLOPES FROM WEST TO EAST AT APPROXIMATELY 3%. THE ATRISCO HERITAGE ACADEMY HIGH SCHOOL TO THE WEST OF THE SITE IS ALLOWED TO DISCHARGE ONTO THIS SITE UNTIL A STORM DRAIN CONNECTION OUTFALL IS BUILT. IN THE MEANTIME, THE EXISTING TEMPORARY RETENTION POND #1 WAS BUILT TO MITIGATE THE OFFSITE FLOW FROM THE HIGH SCHOOL SITE.

THIS DRAINAGE PLAN REFERENCES THE "VALLE DE ATRISCO APARTMENT DEVELOPMENT DRAINAGE MANAGEMENT PLAN" BY MARK GOODWIN & ASSOCIATES, DATED SEPTEMBER 2018. THE DRAINAGE MANAGEMENT PLAN COMPLETED HYDROLOGIC AND HYDRAULIC ANALYSIS FOR THIS SITE AND THE ADJACENT CONNECTING SITE TO THE EAST. DEVELOPED FLOWRATES FOR THIS SITE ARE OBTAINED DIRECTLY FROM THE DRAINAGE MANAGEMENT PLAN. IN ADDITION, THE STORM DRAIN SYSTEM DESIGN FOR THIS SITE HAS BEEN DESIGNED WITH THE DRAINAGE MANAGEMENT PLAN.


THE DRAINAGE ANALYSIS FOR THIS SITE IS IN ACCORDANCE WITH THE HYDROLOGIC AND HYDRAULIC CRITERIA IN SECTION 22 OF THE CITY OF ALBUQUERQUE DEVELOPMENT PROCESS MANUAL. THE 100-YEAR DESIGN STORM IS USED FOR BOTH UNDEVELOPED AND DEVELOPED CONDITIONS.


#### DEVELOPED DRAINAGE CONDITIONS:


THIS SITE (PHASE II) AND THE ADJACENT CONNECTING SITE TO THE EAST (PHASE I) WILL BE DEVELOPED INTO AN APARTMENT COMPLEX. AS DETERMINED BY THE DRAINAGE MANAGEMENT PLAN, THIS SITE WILL ACCEPT 25 CFS OF OFFSITE FLOW FROM THE HIGH SCHOOL SITE VIA AN ONSITE STORM DRAIN SYSTEM AND PHASE II WILL DISCHARGE ONSITE DEVELOPED FLOW INTO THE STORM DRAIN WHICH CONNECTS TO PHASE I.

FIRST FLUSH VOLUME = 5.4 ACRES (0.34") = 6665 CF THIS VOLUME WILL BE PROVIDED BY OFFSITE OUTFALL POND BUILT WITH THE "VALLE DE ATRISCO APARTMENT DEVELOPMENT DRAINAGE MANAGEMENT PLAN".

	CEJA VISTA APARTMENT COMPLEX P	HASE II				
	BASIN SUMMARY					
BASIN ID	DESCRIPTION OF FLOW DIRECTION	ALLOWABLE Q (CFS)	ACTUAL Q (CFS)			
OFFSITE WEST	Allowable discharge from high school site enters onsite storm drain system at SDMH#2	25.00	25.00			
100	Onsite basin surface flows east toward Phase I	1.85	1.57			
500	Onsite basins surface flow east and are intercepted by	2.55	2.01			
501	drainage inlets into the onsite storm drain system and	6.20	6.37			
502	flows toward SDMH #4	6.96	7.23			
503	IIOWS LOWALD SDIVIN #4	3.76	3.54			
	TOTAL Q AT KEY POINT #2 = 19.47 19.15					
503A	Landscape basins behind curb and in parking island are retained onsite and do not contribute to storm drain flow	N/A	0.63			
	TOTAL O AT SDMH #4 -	11 17	/// 15			

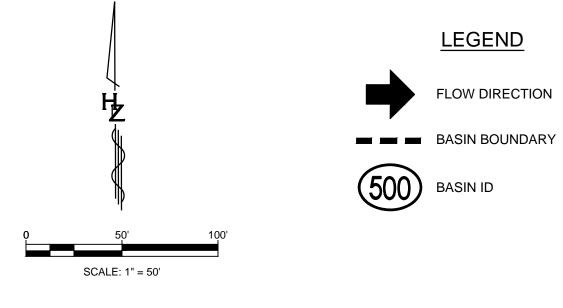

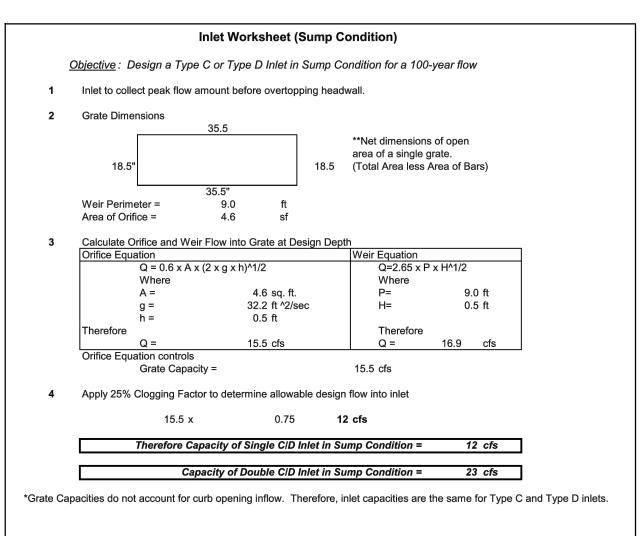

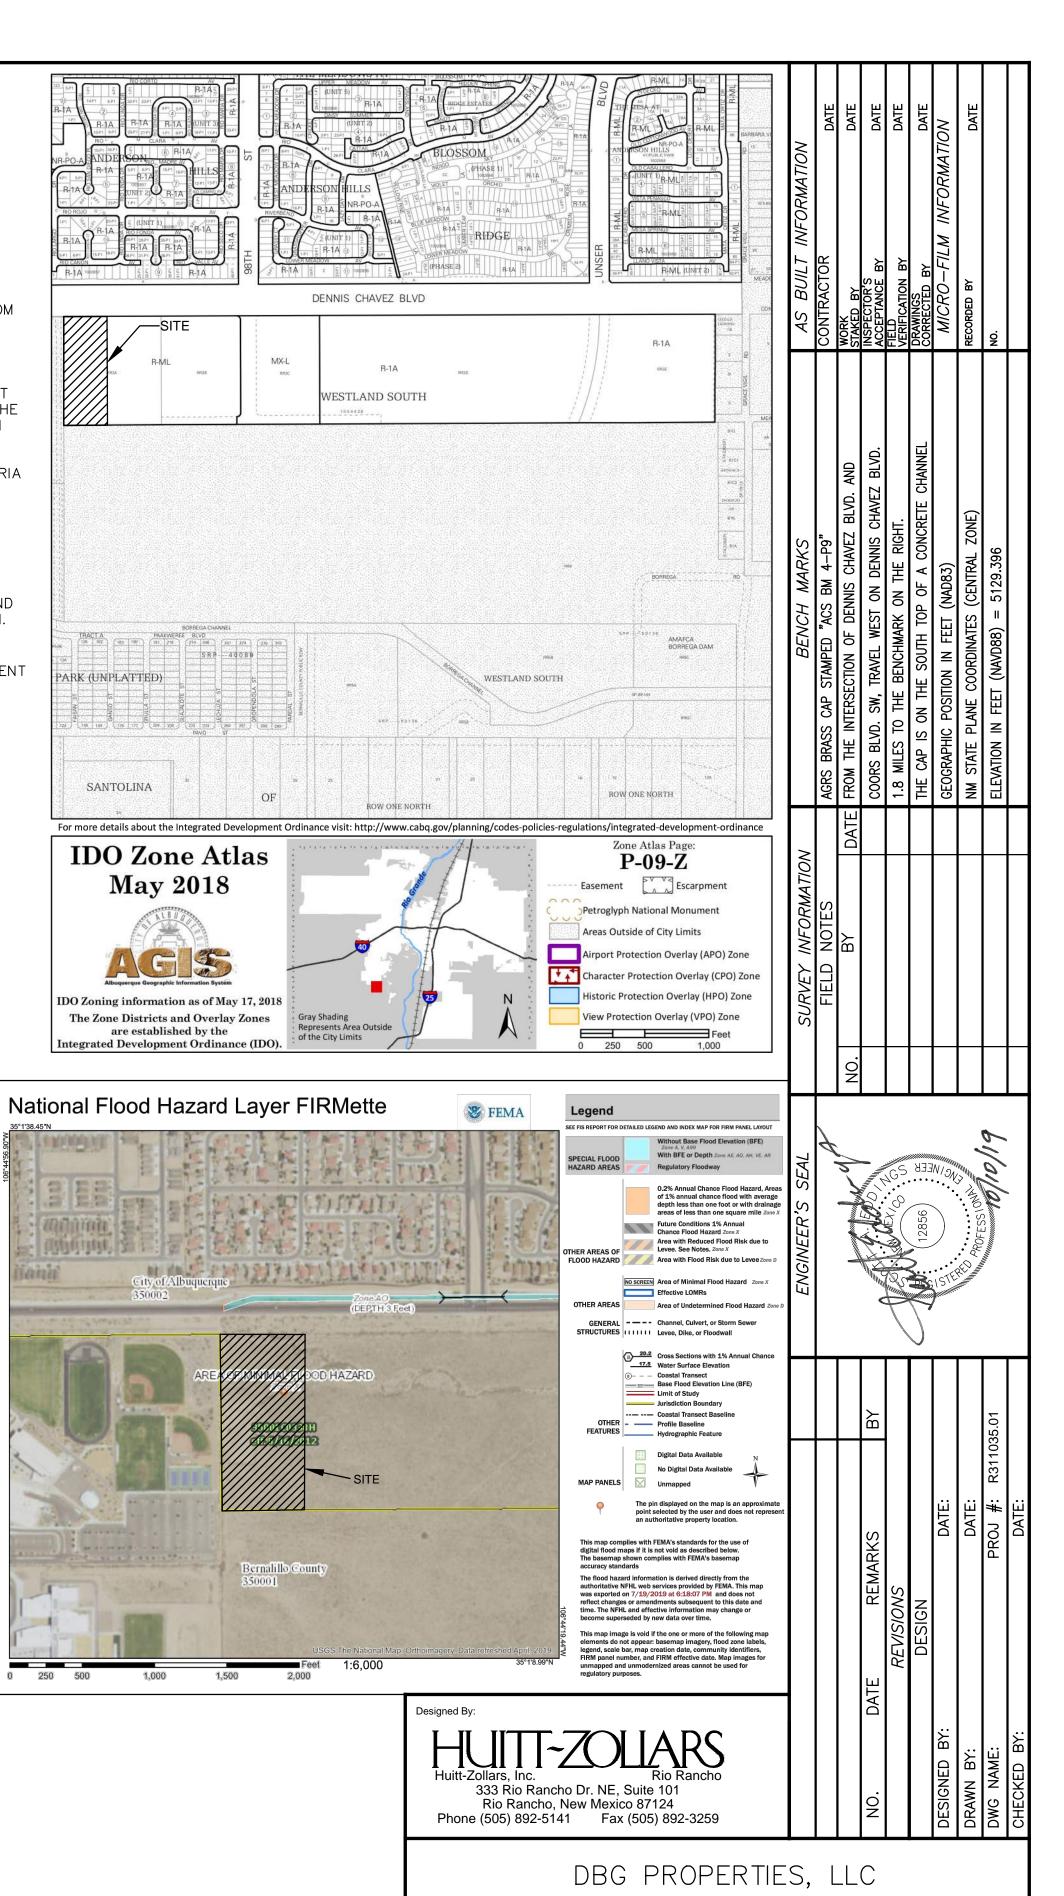

Design Review Committee City Engineer


City Project No. Zone Map No.


P-09-Z

SDP 3.1

CEJA VISTA APARTMENT COMPLEX PHASE II


DRAINAGE PLAN

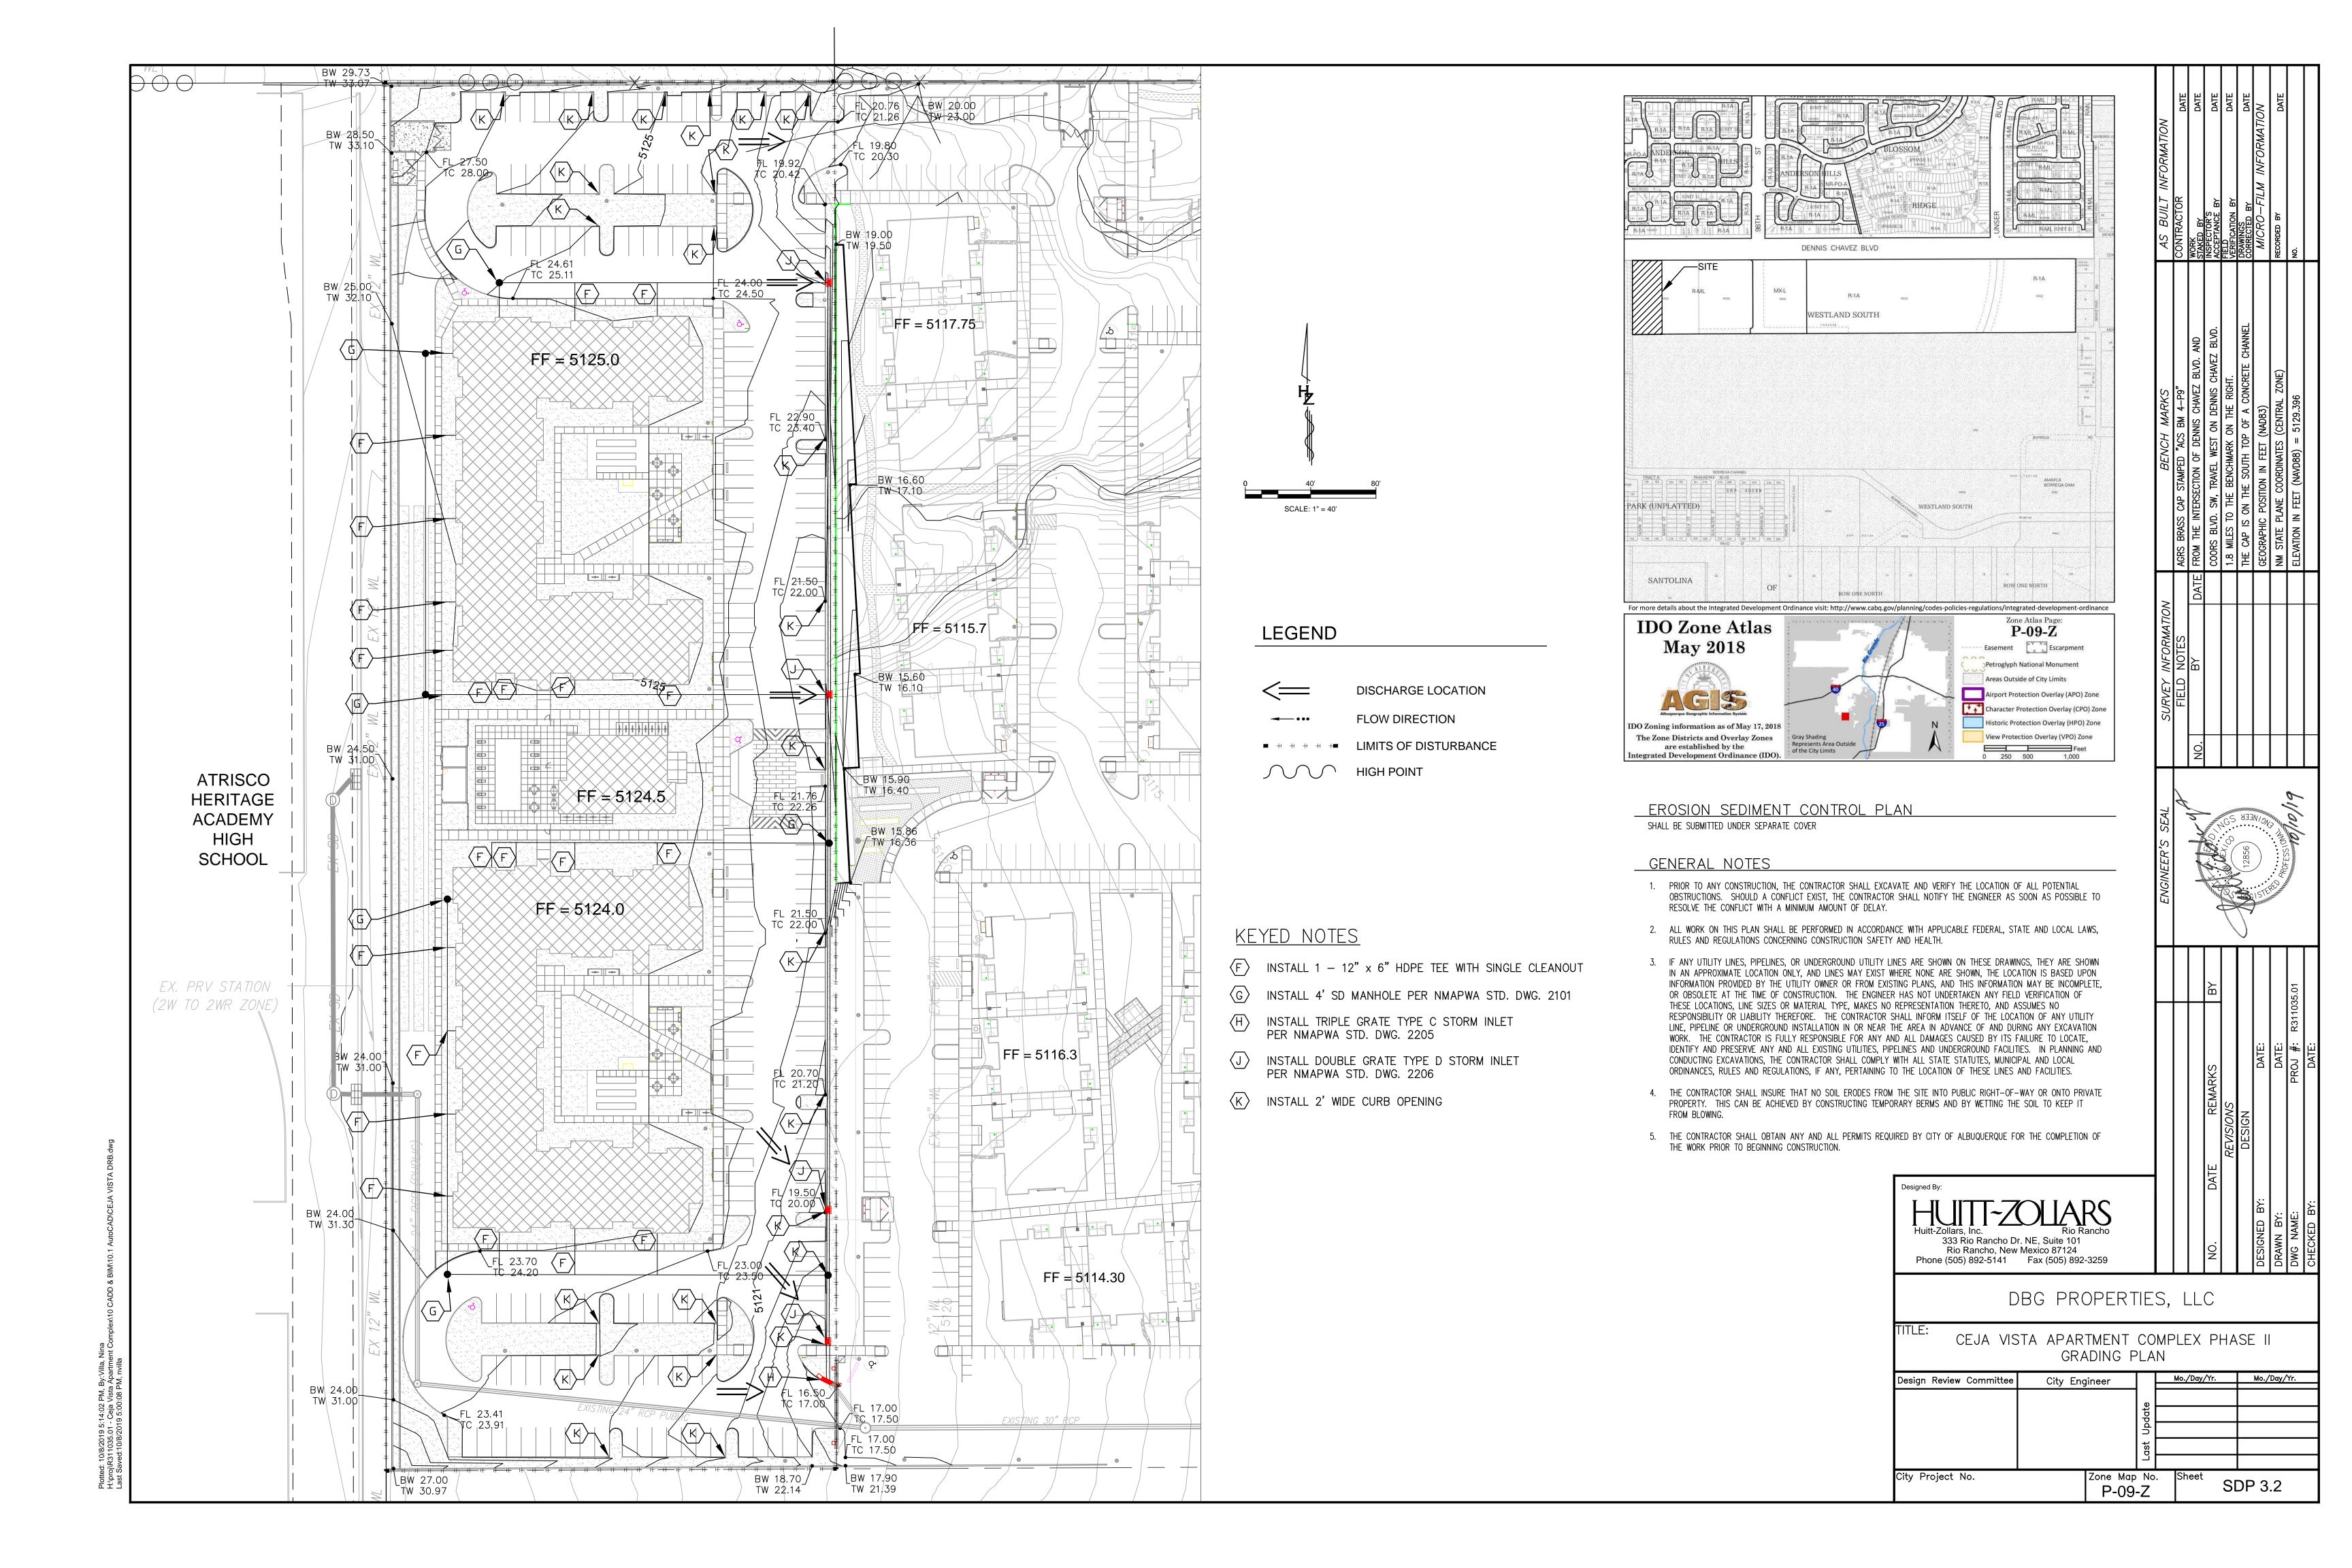

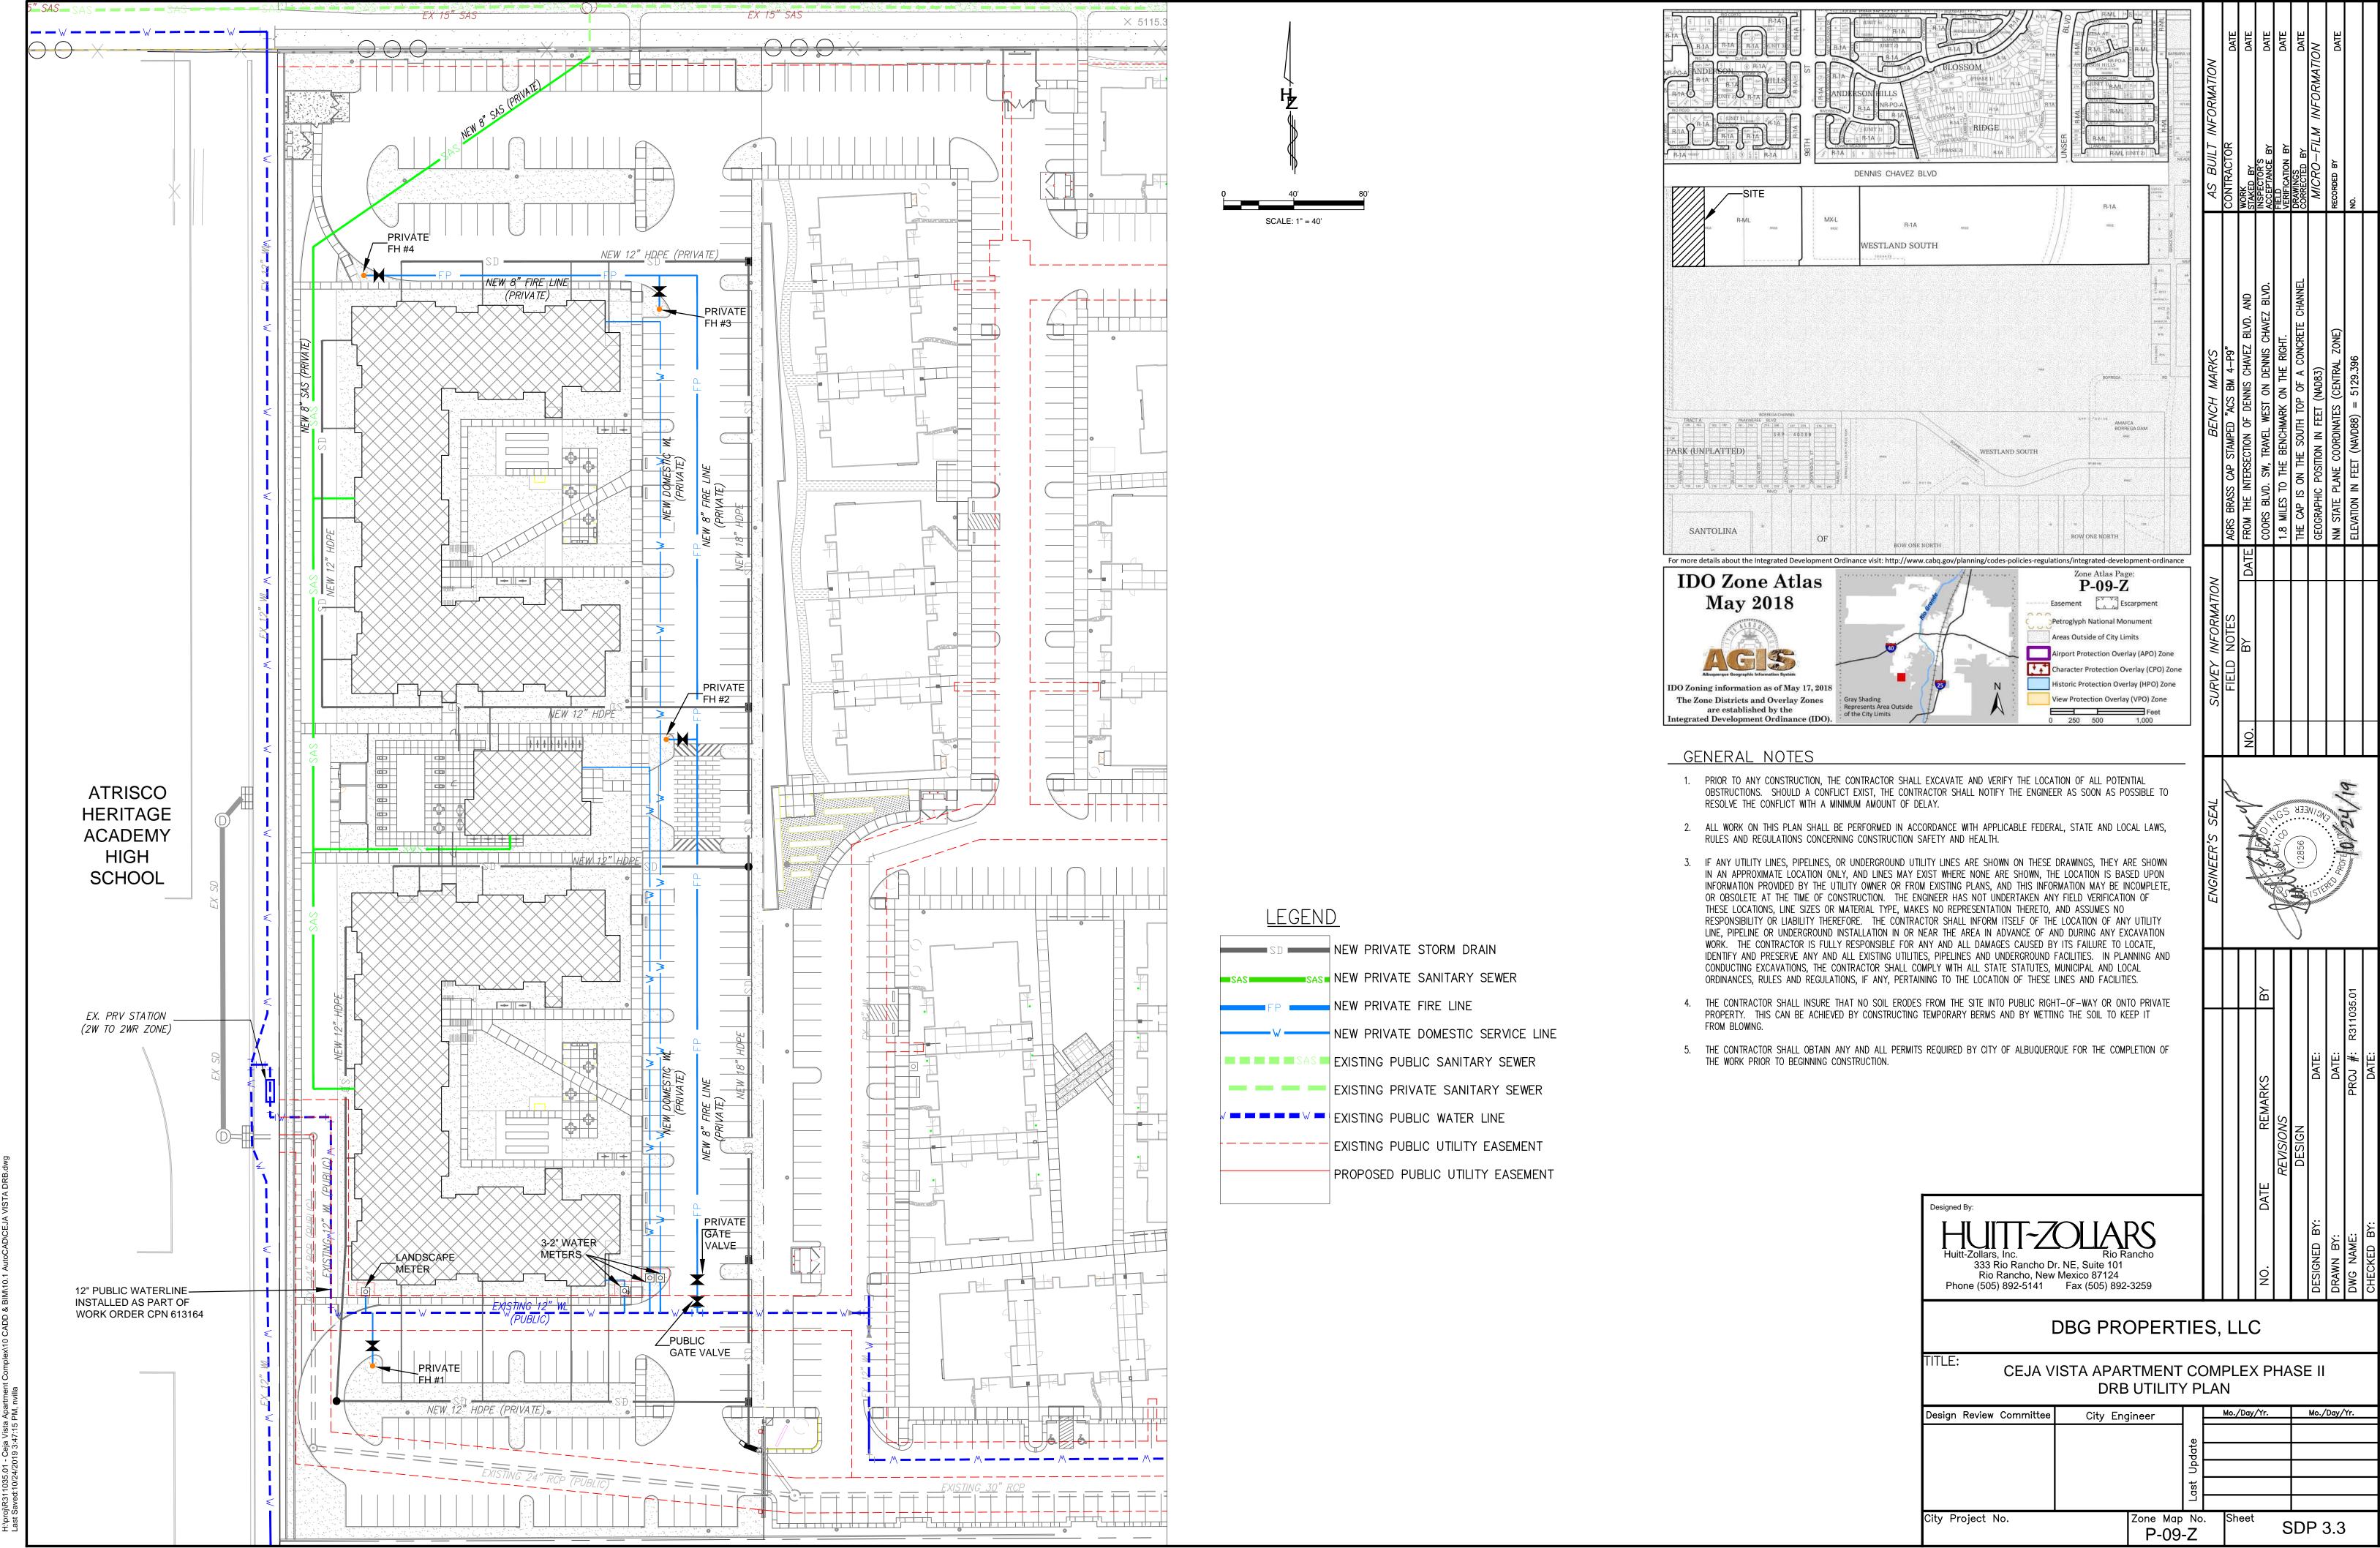


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PROJECT

10001 CEJA VISTA RO ALBUQUERQUE, NN **CEJA VIST** 

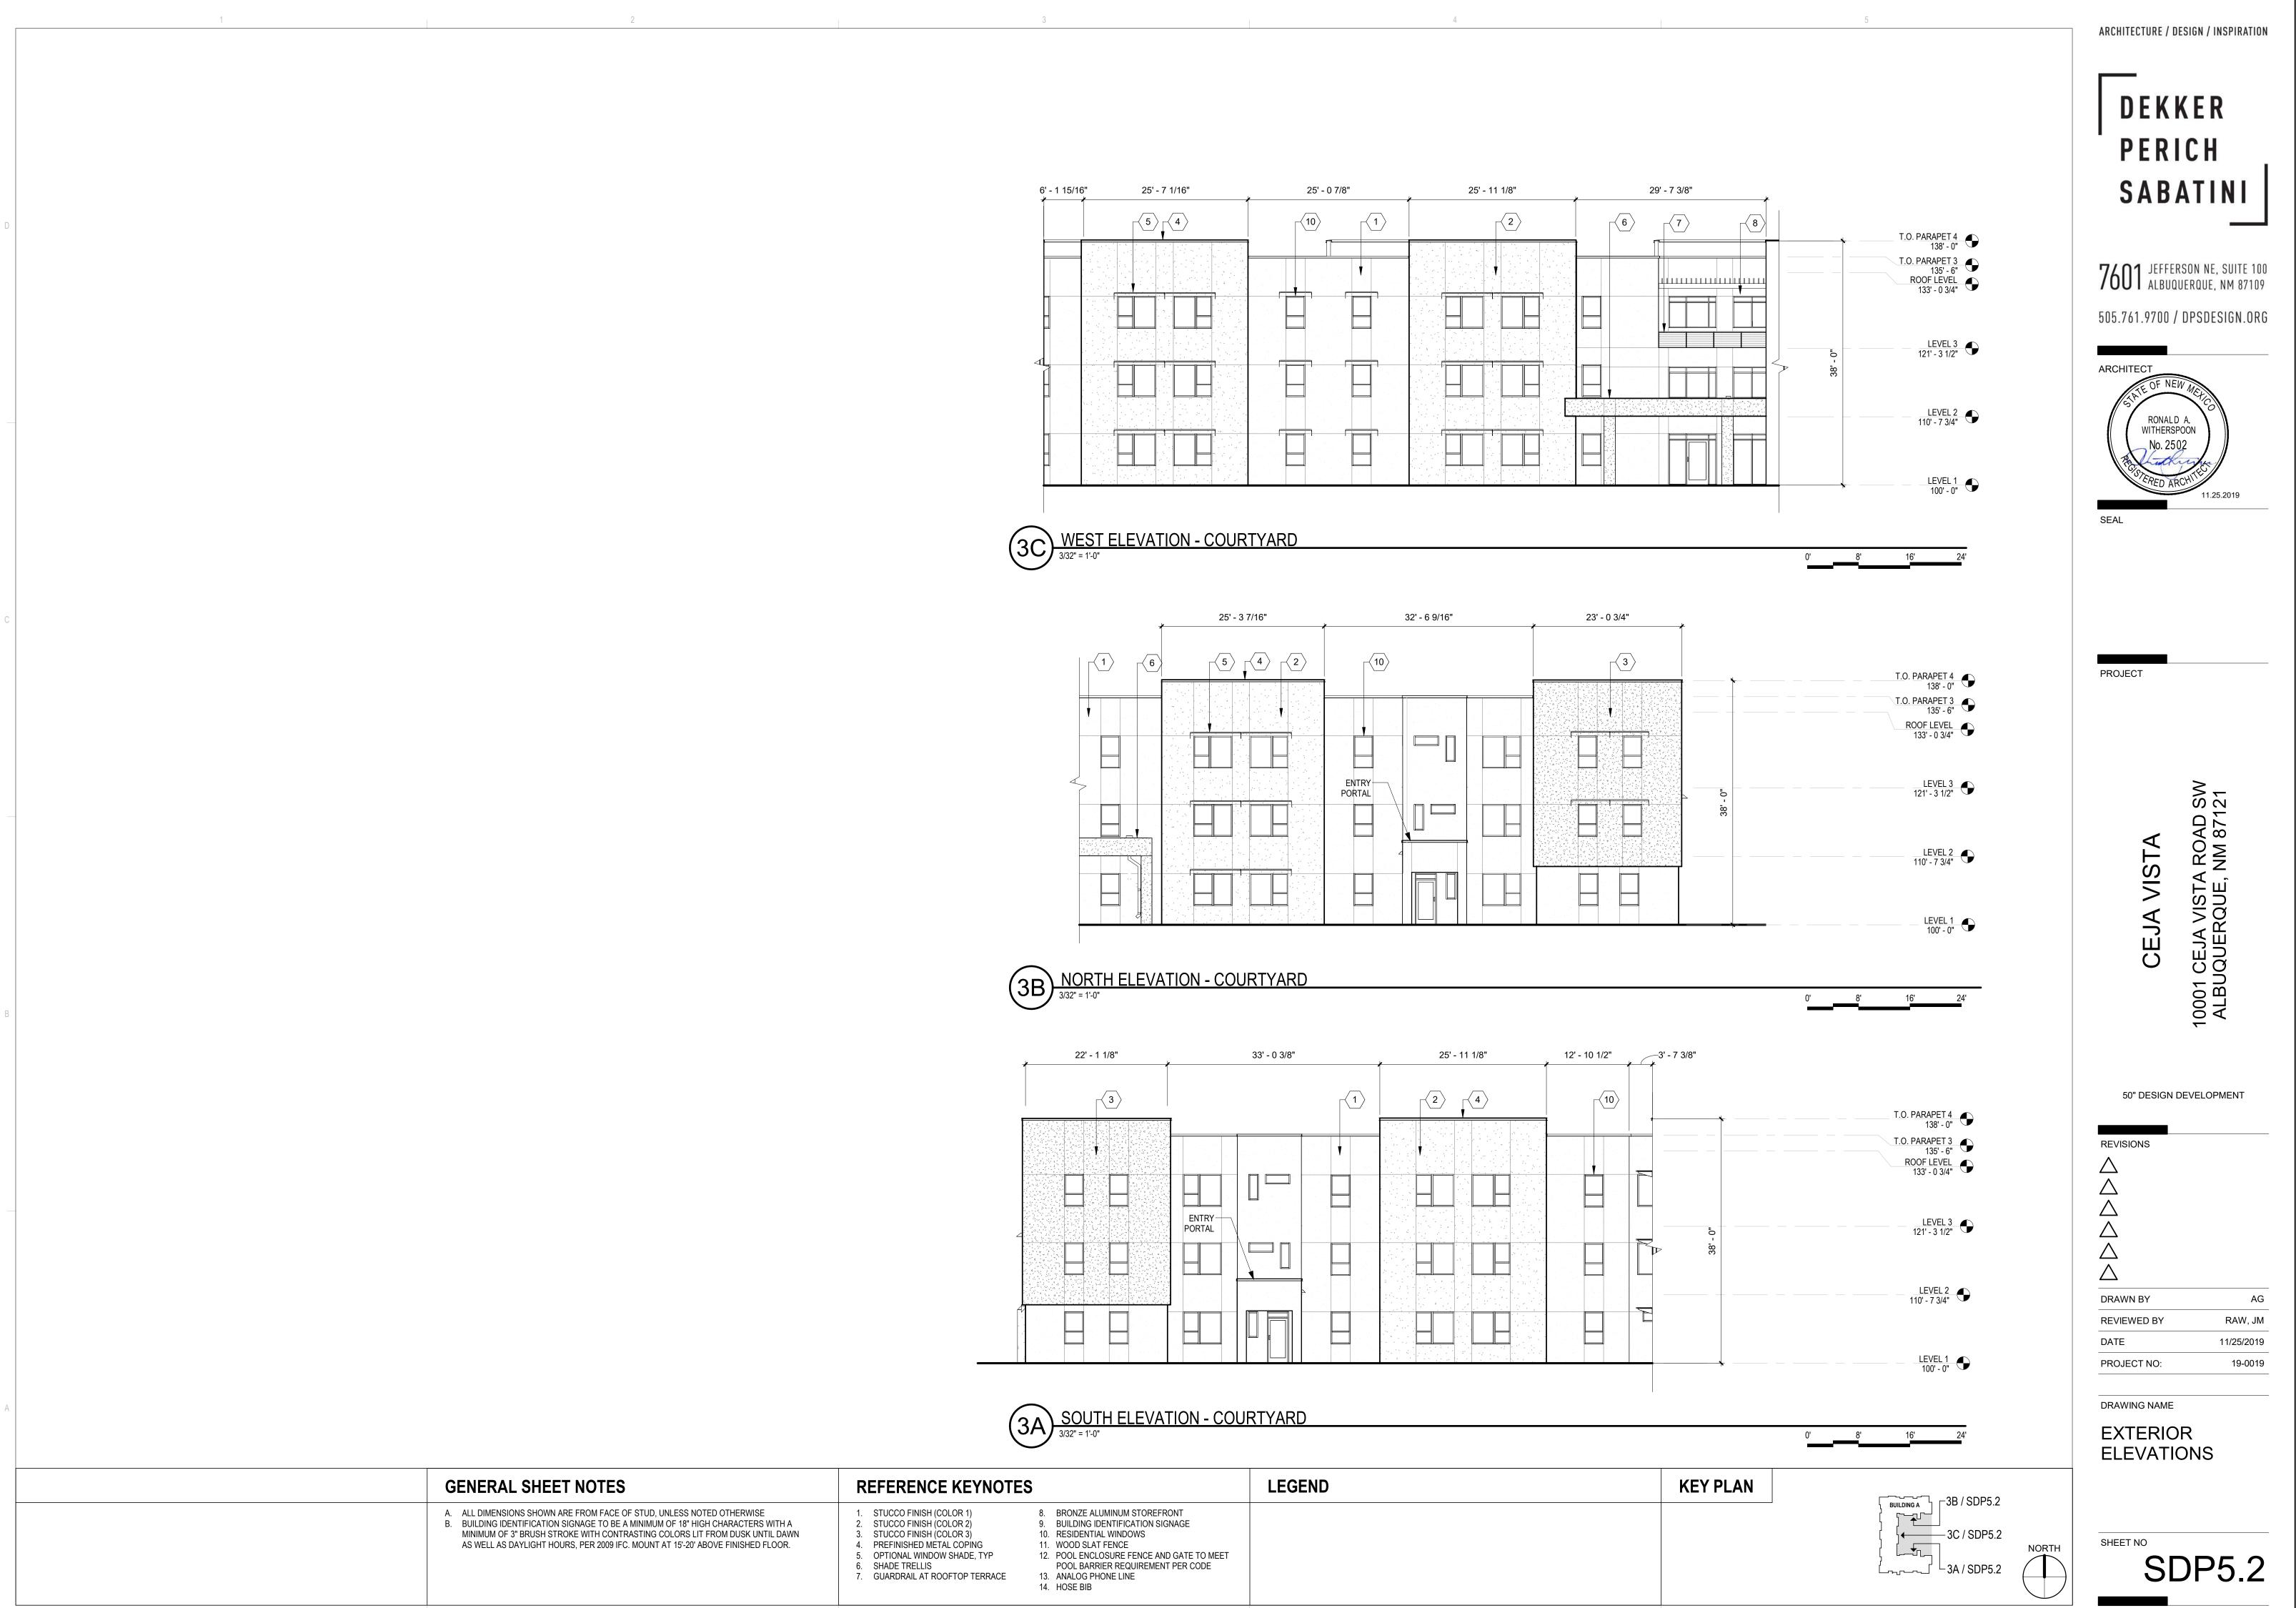50" DESIGN DEVELOPMENT


REVISIONS

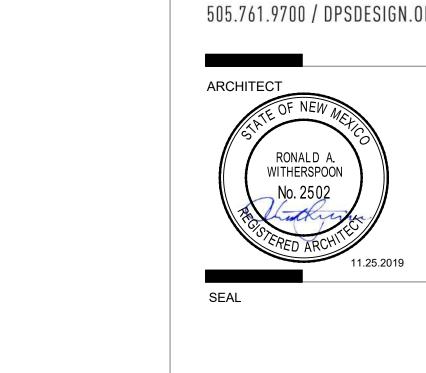RM, AG RAW, JM 11/25/2019

DRAWN BY REVIEWED BY DATE PROJECT NO: 19-0019

DRAWING NAME **EXTERIOR ELEVATIONS** 

SHEET NO SDP5.3

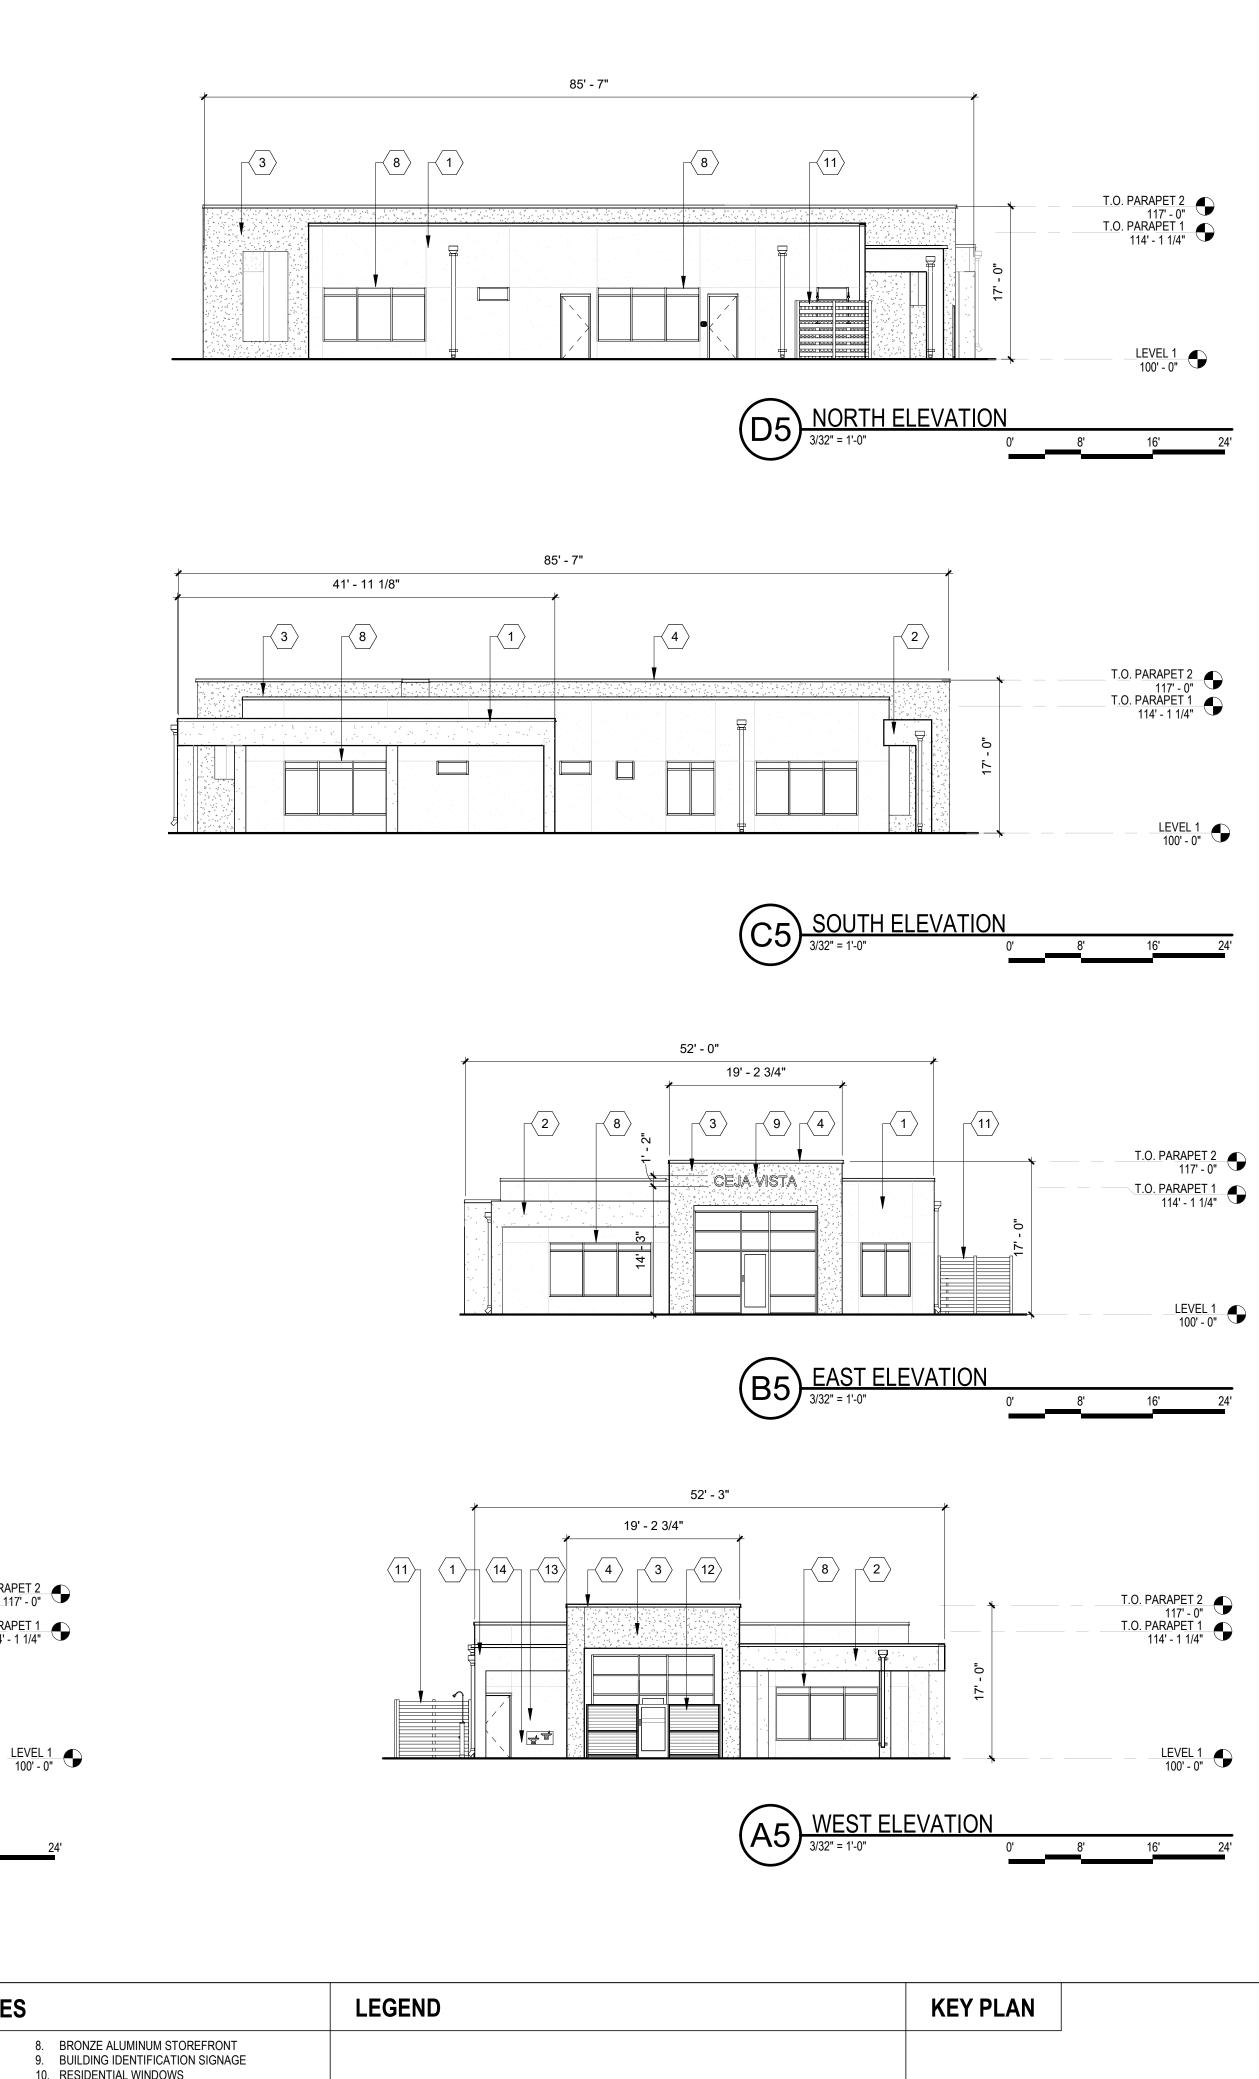

G	ENERAL SHEET NOTES
A. B.	ALL DIMENSIONS SHOWN ARE FROM FACE OF STUD, UNLESS NOTED OTHERWISE BUILDING IDENTIFICATION SIGNAGE TO BE A MINIMUM OF 18" HIGH CHARACTERS WITH A MINIMUM OF 3" BRUSH STROKE WITH CONTRASTING COLORS LIT FROM DUSK UNTIL DAWN AS WELL AS DAYLIGHT HOURS, PER 2009 IFC. MOUNT AT 15'-20' ABOVE FINISHED FLOOR.

52' - 0"

8 2

A2 WEST ELEVATION
3/32" = 1'-0"

19' - 2 3/4"

REFERENCE KEYNOTES 1. STUCCO FINISH (COLOR 1) 2. STUCCO FINISH (COLOR 2) 3. STUCCO FINISH (COLOR 3) 4. PREFINISHED METAL COPING 5. OPTIONAL WINDOW SHADE, TYP


8. BRONZE ALUMINUM STOREFRONT9. BUILDING IDENTIFICATION SIGNAGE10. RESIDENTIAL WINDOWS 11. WOOD SLAT FENCE

12. POOL ENCLOSURE FENCE AND GATE TO MEET POOL BARRIER REQUIREMENT PER CODE
13. ANALOG PHONE LINE
14. HOSE BIB

6. SHADE TRELLIS7. GUARDRAIL AT ROOFTOP TERRACE

T.O. PARAPET 2

T.O. PARAPET 1 114' - 1 1/4"

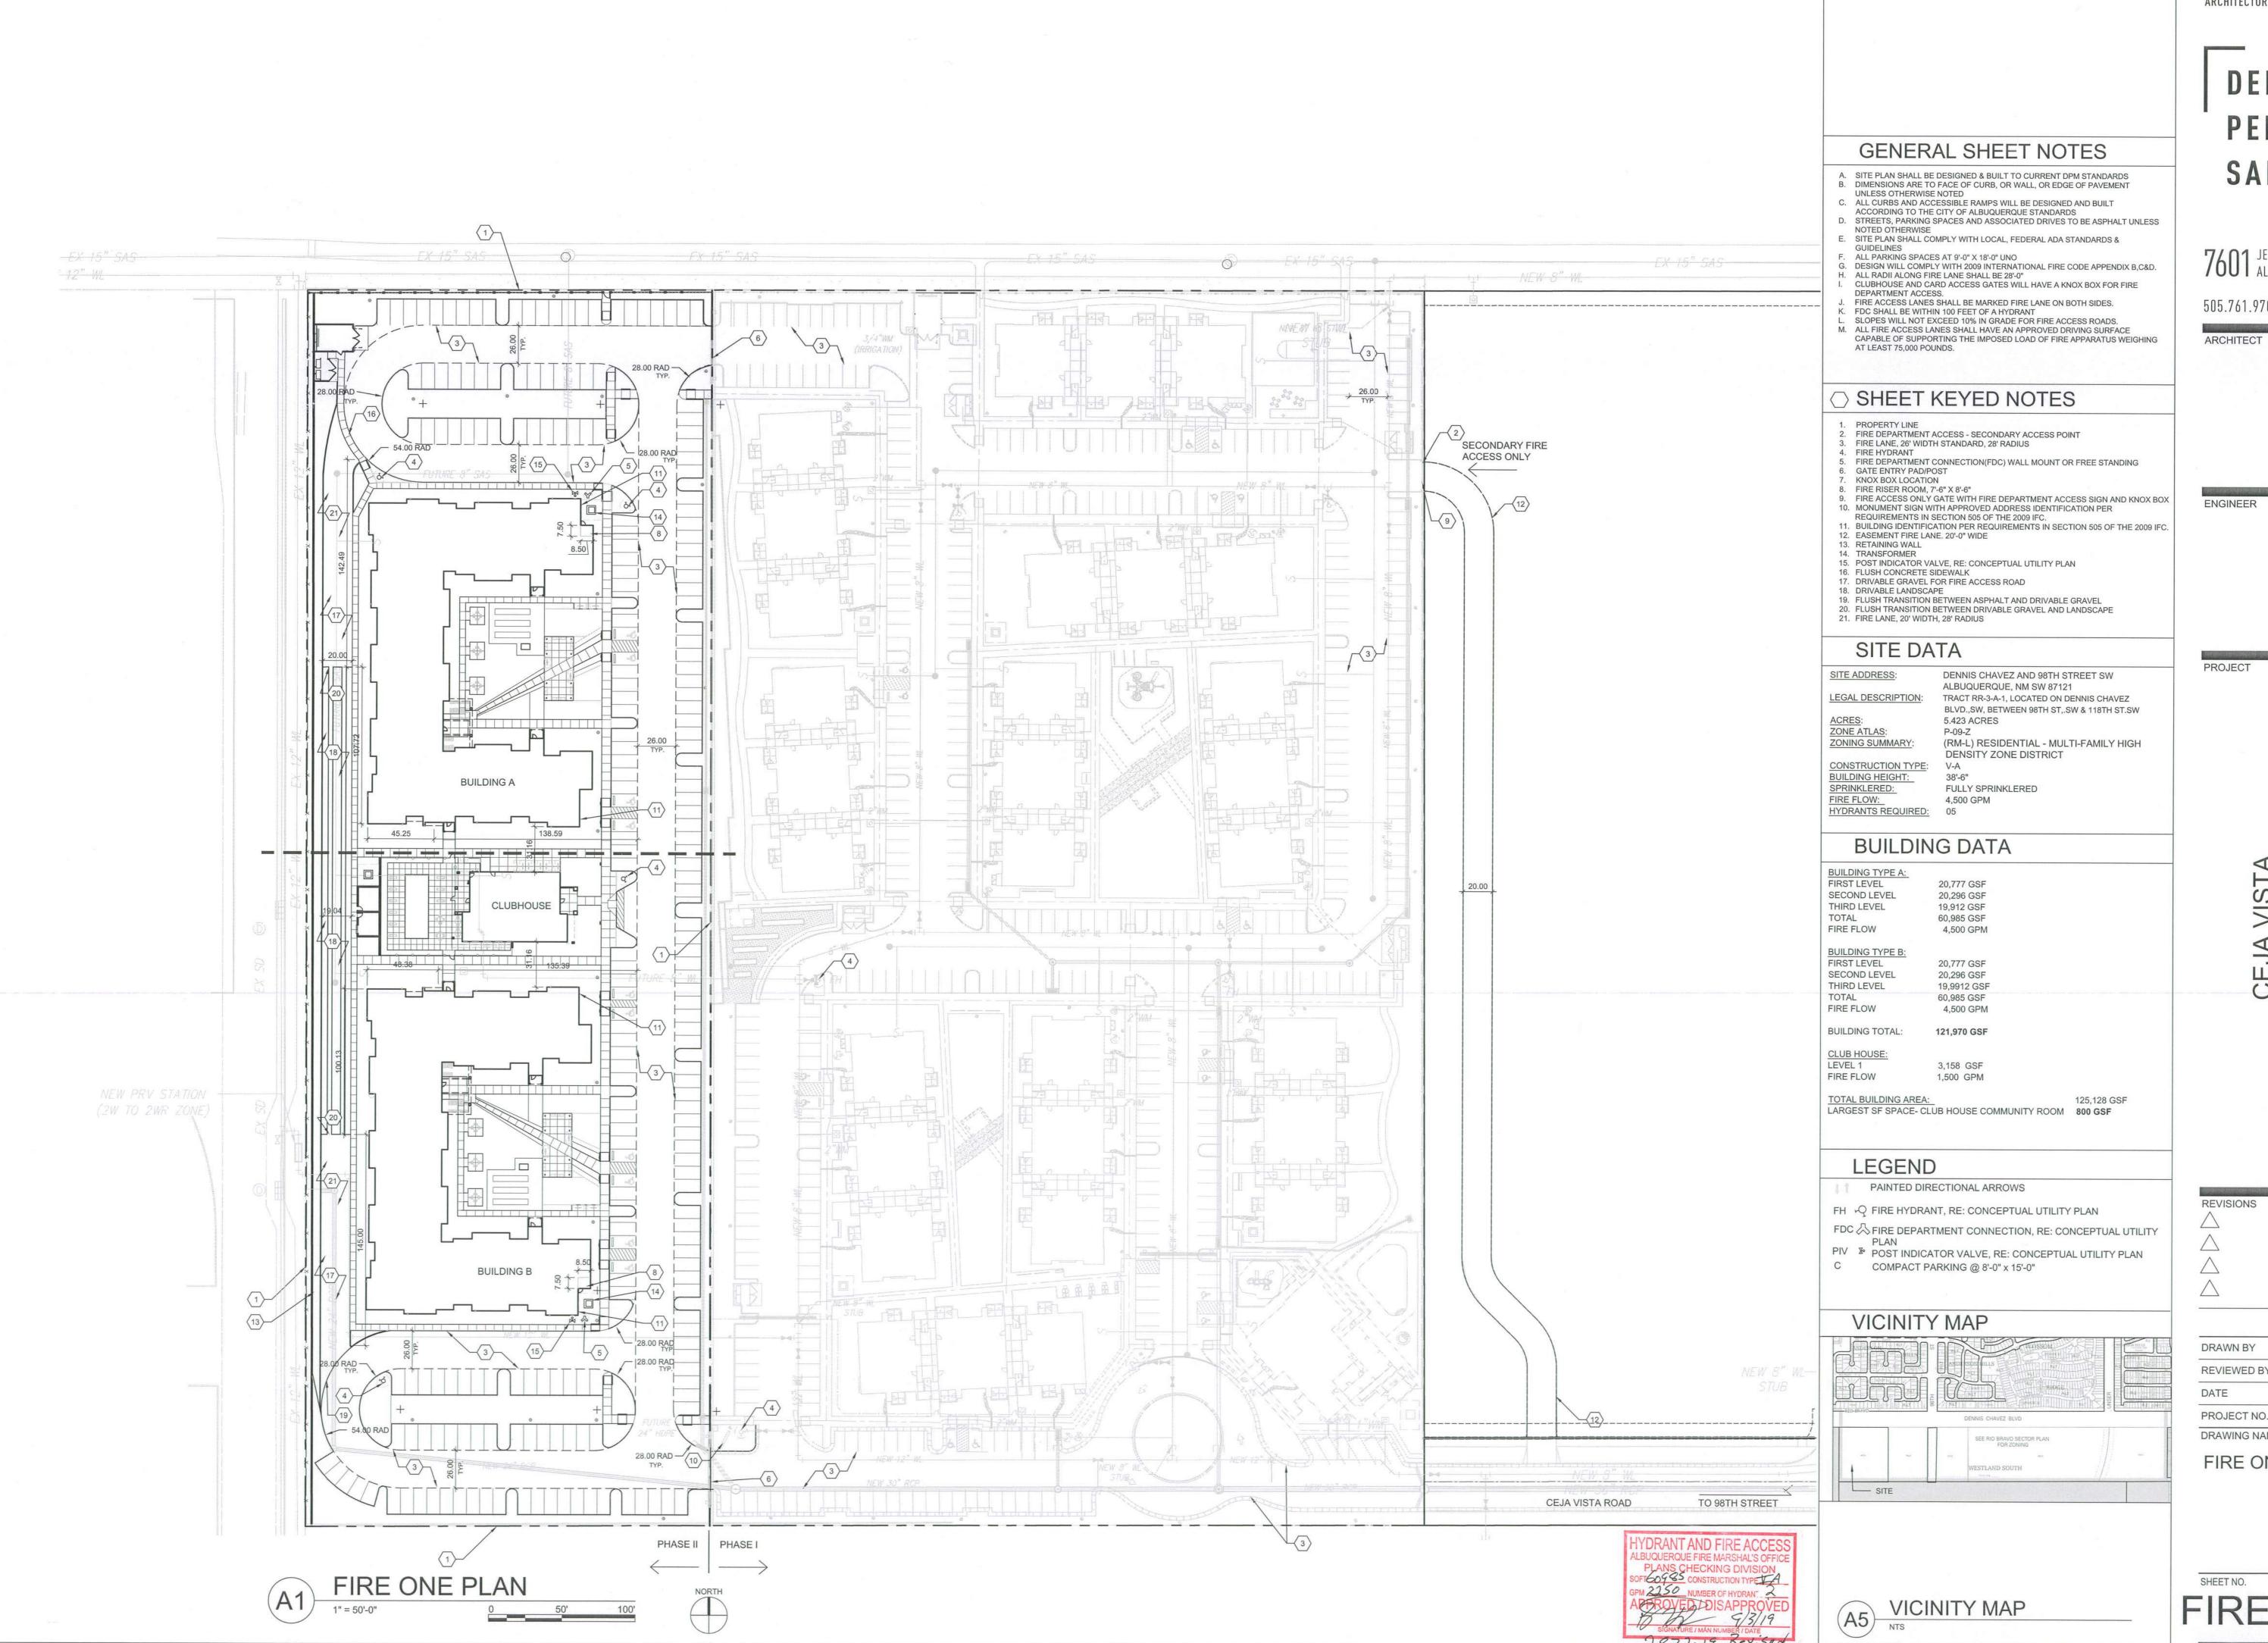

DEKKER PERICH SABATINI

505.761.9700 / DPSDESIGN.ORG

**ENGINEER** 

**REVISIONS** 

JF, AG DRAWN BY RAW, JM **REVIEWED BY** DATE 06/28/2019 PROJECT NO. 19-0019

DRAWING NAME

FIRE ONE PLAN

FIRE ONE

# **LEGEND**

LANDSCAPE AREA STABILIZED CRUSHER FINES INTEGRAL COLORED CONCRETE REINFORCED CONCRETE PAVING

HEAVY DUTY ASPHALT CAPABLE TO SUPPORT 75,000 LBS

---- FIRELANE STRIPING MARKING FIRE ACCESS LANE

PROPERTY LINE

POST INDICATOR VALVE, RE: CONCEPTUAL UTILITY PLAN

SITE LIGHTING

RAISED PLANTING BEDS

CONCRETE BENCH : BIKE RACK

□ 🗘 🐧 OUTDOOR FURNITURE

SIDEWALK RAMP (ARROW POINTS DOWN) TRANSFORMER WITH SAFETY BOLLARDS & 6" THICK CONCRETE PAD PER PNM STANDARDS

PERICH SABATINI

ARCHITECTURE / DESIGN / INSPIRATION

7601 JEFFERSON NE, SUITE 100 ALBUQUERQUE, NM 87109

505.761.9700 / DPSDESIGN.ORG

**ARCHITECT** 

**ENGINEER** 

**PROJECT** 

DATE:

DATE:

DATE:

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DATE:

CEJ/ 10001 CEJA \ BUQUERQUE,

REVISIONS

DRAWN BY AG, RM REVIEWED BY RAW, JM DATE 08/16/2019 PROJECT NO. 19-0019

DRAWING NAME

SITE PLAN

SHEET NO.

ACCESSIBLE PARKING WITH ACCESSIBLE SIGNAGE AND STRIPING, REF: A3/SDP1.2. ACCESSIBLE RAMP, REF: A3/SDP1.2, C2/SDP1.2 & C3/SDP1.2.

MOTORCYCLE PARKING 8. BIKE RACK/PARKING PER IDO AND DPM STANDARD WITH TWO-POINT BIKE LOCKING, REF: D5/SDP1.2.

. ACCESSIBLE AISLE WITH STRIPING 10. MONUMENT SIGN PER IDO REQUIREMENTS, REF: D1/SDP1.2 & D2/SDP1.2.

11. SHADE STRUCTURE

12. RAISED GARDEN BEDS 13. POTTING STATION TABLE.

E. STREETS, PARKING SPACES AND ASSOCIATED DRIVES TO BE

F. PROVIDE POURABLE SEALANT AT ALL EXPANSION JOINTS IN

CONCRETE SIDEWALK, WHERE EXPANSION JOINT MATERIAL

PROVIDED BETWEEN WALLS AND SIDEWALKS AND BETWEEN

PROVIDE AIR ENTRAINED CONCRETE WITH MEDIUM BROOM FINISH

AT ALL SITE CONCRETE. SLOPE ALL CONCRETE SIDEWALKS TO

DRAIN, TYP. RE: CIVIL FOR SPOT ELEVATIONS, GRADING AND

H. SOLID WASTE CONNECTION IS THE RESPONSIBILITY OF THE CITY

LANDSCAPE AND SIGNAGE WILL NOT INTERFERE WITH CLEAR

BETWEEN 3 FEET AND 8 FEET TALL (AS MEASURED FROM THE

GUTTER PAN) WILL NOT BE PERMITTED IN THE CLEAR SIGHT

SIGHT REQUIREMENTS. THEREFORE SIGNS, WALLS AND PLANTING

OF ALBUQUERQUE SOLID WASTE DEPARTMENT.

ASPHALT UNLESS NOTED OTHERWISE.

ASPHALT AND CONCRETE JOINTS.

DRAINAGE.

TRIANGLE.

14. 6' WIDE CONCRETE SIDEWALK PER COA IDO STANDARDS, REF: B5/SDP1.2.

15. 4' WIDE SIDEWALK CONCRETE, REF: B5/SDP1.2. 16. CONCRETE CURB AND GUTTER, REF: A2/SDP1.2

17. FLUSH CONCRETE SIDEWALK, REF: D4/SDP1.2 18. FIRE RISER ROOM

19. FIRE ACCESS GATE & KNOX BOX (LOCATE PER FIRE ONE PLAN) 20. FIRE DEPARTMENT CONNECTION (FDC) WALL MOUNT OR FREE STANDING

21. ELECTRICAL TRANSFORMER (ON 6" CONCRETE PAD) 22. PARKING STRIPING 4" WIDE, COLOR WHITE

31. VANPOOL PARKING SETBACKS: FRONT= 15', SIDE= STREET 10', INTERIOR= 5', REAR= 15' 32. GATE ENTRY PAD/ POST WITH CONTROL ACCESS FOB BUILDING HEIGHT: 35'-0"+10% DEVIATION @ 3'-0" = 38'-0" SPRINKLED: FULLY SPRINKLED

POOL EQUIPMENT ENCLOSURE 34. MAINTENANCE EQUIPMENT ROOM

> **HYDRANTS REQUIRED:** 5 TOTAL **BUILDING OCCUPANCY: R-2, 156 APARTMENTS** CONSTRUCTION TYPE: V-B, FULLY SPRINKLED BUILDING SF: **BUILDING A** 20,777 GSF

> > 3,158 GSF

125,128 GSF

FIRST LEVEL SECOND LEVEL 20,296 GSF THIRD LEVEL 19,912 GSF 60,985 GSF **BUILDING B** FIRST LEVEL 20,777 GSF SECOND LEVEL 20,296 GSF THIRD LEVEL 19,912 GSF 60,985 GSF

FIRE FLOW: 4,500 GPM

CLUBHOUSE

MOTORCYCLE PARKING REQUIRED AND PROVIDED = 5 SPACES FOR 51-300 TOTAL PARKING SPACES REQUIRED = 5 SPACES PROVIDED = 5 SPACES

25% OF 223 REQUIRED PARKING MAY BE COMPACT

STANDARD ACCESSIBLE SPACES:

BIKE PARKING: 00.25 PER UNIT

REQUIRED:  $0.25 \times 156 = 39$ 

EXTERIOR BIKE PARKING: 32

20% SECURED LONG TERM STORAGE: 8

PROVIDED: 10 SPACES

PROVIDED: 40

PROVIDED COMPACT PARKING: 5 SPACES @ 8'-0" x 15'-0"

REQUIRED: 8 STANDARD SPACES & 2 VAN ACCESSIBLE

PROVIDED STANDARD PARKING: 218 SPACES @ 9'-0" x 18'-0"

POOL PERIMETER FENCE