

PER THIS ADMINISTRATIVE AMENDMENT •

LOCKER ROOM FACILITY AT MDS

CONVINAL
ENTERPRISES

AT

WALKY
WALK

SCALE 1" = 2000'
ZONE ATLAS MAPS R-14-Z & R-15-Z

•

SUBDIVISION DATA

PROJECT LIMITS AREA = 48 acres ±
ZONE: SU-1 FOR URBAN REGIONAL PARK
PARKING: 3,600 SPACES
(PROVIDED BY BERNALILLO COUNTY, Z-97-141)

LEGAL DESCRIPTION

THAT CERTAIN PARCEL OF LAND SITUATE WITHIN SECTION 21, AND THE EAST HALF OF SECTION 20, TOWNSHIP 9 NORTH, RANGE 3 EAST, BERNALILLO COUNTY, NEW MEXICO, CONSISTING OF 48 ACRES \pm

DRB 99.6

CASE NUMBER Z-98-26
THIS PLAN IS CONSISTENT WITH THE SPECIFIC SITE DEVELOPMENT

THIS PLAN IS CONSISTENT WITH THE SPECIFIC SITE DEVELOPMENT
PLAN APPROVED BY THE ENVIRONMENTAL PLANNING COMMISSION
ON DECEMBER, 1997 AND THE FINDINGS IN THE OFFICIAL
NOTICE OF DECISION HAVE BEEN COMPLIED WITH.

DATE

Bradley Bingham

11-3-99

UTHLITY DEVELOPMENT

DATE

11-03-90

TRANSPORTATION DEVELOPMENT

DATE

CITY ENGINEER / HYDROLOGY

DATE

Living

11-3-99

DATE

DATE

AMPHITHEATER AND ASSOCIATED FACILITIES INCLUDING STORAGE
FACILITIES, RESTROOMS, TICKET SALES OFFICE AND CONCESSIONS.
THE AMPHITHEATER ACCOMODATES A MAXIMUM OF 8,400 SPECTATORS
PURSUANT TO THE MESA DEL SOL LEVEL B PLAN AND TRAFFIC
IMPACT STUDY APPROVED MAY 25, 1996. CAPACITY TO EXPAND
TO 15,000 ONCE ACCESS IS PROVIDED FROM UNIVERSITY BOULEVARD.

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ALBUQUERQUE, NM 87106

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505.842.8865

SEATING CAPACITY: SEE SHEET 2, NOTE 5
-AMPHITHEATER AND ASSOCIATED FACILITIES INCLUDING STORAGE FACILITIES.

A RESTROOMS, TICKET SALES OFFICE AND CONCESSIONS. THE AMPHITHEATER ACCOMODATES A MAXIMUM OF 12,000 SPECTATORS PURSUANT TO THE MESA DE SOL LEVEL B PLAN, TRAFFIC IMPACT STUDY APPROVED MAY 25, 1996.

SUPPLEMENTAL TRAFFIC ANALYSIS DATED JUNE, 2000, AND THAT PERFORMANCES WILL BE CONTROLLED EVENTS WITH APPROVED TRAFFIC MANAGEMENT. CAPACITY TO EXPAND TO 15,000 ONCE ACCESS IS PROVIDED FROM UNIVERSITY BOULEVARD.


November 2, 1999

MESA DEL SOL

REGIONAL RECREATION COMPLEX

PHASE 1B AMPHITHEATER


OVERALL PLAN SHEET 1 OF 14

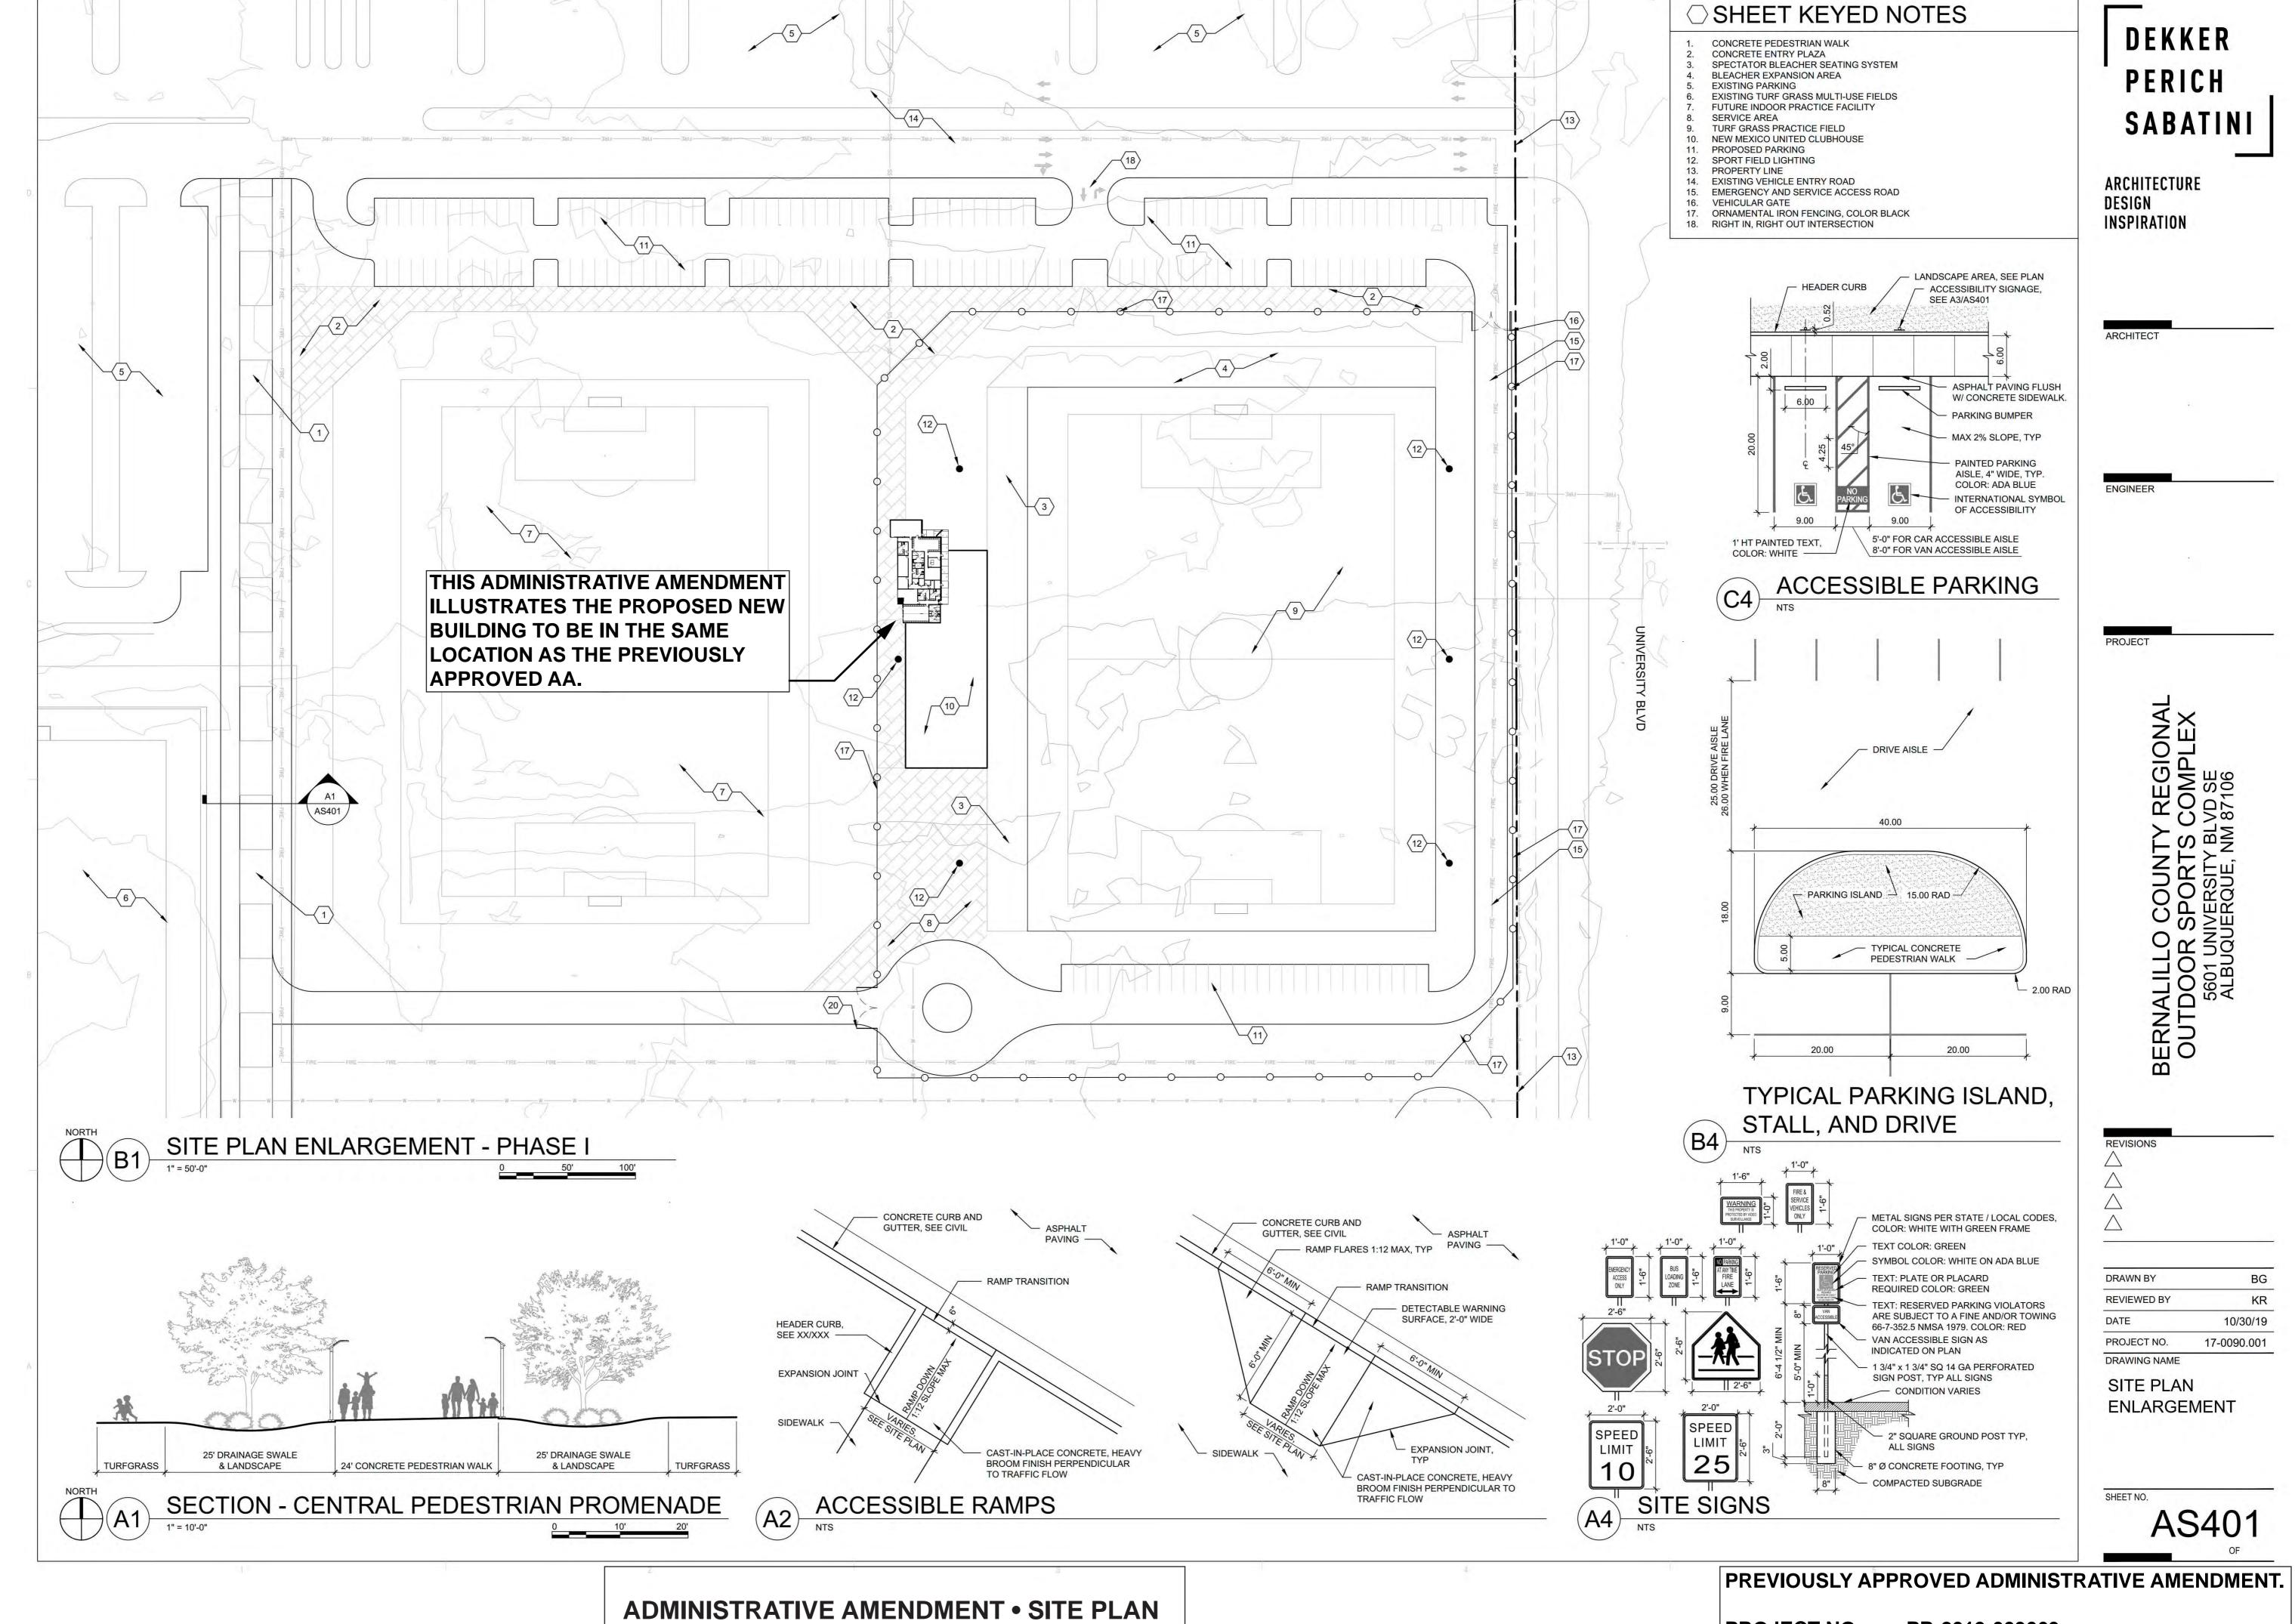



LOCKER ROOM FACILITY AT MDS


PROJECT NO: CASE NO. APPROVED:

PR-2019-003069 SI-2019-00365 27 APRIL 2020

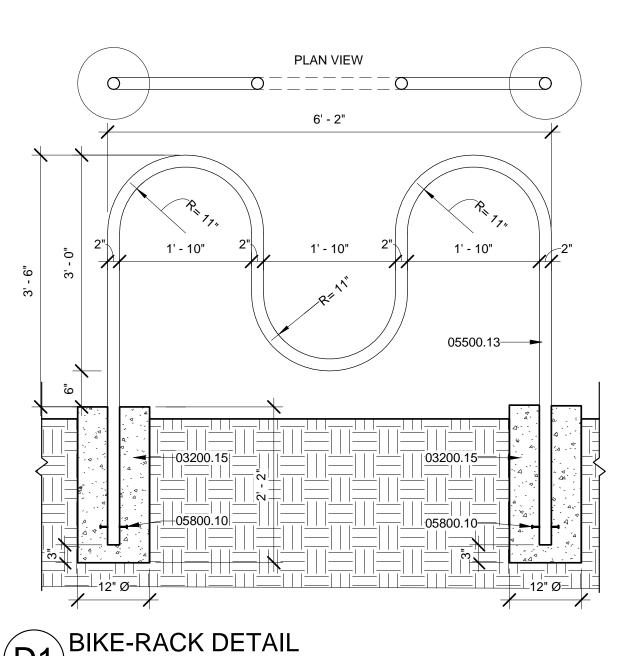

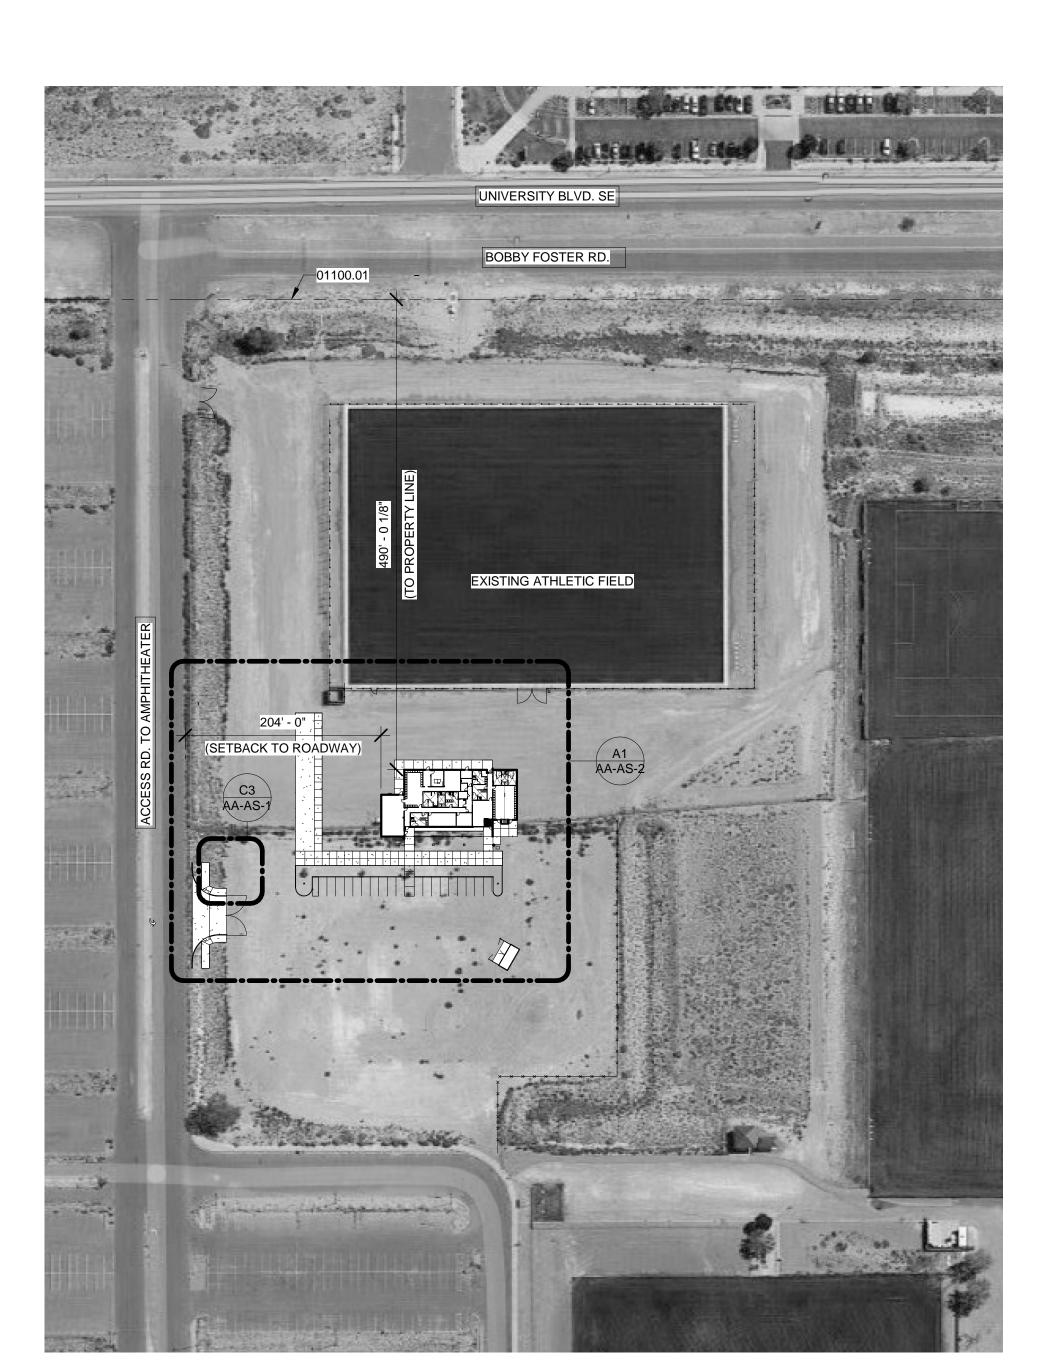

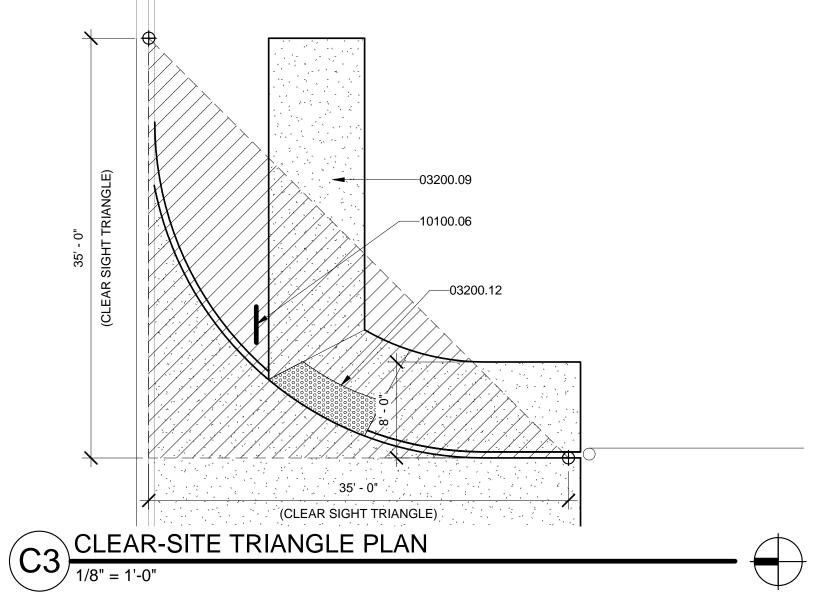

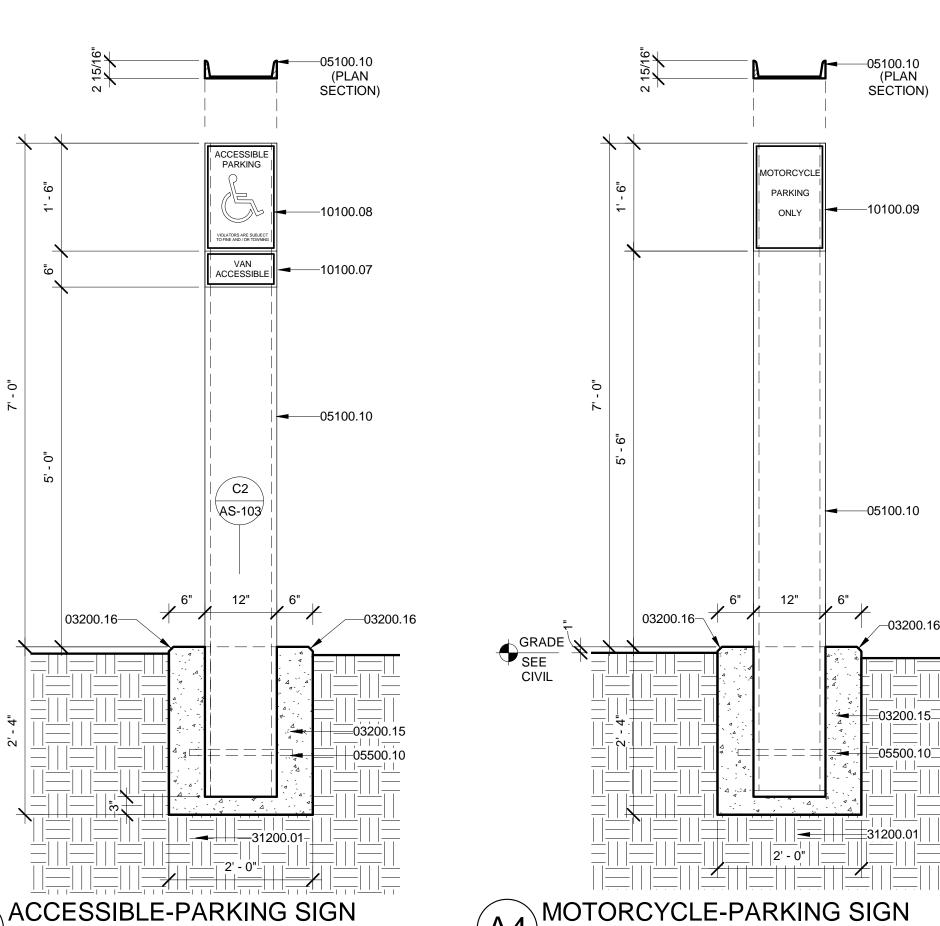



SITE DETAILS.

01100.01 PROPERTY LINE. 03200.09 CONCRETE SIDEWALK PER CITY OF ALBUQUERQUE STANDARD SPECIFICATIONS. REFER TO CITY STANDARD DETAIL DWG. 2430. SEE

03200.12 CONCRETE ACCESSIBLE SIDEWALK RAMP WITH TRUNCATED DOMES PER CITY OF ALBUQUERQUE STANDARD SPECIFICATION. REFER TO COA STANDARD DWGS. 2440 AND 2441. SEE CIVIL.

03200.15 4000 PSI, AIR-ENTRAINED CAST IN PLACE CONCRETE FOOTING. 03200.16 CHAMFER OUTSIDE EDGE 3/4", TYPICAL. STEEL CHANNEL POST, C12 X 20.7, SIGN POST. PRIME AND PAINT. SEE

NO. 6 REBAR X 18" LONG BAR. DRILL HOLES IN 'C' CHANNEL FLANGE, TACK WELD STEEL BAR INTO PLACE. 2"Ø STEEL PIPE BIKE RACK. SET IN CONCRETE FOOTING. GRIND EDGES

SMOOTH. PRIME AND PAINT. (3) 3" LONG STUD BOLTS WELDED TO PIPE.

STOP SIGN (R1-1) AND NO LEFT TURN SIGN (R3-1) PER MUTCD STANDARDS. ALÚMINUM OR FIBERGLASS PLATE: SIGN FIELD IS RED, BORDER AND LETTERING ARE WHITE. SEE DETAIL C4 / AS-103.

PROVIDE "VAN ACCESSIBLE" SIGN AT DESIGNATED LOCATIONS. SEE 10100.07 ENLARGED SITE PLANS.

ADA ACCESSIBLE PARKING SIGN. ALUMINUM OR FIBERGLASS PLATE: SIGN FIELD IS WHITE, SIGN LETTERING AND BORDERS ARE GREEN. SEE DETAIL A3 / AA-AS-1. LOCATE SIGN CENTERED ON PARKING SPACE AND 1'-8" BACK FROM EDGE OF SIDEWALK. CAST IN CONCRETE SIDEWALK.

10100.09 MOTORCYCLE PARKING SIGN. ALUMINUM OR FIBERGLASS PLATE: SIGN FIELD IS WHITE, SIGN LETTERING AND BORDERS ARE GREEN. SEE DETAIL A4 / AA-AS-1. LOCATE SIGN CENTERED PARKING SPACE.

31200.01 COMPACTED SUBGRADE AT 95% MIN. SEE GEOTECHNICAL REPORT.

Isleta Amphitheater MESA DEL SOL SITE LOCATION

ZONE LOCATION MAP R-15-Z

5601 UNIVERSITY BLVD. SE ALBUQUERQUE, NM 87105

THE SITE IS LOCATED WITHIN THE CITY OF ALBUQUERQUE

 IT IS LEASED BY BERNALILLO COUNTY IT IS OWNED BY THE STATE OF NEW MEXICO

NR-PO-C: IS PERMISSIVE AS PARKS AND OPEN SPACE,

COA ZONING:

TR 13 BULK LAND PLAT OF MESA DEL SOL TRACTS 1-15CONT

PER IDO A-3(c)(7)(a). NOTE: DAVID FLORES (DEPUTY DIRECTOR) OF THE COA PARKS AND RECREATION DEPT. SUPPORTS THIS PROJECT.

[PER TABLE 4-2-1 ALLOWABLE USES: THIS FACILITY IS PERMISSIVE]

PARKING REQUIREMENTS PER IDO 14-16-5-5: CLUB OR EVENT FACILITY

PARKING REQUIREMENTS:
1 SPACE / 1,000 GSF OR 1 SPACE / 4 SEATS IN MAIN ASSEMBLY

THEREFORE:
PER BUILDING AREA: 7,971 GSF = 8 SPACES

MAIN ASSEMBLY / TEAM MEETING ROOM = 65 OCCUPANTS

<u>65</u> = 16.25 = **17 SPACES**

NOTE: THE LARGER OF THE CALCULATIONS BASED ON BUILDING AREA VS. ASSEMBLY OCCUPANTS WAS USED AS THE MINIMUM BUMBER OF REQUIRED SPACES = 17


VEHICLE PARKING PROVIDED:

BICYCLE SPACES REQUIRED:

19 PARKING SPACES 19 IS GREATER THAN 17, THEREFORE OK.

1 SPACE **HANDICAPPED PARKING REQUIREMENTS:** HANDICAPPED PARKING PROVIDED: 12 SPACES MOTORCYCLE SPACES REQUIRED: 1 SPACE MOTORCYCLE SPACES PROVIDED: 1 SPACE

BICYCLE SPACES PROVIED:

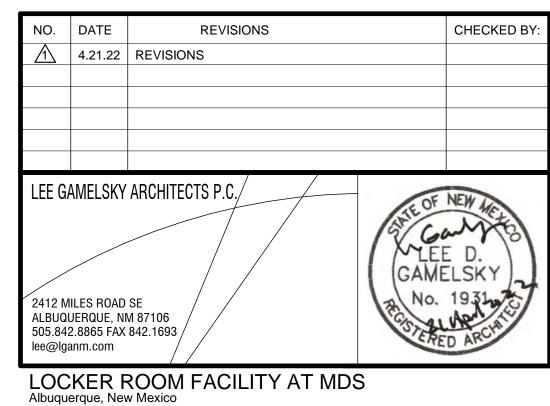


PROJECT ARCHITECT: LGA Project #: 20-01-ABQ.7 LEE GAMELSKY, AIA 4.21.2022


ADMINISTRATIVE AMENDMENT • **OVERALL SITE PLAN** LOCKER ROOM FACILITY AT MDS

AA-AS-1



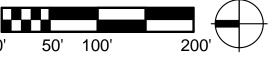



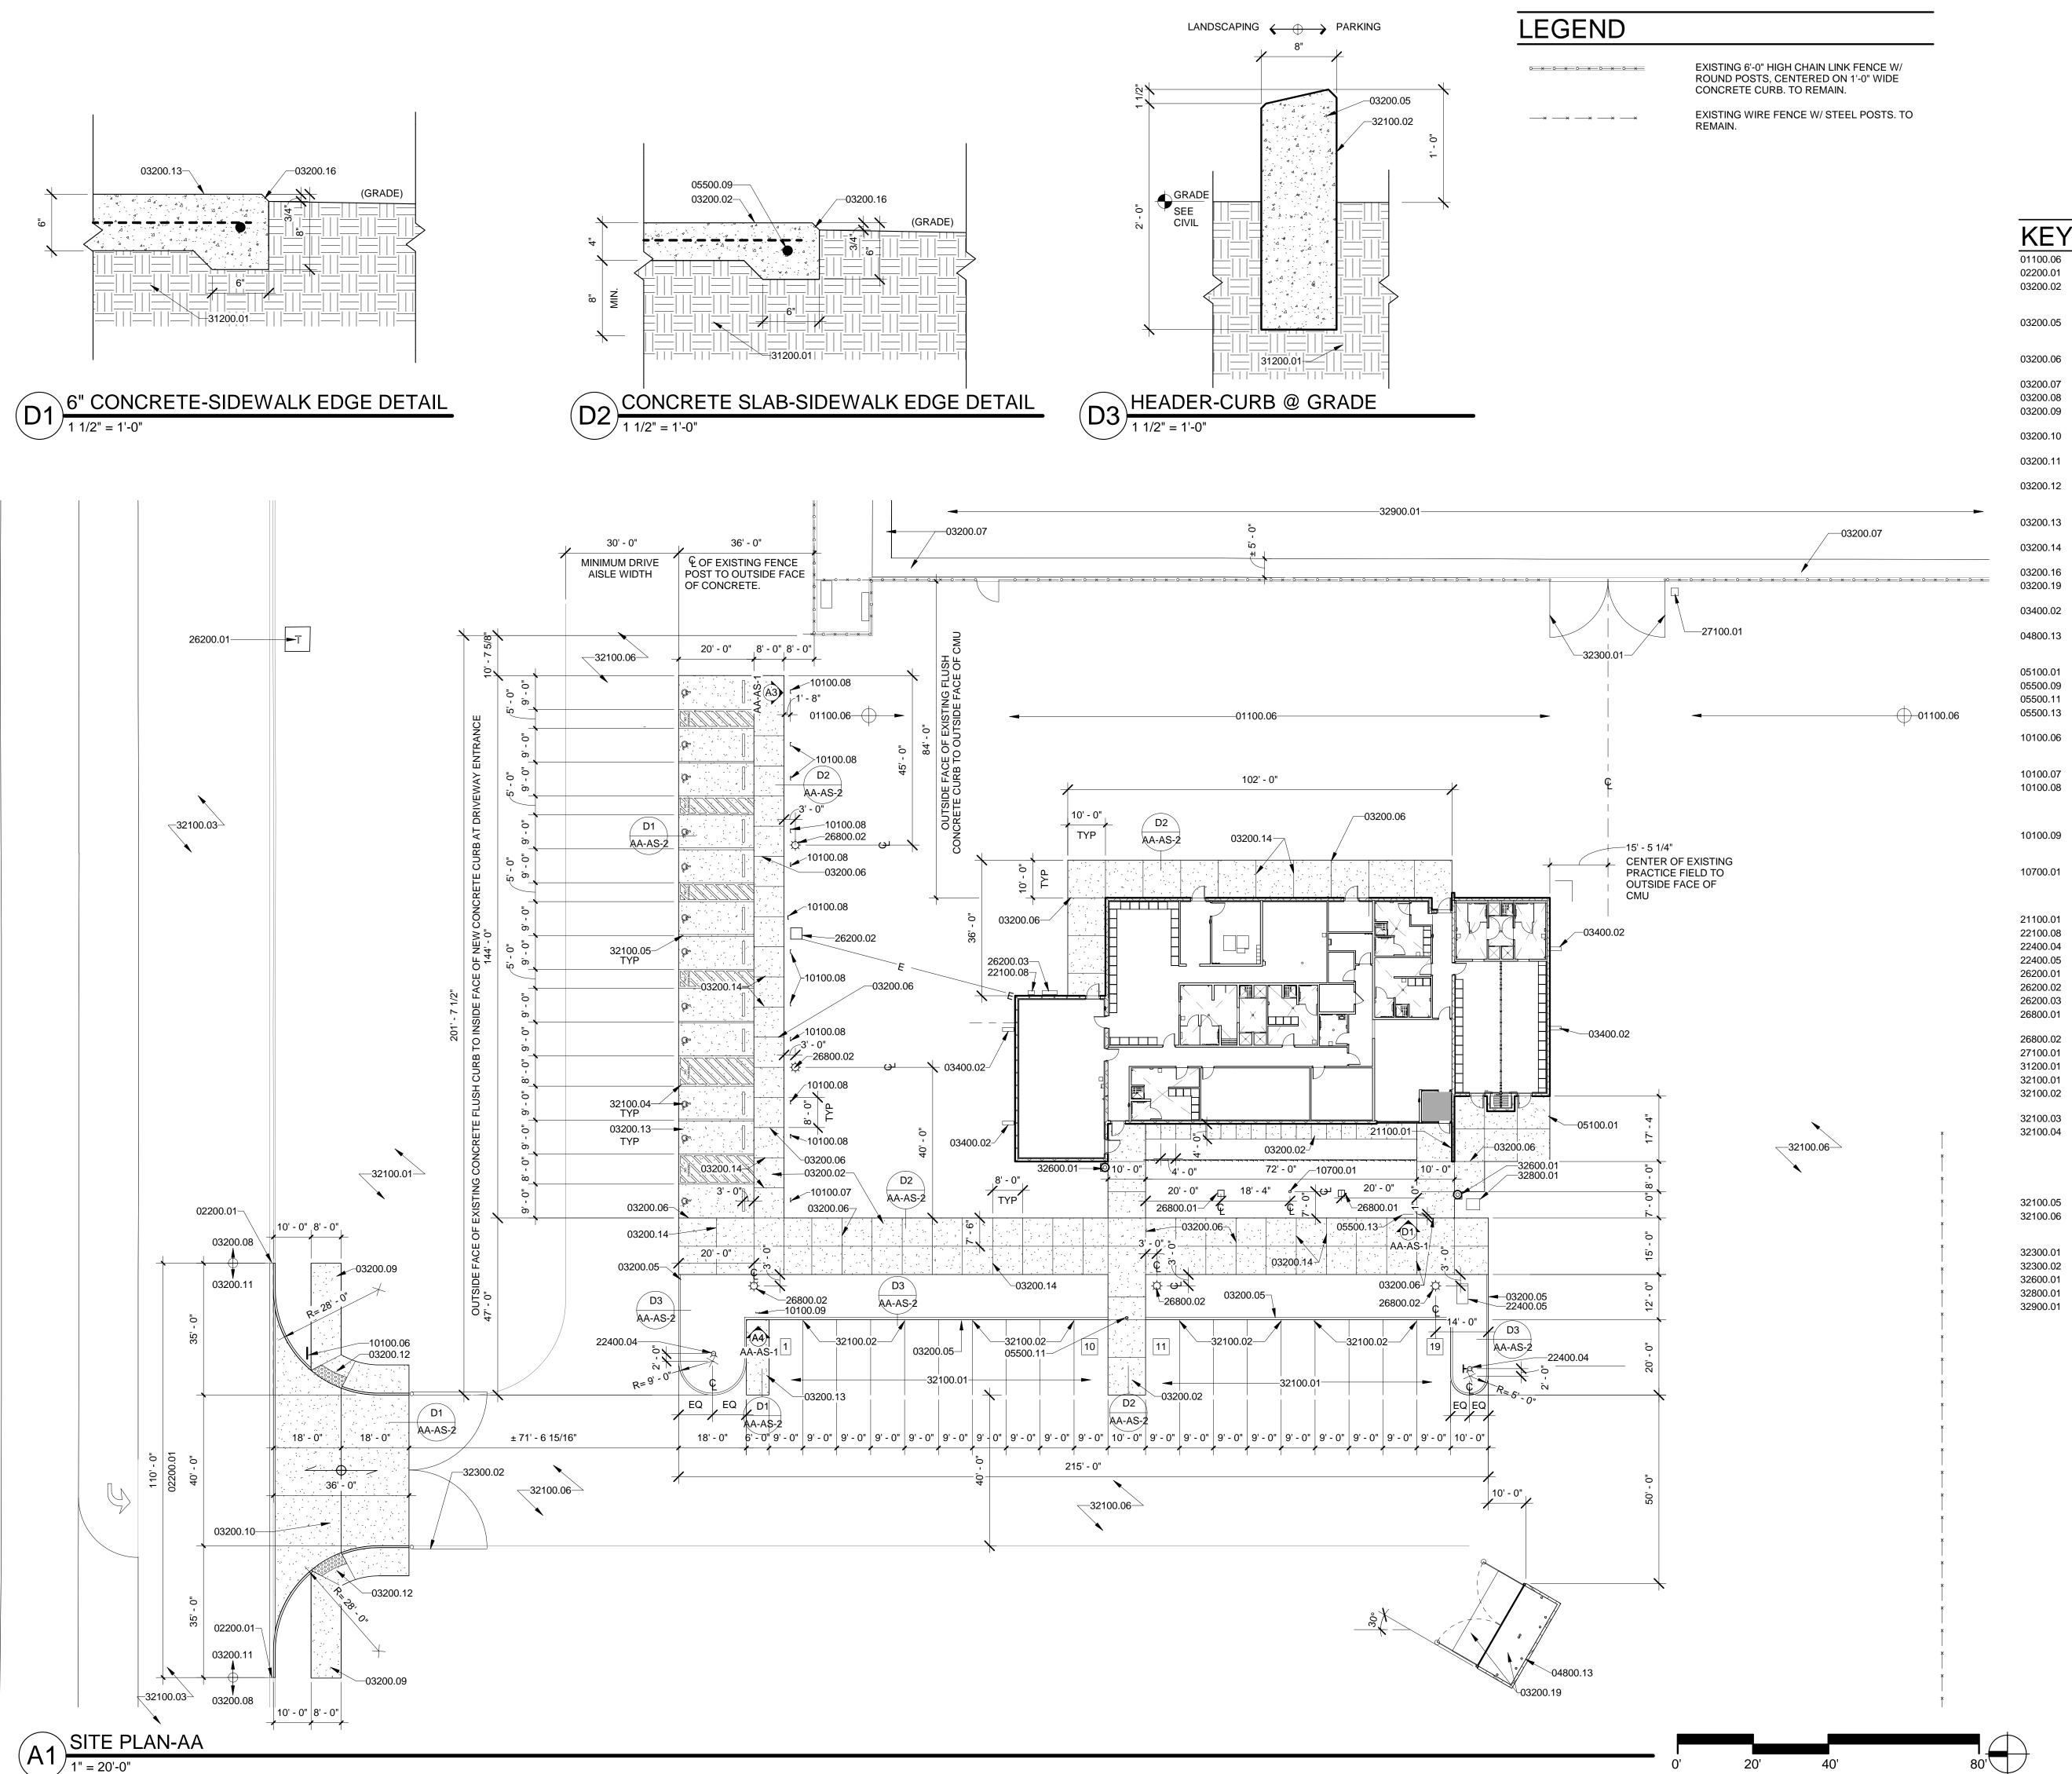

GENERAL NOTES

EXTERIOR LIGHTS AND LIGHT POLES SHALL BE INSTALLED NO TALLER THAN 18' ABOVE GRADE. LIGHT FISTURES SHALL COMPLY WITH THE NIGHT SKY ORDINANCE, AND SHALL COMPLY WITH THE REQUESTS OF KIRTLAND AFB AND/ OR THE DEPARTMENT ON ENERGY.

KEYED NOTES

01100.06 FUTURE BLEACHER LOCATION. NOT PART OF THIS CONTRACT. SAWCUT/ REMOVE EXISTING CURB AND GUTTER FOR NEW CURB CUT. 4" THICK, 4000 PSI, AIR-ENTRAINED CONCRETE SLAB/SIDEWALK REINFORCE WITH 03200.02 4X4-W2.9/W2.9 WELDED WIRE MESH, FLAT SHEETS ONLY. INSTALL ON CHAIRS CENTERED IN

4000 PSI, AIR-ENTRAINED CAST IN PLACE CONCRETE HEADER CURB MODIFIED CITY OF ALBUQUERQUE STANDARD SPECIFICATION. REFER TO CITY STANDARD DETAIL 2415 B. SEE

SITE DETAILS. SEE CIVIL. 03200.06 1/2" THICK EXPANSION MATERIAL, WITH POUR IN PLACE SEALANT. ASPHALT IMPREGNATED OR EQUAL. SEE DETAIL D3 / AS-102.

EXISTING CONCRETE PAD/ SIDEWALK, TO REMAIN.

EXISTING CONCRETE CURB AND GUTTER, TO REMAIN.

CONCRETE SIDEWALK PER CITY OF ALBUQUERQUE STANDARD SPECIFICATIONS. REFER TO

CITY STANDARD DETAIL DWG. 2430. SEE CIVIL. CONCRETE PAVING PER CITY OF ALBUQUERQUE STANDARD SPECIFICATION. REFER TO CITY

STANDARD DETAIL 2426 FOR PRIVATE ENTRANCE. SEE CIVIL. NEW CONCRETE CURB AND GUTTER PER CITY OF ALBUQUERQUE STANDARD SPECIFICATION.

REFER TO CITY STANDARD DETAIL 2415. SEE CIVIL. CONCRETE ACCESSIBLE SIDEWALK RAMP WITH TRUNCATED DOMES. PER CITY OF ALBUQUERQUE STANDARD SPECIFICATION. REFER TO COA STANDARD DWGS. 2440 AND 2441.

6" THICK, 4000 PSI, AIR-ENTRAINED CONCRETE SLAB. REINFORCE W/ NO.4 REBAR @ 16" O.C.

EACH WAY. 1" DEEP X 3/8" WIDE CONCRETE CONTROL JOINT. SPACED 5'-0" APART, OR AS INDICATED ON

PLAN. SEE DETAIL D3/ AS-102. 03200.16 CHAMFER OUTSIDE EDGE 3/4", TYPICAL.

6" THICK, 4000 PSI, AIR-ENTRAINED CONCRETE SLAB W/ 3/4" AGGREGATE. REINFORCE W/ 6X6 10/10 WELDED WIRE MESH.

12" X 36" PRE CAST CONCRETE SPLASH BLOCK. PROVIDE AT INDICATED DOWNLEADER LOCATIONS.

8" X 8" X 16" CMU BLOCK, SPLIT FACE GRAY COLOR BLOCK (SINGLE SIDED EXTERIOR SPLIT FACE), REINFORCED CMU WALL W/ NO.5 REBAR @ 16" O.C. VERTICAL. GROUT ALL CELL SOLID. PROVIDE (2) NO.5 IN KNOCK OUT BOND BEAMS @ 48" O.C. HORIZONTAL

STEEL COLUMN. PRIME AND PAINT AT EXPOSED LOCATIONS. SEE STRUCTURAL

NO. 4 REBAR CONTINUOUS.

8"Ø X 6'-0" TALL STEEL PIPE, CONCRETE FILLED. PRIME AND PAINT 2"Ø STEEL PIPE BIKE RACK. SET IN CONCRETE FOOTING. GRIND EDGES SMOOTH. PRIME AND

STOP SIGN (R1-1) AND NO LEFT TURN SIGN (R3-1) PER MUTCD STANDARDS. ALUMINUM OR

FIBERGLASS PLATE: SIGN FIELD IS RED, BORDER AND LETTERING ARE WHITE. SEE DETAIL C4 / PROVIDE "VAN ACCESSIBLE" SIGN AT DESIGNATED LOCATIONS. SEE ENLARGED SITE PLANS

ADA ACCESSIBLE PARKING SIGN. ALUMINUM OR FIBERGLASS PLATE: SIGN FIELD IS WHITE, SIGN LETTERING AND BORDERS ARE GREEN. SEE DETAIL A3 / AA-AS-1. LOCATE SIGN CENTERED ON PARKING SPACE AND 1'-8" BACK FROM EDGE OF SIDEWALK. CAST IN

CONCRETE SIDEWALK. 10100.09 MOTORCYCLE PARKING SIGN. ALUMINUM OR FIBERGLASS PLATE: SIGN FIELD IS WHITE, SIGN LETTERING AND BORDERS ARE GREEN. SEE DETAIL A4 / AA-AS-1. LOCATE SIGN CENTERED

20' HIGH X 5"Ø BUTT CONE TAPERED ALUMINUM FLAG POLE W/ EXTERNAL HALYARD (23'-0" OVERALL HEIGHT). (MANUFACTURER CONCORD INDUSTRIES, 800.634.4926, OR EQUAL).

CONTINENTAL STYLE. INSTALL PER MANUFACTURER'S SPECIFICATIONS. SEE DETAIL D1 /

21100.01 KNOX BOX INSTALLED RECESSED IN CMU WALL @ 48" A.F.F. GROUT SOLID IN WALL. 22100.08 NEW GAS METER. SEE PLUMBING

NEW FIRE HYDRANT, SEE CIVIL.

BACKFLOW PREVENTER INSTALLED IN HOT BOX. SEE CIVIL. SEE PLUMBING. SEE ELECTRICAL.

EXISTING ELECTRICAL TRANSFORMER, TO REMAIN. SEE ELECTRICAL. NEW TRANSFORMER. SEE ELECTRICAL.

NEW ELECTRICAL PANEL. SEE ELECTRICAL.

RECESSED LIGHT FIXTURE INSTALLED IN CONCRETE CUBE BOLLARD. LIGHT FIXTURE ILLUMINATES METAL TRELLIS/ FINS STRUCTURE. SEE ELECTRICAL. SEE DETAIL A4/ AS-104.

LIGHT POLE. SEE ELECTRICAL.

EXISTING COMMUNICATIONS IN-GROUND QUARTZITE BOX, TO REMAIN.

COMPACTED SUBGRADE AT 95% MIN. SEE GEOTECHNICAL REPORT. EXISTING COMPACTED GRADE TO REMAIN.

6" WIDE, WHITE PAINT STRIPS ON VERTICAL AND HORIZONTAL SURFACE OF MODIFIED

HEADER CURB TO INDICATE PARKING STALL. TYPICAL AT PARKING SPACES ON GRADE. EXISTING ASPHALT PAVING, TO REMAIN. SEE CIVIL.

PROVIDE AND INSTALL PARKING STRIPING, HANDICAP SYMBOL (36" X 36"), AND HANDICAP

STRIPING. PROVIDE 6" WIDE X 2'-0" O.C. DIAGONAL PAINT STRIPING. SEE INDICATED LAYOUT.

PROVIDE THE WORDS "NO PARKING" IN CAPITAL LETTERS, 1'-0" HIGH LETTERS X 2" WIDE STRIPES LOCATED SO AS TO BE CLOSE TO WHERE ADJACENT VEHICLE'S REAR TIRES WOULD BE PARKED. WHITE PARKING LINES AT REGULAR SPACE, AND BLUE COLOR AT HANDICAPPED SPACES AND ACCESS AISLE.

32100.05 PROVIDE 6" WIDE PAINT STRIPING. SEE INDICATED LAYOUT.

EXISTING COMPACTED GRADE TO REMAIN, CAPABLE OF SUPPORTING 75,000 POUND FIRE APPARATUS VEHICLES. AS REQUIRED PROVIDE ADDITIONAL COMPACTED GRAVEL TO MAINTAIN ALL WEATHER TRAVEL SURFACE.

EXISTING GATE, TO REMAIN.

PIPE GATE PER COA STANDARD #2251, SEE CIVIL. PROVIDE KNOX LOCK. 38 GALLON POWDER COATED STEEL, REFUSE CONTAINER W/ DOMED LID.

IN-GROUND IRRIGATION VALVE BOX. SEE CIVIL. SEE PLUMBING. SEE ELECTRICAL.

32900.01 EXISTING ATHLETIC FIELD W/ TURF, TO REMAIN.

lee@lganm.com

NO. DATE REVISIONS **CHECKED BY** 4.21.22 REVISIONS LEE GAMELSKY ARCHITECTS P.C./ GAMELSKY 2412 MILES ROAD SE ALBUQUERQUE, NM 87106 505.842.8865 FAX 842.1693 /

LOCKER ROOM FACILITY AT MDS Albuquerque, New Mexico


PROJECT ARCHITECT: LGA Project #: 20-01-ABQ.7 LEE GAMELSKY, AIA

ADMINISTRATIVE AMMENDMENT • SITE PLAN

LOCKER ROOM FACILITY AT MDS

AA-AS-2

4.21.2022

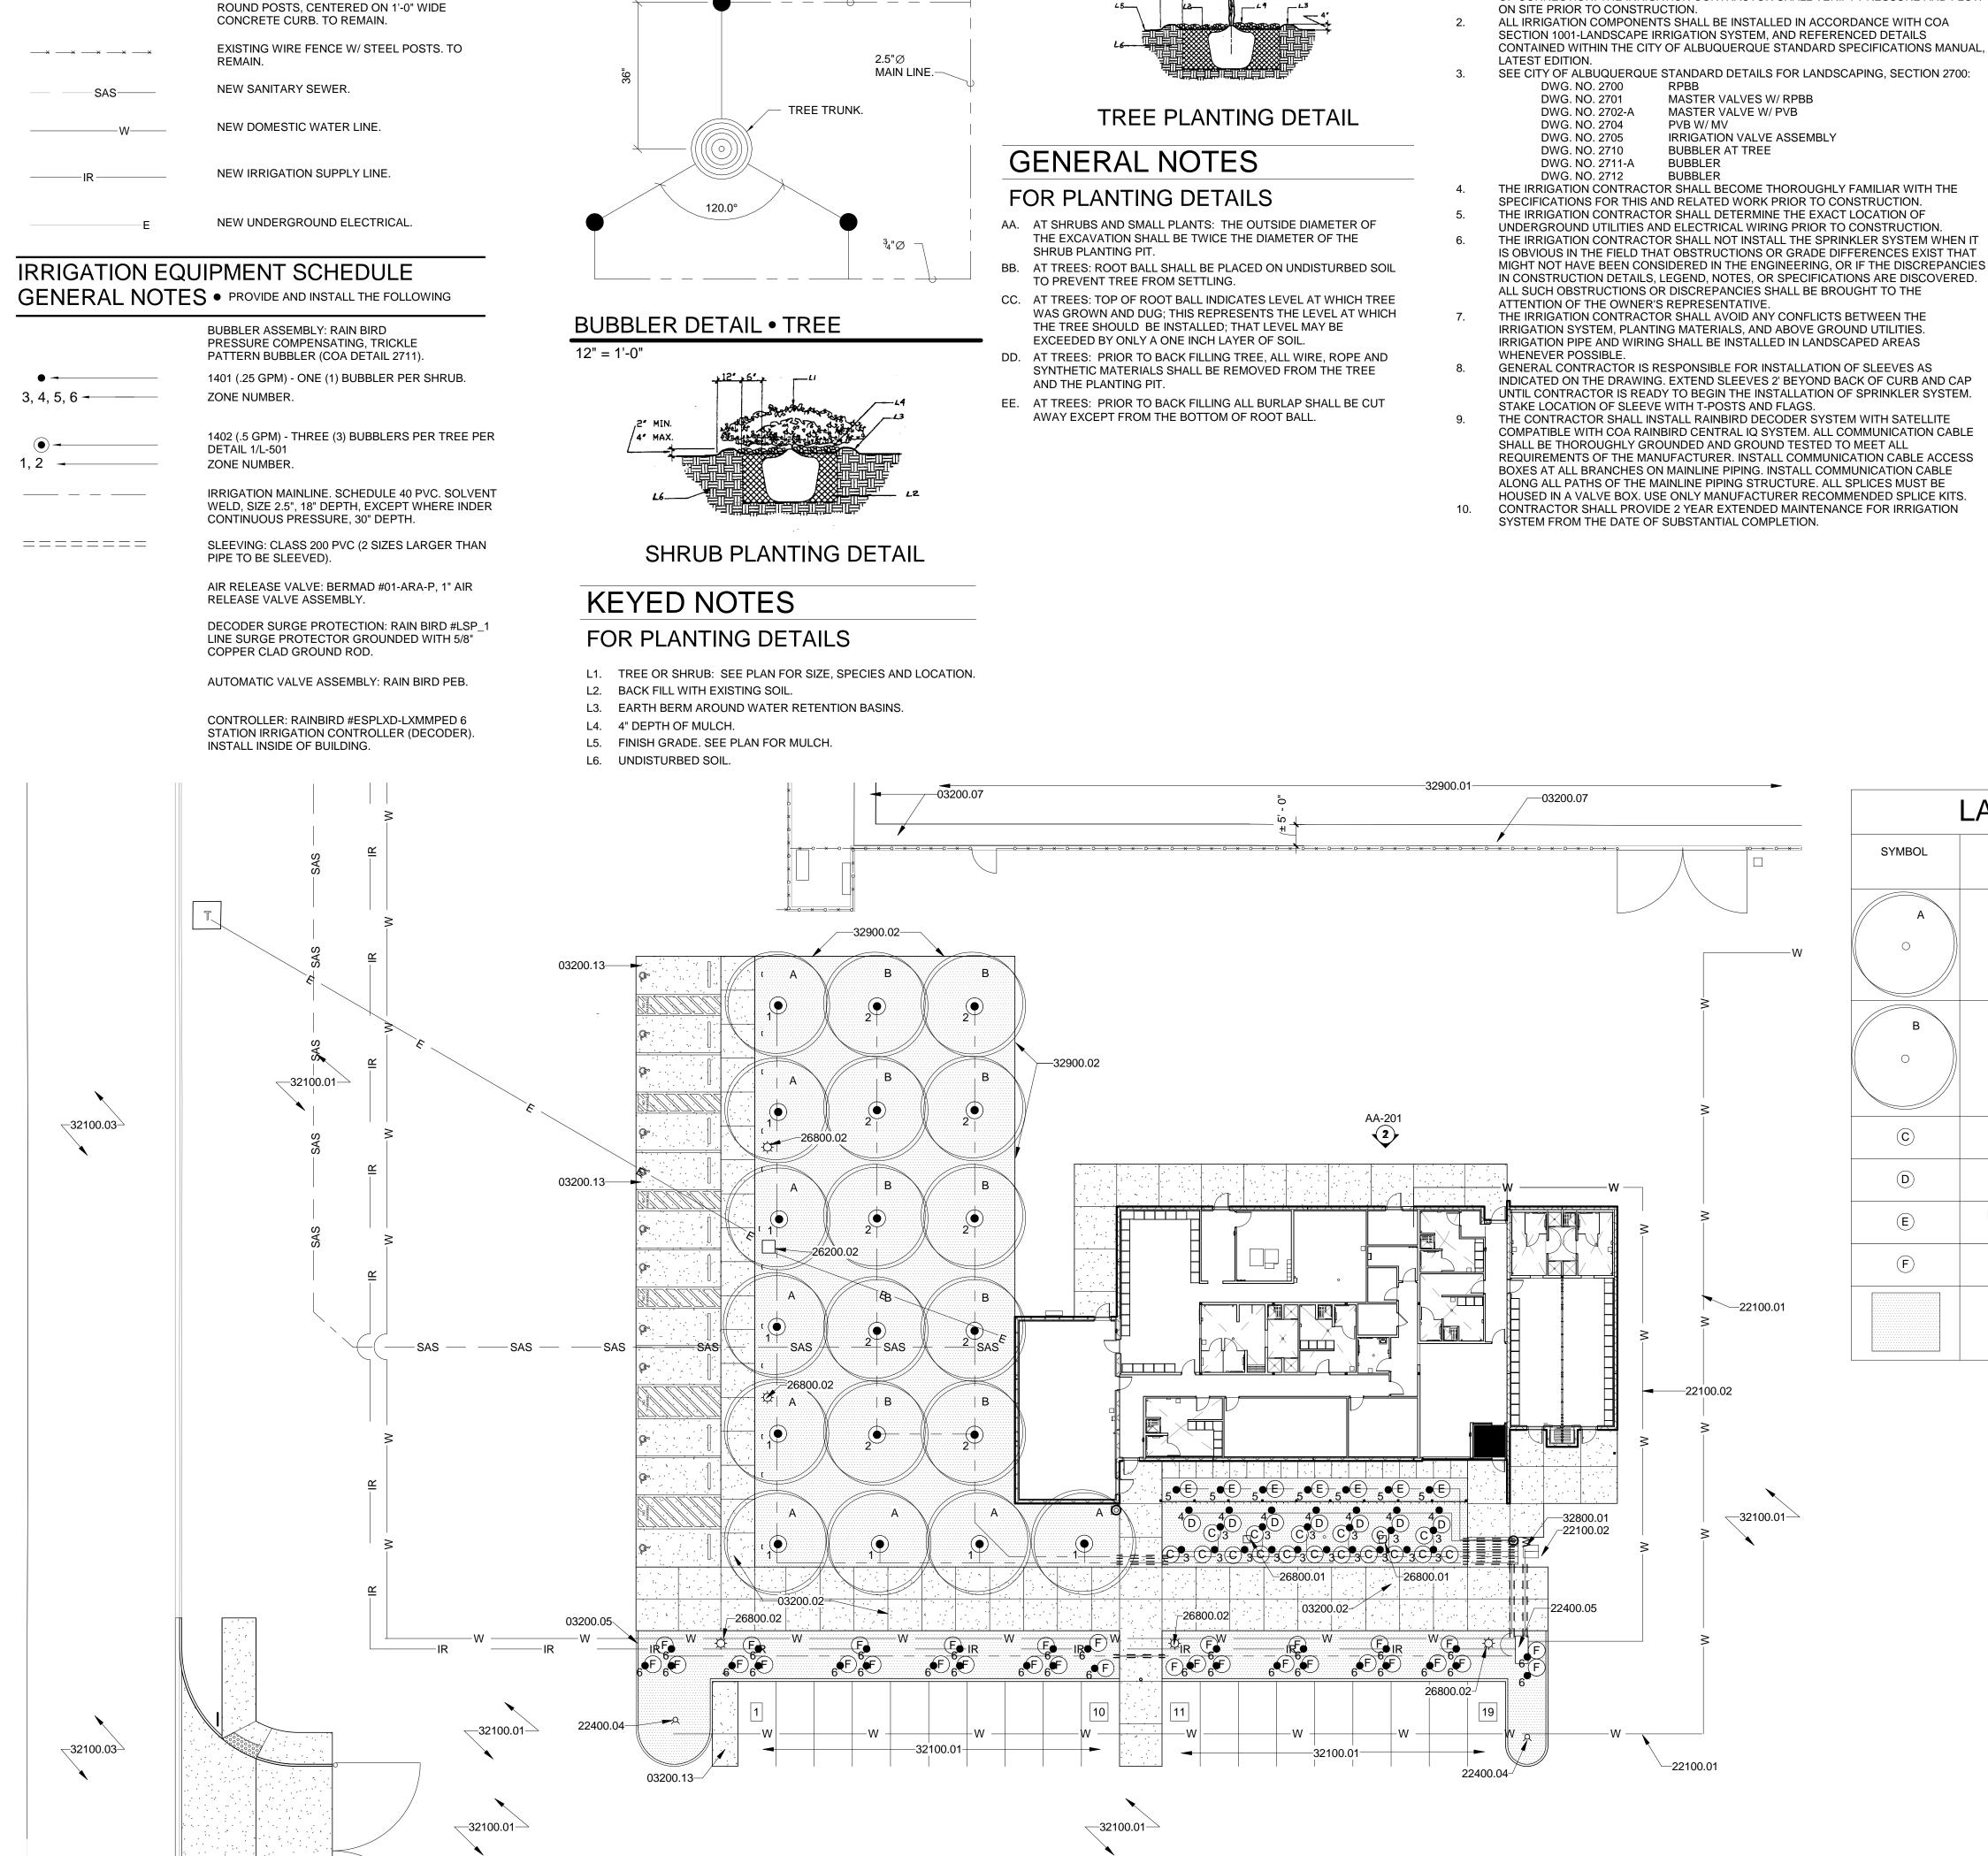

(3) BUBBLERS

EQUALLY SPACED.

³4"Ø

LEGEND

o × o × o × o ×

LANDSCAPE PLAN-AA

1" = 20'-0"

EXISTING 6'-0" HIGH CHAIN LINK FENCE W/

GENERAL NOTES

GENERAL IRRIGATION NOTES

THE SYSTEM DESIGN ASSUMES A MINIMUM STATIC PRESSURE OF 75 PSI AT THE POINT

OF-CONNECTION. THE IRRIGATION CONTRACTOR SHALL VERIFY PRESSURE AND FLOW

- PRIOR TO BEGINNING WORK ON THE PROJECT, THE LANDSCAPE CONTRACTOR SHALL REVIEW THE PROJECT IN THE FIELD WITH THE OWNER'S REPRESENTATIVE. IF DISCREPANCIES OCCUR BETWEEN THE DRAWINGS AND THE SITE, THE LANDSCAPE CONTRACTOR SHALL NOTIFY THE OWNER'S REPRESENTATIVE FOR CLARIFICATION PRIOR TO PROCEEDING ON THAT PORTION OF
- ALL PLANTING AREAS ARE TO HAVE WEEDS AND COMPETITIVE
- VEGETATION REMOVED PRIOR TO PREPARATION FOR PLANTING. THE OWNER'S REPRESENTATIVE SHALL APPROVE ALL PLANT MATERIAL PRIOR TO PLANTING. IN ADDITION, THE OWNER REPRESENTATIVE RESERVES THE RIGHT TO REFUSE ANY PLANT MATERIAL DEEMED UNACCEPTABLE. THE OWNER'S
- REPRESENTATIVE IS TO APPROVE ANY AND ALL SUBSTITUTIONS. IT IS THE LANDSCAPE CONTRACTOR'S RESPONSIBILITY TO LOCATE ALL UNDERGROUND UTILITIES PRIOR TO COMMENCEMENT OF PLANTING OPERATIONS.

PLANTING INSTALLATION SHALL BE IN ACCORDANCE WITH ALL

- CITY OF ALBUQUERQUE STANDARD SPECIFICATIONS (SECTION 1005 - PLANTING) AND DETAILS. CONTRACTOR SHALL PROVIDE 2 YEARS OF EXTENDED
- MAINTENANCE OF ALL ANDSCAPE AREAS FROM THE DATE OF SUBSTANTIAL COMPLETION.
- SEE SHEET G-002 FOR CODE DATA/ LANDSCAPING
- REQUIREMENTS.
- SEE CITY OF ALBUQUERQUE STANDARD DETAILS FOR LANDSCAPING SECTION 2700:

DWG. NO. 2714 TREE PLANTING SHRUB PLANTING DWG. NO. 2716

KEYED NOTES

4" THICK, 4000 PSI, AIR-ENTRAINED CONCRETE SLAB/SIDEWALK REINFORCE WITH 4X4-W2.9/W2.9 WELDED WIRE MESH, FLAT SHEETS ONLY. INSTALL ON CHAIRS CENTERED IN SLAB.

4000 PSI. AIR-ENTRAINED CAST IN PLACE CONCRETE HEADER CURB 03200.05

MODIFIED CITY OF ALBUQUERQUE STANDARD SPECIFICATION. REFER TO CITY STANDARD DETAIL 2415 B.

03200.07 EXISTING CONCRETE PAD/ SIDEWALK, TO REMAIN. 6" THICK, 4000 PSI, AIR-ENTRAINED CONCRETE SLAB. REINFORCE W/ NO.4 REBAR @ 16" O.C. EACH WAY.

6"Ø WATER SUPPLY FOR FIRE HYDRANTS. 22100.01

22100.02 WATER SUPPLY.

22400.04 NEW FIRE HYDRANT.

22400.05 BACKFLOW PREVENTER INSTALLED IN HOT BOX.

NEW TRANSFORMER.

RECESSED LIGHT FIXTURE INSTALLED IN CONCRETE CUBE BOLLARD. LIGHT FIXTURE ILLUMINATES METAL TRELLIS/ FINS

STRUCTURE. LIGHT POLE.


26800.02 EXISTING COMPACTED GRADE TO REMAIN.

32100.03 EXISTING ASPHALT PAVING, TO REMAIN. IN-GROUND IRRIGATION VALVE BOX. 32800.01

32900.01 EXISTING ATHLETIC FIELD W/ TURF, TO REMAIN.

4" HIGH METAL EDGING ,MINIMUM. STAKE AS REQUIRED.

LANDSCAPE SCHEDULE **REMARKS** SYMBOL **BOTANICAL NAME COMMON NAME** QTY SIZE EMERALD SUNSHINE ELM (M) ULMUS PROPINQUA 2.5"Ø 'JFS-BIEBERICH' GLEITSIA SKYLINE HONEYLOCUST (M+) **TIACANTHOS** 2.5"Ø 'SKYLINE' 1 GAL. WALKER'S LOW CATMINT (L+) **NEPETA HYBRID** 'WALKER'S LOW' 3 GAL. FURMAN'S RED SALVIA GREGGII CHERRY SAGE (L+) 'FURMAN'S RED' 5 GAL. POTENTILLA FUTICOSA JACKMAN'S SHRUBBY CINQUEFOIL (M+) 'JACKMANII' 5 GAL. CALAMOGROSTIS A KARL FOERSTER FEATHER REED GRASS (M) 'KARL FOERSTER BLACK CRUSHER FINES 4" THICK. ROLLED. INSTALL SUPPLIER: OVER GEOTEXTILE FABRIC, JPR GRAVEL NM OVER COMPACTED GRADE (BASIS OF DESIGN) TO 95%. (505.503.7766)

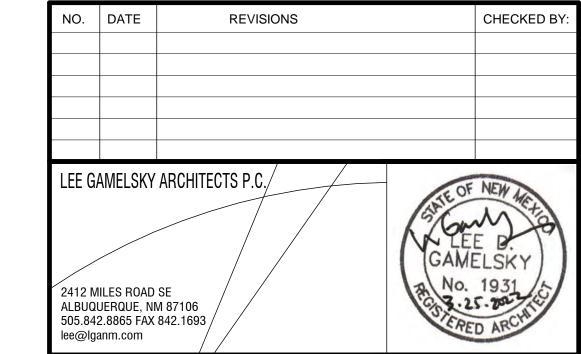

LOCKER ROOM FACILITY AT MDS


PROJECT ARCHITECT: LEE GAMELSKY, AIA


Albuquerque, New Mexico

LGA Project #: 20-01-ABQ.7 3.25.2022


ADMINISTRATIVE AMMENDMENT • LANDSCAPE PLAN LOCKER ROOM FACILITY AT MDS

AA-L

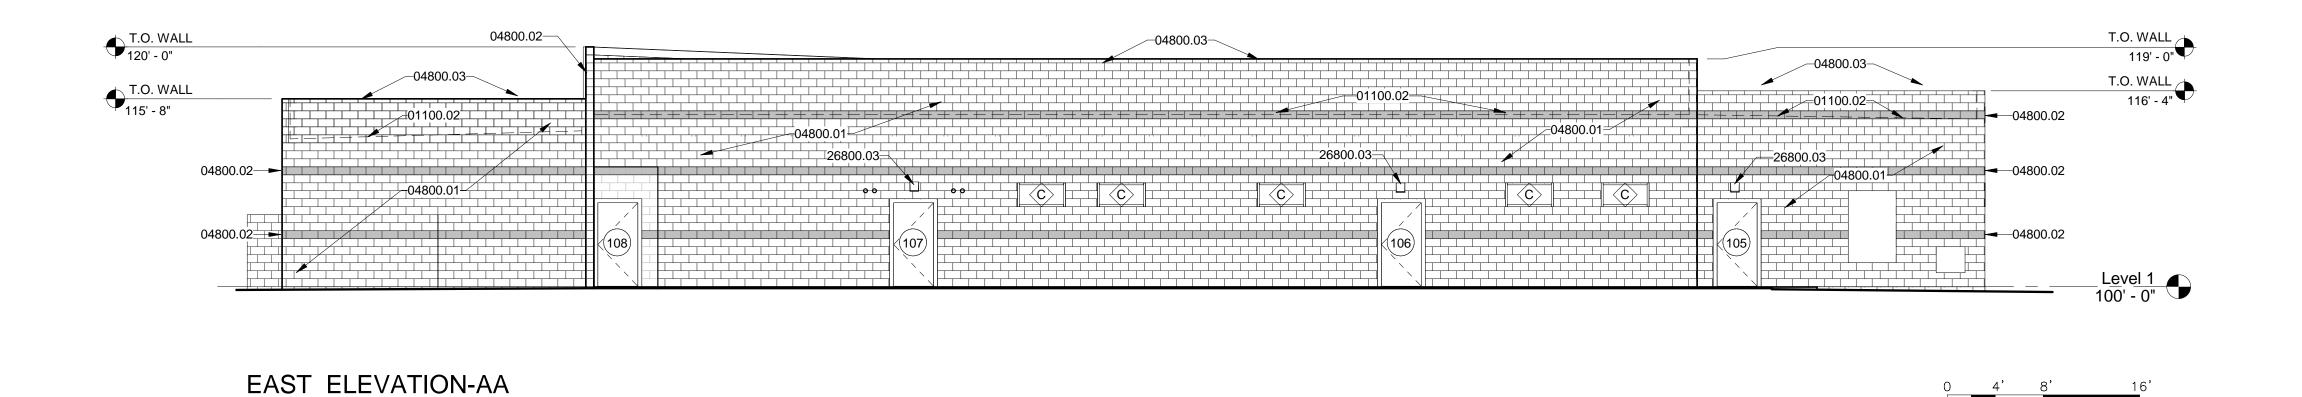


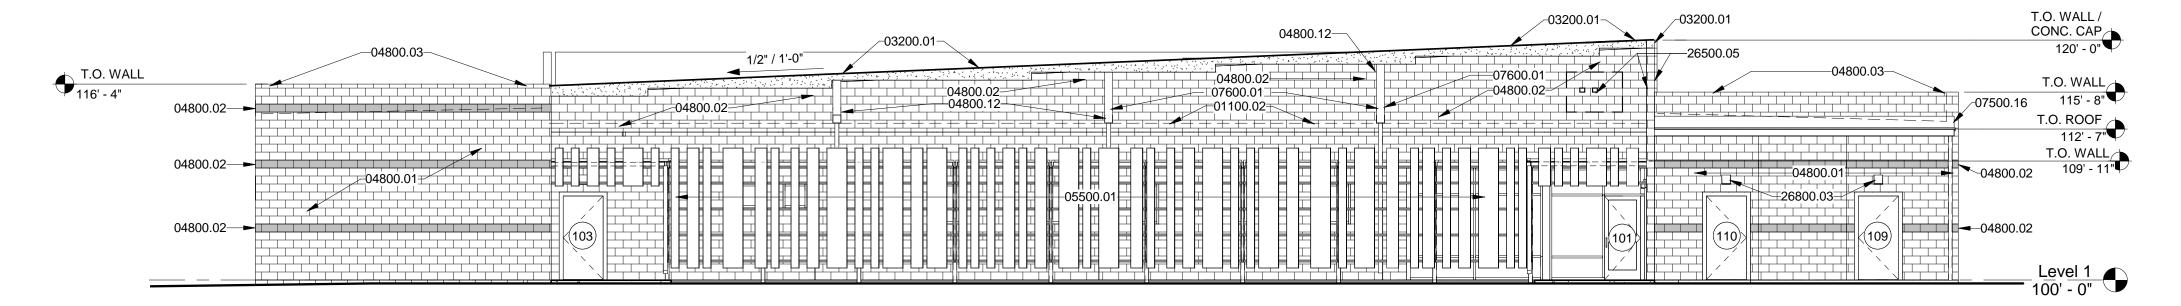

WEST ELEVATION-AA 1/8" = 1'-0"

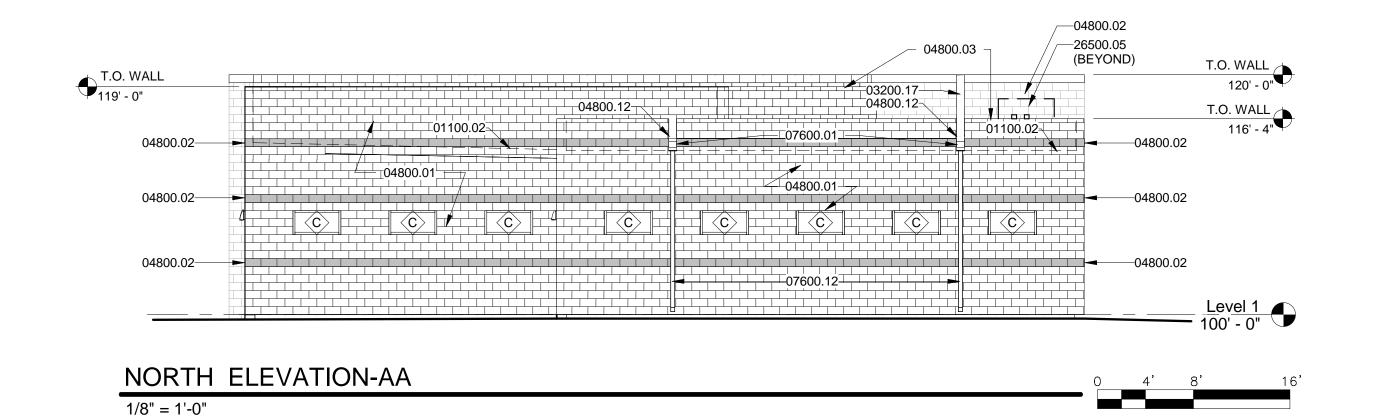

1/8" = 1'-0"

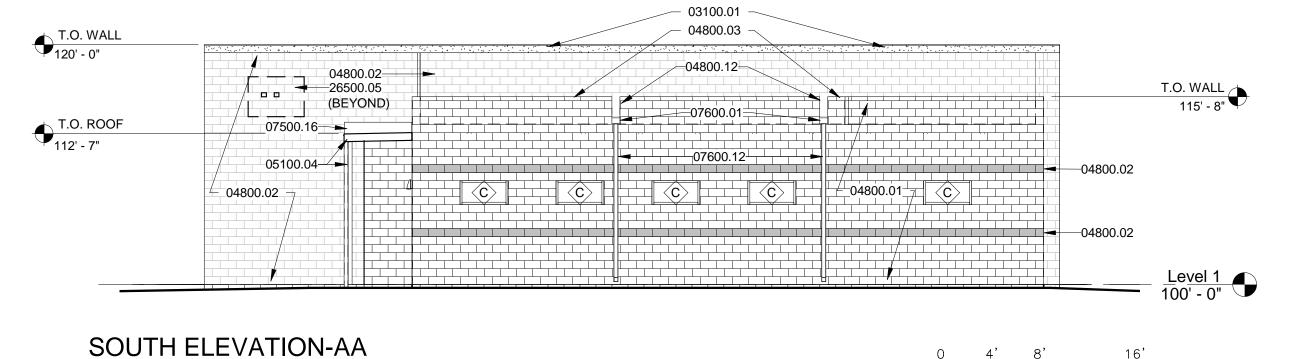

1/8" = 1'-0"

8" X 8" X 16" CMU BLOCK. BURNISHED FACE ON THE EXTERIOR AND EXPOSED INTERIOR SURFACES. INTEGRAL COLOR BLACK BLOCK. PROVIDE INTEGRAL COLOR BLACK MORTAR. 4" X 8" X 16" CMU CAP BLOCK. STANDARD GREY COLOR BLOCK THE CMU WALL, CAP BLOCK AND CAST IN PLACE CONCRETE CAP, STOPS AT THE THROUGH WALL SCUPPER, SUCH THAT SCUPPER IS OPEN TO THE SKY ABOVE. PROVIDE 8" WIDE STEEL PORTAL STRUCTURE. COLUMNS / BEAMS / ANGLES, 05100.04 STEEL SHEETING, ETC. PRIME AND PAINT BLACK. VERTICAL 16 GA STEEL PANELS, 10'-0" LONG, WELDED TO TUBE STEEL PORTAL STRUCTURE. PRIME AND PAINT YELLOW. VERTICAL TERMINATION BAR W/ SEALANT ON CMU WALL WHERE 07500.16 ROOF EDGE IS LOCATED. THROUGH WALL SCUPPER/ OVERFLOW SCUPPER, COLLECTOR 07600.01 BOX SMACNA STYLE FIG. 1-25F, DOWNLEADER, FLASHING, TRIM, ETC. 24 GA. PREFINISHED KYNAR BLACK COLOR. DOWNSPOUT AT ROOF SCUPPERS. 4"X4" X 24 GA. GALVANIZED METAL. PREFINISHED KYNAR PVDF FINISH. MATT BLACK. PROVIDE DOWNSPOUT HANGERS @ 6'-0" O.C. MAX. INSTALL PER SMACNA FIG. 1-35A. FABRICATE FROM 1/16" X 1" FLAT STOCK. MATCH DOWNSPOUT FINISH. SIGN (3) LOCATIONS. PROVIDED AND INSTALLED BY TENANT. ROUGH-IN ELECTRICAL AND CONTROL J-BOXES AND CONDUIT @ 26800.03 WALL MOUNTED LIGHT FIXTURE.

DASHED LINE INDICATES TOP OF ROOF MEMBRANE BEYOND.

CAST-IN-PLACE CONCRETE CAP. INTEGRAL COLOR BLACK.

CAST-IN-PLACE CONCRETE CAP. INTEGRAL COLOR BLACK.

8" X 8" X 16" CMU BLOCK. SPLIT FACE GRAY COLOR BLOCK.


KEYED NOTES

SLOPED AT THIS LOCATION.

03200.01

03200.17

04800.01

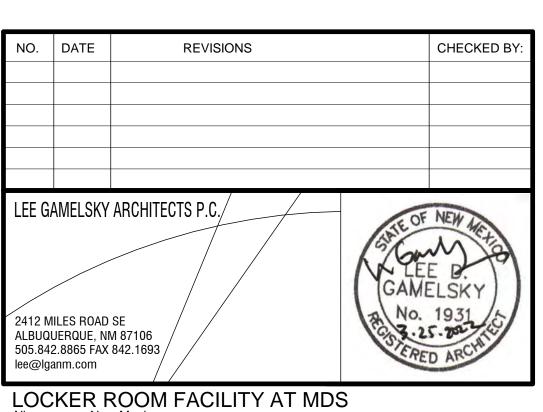

LOCKER ROOM FACILITY AT MDS
Albuquerque, New Mexico

PROJECT ARCHITECT: LGA Project #: 20-01-ABQ.7 LEE GAMELSKY, AIA

ADMINISTRATIVE AMENDMENT • **EXTERIOR ELEVATIONS** LOCKER ROOM FACILITY AT MDS

Sheet: AA-201

3.25.2022