
FORM P3: ADMINISTRATIVE DECISIONS AND MINOR AMENDMENTS

A single PDF file of the complete application including all plans and documents being submitted must be emailed to PLNDRS@cabq.gov
prior to making a submittal. Zipped files or those over 9 MB cannot be delivered via email, in which case the PDF must be provided on a CD.

| pn | or to making a submittal. Zipped files or those over 9 MB cannot be delivered via email, in while | ch case the PDF must be provided on a CD. |
|------|--|--|
| | ARCHEOLOGICAL CERTIFICATE Archaeological Compliance Documentation Form with property information section of Only the information above is required unless the City Archaeologist determines that Certificate of No Effect, in which case a treatment plan prepared by a qualified archaeological impacts of the proposed development must be submitted and reviewe criteria in IDO Section 14-16-6-5(A)(3)(b) Letter of authorization from the property owner if application is submitted by an ager Zone Atlas map with the entire site clearly outlined and labeled | t the application does not qualify for a aeologist that adequately mitigates any d for a Certificate of Approval per the |
| TÁ N | MINOR AMENDMENT TO SITE PLAN – ADMIN, EPC, or DRB | folded |
| | Minor Amendments must be within the thresholds established in IDO TABLE 6-thresholds is considered a Major Amendment and must be processed through the request. | |
| | MINOR AMENDMENT TO SITE DEVELOPMENT PLAN APPROVED PRIOR TO THE E Justification letter describing, explaining, and justifying the request per the criteria in Three (3) copies of all applicable sheets of the approved Site Development Plan bein Copy of the Official Notice of Decision associated with the prior approval Three (3) copies of the proposed Site Development Plan, with changes circled and in Refer to the Site Plan Checklist for information needed on the proposed Site Plan. Letter of authorization from the property owner if application is submitted by an agen Zone Atlas map with the entire site clearly outlined and labeled | IDO Section 14-16-6-4(Z)(1)(a) ng amended, folded oted |
| 0 | Minor Amendments must be within the thresholds established in IDO TABLE 6-4 thresholds is considered a Major Amendment and must be processed through to the request. ACCELERATED EXPIRATION SITE PLAN Justification letter describing, explaining, and justifying the request per the criteria in I Site Plan to be Expired Letter of authorization from the property owner if application is submitted by an agent Zone Atlas map with the entire site clearly outlined and labeled ALTERNATIVE SIGNAGE PLAN Proposed Alternative Signage Plan compliant with IDO Section 14-16-5-12(F)(5) Justification letter describing, explaining, and justifying the request per the criteria in Required notices with content per IDO Section 14-16-6-4(K) Office of Neighborhood Coordination notice inquiry response and proof of emailed Association representatives | he original decision-making body for DO Section 14-16-6-4(X)(2)(c) t IDO Section 14-16-6-5(F)(4)(c) |
| 0 | Sign Posting Agreement _ Letter of authorization from the property owner if application is submitted by an agent _ Zone Atlas map with the entire site clearly outlined and labeled ALTERNATIVE LANDSCAPE PLAN _ Justification letter describing, explaining, and justifying the request per the criteria in II _ Landscape Plan _ Letter of authorization from the property owner if application is submitted by an agent _ Zone Atlas map with the entire site clearly outlined and labeled | DO Section 14-16-5-6(C)(16) |
| I, | the applicant or agent, acknowledge that if any required information is not submitted with this cheduled for a public meeting or hearing, if required, or otherwise processed until it is complet | application, the application will not be e. |
| Sig | nature: Manager Manage | Date: 2 5 202 |
| Prir | nted Name: Wayash Sundaram | Applicant or □ Agent |
| FOF | R OFFICIAL USE ONLY | |
| | Project Number: Case Numbers | |
| | PR-2019-003077 SI-2021-02122 - - | |
| Staf | ff Signature: | W. W. Carlot |

Effective 12/2/20



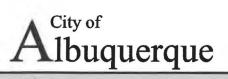

DEVELOPMENT REVIEW APPLICATION

Effective 4/17/19

| Please check the appropriate box and | d refer to supp | lemental forms for su | ıbmittal requirements. All fe | es must be p | aid at the time o | f application. |
|--|-------------------------------|------------------------------------|-------------------------------|-----------------------------------|--|-----------------------|
| Administrative Decisions | Dec | cisions Requiring a P | ublic Meeting or Hearing | Policy Dec | isions | |
| ☐ Archaeological Certificate (Form P3) | | Site Plan – EPC includ orm P1) | ling any Variances – EPC | ☐ Adoption Plan or Fac | or Amendment o ility Plan <i>(Form Z)</i> | f Comprehensive |
| ☐ Historic Certificate of Appropriateness (Form L) | s – Minor 🗆 I | Master Development P | Plan <i>(Form P1)</i> | ☐ Adoption Designation | or Amendment of (Form L) | f Historic |
| ☐ Alternative Signage Plan (Form P3) | | Historic Certificate of A rm L) | ppropriateness – Major | ☐ Amendment of IDO Text (Form Z) | | |
| ☐ Alternative Landscape Plan (Form P3 |) 🗆 [| Demolition Outside of I | HPO (Form L) | ☐ Annexati | on of Land (Form | Z) |
| Minor Amendment to Site Plan (Form | P3) 🗆 H | Historic Design Standa | rds and Guidelines (Form L) | ☐ Amendm | ent to Zoning Mar | o – EPC (Form Z) |
| ☐ WTF Approval (Form W1) | | Vireless Telecommuni rm W2) | cations Facility Waiver | □ Amendm | ent to Zoning Mar | o – Council (Form Z) |
| | | | | Appeals | | |
| | | | | ☐ Decision A) | by EPC, LC, ZHE | , or City Staff (Form |
| APPLICATION INFORMATION | | | | | | |
| Applicant: Payash Sumayam | 1 Sundara | m Punders in | ν. | Phone: | 505-831-4 | 1260 |
| Address: 4239 Balluon Po | IXX Rd. N | E. SIIK A | | Email: 1 | Prakasha | tmsnm.com |
| City: AIDIDIUMIU | | 1000 | State: NM | Zip: | 87109 | |
| Professional/Agent (if any): | | | | Phone: | | |
| Address: | | | | Email: | | |
| City: | | | State: | Zip: | | |
| Proprietary Interest in Site: | | | List all owners: | | | |
| BRIEF DESCRIPTION OF REQUEST | | | | | | |
| Minor chames to el | avations | 5 | | | | |
| | | | | | | |
| SITE INFORMATION (Accuracy of the | existing legal o | lescription is crucial! | Attach a separate sheet if | necessary.) | | |
| Lot or Tract No.: (A1014 | | | Block: (| Unit: | | |
| Subdivision/Addition: Louislana | | | MRGCD Map No.: | UPC Cod | de: 1019069 CL | 1416730905 |
| Zone Atlas Page(s): H-19-2 | Existing Zoning: (\(\) | | -14 | | Zoning: N/A | |
| # of Existing Lots: | # of Proposed Lots: \ | | | Total Area of Site (acres): 1,5 9 | | |
| LOCATION OF PROPERTY BY STREET | | | | | | |
| Site Address/Street: 2430 Julyana | BIVE NE | Between: Zouislay | 30 | and: Cut 10 | Y. | |
| CASE HISTORY (List any current or pri | THE RESIDENCE OF SHARE SHARES | | | | | |
| 11.12 | DOR MS | e File H: DD.7 | 019-003077. Build | ma Demit | BP-7021- | 31134 |
| Signature: |) | | 1 | Date: | 115/2021 | |
| Printed Name: | ach So | udaran | | M Applica | ant or □ Agent | |
| FOR OFFICIAL USE ONLY | | 0113011-001 | 1 3 1 1 1 1 | | | |
| Case Numbers | Action | Fees | Case Numbers | | Action | Fees |
| SI-2021-02122 A | A | | | | | |
| | | | | | | |
| | | | | | | |
| Meeting/Hearing Date: | | | | Fee Total | : | |
| Staff Signature: | | | Date: | Project # | PR-2019-0 | 003077 |
| | | | | | | |

From: Rodenbeck, Jay B.

To: Gould, Maggie S.; Webb, Robert L.; Cordero, Shannon D.


Subject: Marriot Administrative Amendment

Date: Wednesday, December 15, 2021 4:04:57 PM

A new Administrative Amendment for a Marriot is featured in the link below:

 $\underline{X:\PL\SHARES\PL-Share\Jay_Rodenbeck\Marriot_AA_Submittal\12.15.2021\ Minor\ Amdendment\ to\ Site\ Plan\ Docs.pdf}$

Jay

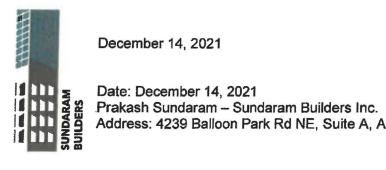

December 14, 2021

Address: 4239 Balloon Park Rd NE, Suite A, Albuquerque, NM 87109

Re: Minor Amendment to Site Plan - Justification Letter-PR-2019-003077

To whom it may concern,

This letter is intended to provide you with a justification for the changes which have occurred on the Elem hotel project Permit# BP-2021-31134. We request your approval for the minor modifications to the approv DRB plan outlined in detail below.

- The outdoor pool bathrooms, mechanical room and storage were relocated to meet requirements the Marriott franchise.
- The drop off canopy was added with additional supports for the cantilever and the vestibule was sli extended out to accommodate requirements from the Marriott franchise.
- The base material was upgraded, wooden fiber cement panels to replace EIFS and the color of the volume in the background on the right-hand side was changed from a light color to a dark. These done to meet requirements from the Marriott franchise.
- The exterior glazing was added to meet requirements from the Marriott franchise.
- On the 7th floor rooftop bar, there was a reduction in outdoor space to provide back of house support two public restrooms, per the City's requirements. The square footage change was approximately the total square footage.
- Floors 1-6 remain the same as the prior approved DRB set.

We believe all of these changes are in accordance with the IDO and are minor changes to the previous approved site development plan.


Prakash Sundaram

Regards

4239BalloonParkRd.NE Albuquerque, NM 87109

Phone (505) 831-

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West Elevation

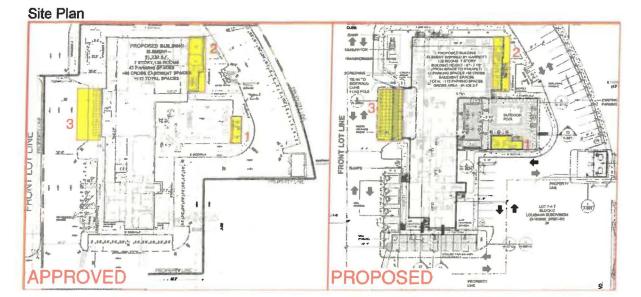

PROPOSED

South Elevation

APPROVED



East Elevation



APPROVED




PROPOSED



APPROVED

Rooftop



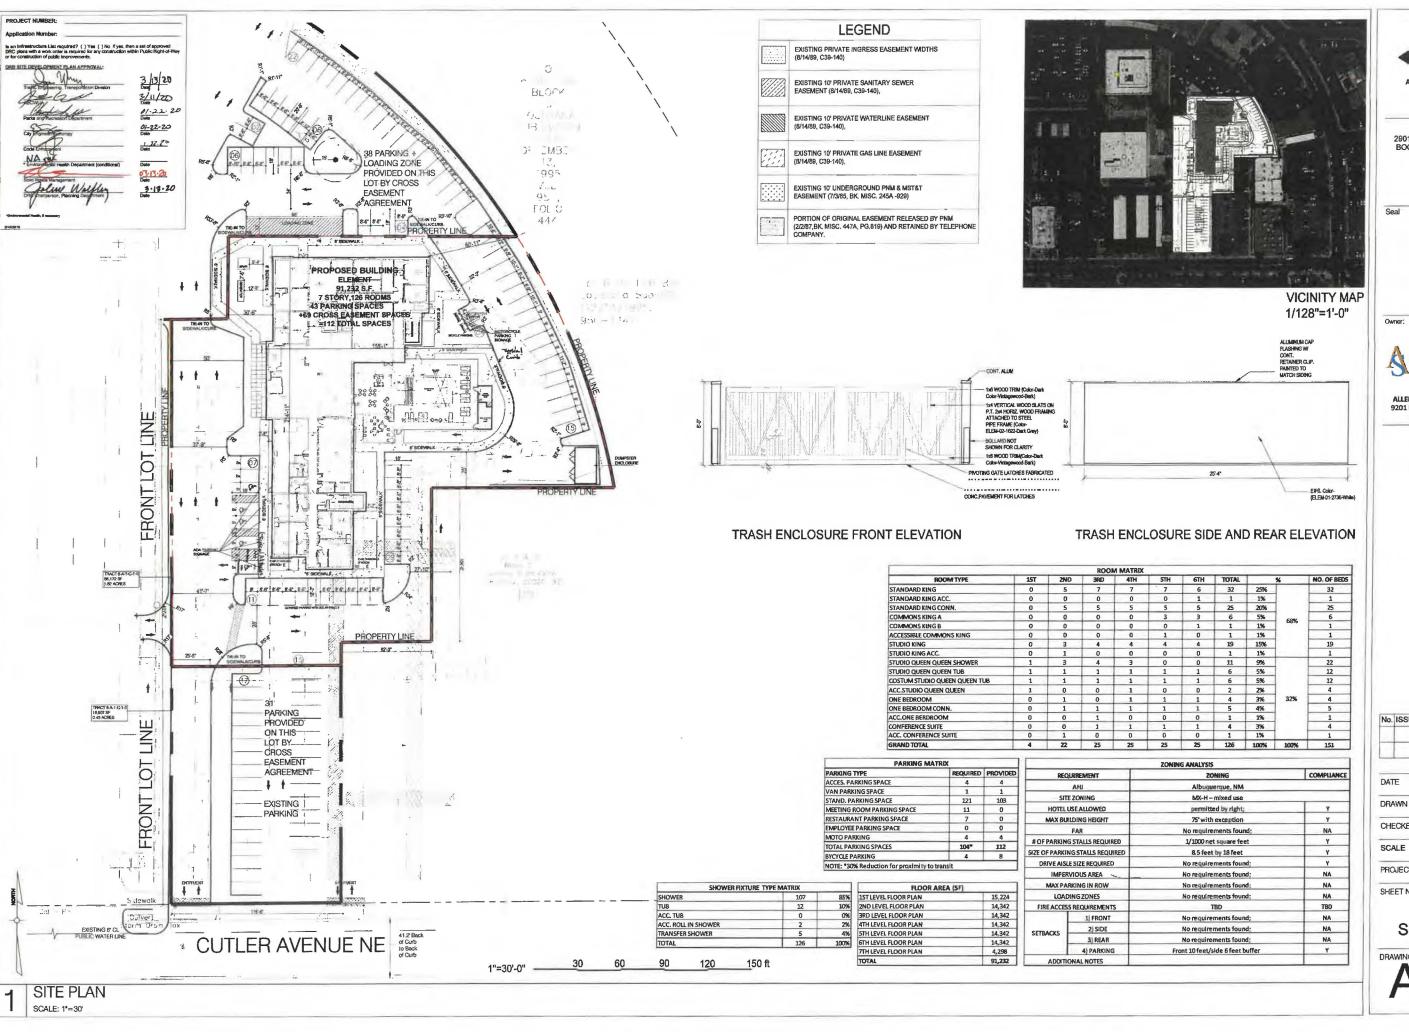



ALLEN SIGMON REAL ESTATE GROUP 9201 MONTGOMERY BLVD, NE BLDG 1 ALBUQUERQUE, NM 87111



ELEMENT ALBUQUERQUE,NM


No. ISSUE DATE PROJECT STATUS

2020.01.17 SG DRAWN BY CHECKED BY DH AS NOTED PROJECT NO. B4 - 176 - 1901

SHEET NAME

SITE PLAN

DRAWING NO.

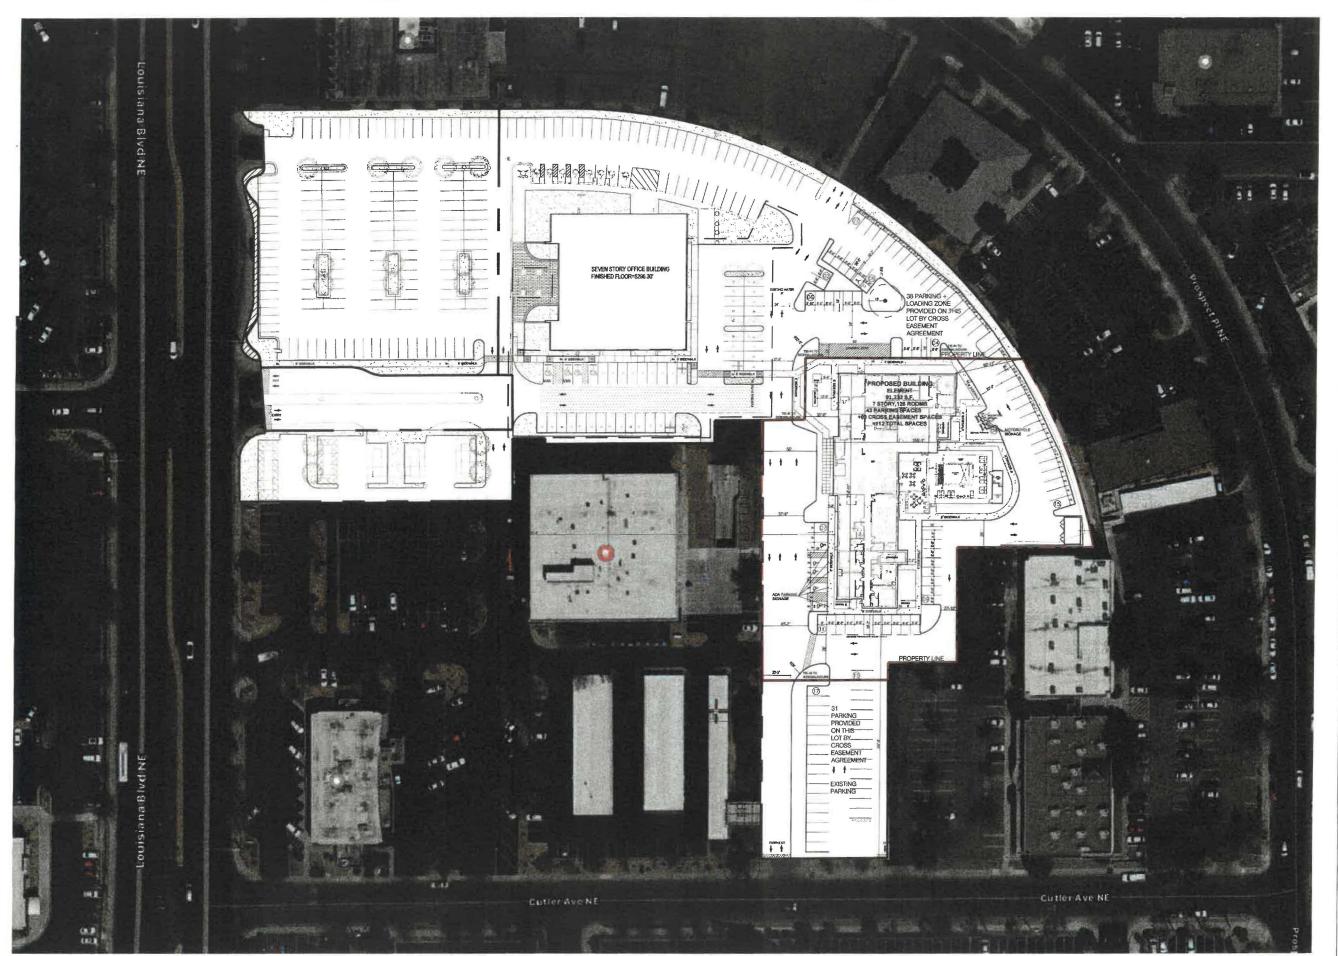





ALLEN SIGMON REAL ESTATE GROUP 9201 MONTGOMERY BLVD, NE BLDG 1 ALBUQUERQUE, NM 87111



ELEMENT ALBUQUERQUE,NM


| No. | ISSUE DATE | PROJECT STATUS |
|-----|------------|----------------|
| | | |

| DATE | 2020.01.17 |
|-------------|-----------------|
| DRAWN BY | SG |
| CHECKED BY | DH |
| SCALE | AS NOTED |
| PROJECT NO. | B4 - 176 - 1901 |

MASTER PLAN

SHEET NAME

A1.1

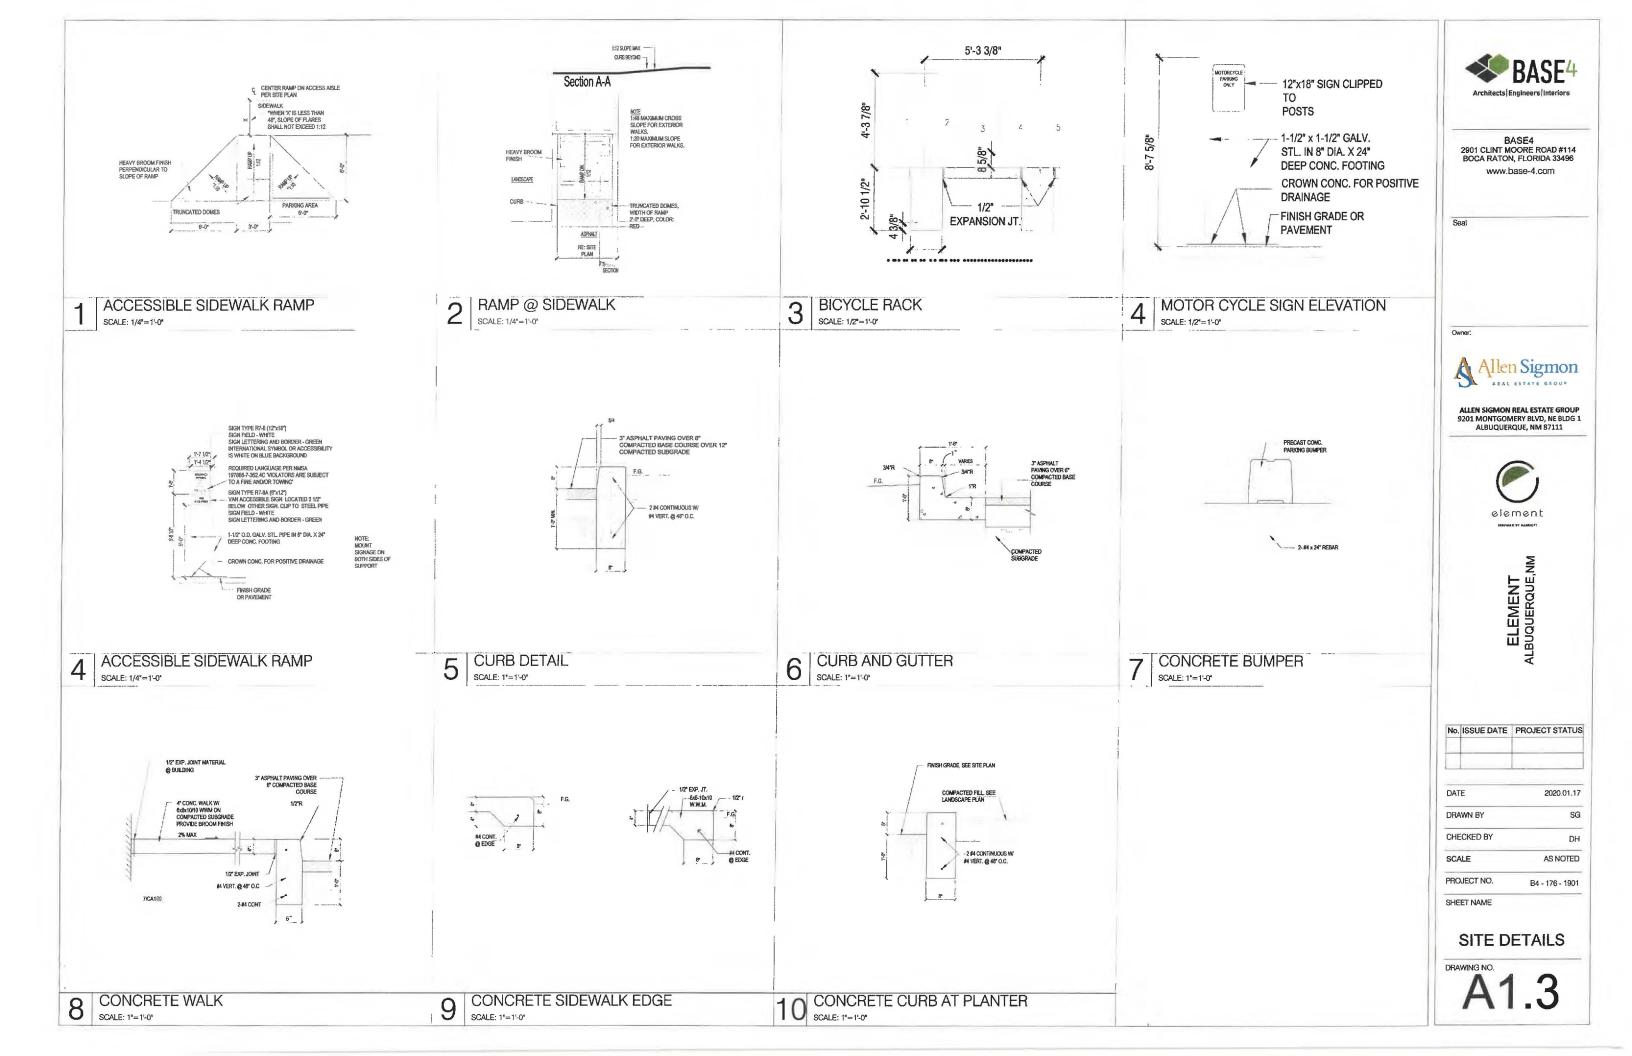

GENERAL NOTES

- COORDINATION: ALL ELECTRICAL WORK SHALL BE COORDINATE THROUGH THE DESIGN/BUILD CONTRACTOR. CODE COMPLIANCE, ALL ELECTRICAL WORK SHALL COMPLY WITH OR SURPASS THE CODE COMPLIANCE AND RECIPIONAL WORK STANDARD WITH WITH ON SIGNASS THE EDITION OF NESC. ALL WORK SHALL COMENTY WITH ALL APPLICABLE SERVING POWER AND COMMUNICATION UTILITIES CODES, ORDINANCES, RULES AND REGULATION.
- 3. MEET ALL REQUIREMENTS: ALL WORK SHALL MEET THE REQUIREMENTS OF THE AFORE MENTIONED CODES AND ALL CODES AND STANDARDS REFERENCED IN THE SPECIFICATION, ALTHOUGH THE DETAILS OF SUCH WORK MAY NOT BE SHOWN ON THE
- . CONFLICTS: CONFLICTS BETWEEN THE APPLICABLE CODES, STANDARDS AND THE PLANS AND SPECIFICATION MUST BE BROUGHT TO THE ATTENTION OF THE DESIGN/BUILD CONTRACTOR, PRIOR TO PROCEEDING WITH THE WORK IN QUESTION.
- CONFLICTING STANDARDS: IN THE CASE OF CONFLICT BETWEEN THE CONTRACTOR DOCUMENTS AND A GOVERNING CODE OR ORIDINANCE, THE MORE STRINGENT STANDARD SHALL APPLY.
- ACCEPTANCE OF CONDITIONS: INTIATING WORK CONSTITUTES SUBCONTRACTOR ACCEPTANCE OF THE EXISTING CONDITION ASSOCIATED WITH THE WORK IN QUESTION.
- 7. TRADE LICENSE: THE ELECTRICAL SUBCONTRACTOR SHALL BE CURRENTLY LICENSED TO PERFORM THIS WORK WITHIN THE JURISDICTION HAVING AUTHORITY, ALL REQUIRED LICENSING SHALL BE MAINTAINED THROUGHOUT THE DURATION OF THE WORK.
- SAFE: THE ELECTRICAL SUBCONTRACTOR IS RESPONSIBLE FOR OVERSEEING THE SAFE OPERATION OF ALL EQUIPMENT IN HIS USE. THE ELECTRICAL SUBCONTRACTOR IS RESPONSIBLE FOR MAINTAINING ALL OF THE EQUIPMENT IN HIS USE IN A SAFE CONDITION. KEEP DEAD FRONT EQUIPMENT IN PLACE WHEN EQUIPMENT IS ENERGIZED. CONDUCT ALL CONSTRUCTION OPERATION IN A SAFE MANINER FOR EMPLOYEES. AS WELL AS OTHER WORK PERSONS OR ANYONE VISITING THE JOB SITE. PROVIDE BARRIERS, FLAGS, TAPE, ETC. AS REQUIRED FOR SAFETY.

 ALL ELECTRICAINS MUST PERFORM THIER WORK IN ACCORDANCE TO THE GUIDELINES SET FORTH BY THE NPPA 70E.
- PROFESSIONALISM AND APPEARANCE OF WORK: WORKMANSHIP OF ALL INSTALLATION PHOFESSIONALISM AND APPEARSANCE OF WORSE, WORKNAMPORT OF THE TRADE OF SHALL BE IN ACCORDANCE WITH ACCEPTED PRACTICES OF THIS TRADE. INSTALLATION METHODS SHALL CONFORM TO MANUFACTURERS SPECIFICATION. THE SUBCONTRACTOR TRADE FOR THE QUERTION OF THE JOB WITH QUALIFIED JOURNEYMEN AND EMPLOYEES IN THIS TO COMMUNICATE WITH AND KEEP THE DESIGN/BUILD CONTRACTOR APPRAISED OF CHANGES OR CLARIFICATIONS
- 10. WORKMANSHIP: ALL ELECTRICAL EQUIPMENT SHALL BE INSTALLED IN A NEAT, DURABLE.
- STORAGE AND EQUIPMENT STORAGE OF EQUIPMENT FOR THE JOB IS THE RESPONSIBILITY OF THE ELECTRICAL SUBCONTRACTOR AND SHALL BE SCHEDULED FOR DELIVERY TO THE SITE AS THE EQUIPMENT IS REQUIRED, DAMAGE TO THE EQUIPMENT DELIVERED TO THE SITE OR IN TRANSPORT TO THE JOB SHALL BE THE RESPONSIBILITY THE ELECTRICAL SUBCONTRACTOR.
- UTILITY COORDINATION: ELECTRICAL SUBCONTRACTOR SHALL CONTACT ALL UTILITIES AND VERIFY ALL UTILITY REQUIREMENTS PROR TO COMMENCING OR ORDERING ANY MATERIALS WHATSOEVER. CONFLICTS BETWEEN LITTLITY REQUIREMENTS AND THE PLANS OR SPECIFICATIONS SHALL BE BROUGHT TO THE ATTENTION OF OF THE DESIGN/BUILD CONTRACTOR PRIOR TO COMMENCING CONSTRUCTION OR ORDERING MATERIALS WHATSOEVER SUBCONTRACTOR SHALL CALL PRE-CONSTRUCTION FACE-TO-FACE MEETING WITH THE UTILITY COMPANIES TO REVIEW REQUIREMENTS AND PLANS
- 13. METHODS OF CONSTRUCTION: UNLESS OTHERWISE NOTED OR SHOWN , THESE DRAWINGS AND SPECIFICATIONS DO NOT INDICATE METHODS OF CONSTRUCTION THE SUBCONTRACTOR SHALL SUPERVISE AND DIRECT THE WORK, AND BE SOLELY RESPONSIBLE FOR ALL CONSTRUCTION MEANS, METHODS, TECHNIQUES, SEQUENCES,
- 14. THE EXACT LOCATION AND THE ARRANGEMENTS OF ALL PARTS SHALL BE DETERMINED AS THE WORK PROGRESSES. THE SUBCONTRACTOR SHALL BE RESPONSIBLE FOR PROVIDING A COMPLETE AND FUNCTIONAL ELECTRICAL SYSTEM.
- 15. INCIDENTAL ITEMS: INCIDENTAL ITEMS NOT INDICATED ON DRAWINGS, NOT MENTIONED IN THE SPECIFICATIONS THAT CAN BE LEGITIMATELY AND REASONABLY INFERRED TO BELONG TO THE WORK DESCRIBED OR NECESSARY IN GOOD PRACTICE TO PROVIDE A COMPLETE SYSTEM, SHALL BE FURNISHED AND INSTALLED AS TOUGH ITEMIZED HERE IN
- 16. DAMAGE RESPONSIBILITY: THE SUBCONTRACTOR SHALL BE RESPONSIBLE FOR ANY LOSS OR DAMAGE CAUSED BY HIM OR HIS WORKMEN TO THE FACILITY DURING THE COURSE OF CONSTRUCTION, AND SHALL BE FULLY RESPONSIBLE FOR REPAIRING OR REPLACING AS REQUIRED TO INSURE RESTORATION TO ORIGINAL CONDITION.
- 17. COMPLETE AND FUNCTIONAL SYSTEM: SUBCONTRACTOR SHALL FURNISH MATERIALS TOOLS, SERVICES, LABOR, ETC, FOR A COMPLETE AND FULLY FUNCTIONAL ELECTRICAL INSTALLATION UNLESS OTHERWISE NOTED ON PLANS.
- 18. COOPDINATION WITH OTHER TRADES: THE SUBCONTRACTOR SHALL BE RESPONSIBLE FOR COORDINATING ALL ELECTRICAL INSTALLATION WITH ALL OTHER TRADES TO AVOID
- SUBCONTRACTOR SHALL DETERMINE EXACT LOCATION IN THE FIELD, FEEDERS SHALL NOT BE INCREASED IN LENGTHS SHOWN WITHOUT ENGINEERING APPROVAL.
- 20. EQUIPMENT OUTDOOR RATINGS: ALL ELECTRICAL EQUIPMENT EXPOSED OR INSTALLED OUTDOORS SHALL BE NEMA 3R (WEATHER PROOF) OR NEMA 4 (WET LOCATION) RATED
- SUBMITTAL /SHOP DRAWINGS : ALL SUBMITTAL /SHOP DRAWINGS SHALL CONTAIN COMPLETE INFORMATION NECESSARY TO DETERMINE THAT THE ITEM IS APPROPRIATI FOR THE PURPOSE INTENDED. ALL/SUBMITTA /SHOP DRAWINGS SHALL. CONTAIN THE MANUFACTURES CONTACT PERSON AND CURRENT TELEPHONE NUMBER
- INDICATED LOCATION OF FOLIPMENT LOCATION OF FOLIPMENT CONDUIT, AND WITH THE CIVIL AND ARCHITECTURAL DRAWINGS.
- NRTL LISTING: ALL ELECTRICAL EQUIPMENT. SHALL BE NEW JIN FIRST CLASS CONDITION. AND LISTED BY NATIONALLY RECOGNIZED TESTING LABORATORY (INRTLISUCH AS U.L. IF SUCH A LISTING EXIST FOR COMPARABLE EQUIPMENT.
- GENERAL. SUBCONTRACTOR WORK: ELECTRICAL SUBCONTRACTOR IS RESPONSIBLE FOR WORK OF A GENERAL CONTRACTING NATURE SPECIFIED ON ELECTRICAL. PLANS INCLUDING, JULY NOT NECESSARILY LUMBED TO THE FOLLOWING.

 A CONCRETE FOOTINGS INCLUDING REBAR AND MOUNTING BOLTS FOR PLACEMENTS OF LIGHTS PAYLINE POLES.

- C. SUPPLY AND INSTALLATION OF ALL EQUIPMENT PADS AND SPLICE BOXES UNLESS NOTED OTHERWISE.
- WORKING SPACE :WORKING SPACE SHALL MEET OR EXCEED THE NEC REQUIREMENT FOR ALL ELECTRICAL EQUIPMENT. (SEE NFPA 70-2005, SEC 110-26)
- EQUIPMENT ACCECIBILITY :IT SHALL BE THE RESPONSIBILITY OF SUBCONTRACTOR TO SEE THAT ALL THE ELECTRICAL EQUIPMENT SHALL BE MADE ACCESSIBLE, SUCH AS JUNCTION BOXES, PULL BOXES PANELBOARDS, SWITCHES, CONTROLS AND SUCH OTHER APPARATUS AS MAY REQUIRE MAINTENANCE AND OPERATION FROM TIME TO TIME.

- 27. EQUIPMENT PROTECTION: AFTER INSTALLATION, ELECTRICAL EQUIPMENT SHALL BE PROTECTED TO PREVENT DAMAGE DURING THE CONSTRUCTION PERIOD OPENINGS IN CONDUITS AN BOXES SHALL BE CLOSED TO PREVENT THE ENTRANCE OF FOREIGN
- 28. AS BUILD RECORD DRAWINGS: PROVIDE RECORD DRAWING TO THE D/B CONTRACTING OFFICER WITH ALL CHANGES NOTED THEREON AT THE COMPLETION OF THE PROJECT. RECORD DRAWINGS SHALL BE SIGN AND DATED BY SUBCONTRACTOR.
- 29. SHOP DRAWINGS:SUBMIT SHOP DRAWINGS AND MATERIALS LIST FOR REVIEW PRIOR TO COMMENCING ANY WORK, ALL EQUIPMENT TO BEAR U.L. LABEL OR THAT OF ANOTHER ACCEPTABLE TESTING LABORATORY, WHEN SUCH LISTINGS EXIST. FOR COMPARABLE EQUIPMENT SHOP DRAWING MUST BE STAMPED BY THE SUBCONTRACTOR FOR CONFORMANCE PRIOR TO SUBMITTAL
- 30. DIGGING PERMITS AND OUTAGE REQUESTS :ALL DIGGING PERMITS AND OUTAGE REQUESTS ARE THE RESPONSIBILITY OF THE SUBCONTRACTOR. COPIES SHALL BE PROVIDED TO THE D/B CONTRACTOR BEFORE CONSTRUCTION BEGINS
- 30. DIGGING PERMITS AND OUTAGE REQUESTS: ALL DIGGING PERMITS AND OUTAGE REQUESTS ARE THE RESPONSIBILITY OF THE SUBCONTRACTOR, COPIES SHALL BE PROVIDED TO THE D/B CONTRACTOR BEFORE CONSTRUCTION BEGINS
- 31. ATTRACTIVE NUISANCES: OPEN TRENCHES, ELECTRICAL EQUIPMENT AND DEVICES SHALL NOT PRESENT AN ATTRACTIVE NUISANCE TO CHILDREN. ALL ELECTRICAL EQUIPMENT SHALL BE TOTALLY INACCESSIBLE, DEAD FRONT AND LOCKABLE.
- 32, ROUTING AND LOCATION: THE ROUTING OF THE NEW UNDERGROUND FEEDERS SHALL BE APPROVED BY AND COORDINATED WITH THE DESIGN/BUILD CONTRACTOR. EXCEPT FOR CROSSINGS, ELECTRICAL AND COMMUNICATIONS UTILITIES SHALL NOT BE LOCATED UNDER STREETS.
- 34. THE SUBCONTRACTOR IS RESPONSIBLE TO COOPDINATE WITH THE DESKINGUILD CONTRACTOR FOR REMOVING, LOCATING, CAPPING AND OR RELOCATION OF ANY ELECTRIC FACILITIES WHICH ARE NOT TO REMAIN IN SERVICE AND TO INSTALL FACILITIES AS REQUIRED TO MAINTAIN CONTINUOUS SERVICE TO DWELLING UNITS OR BUILDING STRUCTURES THAT WILL REMAIN,
- 35. NON-METALLIC WEATHERPROOF ENCLOSURES SHALL BE CONSTRUCTED OF GLASS FIBER REINFORCED POLYESTER RESIN, WITH PIGMENTED HEAT RESISTANT HIGH GLOSS SUFFACING SEALER ON THE INTERIOR, WITH PIGMENTED, ULTRAWOULET UGHT STABILIZED WEATHER RESISTANT SUFFACE COAT ON THE EXTERIOR, EACH SECTION SHALL BE MOLDED IN ONE PIECE, SECTIONAL COMPONENTS JOINED BY BOLTING RIVETING OF USE OF ADHESIVES ARE NOT ACCEPTABLE. ALL HARDWARE SHALL CONSIST OF TYPE 304 STAINLESS STEEL AND SHALL INCLUDE PENTAGONAL BOLTS AND PROVISIONS FOR PADLOCKING, DIMENSIONS OF ENCLOSURES SHALL BE AS REQUIRED TO ACCOMMODATE EQUIPMENT AND/OR FUNCTIONS SPECIFIED, BUT IN NO CLASS
- 36. PROVIDE LOCKS AT ALL ELECTRICAL ENCLOSURES SUCH AS TRANSFORMERS, FUSE AND SPLICE CABINETS. LOCKS ARE TO BE COMPATIBLE WITH EXISTING LOCKS USED BY BASE ELECTRICAL.
- 37. PROVIDE ENGRAVED PLASTIC NAME PLATES FOR SWITCHBOARDS, PANELS, TERMINAL CABINETS, AND ANY OTHER MAJOR ELECTRICAL ITEM. SCREW-ON ATTACHMENT ONLY-
- 38. EQUIPMENT LOCATIONS ARE APPROXIMATE. EXACT ROUTING AND EQUIPMENT LOCATION IS TO BE COORDRAITED WITH OTHER TRADES AND APPROVED BY THE DIS CONTRACTOR WHERE SHOWN EQUIPMENT IS TO BE CLUSTERED COORDINATE CLUSTERED LOCATIONS WITH LANDSCAPE CONTRACTOR FOR SHELDING, MAINTAIN WORKING CLEARANCES. A MINIMUM DISTANCE OF 4" IS REQUIRED BETWEEN PRIMARY ELECTRICAL LINES AND WET UTILITIES.
- 39. TRENCHING IS TO AVOID DRIP LINES ON TREES AS SHOWN ON PLANS, ALL TRENCHING TTHIN DRIP LINES TO BE APPROVED BY THE D/B CONTRACTOR
- 40. STAKING OF ELECTRICAL EQUIPMENT PADS: ALL ELECTRICAL EQUIPMENT. 13 STARTING OF ELECTRICAL EQUIPMENT PAULS: ALL ELECTRICAL EQUIPMENT, INCLUDING TRANSFORMERS, SWITCHES, METERS, JUNCTION CASINETS, LIGHTING POLE BASES, ETC. ARE TO BE STAXED BY THE ASSIGNED PROJECT SURVEYORS FOR FINAL ELEVATION AND LOCATION OF PAULS OF ANCHORS. ELEVATIONS ARE TO BE DETERMINED BY THE SITE CAIL. DESIGN ENGINEER. IN CONSISTENCIES AND INTERFERENCES ARE TO BE REPORTED TO THE DIS CONTRACTOR. THE ELECTRICAL SUBCONTRACTOR IS TO VERIFY THAT EQUIPMENT PAD ELEVATIONS ARE AS STAKED.
- 41, STAKING OF ELECTRICAL TRENCHES: AFTER ELECTRICAL TRENCHES ARE MARKED FOR BOUTING BY THE ELECTRICAL SUBCONTRACTOR, ARRANGEMENTS ARE TO BE MADE FOR THE ASSIGNED PROJECT SURVEYORS TO LOCATE THE MARKED ROUTE AND TRANSFER THE ASSIGNED PHACE IS JOINED TO ID COLOR IT THE MARKED FROM EVEN HAVE INFORMATION TO THE SITE CYAL DESIGN ENGINEER TO ASSIGN FINNSH GRADES. THESE FINISH GRADES SHALL BE TRANSFERRED BACK TO THE ASSIGNED PROJECT SURVEYOR TO PROVIDE TRENCH STANING INDICATING FINAL GRADE TO RESURE THAT MINIMUM BURIAL DEPTHS ARE MAINTAINED. THE ELECTRICAL SUSCONTRACTOR IS TO VERIFY THAT TRENCH DEPTHS RELATIVE TO FINISH GRADE ARE AS STAKED
- 42. ALL SPARE/EMPTY CONDUITS SHALL BE PROVIDED WITH A PULL LINE
- 43. INSTALLATION GUIDELINES SHALL CONFIRM TO CURRENT NEPA 70 NEC. 44. ALL EQUIPMENT INCLUDING POLE RISERS, PAD MOUNTED GEAR, LIGHT POLES AND ISC.
- EQUIPMENTS SHALL BE GROUNDED.
- 45. EQUIPMENT GROUNDING: ONE 3/4 INCH BY 10 FOOT COPPER CLAD GROUND ROD SHALL BE INSTALLED IN A CONDUIT WINDOW OF EACH EQUIPMENT PAO (WHERE TRANSFORMER PAOS HAVE MORE THAN ONE CONDUIT WINDOW. THE GROUND RODS SHALL BE INSTALLED IN SECONDARY/LOW VOLTAGE WINDOW), ALL UNDERGROUND GROUNDING CONNECTIONS SHALL BE EXOTHERMIC TYPE CONNECTIONS.

LEGENDS CONDLIT FOR POWER COMMUNICATIONS CONDUC PANNFI NEMA 5-20R DUPLEX RECEPTACLE MOUNTED AT 15" AFF ON CENTER, UNO. IG = ISOLATED GROUND WP = GROUND FAULT CIRCUIT INTERRUPTER AC = MOUNTED 4" ABOVE COUNTER TRANSFORMER MS8 (J)

ABBREVIATIONS

JUNCTION BOX

AMP
AVAILABLE FAULT CUFFIENT
AMPERES INTERRUPTING CAPACITY
ABOVE FINISHED ILOOR
AMERICAN DISBILITIES ACT
AMP TERP
AUTOMATIC TRANSFER SWITCH
AMERICAN WIRE GAUGE
BREAKER
CONDUIT OR CONDUCTOR
AS APPLICABLE
CIRCUIT BREAKER
CIRCUIT
CEILING
CONDUIT ONLY
CONTROL POWER TRANSFORMER
DOUBLE THROW TRANSFER SWITCH
EMPTY CONDUIT
EM-ALIST FAN
ELECTRICAL-PLECTRIC
EMERGENCY
FIRE ALARM
FIRE ALARM
FIRE ALARM
ONTROL PANEL
? FLUORESCENT
J GROUND
GROUND
GROUND
FAULT (CIRCUIT)



GENERATOR
JOROUND FAULT (CIRCUIT)
INTERRUPTER
HAND HOLEPHIGH INTENSITY
DISCHARGE
HAND/OFF/AUTO
HORSE POWER
HOT WATER HEATER
ISOLATED GROUND
INCANDESCENT
JUNCTION BOX
THOUSAND CIRCULAR MILES
KELOWATT
KELOWAT
KELOWATT
KELOWATT
KELOWAT
KELOWA

KILOWATT HOUR LIGHTS

MOTOR CONTROL CENTER METAL HALIDE OR MANHOLE-MAIN LUG ONLY

NATIONAL ELECTRICAL CODE NATIONAL FIRE PROTECTION ASSOCIATION NIGHT LIGHT (UNSWITCHED CKT.)

POLE PULL BOX POLYVINYL CHLORIDE

RECEPTACLE RIGID GALVANIZED STEEL SHIELDED

SINGLE POLE, DOUBLE THROW SINGLE POLE, SINGLE THROW SERIES RATED AMPERES INTERRUPTING CAPACITY

SW SWB TELE TTB UG UPS UON V TELEPHONE TELEPHONE TERMINAL BOARD UNDERGROUND UNINTERRUPTABLE POWER SUPPLY UNLESS OTHERWISE NOTED

VOLT



MANUFACTURER - EATON MCGRAW-EDISON CATALOG - GLEON-AF-03-LED-E1-T3-BK INPUT WATTAGE - 166 W COLOR TEMP - BLACK, 3000K FIXTURE - ALZ-01, ALZ-01A



MANUFACTURER - EATON/INVUE CATALOG - ABB-B2-LED-42-D1-S-DP INPUT WATTAGE - 32 W COLOR TEMP - DARK PLATINUM, 4000K FIXTURE - ALZ-02



BASE4 2901 CLINT MOORE ROAD #114 BOCA RATON, FLORIDA 33496 www.base-4.com

Seal



ALLEN SIGMON REAL ESTATE GROUP ALBUQUERQUE, NM 87111



ELEMENT ALBUQUERQUE,N

No. ISSUE DATE PROJECT STATUS

2020,01.16

DRAWN BY SG CHECKED BY DH SCALE AS NOTED PROJECT NO. B4 - 176 - 1901

SHEET NAME

SITE LIGHTING NOTES AND ABBREVIATIONS


DRAWING NO.

DATE

SL001

SITE LIGHTING GENERAL NOTES:

- CONTRACTOR SHALL CO-ORDINATE WITH OWNER/CIVIL ENGINEER FOR SITE LIGHTING DETAILS. BASE4 HAS PROPOSED PANEL FOR SITE POWER CONTRACTOR SHALL USE THAT FOR FUTURE REFERENCE.
- 2. LIGHTING NOT DESIGNATED FOR DUST-TO-DAWN OPERATION SHALL BE CONTROLLED BY EITHER A COMBINATION OF A PHOTOSENSOR AND A TIME SWITCH, OR AN ASTRONOMINAL TIME SWITCH. LIGHTING DESIGNATED FOR DESK-TO-DAWN OPEATION SHALL BE CONTROLLED BY AN ASTRONOMICAL TIME SWITCH OR PHOTOSENSOR, ALL TIME SWITCHES SHALL RETAIN PROGRAMMING AND THE TIME SETTING DURING LLOSS OF POWER FOR A PERIOD OF AT LEAST 10 HOURS, LIGHTING DESIGNATED TO OPERATE MORE THAN 2000 HOURS PER YEAR FOR UNCOVERED PARKING AREAS SHALL BE COUPPED WITH MOTION SENSORS THAT WILL REDUCE THE LUMINARIES POWER BY 33 PERCENT OR TURN OFF ONE THIRD THE LUMINARIES WHEN NO ACTIVITY IS
- POLE BASE COVERS ARE TO BE INSTALLED SO THAT THE BASE COVER FITS FLUSH TO THE TOP OF THE CONCRETE BASE. LEVELING SHIMS AND NUTS
 SHALL NOT CAUSE A GAP BETWEEN THE POLE BASE AND THE BASE COVER.
- ALL WIRING IS TO BE #12 AWG AND #12 AWG GROUND MINIMUM THHRYTHWN (80 DEG. C) IN 1° SCHEDULE 40 PVC (MINIMUM SIZE). TRENCH 30° DEEP. CLEAN BACKFILL USING SITE MATERIALS CAN BE USED. PROVIDE PREMILIM BACKFILL WHERE SITE MATERIALS ARE NOT ACCEPTABLE FOR USE.

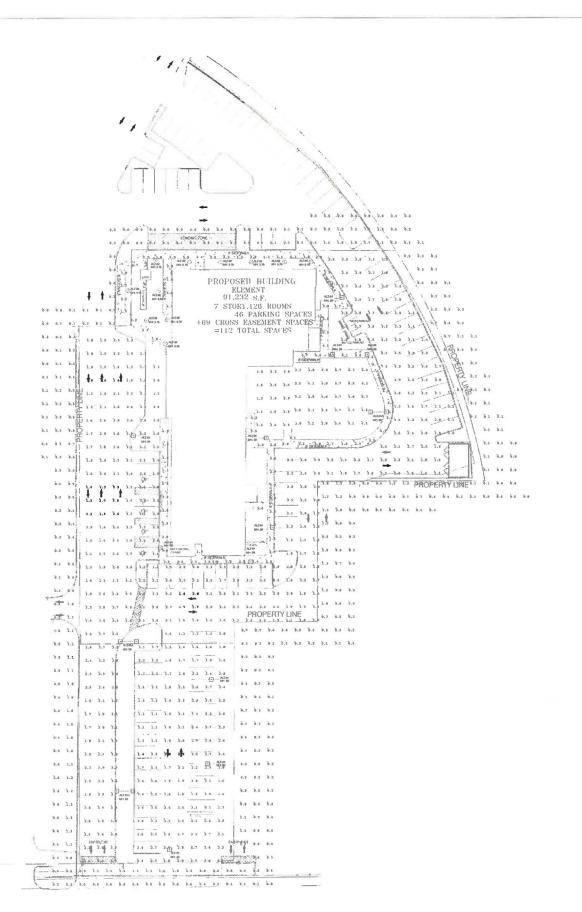

| | ALL SITE LIGHTING POLES SHALL BE WIND SPEED RATED FOR 80 MPH, MIN. | TYPICAL SITE USHTING FIXTURE |
|-------------------|--|--|
| | - | ROUND TAPERED ALUMINUM POLE |
| Ь | REINFORCED HANDHOLE | - #12 CONDUCTORS UP TO FIXTURE(S) |
| 28 | GROUNDING LUG | IN-LINE FUSE |
| | CAST ALUMINUM NUT | 4 BOLT CIRCLE PER |
| FINISH GRADE - | 0.1 | GROUT FILL |
| .m1 | 2 | 1º CHAMPERED EDGE |
| | | ANCHOR BOLTS PER MANUFACTURER |
| | 0.00 | SCH, 80 PVC CONDUIT REFER TO SITE OF CONDUITS |
| | 6 | ELECTRICAL PLAN FOR SIZE AND NUMBER |
| 3/45/10 (1903) | | ROLIND POLE BASE 4,500 PSI CONCRETE |
| GROUNDING F | STEEL | BEA #6 VERTICAL BARS W/ #3 HORIZONTAL THE BARS 12" O.C. |
| | 2'-0" | NOTE POLE BASE AT POOL SHALL BE FLUSH WITH BASE |
| | POLE BASE DETAIL WHEN | E FOUNDATION FLUSH WITH GRADE |

| Label | CalcType | Units | Avg | Mex | Min | . Avg/Min | Max/Min |
|---------------|---------------|-------|------|------|-----|-----------|---------|
| Outdoor Patlo | . Illuminance | Fc | 3.25 | 4.8 | 1.0 | 3.25 | 4.80 |
| Outdoor Pool | filuminance | Fc | 6.54 | 12.2 | 3.0 | 2.18 | 4.07 |
| Parking | Muminance | Fc | 3.94 | 11.2 | 1.0 | 3.94 | 11.20 |
| Property Line | Illuminance | Fc | 0.35 | 2.6 | 0.0 | N.A. | N.A. |
| Side Walk | Illuminance | Fc | 4.92 | 12.5 | 1.0 | 4.92 | 12.50 |

| Symbol | Qty | Label | Arrangement | Total Lamp Lumens | LLF | Description | Filename | Arm | Lum. Watts |
|--------|-----|---------|-------------|-------------------|-------|-----------------------|---------------------------|-----|------------|
| - 0 | 11 | ALZ-01 | SINGLE | N.A. | 0.900 | GLEON-AF-03-LED-E1-T3 | GLEON-AF-03-LED-E1-T3.ies | 2 | 166 |
| (3) | 11 | ALZ-02 | SINGLE | N.A. | 0.900 | AB8-B2-LED-D1-S | ABB-B2-LED-D1-S.ies | 0 | 32 |
| | 3 | ALZ-01A | BACK-BACK | N.A. | 0.900 | GLEON-AF-03-LED-E1-T3 | GLEON-AF-03-LED-E1-T3.les | 2 | 166 |

NOTE:MOUNTING HEIGHTS ARE MENTIONED NEAR FIXTURES IN THE DRAWING USING ABBR,MH:XX.X.EG.MH:20 INDICATES A MOUNTING HEIGHT OF 20 FEET.



BASE4
2901 CLINT MOORE ROAD #114
BOCA RATON, FLORIDA 33496
www.base-4.com

Car



ALLEN SIGMON REAL ESTATE GROUP 9201 MONTGOMERY BLVD, NE BLDG 1 ALBUQUERQUE, NM 87111



ELEMENT ALBUQUERQUE,NM

| No. | ISSUE DATE | PROJECT STATUS |
|-----|------------|----------------|
| | | |
| | | |
| | No. | No. ISSUE DATE |

 DATE
 2020.01.16

 DRAWN BY
 SG

 CHECKED BY
 DH

 SCALE
 AS NOTED

 PROJECT NO.
 B4 - 176 - 1901


SHEET NAME

SITE PHOTOMETRICS PLAN

DRAWING NO.

SL002



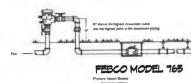

FEBCO MODEL 165




Landscape Architect



SHRUB PLANTING DETAIL

CHARLE MAKE THE DEFECTOR OF THE SHIPS RETENTION SHARM SHALL SE TRICE THE DEFECTOR OF THE SHIPS PLANTING

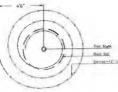

Netofim Spiral Detail

244@ Louislana Proposed Hotel Albuquerque, NM



ORALIN BY On REVIBION . SHEET .

LS-101


GRAPHIC SCALE 40 20 0 20 40 BCALE: 1" = 40'-0"

DRAINAGE NARRATIVE **EROSION CONTROL NOTES:** THE SITE IS A FULLY DEVELOPED PORTION OF AN EXISTING SITE. THE OVERALL ORIGINAL SITE WAS DESIGNED TO DISCHARGE TO AN EXISTING 60" STORM DRAIN IN LPUISIANA, VIA SURFACE AND UNDERGROUND CONDUITS. THE OVERALL SITE ANALYSIS IS LOCATED IN DRAINAGE FILE H16D1. 2. CONTRACTOR IS RESPONSIBLE FOR MAINTAINING RUN-OFF ON SITE DURING THE PROJECT AREA WAS AT ONE TIME A RETENTION BASIN. THE SITE WAS REANALYZED BY BOHANAN HUSTON IN 1984 AMD PARTIALLY CONSTRUCED, THE POND BASIN WAS CONVERTED TO A PARKING LOT DETENION POND IN A REPORT BY LARRY REID IN 2004. THE PROJECT AREA ACCEPTS 3. CONTRACTOR IS RESPONSIBLE FOR CLEANING ALL SEDIMENT THAT GETS INTO UPLAND FLOW FROM THE EAST. THE SITE IS ALLOWED TO DISCHARGE AT A PEAK RATE OF 1.6CFS. 4. REPAIR OF DAMAGED FACILITIES AND CLEANUP OF SEDIMENT ACCUMULATIONS ON LOT 6-A-1-A, BLOCK C LOUISIANA SUBDIVISION THIS DEVELOPMENT WILL CONTINUE TO ALLOW THE UPLAND PLOW of 3.435 CFS TO ENTER THE SITE. THE SITE WILL CONTINUE TO GENERATE 6.30 CFS. THE BASIN DISCHARGE SHALL MATCH THE CONTRACTOR. HISTORICAL RATE OF 0.63 CFS ALLOWED BY THE INTRODUCTION PARKING LOT DETENTION WITH 5. ALL EXPOSED EARTH SURFACES MUST BE PROTECTED FROM WIND AND WATER EROSION PRIOR TO FINAL ACCEPTANCE OF ANY PROJECT. 6=52cm SUBSURFACE INFILTRATION CHAMBERS. THE REQUIRED FIRST FLUSH VOLUME OF 1450 CUBIC FEET WILL BE CAPTURED BY THE UNDERGROUND CHAMBERS. THE DEVELOPMENT OF THIS SITE WILL MATCH EXISTING CONDITIONS. 2.265 CFS WATER BREAK 5300 52 LOT 6-A-B, BLOCK C CONNECT EXISTING 12" PVC REIGAT CONNECT EASTING 12 PMC I'D TYPE "D' DROP INLET GRATE = 94.75 MYSELL = 95.50 EXISTING STORM DRAIN LIFT STATION REMOVE EXISTING DRAIN. COVERED PAR FF = 5296.25 NEW 50 LF OF 12" HOPE FP = 5295.75 A REMOVE EXISTING 12 ... 1.17 CFS - IKRIGATION BOY WATER BREAK INFLITRATOR SYSTEM. 26 MC 450Q CHAMBERS NVERT = 86.00 GRATE = M. TSMWSBL... ADJOINING BOILDING STORM DRAIN W/Z" ORIFICE PLATE GRATE = 94.75MWSEL = 95 . \$0 INSTAL INDERGROUNG OVE EXISTING 12" TYPE "D" DROP INLET W.IZ" ORIFICE PLATE GRATE = 95.00 INFILTRATOR SYSTEM 20 MC 4500 CHAMBERS NEW 117 LF OF 12" HDPE STORM DRAIN WATER BREAK LOT 7-A-1-A-1-A, BLOCK C REMOVE EXISTING 6 蒙 STEEL SALE P=5295 TYPE "D" DROP INLE NEW 120 LF OF 12" HDPE The Street Rr STORM DRAIN GRATE = 94.25 MWSEL = 95.00 TER BREAK > TA=5794.85 8-5394 F KTA-5294 70 0.63 CFS DISCHARGE VIA 12" PIPE LIGHT POLE -18-5235.53 14-5294.86(TA=5294.6) C8=5294.73 C9=5294.6 'A=5294.6 - A=5294.6 CE=5294 & JCE=5294.7 TA=5294 0. TA=5294.5 105 XIA=5294 /6-TA=5294.5 h=5294 ¥1A=5294.51 CF=529-F4=5293 1A: 5294.56 $(R_{G_{\overline{E}})}$ Ct=5295 03 CB= TA=5294.68 TA= 5294.719 CS EXISTING UTILITIES ARE NOT SHOWN. IT SHALL BE THE SOLE RESPONSIBILITY OF THE CONTRACTOR TO CONDUCT ALL NECESSARY FIELD INVESTIGATIONS PRIOR TO ANY EXCAVATION TO DETERMINE THE ACTUAL LOCATION OF UTILITIES & OTHER IMPROVEMENTS. 15=1294 Th=579 FI JONE SHE SCALE: 1"=30"

- 1. CONTRACTOR IS RESPONSIBLE FOR OBTAINING A TOPSOIL DISTURBANCE PERMIT

- ADJACENT PROPERTIES AND IN PUBLIC FACILITIES IS THE RESPONSIBILITY OF THE



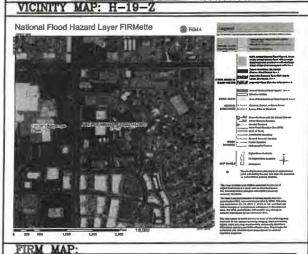

LEGAL DESCRIPTION:
LOTS 5-A-1, 5-A-2, 8-A-1-C-1-A AND 6-A-1-C-1-B, BLOCK
ALBUQUERQUE, BERNALILLO COUNTY, NEW MEXICO

- 1. ALL SPOT ELEVATIONS REPRESENT FLOWLINE ELEVATION UNLESS OTHERWISE NOTED.
- 2. ALL SLOPES SHALL BE $\,$ 3:1 MAX, AND GRAVEL OR NATIVE SEEDING PRIOR TO CO.
- 3. ANY PERIMETER WALLS MUST BE PERMITED SEPARATELY. ALL RETAINING WALL DESIGN SHALL BE BY OTHERS.
- 4. SURVEY INFORMATION PROVIDED BY COMMUNITY SCIENCES CORPORATION USING NAVD

LEGEND

-

EXISTING SPOT ELEVATION **⊕** XXXXX PROPOSED SPOT ELEVATION BOUNDARY ADJACENT BOUNDAR ==== EXISTING CURB AND GUTTER PROPOSED WATER BREAK

C = WATER METER = SANITARY SEWER MANHOLE (D) = STORM DRAIN MANHOLE PROPOSED HOPE STORM DRAIN

CB = CURB
BPOND = BOTTOM OF POND
DRN = DRAIN
EC = EDGE OF CONCRETE
FF = FINISHED FLOOR
FL = FLOW LINE

T = LIGHT POLE


m = IRRIGATION BOX 2 WATER VALVE

G = GROUND
N&D = NAIL & DISC
RMP = RAMP
SASMH = SANITARY SEWER MANHOLE
TA = TOP OF ASPHALT

DRAWN BY DEM

DATE

PROPOSED TYPE "D" DROP INLET PER COA STD DWG (P) = PHONE MANHOLE PROPOSED INDERGROUND INFILTRATOR SYSTEM

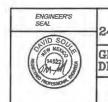

2440 LOUISIANA BLVD.

Engineering

11/7/19 DAVID SOULE

*UPDATED BASE 1/9/2020

GRADING AND DRAINAGE PLAN ID) CICIESIANA BILVO DIN SHEET# Rio Grande C1 JOB#



| | | | ROOM | MATRIX | | | | | | |
|-------------------------------|-----|-----|------|--------|-----|-----|-------|------|------|-------------|
| ROOM TYPE | 1ST | 2ND | 3RD | 4TH | 5TH | 6TH | TOTAL | | % | NO. OF BEDS |
| STANDARD KING | 0 | 5 | 7 | 7 | 7 | 6 | 32 | 25% | | 32 |
| STANDARD KING ACC. | 0 | 0 | 0 | 0 | 0 | 1 | 1 | 1% | | 1 |
| STANDARD KING CONN. | 0 | 5 | 5 | 5 | 5 | 5 | 25 | 20% | | 25 |
| COMMONS KING A | 0 | 0 | 0 | 0 | 3 | 3 | 6 | 5% | 68% | 6 |
| COMMONS KING B | 0 | 0 | 0 | 0 | 0 | 1 | 1 | 1% | 0070 | 1 |
| ACCESSIBLE COMMONS KING | 0 | 0 | 0 | 0 | 1 | 0 | 1 | 1% | | 1 |
| STUDIO KING | 0 | 3 | 4 | 4 | 4 | 4 | 19 | 15% | | 19 |
| STUDIO KING ACC. | 0 | 1 | 0 | 0 | 0 | 0 | 1 | 1% | | 1 |
| STUDIO QUEEN QUEEN SHOWER | 1 | 3 | 4 | 3 | 0 | 0 | 11 | 9% | | 22 |
| STUDIO QUEEN QUEEN TUB | 1 | 1 | 1 | 1 | 1 | 1 | 6 | 5% | | 12 |
| COSTUM STUDIO QUEEN QUEEN TUB | 1 | 1 | 1 | 1 | 1 | 1 | 6 | 5% | | 12 |
| ACC.STUDIO QUEEN QUEEN | 1 | 0 | 0 | 1 | 0 | 0 | 2 | 2% | | 4 |
| ONE BEDROOM | 0 | 1 | 0 | 1 | 1 | 1 | 4 | 3% | 32% | 4 |
| ONE BEDROOM CONN. | 0 | 1 | 1 | 1 | 1 | 1 | 5 | 4% | | 5 |
| ACC. ONE BERDROOM | 0 | 0 | 1 | 0 | 0 | 0 | 1 | 1% | V | 1 |
| CONFERENCE SUITE | 0 | 0 | 1 | 1 | 1 | 1 | 4 | 3% | | 4 |
| ACC. CONFERENCE SUITE | 0 | 1 | 0 | 0 | 0 | 0 | 1 | 1% | | 1 |
| GRAND TOTAL | 4 | 22 | 25 | 25 | 25 | 25 | 126 | 100% | 200% | 151 |

| SHOWER FIXTUR | E TYPE MATRIX | FLOOR AREA (SF) | | | |
|---------------------|---------------|-----------------|----------------------|--------|--|
| SHOWER | 107 | 85% | 1ST LEVEL FLOOR PLAN | 15,224 | |
| TUB | 12 | 10% | 2ND LEVEL FLOOR PLAN | 14,342 | |
| ACC. TUB | 0 | 0% | 3RD LEVEL FLOOR PLAN | 14,342 | |
| ACC. ROLL IN SHOWER | 2 | 2% | 4TH LEVEL FLOOR PLAN | 14,342 | |
| TRANSFER SHOWER | 5 | 4% | 5TH LEVEL FLOOR PLAN | 14,342 | |
| TOTAL | 126 | 100% | 6TH LEVEL FLOOR PLAN | 14,342 | |
| | | | 7TH LEVEL FLOOR PLAN | 4,298 | |
| | | | TOTAL | 91,232 | |





ALLEN SIGMON REAL ESTATE GROUP 9201 MONTGOMERY BLVD, NE BLDG 1 ALBUQUERQUE, NM 87111



ELEMENT ALBUQUERQUE,NM

| No. | ISSUE DATE | PROJECT STATUS |
|-----|------------|----------------|
| | | |
| i y | | |

2020.01.17 DRAWN BY SG CHECKED BY DH AS NOTED SCALE PROJECT NO.

B4 - 176 - 1901

SHEET NAME

FLOOR PLANS

A2.1

FIRST FLOOR PLAN SCALE: 3/32*=1'-0"



| | | | ROOM | MATRIX | | | | | | |
|-------------------------------|-----|-----|------|--------|-----|-----|-------|------|-------|-------------|
| ROOM TYPE | 1ST | 2ND | 3RD | 41H | 5TH | бТН | TOTAL | | % | NO. OF BEDS |
| STANDARD KING | 0 | 5 | 7 | 7 | 7 | 6 | 32 | 25% | | 32 |
| STANDARD KING ACC. | 0 | 0 | 0 | 0 | 0 | 1 | 1 | 1% | | 1 |
| STANDARD KING CONN. | 0 | 5 | 5 | 5 | 5 | 5 | 25 | 20% | 68% | 25 |
| COMMONS KING A | 0 | 0 | 0 | 0 | 3 | 3 | 6 | 5% | | 6 |
| COMMONS KING B | 0 | 0 | 0 | 0 | 0 | 1 | 1 | 1% | 1 00% | 1 |
| ACCESSIBLE COMMONS KING | 0 | 0 | 0 | 0 | 1 | 0 | 1 | 1% | | 1 |
| STUDIO KING | 0 | 3 | 4 | 4 | 4 | 4 | 19 | 15% | | 19 |
| STUDIO KING ACC. | 0 | 1 | 0 | 0 | 0 | 0 | 1 | 1% | | 1 |
| STUDIO QUEEN QUEEN SHOWER | 1 | 3 | 4 | 3 | 0 | 0 | 11 | 9% | | 22 |
| STUDIO QUEEN QUEEN TUB | 1 | 1 | 1 | 1 | 1 | 1 | 6 | 5% | | 12 |
| COSTUM STUDIO QUEEN QUEEN TUB | 1 | 1 | 1 | 1 | 1 | 1 | 6 | 5% | | 12 |
| ACC.STUDIO QUEEN QUEEN | 1 | 0 | 0 | 1 | 0 | 0 | 2 | 2% | | 4 |
| ONE BEDROOM | 0 | 1 | 0 | 1 | 1 | 1 | 4 | 3% | 32% | 4 |
| ONE BEDROOM CONN. | 0 | 1 | 1 | 1 | 1 | 1 | 5 | 4% | | 5 |
| ACC.ONE BERDROOM | 0 | 0 | 1 | 0 | 0 | 0 | 1 | 1% | | 1 |
| CONFERENCE SUITE | 0 | 0 | 1 | 1 | 1 | 1 | 4 | 3% | | 4 |
| ACC. CONFERENCE SUITE | 0 | 1 | 0 | 0 | 0 | 0 | 1 | 1% | | 1 |
| GRAND TOTAL | 4 | 22 | 25 | 25 | 25 | 25 | 126 | 100% | 100% | 151 |

| SHOWER FIXTUR | E TYPE MATRIX | FLOOR AREA (SF) | | | |
|--------------------|---------------|-----------------|----------------------|--------|--|
| HOWER | 107 | 85% | 1ST LEVEL FLOOR PLAN | 15,224 | |
| UB | 12 | 10% | 2ND LEVEL FLOOR PLAN | 14,342 | |
| CC. TUB | 0 | 0% | 3RD LEVEL FLOOR PLAN | 14,342 | |
| CC. ROLL IN SHOWER | 2 | 2% | 4TH LEVEL FLOOR PLAN | 14,342 | |
| RANSFER SHOWER | 5 | 4% | 5TH LEVEL FLOOR PLAN | 14,342 | |
| OTAL | 126 | 100% | 6TH LEVEL FLOOR PLAN | 14,342 | |
| | | | 7TH LEVEL FLOOR PLAN | 4,298 | |
| | | | TOTAL | 91,232 | |



ALLEN SIGMON REAL ESTATE GROUP 9201 MONTGOMERY BLVD, NE BLDG 1 ALBUQUERQUE, NM 87111



ELEMENT ALBUQUERQUE,NM

| No. | ISSUE DATE | PROJECT STATUS |
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DATE 2020.01.17 DRAWN BY SG CHECKED BY DH SCALE AS NOTED PROJECT NO. B4 - 176 - 1901


SHEET NAME

FLOOR PLANS

A2.2

SECOND FLOOR PLAN

SCALE: 3/32*=1'-0*

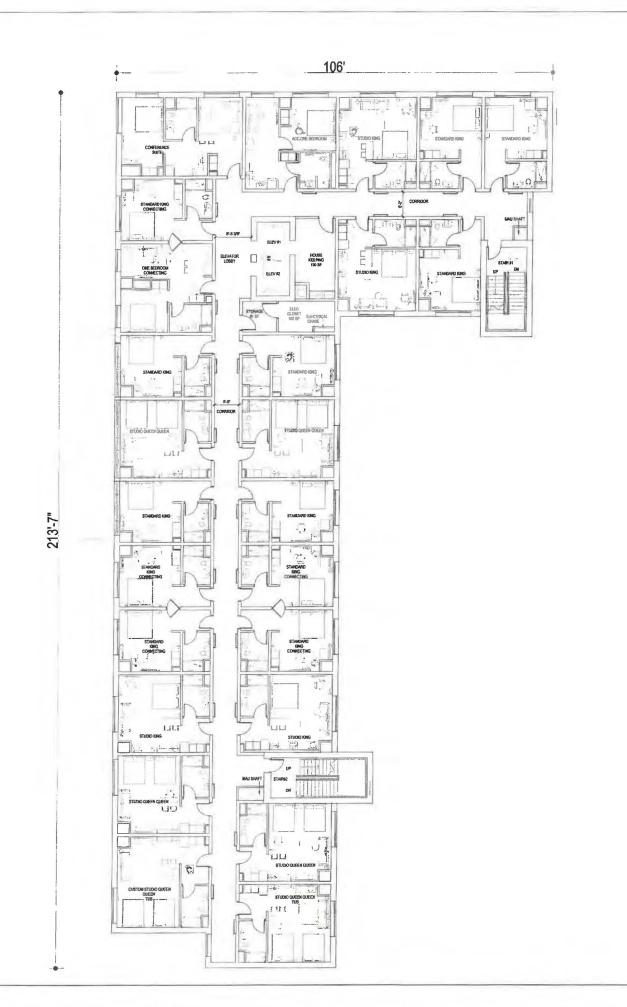

| | | | ROOM | MATRIX | | | | | | |
|-------------------------------|-----|-----|------|--------|-----|-----|-------|------|------|------------|
| ROOM TYPE | 1ST | 2ND | 3RD | 4TH | 5TH | 6TH | TOTAL | | % | NO. OF BED |
| STANDARD KING | 0 | 5 | 7 | 7 | 7 | 6 | 32 | 25% | | 32 |
| STANDARD KING ACC. | 0 | 0 | 0 | 0 | 0 | 1 | 1 | 1% | | 1 |
| STANDARD KING CONN. | 0 | 5 | 5 | 5 | 5 | 5 | 25 | 20% | | 25 |
| COMMONS KING A | 0 | 0 | 0 | 0 | 3 | 3 | 6 | 5% | 68% | 6 |
| COMMONS KING B | 0 | 0 | 0 | 0 | 0 | 1 | 1 | 1% | DQ76 | 1 |
| ACCESSIBLE COMMONS KING | 0 | 0 | 0 | 0 | 1 | 0 | 1 | 1% | | 1 |
| STUDIO KING | 0 | 3 | 4 | 4 | 4 | 4 | 19 | 15% | | 19 |
| STUDIO KING ACC. | 0 | 1 | 0 | 0 | 0 | 0 | 1 | 1% | | 1 |
| STUDIO QUEEN QUEEN SHOWER | 1 | 3 | 4 | 3 | 0 | 0 | 11 | 9% | | 22 |
| STUDIO QUEEN QUEEN TUB | 1 | 1 | 1 | 1 | 1 | 1 | 6 | 5% | | 12 |
| COSTUM STUDIO QUEEN QUEEN TUB | 1 | 1 | 1 | 1 | 1 | 1 | 6 | 5% | į . | 12 |
| ACC.STUDIO QUEEN QUEEN | 1 | 0 | 0 | 1 | 0 | 0 | 2 | 2% | | 4 |
| ONE BEDROOM | 0 | 1 | 0 | 1 | 1 | 1 | 4 | 3% | 32% | 4 |
| ONE BEDROOM CONN. | 0 | 1 | 1 | 1 | 1 | 1 | 5 | 4% | | 5 |
| ACC.ONE BERDROOM | 0 | 0 | 1 | 0 | 0 | 0 | 1 | 1% | | 1 |
| CONFERENCE SUITE | 0 | 0 | 1 | 1 | 1 | 1 | 4 | 3% | | 4 |
| ACC. CONFERENCE SUITE | 0 | 1 | 0 | 0 | 0 | 0 | 1 | 1% | | 1 |
| GRAND TOTAL | 4 | 22 | 25 | 25 | 25 | 25 | 126 | 100% | 100% | 151 |

| SHOWER FIXTURE TYPE MATRIX | | | | | | | | |
|----------------------------|-----|------|--|--|--|--|--|--|
| HOWER | 107 | 85% | | | | | | |
| UB | 12 | 10% | | | | | | |
| CC. TUB | 0 | 0% | | | | | | |
| CC. ROLL IN SHOWER | 2 | 296 | | | | | | |
| RANSFER SHOWER | 5 | 4% | | | | | | |
| OTAL | 126 | 100% | | | | | | |

| FLOOR AREA (S | iF) |
|----------------------|--------|
| 1ST LEVEL FLOOR PLAN | 15,224 |
| 2ND LEVEL FLOOR PLAN | 14,342 |
| 3RD LEVEL FLOOR PLAN | 14,342 |
| 4TH LEVEL FLOOR PLAN | 14,342 |
| 5TH LEVEL FLOOR PLAN | 14,342 |
| 6TH LEVEL FLOOR PLAN | 14,342 |
| 7TH LEVEL FLOOR PLAN | 4,298 |
| TOTAL | 91,232 |



Cool

Owne



ALLEN SIGMON REAL ESTATE GROUP 9201 MONTGOMERY BLVD, NE BLDG 1 ALBUQUERQUE, NM 87111



ELEMENT ALBUQUERQUE,NM

| NO. | ISSUE DATE | PROJECT STATU |
|-----|------------|---------------|
| | | |
| 137 | | |

 DATE
 2020.01.17

 DRAWN BY
 SG

 CHECKED BY
 DH

 SCALE
 AS NOTED

 PROJECT NO.
 B4 - 176 - 1901

SHEET NAME

FLOOR PLANS

DRAWING N

A2.3

THIRD FLOOR PLAN SCALE: 3/32"=1"-0"



| | | | ROOM | MATRIX | | | | | | |
|-------------------------------|-----|-----|------|--------|-----|-----|-------|------|------|-------------|
| ROOM TYPE | 15T | 2ND | 3RD | 4TH | 5TH | бТН | TOTAL | | % | NO. OF BEDS |
| STANDARD KING | 0 | 5 | 7 | 7 | 7 | 6 | 32 | 25% | | 32 |
| STANDARD KING ACC. | 0 | 0 | 0 | 0 | 0 | 1 | 1 | 1% | | 1 |
| STANDARD KING CONN. | 0 | 5 | 5 | 5 | 5 | 5 | 25 | 20% | 68% | 25 |
| COMMONS KING A | 0 | 0 | 0 | 0 | 3 | 3 | 6 | 5% | | 6 |
| COMMONS KING B | 0 | 0 | 0 | 0 | 0 | 1 | 1 | 1% | 0070 | 1 |
| ACCESSIBLE COMMONS KING | 0 | 0 | 0 | 0 | 1 | 0 | 1 | 1% | | 1 |
| STUDIO KING | 0 | 3 | 4 | 4 | 4 | 4 | 19 | 15% | | 19 |
| STUDIO KING ACC. | 0 | 1 | 0 | 0 | 0 | 0 | 1 | 1% | 1 | 1 |
| STUDIO QUEEN QUEEN SHOWER | 1 | 3 | 4 | 3 | 0 | 0 | 11 | 9% | | 22 |
| STUDIO QUEEN QUEEN TUB | 1 | 1 | 1 | 1 | 1 | 1 | 6 | 5% | | 12 |
| COSTUM STUDIO QUEEN QUEEN TUB | 1 | 1 | 1 | 1 | 1 | 1 | 6 | 5% | | 12 |
| ACC.STUDIO QUEEN QUEEN | 1 | 0 | 0 | 1 | 0 | 0 | 2 | 2% | | 4 |
| ONE BEDROOM | 0 | 1 | 0 | 1 | 1 | 1 | 4 | 3% | 32% | 4 |
| ONE BEDROOM CONN. | 0 | 1 | 1 | 1 | 1 | 1 | 5 | 4% | | 5 |
| ACC.ONE BERDROOM | D | 0 | 1 | 0 | 0 | 0 | 1 | 1% | | 1 |
| CONFERENCE SUITE | 0 | 0 | 1 | 1 | 1 | 1 | 4 | 3% | | 4 |
| ACC. CONFERENCE SUITE | 0 | 1 | 0 | 0 | 0 | 0 | 1 | 1% | | 1 |
| GRAND TOTAL | 4 | 22 | 25 | 25 | 25 | 25 | 126 | 100% | 100% | 151 |

| SHOWER FIXTURE TYPE MATRIX | | | FLOOR AREA (SF) | | |
|----------------------------|-----|------|----------------------|--------|--|
| SHOWER | 107 | 85% | 1ST LEVEL FLOOR PLAN | 15,224 | |
| TUB | 12 | 10% | 2ND LEVEL FLOOR PLAN | 14,342 | |
| ACC. TUB | 0 | 0% | 3RD LEVEL FLOOR PLAN | 14,342 | |
| ACC. ROLL IN SHOWER | 2 | 2% | 4TH LEVEL FLOOR PLAN | 14,342 | |
| TRANSFER SHOWER | 5 | 4% | 5TH LEVEL FLOOR PLAN | 14,342 | |
| TOTAL | 126 | 100% | 6TH LEVEL FLOOR PLAN | 14,342 | |
| | | | 7TH LEVEL FLOOR PLAN | 4,298 | |
| | | | TOTAL | 91,232 | |



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ALLEN SIGMON REAL ESTATE GROUP 9201 MONTGOMERY BLVD, NE BLDG 1 ALBUQUERQUE, NM 87111



ELEMENT ALBUQUERQUE,NM

| No. | ISSUE DATE | PROJECT STATUS | | | | | | |
|-----|------------|----------------|--|--|--|--|--|--|
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| | | | | | | | | |

 DATE
 2020.01.17

 DRAWN BY
 SG

 CHECKED BY
 DH

 SCALE
 AS NOTED

 PROJECT NO.
 B4 - 176 - 1901

SHEET NAME

FLOOR PLANS

A2.4



| | | | ROOM | MATRIX | | | | | | |
|-------------------------------|-----|-----|------|--------|------|-----|-------|------|------|-------------|
| ROOM TYPE | 1ST | 2ND | 3RD | 4TH | 511H | 6TH | TOTAL | | % | NO. OF BEDS |
| STANDARD KING | 0 | - 5 | 7 | 7 | 7 | 6 | 32 | 25% | | 32 |
| STANDARD KING ACC. | 0 | 0 | 0 | 0 | 0 | 1 | 1 | 1% | | 1 |
| STANDARD KING CONN. | 0 | 5 | 5 | 5 | . 5 | 5 | 25 | 20% | | 25 |
| COMMONS KING A | 0 | 0 | 0 | 0 | 3 | 3 | 6 | 5% | 68% | 6 |
| COMMONS KING B | 0 | 0 | 0 | 0 | 0 | 1 | 1 | 1% | | 1 |
| ACCESSIBLE COMMONS KING | 0 | 0 | 0 | 0 | 1 | 0 | 1 | 1% | | 1 |
| STUDIO KING | 0 | 3 | 4 | 4 | 4 | 4 | 19 | 15% | | 19 |
| STUDIO KING ACC. | 0 | 1 | 0 | 0 | . 0 | 0 | 1 | 1% | | 1 |
| STUDIO QUEEN QUEEN SHOWER | 1 | 3 | 4 | 3 | 0 | 0 | 11 | 9% | | 22 |
| STUDIO QUEEN QUEEN TUB | 1 | 1 | 1 | 1 | 1 | 1 | 6 | 5% | | 12 |
| COSTUM STUDIO QUEEN QUEEN TUB | 1 | 1 | 1 | 1 | 1 | 1 | 6 | 5% | | 12 |
| ACC.STUDIO QUEEN QUEEN | 1 | 0 | 0 | 1 | 0 | 0 | 2 | 2% | , | 4 |
| ONE BEDROOM | 0 | 1 | 0 | 1 | 1 | 1 | 4 | 3% | 32% | 4 |
| ONE BEDROOM CONN. | 0 | 1 | 1 | 1 | 1 | 1 | 5 | 4% | | 5 |
| ACC.ONE BERDROOM | 0 | 0 | 1 | 0 | 0 | 0 | 1 | 1% | | 1 |
| CONFERENCE SUITE | 0 | 0 | 1 | 1 | 1 | 1 | 4 | 3% | | 4 |
| ACC. CONFERENCE SUITE | 0 | 1 | 0 | 0 | 0 | 0 | 1 | 1% | | 1 |
| GRAND TOTAL | 4 | 22 | 25 | 25 | 25 | 25 | 126 | 100% | 100% | 151 |

| SHOWER FIXTUR | E TYPE MATRIX | FLOOR AREA (SF) | | | | | | |
|---------------------|---------------|-----------------|------------------------|--------|--|--|--|--|
| SHOWER | 107 | 85% | 1ST LEVEL FLOOR PLAN | | | | | |
| TUB | 12 | 10% | 2ND LEVEL FLOOR PLAN | | | | | |
| ACC. TUB | 0 | 0% | 3RD LEVEL FLOOR PLAN | | | | | |
| ACC. ROLL IN SHOWER | 2 | 2% | 4TH LEVEL FLOOR PLAN | | | | | |
| TRANSFER SHOWER | 5 | 4% | STH LEVEL FLOOR PLAN 1 | | | | | |
| TOTAL | 126 | 100% | 6TH LEVEL FLOOR PLAN | 14,34 | | | | |
| | | | 7TH LEVEL FLOOR PLAN | 4,298 | | | | |
| | | | TOTAL | 91,232 | | | | |





ALLEN SIGMON REAL ESTATE GROUP 9201 MONTGOMERY BLVD, NE BLDG 1 ALBUQUERQUE, NM 87111



ELEMENT ALBUQUERQUE,NM

DRAWN BY SG CHECKED BY DH AS NOTED SCALE PROJECT NO. B4 - 176 - 1901

SHEET NAME

FLOOR PLANS

A2.5

FIFTH FLOOR PLAN

SCALE: 3/32"=1'-0"



| | | | ROOM | MATRIX | | | | | | |
|-------------------------------|-----|-----|------|--------|-----|-----|-------|------|------|-------------|
| ROOM TYPE | 1ST | 2ND | 3RD | 4TH | 5TH | 6TH | TOTAL | | % | NO. OF BEDS |
| STANDARD KING | 0 | 5 | 7 | 7 | 7 | 6 | 32 | 25% | | 32 |
| STANDARD KING ACC. | 0 | D | 0 | 0 | 0 | 1 | 1 | 1% | | 1 |
| STANDARD KING CONN. | 0 | 5 | 5 | 5 | 5 | 5 | 25 | 20% | 1 | 25 |
| COMMONS KING A | 0 | 0 | 0 | 0 | 3 | 3 | 6 | 5% | 68% | 6 |
| COMMONS KING B | 0 | 0 | 0 | 0 | 0 | 1 | 1 | 1% | | 1 |
| ACCESSIBLE COMMONS KING | 0 | 0 | 0 | 0 | 1 | 0 | 1 | 1% | | 1 |
| STUDIO KING | 0 | 3 | 4 | 4 | 4 | 4 | 19 | 15% | | 19 |
| STUDIO KING ACC. | 0 | 1 | 0 | 0 | 0 | 0 | 1 | 1% | | 1 |
| STUDIO QUEEN QUEEN SHOWER | 1 | 3 | 4 | 3 | 0 | 0 | 11 | 9% | | 22 |
| STUDIO QUEEN QUEEN TUB | 1 | 1 | 1 | 1 | 1 | 1 | 6 | 5% | 1 | 12 |
| COSTUM STUDIO QUEEN QUEEN TUB | 1 | 1 | 1 | 1 | 1 | 1 | 6 | 5% | | 12 |
| ACC.STUDIO QUEEN QUEEN | 1 | 0 | 0 | 1 | 0 | 0 | 2 | 2% | - | 4 |
| ONE BEDROOM | 0 | 1 | 0 | 1 | 1 | 1 | 4 | 3% | 32% | 4 |
| ONE BEDROOM CONN. | 0 | 1 | 1 | 1 | 1 | 1 | 5 | 4% | | 5 |
| ACC.ONE BERDROOM | 0 | 0 | 1 | 0 | 0 | 0 | 1 | 1% | | 1 |
| CONFERENCE SUITE | 0 | 0 | 1 | 1 | 1 | 1 | 4 | 3% | | 4 |
| ACC, CONFERENCE SUITE | 0 | 1 | 0 | 0 | 0 | 0 | 1 | 1% | | 1 |
| GRAND TOTAL | 4 | 22 | 25 | 25 | 25 | 25 | 126 | 100% | 100% | 151 |

| SHOWER FIXTUR | E TYPE MATRIX | | FLOOR AREA (SF) | |
|---------------------|---------------|------|----------------------|--------|
| SHOWER | 107 | 85% | 1ST LEVEL FLOOR PLAN | 15,224 |
| TUB | 12 | 10% | 2ND LEVEL FLOOR PLAN | 14,342 |
| ACC. TUB | 0 | 0% | 3RD LEVEL FLOOR PLAN | 14,342 |
| ACC. ROLL IN SHOWER | 2 | 2% | 4TH LEVEL FLOOR PLAN | 14,342 |
| TRANSFER SHOWER | 5 | 4% | 5TH LEVEL FLOOR PLAN | 14,342 |
| TOTAL | 126 | 100% | 6TH LEVEL FLOOR PLAN | 14,342 |
| | | - | 7TH LEVEL FLOOR PLAN | 4,298 |
| | | | TOTAL | 01 222 |





ALLEN SIGMON REAL ESTATE GROUP 9201 MONTGOMERY BLVD, NE BLDG 1 ALBUQUERQUE, NM 87111



ELEMENT ALBUQUERQUE,NM

| ISSUE DATE | PROJECT STATUS |
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| | |
| | ISSUE DATE |

2020.01.17 DRAWN BY SG CHECKED BY AS NOTED SCALE

B4 - 176 - 1901

SHEET NAME

PROJECT NO.

FLOOR PLANS

A2.6

SIXTH FLOOR PLAN

| | | | | | ROOI | M MATRIX | | | | | |
|----|--|-------------------------------|----------------------------|-----|------|----------|---------------|-----------|--------------|---------|-------------|
| | 4001 | ROOM TYPE | 1ST | 2ND | 3RD | 4TH | STH | 6TH | TOTAL | % | NO. OF BEDS |
| | 106' | STANDARD KING | 0 | 5 | 7 | 7 | 7 | 6 | 32 | 25% | 32 |
| | | STANDARD KING ACC. | 0 | 0 | 0 | 0 | 0 | 1 | 1 | 1% | 1 |
| | | STANDARD KING CONN. | 0 | 5 | 5 | 5 | 5 | 5 | 25 | 20% | 25 |
| | | COMMONS KING A | 0 | 0 | 0 | 0 | 3 | 3 | 6 | 5% | 8% 6 |
| | | COMMONS KING B | 0 | 0 | 0 | 0 | 0 | 1 | 1 | 1% | 1 |
| | | ACCESSIBLE COMMONS KING | 0 | 0 | 0 | 0 | 1 | 0 | 1 | 1% | 1 |
| • | No. of the state o | STUDIO KING | 0 | 3 | 4 | 4 | 4 | 4 | 19 | 15% | 19 |
| 1 | Outnodes labor troe | STUDIO KING ACC. | 0 | 1 | 0 | 0 | 0 | 0 | 1 | 1% | 1 |
| | 4000 | STUDIO QUEEN QUEEN SHOWER | 1 | 3 | 4 | 3 | 0 | 0 | 11 | 9% | 22 |
| | | STUDIO QUEEN QUEEN TUB | 1 | 1 | 1 | 1 | 1 | 1 | 6 | 5% | 12 |
| | | COSTUM STUDIO QUEEN QUEEN TUB | 1 | 1 | 1 | 1 | 1 | 1 | 6 | 5% | 12 |
| | | ACC.STUDIO QUEEN QUEEN | 1 | 0 | 0 | 1 | 0 | 0 | 2 | 2% | 4 |
| | HEATTOPS COMM. | ONE BEDROOM | 0 | 1 | 0 | 1 | 1 | 1 | 4 | 3% 3: | 2% 4 |
| | BOOTH SACTIVEO BOOTH SACTIVE BOOTH SACTIVE BOOTH BOOTH SACTIVE BOOTH SACTIVE BOOTH BOOTH SACTIVE BOOTH BOOTH BOOTH BOOTH BOOTH | ONE BEDROOM CONN. | 0 | 1 | 1 | 1 | 1 | 1 | 5 | 4% | 5 |
| | 3000 SF FRE FLACE | ACC.ONE BERDROOM | 0 | 0 | 1 | 0 | 0 | 0 | 1 | 1% | 1 |
| | MONTOPE HIGHTOPE | CONFERENCE SUITE | 0 | 0 | 1 | 1 | 1 | 1 | 4 | 3% | 4 |
| | | ACC. CONFERENCE SUITE | 0 | 1 | 0 | 0 | 0 | 0 | 1 | 1% | 1 |
| | BAC SAC | GRAND TOTAL | 4 | 22, | 25 | 25 | 25 | 25 | 126 | 100% 10 | 00% 151 |
| | 100, 100.5 | | SHOWER FIXTURE TYPE MATRIX | | 1 | | FLOOR AREA (5 | SF) | | | |
| D. | for the second | | SHOWER | | | 107 | 85 | 1ST LEV | VEL FLOOR P | | 15,224 |
| | . Add | | TUB | | | 12 | 309 | 2ND LE | EVEL FLOOR F | LAN | 14,342 |
| | PREPLACE | | ACC. TUB | | | 0 | 01 | | EVEL FLOOR P | | 14,342 |
| 1 | | | ACC. ROLL IN SHO | WER | | 2 | 25 | 6 4TH LEY | VEL FLOOR P | LAN | 14,342 |
| | STORAGE FOOH | | TRANSFER SHOWE | | | 5 | 49 | | VEL FLOOR P | | 14,342 |
| (| STAINES | | TOTAL | | | 126 | 1009 | 6TH LEV | VEL FLOOR P | LAN | 14,342 |
| | MONNAG : | | | | | | | | | | |

| ROOM TYPE | 1ST | 2ND | 3RD | 4114 | STH | 6TH | TOTAL | | % | NO. OF BEDS |
|-------------------------------|-----|-----|-----|------|-----|-----|-------|------|------|-------------|
| STANDARD KING | 0 | 5 | 7 | 7 | 7 | 6 | 32 | 25% | | 32 |
| STANDARD KING ACC. | 0 | 0 | 0 | 0 | 0 | 1 | 1 | 1% | | 1 |
| STANDARD KING CONN. | 0 | 5 | 5 | 5 | 5 | 5 | 25 | 20% | | 25 |
| COMMONS KING A | 0 | 0 | 0 | 0 | 3 | 3 | 6 | 5% | 68% | 6 |
| COMMONS KING B | 0 | 0 | 0 | 0 | 0 | 1 | 1 | 1% | 00% | 1 |
| ACCESSIBLE COMMONS KING | 0 | 0 | 0 | 0 | 1 | 0 | 1 | 1% | | 1 |
| STUDIO KING | 0 | 3 | 4 | 4 | 4 | 4 | 19 | 15% | | 19 |
| STUDIO KING ACC. | 0 | 1 | 0 | 0 | 0 | 0 | 1 | 1% | | 1 |
| STUDIO QUEEN QUEEN SHOWER | 1 | 3 | 4 | 3 | 0 | 0 | 11 | 9% | | 22 |
| STUDIO QUEEN QUEEN TUB | 1 | 1 | 1 | 1 | 1 | 1 | 6 | 5% | | 12 |
| COSTUM STUDIO QUEEN QUEEN TUB | 1 | 1 | 1 | 1 | 1 | 1 | 6 | 5% | | 12 |
| ACC.STUDIO QUEEN QUEEN | 1 | 0 | 0 | 1 | 0 | 0 | 2 | 2% | | 4 |
| ONE BEDROOM | 0 | 1 | 0 | 1 | 1 | 1 | 4 | 3% | 32% | 4 |
| ONE BEDROOM CONN. | 0 | 1 | 1 | 1 | 1 | 1 | 5 | 4% | | 5 |
| ACC.ONE BERDROOM | 0 | 0 | 1 | 0 | 0 | 0 | 1 | 1% | | 1 |
| CONFERENCE SUITE | 0 | 0 | 1 | 1 | 1 | 1 | 4 | 3% | | 4 |
| ACC, CONFERENCE SUITE | 0 | 1 | 0 | 0 | 0 | 0 | 1 | 1% | | 1 |
| GRAND TOTAL | 4 | 22 | 25 | 25 | 25 | 25 | 126 | 100% | 100% | 151 |

| SHOWER FIXTURE | FLOOR | | |
|----------------|-------|------|----------------------|
| /ER | 107 | 85% | 1ST LEVEL FLOOR PLAN |
| | 12 | 10% | 2ND LEVEL FLOOR PLAN |
| UB | 0 | 0% | 3RD LEVEL FLOOR PLAN |
| OLL IN SHOWER | 2 | 2% | 4TH LEVEL FLOOR PLAN |
| SFER SHOWER | 5 | 496 | 5TH LEVEL FLOOR PLAN |
| | 126 | 100% | 6TH LEVEL FLOOR PLAN |
| | | | THIEVEL FLOOR PLAN |





ALLEN SIGMON REAL ESTATE GROUP 9201 MONTGOMERY BLVD, NE BLDG 1 ALBUQUERQUE, NM 87111




ELEMENT ALBUQUERQUE,NM

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DATE 2020.01.17 DRAWN BY SG CHECKED BY DH SCALE AS NOTED PROJECT NO. B4 - 176 - 1901

SHEET NAME

FLOOR PLAN

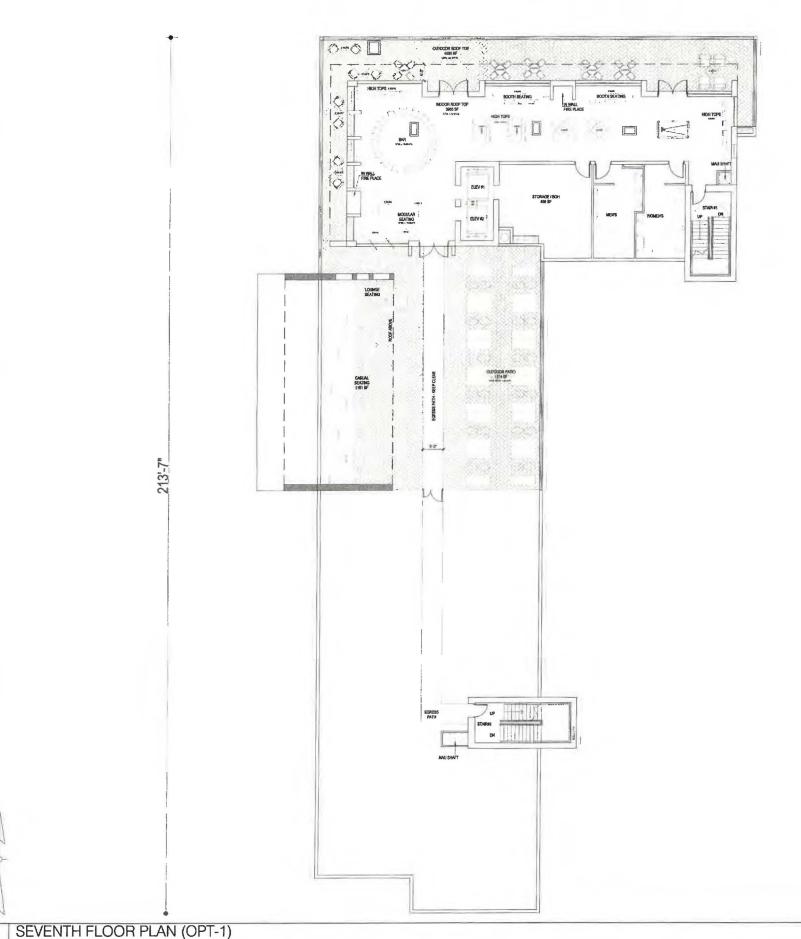

SCALE: 3/32"=1'-0"



| | | ND-EX | TERIOR ES | |
|------|---------------------------|-------|---|------------|
| CODE | MTL-TYPE | COLOR | MATERIAL NAME | MATERIAL % |
| 01 | EIFS-DRYVIT | | ELEM-01-2736-WHITE | 31 % |
| 02 | EIFS-DRYVIT | | ELEM-02-1022-DARK GREY | 36 % |
| 03 | EIFS-DRYVIT | | ELEM-03-1022-GREEN | 0 % |
| 04 | ALCOA- BUILDING PANELS | | COLORWELD 500XL-BRIGHT SILVER METALLIC | 21 % |
| 05 | ALCOA- BUILDING PANELS | 中国 | WOOD FINISH SCOTISH QAK (D 8115 MR) | 12 % |
| 06 | ALCOA- BUILDING PANELS | 14 | WOOD FINISH ITALIAN WALNUT | 1276 |
| | | | TOTAL | 100% |



Seal

Owner:



ALLEN SIGMON REAL ESTATE GROUP 9201 MONTGOMERY BLVD, NE BLDG 1 ALBUQUERQUE, NM 87111



ELEMENT ALBUQUERQUE,NM

| No. | ISSUE DATE | PROJECT STATUS |
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 DATE
 2020.01.17

 DRAWN BY
 SG

 CHECKED BY
 DH

 SCALE
 AS NOTED

 PROJECT NO.
 B4 - 176 - 1901

SHEET NAME

ELEVATIONS

DRAWING NO.

A3.1







| | | ND-EX | TERIOR ES | |
|------|---------------------------|-------|---|------------|
| CODE | MTL-TYPE | COLOR | MATERIAL NAME | MATERIAL 9 |
| 01 | EIFS-DRYVIT | | ELEM-01-2738-WHITE | 50 % |
| 02 | EIFS-DRYVIT | | ELEM-02-1022-DARK GREY | 9 % |
| 03 | EIFS-DRYVIT | | ELEM-03-1022-GREEN | 0% |
| 04 | ALCOA- BUILDING PANELS | E P | COLORWELD 500XL-BRIGHT SILVER METALLIC | 9 % |
| 05 | ALCOA- BUILDING PANELS | | WOOD FINISH SCOTISH OAK (D 8115 MR) | 22.04 |
| 06 | ALCOA- BUILDING PANELS | | WOOD FINISH ITALIAN WALNUT | 23 % |
| | | | TOTAL | 100% |

LEGEND-EXTERIOR FINISHES

MATERIAL NAME

ELEM-02-1022-DARK GREY

COLORWELD 500XL-BRIGHT SILVER METALLIC

WOOD FINISH SCOTISH OAK (D 8115 MR)

TOTAL

WOOD FINISH ITALIAN WALNUT

ELEM-01-2738-WHITE

ELEM-03-1022-GREEN

MATERIAL %

61 %

24 %

0 %

1 %

14 %

100%

CODE MTL-TYPE

01 EIFS-DRYVIT

02 EIFS-DRYVIT

03 EIFS-DRYVIT

04 ALCOA-BUILDING PANELS

05 ALCOA-BUILDING PANELS



BASE4 2901 CLINT MOORE ROAD #114 BOCA RATON, FLORIDA 33496 www.base-4.com



ALLEN SIGMON REAL ESTATE GROUP 9201 MONTGOMERY BLVD, NE BLDG 1 ALBUQUERQUE, NM 87111



ELEMENT ALBUQUERQUE,NM

| No. | ISSUE DATE | PROJECT STATUS |
|-----|------------|-----------------|
| DAT | E | 2020.01.17 |
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| SCA | VLE . | AS NOTED |
| PRO | NECT NO. | B4 - 176 - 1901 |
| SHE | ET NAME | |

ELEVATIONS

4 SOUTH ELEVATION SCALE: 3/32"=1"-0"



| | 2 | ROOF TOP +67-3 1/2 4 | 06 ALCOA- BUILDING PANE |
|--|---|--------------------------|----------------------------|
| | | SIXTH FLOOR +56'-9' | |
| | | FIFTH FLOOR . +46°-21/2" | |
| | | FOURTH FLOOR +95'-8" | |
| | | THIRD FLOOR +25-11/2* | |
| | | SECOND FLOOR +14-7* | |
| | | | |
| | | ₽ | |

3

NOTICE TO CONTRACTORS

1. AN EXCAVATION/CONSTRUCTION PERMIT WILL BE REQUIRED BEFORE BEGINNING ANY WORK WITHIN BERNALILLO COUNTY ROW. AN APPROVED COPY OF THESE PLANS MUST BE SUBMITTED AT THE TIME OF APPLICATION FOR THIS PERMIT.

2. ALL WORK DETAILED ON THESE PLANS TO BE PERFORMED, EXCEPT AS OTHERWISE 2. ALL WORN DELIBER ON THESE POWNS I DE PERFORMED, SOCIETY BY CHEMINES STATED OR PROVIDED HEREON, SHALL BE CONSTRUCTED IN ACCORDANCE WITH NEW MEXICO STANDARD SPECIFICATIONS FOR PUBLIC WORKS CONSTRUCTION, MOST RECENT EDITION.

3, TWO WORKING DAYS PRIOR TO ANY EXCAVATION, CONTRACTOR MUST CONTACT LINE LOCATING SERVICE, 260-1990, FOR LOCATION OF EXISTING UTILITIES.

4. PRIOR TO CONSTRUCTION, THE CONTRACTOR SHALL EXCAVATE AND VERIFY THE HORIZONTAL AND VERTICAL LOCATIONS OF ALL PERTINENT EXISTING UTILITIES, AND/OR OBSTRUCTIONS, SHOULD A CONFLICT EXIST, THE CONTRACTOR SHALL NOTIFY THE ENGINEER SO THAT THE CONFLICT CAN BE RESOLVED WITH A MINIMUM AMOUNT OF DELAY.

5. BACKFILL COMPACTION SHALL BE ACCORDING TO ARTERIAL STREET USE.

6. MAINTENANCE OF THESE FACILITIES SHALL BE THE RESPONSIBILITY OF THE OWNER OF THE PROPERTY SERVED.

7. WORK ON ARTERIAL STREETS SHALL BE PERFORMED ON A 24-HOUR BASIS.

8. CONTRACTOR SHALL DETERMINE LOCATION OF ANY UNDERGROUND FACILITY IN OR NEAR WORK AREAS, INCLUDING REQUESTS TO OWNERS/OPERATORS OF SAID FACILITIES PER SECTION 82-14-5 NMSA 1978.

9. CONTRACTOR SHALL PLAN ALL EXCAVATION TO MINIMIZE INTERFERENCE OR DAMAGE OF UNDERGROUND FACILITIES.

10. CONTRACTOR SHALL PROVIDE ADVANCE TELEPHONE NOTICE OF COMMENCEMENT, EXTENT 10, CONTRACTOR SHALL PROVIDE ADVANCE TELEPHONE NOTICE OF COMMENCEMENT, EXTENT AND DURATION OF ALL EXCAVATION WORK TO THE ONE-CALL NOTIFICATION SYSTEM, OR TO OWNERS/OPERATORS OF ANY EXISTING UNDERGROUND FACILITY IN OR NEAR THE EXCAVATION AREA THAT ARE NOT MEMBERS OF THE ONE-CALL NOTIFICATION CENTER, IN ORDER THAT OWNERS/OPERATORS MAY LOCATE AND MARK UNDERGROUND FACILITY PER SECTION 82-14-5 NIMSA 1978 PRIOR TO ANY COMMENCEMENT OF WORK. CONTRACTOR SHALL REQUEST REAFFIRMATION OF LOCATION EVERY TEN (10) WORKING DAYS AFTER INITIAL REQUEST

NEUDEST.

11. CONTRACTOR SHALL MAINTAIN EIGHTEEN (18) INCHES BETWEEN EXISTING UNDERGROUND FACILITIES THAT HAVE BEEN PREVIOUSLY IDENTIFIED AND MARKED BY THE OWNERS/OPERATORS OF SAID FACILITIES. CUTTING EDGE OR POINT OF ANY MECHANICAL EXCAVATION AREA WILL BE USED IN A MANNER NECESSARY TO PREVENT DAMAGE TO EXISTING UNDERGROUND FACILITIES.

12. CONTRACTOR SHALL PROVIDE SUPPORT FOR EXISTING UNDERGROUND FACILITIES IN OR NEAR EXCAVATION AREA AS NECESSARY TO PREVENT DAMAGE TO SAID FACILITIES.

13. CONTRACTOR SHALL BACKFILL ALL EXCAVATIONS IN A MANNER AND WITH MATERIALS AS MAY BE NECESSARY TO PREVENT DAMAGE TO AND PROVIDE RELIABLE SUPPORT DURING AND FOLLOWING BACK FILLING ACTIVITIES FOR PREEXISTING UNDERGROUND FACILITIES IN OR NEAF EXCAVATION AREA.

14. CONTRACTOR SHALL IMMEDIATELY NOTIFY BY TELEPHONE THE OWNER/OPERATOR OF ANY UNDERGROUND FACILITY WHICH MAY HAVE BEEN DAMAGED OR DISLODGED DURING EXCAVATION WORK.

15. CONTRACTOR SHALL NOT MOVE OR OBLITERATE MARKINGS MADE PURSUANT TO CHAPTER 82, ARTICLE 14 NMSA 1978, OR FABRICATE MARKINGS IN A UNMARKED LOCATION FOR THE PURPOSE OF CONCELLING OR AVOIDING LIABILITY FOR VIOLATION OF OR NONCOMPLIANCE WITH THE PROVISIONS OF CHAPTER 62, ARTICLE 11 NMSA 1978.

18. ELECTRONIC MARKER SPHERES (EMS) SHALL BE INSTALLED ON WATER LINE AND SANITARY SEWER LINE FACILITIES PER SECTION 170 OF THE BERNAULLO COUNTY STANDARD SPECIFICATIONS 1986 EDITION AS REVISED THROUGH UPDATE #8.

17. THE CONTRACTOR SHALL COORDINATE WITH THE WATER UTILITY AUTHORITY SEVEN (7) DAYS IN ADVANCE OF PERFORMING WORK THAT WILL AFFECT THE PUBLIC WATER OR SANTARY SEWER INFRASTRUCTURE. WORK REQUIRING SHUTOFF OF FACILITIES DESIGNATED AS MASTER PLAN FACILITIES MUST BE COORDINATED WITH THE WATER AUTHORITY 14 DAYS IN ADVANCE OF PERFORMING SUCH WORK, ONLY WATER AUTHORITY CREWS ARE AUTHORIZED TO OPERATE PUBLIC VALVES.

18, ALL EXCAVATION, TRENCHING, AND SHORING ACTIVITIES MUST BE CARRIED-OUT IN ACCORDANCE WITH OSHA 29 CFR 1926.6150 SUBPART P.

19. ALL IMPACTED STRIPING SHALL BE REPLACED BY CONTRACTOR.


20. MANHOLE STEPS SHALL NOT BE INSTALLED IN SANITARY SEWER MANHOLES.

21. ALL WATER METERS SHALL INCLUDE DUAL CHECK VALVE SETTERS. 22, ALL WATER METER COVERS AND LIDS SHALL BE PER TOWN OF BERNALILLO STANDARDS.

23. ALL MANHOLES AND VALVES SHALL HAVE GPS INFORMATION RECORDED AS PART OF AS BUILT PLAN SET.

24. CONTRACTOR SHALL VERIFY ALL EXISTING CONNECTIONS PRIOR TO CONSTRUCTION. CONTRACTOR SHALL NOTIFY ENGINEER OF THE HORIZONTAL AND VERTICAL LOCATION PRIOR TO CONSTRUCTION.

EXISTING UTILITIES ARE NOT SHOWN.
IT SHALL BE THE SOLE RESPONSIBILITY
OF THE CONTRACTOR TO CONDUCT ALL
NECESSARY FIELD INVESTIGATIONS PRIOR TO ANY EXCAVATION TO DETERMINE THE ACTUAL LOCATION OF UTILITIES & OTHER

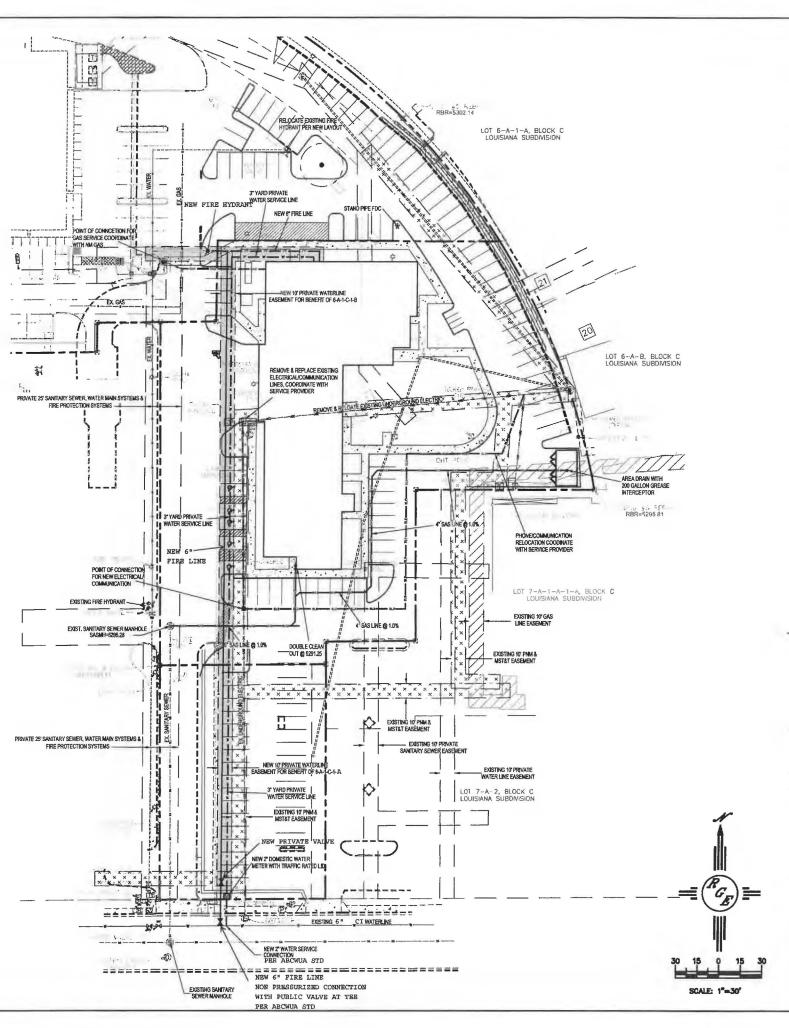



THE CONTRACTOR SHALL COORDINATE WITH THE WATER UTILITY AUTHORITY SEVEN (7) DAYS IN ADVANCE OF PERFORMING WORK THAT WILL AFFECT THE PUBLIC WATER OR SANITARY SEWER IN PREASTRUCTURE. WORK REQUIRING SHUTOFF OF FACILITIES DESIGNATED AS MASTER PLAN FACILITIES MUST BE COORDINATED WITH THE WATER AUTHORITY 16 DAYS IN ADVANCE OF PERFORMING SUCH WORK. ONLY WATER AUTHORITY CREWS ARE AUTHORIZED TO OPERATE PUBLIC VALVES.

LEGEND

MULLP

VICINITY MAP: H-19-Z

| | BOUNDARY | CB = CURB BPOND = BOTTOM OF POND |
|---------------|-------------------------------------|---|
| | ADJACENT BOUNDARY | DRN = DRAIN EC = EDGE OF CONCRETE FF = FINISHED FLOOR |
| | EXISTING CURB AND GUTTER | FL = FLOW LINE G = GROUND |
| SS | EXISTING SANITARY SEWER | N&D = NAIL & DISC RMP = RAMP |
| w | EXISTING WATER LINE | SASMH = SANITARY SEWER MANH |
| c c | PROPOSED SANITARY SEWER | ⊅ = LIGHT POLE □ = CABLE BOX □ = IRRIGATION BOX |
| - SAS | PROPOSED SANITARY SEWER | M = WATER VALVE |
| —BLE | PROPOSED ELECTRIC LINE | = WATER METÉR = SANITARY SEWER MANHOLE |
| — FP —— FP —— | PROPOSED FIRE PROTECTION LINE | STORM DRAIN MANHOLE |
| - w — w — | PROPOSED WATER LINE | ELECTRIC MANHOLE PHONE MANHOLE |
| - GAS GAS | PROPOSED GAS LINE | |
| | PROPOSED 10' PRIVATE WATER EASEMENT | |



DAVID SOULE P.E. #14522

2440 LOUISIANA BLVD.

UTILITY PLAN


DATE 10-24-19 LOUISIANA BLVO.DW

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Rio Grando Engineering

SHEET# JOB#



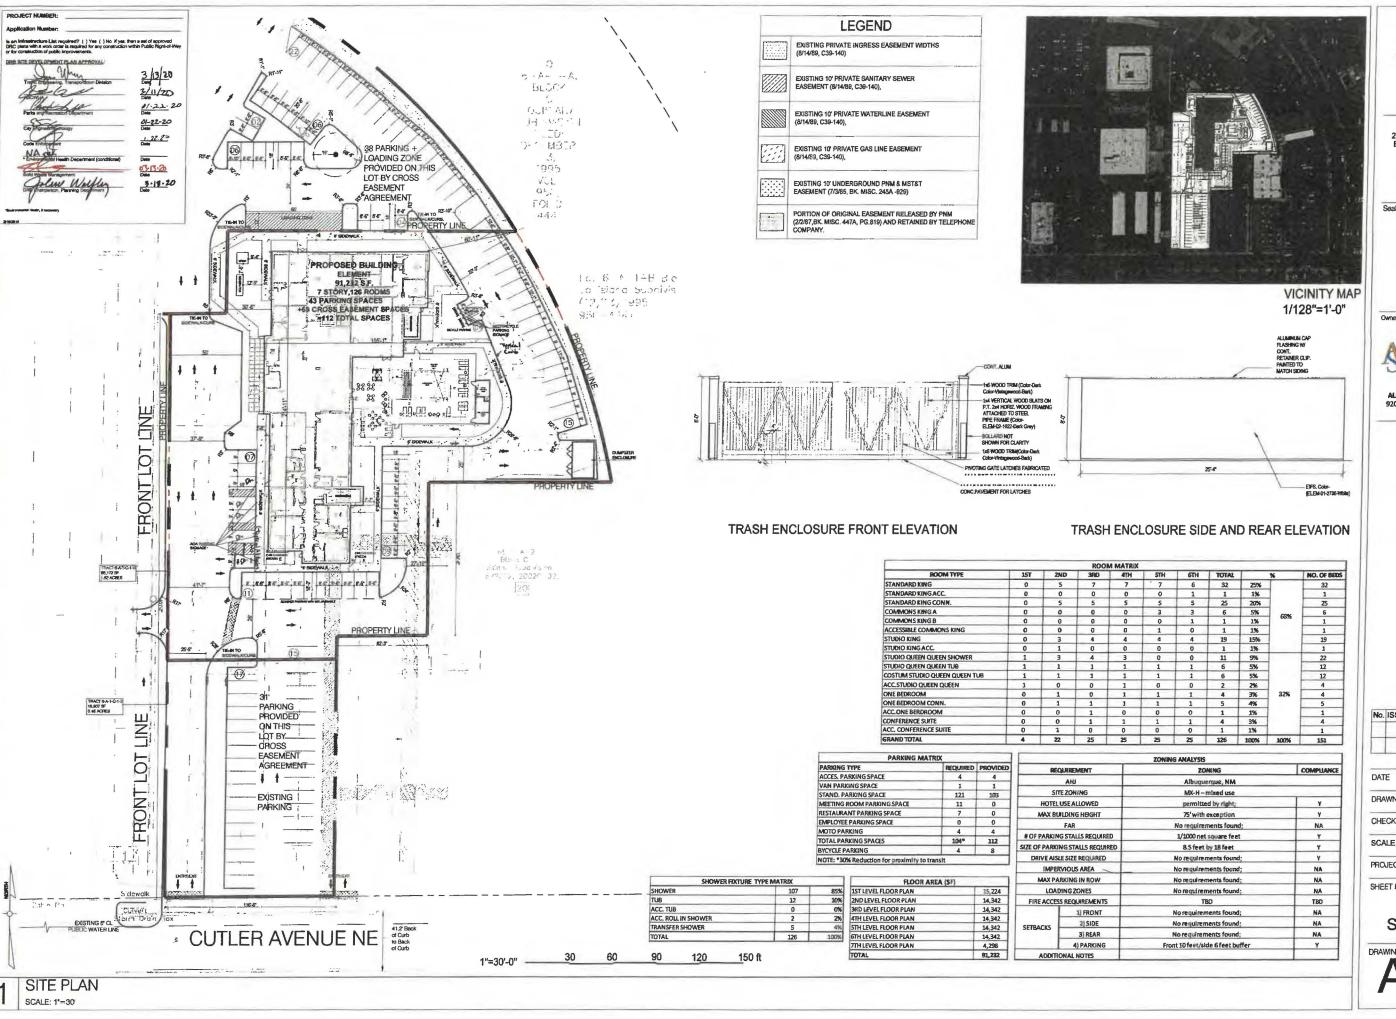

ALLEN SIGMON REAL ESTATE GROUP 9201 MONTGOMERY BLVD, NE BLDG 1 ALBUQUERQUE, NM 87111



ELEMENT ALBUQUERQUE,NM


No. ISSUE DATE | PROJECT STATUS

2020.01.17 DRAWN BY SG CHECKED BY DH AS NOTED SCALE PROJECT NO. B4 - 176 - 1901

SHEET NAME

SITE PLAN

DRAWING NO.

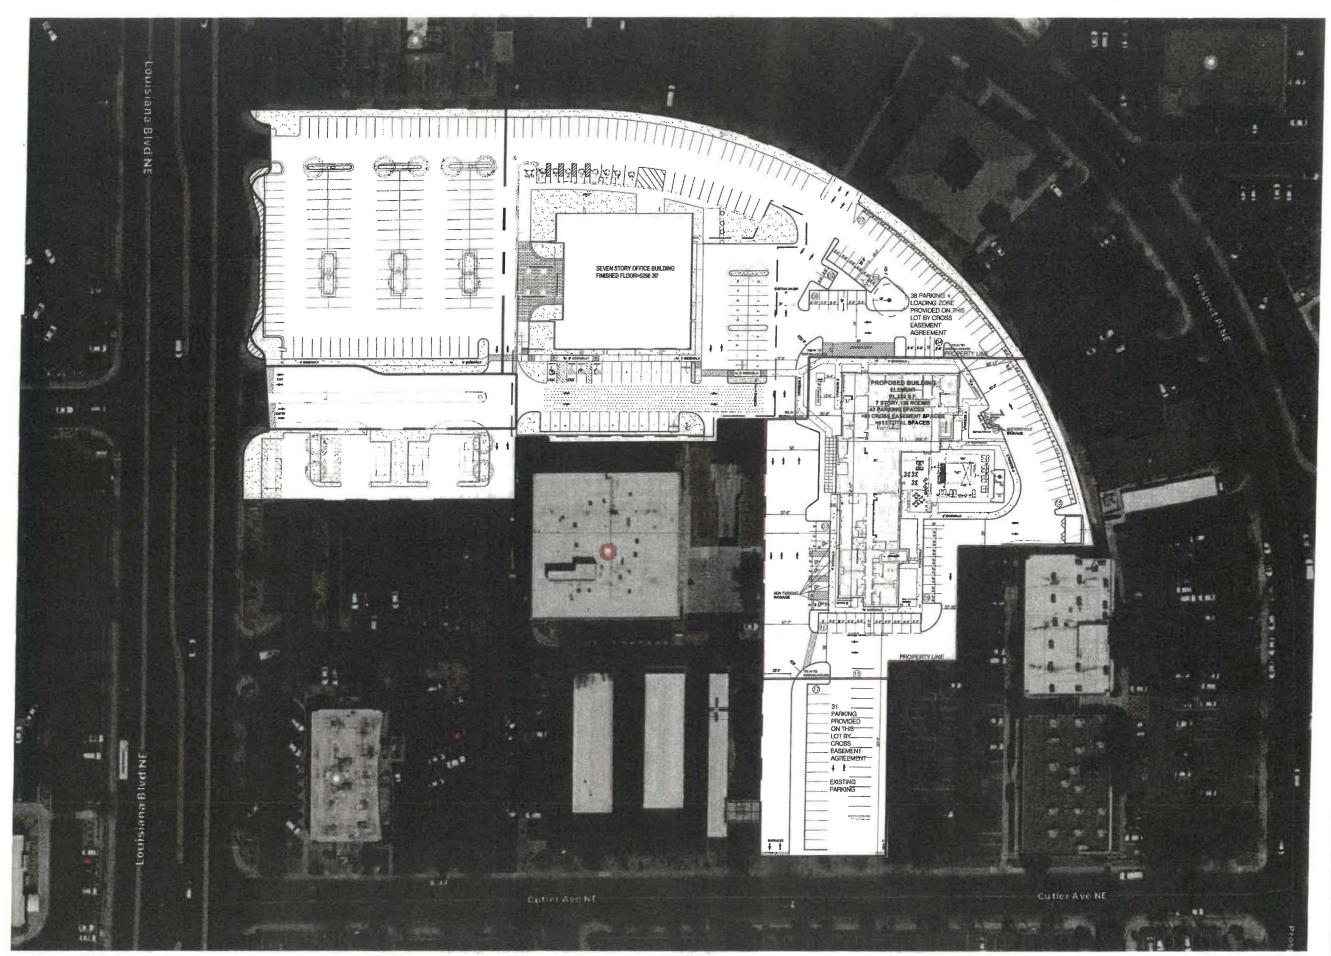





ALLEN SIGMON REAL ESTATE GROUP 9201 MONTGOMERY BLVD, NE BLDG 1 ALBUQUERQUE, NM 87111



ELEMENT ALBUQUERQUE,NM


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DATE 2020.01.17 DRAWN BY SG CHECKED BY DH SCALE AS NOTED PROJECT NO. B4 - 176 - 1901

SHEET NAME

MASTER PLAN

PRAWING NO.

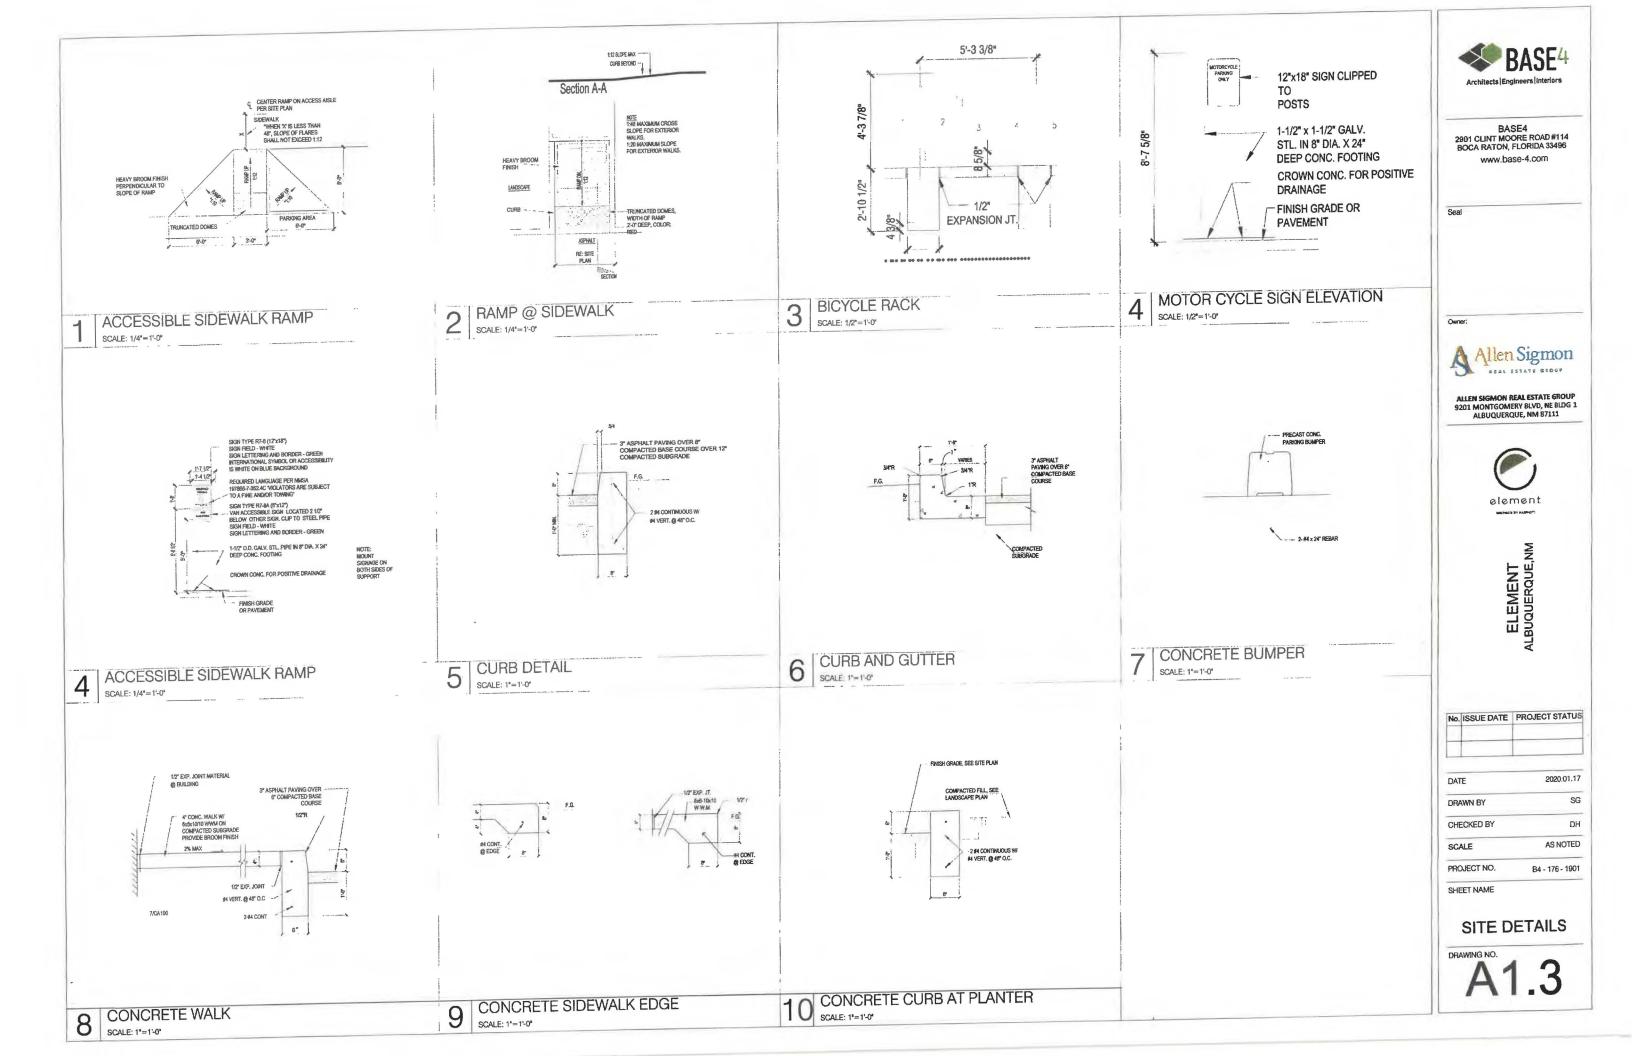

GENERAL NOTES

- COORDINATION: ALL ELECTRICAL WORK SHALL BE COORDINATE THROUGH THE DESIGNBUILD CONTRACTOR
- CODE COMPLIANCE: ALL ELECTRICAL WORK SHALL COMPLY WITH OR SURPASS THE REQUIREMENTS OF THE NATIONAL ELECTRICAL CODE, NPPA 70, AND THE LATEST EDITION OF NESC. ALL WORK SHALL COMPLY WITH ALL APPLICABLE SERMING POWER AND COMMUNICATION UTILITIES' CODES, ORDINANCES, RILLES AND REGULATION
- MEET ALL REQUIREMENTS: ALL WORK SHALL MEET THE REQUIREMENTS OF THE AFORE MENTIONED CODES AND ALL CODES AND STANDARDS REFERENCED IN THE SPECIFICATION, ALTHOUGH THE DETAILS OF SUCH WORK MAY NOT BE SHOWN ON THE GS OR REFERENCED IN THE SPECIFICATIONS
- CONFLICTS: CONFLICTS BETWEEN THE APPLICABLE CODES, STANDARDS AND THE PLANS AND SPECIFICATION MUST BE BROUGHT TO THE ATTENTION OF THE DESIGN, BUILD CONTRACTOR, PRIOR TO PROCEEDING WITH THE WORK IN QUESTION.
- CONFLICTING STANDARDS: IN THE CASE OF CONFLICT BETWEEN THE CONTRACTOR DOCUMENTS AND A GOVERNING CODE OF ORDINANCE, THE MORE STRINGENT
- ACCEPTANCE OF CONDITIONS: INITIATING WORK CONSTITUTES SUBCONTRACTOR ACCEPTANCE OF THE EXISTING CONDITION ASSOCIATED WITH THE WORK IN QUESTION.
- TRADE LICENSE: THE ELECTRICAL SUBCONTRACTOR SHALL BE CURRENTLY LICENSED TO PERFORM THIS WORK WITHIN THE JURISDICTION HAWNG AUTHORTY. ALL REQUIRED LICENSING SHALL BE MAINTAINED THROUGHOUT THE UDRATION OF THE WORK.
- I. SAFE: THE ELECTRICAL SUBCONTRACTOR IS RESPONSIBLE FOR OVERSEEING THE SAFE OPERATION OF ALL EQUIPMENT IN HIS USE. THE ELECTRICAL SUBCONTRACTOR IS RESPONSIBLE FOR MAINTAINING ALL OF THE EQUIPMENT IN HIS USE IN A SAFE CONDITION. KEEP DEAD FRONT EQUIPMENT IN PLACE WHEN EQUIPMENT IS ENERGIZED. CONDUCT ALL CONSTRUCTION OPERATION IN A SAFE MANNER FOR EMPLOYEES. AS WELL AS OTHER WORK PERSONS OR ANYONE VISITING THE JOB SITE. PROVIDE BARBIERS, FLAGS, TAPE, ETC. AS REQUIRED FOR SAFETY.
 ALL ELECTRICANS MUST PERFORM THIER WORK IN ACCORDANCE TO THE GUIDELINES SET FORTH BY THE NFPA 70E.
- 1. PROFESSIONALISM AND APPEARANCE OF WORK WORKMANSHIP OF ALL INSTALLATION SHALL BE IN ACCORDANCE WITH ACCEPTED PRACTICES OF THIS TRADE, INSTALLATION METHODS SHALL COMPORM TO MANUFACTURES SPECIFICATION. THE SUBCONTRACTOR TRADE FOR THE DURATION OF THE JOB WITH QUALIFIED JOURNEYMEN AND EMPLOYEES IN THIS TO COMMUNICATE WITH AND KEEP THE DESIGNABULD CONTRACTOR APPRAISED OF CHANGES OR CLARRICCATIONS.
- WORKMANSHIP: ALL ELECTRICAL EQUIPMENT SHALL BE INSTALLED IN A NEAT, DURABLE.
- STORAGE AND EQUIPMENT STORAGE OF EQUIPMENT FOR THE JOB IS THE RESPONSIBILITY OF THE ELECTRICAL SUBCONTRACTOR AND SHALL BE SOCIEDULED FOR DELIVERY TO THE STIE AS THE EQUIPMENT IS REQUIRED, DAWAGE TO THE EQUIPMENT DELIVERED TO THE SITE OR IN TRANSPORT TO THE JOB SHALL BE THE RESPONSIBILITY THE ELECTRICAL SUBCONTRACTOR.
- LITILITY COORDINATION: ELECTRICAL SUBCONTRACTOR SHALL CONTACT ALL UTILITIES UTILITY COORDINATION: ELECTRICAL SUBCONTRACTOR SHALL CONTACT ALL UTILITIES AND VERREY ALL UTILITY REQUIREMENTS PRIOR TO COMMENCING OR ORDERING ANY MATERIALS WHATSOEVER. CONFLICTS BETWEEN UTILITY REQUIREMENTS AND THE PLANS OR SECURICATIONS SHALL BE BROUGHT TO THE ATTENTION OF OF THE DESIGNABURD CONTRACTOR PRIOR TO COMMENCING CONSTRUCTION OR ORGERING ANY MATERIALS WHATSOEVER, SUBCONTRACTOR SHALL CALL FOR A PRE-CONSTRUCTION PAGE: TO-FAGE MEETING WITH THE UTILITY COMPANIES TO REVIEW REQUIREMENTS AND PLANS.
- 13. METHODS OF CONSTRUCTION. UNLESS OTHERWISE NOTED OR SHOWN , THESE DRAWNINGS AND SPECIFICATIONS DO NOT INDICATE METHODS OF CONSTRUCTION . THE SUBCONTRACTOR SHALL SUPERVISE AND DIFFECT THE WORK, AND BE SOLELY RESPONSIBLE FOR ALL CONSTRUCTION MEANS, METHODS, TECHNIQUES, SECURIVES.
- 14. THE EXACT LOCATION AND THE ARRANGEMENTS OF ALL PARTS SHALL BE DETERMINED
 AS THE WORK PROGRESSES. THE SUBCONTRACTOR SHALL BE RESPONSIBLE FOR PROVIDING A COMPLETE AND FUNCTIONAL ELECTRICAL SYSTEM.
- INCIDENTAL ITEMS: INCIDENTAL ITEMS NOT INDICATED ON DRAWINGS, NOT MENTIONED BY THE SPECIFICATIONS THAT CAN BE LEGITIMATELY AND REASONABLY INFERRED TO BELIONED TO THE WORK DESCRIBED ON INCIDENSAME IN GOOD PRACTICE TO PROVIDE A COMPLETE SYSTEM, SHALL BE FURNISHED AND INSTALLED AS TOUGH ITEMIZED HERE IN
- DAMAGE RESPONSIBILITY: THE SUBCONTRACTOR SHALL BE RESPONSIBLE FOR ANY LOSS OR DAMAGE CAUSED BY HIM OR HIS WORKINEN TO THE FACILITY DURING THE COURSE OF CONSTRUCTION, AND SHALL BE FULLY RESPONSIBLE FOR REPARING OR REPLACING AS REQUIRED TO INSURE RESTORATION TO ORIGINAL CONDITION.
- COMPLETE AND FUNCTIONAL SYSTEM: SUBCONTRACTOR SHALL FURNISH MATERIALS, TOOLS, SERVICES, LABOR, ETC. FOR A COMPLETE AND FULLY FUNCTIONAL ELECTRICAL INSTALLATION UNLESS OTHERWISE NOTED ON PLANS
- COORDINATION WITH OTHER TRADES: THE SUBCONTRACTOR SHALL BE RESPONSIBLE FOR COORDINATING ALL ELECTRICAL INSTALLATION WITH ALL OTHER TRADES TO AVOID ANY CONFLICTS.
- SUBCONTRACTOR SHALL DETERMINE EXACT LOCATION IN THE FIELD. FEEDERS SHALL NOT BE INCREASED IN LENGTHS SHOWN WITHOUT ENGINEERING APPROVAL
- EQUIPMENT OUTDOOR RATINGS: ALL ELECTRICAL EQUIPMENT EXPOSED OR INSTALLED OUTDOORS SHALL BE NEMA 3R (WEATHER PROOF) OR NEMA 4 (WET LOCATION) RATED.
- INDICATED LOCATION OF EQUIPMENT J.OCATION OF EQUIPMENT ,CONDUIT, AND DEVICES SHOWN ON THE DRAWINGS ARE APPROXIMATE AND SHALL BE COORDINATED WITH THE CIVIL AND ARCHITECTURAL DRAWINGS.
- NRTL LISTING: ALL ELECTRICAL EQUIPMENT SHALL BE NEW, IN FIRST CLASS CONDITION AND LISTED BY NATIONALLY RECOGNIZED TESTING LABORATORY, (NRTL)SUCH AS U.L. IF SUCH A LISTING EXIST FOR COMPARABLE EQUIPMENT.
- GENERAL SUBCONTRACTOR WORK: ELECTRICAL SUBCONTRACTOR IS RESPONSIBLE FOR WORK OF A GENERAL CONTRACTING NATURE SPECIFIED ON ELECTRICAL PLANS INCLUDING, BUT NOT INCESSARILY JUNITED TO THE FOULDWING.

 A CONCRETE FOOTINGS INCLUDING REBAR AND MOUNTING BOLTS FOR PLACEMENTS OF LIGHTS RIXTURE POLES.

 PLACEMENTS OF LIGHTS RIXTURE POLES.

 TEDIOLOGICAL AND BACKETURE INC. OF TEDIOLOGIC

- B. TRENCHING AND BACKFILLING OF THENCHES.
 C. SUPPLY AND INSTALLATION OF ALL EQUIPMENT PADS AND SPLICE BOXES UNLESS.
- WORKING SPACE : WORKING SPACE SHALL MEET OR EXCEED THE NEC REQUIREMENT FOR ALL ELECTRICAL EQUIPMENT. (SEE NFPA 70-2005, SEC 110-25)
- EQUIPMENT ACCECIBILITY : IT SHALL BE THE RESPONSIBILITY OF SUBCONTRACTOR TO SEE THAT ALL THE ELECTRICAL EQUIPMENT SHALL BE ADDE ADDESSIBLE. SUCH AS JUNCTION BOXES, PAUL BOXES PANELBOARDS, SWITCHES, CONTROLS AND SUCH OTHER APPARATUS AS MAY REQUIRE MAINTENANCE AND OPERATION FROM TIME TO TIME.

- 27. EQUIPMENT PROTECTION: AFTER INSTALLATION, ELECTRICAL EQUIPMENT SHALL BE PROTECTED TO PREVENT DAMAGE DURING THE CONSTRUCTION PERIOD OPENINGS IN CONDUITS AN BOXES SHALL BE CLOSED TO PREVENT THE ENTRANCE OF FOREIGN
- 28. AS BUILD RECORD DRAWINGS: PROVIDE RECORD DRAWING TO THE D/8 CONTRACTING OFFICER WITH ALL CHANGES NOTED THEREON AT THE COMPLETION OF THE PROJECT RECORD DRAWINGS SHALL BE SIGN AND DATED BY SUBCONTRACTOR.
- 29. SHOP DRAWINGS SUBMIT SHOP DRAWINGS AND MATERIALS LIST FOR REVIEW PROR TO COMMENCING ANY WORK, ALL EQUIPMENT TO BEAR U.L. LABEL OR THAT OF ANOTHER ACCEPTABLE TESTING LABORATIONY, WHEN SUCH LISTINGS EXIST FOR COMPARABLE EQUIPMENT SHOP DRAWING MUST BE STAMPED BY THE SUBCONTRACTOR FOR CONFORMANCE PRIOR TO SUBMITTAL
- 30. DIGGING PERMITS AND OUTAGE REQUESTS :ALL DIGGING PERMITS AND OUTAGE REQUESTS ARE THE RESPONSIBILITY OF THE SUBCONTRACTOR. COPIES SHALL BE PROVIDED TO THE DIR CONTRACTOR BEFORE CONSTRUCTION BEGINS.
- 30. DIGGING PERMITS AND OUTAGE REQUESTS: ALL DIGGING PERMITS AND OUTAGE REQUESTS ARE THE RESPONSIBILITY OF THE SUBCONTRACTOR. COPIES SHALL BE PROVIDED TO THE DIS CONTRACTOR BEFORE CONSTRUCTION BEGINS
- 31 ATTRACTIVE NUISANCES: OPEN TRENCHES, ELECTRICAL EQUIPMENT AND DEVICES SHALL NOT PRESENT AN ATTRACTIVE NUISANCE TO CHLOPEN. ALL ELECTRICAL EQUIPMENT SHALL BE TOTALLY INACCESSIBLE, DEAD PRONT AND LOCKWISE.
- 32. ROUTING AND LOCATION: THE ROUTING OF THE NEW UNDERGROUND FEEDERS SHALL BE APPROVED BY AND COORDINATED WITH THE DESIGNABUILD CONTRACTOR. EXCEPT FOR CROSSINGS, ELECTRICAL AND COMMUNICATIONS UTILITIES SHALL NOT BE LOCATED UNDER STREETS.
- 33. UPON COMPLETION OF WORK THE SUBCONTRACTOR SHALL PROVIDE THE D/B TOR WITH ONE (1) SPARE SET OF FUSES OF EACH SIZE AND TYPE INSTALLED
- 34. THE SUBCONTRACTOR IS RESPONSIBLE TO COORDINATE WITH THE DESIGN/BUILD CONTRACTOR FOR PEMOVING, LOCATING, CAPPING AND OR RELOCATION OF ANY ELECTRIC FACILITIES WHICH ARE NOT TO REMAIN IN SERVICE AND TO INSTALL FACILITIES AS REQUIRED TO MAINTAIN CONTINUOUS SERVICE TO DWELLING UNITS OR
- SOLDING STRUCTORES THAT WILL REMAIN,

 5. MON-METALLIC WEATHERPROOF ENCLOSURES SHALL BE CONSTRUCTED OF GLASS
 FIBER REINFORCED POLVESTER RESIN, WITH PROMENTED HEAT RESISTANT HIGH GLOSS
 SURFACING SEALER ON THE INTERIOR, WITH PROMENTED, LUTRAWOLET LIGHT
 STABILIZED WEATHER RESISTANT SURFACE COAT ON THE EXTERIOR, EACH SECTION
 SHALL BE MOLDED IN ONE PIECE, SECTIONAL COMPONENTS JOINED BY BOLTING
 SHALL BE MOLDED IN ONE PIECE, SECTIONAL COMPONENTS JOINED BY BOLTING
 SHALL BE MOLDED IN ONE PIECE, SECTIONAL COMPONENTS JOINED BY BOLTING
 SHALL BE MOLDED IN ONE PIECE, SECTIONAL COMPONENTS JOINED BY BOLTING
 SHALL BE MOLDED IN ONE PIECE, SECTIONAL COMPONENTS JOINED BY BOLTING
 SHOULD FENTAGONAL BOLTS AND
 PROVISIONS FOR PADLICOCKING, DIMENSIONS OF ENCLOSURES SHALL BE AS REQUIRED
 TO ACCOMMODATE ECHIMIENT AND/OR FUNCTIONS SPECIFIED, BUT IN NO CLASS
 SMALLER THAN INDICATED.
- 36. PROVIDE LOCKS AT ALL ELECTRICAL ENCLOSURES SUCH AS TRANSFORMERS, FUSE AND SPLICE CABINETS. LOCKS ARE TO BE COMPATIBLE WITH EXISTING LOCKS USED BY BASE ELECTRICAL.
- PROMDE ENGRAVED PLASTIC NAME PLATES FOR SWITCHBOARDS, PANELS, TERBINAL CABINETS, AND DAY OTHER MAJOR ELECTRICAL ITEM. SCREW-ON ATTACHMENT ONLY-NO ADRESIVE.
- 38. EQUIPMENT LOCATIONS ARE APPROXIMATE, EXACT ROUTING AND EQUIPMENT LOCATION IS TO BE COORDINATED WITH OTHER TRADES AND APPROVED BY THE DIS CONTRACTOR WHERE SHOWN EQUIPMENT IS TO BE CLUSTERED, COORDINATE CLUSTERED LOCATIONS WITH LANDSCAPE CONTRACTOR FOR SHELDING. MAINTAIN WORKING CLEARANCES. A MINIMUM DISTANCE OF 4' IS REQUIRED BETWEEN PRIMARY ELECTRICAL LINES AND WET UTILITIES.
- 39. TRENCHING IS TO AVOID DRIP LINES ON TREES AS SHOWN ON PLANS. ALL TRENCHING WITHIN DRIP LINES TO BE APPROVED BY THE D/B CONTRACTOR.
- 40. STAKING OF ELECTRICAL EQUIPMENT PADS: ALL ELECTRICAL EQUIPMENT, INCLUDING TRANSFORMERS, SWITCHES, METERS, JUNCTION CABINETS, LIGHTING POLE BASES, ETC. ARE TO BE STAKED BY THE ASSIGNED PROJECT SUPPEYORS FOR FINAL ELEVATION AND LOCATION OF PADS OR ANCHORS. ELEVATIONS ARE TO BE DETERMINED BY THE SITE CYLL DESIGN ENGINEER. IN CONSISTENCIES AND INTERFERENCES ARE TO BE REPORTED TO THE DIS CONTRACTOR. THE ELECTRICAL SUBCONTRACTOR THE ELECTRICAL SUBCONTRACTOR. THE ELECTRICAL
- 41. STAKING OF ELECTRICAL TRENCHES: AFTER ELECTRICAL TRENCHES ARE MARKED FOR . STAKING OF ELECTRICAL THENCHES: AFTER ELECTRICAL TREDICIES AFE MARKED FOR MOUTING BY THE ELECTRICAL SUBCONTRACTOR, APPANCEMENTS ARE TO BE MADE FOR THE ASSIGNED PROJECT SURVEYORS TO LOCATE THE MARKED ROUTE AND TRANSFER THIS INFORMATION TO THE STE CIVIL DESIGN ENGINEER TO ASSIGN FINEN GRADES. THESE FINISH GRADES SHALL BE TRANSFERRED BACK TO THE ASSIGNED PROJECT SURVEYOR TO PROJUCE TRENCH STAGNIG INDICATING FINAL GRADE TO INSURE THAT MINIMUM BURIAL DEPTHS ARE MAINTAINED. THE ELECTRICAL SUBCONTRACTOR IS TO VERIFY THAT TRENCH DEPTHS RELATIVE TO FINISH GRADE ARE AS STAKED.
- 42. ALL SPARE/EMPTY CONDUITS SHALL BE PROVIDED WITH A PULL LINE.
- 43 INSTALLATION GUIDELINES SHALL CONFIRM TO CURRENT NEPA 70 NEC.

SITE LIGHTING GENERAL NOTES:

- 44. ALL EQUIPMENT INCLUDING POLE RISERS, PAD MOUNTED GEAR, LIGHT POLES AND ISC. EQUIPMENTS SHALL BE GROUNDED.
- 45. EQUIPMENT GROUNDING: ONE 3/4 INCH BY 10 FOOT COPPER CLAD GROUND ROD SHALL BE INSTALLED IN A CONDUIT WINDOW OF EACH EQUIPMENT PAD (WHERE TRANSFORMER PADS HAVE MORE THAN ONE CONDUIT WINDOW. THE GROUND RODS SHALL BE INSTALLED IN SECONDAPT/LOW VOLTAGE WINDOW). ALL UNDERGROUND GROUNDING CONNECTIONS SHALL BE SOTHERBING TYPE CONNECTIONS CONNECTIONS SHALL BE SOTHERBING TYPE CONNECTIONS.

LEGENDS

CONDUIT FOR POWER COMMUNICATIONS CONDUIT CONDUIT FOR BUILDING SIGNAGE NEMA 5-20R DUPLEX RECEPTACLE MOUNTED AT 15' AFF ON CENTER, UNO. IG = ISOLATED GROUND GROUND FAULT CIRCUIT INTERRUPTER WP - GROUND FAULT CIRCUIT INTERRUPTER AC = MOUNTED 4" ABOVE COUNTER TRANSFORMER GENERATOR 11/2 **(J**) JUNCTION BOX

ABBREVIATIONS

AMP
AVAILABLE FAULT CURRENT
AMPERES INTERRUPTING CAPACITY
ABOVE FINISHED FLOOR
AMERICAN DISABILITIES ACT AUTOMATIC TRANSFER SWITCH AMERICAN WIRE GAUGE BREAKER CONDUIT OR CONDUCTOR-AS APPLICABLE CIRCUIT BREAKER CIRCUIT CEILING CONDUIT ONLY CONTROL POWER TRANSFORMER

DOUBLE THROW TRANSFER SWITCH EMPTY CONDUIT EXHALIST FAN ELEC FLECTRICAL/ELECTRIC

FACE FIRE ALARM CONTROL PANEL

OF GFOLGROUND FAULT (CIRCLIE) HAND HOLESHIGH INTENSITY HAND/OFF/AUTO HORSE POWER

ISOLATED GROUND INCANDESCENT JUNCTION BOX

THOUSAND CIRCULAR MILES KILOVOLT - AMPERE KILOWATT HOUR LIGHTS MAIN CIRCUST BREAKER

METAL HALIDE OR MANHOLE MLO NEUTRAL NATIONAL ELECTRICAL CODE

NON FUSED NATIONAL FIRE PROTECTION NIGHT LIGHT (UNSWITCHED CKT.)

POLE PULL BOX PANEL POLYVINYL CHLORIDE RECEPTACLE RIGID GALVANIZED STEEL SUPPLY FAN

SHELDED SURGE PROTECTIVE DEVICE SINGLE POLE, DOUBLE THROW SINGLE POLE, SINGLE THROW SERIES RATED AMPERES INTERRUPTING CAPACIT STRUCTURED WIRING BOX TELEPHONE

WEATHERPROOF

CONTRACTOR SHALL CO-ORDINATE WITH OWNER/CML ENGINEER FOR SITE LIGHTING DETAILS. BASE4 HAS PROPOSED PANEL FOR SITE POWER CONTRACTOR SHALL USE THAT FOR FUTURE REFERENCE.

2. LIGHTING NOT DESIGNATED FOR DUST-TO-DAWN OPERATION SHALL BE CONTROLLED BY FITHER A COMBINATION OF A PHOTOSENSOR AND A TIME EASTING NOT AN ASTRONOMINAL TIME SWITCH, LIGHTING DESIGNATED FOR DESK-TO-DAWN OPERATION SHALL BE CONTROLLED SY AN ASTRONOMINAL TIME SWITCH, LIGHTING DESIGNATED FOR DESK-TO-DAWN OPERATION SHALL BE CONTROLLED SY AN ASTRONOMICAL TIME SWITCH OR PHOTOSENSOR, ALL TIME SWITCHES SHALL RETAIN PROGRAMMING AND THE TIME SETTING DURING LIGS OF POWER FOR A PERIOD OF AT LEAST 19 HOURS, LIGHTING DESIGNATED TO OPERATE MORE THAN 2000 HOURS FER TEAR FOR UNCOVERDED PARKING AREAS SHALL BE COUPPED WITH MOTION SENSORS THAT WILL REDUCE THE LUMINARIES POWER BY 33 PERCENT OR TURN OFF ONE THIRD THE LUMINARIES WHEN NO ACTIVITY IS

POLE BASE COVERS ARE TO BE INSTALLED SO THAT THE BASE COVER FITS FLUSH TO THE TOP OF THE CONCRETE BASE. LEVELING SHIMS AND NUTS SHALL NOT CAUSE A GAP BETWEEN THE POLE BASE AND THE BASE COVER.

ALL WIRING IS TO BE #12 AWG AND #12 AWG GROUND MINIMUM THHN/THYN (60 DEG. C) IN 1° SCHEDULE 40 PVC (MINIMUM SIZE). TRENCH 30° DEEP, CLEAN BACKFILL USING SITE MATERIALS CAN BE USED PROVIDE PREMIUM BACKFILL WHERE SITE MATERIALS ARE NOT ACCEPTABLE FOR USE.

TELEPHONE TERMINAL BOARD UNDERGROUND UNINTERRUPTABLE POWER SUPPLY UNILESS OTHERWISE NOTED

MANUFACTURER - EATON MCGRAW-EDISON CATALOG - GLEON-AF-03-LED-E1-T3-BK INPUT WATTAGE - 166 W COLOR TEMP - BLACK, 3000K FIXTURE - ALZ-01,ALZ-01A

MANUFACTURER - EATON/INVUE CATALOG - ABB-B2-LED-42-D1-S-DP INPUT WATTAGE - 32 W COLOR TEMP - DARK PLATINUM, 4000K FIXTURE - ALZ-02



BASE4 2901 CLINT MOORE ROAD #114 BOCA RATON, FLORIDA 33496 www.base-4.com

Seal



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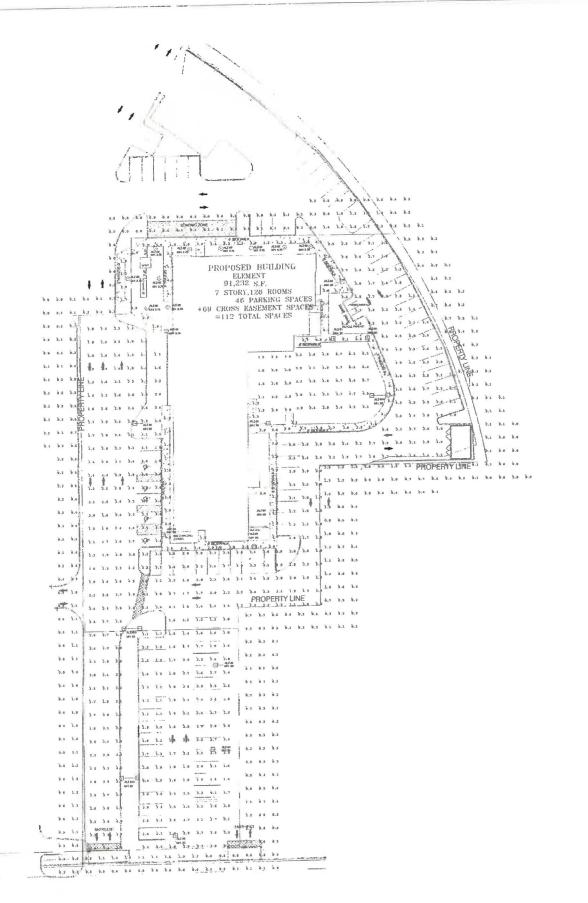
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SHEET NAME SITE LIGHTING NOTES AND ABBREVIATIONS

DRAWING NO.

SL001



| | | | - ROUND TAPERED ALLAWNUM POLE |
|--|------------------------|--|---|
| 25.00 | REINFORCED HANDHOLE | | #12 CONDUCTORS UP TO FEXTURE(S) |
| × | GROUNDING LUG | | - IN-LINE FLISE |
| | CAST ALUMINUM NUT | | - 4 BOLT CIRCLE PER |
| FINISH GRADE | ş (| | GAQUT FILL |
| <u>.</u> | 502 | | 1" CHAMFERED EDGE |
| | | | - ANCHOR BOLTS PER MANUFACTURER |
| | 0.0 | The same of the sa | SCH, 80 PVC CONDUIT REFER TO SITE OF CONDUITS |
| | | | ELECTRICAL PLAN FOR SIZE AND NUMBER |
| | | | ROUND POLE BASE 4,600 PSI CONCRETE |
| 3/4/x10" (19/3); COPPERCUAD GROUNDING: | STEEL | and . | BEAL #6 VERTICAL BARS W/ #3 HORIZONTAL THE BARS 12" O.C. |
| | 2 | N-O" MOTE POLE BASE | AT POOL SHALL BE FLUSH WITH BASE |
| | POLE BASE DE | TAIL WHERE FOUNDATION FLUSH | WITH GRADE |
| | | | |

| uminaire Sche | | | 1.4. | Total Lamp Lumens | LIF | Description | Filename | Arm | Lum. Watts |
|---------------|-----|--------|-------------|-------------------|-------|-------------------------|---------------------------|-----|------------|
| lodmy | Oty | Label | Arrangement | | | CONTROL OF COLUMN FA TO | G FON-AF-03-LED-E1-T3.ies | 2 | 166 |
| 7 | 11 | ALZ-01 | SINGLE | N.A. | 0.900 | | | - | |
| | | or mir | | N.A. | 0.900 | ARB-B2-I FD-D1-S | ABB-B2-LED-D1-S.ies | 10 | 32 |
| (-) | 111 | ALZ-02 | SINGLE | N.A. | 0.900 | | | 2 | 166 |

NOTE:MOUNTING HEIGHTS ARE MENTIONED NEAR FIXTURES IN THE DRAWING USING ABBR,MH:XX.X.EG.MH:20 INDICATES A MOUNTING HEIGHT OF 20 FEET.



BASE4 2901 CLINT MOORE ROAD #114 BOCA RATON, FLORIDA 33496 www.base-4.com

Seal

Owner:



ALLEN SIGMON REAL ESTATE GROUP 9201 MONTGOMERY BLVD, NE BLDG 1 ALBUQUERQUE, NM 87111



ELEMENT ALBUQUERQUE,NM

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 SG

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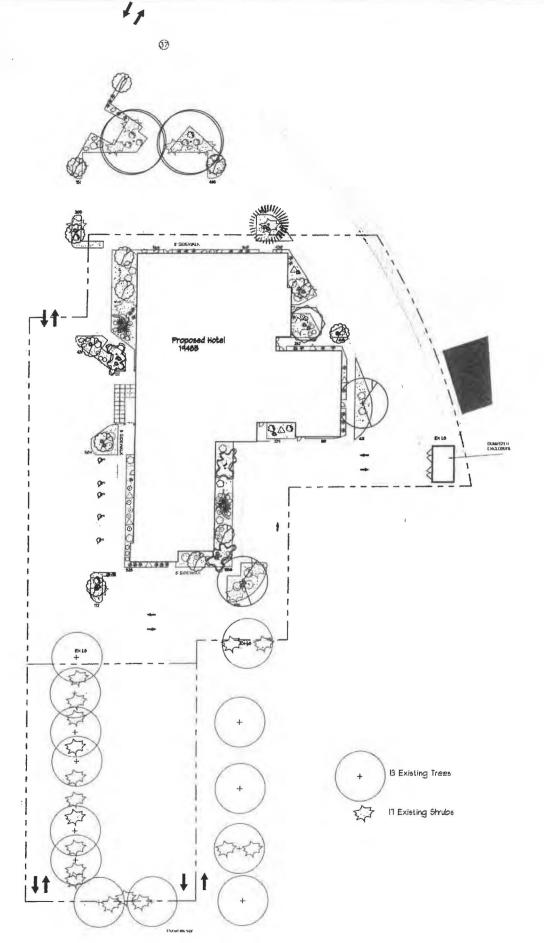
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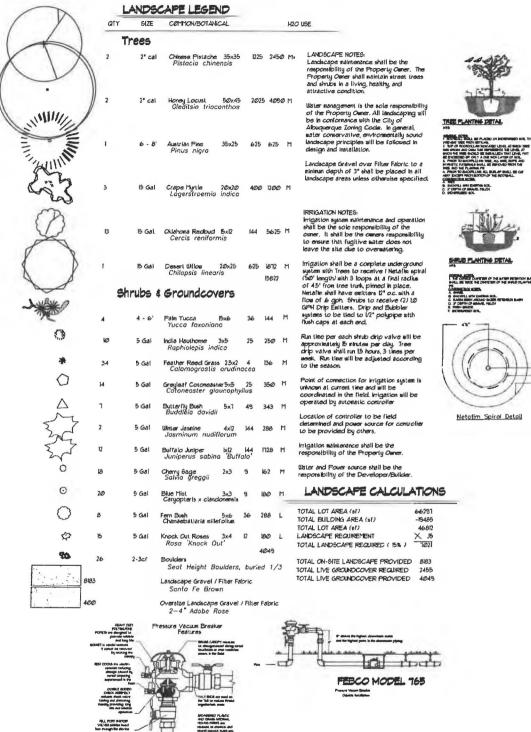
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 B4 - 176 - 1901

SITE PHOTOMETRICS PLAN

DRAWING NO.

SL002





ALL RECORD SCOT


FEBCO MODEL 765



Landacapa Architect



DATE COUNTY DISTRICT OF THE SAME PERSONS BASES

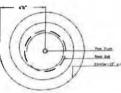

Netofim Spiral Detail

The Hillisp

The design contained herein retains the property of the skilling Landcoppe Advitages and Contributions and the property Contributions and the property flow. This is an original classify and that for be referred to the proping the state of the skilling of the plant for be referred to the proping the skilling that the particular three beam paid or a job code plantack.

244@ Louislana Proposed Hotel Albuquerque, NM

DRAIN BY dn REVIBION P SHEET .

LS-101

SCALE: 1 . 40'-0"

GRAPHIC SCALE 40 20 0 20 40

DRAINAGE NARRATIVE THE SITE IS A FULLY DEVELOPED PORTION OF AN EXISTING SITE. THE OVERALL ORIGINAL SITE WAS DESIGNED TO DISCHARGE TO AN EXISTING 60" STORM DRAIN IN LPUISIANA, VIA SURFACE AND UNDERGROUND CONDUITS. THE OVERALL SITE ANALYSIS IS LOCATED IN DRAINAGE FILE H16D1. THE PROJECT AREA WAS AT ONE TIME A RETENTION BASIN. THE SITE WAS REANALYZED BY BOHANAN HUSTON IN 1984 AMD PARTIALLY CONSTRUCED. THE POND BASIN WAS CONVERTED TO A PARKING LOT DETENION POND IN A REPORT BY LARRY REID IN 2004. THE PROJECT AREA ACCEPTS UPLAND FLOW FROM THE EAST. THE SITE IS ALLOWED TO DISCHARGE AT A PEAK RATE OF 1.6CFS. LOT 6-A-1-A, BLOCK C THIS DEVELOPEMENT WILL CONTINUE TO ALLOW THE UPLAND FLOW of 3.435 CFS TO ENTER THE SITE. THE SITE WILL CONTINUE TO GENERATE 6.30 CFS. THE BASIN DISCHARGE SHALL MATCH THE HISTORICAL RATE OF 0.63 CFS ALLONED BY THE INTRODUCTION PARKING LOT DETENTION WITH SUBSURFACE INFILTRATION CHAMBERS. THE REQUIRED FIRST FLUSH VOLUME OF 1450 CUBIC FRET WILL BE CAPTURED BY THE UNDERGROUND CHAMBERS. THE DEVELOPMENT OF THIS SITE WILL MATCH EXISTING CONDITIONS. 2.265 CPS WATER BREAK LOT 6-A-B, BLOCK C CONNECT EXISTING 12" PVC TO TYPE "D" DROP INLET GRATE=94.75 MWSEL=95.50 REMOVE EXISTING DRAIN COVERED FF = 5296.25 NEW 59 LF OF 12" HOPE FP = 5295.75 ___ 1.17 CFS - IERREALION BOX TYPE TO DROP MLET STORM DRA TYPE TO DROP INLET WIZ ORFICE PLATE GRATE = 94 75M W SEL = 95 . 10 INSTAL UNDERGROUND INFILTRATOR SYSTEM 20 INC 4500 CHAMBERS F EXISTING 12" TYPE "D" DROP INLET W.12" ORIFICE PLATE GRATE = \$5.00 T NEW 117 LF OF 12" HOPE STORM DRAIN WATER BREAK WATER BREAK LOT 7-A-1-A-1-A BLOCK C 154-5295 16 REMOVE EXISTING 6 94.85 HDPE STORM DRA MATER ACTE TYPE TO DROP INL 14-5294 46 STORM DRAIN GRATE = 94.25 MWSEL = 95.00 TER BREAK ×T4=5294.85 ×1A-5294.70 0.63 CFS DISCHARGE VIA 12" PIPE traf Fots -CB = 5294.73 CB = 5294.5 *A = 5294.65 **A 5294.6 CE - 5294 82 JCB - 5294,79 TA - 5294 6. TA - 5294,59 ¥1A=5294.51 F 5. 1 TE = 93.96 19-5795-45 4-5294.76 TA=5294.35 ×1A::5291.56 LOT 7-A-2, BLOCK C LOUISIANA SUBDIVISION -5293-EXISTING UTILITIES ARE NOT SHOWN. IT SHALL BE THE SOLE RESPONSIBILITY OF THE CONTRACTOR TO CONDUCT ALL NECESSARY FIELD INVESTIGATIONS PRIOR 4.57 Fit 111-14 WATER METER TO ANY EXCAVATION TO DETERM **ACTUAL LOCATION OF UTILITIES & OTHER** -xf0=5294.90 CE E BOS FLEGUER

EROSION CONTROL NOTES:


1. CONTRACTOR IS RESPONSIBLE FOR OBTAINING A TOPSOIL DISTURBANCE PERMIT PRIOR TO BEGINNING WORK.

2. CONTRACTOR IS RESPONSIBLE FOR MAINTAINING RUN-OFF ON SITE DURING

3. CONTRACTOR IS RESPONSIBLE FOR CLEANING ALL SEDIMENT THAT GETS INTO EXISTING RIGHT-OF-WAY.

4. REPAIR OF DAMAGED FACILITIES AND CLEANUP OF SEDIMENT ACCUMULATIONS ON ADJACENT PROPERTIES AND IN PUBLIC FACILITIES IS THE RESPONSIBILITY OF THE CONTRACTOR.

5. ALL EXPOSED EARTH SURFACES MUST BE PROTECTED FROM WIND AND WATER EROSION PRIOR TO FINAL ACCEPTANCE OF ANY PROJECT

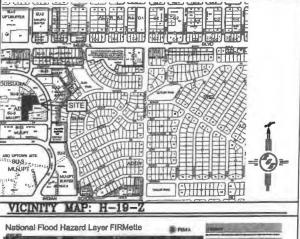

g. M continues. g. - - tentropel The physical and the property of the second species o FIRM MAP:

LEGAL DESCRIPTION:
LOTS S.A-1, S.A-2, S.A-1-C-1-A AND S.A-1-C-1-B, BLOCK
ALBUQUERQUE, BERNALILLO COUNTY, NEW MEXICO

1. ALL SPOT ELEVATIONS REPRESENT FLOWLINE ELEVATION UNLESS OTHERWISE NOTED.

2. ALL SLOPES SHALL BE 3:1 MAX. AND GRAVEL OR NATIVE SEEDING PRIOR TO CO.

3. ANY PERIMETER WALLS MUST BE PERMITED SEPARATELY. ALL RETAINING WALL DESIGN SHALL BE BY OTHERS.

4. SURVEY INFORMATION PROVIDED BY COMMUNITY SCIENCES CORPORATION USING NAVD

LEGEND

C8 = CURB BPOND = BOTTOM OF POND DRN = DRAIN EC = EDGE OF CONCRETE FF = FINISHED FLOOR FL = FLOW LINE G = GROUND
N&D = NAIL & DISC
RMP = RAMP
SASMH = SANITARY SEWER MANHOLE
TA = TOP OF ASPHALT EXISTING SPOT ELEVATION BOUNDARY = LIGHT POLE --- ADJACENT ROLINDARY ETI = IRRIGATION BOX = WATER VALVE CI = WATER METER PROPOSED WATER BREAK = SANETARY SEWER MANHOLE STORM DRAIN MANHOLE PROPOSED HOPE STORM DRAIN PROPOSED TYPE "D" DROP INLET PER COA STD DWG P = PHONE MANHOLE PROPOSED LIMDERGROUND INFILTRATOR SYSTEM

BY DEM


DATE 10-24-19

O L OLUBANIA BLVD.DI

C1


SHEET#

JOB#

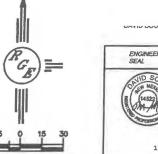



SCALE: 1"=30" *UPDATED BASE 1/9/2020

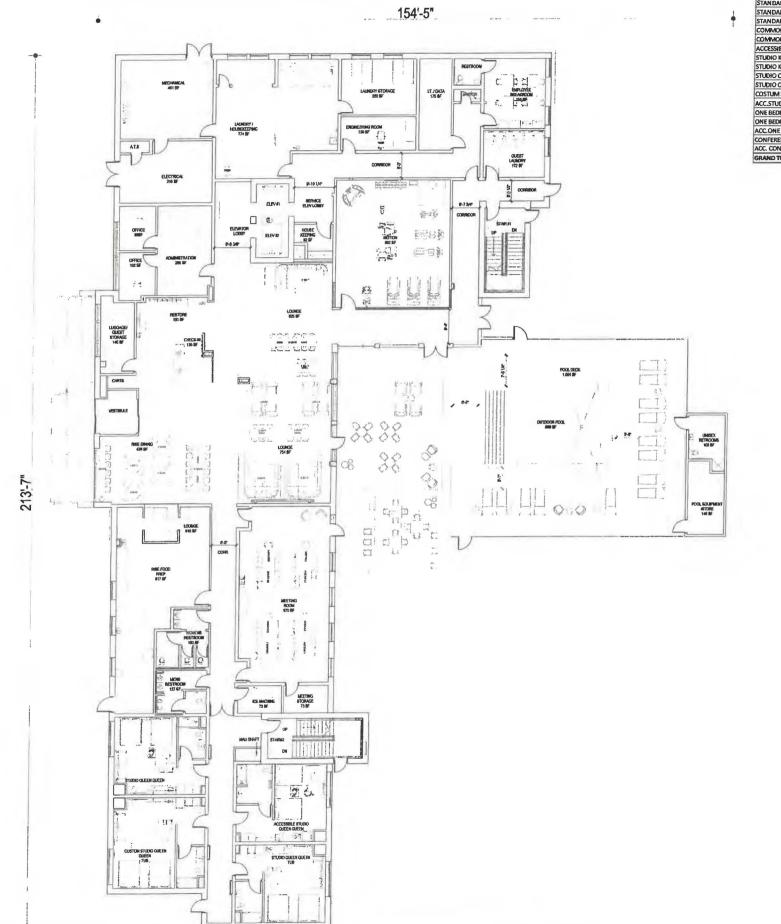

| | | | ROOM | A MATRIX | | | | | | |
|-------------------------------|-----|-----|------|----------|-----|-----|-------|------|------|-------------|
| ROOM TYPE | 15T | 2ND | 3RD | 4TH | 5TH | 6TH | TOTAL | | % | NO. OF BEDS |
| STANDARD KING | 0 | 5 | 7 | 7 | 7 | 6 | 32 | 25% | | 32 |
| STANDARD KING ACC. | 0 | 0 | 0 | 0 | 0 | 1 | 1 | 1% | 7 | 1 |
| STANDARD KING CONN. | 0 | 5 | 5 | 5 | 5 | 5 | 25 | 20% | 1 | 25 |
| COMMONS KING A | 0 | 0 | 0 | 0 | 3 | 3 | 6 | 5% | 68% | 6 |
| COMMONS KING B | 0 | 0 | 0 | 0 | 0 | 1 | 1 | 1% | 0076 | 1 |
| ACCESSIBLE COMMONS KING | 0 | 0 | 0 | 0 | 1 | 0 | 1 | 1% | | 1 |
| STUDIO KING | 0 | 3 | 4 | 4 | 4 | 4 | 19 | 15% | | 19 |
| STUDIO KING ACC. | 0 | 1 | 0 | 0 | 0 | 0 | 1 | 1% | | 1 |
| STUDIO QUEEN QUEEN SHOWER | 1 | 3 | 4 | 3 | 0 | 0 | 11 | 9% | | 22 |
| STUDIO QUEEN QUEEN TUB | 1 | 1 | 1 | 1 | 1 | 1 | 6 | 5% | | 12 |
| COSTUM STUDIO QUEEN QUEEN TUB | 1 | 1 | 1 | 1 | 1 | 1 | - 6 | 5% | | 12 |
| ACC.STUDIO QUEEN QUEEN | 1 | 0 | 0 | 1 | 0 | 0 | 2 | 2% | | 4 |
| ONE BEDROOM | 0 | 1 | 0 | 1 | 1 | 1 | 4 | 3% | 32% | 4 |
| ONE BEDROOM CONN. | 0 | 1 | 1 | 1 | 1 | 1 | 5 | 4% | | 5 |
| ACC.ONE BERDROOM | 0 | 0 | 1 | 0 | 0 | 0 | 1 | 1% | | 1 |
| CONFERENCE SUITE | 0 | 0 | 1 | 1 | 1 | 1 | 4 | 3% | | 4 |
| ACC. CONFERENCE SUITE | 0 | 1 | 0 | 0 | 0 | 0 | 1 | 1% | | 1 |
| GRAND TOTAL | 4 | 22 | 25 | 25 | 25 | 25 | 126 | 100% | 100% | 151 |

| SHOWER FIXTUR | E TYPE MATRIX | FLOOR AREA (S | 5F) | |
|--------------------|---------------|---------------|----------------------|--------|
| HOWER | 107 | 85% | 1ST LEVEL FLOOR PLAN | 15,224 |
| UB | 12 | 10% | 2ND LEVEL FLOOR PLAN | 14,342 |
| CC. TUB | 0 | 0% | 3RD LEVEL FLOOR PLAN | 14,342 |
| CC. ROLL IN SHOWER | 2 | 2% | 4TH LEVEL FLOOR PLAN | 14,342 |
| RANSFER SHOWER | 5 | 4% | 5TH LEVEL FLOOR PLAN | 14,342 |
| OTAL | 126 | 100% | 6TH LEVEL FLOOR PLAN | 14,342 |
| | | | 7TH LEVEL FLOOR PLAN | 4,298 |
| | | | TOTAL | 91,232 |





ALLEN SIGMON REAL ESTATE GROUP 9201 MONTGOMERY BLVD, NE BLDG 1 ALBUQUERQUE, NM 87111



No. ISSUE DATE | PROJECT STATUS


DATE 2020.01.17 DRAWN BY SG CHECKED BY DH SCALE AS NOTED PROJECT NO. B4 - 176 - 1901

SHEET NAME

FLOOR PLANS

A2.1

FIRST FLOOR PLAN SCALE: 3/32'=1'-0"

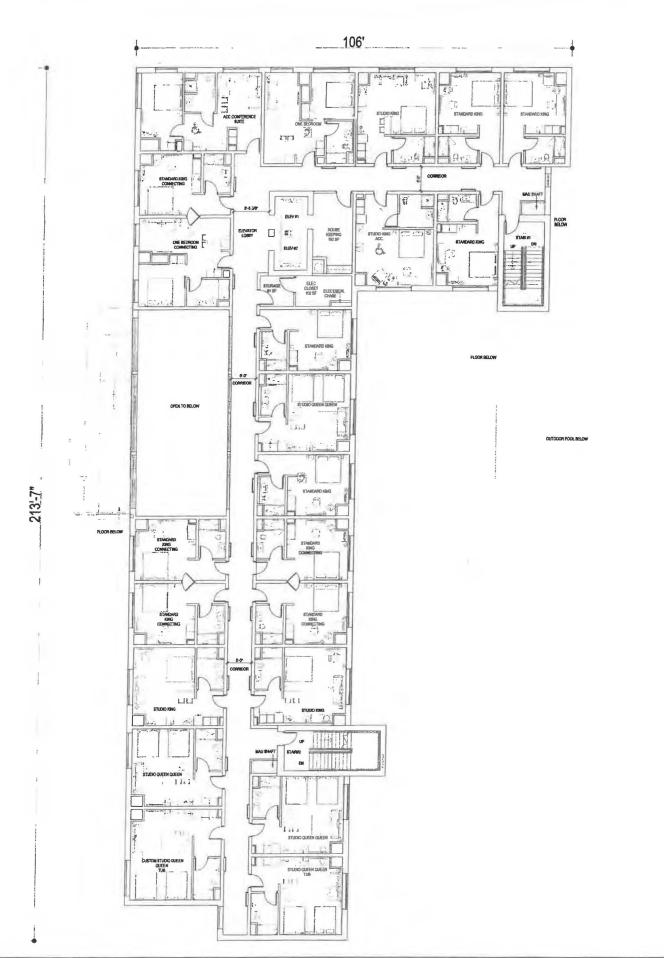

| | | | ROOR | MATRIX | | | | | | |
|-------------------------------|-----|-----|------|--------|-----|-----|-------|------|-------|-------------|
| ROOM TYPE | 1ST | 2ND | 3RD | 4TH | 5TH | 6TH | TOTAL | | % | NO. OF BEDS |
| STANDARD KING | 0 | 5 | 7 | 7 | 7 | 6 | 32 | 25% | | 32 |
| STANDARD KING ACC. | 0 | 0 | 0 | D | 0 | 1 | 1 | 1% | | 1 |
| STANDARD KING CONN. | 0 | 5 | 5 | 5 | 5 | 5 | 25 | 20% |] | 25 |
| COMMONS KING A | 0 | 0 | 0 | 0 | 3 | 3 | 6 | 5% | 68% | 6 |
| COMMONS KING 8 | 0 | 0 | 0 | 0 | 0 | 1 | 1 | 1% | Q2576 | 1 |
| ACCESSIBLE COMMONS KING | 0 | 0 | 0 | 0 | 1 | 0 | 1 | 1% | 1 | 1 |
| STUDIO KING | 0 | 3 | 4 | 4 | 4 | 4 | 19 | 15% | 1 | 19 |
| STUDIO KING ACC. | 0 | 1 | 0 | 0 | 0 | 0 | 1 | 1% | | 1 |
| STUDIO QUEEN QUEEN SHOWER | 1 | 3 | 4 | 3 | 0 | 0 | 11 | 9% | | 22 |
| STUDIO QUEEN QUEEN TUB | 1 | 1 | 1 | 1 | 1 | 1 | 6 | 5% | | 12 |
| COSTUM STUDIO QUEEN QUEEN TUB | 1 | 1 | 1 | 1 | 1 | 1 | - 6 | 5% | | 12 |
| ACC.STUDIO QUEEN QUEEN | 1 | 0 | 0 | 1 | 0 | 0 | 2 | 2% | | 4 |
| ONE BEDROOM | 0 | 1 | 0 | 1 | 1 | 1 | 4 | 3% | 32% | 4 |
| ONE BEDROOM CONN. | a | 1 | 1 | 1 | 1 | 1 | 5 | 4% | | 5 |
| ACC, ONE BERDROOM | 0 | 0 | 1 | 0 | 0 | 0 | 1 | 1% | | 1 |
| CONFERENCE SUITE | 0 | 0 | 1 | 1 | 1 | 1 | 4 | 3% | | 4 |
| ACC, CONFERENCE SUITE | 0 | 1 | D | 0 | 0 | 0 | 1 | 1% | | 1 |
| FRAND TOTAL | 4 | 22. | 25 | 25 | 25 | 25 | 126 | 100% | 100% | 151 |

| SHOWER FIXTUR | E TYPE MATRIX | | FLOOR AREA (S | F) | |
|---------------------|---------------|------|---------------------------|--------|--|
| SHOWER | 107 | 85% | 1ST LEVEL FLOOR PLAN | 15,224 | |
| TUB | 12 | 10% | 2ND LEVEL FLOOR PLAN | 14,342 | |
| ACC. TUB | 0 | D% | 3RD LEVEL FLOOR PLAN | 14,342 | |
| ACC. ROLL IN SHOWER | 2 | 2% | 4TH LEVEL FLOOR PLAN | 14,342 | |
| TRANSFER SHOWER | 5 | 4% | 5TH LEVEL FLOOR PLAN | 14,342 | |
| TOTAL | 126 | 100% | 100% 6TH LEVEL FLOOR PLAN | | |
| | | | 7TH LEVEL FLOOR PLAN | 4,298 | |
| | | | TOTAL | 01 777 | |

Architects Engineers Interiors

BASE4 2901 CLINT MOORE ROAD #114 BOCA RATON, FLORIDA 33496 www.base-4.com



ALLEN SIGMON REAL ESTATE GROUP 9201 MONTGOMERY BLVD, NE 8LDG 1 ALBUQUERQUE, NM 87111



| _ | 1 |
|---|---|
| | |
| | |

DATE 2020.01.17 DRAWN BY SG CHECKED BY DH SCALE AS NOTED PROJECT NO. B4 - 176 - 1901

SHEET NAME

FLOOR PLANS

A2.2

SECOND FLOOR PLAN

SCALE: 3/32"=1'-0"



| | | | ROOM | AINTAM N | | | | | | |
|-------------------------------|-----|-----|------|----------|-----|-----|-------|------|------|-------------|
| ROOM TYPE | 1ST | 2ND | 3RD | 4TH | STH | 6TH | TOTAL | | % | NO, OF BEDS |
| STANDARD KING | 0 | 5 | 7 | 7 | 7 | 6 | 32 | 25% | | 32 |
| STANDARD KING ACC. | 0 | 0 | 0 | 0 | 0 | 1 | 1 | 1% | | 1 |
| STANDARD KING CONN. | 0 | 5 | 5 | 5 | 5 | 5 | 25 | 20% | | 25 |
| COMMONS KING A | 0 | 0 | 0 | 0 | 3 | 3 | 6 | 5% | 68% | 6 |
| COMMONS KING B | 0 | 0 | 0 | 0 | 0 | 1 | 1 | 1% | 0076 | 1 |
| ACCESSIBLE COMMONS KING | 0 | 0 | 0 | 0 | 1 | 0 | 1 | 1% | | 1 |
| STUDIO KING | 0 | 3 | 4 | 4 | 4 | 4 | 19 | 15% | | 19 |
| STUDIO KING ACC. | 0 | 1 | 0 | 0 | 0 | 0 | 1 | 1% | - | 1 |
| STUDIO QUEEN QUEEN SHOWER | 1 | 3 | 4 | 3 | 0 | 0 | 11 | 9% | - | 22 |
| STUDIO QUEEN QUEEN TUB | 1 | 1 | 1 | 1 | 1 | 1 | 6 | 5% | | 12 |
| COSTUM STUDIO QUEEN QUEEN TUB | 1 | 1 | 1 | 1 | 1 | 1 | 6 | 5% | | 12 |
| ACC.STUDIO QUEEN QUEEN | 1 | 0 | 0 | 1 | 0 | 0 | 2 | 2% | | 4 |
| ONE BEDROOM | 0 | 1 | 0 | 1 | 1 | 1 | 4 | 3% | 32% | 4 |
| DNE BEDROOM CONN. | 0 | 1 | 1 | 1 | 1 | 1 | 5 | 4% | | 5 |
| ACC, ONE BERDROOM | 0 | 0 | 1 | 0 | 0 | 0 | 1 | 1% | | 1 |
| CONFERENCE SUITE | 0 | 0 | 1 | 1 | 1 | 1 | 4 | 3% | | 4 |
| ACC. CONFERENCE SUITE | 0 | 1 | 0 | 0 | 0 | 0 | 1 | 1% | | 1 |
| GRAND TOTAL | 4 | 22 | 25 | 25 | 25 | 25 | 126 | 100% | 100% | 151 |

| SHOWER FIXTUR | FLOOR AR | | | | |
|--------------------|----------|------|--|----------|--|
| HOWER | 107 | 85% | 15T LEVEL FLO | OORPLAN | |
| UB . | 12 | 10% | 2ND LEVEL FL | DOR PLAN | |
| CC. TUB | 0 | 0% | 3RD LEVEL FL | OOR PLAN | |
| CC. ROLL IN SHOWER | 2 | 2% | 4TH LEVEL FL | OOR PLAN | |
| RANSFER SHOWER | 5 | 4% | 5TH LEVEL FL | OOR PLAN | |
| DTAL | 126 | 100% | GTH LEVEL FLO | OOR PLAN | |
| | | | 7TH LEVEL FLO | OR PLAN | |
| | | | The state of the s | | |



Seal

Owner

15,224 24,342 14,342 14,342 14,342 14,342 4,298 91,232



ALLEN SIGMON REAL ESTATE GROUP 9201 MONTGOMERY BLVD, NE BLDG 1 ALBUQUERQUE, NM 87111




ELEMENT ALBUQUERQUE,NM

| No. | ISSUE DATE | PROJECT STATUS | | | |
|-----|------------|-----------------|--|--|--|
| DAT | F | 2020.01.17 | | | |
| _ | WN BY | SG | | | |
| CHE | CKED BY | DH | | | |
| SCA | LE | AS NOTED | | | |
| PRO | JECT NO. | B4 - 176 - 1901 | | | |
| SHE | FTNAME | | | | |

FLOOR PLANS

A2.3

THIRD FLOOR PLAN SCALE: 3/32*=1'-0'

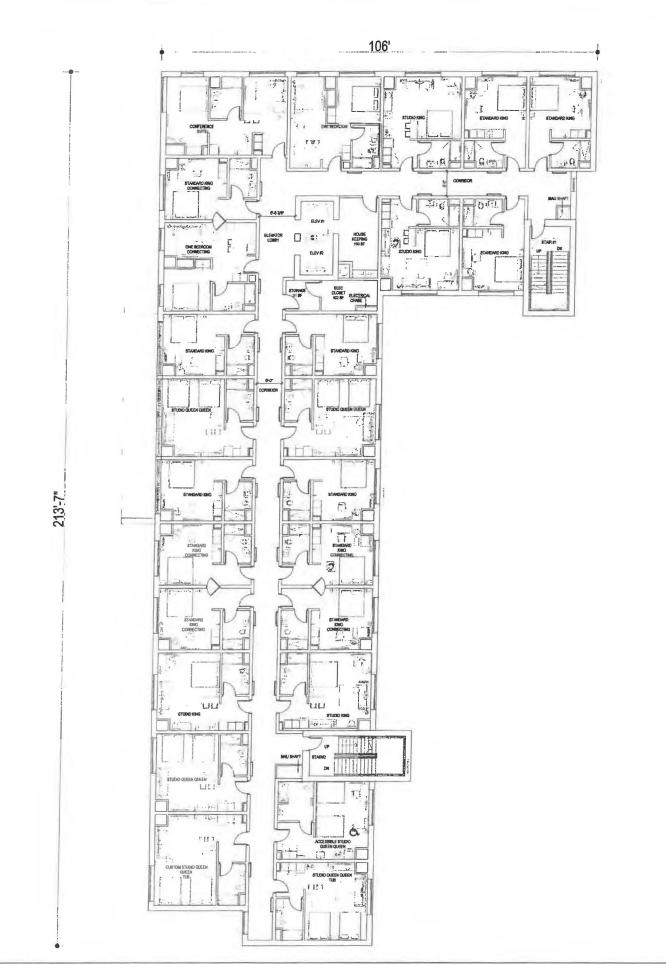

| | | | ROOM | MATRIX | | | | | | |
|-------------------------------|-----|-----|------|--------|-----|-----|-------|------|------|-------------|
| ROOM TYPE | 15T | ZND | 3RD | 4TH | 5TH | 6TH | TOTAL | | % | NO. OF BEDS |
| STANDARD KING | 0 | 5 | 7 | 7 | 7 | 6 | 32 | 25% | | 32 |
| STANDARD KING ACC. | 0 | 0 | 0 | 0 | 0 | 1 | 1 | 1% | | 1 |
| STANDARD KING CONN. | 0 | 5 | 5 | 5 | 5 | 5 | 25 | 20% | 68% | 25 |
| COMMONS KING A | 0 | 0 | 0 | 0 | 3 | 3 | 6 | 5% | | 6 |
| COMMONS KING B | 0 | 0 | 0 | 0 | 0 | 1 | 1 | 1% | | 1 |
| ACCESSIBLE COMMONS KING | 0 | 0 | 0 | 0 | 1 | 0 | 1 | 1% | | 1 |
| STUDIO KING | 0 | 3 | 4 | 4 | 4 | 4 | 19 | 15% | | 19 |
| STUDIO KING ACC. | 0 | 1 | 0 | 0 | 0 | 0 | 1 | 1% | | 1 |
| STUDIO QUEEN QUEEN SHOWER | 1 | 3 | 4 | 3 | 0 | 0 | 11 | 9% | | 22 |
| STUDIO QUEEN QUEEN TUB | 1 | 1 | 1 | 1 | 1 | 1 | 6 | 5% | | 12 |
| COSTUM STUDIO QUEEN QUEEN TUB | 1 | 1 | 1 | 1 | 1 | 1 | 6 | 5% | | 12 |
| ACC.STUDIO QUEEN QUEEN | 1 | 0 | 0 | 1 | 0 | 0 | 2 | 2% | | 4 |
| ONE BEDROOM | 0 | 1 | 0 | 1 | 1 | 1 | 4 | 3% | 32% | 4 |
| ONE BEDROOM CONN. | 0 | 1 | 1 | 1 | 1 | 1 | 5 | 4% | | 5 |
| ACC.ONE BERDROOM | 0 | 0 | 1 | 0 | 0 | 0 | 1 | 1% | | 1 |
| CONFERENCE SUITE | 0 | 0 | 1 | 1 | 1 | 1 | 4 | 3% | | 4 |
| ACC. CONFERENCE SUITE | 0 | 1 | 0 | 0 | 0 | 0 | 1 | 1% | | 1 |
| GRAND TOTAL | 4 | 22 | 25 | 25 | 25 | 25 | 126 | 100% | 100% | 151 |

| SHOWER FIXTUR | E TYPE MATRIX | | FLOOR AREA (SF) | | | |
|---------------------|---------------|------|----------------------|--------|--|--|
| SHOWER | 107 | 85% | 1ST LEVEL FLOOR PLAN | 15,224 | | |
| TUB | 12 | 10% | 2ND LEVEL FLOOR PLAN | 14,342 | | |
| ACC. TUB | 0 | 0% | 3RD LEVEL FLOOR PLAN | 14,342 | | |
| ACC. ROLL IN SHOWER | 2 | 2% | 4TH LEVEL FLOOR PLAN | 14,342 | | |
| TRANSFER SHOWER | 5 | 4% | 5TH LEVEL FLOOR PLAN | 14,342 | | |
| TOTAL | 126 | 100% | 6TH LEVEL FLOOR PLAN | 14,342 | | |
| | | | 7TH LEVEL FLOOR PLAN | 4,298 | | |
| | | | TOTAL | 91,232 | | |





ALLEN SIGMON REAL ESTATE GROUP 9201 MONTGOMERY BLVD, NE BLDG 1 ALBUQUERQUE, NM 87111



No. ISSUE DATE | PROJECT STATUS

DATE 2020.01.17 DRAWN BY SG CHECKED BY DH SCALE AS NOTED


PROJECT NO. B4 - 176 - 1901

SHEET NAME

FLOOR PLANS

A2.4

FOURTH FLOOR PLAN SCALE: 3/32°=1'-0°

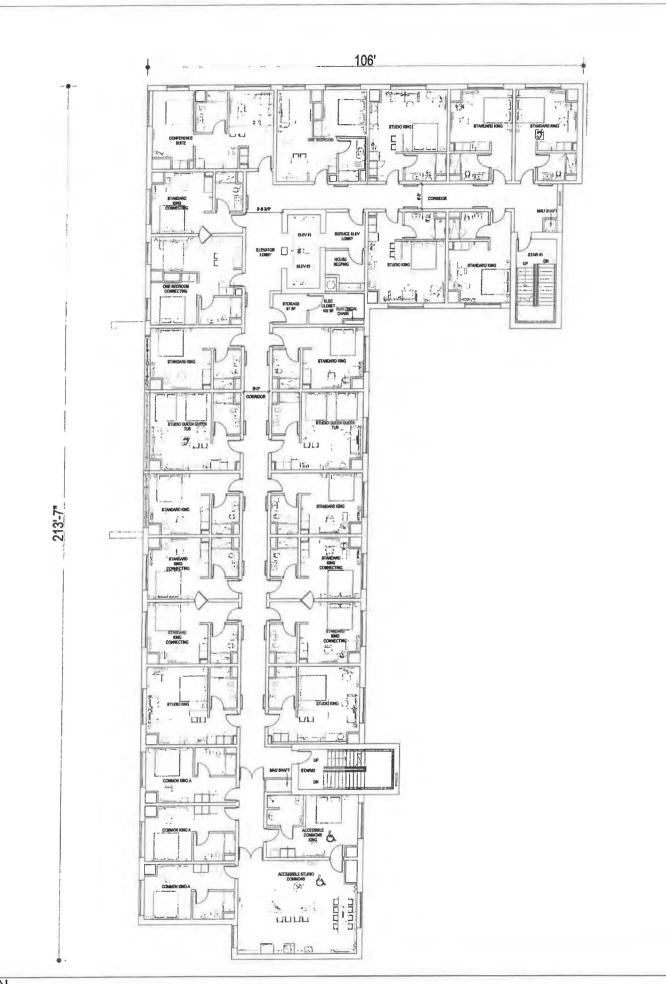

| | | | ROOM | MATRIX | | | | | | |
|-------------------------------|-----|-----|------|--------|-----|-----|-------|------|------|-------------|
| ROOM TYPE | 1ST | 2ND | 3RD | 4TH | 5TH | 6TH | TOTAL | | % | NO. OF BEDS |
| STANDARD KING | 0 | 5 | 7 | 7 | 7 | 6 | 32 | 25% | | 32 |
| STANDARD KING ACC. | 0 | 0 | 0 | 0 | 0 | 1 | 1 | 1% | 1 | 1 |
| STANDARD KING CONN. | 0 | 5 | 5 | 5 | 5 | 5 | 25 | 20% | 68% | 25 |
| COMMONS KING A | 0 | 0 | 0 | 0 | 3 | 3 | 6 | 5% | | 6 |
| COMMONS KING B | 0 | 0 | 0 | 0 | 0 | 1 | 1 | 1% | 9876 | 1 |
| ACCESSIBLE COMMONS KING | 0 | 0 | 0 | 0 | 1 | 0 | 1 | 1% | | 1 |
| STUDIO KING | 0 | 3 | 4 | 4 | 4 | 4 | 19 | 15% | | 19 |
| STUDIO KING ACC. | 0 | 1 | 0 | 0 | 0 | 0 | 1 | 1% | | 1 |
| STUDIO QUEEN QUEEN SHOWER | 1 | 3 | 4 | 3 | 0 | 0 | 11 | 9% | | 22 |
| STUDIO QUEEN QUEEN TUB | 1 | 1 | 1 | 1 | 1 | 1 | 6 | 5% | | 12 |
| COSTUM STUDIO QUEEN QUEEN TUB | 1 | 1 | 1 | 1 | 1 | 1 | 6 | 5% | | 12 |
| ACC.STUDIO QUEEN QUEEN | 1 | 0 | 0 | 1 | 0 | 0 | 2 | 2% | | 4 |
| ONE BEDROOM | 0 | 1 | 0 | 1 | 1 | 1 | 4 | 3% | 32% | 4 |
| ONE BEDROOM CONN. | 0 | 1 | 1 | 1 | 1 | 1 | 5 | 4% | | 5 |
| ACC.ONE BERDROOM | 0 | 0 | 1 | 0 | 0 | 0 | 1 | 1% | | 1 |
| CONFERENCE SUITE | 0 | 0 | 1 | 1 | 1 | 1 | 4 | 3% | li i | 4 |
| ACC. CONFERENCE SUITE | 0 | 1 | 0 | 0 | 0 | 0 | 1 | 1% | | 1 |
| GRAND TOTAL | 4 | 22 | 25 | 25 | 25 | 25 | 126 | 100% | 100% | 151 |

| SHOWER FIXTUR | E TYPE MATRIX | FLOOR AREA (SF) | | |
|---------------------|---------------|-----------------|----------------------|--------|
| SHOWER | 107 | 85% | 15T LEVEL FLOOR PLAN | 15,224 |
| TUB | 12 | 10% | 2ND LEVEL FLOOR PLAN | 14,342 |
| ACC. TUB | 0 | 0% | 3RD LEVEL FLOOR PLAN | 14,342 |
| ACC. ROLL IN SHOWER | 2 | 296 | 4TH LEVEL FLOOR PLAN | 14,342 |
| TRANSFER SHOWER | 5 | 4% | 5TH LEVEL FLOOR PLAN | 14,342 |
| TOTAL | 126 | 100% | 6TH LEVEL FLOOR PLAN | 14,342 |
| | | | 7TH LEVEL FLOOR PLAN | 4,298 |
| | | | TOTAL | 01 232 |





ALLEN SIGMON REAL ESTATE GROUP 9201 MONTGOMERY BLVD, NE BLDG 1 ALBUQUERQUE, NM 87111



| DAT | E | 2020.01.17 |
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DH

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No. ISSUE DATE PROJECT STATUS

CHECKED BY SCALE


PROJECT NO. B4 - 176 - 1901

SHEET NAME

FLOOR PLANS

A2.5

FIFTH FLOOR PLAN SCALE: 3/32"=1'-0"

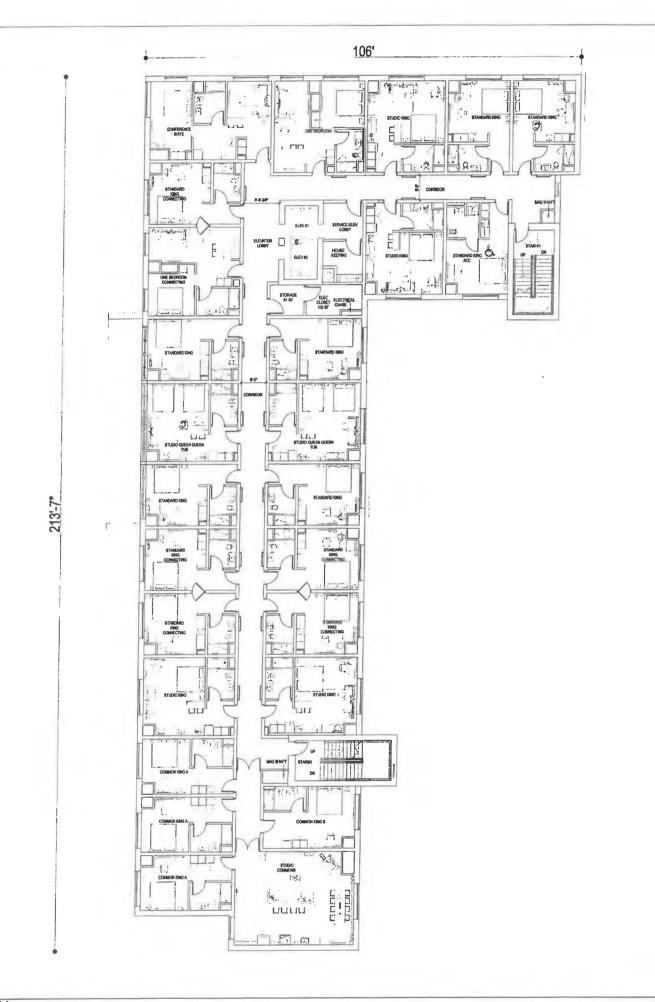

| | | | ROOM | MATRIX | | | | | | |
|-------------------------------|-----|-----|------|--------|-----|-----|-------|------|------|-------------|
| ROOM TYPE | 1ST | 2ND | 3RD | 4TH | 5TH | бТН | TOTAL | | % | NO. OF BEDS |
| STANDARD KING | 0 | 5 | 7 | 7 | 7 | 6 | 32 | 25% | | 32 |
| STANDARD KING ACC. | 0 | 0 | 0 | 0 | 0 | 1 | 1 | 1% |] | 1 |
| STANDARD KING CONN. | 0 | 5 | 5 | 5 | 5 | 5 | 25 | 20% | 68% | 25 |
| COMMONS KING A | 0 | 0 | 0 | 0 | 3 | 3 | 6 | 5% | | 6 |
| COMMONS KING B | 0 | 0 | 0 | 0 | 0 | 1 | 1 | 1% | 6876 | 1 |
| ACCESSIBLE COMMONS KING | 0 | 0 | 0 | 0 | 1 | 0 | 1 | 1% | | 1 |
| STUDIO KING | 0 | 3 | 4 | 4 | 4 | 4 | 19 | 15% | 1 | 19 |
| STUDIO KING ACC. | 0 | 1 | 0 | 0 | 0 | 0 | 1 | 1% | | 1 |
| STUDIO QUEEN QUEEN SHOWER | 1 | 3 | 4 | 3 | 0 | 0 | 11 | 9% | 10.7 | 22 |
| STUDIO QUEEN QUEEN TUB | 1 | 1 | 1 | 1 | 1 | 1 | 6 | 5% | | 12 |
| COSTUM STUDIO QUEEN QUEEN TUB | 1 | 1 | 1 | 1 | 1 | 1 | 6 | 5% | | 12 |
| ACC.STUDIO QUEEN QUEEN | 1 | 0 | 0 | 1 | 0 | 0 | 2 | 2% | | 4 |
| ONE BEDROOM | 0 | 1 | 0 | 1 | 1 | 1 | 4 | 3% | 32% | 4 |
| ONE BEDROOM CONN. | 0 | 1 | 1 | 1 | 1 | 1 | 5 | 4% | | 5 |
| ACC.ONE BERDROOM | 0 | 0 | 1 | 0 | 0 | 0 | 1 | 1% | | 1 |
| CONFERENCE SUITE | 0 | 0 | 1 | 1 | 1 | 1 | 4 | 3% | | 4 |
| ACC. CONFERENCE SUITE | 0 | 1 | 0 | 0 | 0 | 0 | 1 | 1% | | 1 |
| SRAND TOTAL | 4 | 22 | 25 | 25 | 25 | 25 | 126 | 100% | 100% | 151 |

| SHOWER FIXTUR | E TYPE MATRIX | | FLOOR AREA (S | F) | | |
|---------------------|---------------|------|----------------------|-------|--|--|
| SHOWER | 107 | 85% | 1ST LEVEL FLOOR PLAN | | | |
| TUB | 12 | 10% | 2ND LEVEL FLOOR PLAN | 14,34 | | |
| ACC. TUB | 0 | 0% | 3RD LEVEL FLOOR PLAN | 14,34 | | |
| ACC. ROLL IN SHOWER | 2 | 2% | 4TH LEVEL FLOOR PLAN | 14,34 | | |
| TRANSFER SHOWER | 5 | 4% | 5TH LEVEL FLOOR PLAN | 14,34 | | |
| TOTAL | 126 | 100% | 6TH LEVEL FLOOR PLAN | 14,34 | | |
| | | | 7TH LEVEL FLOOR PLAN | 4,298 | | |
| | | | TOTAL | 91,23 | | |



Seal

Owne



ALLEN SIGMON REAL ESTATE GROUP 9201 MONTGOMERY BLVD, NE BLDG 1 ALBUQUERQUE, NM 87111



ELEMENT BLOUFROUE NM

| No. | ISSUE DATE | PROJECT STATU |
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| | | |
| DAT | E | 2020.01.17 |
| | | |

CHECKED BY

SCALE AS NOTED


PROJECT NO. B4 - 176 - 1901

SHEET NAME

FLOOR PLANS

A2.6

SIXTH FLOOR PLAN SCALE: 3/32*=1'-0"

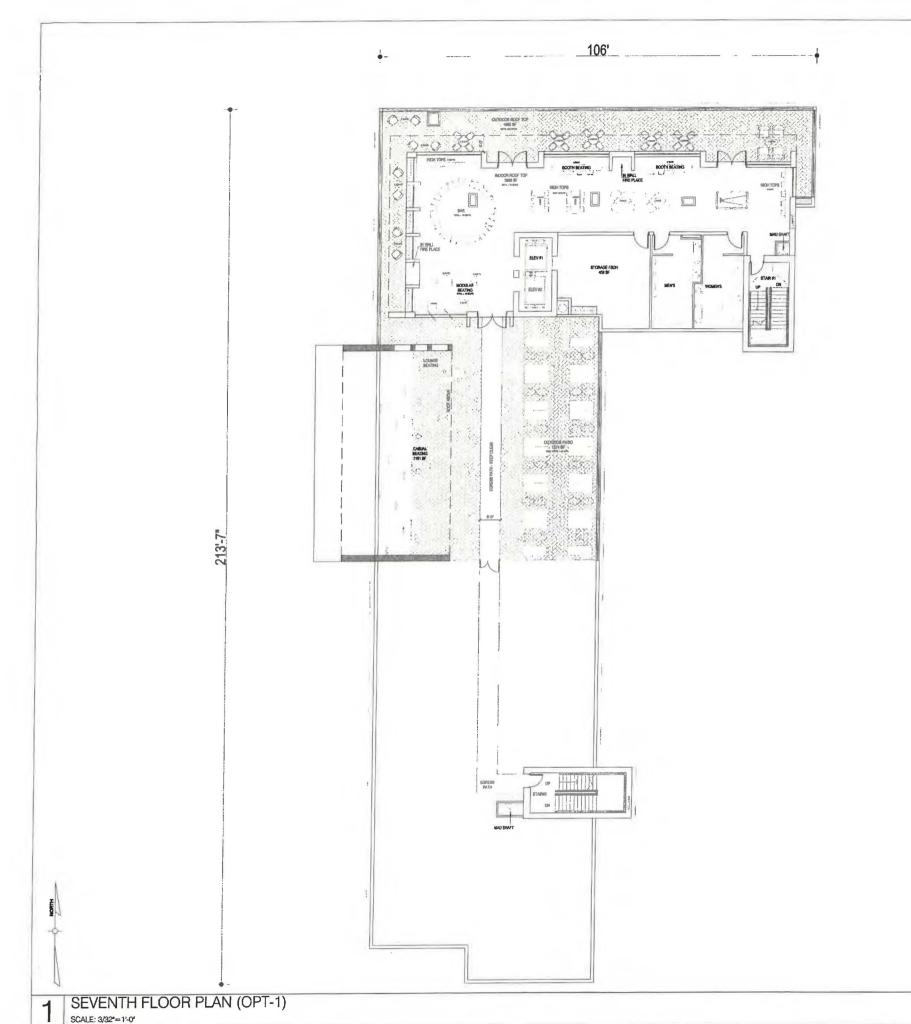

| | | | ROOP | MATRIX | | | | | | |
|-------------------------------|-----|-----|------|--------|-----|-----|-------|------|------|------------|
| ROOM TYPE | 157 | 2ND | 3RD | 4TH | 5TH | 6TH | TOTAL | | % | NO. OF BED |
| STANDARD KING | 0 | 5 | 7 | 7 | 7 | 6 | 32 | 25% | | 32 |
| STANDARD KING ACC. | 0 | 0 | 0 | 0 | 0 | 1 | 1 | 1% | | 1 |
| STANDARD KING CONN. | 0 | 5 | 5 | 5 | 5 | 5 | 25 | 20% | | 25 |
| COMMONS KING A | 0 | 0 | 0 | 0 | 3 | 3 | 6 | 5% | 68% | 6 |
| COMMONS KING B | 0 | 0 | 0 | 0 | 0 | 1 | 1 | 1% | 0070 | 1 |
| ACCESSIBLE COMMONS KING | 0 | 0 | 0 | 0 | 1 | 0 | 1 | 1% | | 1 |
| STUDIO KING | 0 | 3 | 4 | 4 | 4 | 4 | 19 | 15% | | 19 |
| STUDIO KING ACC. | 0 | 1 | 0 | 0 | 0 | 0 | 1 | 1% | | 1 |
| STUDIO QUEEN QUEEN SHOWER | 1 | 3 | 4 | 3 | 0 | 0 | 11 | 9% | | 22 |
| STUDIO QUEEN QUEEN TUB | 1 | 1 | 1 | 1 | 1 | 1 | 6 | 5% | | 12 |
| COSTUM STUDIO QUEEN QUEEN TUB | 1 | 1 | 1 | 1 | 1 | 1 | 6 | 5% | | 12 |
| ACC.STUDIO QUEEN QUEEN | 1 | 0 | 0 | 1 | 0 | 0 | 2 | 2% | | 4 |
| ONE BEDROOM | 0 | 1 | 0 | 1 | 1 | 1 | 4 | 3% | 32% | 4 |
| ONE BEDROOM CONN. | 0 | 1 | 1 | 1 | 1 | 1 | 5 | 4% | | 5 |
| ACC.ONE BERDROOM | 0 | 0 | 1 | 0 | 0 | 0 | 1 | 1% | | 1 |
| CONFERENCE SUITE | 0 | 0 | 1 | 1 | 1 | 1 | 4 | 3% | | 4 |
| ACC. CONFERENCE SUITE | 0 | 1 | 0 | 0 | 0 | 0 | 1 | 1% | | 1 |
| FRAND TOTAL | 4 | 22 | 25 | 25 | 25 | 25 | 126 | 100% | 100% | 151 |

| SHOWER FIXTURE | E TYPE MATRIX | | F |
|---------------------|---------------|------|--------------------|
| SHOWER | 107 | 85% | 1ST LEVEL FLOOR PL |
| TUB | 12 | 10% | 2ND LEVEL FLOOR PI |
| ACC. TUB | 0 | 0% | 3RD LEVEL FLOOR PL |
| ACC, ROLL IN SHOWER | 2 | 2% | 4TH LEVEL FLOOR PL |
| TRANSFER SHOWER | 5 | 4% | 5TH LEVEL FLOOR PL |
| TOTAL | 126 | 100% | 6TH LEVEL FLOOR PL |
| | | | 7TH LEVEL FLOOR PL |

| 0 | 1 | 1% | | 1 |
|-------|------------|----------|---------|--------|
| 25 | 126 | 100% | 100% | 151 |
| | | FLOOR AR | EA (SF) | |
| STLEV | EL FLOOR F | LAN | | 15,224 |
| NDLE | VEL FLOOR | PLAN | | 14,342 |
| RDLE | /EL FLOOR | PLAN | | 14,342 |
| THLEN | EL FLOOR F | PLAN | | 14,342 |
| THLEV | EL FLOOR F | 14,342 | | |
| THLEV | EL FLOOR F | LAN | | 14,342 |
| _ | | | | |





ALLEN SIGMON REAL ESTATE GROUP 9201 MONTGOMERY BLVD, NE BLDG 1 ALBUQUERQUE, NM 87111



ELEMENT ALBUQUERQUE,NM

No. ISSUE DATE | PROJECT STATUS

DATE 2020.01.17 DRAWN BY SG CHECKED BY DH SCALE AS NOTED PROJECT NO.

B4 - 176 - 1901

SHEET NAME

FLOOR PLAN

A2.7



| | | ND-EX | CTERIOR ES | |
|------|---------------------------|----------|---|------------|
| CODE | MTL-TYPE | COLOR | MATERIAL NAME | MATERIAL 9 |
| 01 | EIFS-DRYVIT | STATE OF | ELEM-01-2738-WHITE | 31 % |
| 02 | EIFS-DRYVIT | N. C. | ELEM-02-1022-DARK GREY | 36 % |
| 03 | EIFS-DRYVIT | | ELEM-03-1022-GREEN | 0 % |
| 04 | ALCOA- BUILDING PANELS | | COLORWELD 500XL-BRIGHT SELVER METALLIC | 21 % |
| 05 | ALCOA- BUILDING PANELS | | WOOD FINISH SCOTISH OAK (D 8115 MR) | 12 % |
| 06 | ALCOA- BUILDING PANELS | | WOOD FINISH ITALIAN WALNUT | 12 76 |
| | , | | TOTAL | 100% |



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ALLEN SIGMON REAL ESTATE GROUP 9201 MONTGOMERY BLVD, NE BLDG 1 ALBUQUERQUE, NM 87111



ELEMENT ALBUQUERQUE,NM

| No. | ISSUE DATE | PROJECT STATUS | | |
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| DATE | 2020.01.17 |
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| CHECKED BY | DH |
| SCALE | AS NOTED |
| PROJECT NO. | B4 - 176 - 1901 |
| SHEET NAME | |

ELEVATIONS

DRAWING NO.

A3.1





| | | ND-EX | TERIOR ES | |
|------|---------------------------|-------|---|------------|
| CODE | MTL-TYPE | COLOR | MATERIAL NAME | MATERIAL 9 |
| 01 | EIFS-DRYVIT | | ELEM-01-2738-WHITE | 59 % |
| 02 | EIFS-DRYVIT | | ELEM-02-1022-DARK GREY | 9 % |
| 03 | EIFS-DRYVIT | | ELEM-03-1022-GREEN | 0 % |
| 04 | ALCOA- BUILDING PANELS | | COLORWELD 500XL-BRIGHT SILVER METALLIC | 9% |
| 05 | ALCOA- BUILDING PANELS | | WOOD FINISH SCOTISH OAK (D 8115 MR) | 23 % |
| 06 | ALCOA- BUILDING PANELS | HS. | WOOD FINISH ITALIAN WALNUT | 2376 |
| | | | TOTAL | 100% |

LEGEND-EXTERIOR FINISHES

COLOR

MATERIAL NAME

ELEM-02-1022-DARK GREY

WOOD FINISH SCOTISH OAK (D 8115 MR)

TOTAL

ELEM-01-2738-WHITE

ELEM-03-1022-GREEN COLORWELD 500XL-BRIGHT SILVER METALLIC

WOOD FINISH ITALIAN WALNUT

MATERIAL %

61 %

24 %

0 %

1%

14 %

100%

CODE MIL-TYPE

01 EFS-DRYVIT

02 EIFS-DRYVIT

03 EIFS-DRYVIT

04 ALCOA-BUILDING PANELS

05 ALCOA-BUILDING PANELS

06 ALCOA-BUILDING PANELS



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ELEMENT ALBUQUERQUE,NM

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ELEVATIONS



| | | | 01 | | PARAPET 1 + 68- | |
|--|----|--|----|--|---------------------------|--|
| | | | | | 21 91 | |
| | | | | | SIXTH FLOOR +56'-9' | |
| | | | | | FIFTH FLOOR +46-21/2 | |
| | 06 | | | | FOURTH FLOOR +35-8" | |
| | | | | | 27.8-01. | |
| | | | | | THIAD FLOOR +25-1 1/2* | |
| | | | | | SECOND FLOOR +14-7* | |
| | | | | | <u> </u> | |

3

NOTICE TO CONTRACTORS

AN EXCAVATION/CONSTRUCTION PERMIT WILL BE REQUIRED BEFORE BEGINNING ANY WORK WITHIN BERNALILLO COUNTY ROW. AN APPROVED COPY OF THESE PLANS MUST BE SUBMITTED AT THE TIME OF APPLICATION FOR THIS PERMIT.

2. ALL WORK DETAILED ON THESE PLANS TO BE PERFORMED, EXCEPT AS OTHERWISE STATED OR PROVIDED HEREON, SHALL BE CONSTRUCTED IN ACCORDANCE WITH NEW MEXICO STANDARD SPECIFICATIONS FOR PUBLIC WORKS CONSTRUCTION, MOST RECENT EDITION,

3. TWO WORKING DAYS PRIOR TO ANY EXCAVATION, CONTRACTOR MUST CONTACT LINE LOCATING SERVICE, 260-1990, FOR LOCATION OF EXISTING UTILITIES.

4. PRIOR TO CONSTRUCTION, THE CONTRACTOR SHALL EXCAVATE AND VERIFY THE HORIZONTAL AND VERTICAL LOCATIONS OF ALL PERTINENT EXISTING UTILITIES, AND/OR OBSTRUCTIONS. SHOULD A CONFLICT EXIST, THE CONTRACTOR SHALL NOTIFY THE ENGINEER SO THAT THE CONFLICT CAN BE RESOLVED WITH A MINIMUM AMOUNT OF DELAY.

5. BACKFILL COMPACTION SHALL BE ACCORDING TO ARTERIAL STREET USE.

 $\boldsymbol{6}.$ MAINTENANCE OF THESE FACILITIES SHALL BE THE RESPONSIBILITY OF THE OWNER OF THE PROPERTY SERVED.

7, WORK ON ARTERIAL STREETS SHALL BE PERFORMED ON A 24-HOUR BASIS.

8. CONTRACTOR SHALL DETERMINE LOCATION OF ANY UNDERGROUND FACILITY IN OR NEAR WORK AREAS, INCLUDING REQUESTS TO OWNERS/OPERATORS OF SAID FACILITIES PER SECTION 82-14-5 MMSA 1978.

9. CONTRACTOR SHALL PLAN ALL EXCAVATION TO MINIMIZE INTERFERENCE OR DAMAGE OF UNDERGROUND FACILITIES.

10. CONTRACTOR SHALL PROVIDE ADVANCE TELEPHONE NOTICE OF COMMENCEMENT, EXTENT 10, CONTRACTOR SHALL PROVIDE ADVANCE TELEPHONE NOTICE OF COMMENCEMENT, EXTENT AND DURATION OF ALL EXCAVATION WORK TO THE ONE-CALL NOTIFICATION SYSTEM, OR TO OWNERS/OPERATORS OF ANY EXISTING UNDERGROUND FACILITY IN OR NEAR THE EXCAVATION AREA THAT ARE NOT MEMBERS OF THE ONE-CALL NOTIFICATION CENTER; IN ORDER THAT OWNERS/OPERATORS ANAL LOCATE AND MARK UNDERGROUND FACILITY PER SECTION 62-14-5 NNSA 1978 PRIOR TO ANY COMMENCEMENT OF WORK. CONTRACTOR SHALL STANDARD FOR THE PROVINCE OF CONTRACTOR SHALL SHA REQUEST REAFFIRMATION OF LOCATION EVERY TEN (10) WORKING DAYS AFTER INITIAL

REQUEST.

11. CONTRACTOR SHALL MAINTAIN EIGHTEEN (18) INCHES BETWEEN EXISTING UNDERGROUND FACILITIES THAT HAVE BEEN PREVIOUSLY IDENTIFIED AND MARKED BY THE OWNERS/OPERATORS OF SAID FACILITIES. CUTTING EDGE OR POINT OF ANY MECHANICAL EXCAVATION AGE WILL BE USED IN A MAINNER RECESSARY TO PREVENT DAMAGE TO EXISTING UNDERGROUND FACILITIES.

12. CONTRACTOR SHALL PROVIDE SUPPORT FOR EXISTING UNDERGROUND FACILITIES IN OR NEAR EXCAVATION AREA AS NECESSARY TO PREVENT DAMAGE TO SAID FACILITIES.

13. CONTRACTOR SHALL BACKFILL ALL EXCAVATIONS IN A MANNER AND WITH MATERIALS AS MAY BE NECESSARY TO PREVENT DAMAGE TO AND PROVIDE RELIABLE SUPPORT DURING AND FOLLOWING BACK FILLING ACTIVITIES FOR PREEXISTING UNDERGROUND FACILITIES IN OR NEAR EXCAVATION AREA.

14, CONTRACTOR SHALL IMMEDIATELY NOTIFY BY TELEPHONE THE OWNER/OPERATOR OF ANY UNDERGROUND FACILITY WHICH MAY HAVE BEEN DAMAGED OR DISLODGED DURING EXCAVATION WORK.

15. CONTRACTOR SHALL NOT MOVE OR OBLITERATE MARKINGS MADE PURSUANT TO CHAPTER 82, ARTICLE 14 NMSA 1978, OR FABRICATE MARKINGS IN A UMANASCED LOCATION FOR THE PURPOSE OF CONCEALING OR AVOIDING LUBLILTY FOR VIOLATION OF OR NONCOMPLIANCE WITH THE PROVISIONS OF CHAPTER 82, ARTICLE 11 NMSA 1978.

16. ELECTRONIC MARKER SPHERES (EMS) SHALL BE INSTALLED ON WATER LINE AND SANITARY SEWER LINE FACILITIES PER SECTION 170 OF THE BERNALILLO COUNTY STANDARD SPECIFICATIONS 1986 EDITION AS REVISED THROUGH UPDATE #8.

17. THE CONTRACTOR SHALL COORDINATE WITH THE WATER UTILITY AUTHORITY SEVEN (7) DAYS IN ADVANCE OF PERFORMING WORK THAT WILL AFFECT THE PUBLIC WATER OR SANITARY SEWER INFRASTRUCTURE. WORK REQUIRING SHUTOFF OF FACILITIES DESIGNATED AS MASTER PLAN FACILITIES MUST BE COORDINATED WITH THE WATER AUTHORITY 14 DAYS IN ADVANCE OF PERFORMING SUCH WORK, ONLY WATER AUTHORITY CREWS ARE AUTHORIZED TO OPERATE PUBLIC VALVES.

18. ALL EXCAVATION, TRENCHING, AND SHORING ACTIVITIES MUST BE CARRIED-OUT IN ACCORDANCE WITH OSHA 29 CFR 1926.6150 SUBPART P.

19. ALL IMPACTED STRIPING SHALL BE REPLACED BY CONTRACTOR.

20. MANHOLE STEPS SHALL NOT BE INSTALLED IN SANITARY SEWER MANHOLES.

21. ALL WATER METERS SHALL INCLUDE DUAL CHECK VALVE SETTERS.


22. ALL WATER METER COVERS AND LIDS SHALL BE PER TOWN OF BERNALILLO STANDARDS.

23. ALL MANHOLES AND VALVES SHALL HAVE GPS INFORMATION RECORDED AS PART OF AS BUILT PLAN SET.

24. CONTRACTOR SHALL VERIFY ALL EXISTING CONNECTIONS PRIOR TO CONSTRUCTION. CONTRACTOR SHALL NOTIFY ENGINEER OF THE HORIZONTAL AND VERTICAL LOCATION PRIOR TO CONSTRUCTION.

CAUTION:

EXISTING UTILITIES ARE NOT SHOWN.
IT SHALL BE THE SOLE RESPONSIBILITY
OF THE CONTRACTOR TO CONDUCT ALL
NECESSARY FIELD INVESTIGATIONS PRIOR
TO ANY EXCAVATION TO DETERMINE THE
ACTUAL LOCATION OF UTILITIES & OTHER
IMPROVEMENTS.

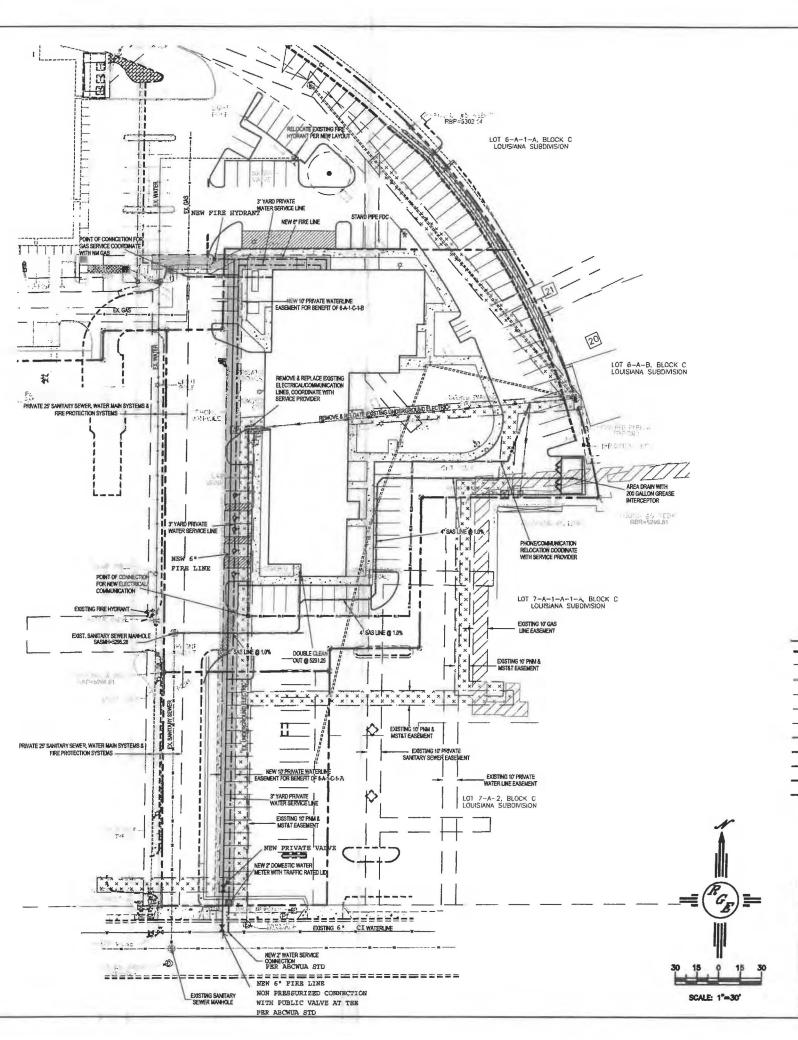



THE CONTRACTOR SHALL COORDINATE WITH THE WATER UTILITY AUTHORITY SEVEN (7) DAYS IN ADVANCE OF PERFORMING WORK THAT WILL AFFECT THE PUBLIC WATER OR SANITARY SEWER INFRASTRUCTURE. WORK REQUIRING SHUTOFF OF FACILITIES DESIGNATED AS MASTER PLAN FACILITIES MUST BE COORDINATED WITH THE WATER AUTHORITY 14 DAYS IN ADVANCE OF PERFORMING SUCH WORK. ONLY WATER AUTHORITY CREWS ARE AUTHORIZED TO OPERATE PUBLIC VALVES.

LEGEND

| | BOUNDARY | C8 = CLIRB BPOND = BOTTOM OF POND |
|-------------|-------------------------------------|---|
| | ADJACENT BOUNDARY | DRN × DRAIN EC = EDGE OF CONCRETE FF = FINISHED FLOOR |
| | EXISTING CURB AND GUTTER | FL = FLOW LINE G = GROUND |
| — ss — — — | EXISTING SANITARY SEWER | N&D = NAIL & DISC RMP = RAMP |
| w | EXISTING WATER LINE | SASMH = SANITARY SEWER MANHOLE TA = TOP OF ASPHALT |
| aa_ | PROPOSED SANITARY SEWER | |
| - SA3 - SA3 | PROPOSED SANITARY SEWER | ₩ * WATER VALVE |
| | PROPOSED ELECTRIC LINE | C) = WATER METER (5) = SANITARY SEWER MANHOLE |
| - FP FP | PROPOSED FIRE PROTECTION LINE | STORM DRAIN MANHOLE |
| — w — w — | PROPOSED WATER LINE | ELECTRIC MANHOLE PHONE MANHOLE |
| GAS GAS | PROPOSED GAS LINE | |
| | PROPOSED 10' PRIVATE WATER EASEMENT | |
| | | |



DAVID SOULE P.E. #14522

2440 LOUISIANA BLVD.

UTILITY PLAN


OLIFSIANIA BLVD.DH SHEET # Rio Granda CS

Engineering

JOB#

BY DEM

DATE 10-24-19

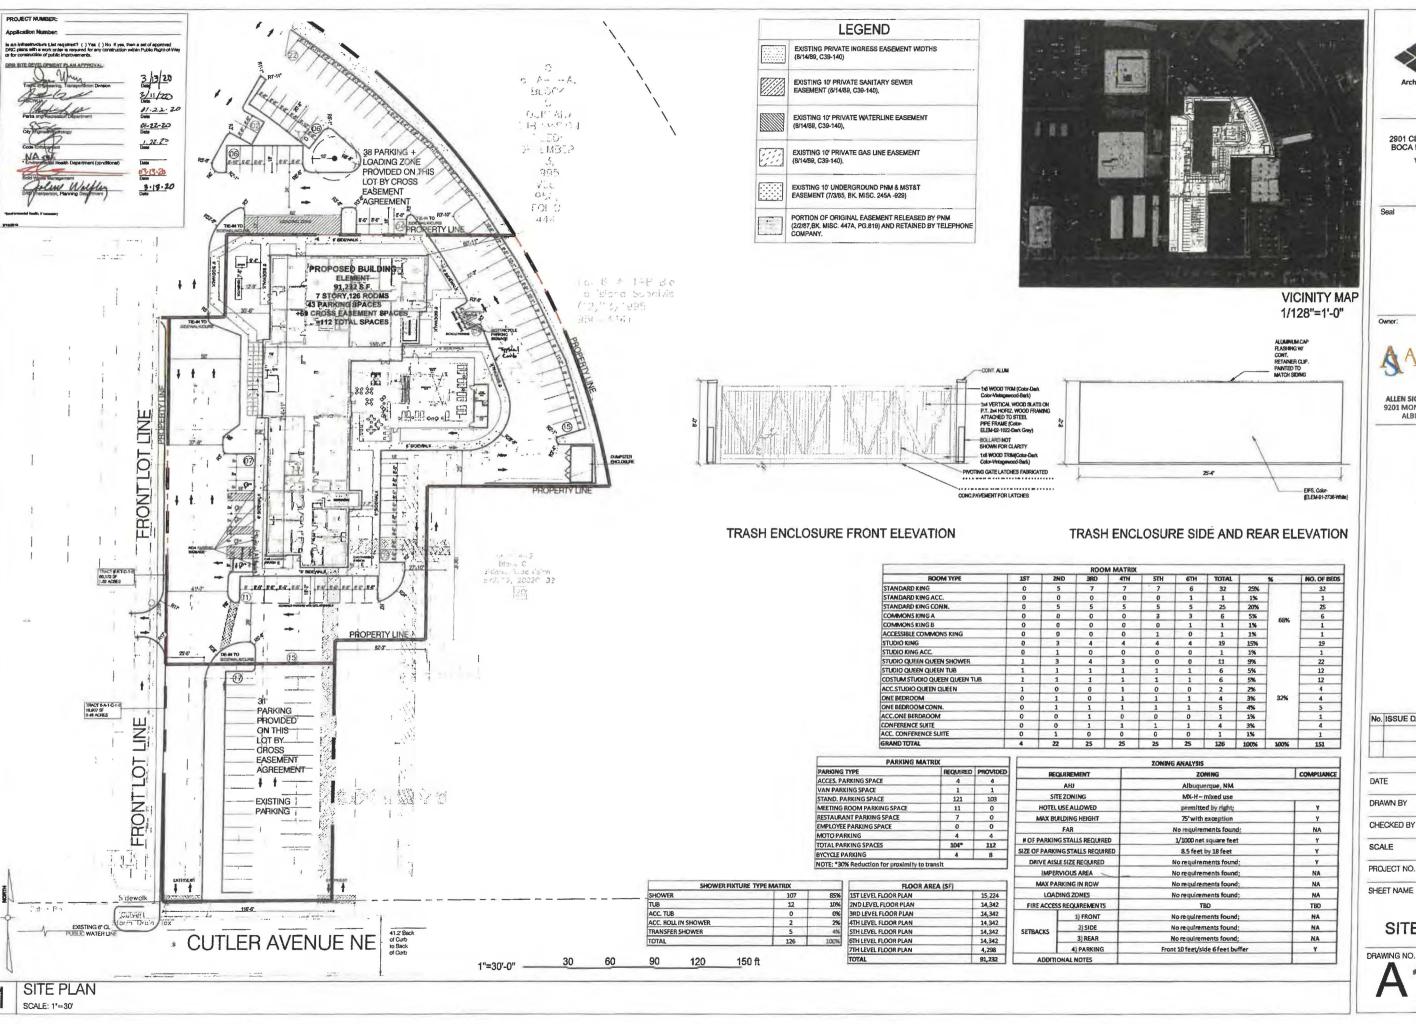

Architects Engineers Interiors

BASE4 2901 CLINT MOORE ROAD #114 BOCA RATON, FLORIDA 33496 www.base-4.com



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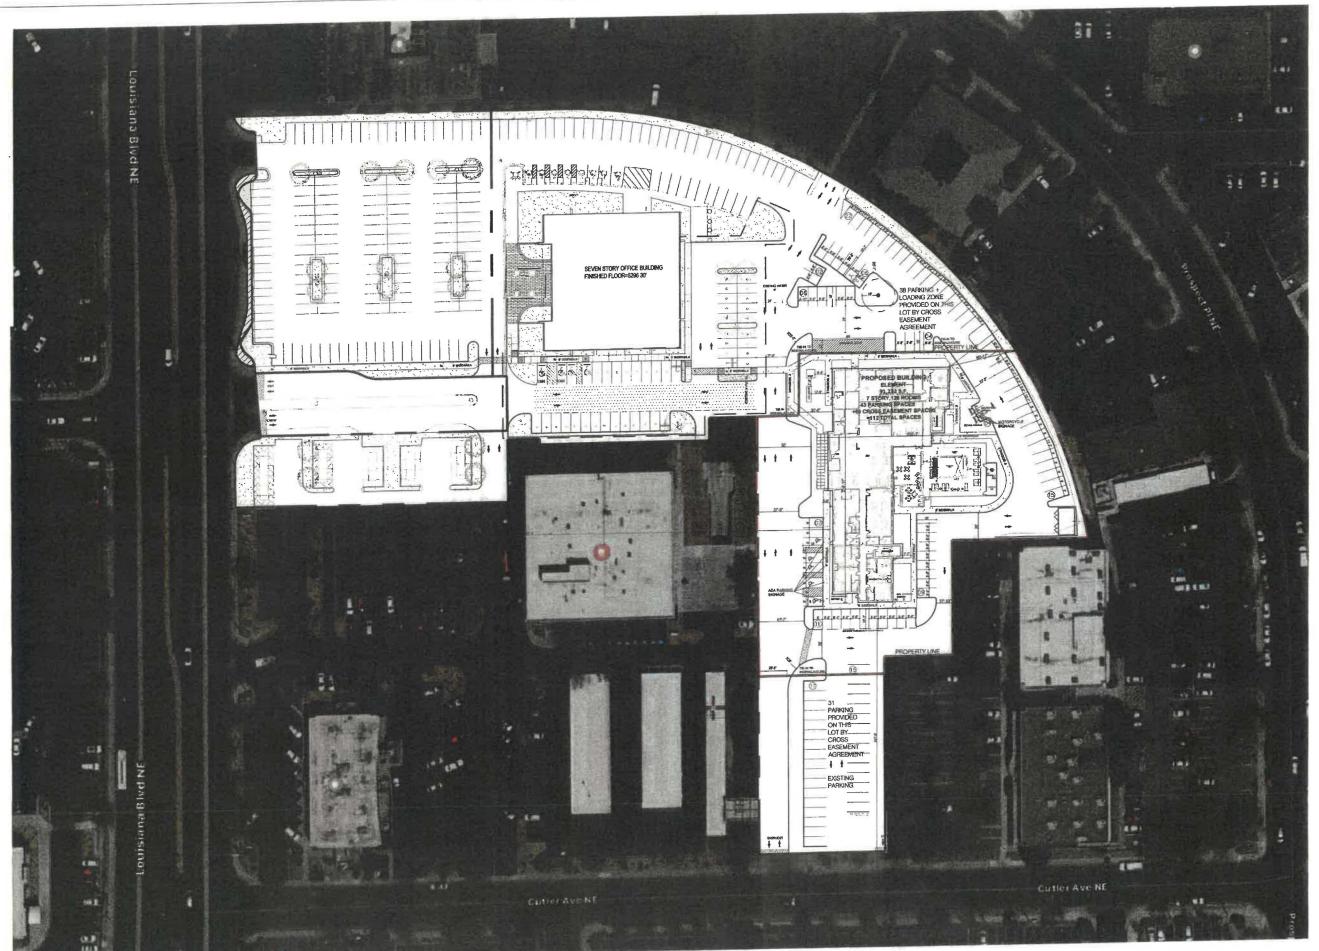


ELEMENT ALBUQUERQUE,NM

| No. | ISSUE DATE | PROJECT STATUS |
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2020.01.17 DRAWN BY SG CHECKED BY DH AS NOTED SCALE PROJECT NO. B4 - 176 - 1901

SITE PLAN







ALLEN SIGMON REAL ESTATE GROUP 9201 MONTGOMERY BLVD, NE BLDG 1 ALBUQUERQUE, NM 87111



ELEMENT ALBUQUERQUE,NM


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2020.01.17 DATE DRAWN BY SG CHECKED BY DH AS NOTED SCALE PROJECT NO. B4 - 176 - 1901

SHEET NAME

MASTER PLAN

DRAWING NO.

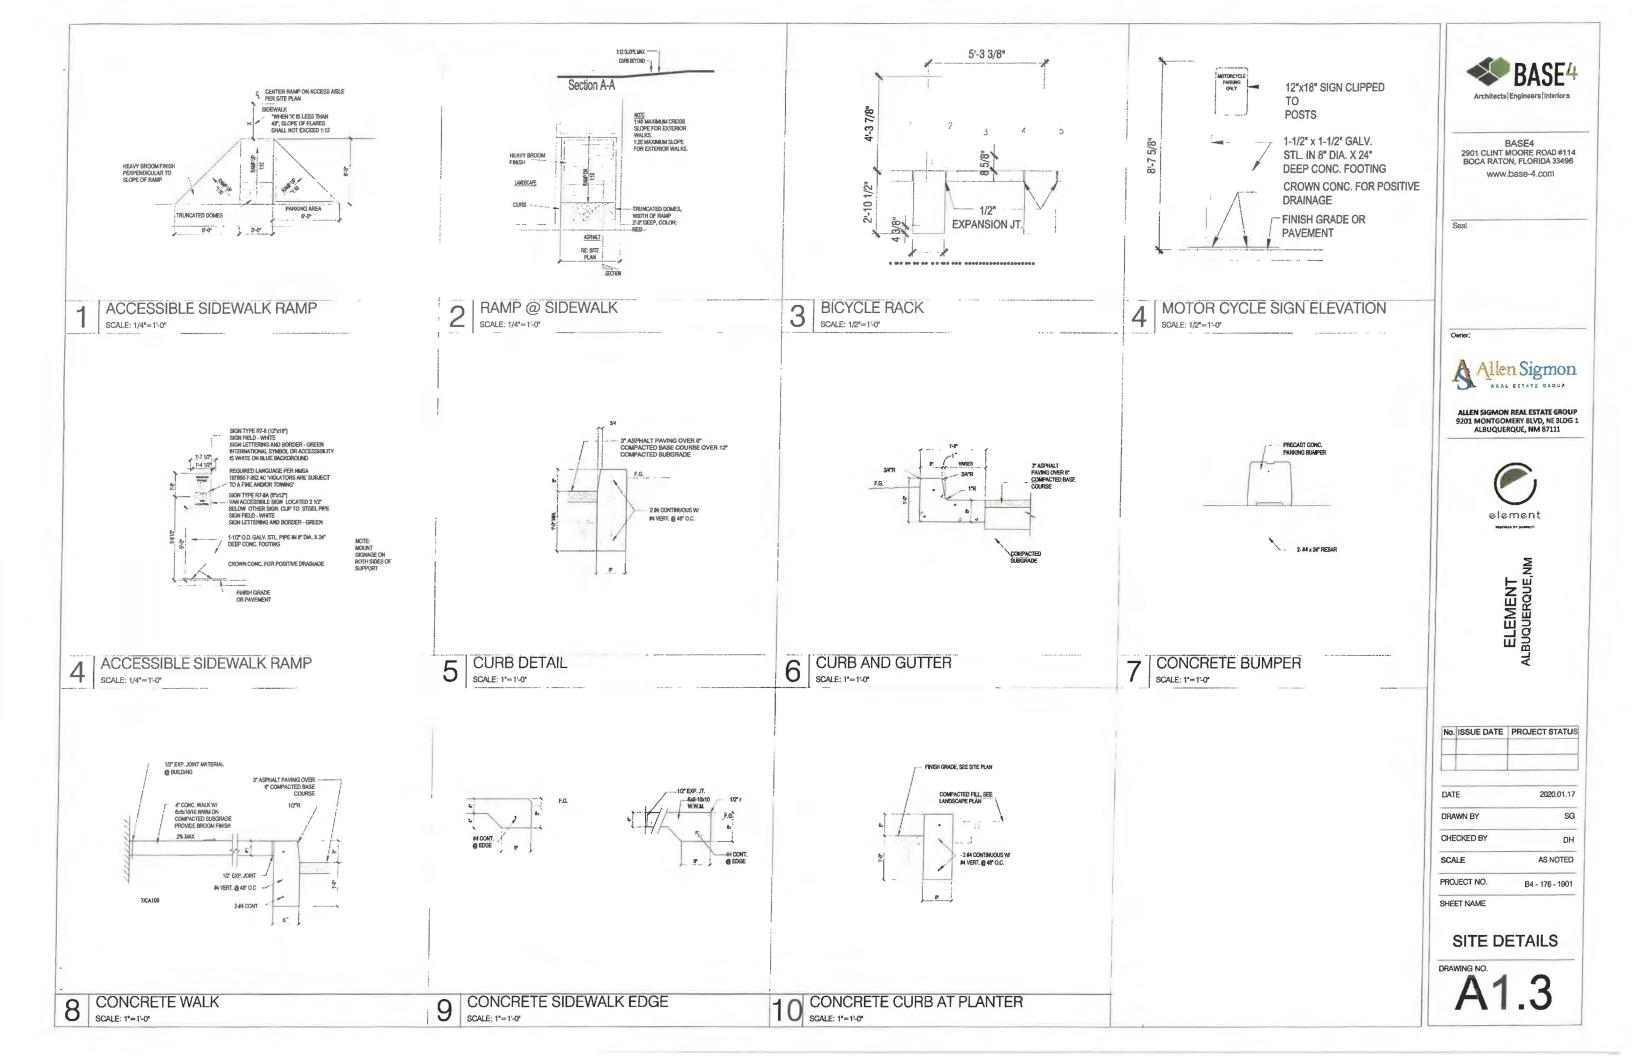

GENERAL NOTES

- COORDINATION: ALL ELECTRICAL WORK SHALL BE COORDINATE THROUGH THE CODE COMPLIANCE, ALL ELECTRICAL WORK SHALL COMPLY WITH OR SURPASS THE REQUIREMENTS OF THE NATIONAL ELECTRICAL CODE, NFPA 70, AND THE LATEST EDITION OF NESC. ALL WORK SHALL COMPLY WITH ALL APPLICABLE SERVING POWER AND COMMUNICATION UTILITIES CODES, ORDINANCES, RULES AND REQUIATION
- MEET ALL REQUIREMENTS: ALL WORK SHALL MEET THE REQUIREMENTS OF THE AFORE MENTIONED CODES AND ALL CODES AND STANDARDS REFERENCED IN THE SPECIFICATION, ALTHOUGH THE DETAILS OF SUCH WORK MAY NOT BE SHOWN ON THE
- INGS OR REFERENCED IN THE SPECIFICATIONS CONFLICTS: CONFLICTS BETWEEN THE APPLICABLE CODES, STANDARDS AND THE PLANS AND SPECIFICATION MUST BE BROUGHT TO THE ATTENTION OF THE
- CONFLICTING STANDARDS: IN THE CASE OF CONFLICT BETWEEN THE CONTRACTOR DOCUMENTS AND A GOVERNING CODE OR ORDINANCE, THE MORE STRINGENT STANDARD SHALL APPLY.
- ACCEPTANCE OF CONDITIONS: INTIATING WORK CONSTITUTES SUBCONTRACTOR ACCEPTANCE OF THE EXISTING CONDITION ASSOCIATED WITH THE WORK IN QUESTION.
- TRADE LICENSE: THE ELECTRICAL SUBCONTRACTOR SHALL BE CURRENTLY LICENSED TO PERFORM THIS WORK WITHIN THE JURISDICTION HAVING AUTHORITY. ALL RECURED LICENSING SHALL BE MAINTAINED THROUGHOUT THE DURATION OF THE WORK.
- SAFE: THE ELECTRICAL SUBCONTRACTOR IS RESPONSIBLE FOR OVERSEEING THE SAFE SAPE: THE ELECTHICAL SUBCONTRACTOR IS REPORTINGHER FOR OFFSECHEM ITERS AND OPERATION OF ALL ECUMPATENT IN HIS USE. THE ELECTRICAL SUBCONTRACTOR IS RESPONSIBLE FOR MAINTAINING ALL OF THE ECULPMENT IN HIS USE IN A SAFE CONDITION. KEEP DEAD FRONT ECUMPATENT IN PLACE WHICH ECULPMENT IS ENERGIZED. CONDUCT ALL CONSTRUCTION OPERATION IN A SAFE MANNER FOR EMPLOYEES. AS WELL AS OTHER WORK PERSONS OR ANYONE VISITING THE JOB SITE. PROVIDE BAPAIERS, FLAGS, TAPE, ETC.. AS REQUIRED FOR SAFETY.
 ALL ELECTRICANS MUST FERFORM THER WORK IN ACCORDANCE TO THE GUIDELINES SET FORTH BY THE NFPA TOE.
- SET FORTH BY THE MYPA 782.

 PROFESSIONALISM AND APPEARANCE OF WORK: WORKMANSHIP OF ALL INSTALLATION SHALL BE IN ACCOPROMICE WITH ACCEPTED PRACTICES OF THIS TRADE. INSTALLATION METHODS SHALL COMFORM TO MANUFACTURERS SPECIFICATION. THE SUBCONTRACTOR TRADE FOR THE DURATION OF THE JOB WITH QUALIFIED JOURNEYMEN AND EMPLOYEES IN THIS TO COMMANINICATE WITH AND KEEP THE DESIGNIBUILD CONTRACTOR APPRAISED OF CHANGES OR CLARIFICATIONS.
- WORKMANSHIP: ALL ELECTRICAL EQUIPMENT SHALL BE INSTALLED IN A NEAT, DURABLE,
- STORAGE AND EQUIPMENT STORAGE OF EQUIPMENT FOR THE JOB IS THE RESPONSIBILITY OF THE ELECTRICAL SUBCONTRACTOR AND SHALL BE SCHEDULED FOR DELIVERY TO THE STEE AS THE EQUIPMENT IS REQUIRED, DAMAGE TO THE ECOMPMENT DELIVERED TO THE STEE ON IN TRANSPORT TO THE JOB SHALL BE THE RESPONSIBILITY THE ELECTRICAL SUBCONTRACTOR.
- THE ELECTRICAL SUBCONTRACTOR.

 UTILITY COORDINATION: ELECTRICAL SUBCONTRACTOR SHALL CONTACT ALL UTILITIES AND VERRY ALL UTILITY REQUIREMENTS PROR TO COMMENCING OR ORDERING ANY MATERIALS WHATSOEVER. CONFLICTS BETWEEN UTILITY REQUIREMENTS AND THE PLANS OR SPECIFICATIONS SHALL BE BROUGHT TO THE ATTENTION OF OF THE DESIGN, BUILD CONTRACTOR PRIOR TO COMMENCING CONSTRUCTION OR ORDERING ANY MATERIALS WHATSOEVER, SUBCONTRACTOR SHALL CALL FOR A PRE-CONSTRUCTION FACE-TO-ACE MEETING WITH THE UTILITY COMPANIES TO REVIEW REQUIREMENTS AND PLANS.
- METHODS OF CONSTRUCTION. UNLESS OTHERWISE NOTEO OR SHOWN , THESE DRAWINGS AND SPECIFICATIONS DO NOT INDICATE METHODS OF CONSTRUCTION . THE SUBCONTRACTOR SHALL SUPERVISE AND DRECT THE WORK, AND BE SOLELY RESPONSIBLE FOR ALL CONSTRUCTION BEANS, METHODS, TECHNIQUES, SEQUENCES, PROCEDURES AND SAFE WORK PRACTICES.
- THE EXACT LOCATION AND THE APPLANGEMENTS OF ALL PARTS SHALL BE DETERMINED AS THE WORK PROGRESSES. THE SUBCONTRACTOR SHALL BE RESPONSIBLE FOR PROVIDING A COMPLETE AND FUNCTIONAL ELECTRICAL SYSTEM.
- INCIDENTAL ITEMS: INCIDENTAL ITEMS NOT INDICATED ON DRAWINGS, NOT MENTIONED IN THE SPECIFICATIONS THAT CAN BE LEGITIMATELY AND REASONABLY INFERRED TO BELLONG TO THE WORK DESCRIBED OR NECESSARY IN GOOD PRACTICE TO PROVIDE A COMPLETE SYSTEM, SHALL BE FURNISHED AND INSTALLED AS TOUGH ITEMIZED HERE IN
- DAMAGE RESPONSIBILITY: THE SUBCONTRACTOR SHALL BE RESPONSIBLE FOR ANY LOSS OR DAMAGE CAUSED BY HIM OR HIS WORKMEN TO THE FACILITY DURING THE COLORSE OF CONSTRUCTION, AND SHALL BE FLILLY RESPONSIBLE FOR REPAIRING OF REPLACING AS REQUIRED TO INSURE RESTORATION TO ORIGINAL CONDITION.
- 17. COMPLETE AND FUNCTIONAL SYSTEM: SUBCONTRACTOR SHALL FURNISH MATERIALS. TOOLS, SERVICES, LABOR, ETC. FOR A COMPLETE AND FULLY FUNCTIONAL ELECTRICAL INSTALLATION UNLESS OTHERWISE NOTED ON PLANS.
- COORDINATION WITH OTHER TRADES: THE SUBCONTRACTOR SHALL BE RESPONSIBLE FOR COORDINATING ALL ELECTRICAL INSTALLATION WITH ALL OTHER TRADES TO AVOID SUBCONTRACTOR SHALL DETERMINE EXACT LOCATION IN THE FIELD, FEEDERS SHALL NOT BE INCREASED IN LENGTHS SHOWN WITHOUT ENGINEERING APPROVAL
- FOLEPMENT OUTDOOR RATINGS: ALL ELECTRICAL EQUIPMENT EXPOSED OR INSTALLED
- SUBMITTAL ISHOP DRAWINGS: ALL SUBMITTAL ISHOP DRAWINGS SHALL CONTAIN COMPLETE INFORMATION NECESSARY TO DETERMINE THAT THE ITEM IS APPROPRIATE FOR THE PURPOSE INTENDED, ALL'SUBBRITA ISHOP DRAWINGS SHALL CONTAIN THE MANUFACTURES CONTACT PERSON AND CURRENT TELEPHONE NUMBER.
- INDICATED LOCATION OF EQUIPMENT LOCATION OF EQUIPMENT CONDUIT, AND DEVICES SHOWN ON THE DRAWINGS ARE APPROXIMATE AND SHALL BE COORDINATED WITH THE CIVIL AND ARCHITECTURAL DRAWINGS.
- NRTL LISTING: ALL ELECTRICAL EQUIPMENT SHALL BE NEW ,IN FIRST CLASS CONDITION AND LISTED BY NATIONALLY RECOGNIZED TESTING LABORATORY (INRIL)SUCH AS U.L. IF SUCH A LISTING EXIST FOR COMPARABLE EQUIPMENT.
- GENERAL SUBCONTRACTOR WORK: ELECTRICAL SUBCONTRACTOR IS RESPONSIBLE GENERAL SUBCONTINUOLINA WORKER ELECTRICAS DISCONTINUOLIN TO HER PROTECTION OF A GENERAL CONTRACTING NATURE SPECIFED ON ELECTRICAL PLANS INCLUDING BUT NOT NECESSARILY LIMITED TO THE FOLLOWING.

 A CONCRETE FOOTINGS INCLUDING REBAR AND MOUNTING BOLTS FOR PLACEMENTS OF LIGHTS ENTURE POLES.

 - C. SUPPLY AND INSTALLATION OF ALL EQUIPMENT PADS AND SPLICE BOXES UNLESS
- WORKING SPACE :WORKING SPACE SHALL MEET OR EXCEED THE NEC REQUIREMENT FOR ALL ELECTRICAL EQUIPMENT. (SEE NFPA 70-2005, SEC 110-26)
- EQUIPMENT ACCECIBILITY :IT SHALL BE THE RESPONSIBILITY OF SUBCONTRACTOR TO SEE THAT ALL THE ELECTRICAL EQUIPMENT SHALL BE MADE ACCESSIBLE, SUCH AS JUNCTION BOXES. PULL BOXES PANELBOARDS, SWITCHES CONTROLS AND SUCH OTHER APPARATUS AS MAY REQUIRE MAINTENANCE AND OPERATION FROM TIME TO

- 27. EQUIPMENT PROTECTION: AFTER INSTALLATION , ELECTRICAL EQUIPMENT SHALL BE PROTECTED TO PREVENT DAMAGE DURING THE CONSTRUCTION PERIOD OPENINGS IN CONDUITS AN BOXES SHALL BE CLOSED TO PREVENT THE ENTRANCE OF FOREIGN
- 28. AS BUILD RECORD DRAWINGS: PROVIDE RECORD DRAWING TO THE D/B CONTRACTING OFFICER WITH ALL CHANGES NOTED THEREON AT THE COMPLETION OF THE PROJECT. RECORD DRAWINGS SHALL BE SIGN AND DATED BY SUBCONTRACTOR.
- 29. SHOP DRAWINGS:SUBMIT SHOP DRAWINGS AND MATERIALS LIST FOR REVIEW PRIOR TO COMMENCING ANY WORK, ALL EQUIPMENT TO BEAR U.L. LABEL OR THAT OF ANOTHER ACCEPTABLE. TESTING LABORATORY , WHEN SUCH LISTINGS D'AST. FOR COMPARABLE EQUIPMENT, SHOP DRAWING MUST BE STAMPED BY THE SUBCONTRACTOR FOR CONFORMANCE PRIOR TO SUBMITTIAL.
- 30 DIGGING PERMITS AND OUTAGE REQUESTS :ALL DIGGING PERMITS AND OUTAGE REQUESTS ARE THE RESPONSIBILITY OF THE SUBCONTRACTOR. COPIES SHALL BE PROVIDED TO THE DIE CONTRACTOR BEFORE CONSTRUCTION BEGINS.
- O DIGGING PERMITS AND OUTLAGE REQUESTS: ALL DIGGING PERMITS AND IDITAGE REQUESTS ARE THE RESPONSIBILITY OF THE SUBCONTRACTOR, COMES SHALL BE PROVIDED TO THE D/B CONTRACTOR BEFORE CONSTRUCTION BEGINS
- 31 ATTRACTIVE NUISANCES: OPEN TRENCHES, ELECTRICAL EQUIPMENT AND DEVICES SHALL NOT PRESENT AN ATTRACTIVE NUISANCE TO CHILDREN, ALL ELECTRICAL EQUIPMENT SHALL BE TOTALLY INACCESSIBLE, DEAD FRONT AND LOCKABLE.
- 12. ROUTING AND LOCATION: THE ROUTING OF THE NEW UNDERGROUND FEEDERS SHALL BE APPROVED BY AND COORDINATED WITH THE DESIGN/BUILD CONTRACTOR. EXCEPT FOR CROSSINGS, ELECTRICAL AND COMMUNICATIONS UTILITIES SHALL NOT BE LOCATED UNDER STREETS.
- 33. UPON COMPLETION OF WORK THE SUBCONTRACTOR SHALL PROVIDE THE D/B CONTRACTOR WITH ONE (1) SPARE SET OF FUSES OF EACH SIZE AND TYPE INSTALLED
- ALTHE SUCCONTRACTOR IS RESPONSIBLE TO COORDINATE WITH THE DESIGN/BUILD CONTRACTOR FOR REMOVING, LOCATING, CAPPING AND OR RELOCATION OF ANY ELECTRIC FACILITIES WHICH ARE NOT TO REMAIN IN SERVICE AND TO INSTALL FACILITIES AS RECURRED TO MAINTAIN CONTINUOUS SERVICE TO DWELLING UNITS OR BUILDING STRUCTURES THAT WILL REMAIN,
- 35. NON-METALLIC WEATHERPROOF ENCLOSURES SHALL BE CONSTRUCTED OF GLASS FIBER REINFORCED POLYESTER RESIN, WITH PIGMENTED HEAT RESISTANT HIGH OLOSS SURFACING SEALER ON THE INTERIOR, WITH PIGMENTED, LUTRAVOLET LIGHT STABILIZED WEATHER RESISTANT SURFACE COAT ON THE EXTERIOR, EACH SECTION. STABILIZED WASHIER RESISTANT SOUTHOUR COMPONENTS JOINED BY BOLTING SHALL BE MOUDED IN ONE RECE, SECTIONAL COMPONENTS JOINED BY BOLTING RIVETING OF LISE OF ADHESIVES ARE NOT ACCEPTABLE. ALL HARDWARE SHALL CONSIST OF TYPE 304 STANLES STEEL AND SHALL INCLUDE PERTAGONAL BOLTS AND PROVISIONS FOR PADLOCKING, DIMENSIONS OF EXCLOSURES SHALL BE AS REQUIRED TO ACCOMMODATE EQUIPMENT ANDOR PUNCTIONS SPECIFIES, BUT IN NO CLASS
- 36. PROVIDE LOCKS AT ALL ELECTRICAL ENCLOSURES SUCH AS TRANSPORMERS, FUSE AND SPLICE CASINETS. LOCKS ARE TO BE COMPATIBLE WITH EXISTING LOCKS USED BY BASE ELECTRICAL.
- 37 PROVIDE ENGRAVED PLASTIC NAME PLATES FOR SWITCHBOARDS PANELS TERMINAL CABINETS, AND ANY OTHER MAJOR ELECTRICAL ITEM, SCREW-ON ATTACHMENT ONLY-
- 38. EQUIPMENT LOCATIONS ARE APPROXIMATE. EXACT ROUTING AND EQUIPMENT LOCATION IS TO BE COORDINATED WITH OTHER TRADES AND APPROVED BY THE DAY CONTRACTOR WHERE SHOWN EQUIPMENT IS TO BE CLUSTERED COORDINATE CLUSTERED LOCATIONS WITH LANDSCAPE CONTRACTOR FOR SHIELDING. MAINTAIN WORKING CLEARANCES. A MININUM DISTANCE OF 4 IS REQUIRED BETWEEN PRIMARY ELECTRICAL UNIONS AND WET UTILITIES.
- 39. TRENCHING IS TO AVOID DRIP LINES ON TREES AS SHOWN ON PLANS, ALL TRENCHING
- 40. STAKING OF ELECTRICAL EQUIPMENT PADS: ALL ELECTRICAL EQUIPMENT D. STAKING OF ELECTRICAL EQUIPMENT PADS: ALL ELECTRICAL EQUIPMENT, INCLUDING THANSFORMERS, SWITCHES, METERS, JUNCHION CASINERS, LIGHTING POLE BASES, ETC. ARE TO BE STAKED BY THE ASSIGNED PROJECT SUPPREYORS FOR FINAL ELEVATION, AND LOCATION OF PADS OR ANCHORS, ELEVATIONS ARE TO BE DETERMINED BY THE SITE CAIL DESIGN ENGINEER. IN CONSISTENCIES AND INTERFERENCES ARE TO BE REPORTED TO THE DIS CONTRACTION. THE ELECTRICAL SUBCONTRACTOR THE JUSTICAL STATE AS STAKED.
- 41. STAKING OF ELECTRICAL TRENCHES: AFTER ELECTRICAL TRENCHES ARE MARKED FOR ROUTING BY THE ELECTRICAL SUBCONTRACTOR, ARRANGEMENTS ARE TO BE MADE FOR THE ASSIGNED PROJECT SURVEYORS TO LOCATE THE MARKED ROUTE AND TRANSFER THIS INFORMATION TO THE SITE CIVIL DESIGN ENGINEER TO ASSIGN FINISH GRADES THESE FINISH GRADES SHALL BE TRANSFERRED BACK TO THE ASSIGNED PROJECT SURVEYOR TO PROVIDE TRENCH STAKING INDICATING FINAL GRADE TO INSURE THAT MINIMUM BURIAL DEPTHS ARE MAINTAINED. THE ELECTRICAL SUBCONTRACTOR IS TO VERIFY THAT TRENCH DEPTHS RELATIVE TO FINISH GRADE ARE AS STAKED.
- 42. ALL SPARE/EMPTY CONDUITS SHALL BE PROVIDED WITH A PULL LINE.
- 43 INSTALLATION GUIDELINES SHALL CONFIRM TO CURRENT NEPA 70 NEC.
- 44. ALL EQUIPMENT INCLUDING POLE RISERS, PAD MOUNTED GEAR, LIGHT POLES AND ISC.
- EQUIPMENT GROUNDING: ONE 3/4 INCH BY 10 FOOT COPPER CLAD GROUND ROD SHALL BE INSTALLED IN A CONDUIT WINDOW OF EACH EQUIPMENT PAD (WHERE THANKSCHMEN PADS HAVE MORE THAN ONE CONDUIT WINDOW. THE GROUND RODS SHALL BE INSTALLED IN SECONDARYLOW VOLTAGE WINDOW), ALL UNDERGROUND GROUNDING CONNECTIONS SHALL BE EXOTHERING TYPE CONNECTIONS.

LEGENDS

COMMUNICATIONS CONDUIT CONDUIT FOR BUILDING SIGNAGE NEMA 5-20R DUPLEX RECEPTACLE MOUNTED AT 15" AFF ON CENTER, UNO. GF = GROUND FAULT CIRCUIT INTERRUPTER WP - GROWND FALLT CIRCUIT INTERRUPTER TRANSFORMER GENERATOR MSB

ABBREVIATIONS

(J)

AVAILABLE FAULT CURRENT AVALABLE FAULT CURRENT
AMPERES INTERRUPTING CAPACITY
ABOVE FINISHED FLOOR
AMERICAN DISABILITIES ACT
AMP TRIP
AUTOMATIC TRANSFER SWITCH
AMERICAN WIRE GAUGE
BREAKER

JUNCTION BOX

AUTOMOTO

AMERICAN WIRE GAUSE
BREAKER
BREAKER
CONDUIT OR CONDUCTORAS APPLICABLE
CIRCUIT BREAKER
CIRCUIT BREAKER
CIRCUIT OR CONTROL POWER TRANSFORMER
TO CONTROL POWER TRANSFORMER
THE ELECTRICAL/BLECTRIC
BM ELECTRICAL/BLECTRIC
BM ELECTRICAL/BLECTRIC
BM ELECTRICAL/BLECTRIC
BM ELECTRICAL/BLECTRIC
BM ELAPM CONTROL PANEL
FLOORS CENT
GRIND GROUND
GEN GENERATOR
GEN GENERATOR
GEN GENERATOR
GENERATOR
GEN GENERATOR
GE

A GHOUND FAULT (CAHOUIT)
INTERRUPTED HAND HOLE?HIGH INTENSITY
DISCHARGE
HAND/OFF/AUTO
HORSE POWER
HOT WATER HEATER
SOLATE GROUND
INCANDESCENT
JUNCTION BOX
THOUSAND CIRCULAR MILES
KILOWATT HOT IS
KILOWATT HOT IS

KILOWATT HOUR

LIGHTS
MAIN CIRCUIT BREAKER
MOTOR CONTROL CENTER MAIN DISTRIBUTION PANEL METAL HALIDE OR MANHOLE-

METAL HALDE ON MANYOLE-AS APPLICABLE MAIN LUG ONLY NEUTRAL NATIONAL ELECTRICAL CODE NON FUSED NATIONAL FIRE PROTECTION ASSOCIATION

ASSOCIATION NIGHT LIGHT (UNSWITCHED CKT.) POLE PULL BOX

PILL BOX
PHASE
PANEL
POLYMINI, CHLORIDE
POWER
RECEPTACLE
RIGID GALVANIZED STEEL
SUPPLY FAN
SHELDED
SURGE PROTECTIVE DEVICE
SINGLE POLE, SINGLE THROW
SIRLES RATED AUFERBES
INTERPURITING CAPACITY
SWITCH
STRUCTURED WIRNING BOX
TELEPHONE
TELEPHONE TERMINAL BOARD
UNDERGROUND
UNDERGROUND
UNINTERRUPTABLE POWER SUPPLY
UNILESS OTHERWISE NOTED
WATTS
WEATHERPROOF

MANUFACTURER - EATON MCGRAW-EDISON CATALOG - GLEON-AF-03-LED-E1-T3-BK INPUT WATTAGE - 166 W COLOR TEMP - BLACK, 3000K FIXTURE - ALZ-01,ALZ-01A

MANUFACTURER - EATON/INVUE CATALOG - ABB-B2-LED-42-D1-S-DP INPUT WATTAGE - 32 W COLOR TEMP - DARK PLATINUM, 4000K FIXTURE - ALZ-02



BASE4 2901 CLINT MOORE ROAD #114 BOCA RATON, FLORIDA 33496 www.base-4.com

Seal



ALLEN SIGMON REAL ESTATE GROUP 9201 MONTGOMERY BLVD, NE BLDG 1 ALBUQUERQUE, NM 87111



ELEMENT ALBUQUERQUE,N

| No. | ISSUE DATE | PROJECT STATUS |
|-----|------------|----------------|
| | | |
| | | |

2020.01.16 SG DRAWN BY CHECKED BY DH SCALE AS NOTED PROJECT NO. B4 - 176 - 1901

SHEET NAME SITE LIGHTING NOTES AND ABBREVIATIONS

DRAWING NO.

SL001


SITE LIGHTING GENERAL NOTES:

CONTRACTOR SHALL CO-ORDINATE WITH OWNER/CIVIL ENGINEER FOR SITE LIGHTING DETAILS. BASE4 HAS PROPOSED PANEL FOR SITE POWER

LIGHTING NOT DESIGNATED FOR DUST-TO-DAWN OPERATION SHALL BE CONTROLLED BY EITHER A COMBINATION OF A PHOTOSENSOR AND A TIME SWITCH, OR AN ASTRONOMINAL TIME SWITCH, LIGHTING DESIGNATED FOR DESK-TO-DAWN OPEATION SHALL BE CONTROLLED BY AN ASTRONOMICAL TIME SWITCH OR PHOTOSENSOR, ALL TIME SWITCHES SHALL RETAIN PROGRAMMING AND THE TIME SETTING DURING LOSS OF POWER FOR A REPIGIO OF AT LEAST 10 HOURS, LIGHTING DESIGNATED TO OPERATE MORE THAN 2004 ONURS PER YEAR FOR UNCUSPED PARKING AREAS SHALL BE EQUIPPED WITH MOTION SENSORS THAT WILL REDUCE THE LUMINARIES POWER BY 33 PERCENT OR TURN OFF ONE THIRD THE LUMINARIES WHEN NO ACTIVITY IS

POLE BASE COVERS ARE TO BE INSTALLED SO THAT THE BASE COVER FITS FLUSH TO THE TOP OF THE CONCRETE BASE. LEVELING SHIMS AND NUTS SHALL NOT CAUSE A GAP BETWEEN THE POLE BASE AND THE BASE COVER.

ALL WIRING IS TO BE #12 AWG AND #12 AWG GROUND MINIMUM THHNVTHWN (90 DEG. C) IN 11 SCHEDULE 40 PVC (MINIMUM SIZE). TRENCH 30° DEEP CLEAN BACKFILL USING SITE MATERIALS CAN BE USED. PROVIDE PREMIUM BACKFILL WHERE SITE MATERIALS ARE NOT ACCEPTABLE FOR USE

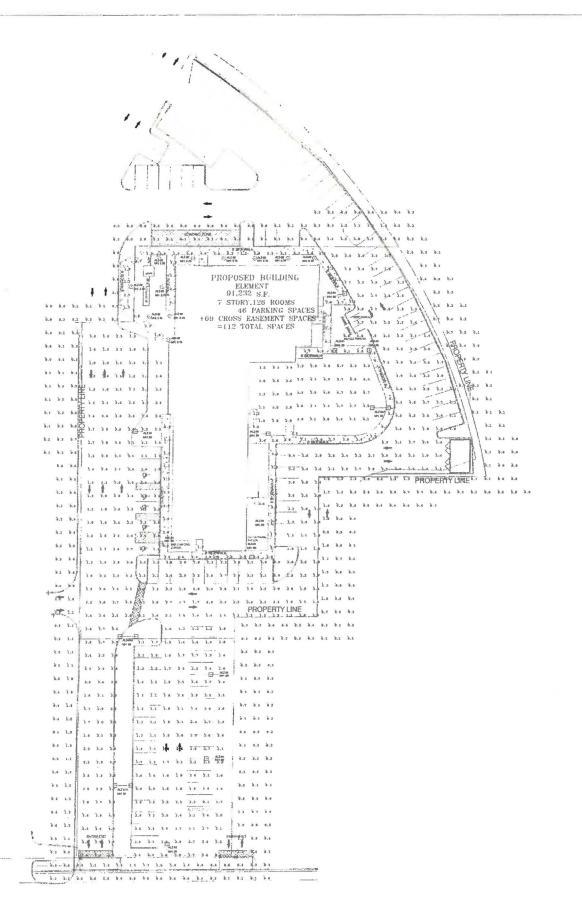

| | | | - ROUND TAPERED ALUMINUM POLE |
|----------------------------|-------------------------------|--|---|
| <i>\$</i> | REINFORCED HANDHOLE | | #12 CONDUCTORS UP TO FORTURE(S) |
| * | GROUNDING [] | | - IN-LINE FUSE |
| | CAST ALUMINUM NUT COVER | | 4 BOLT CIACLE PER |
| FINISH GRADE | ş (4 | | GROUT FILL |
|)r.d | 250 | | 1"CHAMFEREDEDGE |
| | | | - ANCHOR BOLLTS PER MANUFACTURER |
| | 8 | | SCH, 80 PVC CONDUIT REFER TO SITE OF CONDUITS |
| | | The same of the sa | ELECTRICAL PLAN FOR SIZE AND NUMBER |
| 3/45×10* (1900)02 | | | ROUND POLE BASE 4,500 PSI CONORETE |
| COPPERCUAD: GROUNDING R | STEEL | 4 | BEA. #6 VERTICAL BARS W/ #3 HORIZONTAL TIE BARS 12" O.C. |
| | 2'-0' | NOTE POLE BASE A | T POOL SHALL BE FLUSH WITH BASE |
| | POLE BASE DETAIL NOT TO SCALE | MA-JERIE FOUNDATION FLUSH | WITH GRACE |
| | | | |

| Calculation Sumi | mery | | | | | | |
|------------------|------------|-------|------|------|-----|---------|-----------|
| Label | CalcType | Units | Avg | Mex | Min | Avg/Min | : Max/Min |
| Outdoor Patio | fluminence | Fe | 3.25 | 4.8 | 1.0 | 3.25 | 4.80 |
| Outdoor Pool | Bluminance | Fc | 6.54 | 1122 | 3.0 | 2.18 | 4.07 |
| Parking | Numinance | Fc | 3.94 | 11.2 | 1.0 | 3.94 | 11.20 |
| Property Line | Muminance | Fc | 0.35 | 2.6 | 0.0 | N.A. | N.A. |
| Side Walk | Murrinance | i Fc | 4.92 | 12.5 | 1.0 | 4.92 | 12.50 |

| Symbol | Qty | Label | Arrangement | Total Lamp Lumens | TT. | Description | Filename | . Arm | Lum. Watts |
|--------|-----|---------|-------------|-------------------|-------|-----------------------|---------------------------|-------|------------|
| -[:] | 11 | ALZ-01 | SINGLE | N.A. | 0.900 | GLEON-AF-03-LED-E1-T3 | GLEON-AF-03-LED-E1-T3.ies | 2 | 166 |
| 0 | 111 | ALZ-02 | SINGLE | N.A. | 0.900 | ABB-B2-LED-D1-S | AB8-B2-LED-D1-S.ies | 10 | 32 |
| 1 | 3 | ALZ-01A | BACK-BACK | N.A. | 0.900 | GLEON-AF-03-LED-E1-T3 | GLEON-AF-03-LED-E1-T3.ies | 2 | 166 |

NOTE: MOUNTING HEIGHTS ARE MENTIONED NEAR FIXTURES IN THE DRAWING USING ABBR,MH:XX,X,EG,MH:20 INDICATES A MOUNTING HEIGHT OF 20 FEET.



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BOCA RATON, FLORIDA 33496
www.base-4.com

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ALLEN SIGMON REAL ESTATE GROUP 9201 MONTGOMERY BLVD, NE BLDG 1 ALBUQUERQUE, NM 87111



ELEMENT ALBUQUERQUE,NM

| No. | ISSUE DATE | PROJECT STATUS |
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| | | |
| | | |

 DATE
 2020.01.16

 DRAWN BY
 SG

 CHECKED BY
 DH


PROJECT NO. 84 - 176 - 1901


SHEET NAME

SITE PHOTOMETRICS PLAN

DRAWING NO

SL002

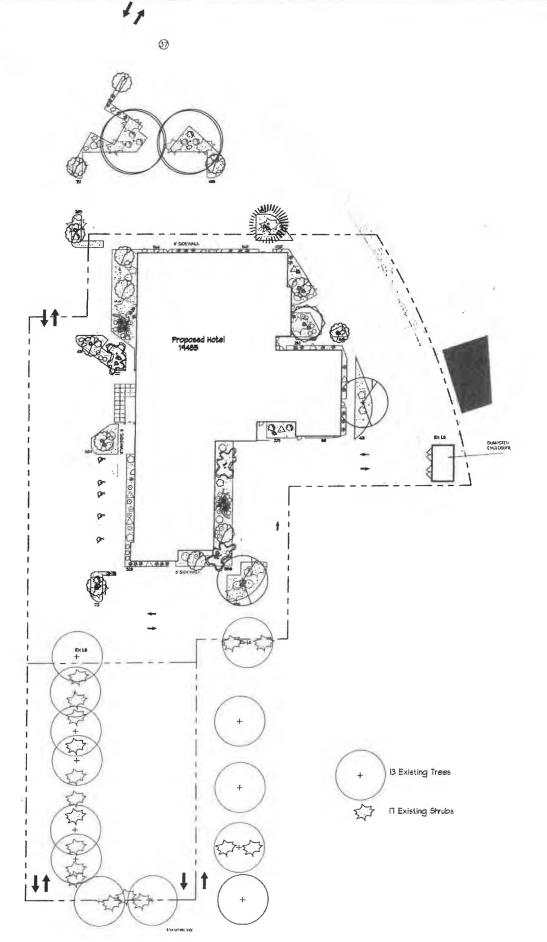

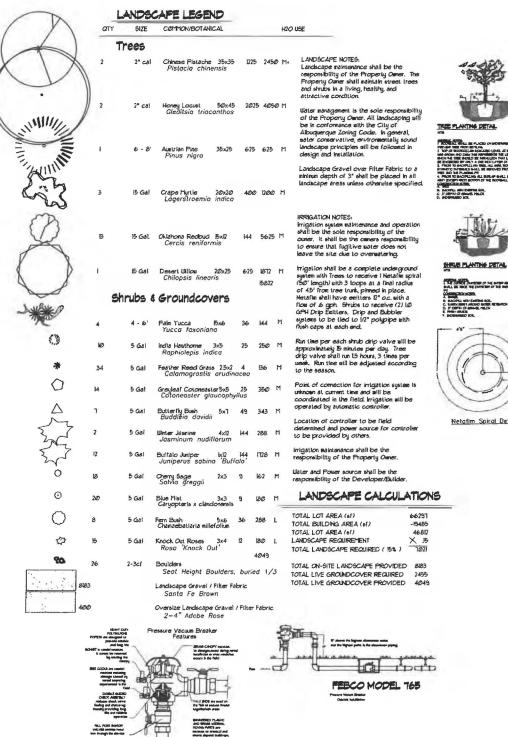

ALL BROKE BODT provides dealeding and long Pic

FEBCO MODEL 165




Landscape Architect





THE CORNER DAYSTER OF THE BATTER RETENTION BASES SHALL BE TROST THE DAYSTER OF THE DAYST PLANTING.

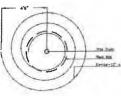

Netofim Spiral Detail

The Hillso

2440 Louislana Proposed Hotel Albuquerque, NM

CALLN BY CAN REVISION • SHEET *

SCALE: 1" + 40'-0"

GRAPHIC SCALE

DRAINAGE NARRATIVE THE SITE IS A FULLY DEVELOPED PORTION OF AN EXISTING SITE. THE OVERALL ORIGINAL SITE WAS DESIGNED TO DISCHARGE TO AN EXISTING 60" STORM DRAIN IN LPUISIANA, VIA SURFACE AND UNDERGROUND CONDUITS. THE OVERALL SITE ANALYSIS IS LOCATED IN DRAINAGE FILE H16D1. THE PROJECT AREA WAS AT ONE TIME A RETENTION BASIN. THE SITE WAS REANALYZED BY BOHANAN HUSTON IN 1984 AMD PARTIALLY CONSTRUCED, THE POND BASIN WAS CONVERTED TO A RRAATION BOX PARKING LOT DETENION POND IN A REPORT BY LARRY REID IN 2004. THE PROJECT AREA ACCEPTS UPLAND FLOW PROM THE BAST. THE SITE IS ALLOWED TO DISCHARGE AT A PEAK RATE OF 1.6CFS. LOT 6-A-1-A, BLOCK C LOUISIANA SUBDIVISION THIS DEVELOPEMENT WILL CONTINUE TO ALLOW THE UPLAND FLOW of 3.435 CFS TO ENTER THE SITE. THE SITE WILL CONTINUE TO GENERATE 6.30 CPS. THE BASIN DISCHARGE SHALL MATCH THE HISTORICAL RATE OF 0.63 CFS ALLOWED BY THE INTRODUCTION PARKING LOT DETENTION WITH SUBSURFACE INFILTRATION CHAMBERS. THE REQUIRED FIRST FLUSH VOLUME OF 1450 CUBIC FRET WILL BE CAPTURED BY THE UNDERGROUND CHAMBERS. THE DEVELOPMENT OF THIS SITE WILL MATCH EXISTING CONDITIONS. 2.265 CFS を展展デーオー52311 6100 57 LOT 6-A-B, BLOCK C CONNECT EXISTING 12" PVC REMOVE EXISTING DRAIN TO TYPE "D" OROP INLET COVERED FF = 5296.25 NEW 50 LF OF 12" HOPE FP = 5295.75 1.17 CFS IKRIGATION BOX WATER RREAK STORM DRAW TYPE 'D' DROP INLET WZ ORIFICE PLATE GRATE = IM.75MWSRL=95. GRATE - MISMISEL-ADJOINING EUILDING INSTAL UNDERGROUND INFILTRATOR SYSTEM 20 MC 4500 CHAMBERS EMOVE EXISTING 12" TYPE 'D' DROP IN ET GRATE - 95.00 T MAFRT = 85.75 NEW 117 LF OF 12" HOPE STORM DRAIN WATER BREAK LOT 7-A-1-A-1-A, BLOCK C *FA=5295.96 REMOVE EXISTING 8" 蒜 SA 85 HOPE STORM DRA MATER At Vr. 14=529446 GRATE = 94.26 MWSEL = 95.00 ×14=5294.85 ×14::5294.70 0.63 CFS DISCHARGE VIA 12* PIPE 18=5295.53 114-5295.89 A=5294.85 TA=5294.51 03-5294.73 08-5294.5 7A-5294.6 CE - 5294 BV JCB - 5294.7 TA - 5294.6. TA - 5294.5 =5294.76.TA=5294. ×1A=5294.51 JF 52 4 TE = 93.96 LOT 7-A-2, BLOCK C KIA:5291.56 FILED: MARCH 18, 2002 BOOK 2002C, PAGE 92 CAUTION: EXISTING UTILITIES ARE NOT SHOWN. IT SHALL BE THE SOLE RESPONSIBILITY OF THE CONTRACTOR TO CONDUCT ALL NECESSARY FIELD INVESTIGATIONS PRIOR Y'ATER MEN WATER WETER TO ANY EXCAVATION TO DETERMINE THE -KEC-5394.90 **ACTUAL LOCATION OF UTILITIES & OTHER** GOS FLEGRA

EROSION CONTROL NOTES:

1. CONTRACTOR IS RESPONSIBLE FOR OBTAINING A TOPSOIL DISTURBANCE PERMIT


2. CONTRACTOR IS RESPONSIBLE FOR MAINTAINING RUN-OFF ON SITE DURING

3. CONTRACTOR IS RESPONSIBLE FOR CLEANING ALL SEDIMENT THAT GETS INTO EXISTING RIGHT-OF-WAY.

4. REPAIR OF DAMAGED FACILITIES AND CLEANUP OF SEDIMENT ACCUMULATIONS ON ADJACENT PROPERTIES AND IN PUBLIC FACILITIES IS THE RESPONSIBILITY OF THE

5. ALL EXPOSED EARTH SURFACES MUST BE PROTECTED FROM WIND AND WATER EROSION PRIOR TO FINAL ACCEPTANCE OF ANY PROJECT.



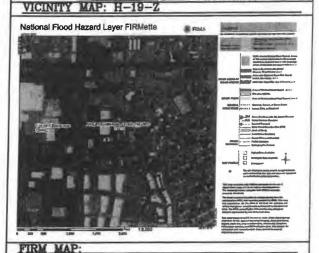

LEGAL DESCRIPTION:
LOTS 5-A-1, 5-A-2, 6-A-1-C-1-A AND 6-A-1-C-1-B, BLOCC
ALBUQUERQUE, BERNALBLO COUNTY, NEW MEXICO

1. ALL SPOT ELEVATIONS REPRESENT FLOWLINE ELEVATION UNLESS OTHERWISE NOTED.

2. ALL SLOPES SHALL BE 3:1 MAX. AND GRAVEL OR NATIVE SEEDING

3. ANY PERIMETER WALLS MUST BE PERMITED SEPARATELY. ALL RETAINING WALL DESIGN SHALL BE BY OTHERS.

4. SURVEY INFORMATION PROVIDED BY COMMUNITY SCIENCES CORPORATION USING NAVD DATUM 1988.

LEGEND


CB = CURB
BPOND = BOTTOM OF POND
DRN = DRAIN
EC = EDGE OF CONCRETE
FF = FINISHED FLOOR
FL = FLOW LINE
DRD = FLOW LINE
RAD = RAIN
RAD = RAIN
SASHH = SASHTARY SEWER MANHOLE
TA = TOP OF ASPHALT
= 118H POLE - -5295 -- -- EXISTING INDEX CONTOUR XXXX EXISTING SPOT ELEVATION ■ XXXXX PROPOSED SPOT ELEVATION # = LIGHT POLE --- ADJACENT BOUNDARY = CASLE BOX I * IRRIGATION BOX ======= EXISTING CURB AND GUTTER = WATER VALVE = WATER METER CO = SANITARY SEWER MANHOLE PROPOSED WATER BREAK = STORM DRAIN MANHOLE PROPOSED HOPE STORM DRAIN E = ELECTRIC MANHOLE PROPOSED TYPE "D" DROP INLET PER COA STD DWG 909060906 PROPOSED UNDERGROUND INFILTRATOR SYSTEM



ENGINEER'S SEAL 11/7/19 DAVID SOULE P.E. #14522

BY DEM 2440 LOUISIANA BLVD. 10-24-19 GRADING AND DRAINAGE PLAN SHEET# Rio Grande C1 Engineering 1806 CENTRAL AMENUE SE SUITE 201 ALBUQUERQUE, NM 87108 (505) 673-0889 JOB#

SCALE: 1"=30" *UPDATED BASE 1/9/2020

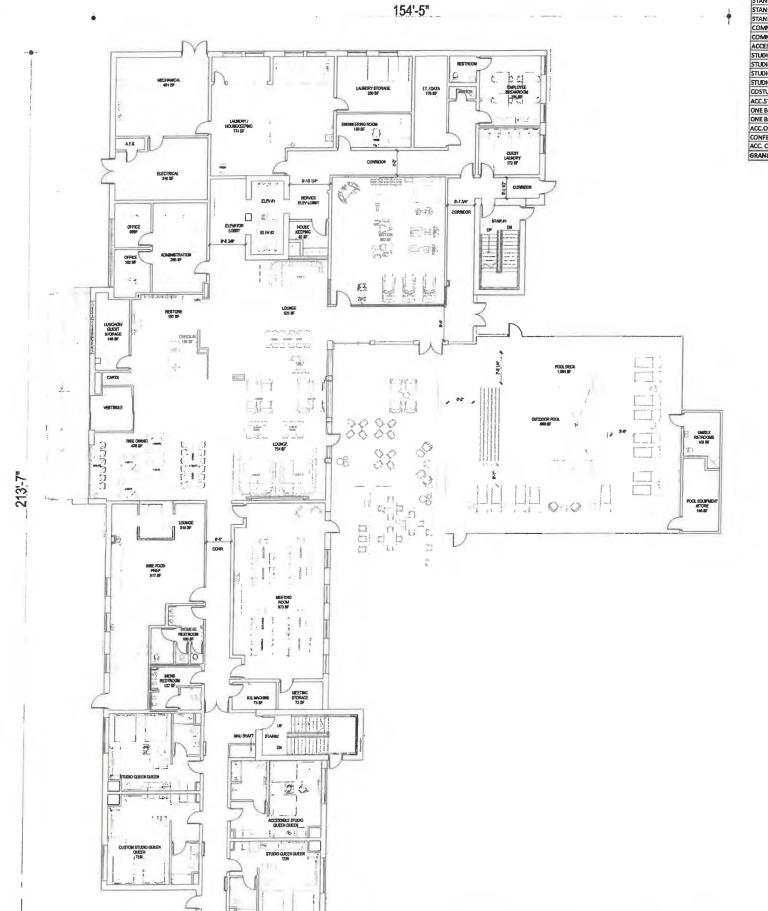

| | | | ROOM | MATRIX. | | | | | | |
|-------------------------------|-----|-----|------|---------|-----|-----|-------|------|------|-------------|
| ROOM TYPE | 15T | 2ND | 3RD | 4TH | 5TH | 6TH | TOTAL | | % | NO. OF BEDS |
| STANDARD KING | 0 | 5 | 7 | 7 | 7 | 6 | 32 | 25% | 1 | 32 |
| STANDARD KING ACC. | 0 | 0 | 0 | 0 | 0 | 1 | 1 | 1% | 1 | 1 |
| STANDARD KING CONN. | 0 | 5 | 5 | 5 | 5 | 5 | 25 | 20% | | 25 |
| COMMONS KING A | 0 | 0 | 0 | 0 | 3 | 3 | 6 | 5% | | - 6 |
| COMMONS KING B | 0 | 0 | 0 | 0 | 0 | 1 | 1 | 1% | 68% | 1 |
| ACCESSIBLE COMMONS KING | 0 | 0 | 0 | 0 | 1 | 0 | 1 | 1% | | 1 |
| STUDIO KING | 0 | 3 | 4 | 4 | 4 | 4 | 19 | 15% | | 19 |
| STUDIO KING ACC. | 0 | 1 | 0 | 0 | 0 | 0 | 1 | 1% | | 1 |
| STUDIO QUEEN QUEEN SHOWER | 1 | 3 | 4 | 3 | 0 | 0 | 11 | 9% | | 22 |
| STUDIO QUEEN QUEEN TUB | 1 | 1 | 1 | 1 | 1 | 1 | 6 | 5% | | 12 |
| COSTUM STUDIO QUEEN QUEEN TUB | 1 | 1 | 1 | 1 | 1 | 1 | 6 | 5% | | 12 |
| ACC.STUDIO QUEEN QUEEN | 1 | 0 | 0 | 1 | 0 | 0 | 2 | 2% | | 4 |
| ONE BEDROOM | 0 | 1 | 0 | 1 | 1 | 1 | 4 | 3% | 32% | 4 |
| ONE BEDROOM CONN. | 0 | 1 | 1 | 1 | 1 | 1 | 5 | 4% | | 5 |
| ACC.ONE BERDROOM | 0 | 0 | 1 | 0 | 0 | 0 | 1 | 1% | | 1 |
| CONFERENCE SUITE | 0 | 0 | 1 | 1 | 1 | 1 | 4 | 3% | | 4 |
| ACC. CONFERENCE SUITE | 0 | 1 | 0 | 0 | 0 | 0 | 1 | 1% | | 1 |
| GRAND TOTAL | 4 | 22 | 25 | 25 | 25 | 25 | 126 | 100% | 100% | 151 |

| SHOWER FIXTUR | E TYPE MATRIX | FLOOR AREA (SF) | | | | |
|---------------------|---------------|-----------------------------|----------------------|--------|--|--|
| SHOWER | 107 | 107 85% 1ST LEVEL FLOOR PLA | 1ST LEVEL FLOOR PLAN | | | |
| TUB | 12 | 10% | 2ND LEVEL FLOOR PLAN | 14,342 | | |
| ACC. TUB | 0 | 0% | 3RD LEVEL FLOOR PLAN | 14,342 | | |
| ACC. ROLL IN SHOWER | 2 | 2% | 4TH LEVEL FLOOR PLAN | 14,342 | | |
| TRANSFER SHOWER | 5 | 496 | STH LEVEL FLOOR PLAN | 14,342 | | |
| TOTAL | 126 | 100% | 6TH LEVEL FLOOR PLAN | 14,342 | | |
| | | | 7TH LEVEL FLOOR PLAN | 4,298 | | |
| | | | TOTAL | 91,232 | | |



Spal

Owner'



ALLEN SIGMON REAL ESTATE GROUP 9201 MONTGOMERY BLVD, NE BLDG 1 ALBUQUERQUE, NM 87111



ELEMENT ALBUQUERQUE,NM

| | - |
|---|---|
| | |
| N. C. | |

 DATE
 2020.01.17

 DRAWN BY
 SG

 CHECKED BY
 DH

 SCALE
 AS NOTED


 PROJECT NO.
 B4 - 176 - 1901

FLOOR PLANS

A2.1

SHEET NAME

FIRST FLOOR PLAN SCALE: 3/32*=1'-0"

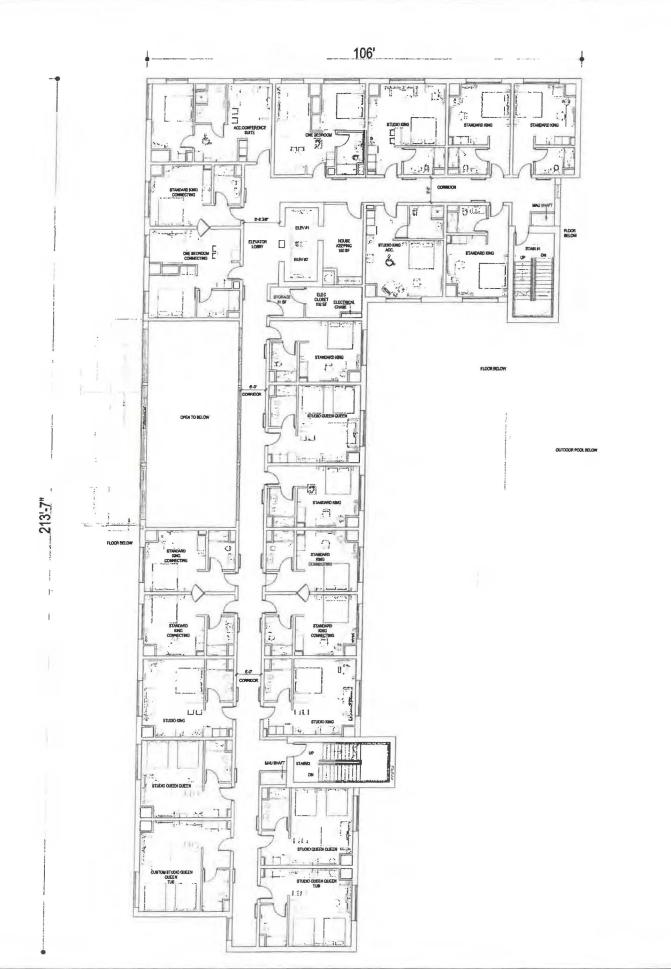

| | | | ROOM | MATRIX | | | | | | |
|-------------------------------|-----|-----|------|--------|-----|-----|-------|------|------|-------------|
| ROOM TYPE | 15T | 2ND | 3RD | 4TH | 5TH | 6TH | TOTAL | | % | NO. OF BEDS |
| STANDARD KING | 0 | 5 | 7 | 7 | 7 | 6 | 32 | 25% | | 32 |
| STANDARD KING ACC. | 0 | D | 0 | 0 | 0 | 1 | 1 | 1% | | 1 |
| STANDARD KING CONN. | 0 | 5 | 5 | 5 | 5 | 5 | 25 | 20% | | 25 |
| COMMONS KING A | 0 | 0 | 0 | 0 | 3 | 3 | 6 | 5% | 68% | 6 |
| COMMONS KING B | 0 | 0 | 0 | 0 | 0 | 1 | 1 | 1% | 0079 | 1 |
| ACCESSIBLE COMMONS KING | 0 | 0 | 0 | 0 | 1 | 0 | 1 | 1% | | 1 |
| STUDIO KING | 0 | 3 | 4 | 4 | 4 | 4 | 19 | 15% | 1 | 19 |
| STUDIO KING ACC. | 0 | 1 | 0 | 0 | 0 | 0 | 1 | 1% | | 1 |
| STUDIO QUEEN QUEEN SHOWER | 1 | 3 | 4 | 3 | 0 | 0 | 11 | 9% | | 22 |
| STUDIO QUEEN QUEEN TUB | 1 | 1 | 1 | 1 | 1 | 1 | 6 | 5% | 1 | 12 |
| COSTUM STUDIO QUEEN QUEEN TUB | 1 | 1 | 1 | 1 | 1 | 1 | 6 | 5% | | 12 |
| ACC.STUDIO QUEEN QUEEN | 1 | 0 | 0 | 1 | 0 | 0 | 2 | 2% | | 4 |
| ONE BEDROOM | 0 | 1 | 0 | 1 | 1 | 1 | 4 | 3% | 32% | 4 |
| ONE BEDROOM CONN. | 0 | 1 | 1 | 1 | 1 | 1 | 5 | 4% | | 5 |
| ACC. ONE BERDROOM | 0 | 0 | 1 | 0 | 0 | 0 | 1 | 1% | | 1 |
| CONFERENCE SUITE | 0 | 0 | 1 | 1 | 1 | 1 | 4 | 3% | | 4 |
| ACC. CONFERENCE SUFFE | 0 | 1 | 0 | 0 | 0 | 0 | 1 | 1% | | 1 |
| GRAND TOTAL | 4 | 22 | 25 | 25 | 25 | 25 | 126 | 100% | 100% | 151 |

| SHOWER FIXTUR | FLOOR AREA (SF) | | | | |
|-------------------|-----------------|------|----------------------|--|--|
| IOWER | 107 | 85% | 1ST LEVEL FLOOR PLAN | | |
| B | 12 | 10% | 2ND LEVEL FLOOR PLAN | | |
| C. TUB | 0 | 0% | 3RD LEVEL FLOOR PLAN | | |
| C. ROLL IN SHOWER | 2 | 2% | ATHLEVEL FLOOR PLAN | | |
| ANSFER SHOWER | 5 | 4% | 5TH LEVEL FLOOR PLAN | | |
| ITAL | 126 | 100% | 6TH LEVEL FLOOR PLAN | | |
| | | - | 7TH LEVEL FLOOR PLAN | | |

BASE4

Architects | Engineers | Interiors

BASE4 2901 CLINT MOORE ROAD #114 BOCA RATON, FLORIDA 33496 www.base-4.com

Spal

15,224 14,342 14,342 14,342 14,342 14,342 4,298 51,232

Owner:



ALLEN SIGMON REAL ESTATE GROUP 9201 MONTGOMERY BLVD, NE BLDG 1 ALBUQUERQUE, NM 87111



Meswere reservent

ELEMENT BUQUERQUE NA

| No. ISS | UE DATE | PROJECT STATUS |
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| | | |
| DATE | | 2020.01.17 |
| DRAWN | BY | SG |
| CHECKE | D BY | DH |
| SCALE | | AS NOTED |
| PROJEC | FNO. | B4 - 176 - 1901 |
| SHEET N | AME | |

FLOOR PLANS

A2.2

SECOND FLOOR PLAN SCALE: 3/32*=1'-0"



| | | | ROOM | A MATRIX | | | | | | |
|-------------------------------|-----|-----|------|----------|-----|-----|-------|------|------|------------|
| ROOM TYPE | 1ST | 2ND | 3RD | 4TH | 57H | 6TH | TOTAL | | % | NO. OF BED |
| STANDARD KING | 0 | 5 | 7 | 7 | 7 | 6 | 32 | 25% | | 32 |
| STANDARD KING ACC. | 0 | 0 | 0 | 0 | 0 | 1 | 1 | 1% | 1 | 1 |
| STANDARD KING CONN. | 0 | 5 | 5 | 5 | 5 | 5 | 25 | 20% | | 25 |
| COMMONS KING A | 0 | 0 | 0 | 0 | 3 | 3 | 6 | 5% | 68% | 6 |
| COMMONS KING B | 0 | 0 | 0 | 0 | 0 | 1 | 1 | 1% | 0076 | 1 |
| ACCESSIBLE COMMONS KING | 0 | 0 | 0 | 0 | 1 | 0 | 1 | 1% | | 1 |
| STUDIO KING | 0 | 3 | 4 | 4 | 4 | 4 | 19 | 15% | 1 | 19 |
| STUDIO KING ACC. | 0 | 1 | D | 0 | 0 | 0 | 1 | 1% | | 1 |
| STUDIO QUEEN QUEEN SHOWER | 1 | 3 | 4 | 3 | 0 | 0 | 11 | 9% | - | 22 |
| STUDIO QUEEN QUEEN TUB | 1 | 1 | 1 | 1 | 1 | 1 | 6 | 5% | | 12 |
| COSTUM STUDIO QUEEN QUEEN TUB | 1 | 1 | 1 | 1 | 1 | 1 | 6 | 5% | | 12 |
| ACC.STUDIO QUEEN QUEEN | 1 | 0 | 0 | 1 | 0 | 0 | 2 | 2% | | 4 |
| ONE BEDROOM | 0 | 1 | 0 | 1 | 1 | 1 | 4 | 3% | 32% | 4 |
| ONE BEDROOM CONN. | 0 | 1 | 1 | 1 | 1 | 1 | 5 | 4% | | 5 |
| ACC.ONE BERDROOM | 0 | 0 | 1 | 0 | 0 | 0 | 1 | 1% | | 1 |
| CONFERENCE SUITE | 0 | 0 | 1 | 1 | 1 | 1 | 4 | 3% | | 4 |
| ACC. CONFERENCE SUITE | 0 | 1 | 0 | 0 | 0 | 0 | 1 | 1% | | 1 |
| GRAND TOTAL | 4 | 22 | 25 | 25 | 25 | 25 | 126 | 100% | 100% | 151 |

| SHOWER FIXTUR | E TYPE MATRIX | | FLOOR AREA (S | F) |
|---------------------|---------------|------|----------------------|--------|
| SHOWER | 107 | 85% | 1ST LEVEL FLOOR PLAN | 15,224 |
| TUB | 12 | 10% | 2ND LEVEL FLOOR PLAN | 14,342 |
| ACC. TUB | 0 | 086 | 3RD LEVEL FLOOR PLAN | 14,342 |
| ACC. ROLL IN SHOWER | 2 | 2% | 4TH LEVEL FLOOR PLAN | 14,342 |
| TRANSFER SHOWER | 5 | 4% | 5TH LEVEL FLOOR PLAN | 14,342 |
| TOTAL | 126 | 100% | 6TH LEVEL FLOOR PLAN | 14,342 |
| | | | 7TH LEVEL FLOOR PLAN | 4,298 |
| | | | TOTAL | 01 727 |



Coal

Owne



ALLEN SIGMON REAL ESTATE GROUP 9201 MONTGOMERY BLVD, NE BLDG 1 ALBUQUERQUE, NM 87111




ELEMENT VQUERQUE,NM

| No. | ISSUE DATE | PROJECT STATUS |
|-----|------------|-----------------|
| | | |
| DAT | E | 2020.01.17 |
| DRA | WN BY | SG |
| CHE | CKED BY | DH |
| SCA | LE | AS NOTED |
| PRO | JECT NO. | B4 - 176 - 1901 |
| SHE | ET NAME | |

FLOOR PLANS

A2.3

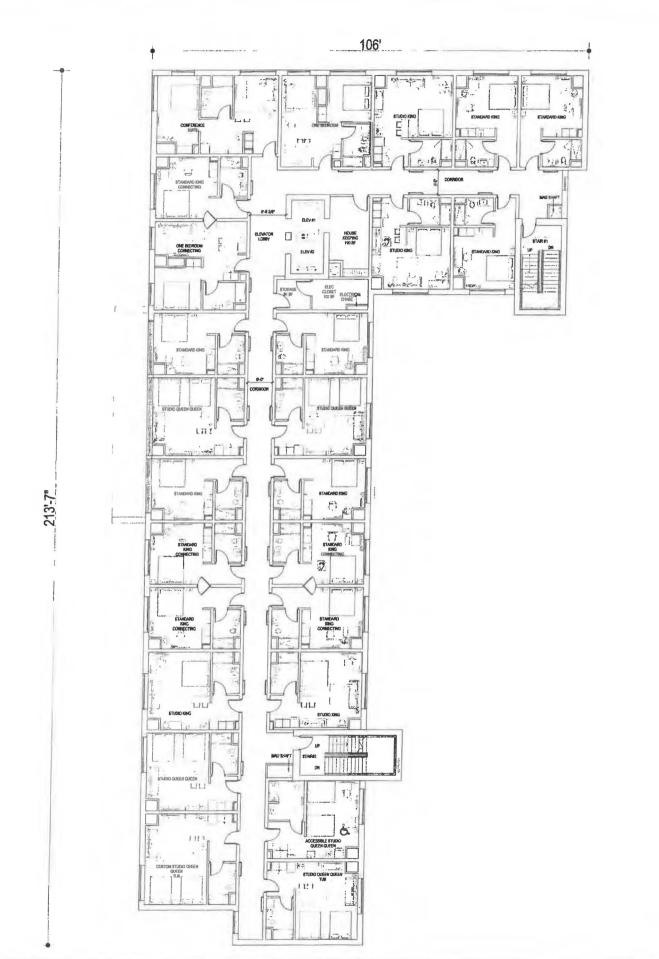

| | | | ROOM | MATRIX | | | | | | |
|-------------------------------|-----|-----|------|--------|-----|-----|-------|------|------|-------------|
| ROOM TYPE | 1ST | 2ND | 3RD | 4TH | 5TH | 6TH | TOTAL | | % | NO. OF BEDS |
| STANDARD KING | 0 | 5 | 7 | 7 | 7 | 6 | 32 | 25% | | |
| STANDARD KING ACC. | 0 | 0 | 0 | 0 | 0 | 1 | 1 | 1% | | 1 |
| STANDARD KING CONN. | 0 | 5 | 5 | 5 | 5 | 5 | 25 | 20% | | 25 |
| COMMONS KING A | 0 | 0 | 0 | 0 | 3 | 3 | 6 | 5% | 68% | 6 |
| COMMONS KING B | 0 | 0 | 0 | 0 | 0 | 1 | 1 | 1% | | 1 |
| ACCESSIBLE COMMONS KING | 0 | 0 | 0 | 0 | 1 | 0 | 1 | 1% | | 1 |
| STUDIO KING | 0 | 3 | 4 | 4 | 4 | 4 | 19 | 15% | | 19 |
| STUDIO KING ACC. | 0 | 1 | 0 | 0 | 0 | 0 | 1 | 1% | 1 | 1 |
| STUDIO QUEEN QUEEN SHOWER | 1 | 3 | 4 | 3 | 0 | 0 | 11 | 9% | | 22 |
| STUDIO QUEEN QUEEN TUB | 1 | 1 | 1 | 1 | 1 | 1 | 6 | 5% | | 12 |
| COSTUM STUDIO QUEEN QUEEN TUB | 1 | 1 | 1 | 1 | 1 | 1 | 6 | 5% | | 12 |
| ACC_STUDIO QUEEN QUEEN | 1 | 0 | 0 | 1 | 0 | 0 | 2 | 2% | | 4 |
| ONE BEDROOM | 0 | 1 | 0 | 1 | 1 | 1 | 4 | 3% | 32% | 4 |
| ONE BEDROOM CONN. | 0 | 1 | 1 | 1 | 1 | 1 | 5 | 4% | | 5 |
| ACC.ONE BERDROOM | 0 | 0 | 1 | 0 | 0 | 0 | 1 | 1% | | 1 |
| CONFERENCE SUITE | 0 | 0 | 1 | 1 | 1 | 1 | 4 | 3% | | 4 |
| ACC. CONFERENCE SUITE | 0 | 1 | 0 | 0 | 0 | 0 | 1 | 1% | | 1 |
| SRAND TOTAL | 4 | 22 | 25 | 25 | 25 | 25 | 126 | 100% | 100% | 151 |

| SHOWER FIXTUR | E TYPE MATRIX | FLOOR AREA (SF) | | | | |
|---------------------|---------------|-----------------|----------------------|--------|--|--|
| SHOWER | 107 | 85% | 1ST LEVEL FLOOR PLAN | 15,224 | | |
| TUB | 12 | 10% | 2ND LEVEL FLOOR PLAN | 14,342 | | |
| ACC. TUB | 0 | 096 | 3RD LEVEL FLOOR PLAN | 14,342 | | |
| ACC. ROLL IN SHOWER | 2 | 2% | 4TH LEVEL FLOOR PLAN | 14,342 | | |
| TRANSFER SHOWER | 5 | 4% | 5TH LEVEL FLOOR PLAN | 14,342 | | |
| TOTAL | 126 | 100% | 6TH LEVEL FLOOR PLAN | 14,342 | | |
| | | | 7TH LEVEL FLOOR PLAN | 4,298 | | |
| | | | TOTAL | 91,232 | | |





ALLEN SIGMON REAL ESTATE GROUP 9201 MONTGOMERY BLVD, NE BLDG 1 ALBUQUERQUE, NM 87111



No. ISSUE DATE PROJECT STATUS

DATE 2020.01.17 DRAWN BY SG CHECKED BY DH SCALE AS NOTED

PROJECT NO. B4 - 176 - 1901

SHEET NAME

FLOOR PLANS

A2.4

FOURTH FLOOR PLAN SCALE: 3/32"=1'-0"



| | | | ROOM | MATRIX | | | | | | |
|-------------------------------|-----|-----|------|--------|-----|-----|-------|------|------|-------------|
| ROOM TYPE | 15T | 2ND | 3RD | 4TH | 5TH | 6ТН | TOTAL | | % | NO. OF BEDS |
| STANDARD KING | 0 | 5 | 7 | 7 | 7 | 6 | 32 | 25% | | 32 |
| STANDARD KING ACC. | 0 | 0 | 0 | 0 | 0 | 1 | 1 | 1% | | 1 |
| STANDARD KING CONN. | 0 | 5 | 5 | 5 | 5 | 5 | 25 | 20% | | 25 |
| COMMONS KING A | 0 | 0 | 0 | 0 | 3 | 3 | 6 | 5% | 68% | 6 |
| COMMONS KING B | 0 . | 0 | 0 | 0 | 0 | 1 | 1 | 1% | 90% | 1 |
| ACCESSIBLE COMMONS KING | 0 | 0 | 0 | 0 | 1 | 0 | 1 | 1% | | 1 |
| STUDIO KING | 0 | 3 | 4 | 4 | 4 | 4 | 19 | 15% | | 19 |
| STUDIO KING ACC. | 0 | 1 | 0 | Ð | 0 | 0 | 1 | 1% | | 1 |
| STUDIO QUEEN QUEEN SHOWER | 1 | 3 | 4 | 3 | 0 | 0 | 11 | 9% | | 22 |
| STUDIO QUEEN QUEEN TUB | 1 | 1 | 1 | 1 | 1 | 1 | 6 | 5% | 100 | 12 |
| COSTUM STUDIO QUEEN QUEEN TUB | 1 | - 1 | 1 | 1 | 1 | 1 | 6 | 5% | | 12 |
| ACC.STUDIO QUEEN QUEEN | 1 | 0 | 0 | 1 | 0 | 0 | 2 | 2% | | 4 |
| ONE BEDROOM | 0 | 1 | 0 | 1 | 1 | 1 | 4 | 3% | 32% | 4 |
| ONE BEDROOM CONN. | 0 | 1 | 1 | 1 | 1 | 1 | 5 | 4% | | 5 |
| ACCONE BERDROOM | 0 | 0 | 1 | 0 | 0 | 0 | 1 | 1% | | 1 |
| CONFERENCE SUITE | 0 | 0 | 1 | 1 | 1 | 1 | 4 | 3% | | 4 |
| ACC. CONFERENCE SUITE | 0 | 1 | 0 | 0 | 0 | 0 | 1 | 1% | | 1 |
| SRAND TOTAL | 4 | 22 | 25 | 25 | 25 | 25 | 126 | 100% | 100% | 151 |

| | 4 | 22 | 25 | 25 | 25 | 25 | 126 | 100% | 100% | 151 |
|------------------|------------|-----------|-----------|--------|------|---------|------------|----------|---------|--------|
| | 5 | HOWER FIX | TURE TYPE | MATRIX | | | | FLOOR AF | EA (SF) | |
| SHOWE | R | | | 107 | 85% | 15T LEV | EL FLOOR I | LAN | | 15,224 |
| TUB | | | | 12 | 10% | 2ND LE | VEL FLOOR | PLAN | | 14,342 |
| ACC. TU | B | | | 0 | 0% | 3RD LEV | /EL FLOOR | PLAN | | 14,342 |
| ACC. RO | HL IN SHOW | rer | | 2 | 296 | 4TH LEV | EL FLOOR | PLAN | | 14,342 |
| TRANSF | ER SHOWER | | | 5 | 4% | 5TH LEV | EL FLOOR | PLAN | | 14,342 |
| TOTAL | | | | 126 | 100% | 6TH LEV | EL FLOOR | PLAN | | 14,342 |
| Name of the last | | | | | | THLEV | EL FLOOR I | PLAN | | 4,298 |
| | | | | | | TOTAL | | | | 91,232 |





ALLEN SIGMON REAL ESTATE GROUP 9201 MONTGOMERY BLVD, NE BLDG 1 ALBUQUERQUE, NM 87111



No. ISSUE DATE | PROJECT STATUS


DATE 2020.01.17 DRAWN BY SG CHECKED BY DH SCALE AS NOTED PROJECT NO. B4 - 176 - 1901

SHEET NAME

FLOOR PLANS

A2.5

FIFTH FLOOR PLAN SCALE: 3/32°=1'-0°

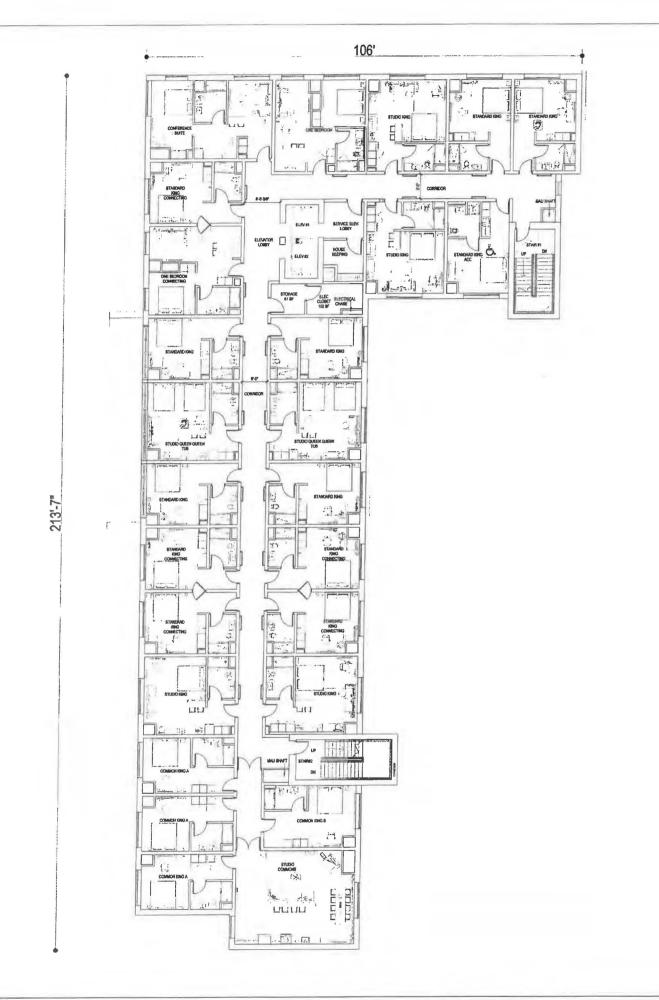

| | | | ROOM | MATRIX | | | | | | |
|-------------------------------|-----|-----|------|--------|-----|-----|-------|------|--------|-------------|
| ROOM TYPE | 1ST | 2ND | 3RD | 4TH | 5TH | 6TH | TOTAL | | % | NO. OF BEDS |
| STANDARD KING | 0 | 5 | 7 | 7 | 7 | 6 | 32 | 25% | | 32 |
| STANDARD KING ACC. | 0 | 0 | 0 | 0 | 0 | 1 | 1 | 1% | 1 | 1 |
| STANDARD KING CONN. | 0 | 5 | 5 | 5 | 5 | 5 | 25 | 20% | | 25 |
| COMMONS KING A | 0 | 0 | 0 | 0 | 3 | 3 | 6 | 5% | 68% | - 6 |
| COMMONS KING B | 0 | 0 | 0 | 0 | 0 | 1 | 1 | 1% | 0876 | 1 |
| ACCESSIBLE COMMONS KING | 0 | 0 | 0 | 0 | 1 | 0 | 1 | 1% |] | 1 |
| STUDIO KING | 0 | 3 | 4 | 4 | 4 | 4 | 19 | 15% |] | 19 |
| STUDIO KING ACC. | 0 | 1 | 0 | 0 | 0 | 0 | 1 | 1% | | 1 |
| STUDIO QUEEN QUEEN SHOWER | 1 | 3 | 4 | 3 | 0 | 0 | 11 | 9% | | 22 |
| STUDIO QUEEN QUEEN TUB | 1 | 1 | 1 | 1 | 1 | 1 | 6 | 5% | | 12 |
| COSTUM STUDIO QUEEN QUEEN TUB | 1 | 1 | 1 | 1 | 1 | 1 | 6 | 5% | | 12 |
| ACC.STUDIO QUEEN QUEEN | 1 | 0 | 0 | 1 | 0 | 0 | 2 | 2% | | 4 |
| ONE BEDROOM | 0 | 1 | 0 | 1 | 1 | 1 | 4 | 3% | 32% | 4 |
| ONE BEDROOM CONN. | 0 | 1 | 1 | 1 | 1 | 1 | 5 | 4% | | 5 |
| ACC.ONE BERDROOM | 0 | 0 | 1 | 0 | 0 | 0 | 1 | 1% | | 1 |
| CONFERENCE SUITE | 0 | 0 | 1 | 1 | 1 | 1 | 4 | 3% | | 4 |
| ACC. CONFERENCE SUITE | 0 | 1 | 0 | 0 | 0 | 0 | 1 | 1% | 1 5 10 | 1 |
| SRAND TOTAL | 4 | 22 | 25 | 25 | 25 | 25 | 126 | 100% | 100% | 151 |

| SHOWER FIXTUR | E TYPE MATRIX | | FLOOR AREA (S | F) |
|---------------------|---------------|------|----------------------|--------|
| SHOWER | 107 | 85% | 1ST LEVEL FLOOR PLAN | 15,224 |
| TU8 | 12 | 10% | 2ND LEVEL FLOOR PLAN | 14,347 |
| ACC. TUB | 0 | 0% | 3RD LEVEL FLOOR PLAN | 14,342 |
| ACC. ROLL IN SHOWER | 2 | 2% | 4TH LEVEL FLOOR PLAN | 14,342 |
| TRANSFER SHOWER | 5 | 4% | 5TH LEVEL FLOOR PLAN | 14,342 |
| TOTAL | 126 | 100% | 6TH LEVEL FLOOR PLAN | 14,342 |
| | | | 7TH LEVEL FLOOR PLAN | 4,298 |
| | | | TOTAL | 91,232 |





ALLEN SIGMON REAL ESTATE GROUP 9201 MONTGOMERY BLVD, NE BLDG 1 ALBUQUERQUE, NM 87111



| NO. | ISSUE DATE | PROJECT STATUS |
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| 17 | | |
| | | |
| DAT | _ | 2020.01.17 |


DRAWN BY SG CHECKED BY DH SCALE AS NOTED PROJECT NO. B4 - 176 - 1901

SHEET NAME

FLOOR PLANS

A2.6

SIXTH FLOOR PLAN SCALE: 3/32"=1'-0"

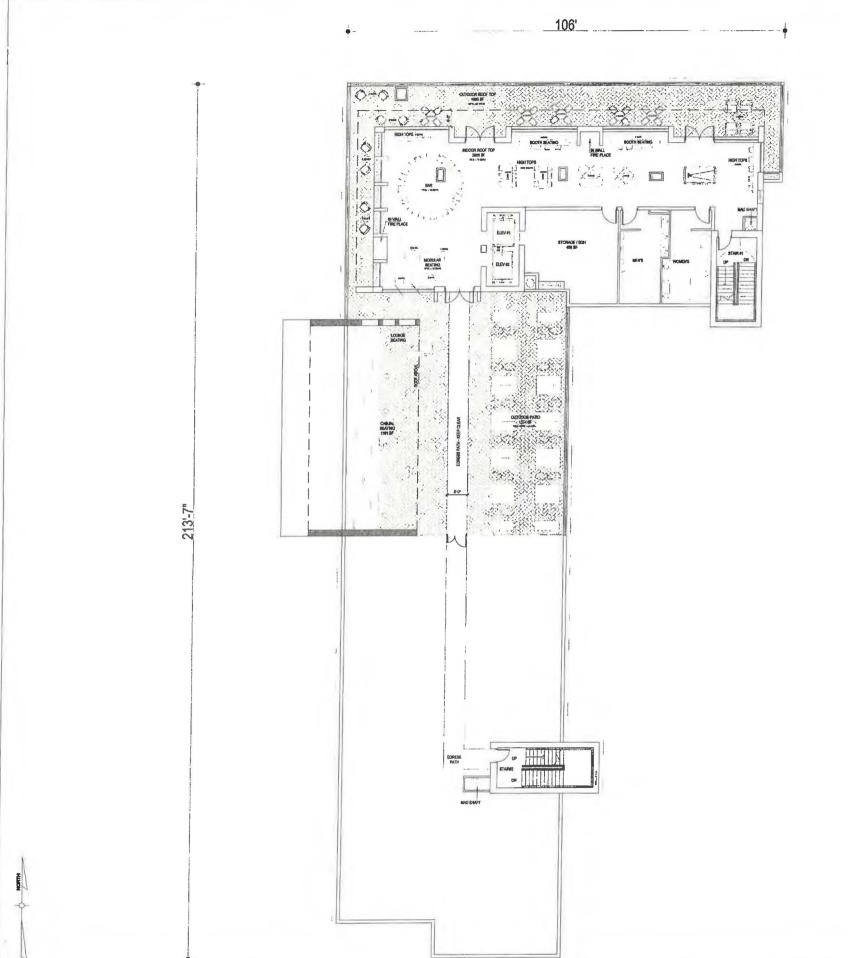

| | | | ROOM | MATRIX | | | | | | |
|-------------------------------|-----|-----|------|--------|-----|-----|-------|------|------|-------------|
| ROOM TYPE | 15T | 2ND | 3RD | 4TH | 5TH | 6TH | TOTAL | | % | NO. OF BEDS |
| STANDARD KING | 0 | 5 | 7 | 7 | 7 | 6 | 32 | 25% | | 32 |
| STANDARD KING ACC. | 0 | 0 | 0 | 0 | 0 | 1 | 1 | 1% | | 1 |
| STANDARD KING CONN. | 0 | 5 | 5 | 5 | 5 | 5 | 25 | 20% |] | 25 |
| COMMONS KING A | 0 | 0 | 0 | 0 | 3 | 3 | 6 | 5% | 68% | 6 |
| COMMONS KING B | 0 | 0 | 0 | 0 | 0 | 1 | 1 | 1% | 0070 | 1 |
| ACCESSIBLE COMMONS KING | 0 | 0 | 0 | 0 | 1 | 0 | 1 | 1% | | 1 |
| STUDIO KING | 0 | 3 | 4 | 4 | 4 | 4 | 19 | 15% | | 19 |
| STUDIO KING ACC. | 0 | 1 | 0 | 0 | 0 | 0 | 1 | 1% | | 1 |
| STUDIO QUEEN QUEEN SHOWER | 1 | 3 | 4 | 3 | 0 | 0 | 11 | 9% | | 22 |
| STUDIO QUEEN QUEEN TUB | 1 | 1 | 1 | 1 | 1 | 1 | 6 | 5% | | 12 |
| COSTUM STUDIO QUEEN QUEEN TUB | 1 | 1 | 1 | 1 | 1 | 1 | 6 | 5% | | 12 |
| ACC.STUDIO QUEEN QUEEN | 1 | 0 | 0 | 1 | 0 | 0 | 2 | 2% | | 4 |
| ONE BEDROOM | 0 | 1 | 0 | 1 | 1 | 1 | 4 | 3% | 32% | 4 |
| ONE BEDROOM CONN. | 0 | 1 | 1 | 1 | 1 | 1 | 5 | 4% | | 5 |
| ACC, ONE BERDROOM | 0 | 0 | 1 | 0 | 0 | 0 | 1 | 1% | | 1 |
| CONFERENCE SUITE | 0 | 0 | 1 | 1 | 1 | 1 | 4 | 3% | | 4 |
| ACC. CONFERENCE SUITE | 0 | 1 | 0 | 0 | 0 | 0 | 1 | 1% | | 1 |
| FRAND TOTAL | 4 | 22 | 25 | 25 | 25 | 25 | 126 | 200% | 100% | 151 |

| | 4 | 22 | 25 | 25 | 25 | 25 | 126 | 200% | 100% | 151 |
|---------|-----------|------------|-----------|--------|------|----------------|------------|----------|---------|--------|
| | | SHOWER FIX | TURE TYPE | MATRIX | | | | FLOOR AF | EA (SF) | |
| SHOWE | R | | | 107 | 85% | 1ST LEV | EL FLOOR I | LAN | | 15,224 |
| TUB | | | | 12 | 10% | 2ND LE | VEL FLOOR | PLAN | | 14,342 |
| ACC. TU | 18 | | | 0 | 0% | 3RD LEV | /EL FLOOR | PLAN | | 14,342 |
| ACC. RC | LLIN SHOW | /ER | | 2 | 2% | 4TH LEV | EL FLOOR | PLAN | | 14,342 |
| TRANSF | ERSHOWER | } | | 5 | 496 | STHLEV | EL FLOOR I | PLAN | | 14,342 |
| TOTAL | | | | 126 | 100% | ETH LEV | EL FLOOR I | PLAN | | 14,342 |
| | | | | | | TTH LEV | EL FLOOR | PLAN | | 4,298 |
| | | | | | | TOTAL | | | | 91,232 |



-

Owner



ALLEN SIGMON REAL ESTATE GROUP 9201 MONTGOMERY BLVD, NE BLDG 1 ALBUQUERQUE, NM 87111



ELEMENT ALBUQUERQUE,NM

| DATE | PROJECT STATUS |
|------|----------------|
| | |
| | |
| | DATE |

 DATE
 2020.01.17

 DRAWN BY
 SG

 CHECKED BY
 DH

 SCALE
 AS NOTED

PROJECT NO. B4 - 176 - 1901

SHEET NAME

FLOOR PLAN

DRAWING N

A2.7

SEVENTH FLOOR PLAN (OPT-1)
SCALE: 3/32*=1'-0'



| | | ND-EX | CTERIOR ES | |
|------|---------------------------|----------|---|------------|
| CODE | MTL-TYPE | COLOR | MATERIAL NAME | MATERIAL 9 |
| 01 | EIFS-DRYVIT | 510 | ELEM-01-2738-WHITE | 31 % |
| 02 | EIFS-DRYVIT | | ELEM-02-1022-DARK GREY | 38 % |
| 03 | EIFS-DRYVIT | | ELEM-03-1022-GREEN | 0 % |
| 04 | ALCOA- BUILDING PANELS | 经 | COLORWELD 500XL-BRIGHT SILVER METALLIC | 21 % |
| 05 | ALCOA- BUILDING PANELS | | WOOD FINISH SCOTISH OAK (D 8115 MR) | 12 % |
| 06 | ALCOA- BUILDING PANELS | | WOOD FINISH ITALIAN WALNUT | 12 76 |
| | | | TOTAL | 100% |



Soot

Owner:



ALLEN SIGMON REAL ESTATE GROUP 9201 MONTGOMERY BLVD, NE BLDG 1 ALBUQUERQUE, NM 87111



ELEMENT ALBUQUERQUE,NM

No. ISSUE DATE PROJECT STATUS

 DATE
 2020.01.17

 DRAWN BY
 SG

 CHECKED BY
 DH

 SCALE
 AS NOTED

 PROJECT NO.
 B4 - 176 - 1901

 SHEET NAME

ELEVATIONS

DRAWING NO.

A3.1





| | | ND-EX | TERIOR ES | |
|------|---------------------------|-------|---|------------|
| CODE | MTL-TYPE | COLOR | MATERIAL NAME | MATERIAL 9 |
| 01 | EIFS-DRYVIT | | ELEM-01-2738-WHITE | 59 % |
| 02 | EIFS-DRYVIT | | ELEM-02-1022-DARK GREY | 9% |
| 03 | EIFS-DRYVIT | P. C. | ELEM-03-1022-GREEN | 0% |
| 04 | ALCOA- BUILDING PANELS | | COLORWELD 500XL-BRIGHT SILVER METALLIC | 9% |
| 05 | ALCOA- BUILDING PANELS | | WOOD FINISH SCOTISH OAK (D 8115 MR) | 23 % |
| 06 | ALCOA- BUILDING PANELS | | WOOD FINISH ITALIAN WALNUT | 23 79 |
| | | | TOTAL | 100% |

LEGEND-EXTERIOR FINISHES

COLOR

MATERIAL NAME

ELEM-01-2738-WHITE

ELEM-03-1022-GREEN

COLORWELD 500XL-BRIGHT SILVER METALLIC

WOOD FINISH SCOTISH DAK (D 8115 MR)

TOTAL

WOOD FINISH ITALIAN WALNUT

MATERIAL %

61 %

24 %

0%

1 %

14 %

100%



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ALLEN SIGMON REAL ESTATE GROUP 9201 MONTGOMERY BLVD, NE BLDG 1 ALBUQUERQUE, NM 87111



ELEMENT ALBUQUERQUE,NM

| No. | ISSUE DATE | PROJECT STATUS |
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| DRA | WN BY | 2020.01.17 SG |
| CHE | CKED BY | DH |
| SCA | LE | AS NOTED |
| PRO | JECT NO. | B4 - 176 - 1901 |
| SHE | ET NAME | |

ELEVATIONS

A3.2



NOTICE TO CONTRACTORS

AN EXCAVATION/CONSTRUCTION PERMIT WILL BE REQUIRED BEFORE BEGINNING ANY WORK
WITHIN BERNALILLO COUNTY ROW. AN APPROVED COPY OF THESE PLANS MUST BE SUBMITTED
AT THE TIME OF APPLICATION FOR THIS PERMIT.

2. ALL WORK DETAILED ON THESE PLANS TO BE PERFORMED, EXCEPT AS OTHERWISE STATED OR PROVIDED HEREON, SHALL BE CONSTRUCTED IN ACCORDANCE WITH NEW MEXICO STANDARD SPECIFICATIONS FOR PUBLIC WORKS CONSTRUCTION, MOST RECENT EDITION.

3, TWO WORKING DAYS PRIOR TO ANY EXCAVATION, CONTRACTOR MUST CONTACT LINE LOCATING SERVICE, 260-1990, FOR LOCATION OF EXISTING UTILITIES.

4. PRIOR TO CONSTRUCTION, THE CONTRACTOR SHALL EXCAVATE AND VERIFY THE HORIZONTAL AND VERTICAL LOCATIONS OF ALL PERTINENT EXISTING UTILITIES, AND/OR OBSTRUCTIONS, SHOULD A CONFLICT EXIST, THE CONTRACTOR SHALL NOTIFY THE ENGINEER SO THAT THE CONFLICT CAN BE RESOLVED WITH A MINIMUM AMOUNT OF DELAY.

5. BACKFILL COMPACTION SHALL BE ACCORDING TO ARTERIAL STREET USE.

6. MAINTENANCE OF THESE FACILITIES SHALL BE THE RESPONSIBILITY OF THE OWNER OF THE PROPERTY SERVED

7. WORK ON ARTERIAL STREETS SHALL BE PERFORMED ON A 24-HOUR BASIS.

8. CONTRACTOR SHALL DETERMINE LOCATION OF ANY UNDERGROUND FACILITY IN OR NEAR WORK AREAS, INCLUDING REQUESTS TO OWNERS/OPERATORS OF SAID FACILITIES PER

9. CONTRACTOR SHALL PLAN ALL EXCAVATION TO MINIMIZE INTERFERENCE OR DAMAGE OF UNDERGROUND FACILITIES.

10, CONTRACTOR SHALL PROVIDE ADVANCE TELEPHONE NOTICE OF COMMENCEMENT, EXTENT AND DURATION OF ALL EXCAVATION WORK TO THE ONE-CALL NOTIFICATION SYSTEM, OR TO OWNERS/OPERATORS OF ANY EXISTING UNDERGROUND FACILITY IN OR NEAR THE EXCAVATION AREA THAT ARE NOT MEMBERS OF THE ONE-CALL NOTIFICATION CENTER; IN ORDER THAT OWNERS/OPERATORS MAY LOCATE AND MARK UNDERGROUND FACILITY PER SECTION 62-14-5 NMSA 1978 PRIOR TO ANY COMMENCEMENT OF WORK, CONTRACTOR SHALL REQUEST REAFFIRMATION OF LOCATION EVERY TEN (10) WORKING DAYS AFTER INITIAL REQUEST.

11. CONTRACTOR SHALL MAINTAIN EIGHTEEN (18) INCHES BETWEEN EXISTING UNDERGROUND FACILITIES THAT HAVE BEEN PREVIOUSLY DENTIFIED AND MARKED BY THE OWNERS/OPERATORS OF SAID FACILITIES, CUTTING EDGE OR POINT OF ANY MECHANICAL EXCAVATING EQUIPMENT UTILIZED IN EXCAVATION AREA WILL BE USED IN A MANNER NECESSARY TO PREVENT DAMAGE TO EXISTING UNDERGROUND FACILITIES.

12. CONTRACTOR SHALL PROVIDE SUPPORT FOR EXISTING UNDERGROUND FACILITIES IN OR NEAR EXCAVATION AREA AS NECESSARY TO PREVENT DAMAGE TO SAID FACILITIES.

13. CONTRACTOR SHALL BACKFILL ALL EXCAVATIONS IN A MANNER AND WITH MATERIALS AS MAY BE NECESSARY TO PREVENT DAMAGE TO AND PROVIDE RELIABLE SUPPORT DURING AND FOLLOWING BACK FILLING ACTIVITIES FOR PREEXISTING UNDERGROUND FACILITIES IN OR NEAR EXCAVATION AREA.

14, CONTRACTOR SHALL IMMEDIATELY NOTIFY BY TELEPHONE THE OWNER/OPERATOR OF ANY UNDERGROUND FACILITY WHICH MAY HAVE BEEN DAMAGED OR DISLODGED DURING EXCAVATION WORK.

15. CONTRACTOR SHALL NOT MOVE OR OBLITERATE MARKINGS MADE PURSUANT TO CHAPTER 62, ARTICLE 14 NMSA 1978, OR FABRICATE MARKINGS III A UMMARKED LOCATION FOR THE PURPOSE OF CONCEALING OR AVOIDING LIBBLITY FOR VIOLATION OF OR NONCOMPLIANCE WITH THE PROVISIONS OF CHAPTER 82, ARTICLE 11 NMSA 1978.

16. ELECTRONIC MARKER SPHERES (EMS) SHALL BE INSTALLED ON WATER LINE AND SANITARY SEWER LINE FACILITIES PER SECTION 170 OF THE BERNALILLO COUNTY STANDARD SPECIFICATIONS 1986 EDITION AS REVISED THROUGH UPDATE #8.

17, THE CONTRACTOR SHALL COORDINATE WITH THE WATER UTILITY AUTHORITY SEVEN (7) DAYS IN ADVANCE OF PERFORMING WORK THAT WILL AFFECT THE PUBLIC WATER OR SANITARY SEWER INFRASTRUCTURE. WORK REQUIRING SHLITOFF OF FACILITIES DESIGNATED AS MASTER PLAN FACILITIES MUST BE COORDINATED WITH THE WATER AUTHORITY 14 DAYS IN ADVANCE OF PERFORMING SUCH WORK. ONLY WATER AUTHORITY CREWS ARE AUTHORIZED TO OPERATE PUBLIC VALVES.

18. ALL EXCAVATION, TRENCHING, AND SHORING ACTIVITIES MUST BE CARRIED-OUT IN ACCORDANCE WITH OSHA 29 CFR 1926.8150 SUBPART P.

19. ALL IMPACTED STRIPING SHALL BE REPLACED BY CONTRACTOR.

20. MANHOLE STEPS SHALL NOT BE INSTALLED IN SANITARY SEWER MANHOLES.


21. ALL WATER METERS SHALL INCLUDE DUAL CHECK VALVE SETTERS.

22. ALL WATER METER COVERS AND LIDS SHALL BE PER TOWN OF BERNALILLO STANDARDS.

23. ALL MANHOLES AND VALVES SHALL HAVE GPS INFORMATION RECORDED AS PART OF AS BUILT PLAN SET.

24. CONTRACTOR SHALL VERIFY ALL EXISTING CONNECTIONS PRIOR TO CONSTRUCTION, CONTRACTOR SHALL NOTIFY ENGINEER OF THE HORIZONTAL AND VERTICAL LOCATION PRIOR TO CONSTRUCTION.

EXISTING UTILITIES ARE NOT SHOWN.
IT SHALL BE THE SOLE RESPONSIBILITY
OF THE CONTRACTOR TO CONDUCT ALL
NECESSARY FIELD INVESTIGATIONS PRIOR
TO ANY EXCAVATION TO DETERMINE THE
ACTUAL LOCATION OF UTILITIES & OTHER
IMPROVEMENTS.

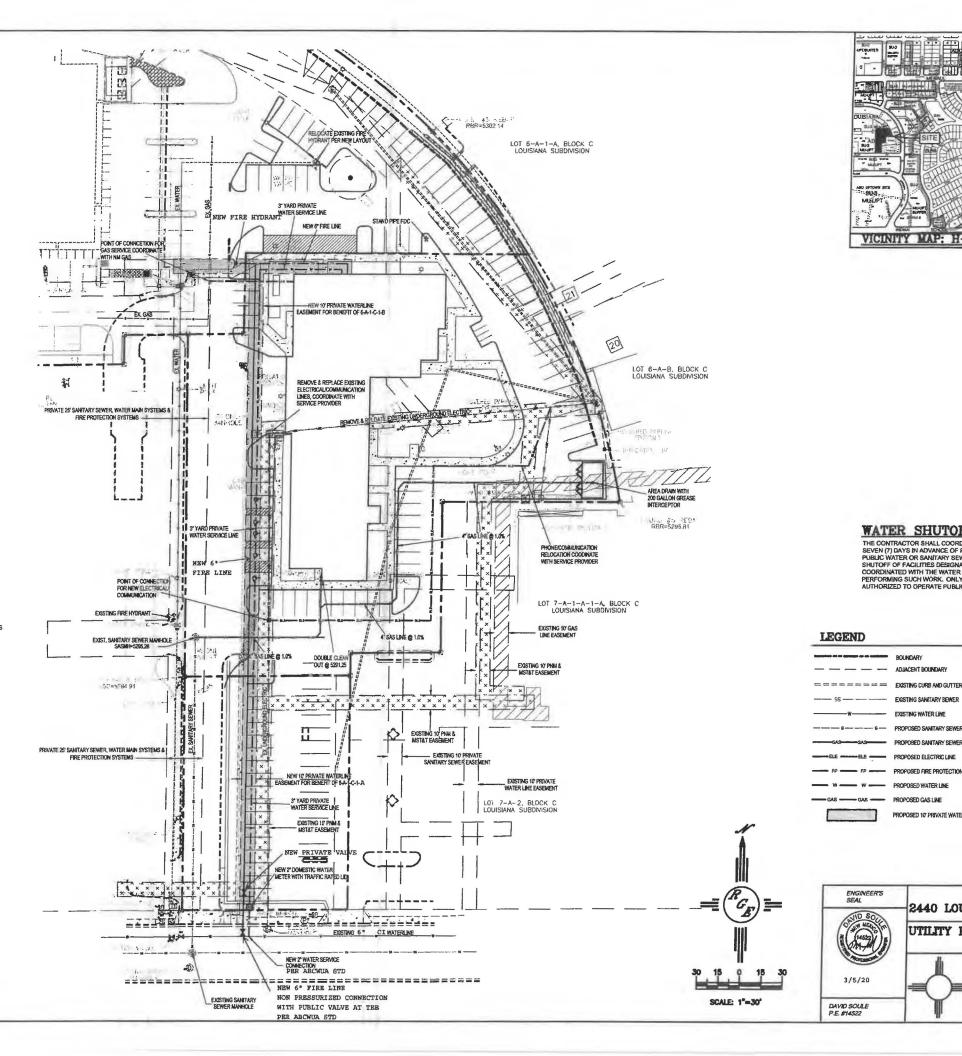

WATER SHUTOFF NOTES:

AUTHORIZED TO OPERATE PUBLIC VALVES.

BOUNDARY

EXISTING WATER LINE

PROPOSED 10' PRIVATE WATER EASEMENT

2440 LOUISIANA BLVD.

Rio Grando

Engineering

UTILITY PLAN

- - ADJACENT BOUNDARY

GAS - PROPOSED GAS LINE

THE CONTRACTOR SHALL COORDINATE WITH THE WATER UTILITY AUTHORITY SEVEN (7) DAYS IN ADVANCE OF PERFORMING WORK THAT WILL AFFECT THE PUBLIC WATER OR SANITARY SEWER INFRASTRUCTURE. WORK REQUIRING SHUTOFF OF FACILITIES DESIGNATED AS MASTER PLAN FACILITIES MUST BE COORDINATED WITH THE WATER AUTHORITY 14 DAYS IN ADVANCE OF

CB = CLIRB
BPOND = BOTTOM OF POND
DRN = DRAIN
EC = EDGE-OF CONCRETE
FF = FINISHED FLOOR
FL = FLOW LINE
MAD = NAME, B DISC.
RMP = RAMP
SABMH = SANITARY SEWER MANHOLE
TA = 100 PO F ASPHALT
D = 16MET DO F DE SANITARY SEWER MANHOLE
TA = 100 PO F ASPHALT

BY DEM

DATE 10-24-19

SHEET # C2

JOB#

OURSIANA BLVD.DI

□ = CABLE BOX
 □ = IRRIGATION BOX


= WATER VALVE

WATER METER

E = ELECTRIC MANHOLE

S = SANTARY SEWER MANHOLE (D) = STORM DRAIN MANHOLE

PERFORMING SUCH WORK, ONLY WATER AUTHORITY CREWS ARE

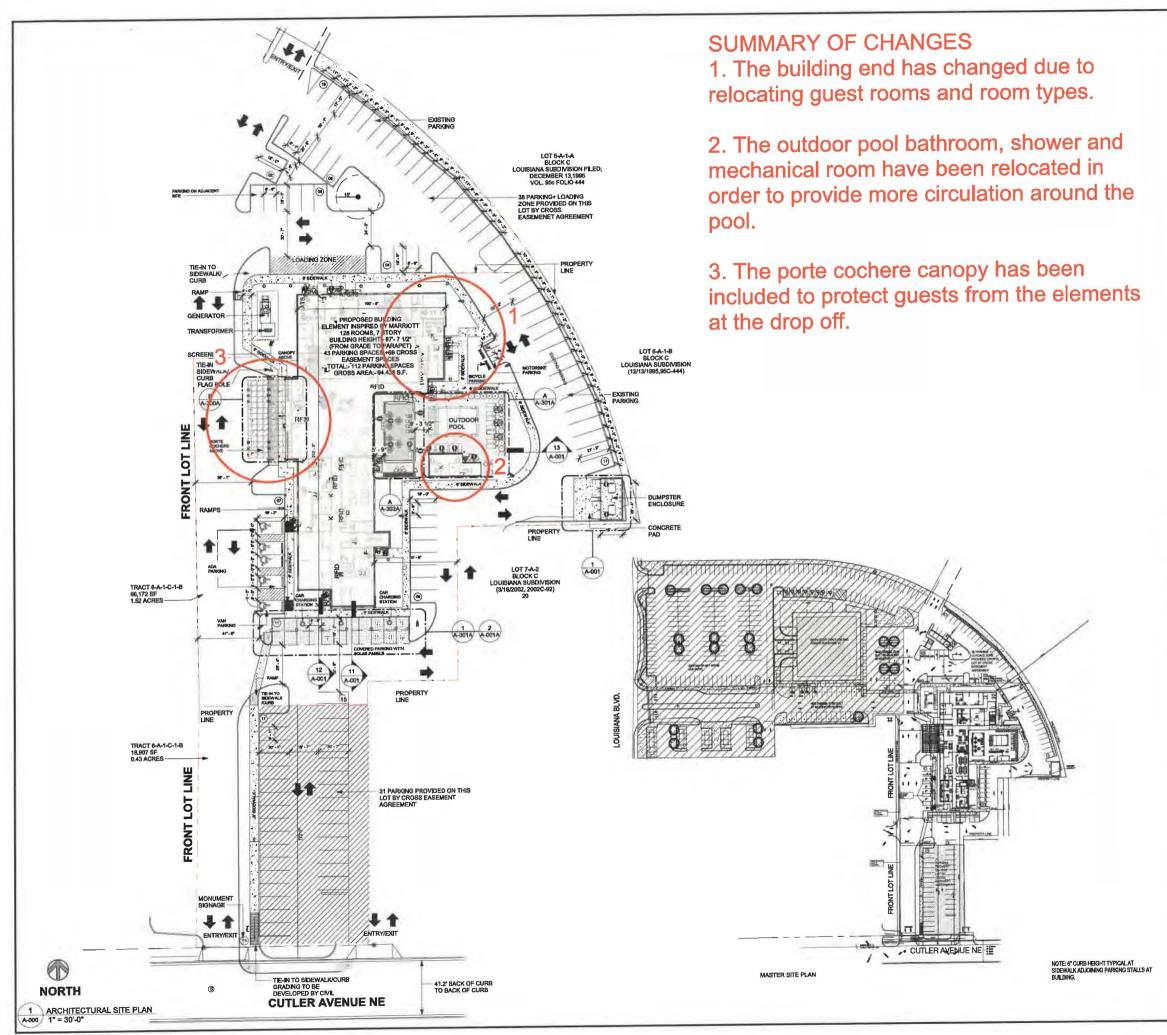

GENERAL NOTES - SITE PLAN

- AL SITE PLAN INFORMATION IS BASED ON TOPOGRAPHIC SUBVIEY PREPARED BY CIVIL ENGINEER. SEE SHEET G-002 FOR CONTACT INFORMATION REFER TO CAVE. ENGINEERING DRAWINGS FOR ADDITIONAL INFORMATION PERTANNICS FOR DESIGN. CLURE CUTS, PAVING, AND PARKING LOT DIMENSIONS. CONTRACTOR GHALL COORDINATE, PRIOR TO THE COMMENCEMENT OF BITTE WORK, THE FINISH FLOOR ELEVATION WITH THE CIVIL ENGINEER AND THE STRUCTURE HORSE.
- ELEVATION WITH THE CMIL ENGINEER AND THE STRUCTURAL ENGINEER STRUCTURAL ENGINEER STRUCTURAL ENGINEER STRUCTURAL ENGINEER STRUCTURAL ENGINEER STRUCTURAL STOTHE EXTENT UNNECESSARY COSTS ARE INCURRED OR DELAYS ARE ANTICIPATED, THE OWNER AND ARCHITECT SHALL BE CONSULTED. THE ARCHITECT, IN CONJUNCTION WITH THE OWNER, WILL DETERMINE THE RESOLUTION. PRIOR TO CONSTRUCTION GENERAL CONTRACTOR SHALL VERLY ALL ITEMS SHOWN AS EXISTING ON THESE DRAWINGS AND NOTIFY THIS OFFICE OF ANY
- DRAWINGS AND NOTIFY THE UTTILL OF THE DISCREPANCIES DISCREPANCIES CONTRACTOR MUST TAKE PRECAUTIONS TO PROTECT OWNERS PROPERTY FROM CONSTRUCTION OPERATIONS BOUNDARY OF CONTRACTOR'S WORK AND STORAGE AREAS WILL BE DEFINED TO MUTUAL AGREEMENT BY CONFERENCE

- CONFERENCE

 LIMITS OF CONSTRUCTION TO BE AREA WITHIN
 PROPERTY LINE OR AS INDICATED WITH LIMIT LINES OF
 CONSTRUCTION
 CONSTRUCTION
 THE MINIMUM REQUIREMENTS FOR
 PAYEMENT DESIGN RECOMMENDATION WALL UNO PER
 CIVIL DRAWNIGS AND SOIL REPORT.
 GENERAL CONTRACTOR TO PROVIDE PAINTED
 STRIPPIG, WORDING, DIRECTIONAL ARROWS AND
 SYMBOLS IN ACCORDANCE WITH SPECIFICATIONS,
 NATIONAL AND LOCAL CODES.
 ALL CONCRETE WALKS ARE 5-07 WIDE AND TO HAVE
 NON-SLIP BROOM FINISH WITH 1/2" EXPANSION JOINT @
 EVERY 25-07 0.C.
- EVERY 25-0" O.C. ALL ACCESSIBLE ROUTES SHALL COMPLY WITH ADA
- ALL ACCESSIBLE ROUTES SHALL COMPLY WITH ANA GUIDELINES.
 ALL EXTERIOR SIGNAGE SHALL BE AS DIRECTED BY OWNER (EXCEPT AS DETAILED WITHIN THESE CONSTRUCTION DOCUMENTS) AND IN COMPLIANCE WITH LOCAL CODES, ADA GUIDELINES AND ANSI VERSIONS ADOPTED BY THE MUNICIPALITY. GENERAL CONTRACTOR TO PROVIDE ELECTRICAL CONDUTT & POWER, SIGNAGE & FOUNDATION ARE O.F.O.I.

- POWER, SIGNAGE & FOUNDATION ARE O.F.O.I.

 COORDINATE EXTERIOR UTILITY LOCATIONS W/ CIVIL
 ENGINEERING DWIGS & WITH UTILITY COMPANIES PRIOF
 TO COMMENCEMENT OF CONSTRUCTION
 GENERAL CONTRACTOR TO ENSURE GAS METER
 PROTECTION WITH STEEL BOLLARDS AS REQUIRED BY
 LOCAL UTILITY JURSDICTION & CODE REQUIREMENTS
 ALL ROOF DRAINS TO TE INTO STORM DRAINAGE
 SYSTEM (SEE CIVIL)
 REFER TO CIVIL ENGINEERING DRAWINGS FOR SITE
 CONSTRUCTION DETAILS, INCLUDING CURB AND
 GUITTER DETAILS AND RADI.
 LANDSCAPE DESIGN IS WOT INCLUDED WITHIN THE
 SCOPE OF WORK REPRESENTED IN THESE DRAWINGS.
 EACH ACCESSIEL PARIONS SHALL BE POSTED W/
 PERMANENT SIGN BEARING THE INTERNATIONAL
 SYMBOL OF ACCESSIBILITY AND THE CAPTION FARKING
 BY DISABLED PERMIT ONLY AND ANY OTHER
 INFORMATION THAT MAY BE REQUIRED LOCALLY,

GROSS AREA (EXCLUDING COVERED OUTDOOR SPACES)

| LEVEL | AREA |
|------------|-----------|
| 1ST FLOOR | 19,167 SF |
| ZND FLOOR | 12,613 SF |
| 3RD FLOOR | 13,787 SF |
| 4TH FLOOR | 13,787 SF |
| 5TH FLOOR | 13,787 SF |
| 6TH FLOOR | 13,787 SF |
| ROOF LEVEL | 7,509 SF |
| TOTAL: 9 | 94,438 SF |

PARKING MATRIX

| REQUIRED | PROVIDED |
|----------|--------------|
| 4 | 4 |
| 1 | 1 |
| 121 | 116 |
| 11 | 11 |
| 7 | 7 |
| 4 | 4 |
| 104° | 116 |
| 4 | 8 |
| | 11 7 4 |



BASE4 2901 CLINT MOORE ROAD, #114

BOCA RATON, FLORIDA 33496 888.901,8008 www.base-4.com RICARDO J. MUNIZ-GUILLET. AIA 2030 HABERSHAM TRACE, CUMMING, GA 30041







2430 LOUISIANA BLVD. NE ALBUQUERQUE, NM 87110, USA PROTOTYPE VERSION: GEN 2.5 REVISION DATE: 2020.02.11 ID PACKAGE: ENLIVEN DECOR PACKAGE VERSION 2.5

DELTA ISSUE DATE DESCRIPTION

ISSUED FOR PERMIT


EDATE 2021.07.15

B4-176-1901

SHEET NAME

ARCHITECTURAL SITE PLAN

DRAWINGS NO.

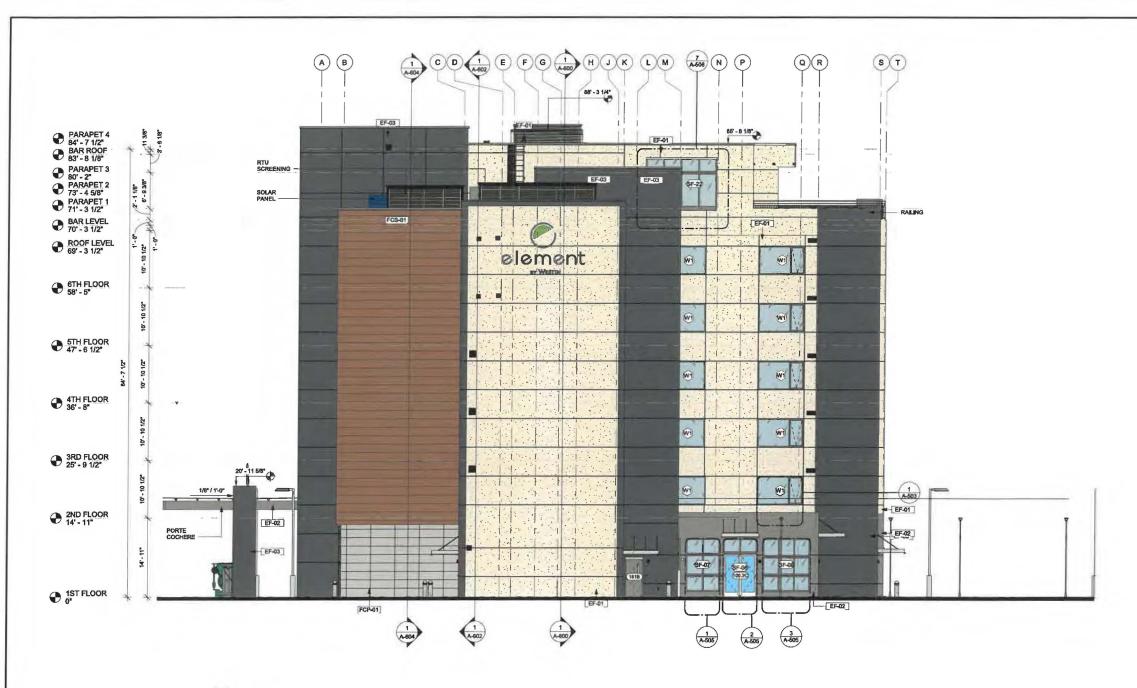

1 SOUTH ELEVATION 1/8" = 1'-0"

GENERAL ELEVATION NOTES

- REVIEW ALL SIGHTLINES AROUND PROPERTY BEFORE LOCATING ROOFTOP EQUIPMENT. VERIFY ALL EQUIPMENT IS ADEQUATELY SCREENED.

 GC TO PROVIDE A MOCK WALL SHOWING A FULL WINDOW INSTALL WITH FLASHING, GC CAN USE A PROPORTIONALLY SCALED DOWN WINDOW IN LIEU OF FULL SIZE WINDOW.

 ALL EXTERIOR VENTS, GRILLES, MECHANICAL LOUVERS AND EXTERIOR HOLLOW METAL DOORS TO BE FAISHED TO MATCH ADJACENT EXTERIOR MATERIAL.

 ALL BULDING PERMITS TO BE CONSISTENT WITH THE APPROVED SITE PLAN. THE PLANNING DEPARTMENT DOES NOT REVEW BUILDING PERMIT PLAN SETS, SO IT IS THE DEVELOPERS RESPONSIBLITY TO ENSURE THAT ELEVATIONS SUBMITTED IN THE BUILDING PERMIT SET MATCH THOSE APPROVED DURING THE SITE PLAN REVIEW PROCESS. IF THE ELEVATIONS DO NOT MATCH THOSE IN THE SITE PLAN REVIEW PROCESS. IF THE ELEVATIONS DO NOT MATCH THOSE IN THE SITE PLAN FERMEL DELAY THE SINJANCE OF A CERTIFICATE OF DCCUPANCY AT THE END OF CONSTRUCTION, AND MAY NECESSITATE MODIFICATIONS TO THE CONSTRUCTED BUILDING. ALL UENT PEPS, ETC. EXTENDING ABOVE THE ROOF SURFACE MUST BE PAINTED A COLOR THAT BLENDS WITH THE ROOF OLO.OR. ARCHITECTURAL FRISH FLOOR ELEVATIONS REFER TO TOP OF FINISH FLOOR ASSEMBLY. SEES STRUCTURAL DWGS FOR TOP OF STRUCTURE AND BEARING HEIGHT ELEVATIONS.

GENERAL SIGNAGE NOTES

JENERAL SIGNAGE NUI ES

ALL SIGNAGE NICATED FOR LIUSTRATIVE
PURPOSES ONLY, LOCATION, SIZE ETC. TO BE
ENTERMINED ON AN INDIVIDUAL PROJECT TASIS,
MINIMI 34° PLYWOOD BACKER BOARD
REQUIED AT SIGN LOCATIONS, AREA SHOULD
COVER ENTIRE LENGTH AND HEIGHT OF FASCIA
OR SPACE AVAILABLE FOR SIGN.
ELECTRICAL AND FINAL CONNECTION BY
CONTRACTOR. ELECTRICAL REQUIREMENTS MAY
BE OBTAINED FROM SIGN COMPANY.
PERMANNENT ACCESS DOORS TO INTERIOR OF
ALL PARAPETS WHERE SIGNS ARE LOCATED TO
BE PROVIDED BY CONTRACTOR. CONTRACTOR.

| EXTERIOR FINISH LEGEND | | | | | | |
|------------------------|----------------------------|-----------------------------------|-------------------|--|--|--|
| MARK | MATERIAL / BRAND | COLOR / FINISH | MATERIAI IMAGE | | | |
| BK-01 | | ASHEN BLACK - 820 | | | | |
| EF-01 | EIF8-PAREX | SANDPEBBLE-ELEM-01-2736-WHITE | | | | |
| EF-02 | EIFS-PAREX | SANDPEBBLE-ELEM-01-1022-DARK GREY | | | | |
| EF-03 | EIFS-PAREX | SANDPEBBLE-MIDNIGHT-MC-048 | | | | |
| FCP-01 | FIBRE CEMENT PANEL/NICHIHA | NICHIA PANEL-GLACIER | | | | |
| FCS-01 | FIBER CEMENT PANEL-NICHIHA | VINTAGE CEDAR BARK | | | | |



BASE4

BASE4 2901 CLINT MOORE ROAD, #114 BOCA RATON, FLORIDA 33496 888 901 8008 www.base-4.com

RICARDO J. MUNIZ-GUILLET, AIA 2030 HABERSHAM TRACE, CUMMING, GA 30041





4239 BALLOON PARK ROAD ALBUQUERQUE, NM 87109 505.831.4200



2430 LOUISIANA BLVD, NE ALBUQUERQUE, NM 87110, USA PROTOTYPE VERSION: GEN 2.5 REVISION DATE: 2020.02.11 ID PACKAGE:- ENLIVEN DECOR PACKAGE VERSION 2.5

| 6 | A7 | 2021,10,21 | ADD#2 |
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| 1 | AD | 2020.12.01 | ISSUED FOR PERMIT |

ISSUED FOR PERMIT

2021.07.15

SB/NS

CHECKED BY

PROJECT NO. B4-176-1901

SHEET NAME

BUILDING **ELEVATION-1**

DRAWINGS NO.



2901 CLINT MOORE ROAD, #114 BOCA RATON, FLORIDA 33496 888,901,8008 www.base-4.com RICARDO J. MUNIZ-GUILLET, AIA 2030 HABERSHAM TRACE, CUMMING, GA 30041 RICARDO J MUNIZ GUILLET DATE: 2021.12.14 TOTAL MANAGEMENT SYSTEMS 4239 BALLOON PARK ROAD ALBUQUERQUE, NM 87109 505.831.4200 2430 LOUISIANA BLVD. NE ALBUQUERQUE, NM 87110, USA PROTOTYPE VERSION: GEN 2.5 REVISION DATE: 2020.02.11 ID PACKAGE: ENLIVEN DECOR PACKAGE VERSION 2.5 DELTA ISSUE DATE DESCRIPTION A7 2021,10,21 ADD#2 A0 2020,12,01 ISSUED FOR PERMIT CURRENT ISSUE **ISSUED FOR PERMIT** 2021.07.15 SB/NS CHECKED BY LA/RB PROJECT NO. B4-176-1901 SHEET NAME BUILDING **ELEVATION-2**

DRAWINGS NO.

A-607

GENERAL ELEVATION NOTES

- REVIEW ALL SIGHTLINES AROUND PROPERTY BEFORE LOCATING ROOFTOP EQUIPMENT. VERIFY ALL EQUIPMENT IS ADEQUATELY SCREENED.

 GC TO PROVIDE A MOCK WALL SHOWING A FULL WINDOW INSTALL WITH FLASHING, GC CAN USE A PROPORTIONALLY SCALED DOWN WINDOW IN LIEU OF FULL SIZE WINDOW.


 ALL EXTERIOR VENTS, GRILLES, MECHANICAL LOLVERS AND EXTERIOR HOLLOW METAL DOORS TO BE FINISHED TO MATCH ADJACENT EXTERIOR MATERIAL.

 ALL BULDING PERMIFS TO BE CONSISTENT WITH THE APPROVED SITE PLAN. THE PLANNING DEPARTIENT DOES NOT REVIEW BUILDING PERMIF FLAN SITE, SO IT IS THE DEVELOPERS RESPONSIBLITY TO ENSURE THAT ELEVATIONS SUBMITTED IN THE BUILDING PERMIFS ENTAIN THOSE APPROVED DURNINTHE SITE PLAN REVIEW PROCESS. IF THE THE SELENCE OF A CERTIFICATE ON THE SELENCE OF THE SELENCE OF A CERTIFICATE ON THE SELENCE OF THE SELENCE OF A CERTIFICATE ON THE SELENCE OF THE SELENCE OF A CERTIFICATE ON THE CONSTRUCTION AND MAY NECESSITATE MODIFICATIONS TO THE CONSTRUCTION BUILDING. ALL VENT PERS. ETC. EXTENDING ABOVE THE ROOF SERRACE MUST BE PAINTED A COLOR THAT BLENDS WITH THE ROOF COLOR.

 ARCHITECTURAL FINISH FLOOR ELEVATIONS REFER TO TOP OF FINISH FLOOR ASSEMBLY, SEE STRUCTURAL DWGS FOR TOP OF STRUCTURE AND BEARING HEIGHT ELEVATIONS

GENERAL SIGNAGE NOTES GENERAL SIGNAGE NOTES ALL SIGNAGE NOICATED FOR LILLSTRATIME PURPOSES ONLY, LOCATION, SIZE, ETC. TO BE DETERMINED ON AN NOIMPOUAL PROJECT BASIS. MINIMUM AN "PLYWOOD BACKER BOADD REQUIRED AT SIGN LOCATIONS, AREA SHOULD COVER ENTIRE LEMBTH AND HEIGHT OF FASCIA OR SPACE AVAILABLE FOR SIGN. ELECTRICAL AND FINAL CONNECTION BY CONVENTED LEMBERS OF SIGNATURE DESCRIPTION BY PERMANENT ACCESS DOORS TO INTENDR OF ALL PROVIDE WEATHER PROOF ACCESS DOORS AT TROOF LEVEL OR ANYWHERE EXTERIOR OR WET CONDITIONS MAY APPLY GUESTROOMS OR PUBLIC SPACES WITH SIGNAGE ON EXTERDIOR WALLS MUST HAVE SIGNAGE AND SIGN COMPANY.

| | EXTERIOR FINISH LEGEND | | | | | |
|--------|----------------------------|-----------------------------------|-------------------|--|--|--|
| MARK | MATERIAL / BRAND | COLOR / FINISH | MATERIAI IMAGE | | | |
| BK-01 | | ASHEN BLACK - 820 | | | | |
| EF-01 | EFS-PAREX | SANDPEBBLE-ELEM-01-2738-WHITE | | | | |
| EF-02 | EIFS-PAREX | SANDPEBBLE-ELEM-01-1022-DARK GREY | | | | |
| EF-03 | EIFS-PAREX | SANDPEBBLE-MIDNIGHT-MC-048 | - 26 | | | |
| FCP-01 | FIBRE CEMENT PANEL/NICHIHA | NICHIA PANEL-GLACIER | | | | |
| FCS-01 | FIBER CEMENT PANEL-NICHIHA | VINTAGE CEDAR BARK | T (36) | | | |

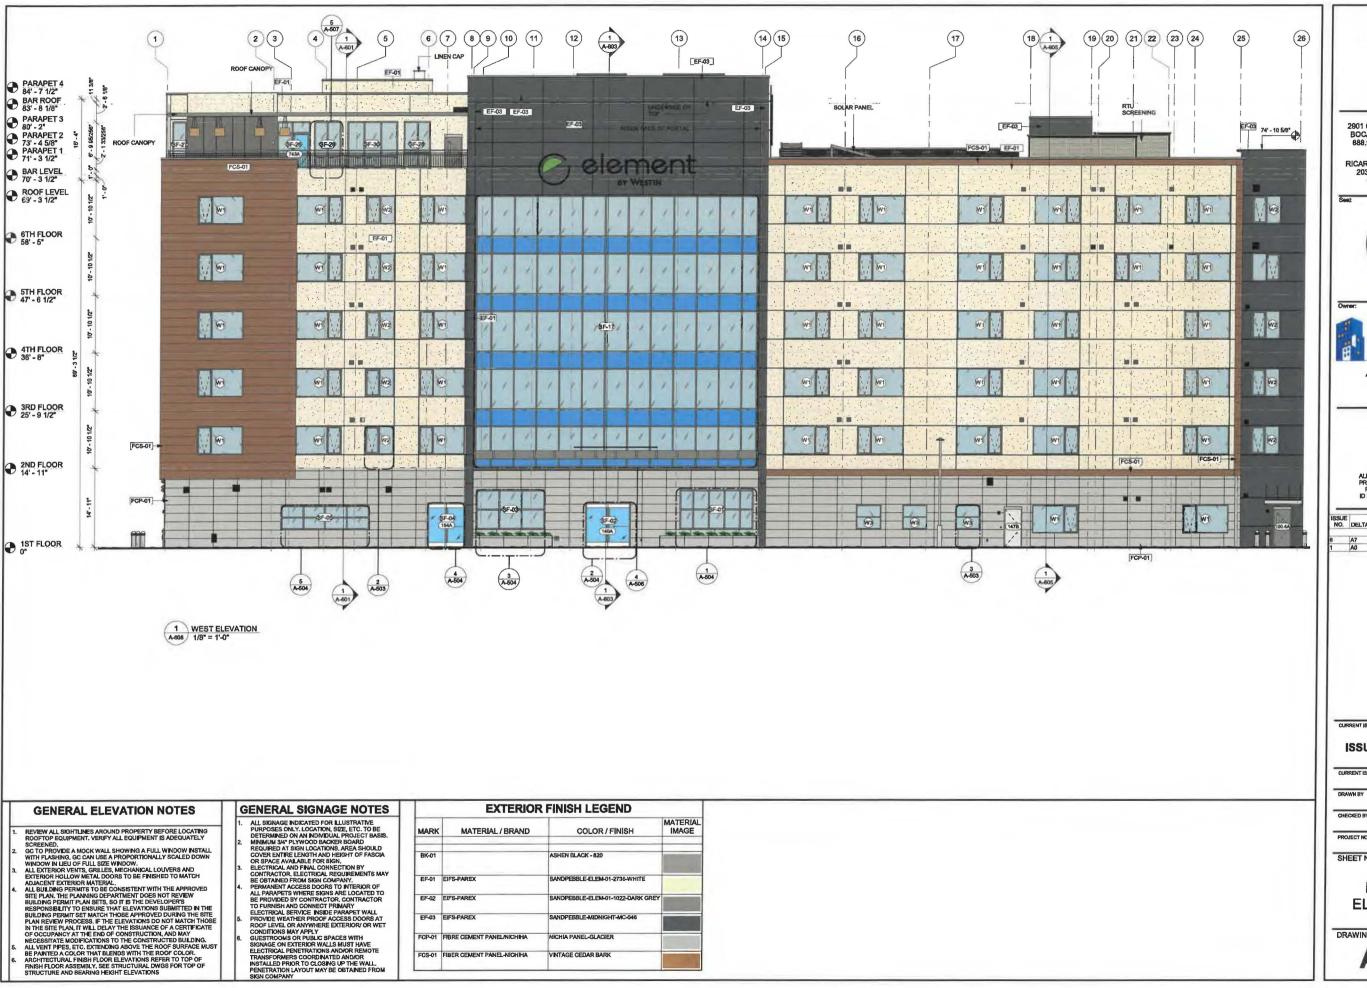



RICARDO J. MUNIZ-GUILLET, AIA 2030 HABERSHAM TRACE, CUMMING, GA 30041







2430 LOUISIANA BLVD. NE ALBUQUERQUE, MM 87110, USA PROTOTYPE VERSION: GEN 2.5 REVISION DATE: 2020.02.11 ID PACKAGE: ENLIVEN DECOR PACKAGE VERSION 2.5

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CURRENT ISSUE

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CURRENT ISSUE DATE 2021.07.15

SB/NS


LA/RB

PROJECT NO. B4-176-1901

SHEET NAME

BUILDING **ELEVATION-3**

DRAWINGS NO.

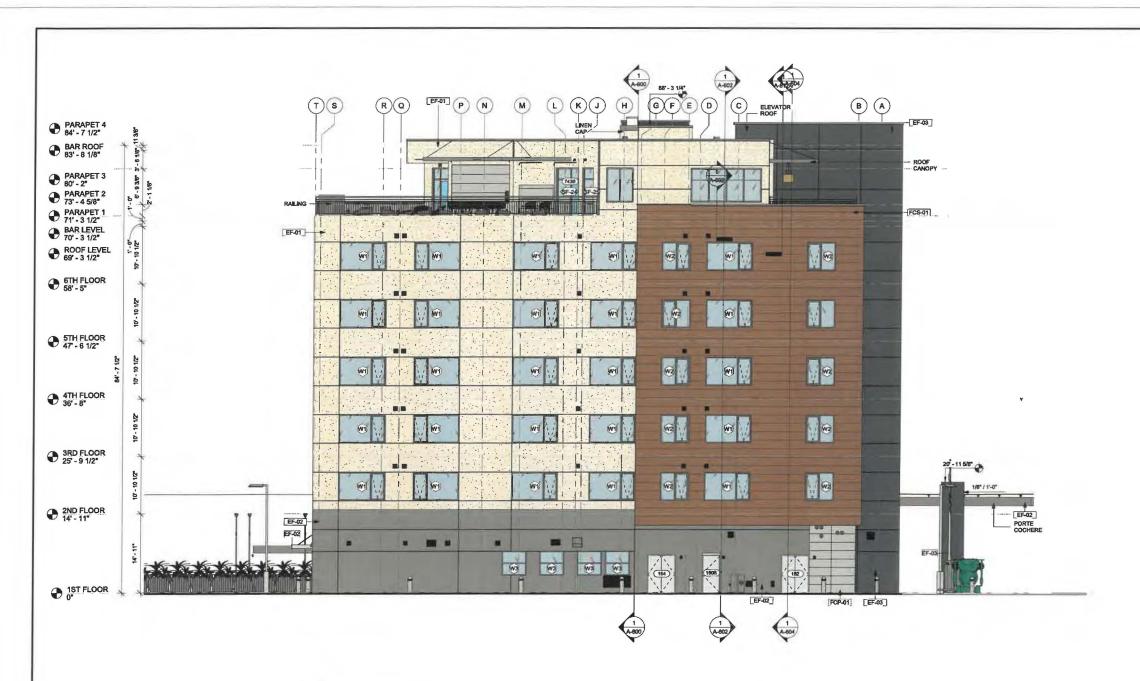

1 NORTH ELEVATION A-609 1/8" = 1'-0"

EXTERIOR FINISH LEGEND GENERAL SIGNAGE NOTES GENERAL ELEVATION NOTES ALL SIGNAGE NOTES

ALL SIGNAGE NIDICATED FOR LLUSTRATIVE
PURPOSES ONLY, LOCATION, SZE, ETC. TO BE
DETERMINED ON AN INDIVIDUAL PROJECT BASIS.
MINIMUM 34" PLYWOOD BACKER BOADD
REQUIRED AT SIGN LOCATIONS, AREA SHOULD
COVER ENTIRE LENGTH AND HEIGHT OF FASCIA
OR SPACE AVAILABLE FOR SIGN.
LECTRICAL AND FANL CONNECTION BY
CONTRACTOR. ELECTRICAL REQUIREMENTS MAY
BE DISTAINED FROM SIGN COMPANY.
PERMANENT ACCESS DOORS TO INTENIOR OF
ALL PRAMPETS WHERE BIGNS ARE LOCATED TO
BE PROVIDED BY CONTRACTOR. CONTRACTOR
TO FURNISH AND CONNECT PRIMARY
LECTRICAL SERVICE INSEE PARAPET WALL
PROVIDE WEATHER PROOF ACCESS DOORS AT
ROOF LEVEL OR ANYWHERE EXTERIOR OR WET
CONDITIONS MAY APPLY.
QUESTROOMS OR PUBLIS PRACES WITH
BIONAGE ON EXTERIOR WALLS MUST HAVE
ELECTROOMS BENEFICATION AND SIGNED FOR THE PROPERTY
MISTALLED PRODOR TO CLOSING UP THE WALL
PENETRATION LAYOUT MAY BE OBTANED FROM
SIGN COMPANY. REVIEW ALL SIGHTLINES AROUND PROPERTY BEFORE LOCATING ROOFTOP EQUIPMENT. VERIFY ALL EQUIPMENT IS ADEQUATELY SCREENED.

GC TO PROVIDE A MOCK WALL SHOWING A FULL WINDOW INSTALL WITH FLASHING, GC CAN USE A PROPORTIONALLY SCALED DOWN WINDOW IN LIEU OF FULL SIZE WINDOW.

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BASE4

BASE4 2901 CLINT MOORE ROAD, #114 BOCA RATON, FLORIDA 33496 888.901,8008 www.base-4.com

RICARDO J. MUNIZ-GUILLET, AIA 2030 HABERSHAM TRACE, CUMMING, GA 30041



DATE: 2021.12,14



4239 BALLOON PARK ROAD ALBUQUERQUE, NM 87109 505.831.4200



2430 LOUISIANA BLVD. NE ALBUQUERQUE, NM 87110, USA PROTOTYPE VERSION: GEN 2.5 REVISION DATE: 2020,02.11 ID PACKAGE: ENLIVEN DECOR PACKAGE VERSION 2.5

| NO. | DELIA | ISSUE DATE | DESCRIPTION |
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| 6 | A7 | 2021,10.21 | ADD#2 |
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CURRENT ISSUE DATE 2021.07.15

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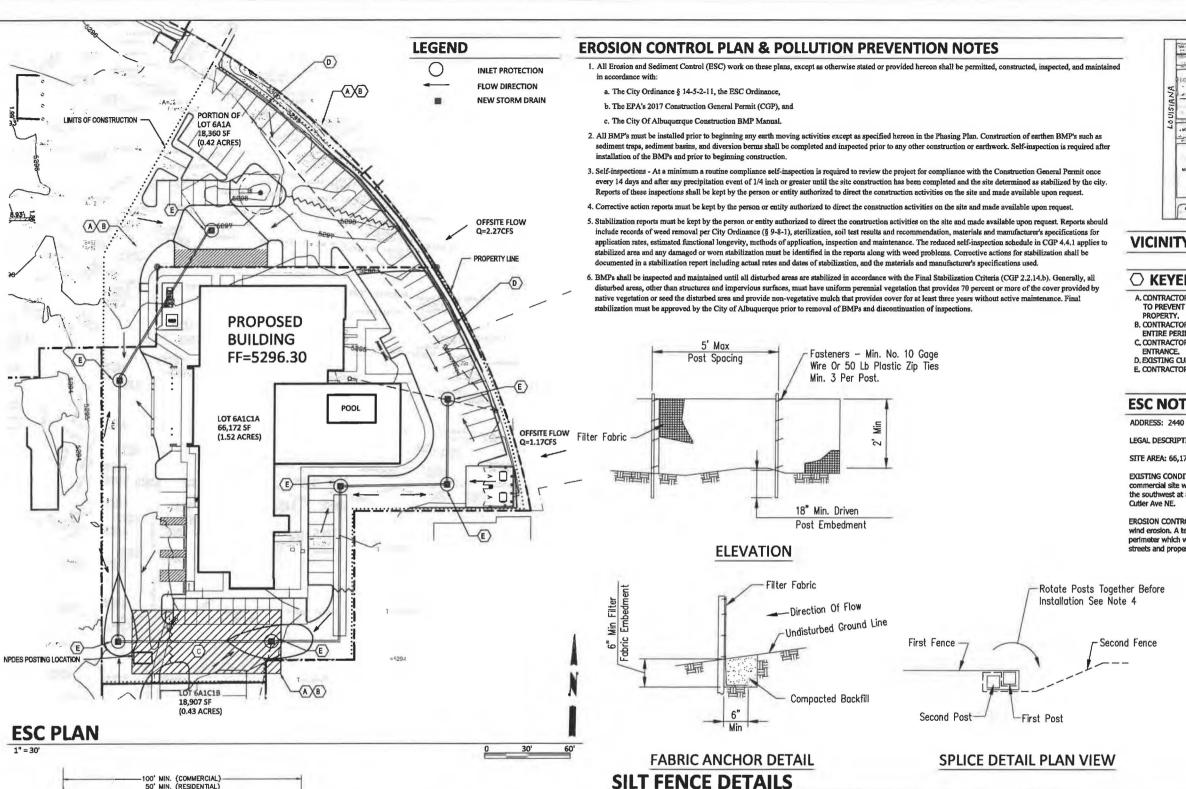
LA/RB

PROJECT NO. B4-176-1901

SHEET NAME

BUILDING ELEVATION-4

DRAWINGS NO.



VICINITY MAP

H-19-Z

O KEYED NOTES

- A. CONTRACTOR SHALL INSTALL PERIMETER BMP PROTECTION TO PREVENT SEDIMENT FROM ENTERING ADJACENT
- B. CONTRACTOR SHALL INSTALL SILT FENCE ALONG THE
- ENTIRE PERIMETER OF CONSTRUCTION FACILITIES,
 C. CONTRACTOR SHALL INSTALL STABILIZED CONSTRUCTION
- D. EXISTING CURB AND GUTTER TO REMAIN.
 E. CONTRACTOR SHALL INSTALL INLET PROTECTION.

ESC NOTES

ADDRESS: 2440 Louisiana Blvd NE, Albuquerque, NM

LEGAL DESCRIPTION: TRACT 6-A-1-C-1-A, BLOCK 'C' LOUISIANA SUBDIVISION

SITE AREA: 66.172 SF (1.519 acres)

EXISTING CONDITIONS: The site is a fully developed portion of an existing commercial site with asphalt parking and landscaping. The site slopes down slightly to the southwest at approximately 1.5% and runoff discharges to the public R/W of

EROSION CONTROL: Disturbed portions of the site shall be kept wetted to minimize wind erosion. A temporary construction fence with screening will follow the site perimeter which will help mitigate windblown sediment. The impact on surrounding streets and properties should be minimized.

- TEMPORARY SILT FENCE SHALL BE INSTALLED PRIOR TO ANY GRADING WORK IN THE AREA TO BE PROTECTED, FENCE SHALL BE MAINTAINED THROUGHOUT THE CONSTRUCTION PERIOD AND REMOVED IN CONJUNCTION WITH THE FINAL GRADING AND SITE STABILIZATION.
- FILTER FABRIC SHALL MEET THE REQUIREMENTS OF MATERIAL SPECIFICATION 592 GEOTEXTILE TABLE 1 OR 2, CLASS 1 WITH EQUIVALENT OPENING SIZE OF AT LEAST 30 FOR NONWOVEN AND 50 FOR WOVEN.
- FENCE POSTS SHALL BE WITHER WOOD POST WIT A MINIMUM CROSS-SECTIONAL AREA 1.5"x1.5" OR A STANDARD STEEL POST
- WHEN SLICES ARE NECESSARY, MAKE SPLICE AT POST ACCORDING TO SPLICE DETAIL, PLACE THE END POSE OF THE SECOND FENCE INSIDE THE END POST OF THE FIRST FENCE. ROTATE BOTH POSTS TOGETHER AT LEAST 180 DEGREES TO CREATE A TIGHT SEAL WITH THE FABRIC MATERIAL, CUT THE FABRIC NEAR THE BOTTOM OF THE POSTS TO ACCOMMODATE THE 6" FLAP. THEN DRIVE BOTH POSTS AND BURY THE FLAP.

FILTER FABRIC

- 1. ENTRANCE(S) SHALL BE LOCATED TO PROVIDE MAXIMUM UTILITY BY ALL
- CONSTRUCTION VEHICLES.
 TURNING RADIUS SUFFICIENT TO ACCOMMODATE LARGE TRUCKS IS TO BE
- MUST BE MAINTAINED IN A CONDITION WHICH WILL PREVENT PERIODIC TOPDRESSING WITH STONE WITH BE NECESSARY, CONTRACTOR SHALL MAINTAIN AS NECESSARY.
- ANY MATERIAL WHICH STILL MAKES IT ONTO THE ROAD MUST BE CLEANED UP IMMEDIATELY.
- FREQUENT CHECKS OF THE ENTRANCE(S) AND TIMELY MAINTENANCE SHALL
- NOTES ARE APPLICABLE AT ALL POINTS OF INGRESS AND EGRESS UNTIL SITE
- 7. UTILIZE FILTER FABRIC IN CLAY SOILS.



ELEMENT HOTEL 2440 LOUISIANA BLVD NE

Scott M McGee PE

9700 Sand Verbena Trail NE

Albuquerque, NM 87122 505.263.2905 scottmmcgee@gmail.com

50' MIN (RESIDENTIAL)

PLAN VIEW


CONSTRUCTION ENTRANCE FOR EROSION CONTROL

EXISTING -

6" MIN. -1 3" - 4" STONE

SIDE CROSS SECTION VIEW

25' OR WIDTH OF PROPOSED STREET OR DRIVEWAY, WHICHEVER IS GREATER.

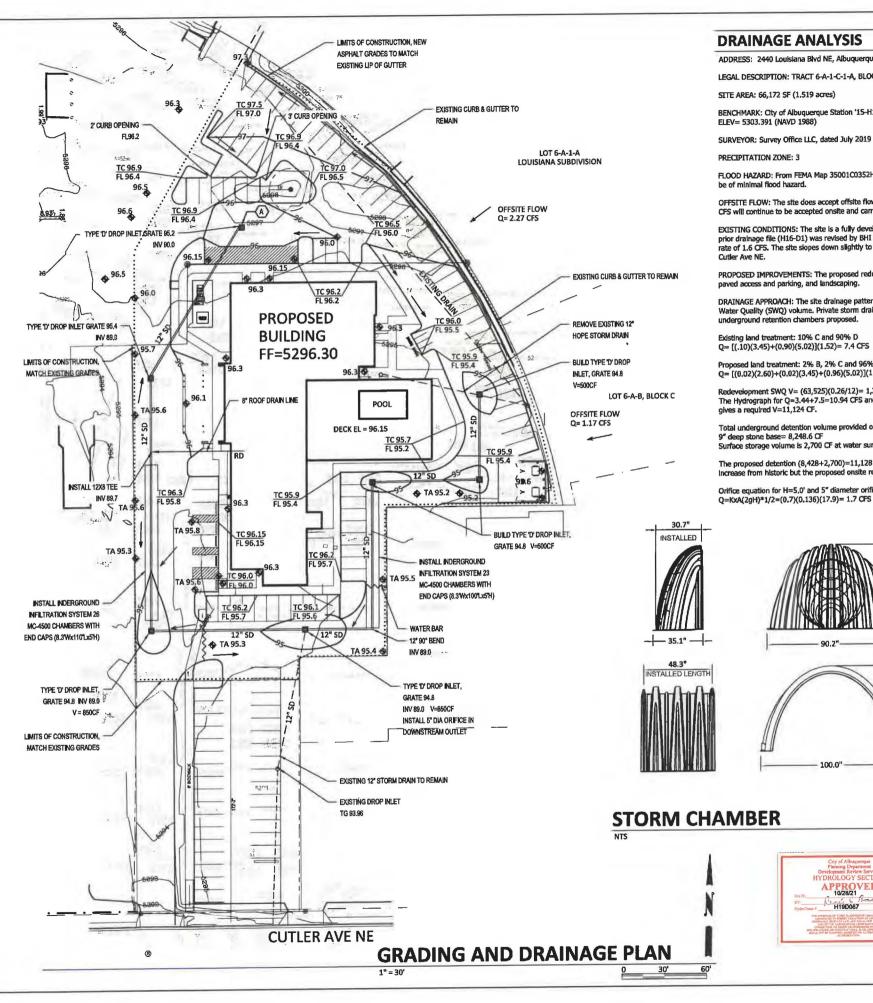

DRAINAGE ANALYSIS

ADDRESS: 2440 Louisiana Blvd NE, Albuquerque, NM

LEGAL DESCRIPTION: TRACT 6-A-1-C-1-A, BLOCK 'C' LOUISIANA SUBDIVISION

SITE AREA: 66,172 SF (1.519 acres)

BENCHMARK: City of Albuquerque Station '15-H18' being a brass cap.

ELEV= 5303.391 (NAVD 1988)

FLOOD HAZARD: From FEMA Map 35001C0352H (8/16/12), this site is identified as being within Zone 'X' which is determined to

OFFSITE FLOW: The site does accept offsite flows from two tracts adjacent to the east as shown on the plan. The total Q=3.44 CFS will continue to be accepted onsite and carried south toward Cutier per the historic flow pattern.

EXISTING CONDITIONS: The site is a fully developed portion of an existing site with asphalt parking and some landscaping. The prior drainage file (H16-D1) was revised by BHI in 1984 and again by Larry Read in 2004, This site has an allowable discharge rate of 1.6 CF5. The site slopes down slightly to the southwest at approximately 1.5% and runoff discharges to the public R/W of

PROPOSED IMPROVEMENTS: The proposed redevelopment of the site includes a new 7-story hotel, a swimming pool, associated naved access and parking, and landscaping.

DRAINAGE APPROACH: The site drainage pattern will follow historic conditions and include the onsite retention of the Storm Water Quality (SWQ) volume. Private storm drains will be extended onsite to provide for catch basins to intercept site runoff with

Existing land treatment: 10% C and 90% D Q= [(.10)(3.45)+(0.90)(5.02)](1.52)= 7.4 CFS

Proposed land treatment: 2% B, 2% C and 96% D Q= [(0.02)(2.60)+(0.02)(3.45)+(0.96)(5.02)](1.52)= 7.5 CFS


ment SWQ V= (63,525)(0.26/12)= 1,376 CF

The Hydrograph for Q=3.44+7.5=10.94 CFS and allowable Q=1.6 CFS (peak time of 11.4 mins and base time of 24.7 mins) gives a required V=11,124 CF.


Total underground detention volume provided onsite is 8,428 CF (49 chambers x 162.6 CF/EA)+(4 end caps x 115.3 CF/EA) using 9" deep stone base= 8,248.6 CF Surface storage volume is 2,700 CF at water surface elevation 5295.1

The proposed detention (8,428+2,700)=11,128 CF will contain the SWQ volume and restrict discharge to 1.7 CFS. Site runoff will Increase from historic but the proposed onsite retention storage will reduce runoff rate to the allowable rate.

Orifice equation for H=5,0' and 5" diameter orifice: Q=KxA(2gH)*1/2=(0.7)(0.136)(17.9)= 1.7 CFS

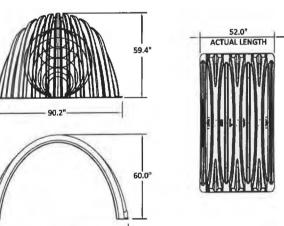

APPROVED 10/28/21 H19D087

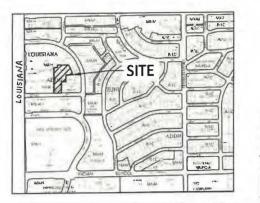

VICINITY MAP


H-19-Z

LEGEND

EXISTING CONSTRUCTION **NEW CONTOUR**

FF=5296.30 PROPOSED BUILDING FINISH FLOOR ELEV

NEW SPOT ELEVATION **NEW CONSTRUCTION ROOF DRAIN** TC TOP OF CURB LIMITS OF CONSTRUCTION

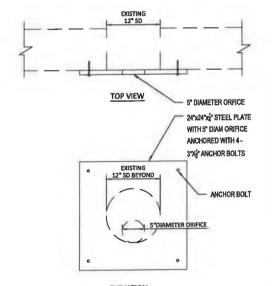

ELEVATION


EXISTING INLET W/ORIFICE PLATE


ELEMENT HOTEL 2440 LOUISIANA BLVD NE

Scott M McGee PE

9700 Sand Verbena Trail NE Albuquerque, NM 87122 505.263.2905 scottmmcgee@gmail.com



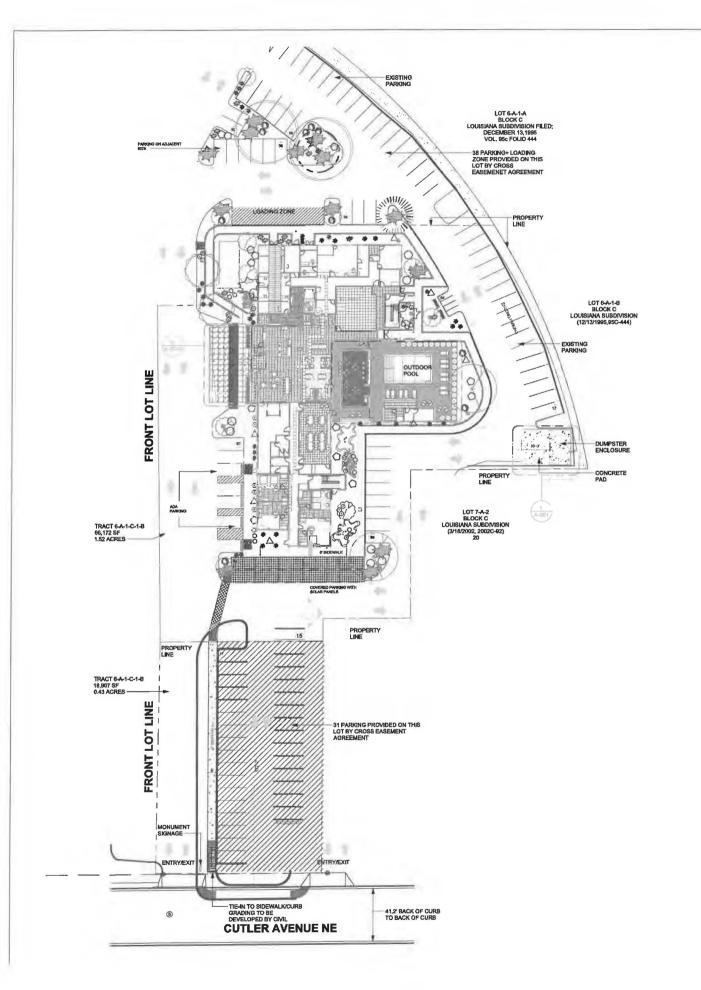

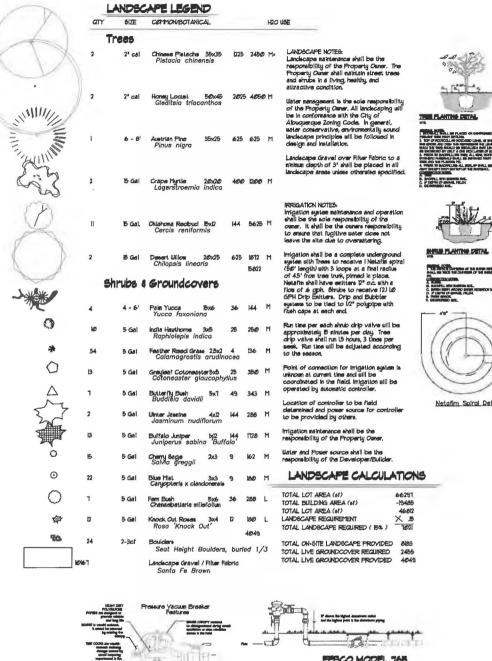

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PEBCO MODEL 768


PALL PORE MESICIP
WESTER State Install
law Strength Do device



Landscape Architect STATE OF NEW ACTO # DANNY D. MITCHELL 239 SCAPE MOON LO

October 30, 2019

THE OWNER PARKETS OF THE SAME PLANTS IN THE

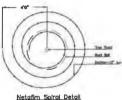

PEBCO MODEL 768

The design contained herein nears the property of The Highson Landcape Arthitistics and of The Highson Landcape Arthitistics and are produced by copyright. Governations and are produced by copyright. The see original design and seal and he released on copyright names projected in the New Seam paid or a job order placed.

2440 Louisiana Proposed Hotel Albuquerque, NM




SHEET .

LS-101

SCALE: 1" . 40'-0"

GRAPHIC SCALE

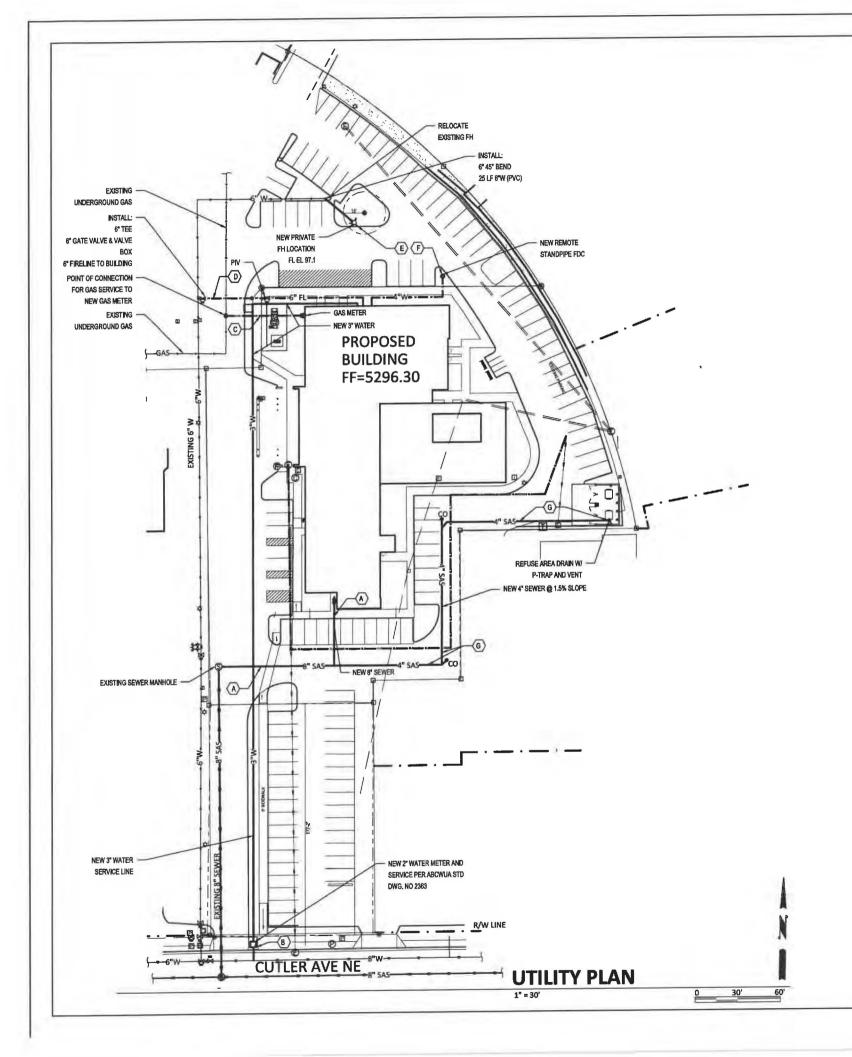



CO W WATER LINE WITH SIZE

-ELE ELECTRIC LINE

-SAS SANITARY SEWER

G GAS LINE

FH FIRE HYDRANT

FDC FIRE DEPT SONNECTION

○ KEYED NOTES


- A, CONNECT NEW 8" SANITARY SEWER SERVICE TO EXISTING ONSITE MANHOLE AS SHOWN, SEE PLUMBING PLAN FOR CONTINUATION,
- B. NEW 2" DOMESTIC WATER SERVICE FROM WATER MAIN TO METER AND 3" WATERLINE FROM METER TO THE BUILDING, SEE PLUMBING PLAN FOR CONTINUATION.
- C. NEW GAS SERVICE TO METER—SIZE PER MECHANICAL PLAN, CONTRACTOR TO COORDINATE WITH NEW MEXICO GAS COMPANY,
- D. NEW 6" FIRELINE TO BUILDING FROM WATER MAIN. INSTALL POST INDICATOR VALVE (PIV) AS SHOWN.
- E. RELOCATE PRIVATE FIRE HYDRANT ONSITE AS SHOWN.
- F, INSTALL REMOTE STANPIPE FIRE DEPT CONNECTION (FDC) AS SHOWN.
- G. INSTALL 4" WASTE LINE FROM REFUSE AREA DRAIN AT MIN. 2% SLOPE. INSTALL DRAIN, P-TRAP, AND 2" VENT AS REQUIRED. ROUTE VENT UP ALONG REFUSE ENCLOSURE WALL TO ABOVE WALL AND BRACE AS REQUIRED.

ELEMENT HOTEL 2440 LOUISIANA BLVD NE

Scott M McGee PE

9700 Sand Verbena Trail NE °
Albuquerque, NM 87122 °
505.263.2905
scottmmcgee@gmail.com



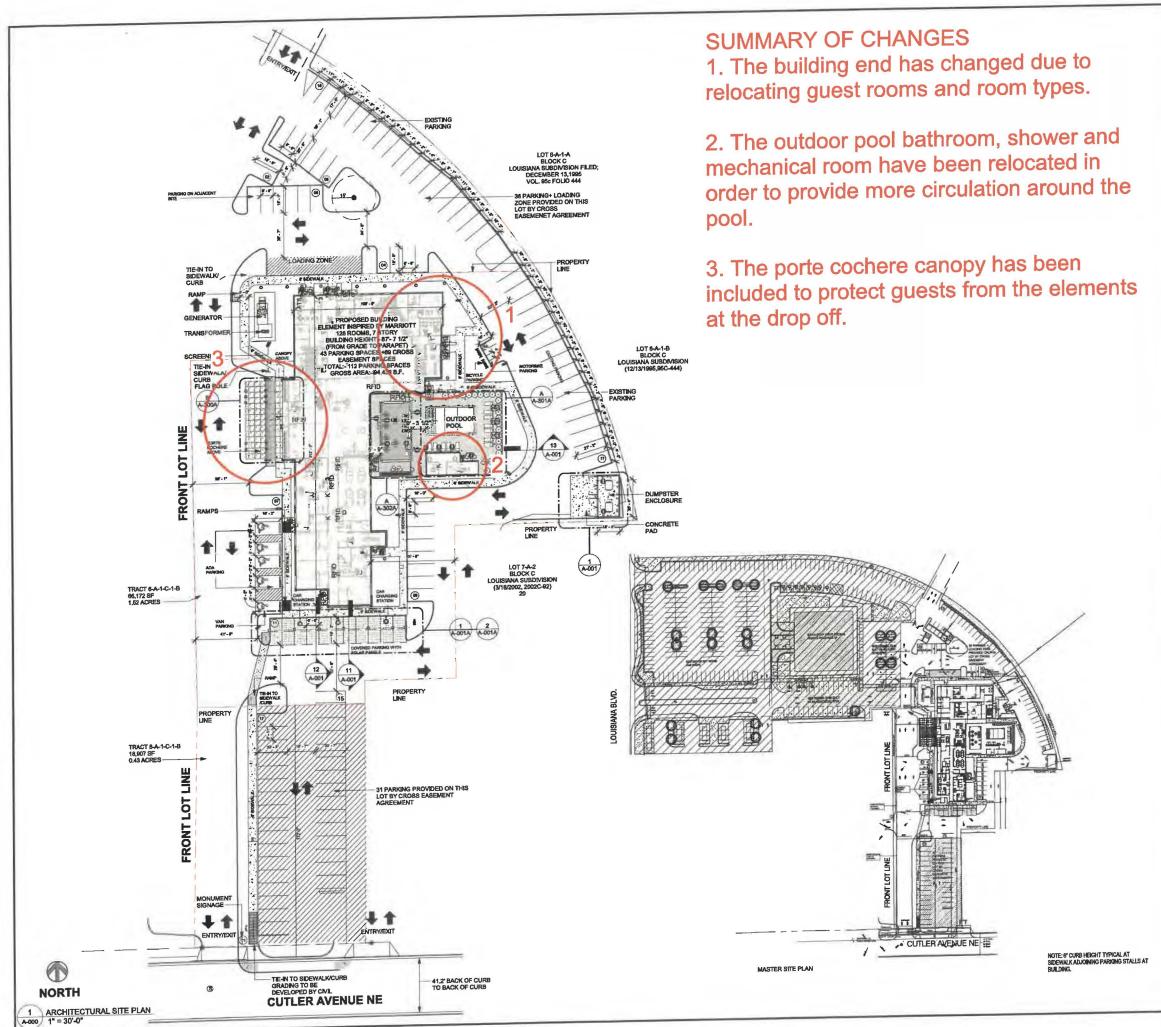

GENERAL NOTES - SITE PLAN

- ALL SITE PLAN INFORMATION IS BASED ON TOPOGRAPHIC SURVEY PREPARED BY CIVIL ENGINEER, SEE SHEET G-002 FOR CONTACT INFORMATION REFER TO CIVIL ENGINEERING DRAWINGS FOR ADDITIONAL INFORMATION PERTAINING TO DRAWINGE DESIGN, CURB CUTS, PAVING, AND PARKING LOT DIMENSIONS.
- DIMENSIONS.
 CONTRACTOR SHALL COORDINATE, PRIOR TO THE
 COMMENCEMENT OF SITE WORK, THE FINISH FLOOR
 ELEVATION WITH THE CIVIL ENGINEER AND THE

- CONFERENCE

 LMITS OF CONSTRUCTION TO BE AREA WITHIN
 PROPERTY LINE OR AS INDICATED WITH LIMIT LINES OF
 CONSTRUCTION.

 GC TO FOLLOW THE MINIMUM REQUIREMENTS FOR
 PAVEMENT DESIGN RECOMMENDATION WALL UNO PER
 CYIL DRAWNIGS AND SOIL REPORT.
 GENERAL CONTRACTOR TO PROVIDE PAINTED
 STRIPING, WORDING, DIRECTIONAL ARROWS AND
 SYMBOLS IN ACCORDANCE WITH SPECIFICATIONS,
 NATIONAL AND LOCAL CODES.

 ALL CONCRETE WALKS ARE 5-0* WIDE AND TO HAVE
 NON-SLIP BROOM FINISH WITH 12" EDPANSION JOINT @
- EVERY 25-0" O.C. ALL ACCESSIBLE ROUTES SHALL COMPLY WITH ADA
- GUDIELNIES.
 ALL EXTENIOR SKANAGE SHALL BE AS DIRECTED BY OWNER (EXCEPT AS DETALLED WITHIN THESE CONSTRUCTION DOCUMENTS) AND IN COMPLIANCE WITH LOCAL CODES, AD A GUIDELINES AND ANSI VERSIONS ADOPTED BY THE MUNICIPALITY. CONTRACTOR TO PROVIDE ELECTRICAL CONDUIT & POWERL SIGNAGE & FOUNDATION ARE O.F.O.I.

GROSS AREA (EXCLUDING COVERED OUTDOOR SPACES)

| LEVEL | AREA |
|------------|-----------|
| 18T FLOOR | 19,167 8F |
| 2ND FLOOR | 12,813 SF |
| SRD FLOOR | 13,787 SF |
| 4TH FLOOR | 13,787 SF |
| 5TH FLOOR | 13,787 SF |
| 6TH FLOOR | 13,787 SF |
| ROOF LEVEL | 7,509 SF |
| TOTAL:9 | 94,438 SF |

DADKING MATRIX

| REQUIRED | PROVIDED |
|----------|-------------------------------|
| 4 | 4 |
| 1 | 1 |
| 121 | 116 |
| 11 | - 11 |
| 7 | 7 |
| 4 | 4 |
| 104* | 118 |
| 4 | 8 |
| | 4 1 121 11 7 4 |



BASE4 2901 CLINT MOORE ROAD, #114 BOCA RATON, FLORIDA 33496 888.901.8008 www.base-4.com

RICARDO J. MUNIZ-GUILLET, AIA 2030 HABERSHAM TRACE, CUMMING, GA 30041







| NO. | DELTA | ISSUE DATE | DESCRIPTION |
|-----|-------|------------|-------------------|
| 4 | A3 | 2021,08.24 | CITY COMMENTS |
| | AD | 2020.12.01 | ISSUED FOR PERMIT |

ISSUED FOR PERMIT

CURRENT ISSUE DATE 2021.07.15 SB/NS

LA/RB

B4-176-1901

SHEET NAME

ARCHITECTURAL SITE PLAN



1 SOUTH ELEVATION A-606 1/8" = 1'-0"

GENERAL ELEVATION NOTES

- REVIEW ALL SIGHTLINES AROUND PROPERTY BEFORE LOCATING ROOFTOP EQUIPMENT. VERIFY ALL EQUIPMENT IS ADEQUATELY SCREENED.

 GC TO PROYIDE A MOCK WALL SHOWING A FULL WINDOW INSTALL WITH FLASHING. GC CAN USE A PROPORTIONALLY SCALED DOWN WINDOW IN LEGU OF FULL SIZE WINDOW.

 ALL EUCENCY CENTS, CRALLES, MECHANICAL LOLVERS AND EXTERIOR NOLDOW METAL DOORS TO BE FINISHED TO MATCH ADJACENT EXTERIOR MATERIAL.

 ALL BULDING PERMITS TO BE CONSISTENT WITH THE APPROVED SITE PLAN, THE PLANING DEPARTMENT DOES NOT REVIEW BULDING PERMIT PLAN BETS, SO IT BUT DOES NOT REVIEW BULDING PERMIT PLAN BETS, SO IT BUT DOES NOT REVIEW BULDING PERMIT PLAN SITE, SO IT BUT DOES NOT REVIEW BULDING PERMIT PLAN SITE, THE ELEVATIONS SUBMITTED IN THE BUILDING PERMICHES. IF THE ELEVATIONS DO NOT MATCH THOSE PLAY HE SITE PLAN, IT WILL DELAY THE SISUANCE OF A CERTIFICATE OF OCCUPANCY AT THE BUD OF CONSTRUCTION DIA MAY NECESSITATE MODIFICATIONS TO THE CONSTRUCTED BULDING. ALL VENT PEPS, ETC. EXTENDING ABOVE THE ROOF SURFACE MUST BE PARTED A COLOR THAT BLENDS WITH THE ROOF COLOR.

 ACCHITECTURAL FINISH FLOOR ELEVATIONS REFER TO TOP OF PRISH FLOOR ASSEMBLY, SEE STRUCTURAL DWISS FOR TOP OF PRISH FLOOR ASSEMBLY, SEE STRUCTURAL DWISS FOR TOP OF PRISH FLOOR ASSEMBLY, SEE STRUCTURAL DWISS FOR TOP OF

GENERAL SIGNAGE NOTES

GENERAL SIGNAGE NOTES

ALL SIGNAGE NIDICATED FOR ILLUSTRATIVE
PURPOSES ONLY, LOCATION, SIZE, ETC. TO BE
DETERMINED ON AN INDIVIDUAL PROJECT BASIS,
MINIMUM 34" PLYWOOD BE AGCER BASIA
REQUIRED AT SIGN LOCATIONS, AREA SHOULD
COVER ENTIRE LEMSTHA AND HEIGHT OF PASCIA
OR SPACE AVALABLE FOR SIGN.
ELECTRICAL AND FINAL CONNECTION BY
CONTRACTOR. ELECTRICAL REQUIREMENTS MAY
BE OBTAINED FROM SIGN COMPANY.
PERMANENT ACCESS DOORS TO INTENDOR OF
ALL PARAPTES WHERE SIGNS ARE LOCATED TO
BE PROVIDED BY CONTRACTOR. CONTRACTOR
TO FURNISH AND CONNECT PRAMARY
ELECTRICAL SERVICE INSDE PARAPET WALL
PROVIDE WEATHER PROCH ACCESS DOORS AT
ROOF LEVEL OR ANYWHERE ENTERFOR OR WET
CONDITIONS MAY APPLY.

QUESTROOMS OR PUBLIC SPACES WITH
SIGNAGE OR ENTERIOR WALLS MUST HAVE
ELECTRICAL PENETRATIONS ANDOOR REMOTE
REMOSE OR ENTERIOR WALLS MUST HAVE
ELECTRICAL PENETRATIONS ANDOOR REMOTE
REMOSE OR OR DETAIL OF THE WALL
PENETRATION LAYOUT MAY BE OBTAINED FROM
SIGN COMPANY.

| | EXTERIOR FINISH LEGEND | | | | | |
|--------|----------------------------|-----------------------------------|------------------|--|--|--|
| MARK | MATERIAL / BRAND | COLOR / FINISH | MATERI/ IMAGE | | | |
| BK-01 | | ASHEN BLACK - 820 | | | | |
| EF-01 | EIFS-PAREX | SANDPEBBLE-ELEM-01-2736-WHITE | - | | | |
| EF-02 | EIFS-PAREX | SANDPERBLE-ELEN-01-1022-DARK GREY | | | | |
| EF-03 | EIFS-PAREX | SANDPEBBLE-MIDNIGHT-MC-048 | | | | |
| FCP-01 | FIBRE CEMENT PANEL/NICHIHA | NICHIA PANEL-GLACIER | | | | |
| FCS-01 | FIBER CEMENT PANEL-NICHIHA | VINTAGE CEDAR BARK | | | | |



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RICARDO J. MUNIZ-GUILLET, AIA 2030 HABERSHAM TRACE, CUMMING, GA 30041







2430 LOUISIANA BLVD. NE ALBUQUERQUE, NM 87110, USA PROTOTYPE VERSION: GEN 2.5 REVISION DATE: 2020.02.11 ID PACKAGE: ENLIVEN DECOR PACKAGE VERSION 2.5

| NO | DELTA | ISSUE DATE | DESCRIPTION |
|----|-------|------------|-------------------|
| 8 | A7 | 2021.10.21 | ADD#2 |
| 1 | AO | 2020.12.01 | ISSUED FOR PERMIT |

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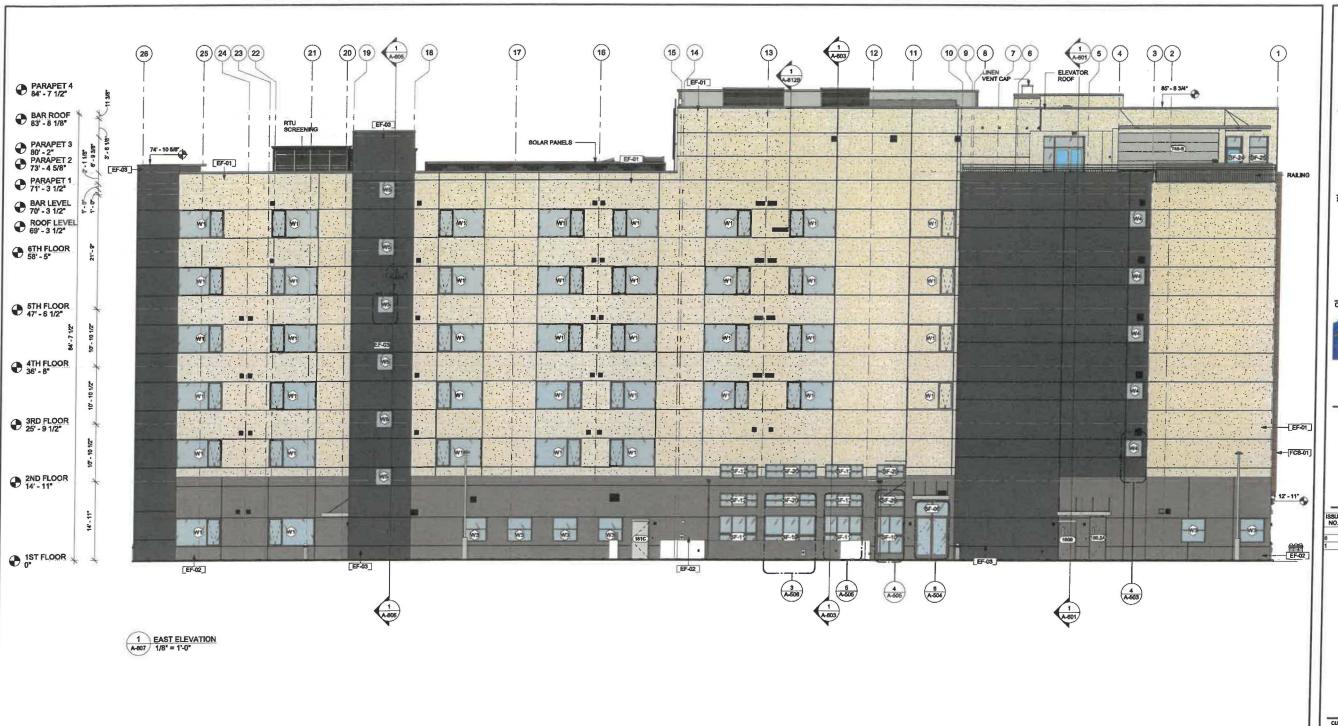
2021.07.15 SB/NS LA/RB

PROJECT NO. B4-176-1901

SHEET NAME

BUILDING **ELEVATION-1**

DRAWINGS NO.



GENERAL ELEVATION NOTES

- REVIEW ALL SIGHTLINES AROUND PROPERTY BEFORE LOCATING ROOFTOP EQUIPMENT. VERIFY ALL EQUIPMENT IS ADEQUATELY SCREENED. GO TO PROVIDE A MOCK WALL SHOWING A FULL WINDOW INSTALL WITH FLASHING, GC CAN USE A PROPORTIONALLY SCALED DOWN WINDOW IN LIEU OF FULL SIZE WINDOW. ALL EXTERIOR NOTING, GRILLES, MECHANICAL LOLVERS AND EXTERIOR HOLLOW METAL DOORS TO BE FINISHED TO MATCH ADJACENT EXTERIOR MATERIAL. ALL BULDING PERMITS TO BE CONSISTENT WITH THE APPROVED SITE PLAN, THE PLANNING DEPARTMENT DOES NOT REVIEW BUILDING PERMIT PLAN SETS, SO IT IS THE DEVELOPER RESPONSIBLITY TO ENSURE THAT ELEVATIONS SUBMITTED IN THE BUILDING PERMIT SET MACH THOSE APPROVED DURING THE SITE PLAN REVIEW PROCESS. IF THE ELEVATIONS DON'T MATCH THOSE IN THE SITE PLAN, IT WILL DELAY THE SISLANCE OF A CERTIFICATE OF OCCUPANCY AT THE END OF CONSTRUCTED BUILDING, HOLLOW THE ROOF SUBFACE AMUST BE PAINTED A COLOR THAT BLENDS WITH THE ROOF GURFACE MUST BE PAINTED A COLOR THAT BLENDS WITH THE ROOF GURFACE MUST BE PAINTED A COLOR THAT BLENDS WITH THE ROOF OF OP PINISH COOR ASSEMBLY. SEE STRUCTURAL DWOS POR TOP OF STRUCTURE AND BEARING HEIGHT ELEVATIONS FOR TOP OF STRUCTURE AND BEARING HEIGHT ELEVATIONS.

GENERAL SIGNAGE NOTES

- ALL SIGNAGE NOTES

 ALL SIGNAGE NOCATED FOR LLUSTRATIVE
 PURPOSES ONLY, LOCATION, SIZE, ETC. TO BE
 DETERMINED ON AN NOMPOULAL PROJECT BASIS,
 MINIMIM 34" PLYWOOD BACKER BOARD
 REQUIRED AT SIGN LOCATIONS, AREA SHOULD
 COVER ENTIRE LENGTH AND HEIGHT OF FASCIA
 OR SPACE AVAILABLE FOR SIGN.
 LECTRICAL AND FINAL CONNECTION BY
 CONTRACTOR, ELECTRICAL REQUIREMENTS MAY
 BEG DITANED FROM SIGN COMPANY.
 PERMANENT ACCESS DOORS TO INTERIOR OF
 ALL PRAPPETS WHERE SIGNS ARE LOCATED TO
 BE PROVIDED BY CONTRACTOR, CONTRACTOR
 TO FURNISH AND CONNECT PRIMARY
 ELECTRICAL SERVICE INSIDE PRAPPET WAIL
 PROVIDE WEATHER PROPO FACESS DOORS AT
 ROOF LEVEL OR ANYWHERE EXTERIORY OR WET
 CONDITIONS MAY APPLY
 GUESTROOMS OR PUBLIC SPACES WITH
 SIGNAGE ON ENTERORY WALLS MUST HAVE
 ELECTRICAL PENTERTATIONS AND REMOTE
 TRANSFORMERS COORDINATED ANDOR
 RISTALLED PRICE OF LOSING UP THE WALL
 PENETRATION LAYOUT MAY BE OSTANED FROM
 SIGN COMPANY.

| | EXTERIOR FINISH LEGEND | | | | | | |
|--------|----------------------------|-----------------------------------|-------------------|--|--|--|--|
| MARK | MATERIAL / BRAND | COLOR / FINISH | MATERIAL IMAGE | | | | |
| BK-01 | | ASHEN BLACK - 820 | | | | | |
| EF-01 | EIFS-PAREX | SANDPERBLE-ELEM-01-2736-WHITE | | | | | |
| EF-02 | EIFS-PAREX | SANDPEBBLE-ELEM-01-1022-DARK GREY | | | | | |
| EF-03 | EIFS-PAREX | SANDPEBBLE-MIDNIGHT-MC-048 | | | | | |
| FCP-01 | FIBRE CEMENT PANEL/NICHIHA | NICHIA PANEL-GLACIER | | | | | |
| FCS-01 | FIBER CEMENT PANEL-NICHINA | VINTAGE CEDAR BARK | Total Contra | | | | |



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RICARDO J. MUNIZ-GUILLET, AIA 2030 HABERSHAM TRACE, CUMMING, GA 30041





4239 BALLOON PARK ROAD ALBUQUERQUE, NM 87109 505.831.4200



2430 LOUISIANA BLVD, NE ALBUQUERQUE, NM 87110, USA PROTOTYPE VERBION: GEN 2.5 REVISION DATE: 2020,02.11 ID PACKAGE: ENLIVEN DECOR PACKAGE VERSION 2.5

| NO. | DELTA | ISSUE DATE | DESCRIPTION |
|-----|-------|------------|-------------------|
| ő | A7 | 2021,10,21 | ADD#2 |
| 1 | AO | 2020.12.01 | ISSUED FOR PERMIT |

CURRENT ISSUE

ISSUED FOR PERMIT

CURRENT ISBUE DATE 2021.07.15

SB/NS LA/RB

PROJECT NO. B4-176-1901

BUILDING **ELEVATION-2**

DRAWINGS NO.



GENERAL ELEVATION NOTES

- REVIEW ALL SIGHTLINES AROUND PROPERTY BEFORE LOCATING ROOFTOP EQUIPMENT, VERIFY ALL EQUIPMENT IS ADEQUATELY SCREENED.

 GC TO PROVIDE A MOCK WALL SHOWING A FULL WINDOW INSTALL WITH FLASHING, GC CAN USE A PROPORTIONALLY SCALED DOWN WINDOW IN LIEU OF FULL SEE WINDOW.

 ALL BUTERIOR VENTS, GRILES, MECHANICAL LOUVERS AND EXTERIOR HOLLOW METAL DOORS TO BE FINISHED TO MATCH ADJACENT EXTERIOR MATERIAL.

 ALL BULDONG PERMITS TO BE CONSISTENT WITH THE APPROVED SITE PLAN. THE PLANNING DEPARTMENT DOES NOT REVIEW BULDING PERMIT PLAN SETS, SO IT IS THE DEVELOPERS.

 RESPONSIBILITY TO ENSURE THAT ELEVATIONS SUBMITTED IN THE BUILDING PERMIT SET HANTH THOSE APPROVED DURING THE BITE PLAN REVIEW PROCESS. FTHE ELEVATIONS SUBMITTED IN THE SITE OF OCCUPANCY AT THE END OF CONSTRUCTION, AND MAY NECESSITATE MOOFFICATIONS TO THE CONSTRUCTION, AND MAY NECESSITATE MOOFFICATIONS TO THE CONSTRUCTION, AND MAY NECESSITATE MOOFFICATIONS TO THE CONSTRUCTION, AND MAY NAME AND ADDITIONAL MAY NAME AND ADDITIONAL MAY NAME AND ADDITIONAL MAY NAME AND ADDITIONAL SHEEP OF TO TOP OF STRUCTURAL DWGS FOR TOP OF STRUCTURE AND BEARING HEART SHEET TOP OF

GENERAL SIGNAGE NOTES

GENERAL SIGNAGE NOTES

ALL SIGNAGE NICKATED FOR ELLISTRATIVE PLEPOSES ONLY LOCATION, SIZE FIT: TO BE PLEPOSES ONLY LOCATION, SIZE FIT: TO BE PLEPOSES ONLY LOCATION, SIZE FIT: TO BE PLEPOSES ONLY LOCATIONS. AREA SHOULD CHORN IN PROJECT PASIS, WINNIMA MY PLYWOOD BACKER BOARD REQUIRED AT SIGN LOCATIONS. AREA SHOULD COVER ENTIRE LENGTH AND HEIGHT OF FASCIA OR SPACE AVALABLE FOR BIGH.

ELECTRICAL AND FINAL COMPRECION BY CONTRACTOR. ELECTRICAL REQUIREMENTS MAY BE OBTAINED FROM SIGN COMPANY. PERMANENT ACCESS DOORS TO INTENIOR OF ALL PRAMPETS WHERE SIGNS ARE LOCATED TO BE PROVIDED BY CONTRACTOR. CONTRACTOR TO FUNDING HAD CONNECT PRIMARY ELECTRICAL SERVICE INSIDE PARAPET WALL PROVIDE WEATHER PROJO ACCESS DOORS AT ROOF LEVEL OR ANYWHERE EXTERIORY OR WET CONDITIONS MAY APPLY.

GUESTROOMS OR PUBLIC SPACES WITH SIGNAGE ON EXTERIOR WALLS MUST HAVE ELECTRICAL PENETRATIONS ANDOR REMOTE TRANSFORMERS COORDINATED ANDOR INSTALLED PRIOR TO CLOSING UP THE WALL PENETRATION LAYOUT MAY BE OSTAMED FROM SIGN COMPANY.

| EXTERIOR FINISH LEGEND | | | | | |
|----------------------------|--|--|--|--|--|
| MATERIAL / BRAND | MATERIAL / BRAND COLOR / FINISH | | | | |
| | ASHEN BLACK - 820 | | | | |
| EIFS-PAREX | SANOPEBBLE-ELEM-01-2736-WHITE | | | | |
| EIFS-PAREX | SANDPEBBLE-ELEM-01-1022-DARK GREY | 10000 | | | |
| EIF8-PAREX | SANDPEBBLE-MIDNIGHT-MC-048 | | | | |
| FIBRE CEMENT PANEL/NICHIHA | NICHIA PANEL-GLACIER | | | | |
| FIBER CEMENT PANEL-NICHIHA | VINTAGE CEDAR BARK | 77.65 | | | |
| | MATERIAL / BRAND EIFS-PAREX EIFS-PAREX EIFS-PAREX FIBRE CEMENT PANEL/NICHIHA | MATERIAL / BRAND COLOR / FINISH ASHEN BLACK - 820 EJFS-PAREX SANDPEBBLE-ELEM-01-2738-WHITE EJFS-PAREX SANDPEBBLE-ELEM-01-1022-DARK GREY EJFS-PAREX SANDPEBBLE-MIDNIGHT-MC-046 FIBRE CEMENT PANEL/NICHHA NICHA PANEL-GLACIER | | | |



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RICARDO J. MUNIZ-GUILLET, AIA 2030 HABERSHAM TRACE, CUMMING, GA 30041



DATE: 2021,12.14



4239 BALLOON PARK ROAD ALBUQUERQUE, NM 87109 505.831.4200



2430 LOUISIANA BLVD. NE ALBIQUERQUE, NM 87110, USA PROTOTYPE VERSION: GEN 2.5 REVISION DATE: 2020.02.11 ID PACKAGE: ENLIVEN DECOR PACKAGE VERSION 2.5

| NO. | DELTA | ISSUE DATE | DESCRIPTION |
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| ē | A7 | 2021.10.21 | ADD#2 |
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CURRENT ISSUE DATE 2021.07.15 SRAIS


LA/RB PROJECT NO. B4-176-1901


SHEET NAME

CHECKED BY

BUILDING ELEVATION-3

DRAWINGS NO.

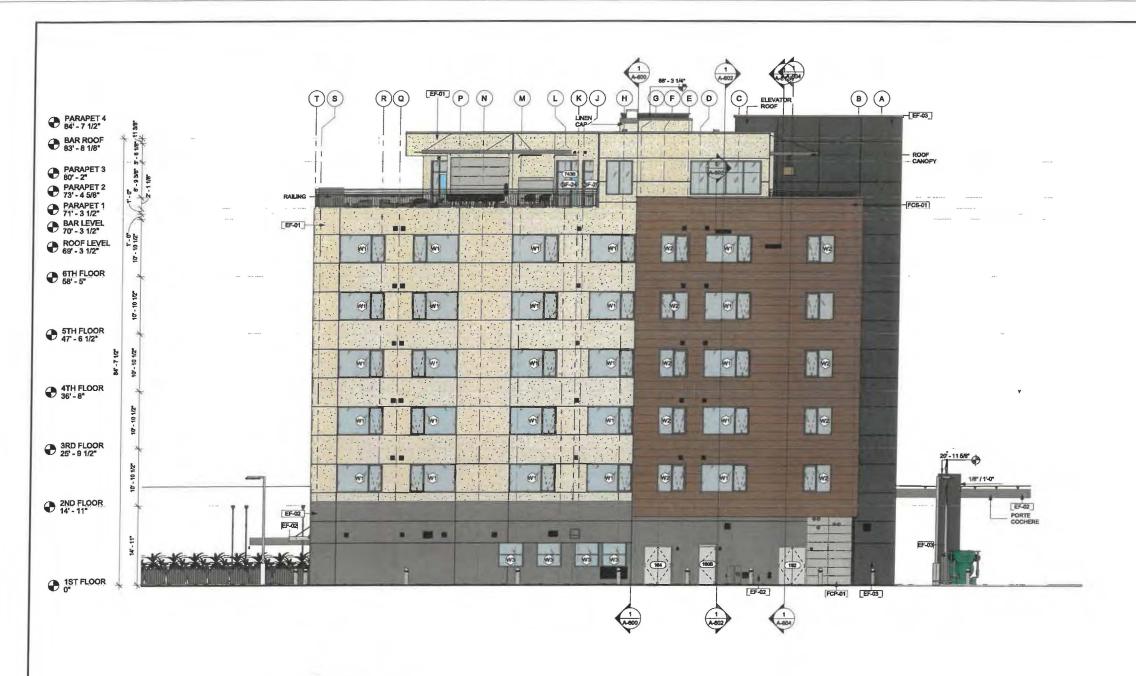

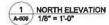

| GENERAL ELEVATION NOTES | GENERAL ELEVATION NOTES GENERAL SIGNAGE NOTES | | EXTERIOR FINISH LEGEND | | | |
|--|---|--------|---|---|---------|--|
| REVIEW ALL SIGHTLINES AROUND PROPERTY BEFORE LOCATING ROOFTOP EQUIPMENT, VERIFY ALL EQUIPMENT IS ADEQUATELY SCREENED. GOTO PROVIDE A MOCK WALL SHOWING A FULL WINDOW INSTALL WITH FLASHING. GC CAN USE A PROPORTIONALLY SCALED DOWN WINDOW IN LEU OF FULL SIZE WINDOW. ALL EXTERIOR VENTS, GRILLES, MECHANICAL LOUVERS AND EXTERIOR HOLDOW METAL DOORS TO BE FINISHED TO MATCH ADJACENT EXTERIOR MATERIAL. ALL BUILDING PERMITS TO BE CONSISTENT WITH THE APPROVED SITE PLAN, THE PLANNING DEPARTMENT DOES NOT REVIEW BUILDING PERMIT PLAN BETS, SO IT IS THE DEVELOPER'S RESPONSIBILITY TO ENSURE THAT ELEVATIONS BUBMITTED IN THE BUILDING PERSIT SET MATCH THOSE APPROVED DURING THE SITE BUILDING PERSIT SET MATCH THOSE APPROVED DURING THE SITE. | 1. ALL SKRAGE INDICATED FOR LLUSTRATIVE PURPOSES ONLY, LOCATION, SIZE, ETC. TO BE DETERMINED ON AN INDIVIDUAL PROJECT BASIS. 2. MINIMUM 34" PLYWOOD BACKER BOARD REQUIRED AT SIGN LOCATIONS, AREA SHOULD COVER ENTIRE LENGTH AND HEIGHT OF FASCIA OR SPACE AVAILABLE FOR SIGN. 3. ELECTRICAL AND FRAL CONNECTION BY CONTRACTOR, LECTRICAL REQUIREMENTS MAY BE OBTAINED FROM SIGN COMPANY. 4. PERMANENT ACCESS DOORS TO INTERIOR OF ALL PARAPETS WHERE SIGNS ANE LOCATED TO BE PROVIDED BY CONTRACTOR, CONTRACTOR. CONTRACTOR TO FURNISH AND CONNECT PRIMARY ELECTRICAL SERVICE INSIDE PARAPET WALL. | | MATERIAL / BRAND | COLOR / FINISH COLOR / FINISH ASHEN BLACK - 820 SANDPEBBLE-ELEM-01-2736-WHITE SANDPEBBLE-ELEM-01-1022-DARK GREV SANDPEBBLE-MIDNIGHT-MC-046 | MATERIA | |
| PUAN REVEN PROCESS, IF THE ELEVATIONS DO NOT MATCH THOSE IN THE SITE HAIR, IT WALL DELY THE SISUANCE OF A CERTIFICATE OF OCCUPANCY AT THE END OF CONSTRUCTION, AND MAY NECESSITATE MODIFICATIONS TO THE CONSTRUCTION, AND MAY NECESSITATE MODIFICATIONS TO THE CONSTRUCTED BUILDING. ALL VENT PIPES, ETC. EXTENDING ABOVE THE ROOF SURFACE MUST BE PAINTED A COLOR THAT BLENDS WITH THE ROOF COLOR. A RRCHITECTURAL FINISH FLOOR ELEVATIONS REFERT TO TOP OF FINISH FLOOR ASSEMBLY, SEE STRUCTURAL DWIGS FOR TOP OF | ROOF LEVEL OR ANYWHERE EXTERIOR/ OR WET CONDITIONS MAY APPLY 8. GUESTROOMS OR PUBLIC SPACES WITH SKINAGE ON EXTERIOR WALLS MUST HAVE ELECTRICAL PERIORITATIONS AND/OR REMOTE | FCP-01 | FIBRE CEMENT PANEL/NICHHA FIBER CEMENT PANEL-NICHHA | NICHIA PANEL-GLACIER VINTAGE CEDAR BARK | | |



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RICARDO J. MUNIZ-GUILLET, AIA 2030 HABERSHAM TRACE, CUMMING, GA 30041





4239 BALLOON PARK ROAD ALBUQUERQUE, NM 87109 505.831.4200



2430 LOUISIANA BLVD. NE ALBUQUERQUE, MA 87110, USA PROTOTYPE VERSION: GEN 2.5 REVISION DATE: 2020.02.11 ID PACKAGE: ENLIVEN DECOR PACKAGE VERSION 2.5

| A7 | 2021.10.21 | ADD#2 |
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CURRENT ISSUE DATE 2021.07.15


PROJECTNO. B4-176-1901

SHEET NAME

BUILDING **ELEVATION-4**

LA/RB

DRAWINGS NO.

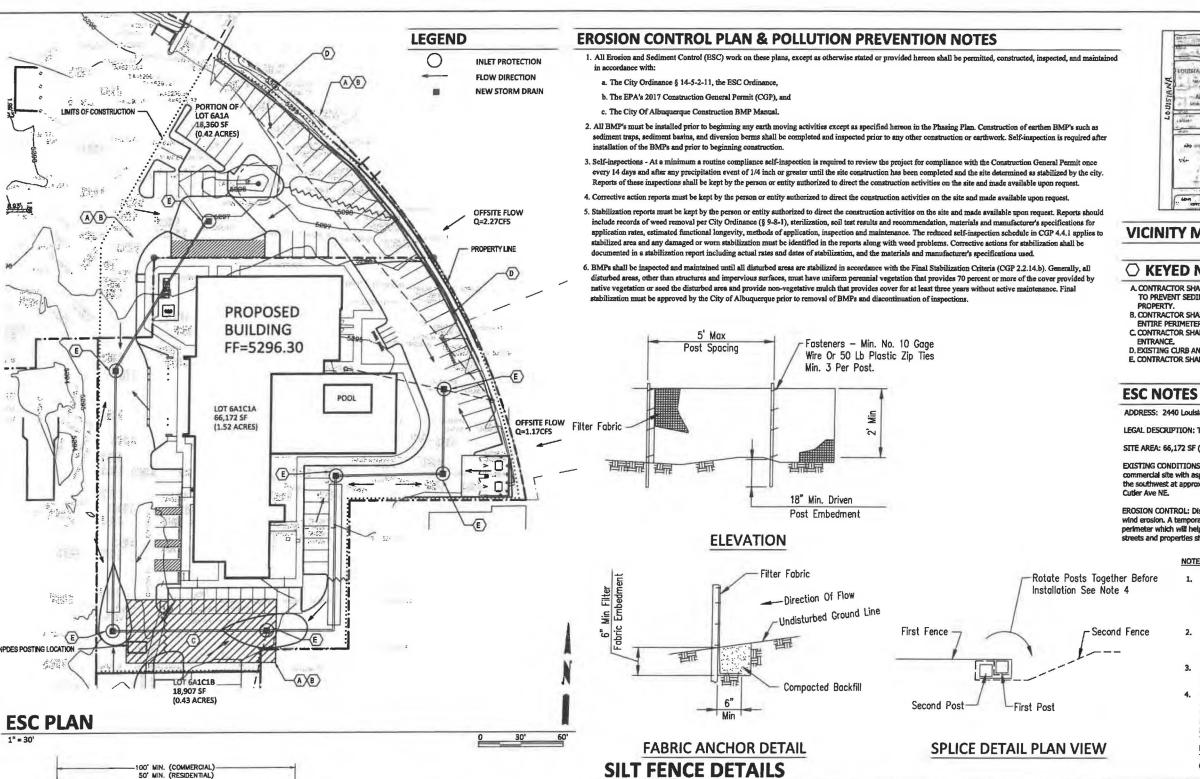

25' OR WIDTH OF PROPOSED STREET OR DRIVEWAY, WHICHEVER !S GREATER.

6" MIN. - 3" - 4" STONE

SIDE CROSS SECTION VIEW



VICINITY MAP

H-19-Z

○ KEYED NOTES

- A. CONTRACTOR SHALL INSTALL PERIMETER BMP PROTECTION
- B. CONTRACTOR SHALL INSTALL SILT FENCE ALONG THE ENTIRE PERIMETER OF CONSTRUCTION FACILITIES.
 C. CONTRACTOR SHALL INSTALL STABILIZED CONSTRUCTION
- D. EXISTING CURB AND GUTTER TO REMAIN. E. CONTRACTOR SHALL INSTALL INLET PROTECTION

ADDRESS: 2440 Louisiana Bivd NE, Albuquerque, NM

LEGAL DESCRIPTION: TRACT 6-A-1-C-1-A, BLOCK 'C' LOUISIANA SUBDIVISION

SITE AREA: 66,172 SF (1.519 acres)

EXISTING CONDITIONS: The site is a fully developed portion of an existing commercial site with asphalt parking and landscaping. The site slopes down slightly to the southwest at approximately 1.5% and runoff discharges to the public R/W of

EROSION CONTROL: Disturbed portions of the site shall be kept wetted to minimize wind erosion. A temporary construction fence with screening will follow the site perimeter which will help mitigate windblown sediment. The impact on surrounding streets and properties should be minimized.

- TEMPORARY SILT FENCE SHALL BE INSTALLED PRIOR TO ANY GRADING WORK IN THE AREA TO BE PROTECTED, FENCE SHALL BE MAINTAINED THROUGHOUT THE CONSTRUCTION PERIOD AND REMOVED IN CONJUNCTION WITH THE FINAL GRADING AND SITE
- STABILIZATION. FILTER FABRIC SHALL MEET THE REQUIREMENTS OF MATERIAL SPECIFICATION 592 GEOTEXTILE TABLE 1 OR 2, CLASS 1 WITH EQUIVALENT OPENING SIZE OF AT
- LEAST 30 FOR NONWOVEN AND 50 FOR WOVEN.

 3. FENCE POSTS SHALL BE WITHER WOOD POST WIT A MINIMUM CROSS-SECTIONAL AREA 1.5"x1.5" OR A STANDARD STEEL POST
- WHEN SLICES ARE NECESSARY, MAKE SPLICE AT POST ACCORDING TO SPLICE DETAIL PLACE THE END POSE OF THE SECOND FENCE INSIDE THE END POST OF THE FIRST FENCE, ROTATE BOTH POSTS TOGETHER AT LEAST 180 DEGREES TO CREATE A TIGHT SEAL WITH THE FABRIC MATERIAL, CUT THE FABRIC NEAR THE BOTTOM OF THE POSTS TO ACCOMMODATE THE 6" FLAP. THEN DRIVE BOTH POSTS AND BURY THE FLAP.

NOTES:

FILTER FABRIC

- 1. ENTRANCE(S) SHALL BE LOCATED TO PROVIDE MAXIMUM UTILITY BY ALL CONSTRUCTION VEHICLES.
 TURNING RADIUS SUFFICIENT TO ACCOMMODATE LARGE TRUCKS IS TO BE
- PROVIDED
- MUST BE MAINTAINED IN A CONDITION WHICH WILL PREVENT PERIODIC TOPORESSING WITH STONE WITH BE NECESSARY, CONTRACTOR SHALL MAINTAIN AS NECESSARY,
- ANY MATERIAL WHICH STILL MAKES IT ONTO THE ROAD MUST BE CLEANED UP IMMEDIATELY.
- FREQUENT CHECKS OF THE ENTRANCE(S) AND TIMELY MAINTENANCE SHALL
- NOTES ARE APPLICABLE AT ALL POINTS OF INGRESS AND EGRESS UNTIL SITE IS STABILIZED.
- UTILIZE FILTER FABRIC IN CLAY SOILS



ELEMENT HOTEL 2440 LOUISIANA BLVD NE


Scott M McGee Pl

9700 Sand Verbena Trail NE Albuquerque, NM 87122 505.263.2905 scottmmcgee@gmail.com



EXISTING

PLAN VIEW

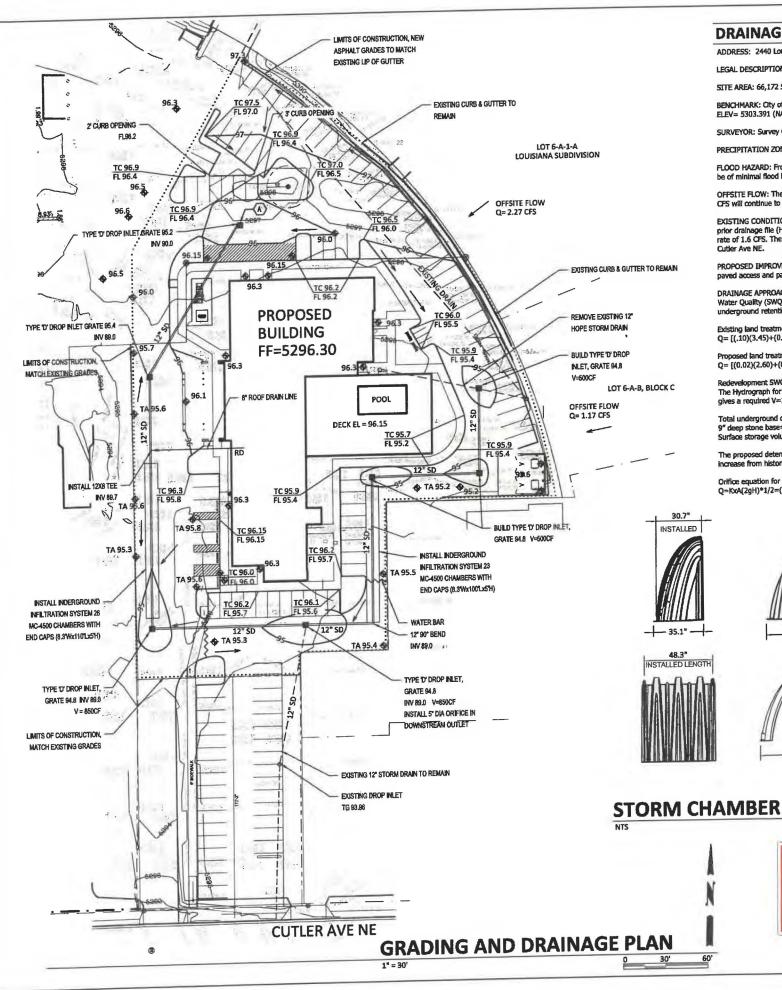

DRAINAGE ANALYSIS

ADDRESS: 2440 Louisiana Blvd NE, Albuquerque, NM

LEGAL DESCRIPTION: TRACT 6-A-1-C-1-A, BLOCK 'C' LOUISIANA SUBDIVISION

SITE AREA: 66,172 SF (1.519 acres)

BENCHMARK: City of Albuquerque Station '15-H18' being a brass cap. ELEV= 5303.391 (NAVD 1988)

SURVEYOR: Survey Office LLC, dated July 2019

PRECIPITATION ZONE: 3

FLOOD HAZARD: From FEMA Map 35001C0352H (8/16/12), this site is identified as being within Zone 'X' which is determined to be of minimal flood hazard.

OFFSITE FLOW: The site does accept offsite flows from two tracts adjacent to the east as shown on the plan. The total Q=3.44 CFS will continue to be accepted onsite and carried south toward Cutter per the historic flow pattern.

EXISTING CONDITIONS: The site is a fully developed portion of an existing site with asphalt parking and some landscaping. The prior drainage file (H16-D1) was revised by BHI in 1984 and again by Larry Read in 2004, This site has an allowable discharge rate of 1.6 CFS. The site slopes down slightly to the southwest at approximately 1.5% and runoff discharges to the public R/W of

PROPOSED IMPROVEMENTS: The proposed redevelopment of the site includes a new 7-story hotel, a swimming pool, associated paved access and parking, and landscaping.

DRAINAGE APPROACH: The site drainage pattern will follow historic conditions and include the onsite retention of the Storm Water Quality (SWQ) volume. Private storm drains will be extended onsite to provide for catch basins to intercept site runoff with

Existing land treatment: 10% C and 90% D Q= [(.10)(3.45)+(0.90)(5.02)](1.52)= 7.4 CFS


Proposed land treatment: 2% B, 2% C and 96% D Q= [(0.02)(2.60)+(0.02)(3.45)+(0.96)(5.02)](1.52)= 7.5 CFS

Redevelopment SWQ V= (63,525)(0.26/12)= 1,376 CF
The Hydrograph for Q=3.44+7.5=10.94 CFS and allowable Q=1.6 CFS (peak time of 11.4 mins and base time of 24.7 mins) gives a required V=11,124 CF.

tention volume provided onsite is 8,428 CF (49 chambers x 162.6 CF/EA)+(4 end caps x 115.3 CF/EA) using Total underground deternor volune provided state is 5,425 G (7,50 g)" deep stone base= 8,248,6 CF Surface storage volume is 2,700 CF at water surface elevation 5295.1

The proposed detention (8,428+2,700)=11,128 CF will contain the SWQ volume and restrict discharge to 1,7 CFS. Site runoff will e from historic but the proposed onsite retention storage will reduce runoff rate to the allowable rate.

Orifice equation for H=5,0' and 5" diameter orifice: Q=KxA(2gH)*1/2=(0.7)(0.136)(17.9)= 1.7 CFS

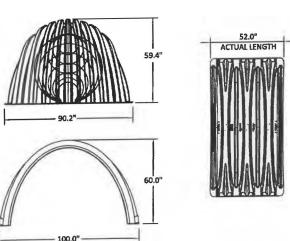

APPROVED



VICINITY MAP

H-19-Z


LEGEND

EXISTING CONSTRUCTION NEW CONTOUR

FF=5296.30 PROPOSED BUILDING FINISH FLOOR ELEV

NEW SPOT ELEVATION NEW CONSTRUCTION - RD **ROOF DRAIN**

TOP OF CURB TC LIMITS OF CONSTRUCTION

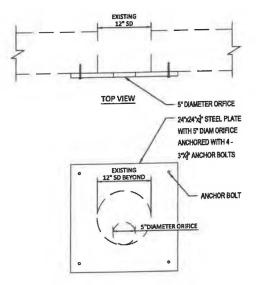

ELEVATION


EXISTING INLET W/ORIFICE PLATE


ELEMENT HOTEL 2440 LOUISIANA BLVD NE

Scott M McGee P

9700 Sand Verbena Trail NE



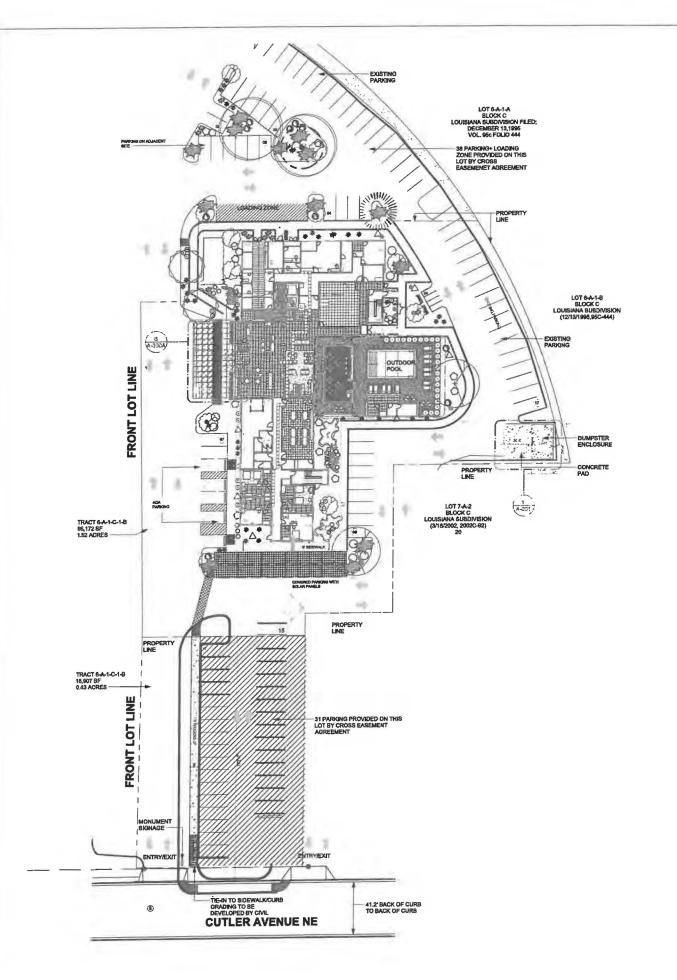

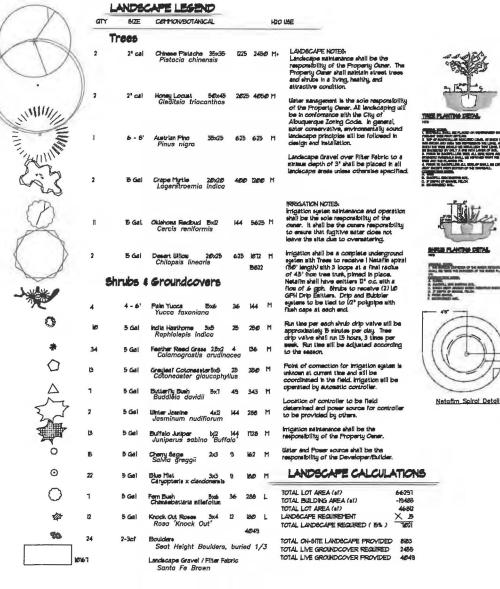

FEBCO MODEL 168



PERCO MODEL 768



The Hillup 1369 Edith NE. Abuquerque, NH 61113 Cont. Lin. 12449 FM (1869) 996-1131 dennyel kloplandacapha

Landscape Architec

STATE OF NEW WOO

DANNY D. MITCHELL

POSCAPE MOUNTS October 30, 2019




Dan







SHEET . LS-101

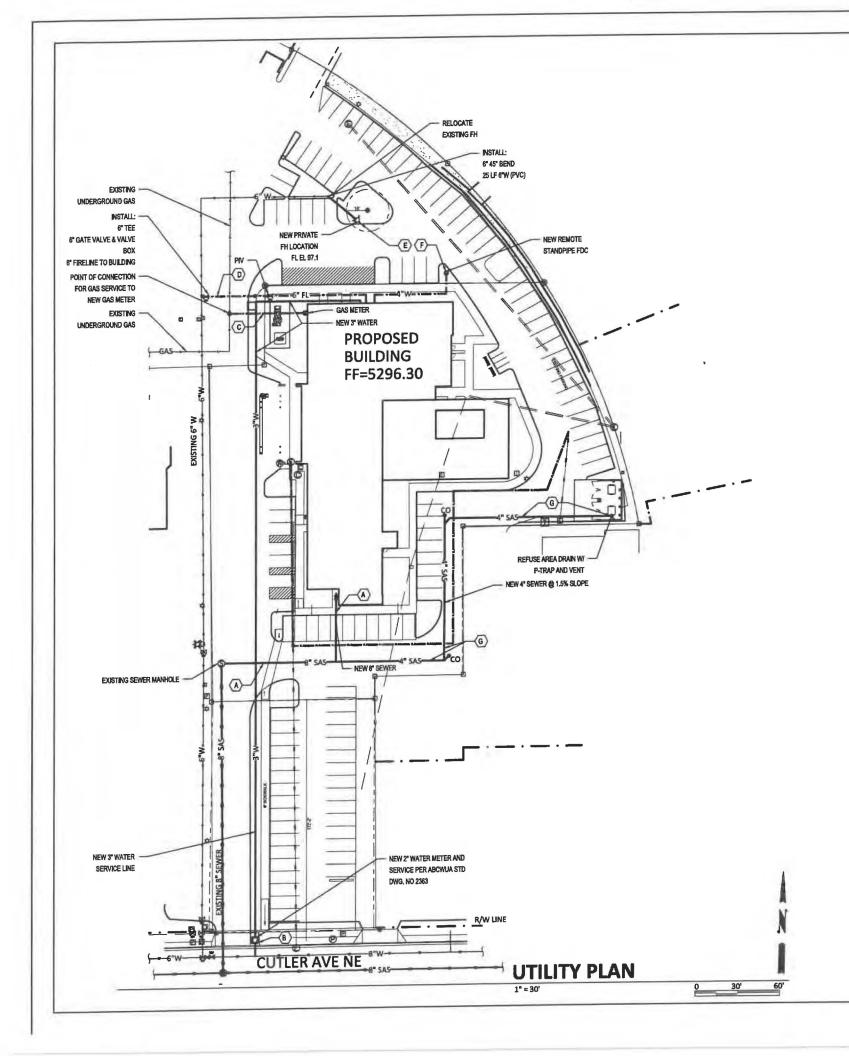

LEGEND

CO • CLEAN OUT

W— WATER LINE WITH SIZE

ELECTRIC LINE

SAS— SANITARY SEWER

GAS LINE

FH FIRE HYDRANT

FDC FIRE DEPT SONNECTION

O KEYED NOTES

- A. CONNECT NEW 8" SANITARY SEWER SERVICE TO EXISTING ONSITE MANHOLE AS SHOWN, SEE PLUMBING PLAN FOR CONTINUATION.
- B. NEW 2" DOMESTIC WATER SERVICE FROM WATER MAIN TO METER AND 3" WATERLINE FROM METER TO THE BUILDING. SEE PLUMBING PLAN FOR CONTINUATION.
- C. NEW GAS SERVICE TO METER—SIZE PER MECHANICAL PLAN. CONTRACTOR TO COORDINATE WITH NEW MEXICO GAS COMPANY.
- D. NEW 6" FIRELINE TO BUILDING FROM WATER MAIN. INSTALL POST INDICATOR VALVE (PIV) AS SHOWN.
- E. RELOCATE PRIVATE FIRE HYDRANT ONSITE AS SHOWN.
- F. INSTALL REMOTE STANPIPE FIRE DEPT CONNECTION (FDC) AS SHOWN.
- G. INSTALL 4" WASTE LINE FROM REFUSE AREA DRAIN AT MIN. 2% SLOPE.
 INSTALL DRAIN, P-TRAP, AND 2" VENT AS REQUIRED. ROUTE VENT UP
 ALONG REFUSE ENCLOSURE WALL TO ABOVE WALL AND BRACE AS
 REQUIRED.


ELEMENT HOTEL 2440 LOUISIANA BLVD NE

Scott M McGee P

9700 Sand Verbena Trail NE Albuquerque, NM 87122 505.263.2905 scottmmcgee@gmail.com





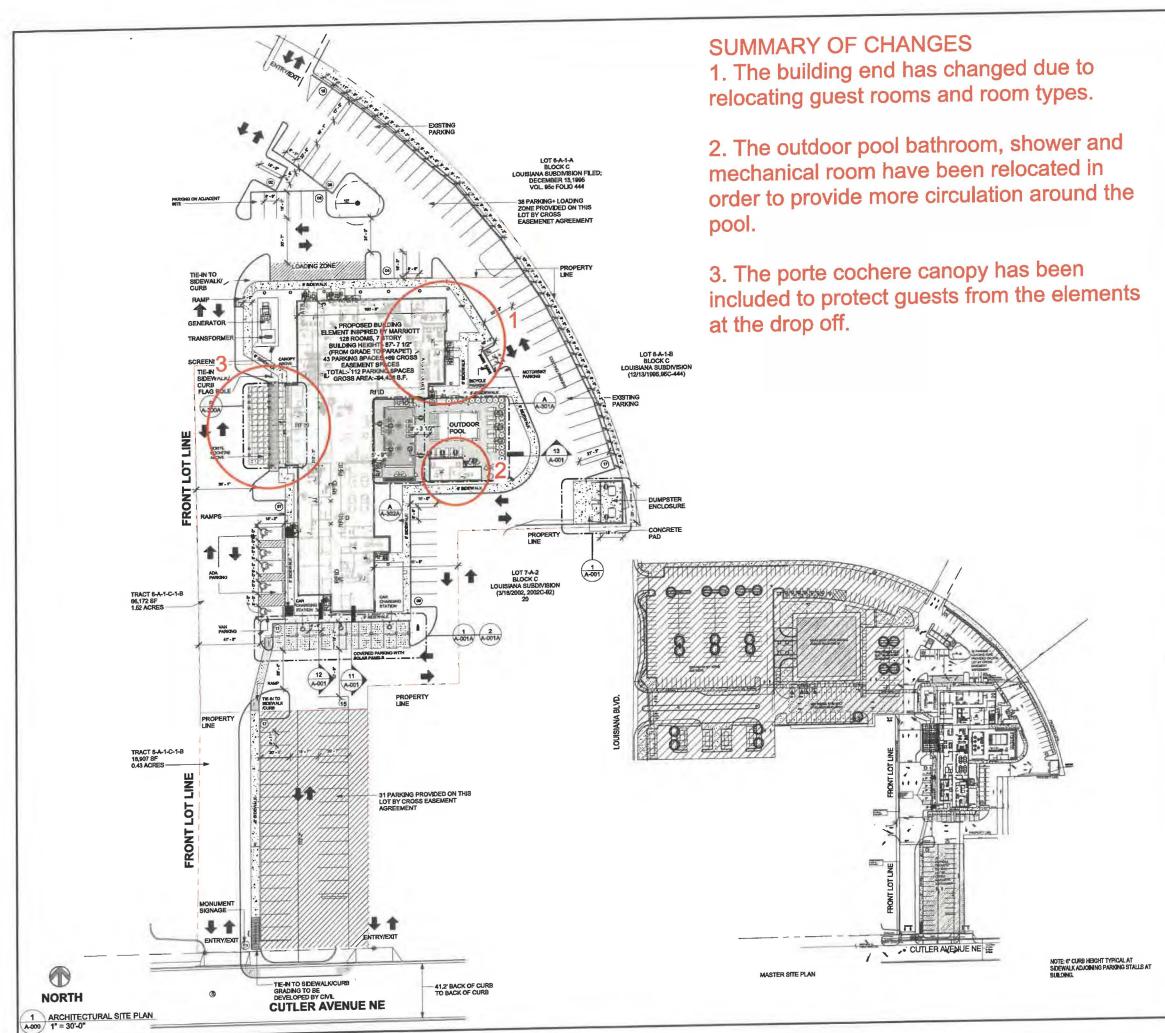

GENERAL NOTES - SITE PLAN

- GENERAL NOTES SITE PLAN

 ALL SITE PLAN INFORMATION IS BASED ON TOPOGRAPHIC
 SURVEY PREPARED BY CIVIL ENGINEER, SEE SHEET GOOD
 FOR CONTACT INFORMATION
 REFER TO CIVIL ENGINEER, SEE SHEET GOOD
 FOR CONTACT INFORMATION PERTANNING TO DRAINAGE
 DESIGN, CURSE CUTS, PAVING, AND PARRONG LOT
 DIMENSIONS.
 CONTRACTOR SHALL COORDINATE, PRIOR TO THE
 COMMENCEMENT OF SITE WORK, THE FINISH FLOOR
 ELEVATION WITH THE CIVIL ENGINEER AND THE
 STRUCTURAL ENGINEER
 SHOULD FIELD CONDITIONS DIFFER FROM PLANS TO THE
 EXTENT UNNECESSARY COSTS ARE INCURRED OR
 BELLAYS ARE ANTICIPATED, THE OWNER AND AREA
 SHOULD FIELD CONDITIONS
 SHALL BE CONSULTED, THE ARCHITECTE AND CHIEF
 STRUCTURAL BE CONSULTED, THE ARCHITECTE AND CHIEF
 STRUCTURAL BE CONSULTED. THE ARCHITECTE AND CHIEF
 WITH THE OWNER WILL DETERMINE THE RESOLUTION.
 PRIOR TO CONSTRUCTION GENERAL CONTRACTOR SHALL
 VERIFY ALL ITEMS SHOWN AS EASTING ON THESE
 DRAININGS AND WOTHEY TITIS OFFICE OF AND
 DISCREPANCE OF TAKE DESCALITIONS TO PROTECT
- DRAWINGS AND MOITH THIS OFTICE OF A DISCREPANCES CONTRACTOR MUST TAKE PRECAUTIONS TO PROTECT COWNERS PROPERTY FROM CONSTRUCTION OPERATION BOUNDARY OF CONTRACTOR'S WORK AND STORAGE AREAS WILL BE DEFINED TO MUTUAL AGREEMENT BY

- LIMITS OF CONSTRUCTION TO BE AREA WITHIN PROPERTY LINE OR AS INDICATED WITH LIMIT LINES OF CONSTRUCTION.

 GC TO FOLLOW THE MINIMUM REQUIREMENTS FOR PAVEMENT DESIGN RECOMMENDATION WALL UND PER CIVIL DRAWNS AND BOIL REPORT.
 GENERAL CONTRACTOR TO PROVIDE PAINTED STRIPING, WORDING, DRECTIONAL ARROWS AND SYJRBOLS IN ACCORDANCE WITH SPECIFICATIONS, NATIONAL AND I COLL CORDES.

- ALL ACCESSIBLE AND 16 SOFTALED BY GUDELINES.
 ALL EXTERIOR SIGNAGE SHALL BE AS DIRECTED BY OWNER (EXCEPT AS DETAILED WITHIN THESE CONSTRUCTION DOCUMENTS) AND IN COMPILANCE WITH LOCAL CODES, AND GUDELINES AND ANSI VERSIONS ADOPTED BY THE MUNICIPALITY, GENERAL CONTRACTOR TO PROVIDE ELECTRICAL CONDUT & POWER, SIGNAGE & FOUNDATION ARE O.F.O.I.

- POWER, SIGNAGE & FOUNDATION ARE O.F.O.I.

 COORDINATE EXTERIOR UTILITY LOCATIONS W/ CIVIL

 ENGINEERING DWGS & WITH UTILITY COMPANIES PRIOR
 TO COMMENCEMENT OF CONSTRUCTION
 GENERAL CONTRACTOR TO ENBURE GAS METER
 PROTECTION WITH STEEL BOLLARDS AS REQUIRED BY
 LOCAL UTILITY JURRISDICTION & CODE REQUIREMENTS
 ALL ROOF DRAINS TO TIE INTO STORM DRAINAGE
 SYSTEM (SEC CIVIL)

 REFER TO CHIL ENGINEERING DRAWINGS FOR SITE
 CONSTRUCTION DETAILS, INCLUDING CURB AND
 GUTTER DETAILS AND RADII.

 LANDSCAFE DESIGN IS NOT INCLUDED WITHIN THE
 SCOPE OF WORK REPRESENTED IN THESE DRAWINGS.
 EACH ACCESSIBLE PARKING SHALL BE POSTED W/
 PERMANENT SIGN BEARING THE INTERNATIONAL
 SYMBOL OF ACCESSIBILITY AND THE CAPTION "PARKING
 BY DISABLED PERMIT ONLY AND ANY OTHER
 INFORMATION THAT MAY BE REQUIRED LOCALLY.

GROSS AREA (EXCLUDING COVERED OUTDOOR SPACES)

| LEVEL | AREA |
|------------|-----------|
| 1ST FLOOR | 19,167 SF |
| 2ND FLOOR | 12,613 SF |
| SRD FLOOR | 13,787 SF |
| ATH FLOOR | 13,787 SF |
| STH FLOOR | 13,787 SF |
| 6TH FLOOR | 13,787 SF |
| ROOF LEVEL | 7,509 SF |
| TOTAL: 9 | 94,438 SF |

PARKING MATRIX

| PARKING TYPE | REQUIRED | PROVIDED |
|----------------------------|----------|----------|
| ACCESSIBLE PARKING SPACE | 4 | 4 |
| VAN PARKING SPACE | 1 | 1 |
| STANDARD PARKING SPACE | 121 | 116 |
| MEETING ROOM PARKING SPACE | 11 | 11 |
| RESTAURANT PARKING SPACE | 7 | 7 |
| MOTO PARKING SPACE | 4 | 4 |
| TOTAL PARKING SPACE | 104* | 118 |
| BICYCLE PARKING SPACE | 4 | 8 |



BASE4 2901 CLINT MOORE ROAD, #114 BOCA RATON, FLORIDA 33496

RICARDO J. MUNIZ-GUILLET, AIA 2030 HABERSHAM TRACE, CUMMING, GA 30041







| NO. | DELTA | ISSUE DATE | DESCRIPTION |
|-----|-------|------------|-------------------|
| 4 | A3 | 2021.08.24 | CITY COMMENTS |
| 1 | A0 | 2020.12.01 | ISSUED FOR PERMIT |

ISSUED FOR PERMIT

2021.07.15 SB/NS

LA/RB

B4-178-1901 SHEET NAME

ARCHITECTURAL SITE PLAN



1 SOUTH ELEVATION 1/8" = 1'-0"

GENERAL ELEVATION NOTES

- REVIEW ALL SIGHTLINES AROUND PROPERTY BEFORE LOCATING ROOFTOP EOLIPMENT, VERRY ALL EQUIPMENT IS ADEQUATELY SCREENED.

 SCREENED FOR A MOCK WALL SHOWING A FULL WINDOW INSTALL WITH FLASHING, GC CAN USE A PROPORTIONALLY SCALED DOWN WINDOW IN LIEU OF FULL SUE WINDOW.

 ALL EXTERIOR VENTS, GRILLES, MECHANICAL LOLVERS AND EXTERIOR HOLLOW METAL DOORS TO BE FNISHED TO MATCH ADJACENT EXTERIOR MATERIAL.

 ALL BULDANG PERMITS TO BE CONSISTENT WITH THE APPROVED SITE FLAN. THE PLANNING DEPARTMENT DOES NOT REVIEW BUILDING PERMIT FOUND SETS, SO IT IS THE EQUEL DEPART FLAN BEST, SO IT IS THE EQUEL DEPART OF THE PROPOSED DURING THE SITE PLAN, THE PLAN, THE STATE THAN STATE OF THE STATE OF THE ADJACENT OF DOCUMENT OF THE STATE OF THE MOCHANICATION OF THE MOCHANGE OF A CERTIFICATE OF COCUPANIE MODIFICATIONS TO THE CONSTRUCTION DIM DAY NECESSARY DEPARTMENT OF THE MODIFICATIONS TO THE CONSTRUCTION DAY MAY NECESSARY DEPARTMENT OF THE MODIFICATIONS TO THE CONSTRUCTION DAY MAY NECESSARY DEPARTMENT OF THE STATE OF THE MODIFICATIONS TO THE CONSTRUCTION DAY MAY ARCHITECTURAL FINISH FLOOR ELEVATIONS REFER TO TOP OF FINISH FLOOR ASSEMBLY, SEE STRUCTURAL DWGS FOR TOP OF STRUCTURE AND BEARING HEIGHT ELEVATIONS

GENERAL SIGNAGE NOTES

- GENERAL SIGNAGE NOTES

 ALL BIGNAGE NIDICATED FOR LLUSTRATIVE PURPOSES ONLY LOCATION, SIZE, ETE. TO BE DETERMINED ON AN INDIVIDUAL PROJECT BASIS, MINIMAL PROJECT BASIS, MINIMAL PLANCED BASIS, MINIMAL PROJECT BASIS, MINIMAL PROPERTY OF A MINIMAL PROPERTY OF A MINIMAL PROPERTY WHERE BOINS ARE LOCATED TO BE PROVIDED BY CONTRACTOR, CONTRACTOR ALL PARAPETS WHERE BOINS ARE LOCATED TO BE PROVIDED BY CONTRACTOR, CONTRACTOR TO FUNDED BASIS AND CONTRACTOR OF WATER BOYNED BASIS AND CONTRACTOR TO FUNDED BASIS AND CONTRACTOR OF WATER BOYNED BASIS AND CONTRACTOR OF WATER BOYNED BASIS AND CONTRACTOR OF WATER BOYNED BASIS AND CONTRACTOR WALLS MINIST HAVE ELECTRICAL BEING COORDINATED ANDOR REMOTE THE WALL, PENETRATION LAYOUT MAY BE OBTANED FROM SIGN COMPANY

| | EXTERIOR | R FINISH LEGEND | |
|--------|----------------------------|-----------------------------------|-------|
| MARK | MATERIAL / BRAND | IATERIAL / BRAND COLOR / FINISH | |
| BK-01 | | ASHEN BLACK - 820 | |
| EF-01 | EIFS-PAREX | SANDPEBBLE-ELEM-01-2736-WHITE | |
| EF-02 | EIFS-PAREX | SANDPEBBLE-ELEN-01-1022-DARK GREY | |
| EF-03 | EIFS-PAREX | SANDPEBBLE-MIDNIGHT-MC-048 | |
| FCP-01 | FIBRE CEMENT PANEL/NICHIHA | NICHIA PANEL-GLACIER | 12.00 |
| FCS-01 | FIBER CEMENT PANEL-NICHIHA | VINTAGE CEDAR BARK | |



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RICARDO J. MUNIZ-GUILLET, AIA 2030 HABERSHAM TRACE, CUMMING, GA 30041





4239 BALLOON PARK ROAD ALBUQUERQUE, NM 87109 505,831,4200



2430 LOUISIANA BLVD. NE ALBUQUERQUE, NM 87110, USA PROTOTYPE VERSION: GEN 2.5 REVISION DATE: 2020,02.11 ID PACKAGE: ENLIVEN DECOR PACKAGE VERSION 2.5

ISSUE NO. DELTA ISSUE DATE DESCRIPTION

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LA/RB

2021.07.15


SB/NS

PROJECT NO. B4-176-1901

SHEET NAME

BUILDING **ELEVATION-1**

DRAWINGS NO.

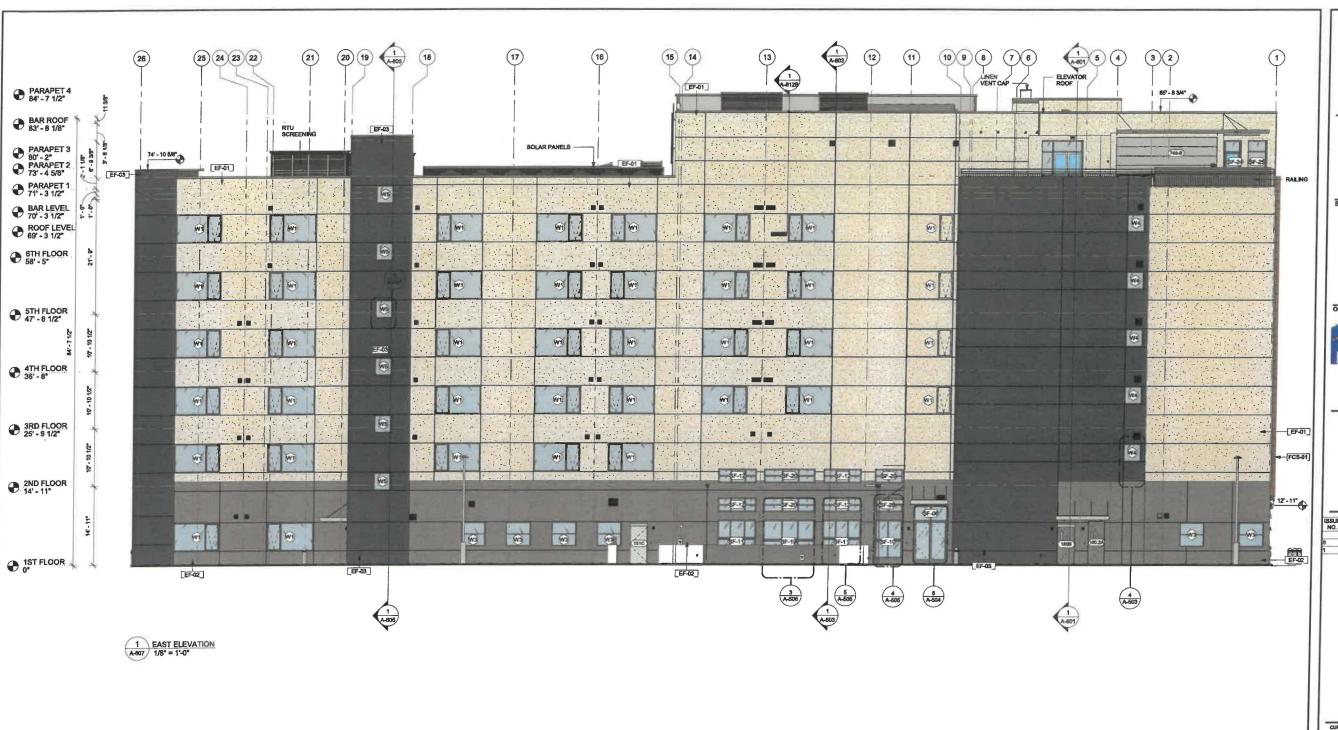

GENERAL ELEVATION NOTES

- REVIEW ALL SIGHTLINES AROUND PROPERTY BEFORE LOCATING ROOFTOP EQUIPMENT. VERIFY ALL EQUIPMENT IS ADEQUATELY SCREENED.

 GC TO PROVIDE A MOCK WALL SHOWING A FULL WINDOW INSTALL WITH FLASHING, GC CAN USE A PROPORTIONALLY SCALED DOWN WINDOW IN LIEU OF FULL SIZE WINDOW.

 ALL EXTERIOR VERTIS, GRALLES, MECHANICAL LOLVERS AND EXTERIOR HOLLOW METAL DOORS TO BE FINISHED TO MATCH ADJACENT EXTERIOR MATERIAL.

 ALL BULDING PERMITS TO BE CONSISTENT WITH THE APPROVED SITE PLAN, THE PLANINNS DEPARTIMENT DOES NOT REVIEW BUILDING PERMIT PLAN SITS, SO IT IS THE DEVELOPERS RESPONSIBLITY TO ENSURE THAT ELEVATIONS BUBINITIED IN THE BUILDING PERMIT SET MACT HINDSE APPROVED DURINITIE BITE PLAN REVIEW PROCESS. IF THE ELEVATIONS DO NOT MATCH THOSE PLAN THE BURNOW THE STEP PLAN THE MODER AND THE CONSTRUCTION, MONEY PROPERTIES AND THE CONSTRUCTION OF THE MODER AND STONE OF THE CONSTRUCTION AND METAL THE STONE OF THE CONSTRUCTION BUSINGS.

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GENERAL SIGNAGE NOTES

- AL BISMAGE NIDICATED FOR ILLISTRATIVE PURPOSS ONLY. LOCATION, SIZE ETC. TO BE DETERMINED ON AN INDIVIDUAL PROJECT BASIS, MINIMIM AN PLYWOOD BEACKER BOADD. REQUIRED AT SIGN LOCATIONS. AREA SHOULD COVERE NOTIFE LEMBIT AND HEIGHT OF FASCIA OR SPACE AVAILABLE FOR SIGN.

 LECTIFICAL AND FINAL CONNECTION BY CONTRACTOR. ELECTRICAL REQUIREMENTS MAY BE OBTAINED FROM SIGN COMPANY. PERMANENT ACCESS DOORS TO INTENIOR OF ALL PRAPPETS WHERE SIGNS ARE LOCATED TO BE PROVIDED BY CONTRACTOR. CONTRACTOR TO FUNDED TO SIGN.

 TO FUNNISH AND CONNECT PRIMARY ELECTRICAL SERVICE INSIDE PARAPET WALL PROVIDE WEATHER PROPO FACESS DOORS AT ROOF LEVEL OR ANYWHERE EXTERDOR OR WET CONDITIONS MAY APPLY.

 QUESTROOMS OR PUBLIC SPACES WITH SIGNAGE ON EXTERIOR WALLS MUST HAVE ELECTRICAL PENETRATIONS ANDOR REMOTE TRANSFORMERS COORDINATED ANDOR RISTALLED PRIOR TO CLOSING UP THE WALL PENETRATION LAYOUT MAY BE OSTANED FROM SIGN COMPANY.

| MARK | MATERIAL / BRAND | COLOR / FINISH | MATERIAL IMAGE | | |
|--------|----------------------------|-----------------------------------|-------------------|--|--|
| BK-01 | | ASHEN BLACK - 820 | | | |
| EF-01 | EIFS-PAREX | SANDPEBBLE-ELEM-01-2738-WHITE | | | |
| EF-02 | EIFS-PAREX | SANDPEBBLE-ELEM-01-1022-DARK GREY | Mari | | |
| EF-03 | EIFS-PAREX | SANDPEBBLE-MIDNIGHT-MC-046 | | | |
| FCP-01 | FIBRE CEMENT PANEL/NICHIHA | NICHIA PANEL-GLACIER | | | |
| FCS-01 | FIBER CEMENT PANEL-NICHIHA | VINTAGE CEDAR BARK | 193 | | |



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4239 BALLOON PARK ROAD ALBUQUERQUE, NM 87109 505.831.4200



2430 LOUISIANA BLVD, NE ALBUQUERQUE, NM 87110, USA PROTOTYPE VERSION: GEN 2.5 REVISION DATE: 2020.02.11 ID PACKAGE: ENLIVEN DECOR PACKAGE VERSION 2.5

DELTA ISSUE DATE DESCRIPTION A7 2021,10,21 ADD#2 A0 2020,12,01 ISSUED FOR PERMIT

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2021.07.15

SB/NS CHECKED BY


PROJECT NO. B4-176-1901

SHEET NAME

BUILDING **ELEVATION-2**

LA/RB

DRAWINGS NO.

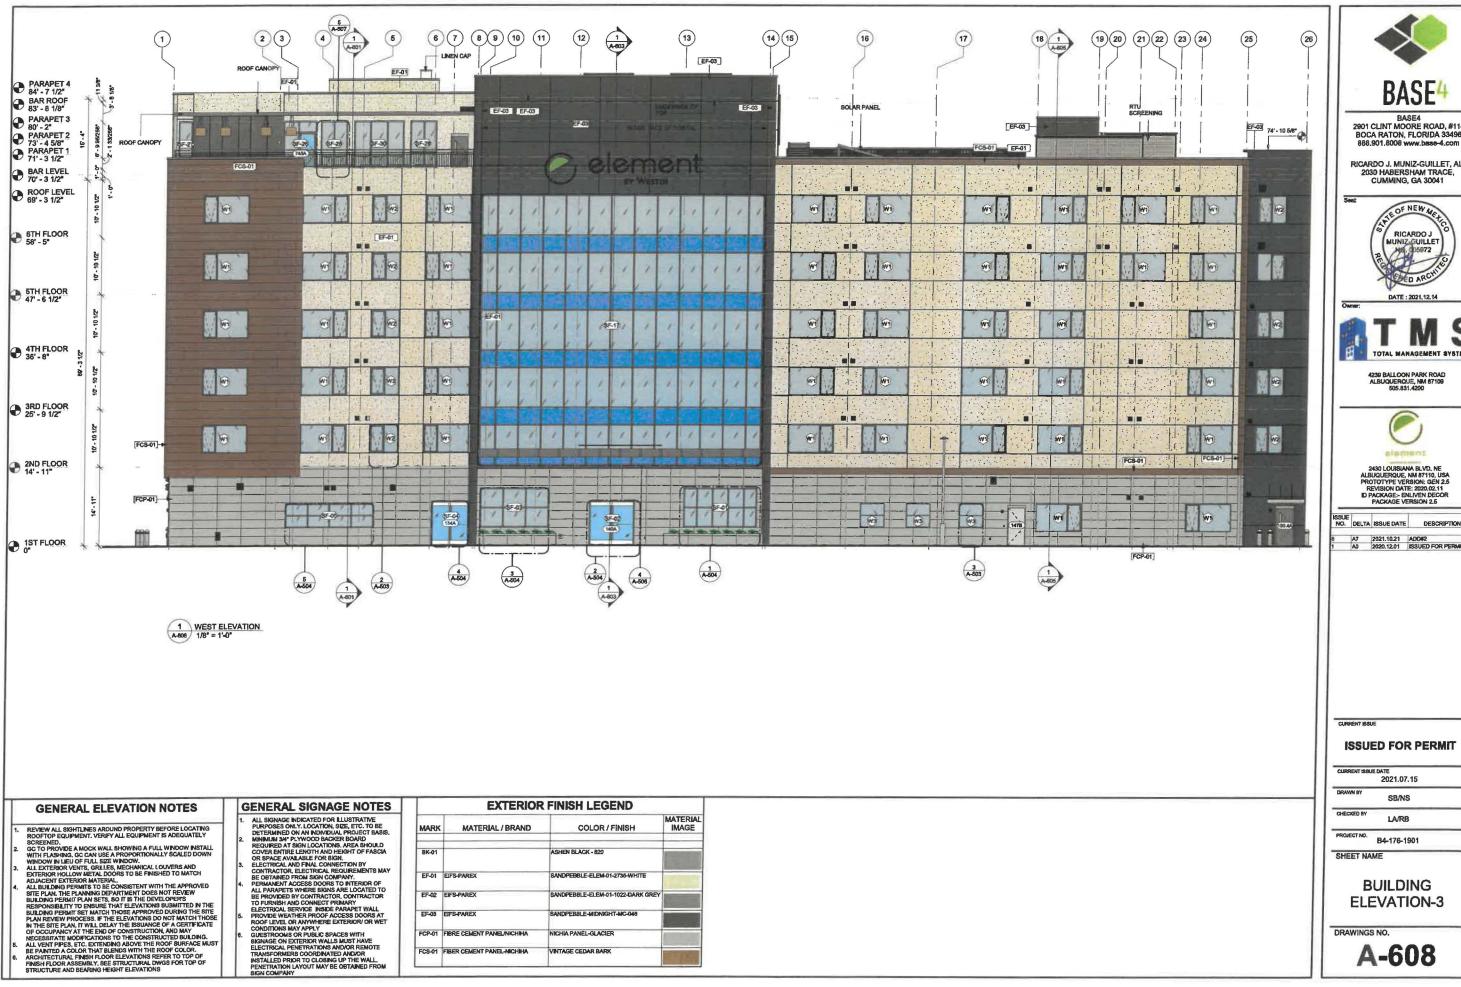

FCP-01 FIBRE CEMENT PANEL/NICHIHA

FCS-01 FIBER CEMENT PANEL-NICHIHA

ICHIA PANEL-GLACIER

VINTAGE CEDAR BARK

BASE4

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RICARDO J. MUNIZ-GUILLET, AIA 2030 HABERSHAM TRACE, CUMMING, GA 30041



DATE: 2021,12.14



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2430 LOUISIANA BLVD. NE ALBUQUERQUE, NM 87116, USA PROTOTYPE VERSION: GEN 2.5 REVISION DATE: 2020,02.11 ID PACKAGE: ENLIVEN DECOR PACKAGE VERSION 2.5

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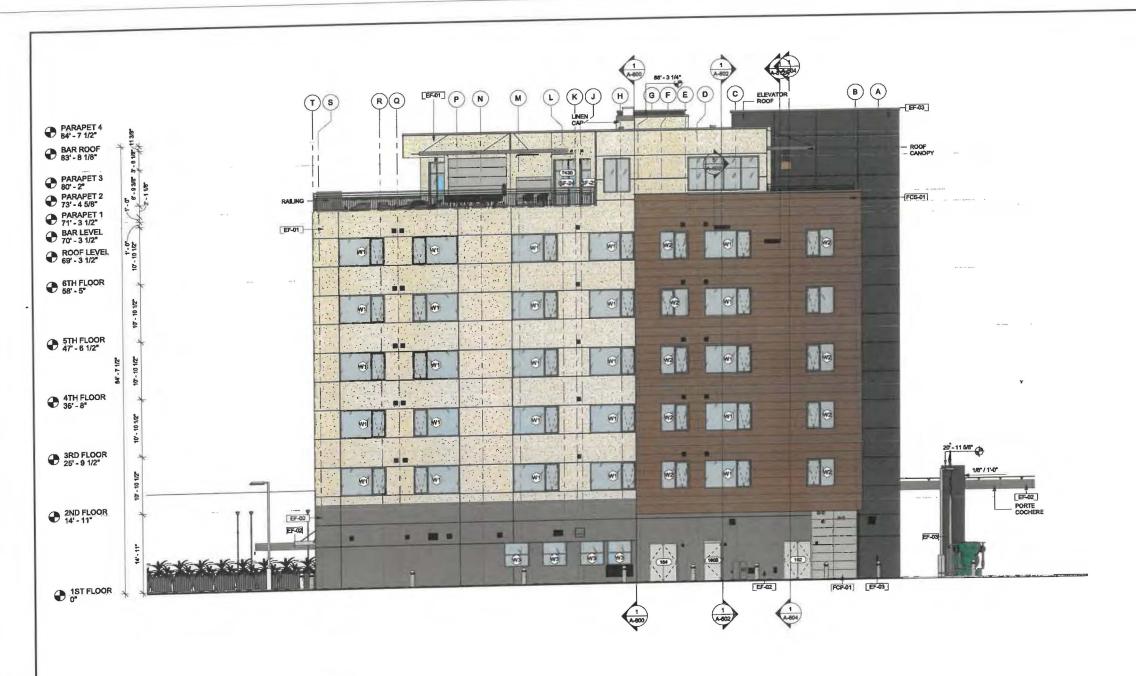
CURRENT ISSUE DATE 2021.07.15 SB/NS

LA/RB PROJECT NO. R4-176-1901

SHEET NAME

BUILDING **ELEVATION-3**

DRAWINGS NO.





GENERAL ELEVATION NOTES

- REVIEW ALL BIGHTLINES AROUND PROPERTY BEFORE LOCATING ROOFTOP EQUIPMENT. VERIFY ALL EQUIPMENT IS ADEQUATELY COREENED.

 COTOP PROVIDE A MOCK WALL SHOWING A FULL WINDOW INSTALL WITH FLASHING. GC CAN IBSE A PROPORTIONALLY SCALED DOWN WINDOW IN IBLEU OF FULL SIZE WINDOW.

 ALL EXTERIOR VENTS, GRILLES, MECHANICAL LOLIVERS AND EXTERIOR HOLLOW METAL DOORS TO BE FINISHED TO MATCH ADJACENT EXTERIOR MATERIAL.

 ALL BULDING PERMITS TO BE CONSISTENT WITH THE APPROVED SITE PLAN, THE PLANNING DEPARTMENT DOES NOT REVIEW BULDING PERMIT PLAN SETS, BO IT BE YELDING SUBMITTED IN THE BULDING PERMIT SHEST, BO IT BE YELDING SUBMITTED IN THE BULDING PERMIT SHEST, BO IT BE YELDING SUBMITTED IN THE BULDING PERMIT PLAN SETS, BO IT BE YELDING SUBMITTED IN THE BUILDING PERMIT SHEST SHEST HAS BUT BE SUBMITIONS DO NOT MATCH THOSE WITH THE STEP PLAN, IT WE SHE BUT THE SUBMICE OF A CERTIFICATE OF COCUPANIO PERMIT PLAN SHEST HAS THE ELEVATION TO THE ORDER OF A CERTIFICATE OF COCUPANIO PERMIT SHEST OF THE CONSTRUCTION DIM DAY NECESSITIFE MODIFICATIONS TO THE CONSTRUCTED BUILDING. ALE PANTED A COLOR THAT BLENDS WITH THE ROOF COLOR.

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 STRUCTURE AND BEARING HEIGHT ELEVATIONS.

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2430 LOUISIANA BLVD. NE ALBUQUERQUE, NM 87110, USA PROTOTYPE VERSION: GEN 2.5 REVISION DATE: 2020.02.11

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CURRENT ISSUE

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CURRENT ISSUE DATE 2021.07.15


SB/NS CHECKED BY LA/RB

PROJECT NO. B4-176-1901

SHEET NAME

BUILDING **ELEVATION-4**

DRAWINGS NO.

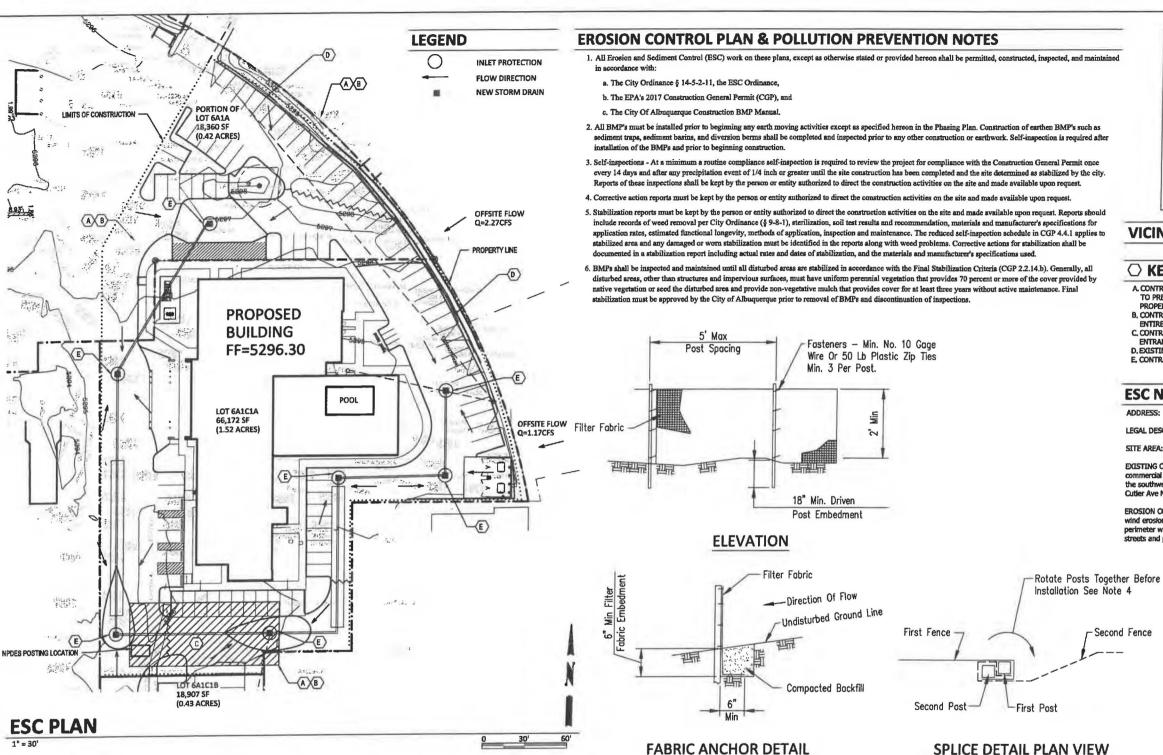

SIDE CROSS SECTION VIEW

VICINITY MAP

H-19-Z

○ KEYED NOTES

- A. CONTRACTOR SHALL INSTALL PERIMETER BMP PROTECTION TO PREVENT SEDIMENT FROM ENTERING ADJACENT
- B. CONTRACTOR SHALL INSTALL SILT FENCE ALONG THE
- ENTIRE PERIMETER OF CONSTRUCTION FACILITIES,
 C. CONTRACTOR SHALL INSTALL STABILIZED CONSTRUCTION
- D EXISTING CURR AND GUTTER TO REMAIN

ESC NOTES

ADDRESS: 2440 Louisiana Blvd NE, Albuquerque, NM

LEGAL DESCRIPTION: TRACT 6-A-1-C-1-A, BLOCK 'C' LOUISIANA SUBDIVISION

SITE AREA: 66.172 SF (1.519 acres)

EXISTING CONDITIONS: The site is a fully developed portion of an existing commercial site with asphalt parking and landscaping. The site slopes down slightly to the southwest at approximately 1,5% and runoff discharges to the public R/W of

EROSION CONTROL: Disturbed portions of the site shall be kept wetted to minimize wind erosion. A temporary construction fence with screening will follow the site perimeter which will help mitigate windblown sediment. The Impact on surrounding

- 1. TEMPORARY STILT FENCE SHALL BE INSTALLED PRIOR TO ANY GRADING WORK IN THE AREA TO BE PROTECTED, FENCE SHALL BE MAINTAINED THROUGHOUT THE CONSTRUCTION PERIOD AND REMOVED IN CONJUNCTION WITH THE FINAL GRADING AND SITE STABILIZATION.
- FILTER FABRIC SHALL MEET THE REQUIREMENTS OF MATERIAL SPECIFICATION 592 GEOTEXTILE TABLE 1 OR 2, CLASS 1 WITH EQUIVALENT OPENING SIZE OF AT LEAST 30 FOR NONWOVEN AND 50 FOR WOVEN.
- FENCE POSTS SHALL BE WITHER WOOD POST WIT A MINIMUM CROSS-SECTIONAL AREA 1.5"x1.5" OR A
- STANDARD STEEL POST WHEN SLICES ARE NECESSARY, MAKE SPLICE AT POST ACCORDING TO SPLICE DETAIL, PLACE THE END POSE OF THE SECOND FENCE INSIDE THE END POST OF THE FIRST FENCE. ROTATE BOTH POSTS TOGETHER AT LEAST 180 DEGREES TO CREATE A TIGHT SEAL WITH THE FABRIC MATERIAL, CUT THE FABRIC NEAR THE BOTTOM OF THE POSTS TO ACCOMMODATE THE 6" FLAP. THEN DRIVE BOTH POSTS AND BURY THE FLAP. COMPACT BACKETT WELL

NOTES:

SILT FENCE DETAILS

- ENTRANCE(S) SHALL BE LOCATED TO PROVIDE MAXIMUM UTILITY BY ALL CONSTRUCTION VEHICLES.
- TURNING RADIUS SUFFICIENT TO ACCOMMODATE LARGE TRUCKS IS TO BE PROVIDED
- MUST BE MAINTAINED IN A CONDITION WHICH WILL PREVENT PERIODIC TOPDRESSING WITH STONE WITH BE NECESSARY, CONTRACTOR SHALL MAINTAIN AS NECESSARY.
- ANY MATERIAL WHICH STILL MAKES IT ONTO THE ROAD MUST BE CLEANED
- NOTES ARE APPLICABLE AT ALL POINTS OF INGRESS AND EGRESS UNTIL SITE
- 7. UTILIZE FILTER FABRIC IN CLAY SOILS.

ELEMENT HOTEL 2440 LOUISIANA BLVD NE

Scott M McGee PE

9700 Sand Verbena Trail NE

Albuquerque, NM 87122 505.263.2905 scottmmcgee@gmail.com


EXISTING ROADWAY

100' MIN. (COMMERCIAL) 50' MIN. (RESIDENTIAL)

PLAN VIEW

CONSTRUCTION ENTRANCE FOR EROSION CONTROL

25' OR WIDTH OF PROPOSED STREET OR DRIVEWAY, WHICHEVER IS GREATER.

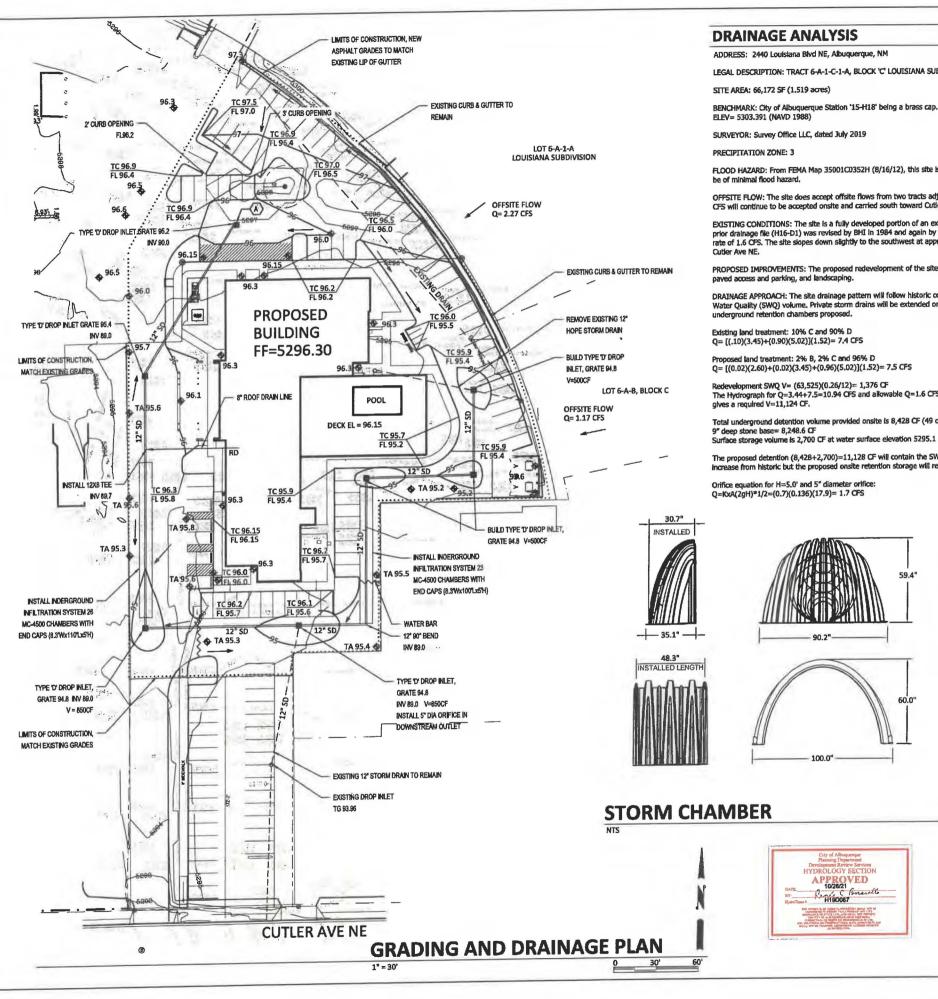

DRAINAGE ANALYSIS

ADDRESS: 2440 Louisiana Bivd NE, Albuquerque, NM

LEGAL DESCRIPTION: TRACT 6-A-1-C-1-A, BLOCK 'C' LOUISIANA SUBDIVISION

STTE AREA: 66,172 SF (1,519 acres)

BENCHMARK: City of Albuquerque Station '15-H18' being a brass cap. ELEV= 5303.391 (NAVD 1988)

SURVEYOR: Survey Office LLC, dated July 2019

PRECIPITATION ZONE: 3

FLOOD HAZARD: From FEMA Map 35001C0352H (8/16/12), this site is identified as being within Zone 'X' which is determined to

OFFSITE FLOW: The site does accept offsite flows from two tracts adjacent to the east as shown on the plan. The total Q=3.44 CFS will continue to be accepted onsite and carried south toward Cutier per the historic flow pattern.

EXISTING CONDITIONS: The site is a fully developed portion of an existing site with asphalt parking and some landscaping. The EALS TIME CONDITIONS: THE SIZE IS A TURY DEVELOPED POTUDING IT ALSO AND SIZE WITH SPIRAL PARTING AND ASSESSED AS THE INSIGHT OF THE STREET AND ASSESSED AS THE SIZE IN A STREET AS THE STREET AS THE SIZE IN A STREET AS THE SIZE IN A STREET AS THE SIZE IN ASSESSED AS THE SIZE IN A STREET AS THE SIZE IN ASSESSED AS THE SIZE IN A STREET AS THE S

PROPOSED IMPROVEMENTS: The proposed redevelopment of the site includes a new 7-story hotel, a swimming pool, associated paved access and parking, and landscaping.

DRAINAGE APPROACH: The site drainage pattern will follow historic conditions and include the onsite retention of the Storm Water Quality (SWQ) volume, Private storm drains will be extended onsite to provide for catch basins to Intercept site runoff with underground retention chambers proposed.

Existing land treatment: 10% C and 90% D Q= [(.10)(3.45)+(0.90)(5.02)](1.52)= 7.4 CFS


Proposed land treatment: 2% B, 2% C and 96% D Q= [(0.02)(2.60)+(0.02)(3.45)+(0.96)(5.02)](1.52)= 7.5 CFS

Redevelopment SWQ V= (63,525)(0,26/12)= 1,376 CF The Hydrograph for Q=3.44+7.5=10.94 CFS and allowable Q=1.6 CFS (peak time of 11.4 mins and base time of 24.7 mins) gives a required V=11,124 CF.

Total underground detention volume provided onsite is 8,428 CF (49 chambers x 162.6 CF/EA)+(4 end caps x 115.3 CF/EA) using 9" deep stone base= 8,248.6 CF

The proposed detention (8,428+2,700)=11,128 CF will contain the SWQ volume and restrict discharge to 1,7 CFS, Site runoff will increase from historic but the proposed onsite retention storage will reduce runoff rate to the allowable rate.

Orifice equation for H=5.0' and 5" diameter orifice: Q=KxA(2gH)*1/2=(0.7)(0.136)(17.9)= 1.7 CFS

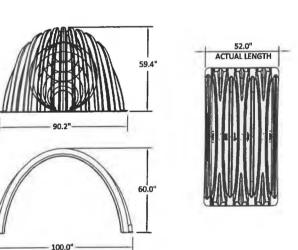

APPROVED Re A190087



VICINITY MAP


H-19-Z

LEGEND

---- EXISTING CONSTRUCTION NEW CONTOUR

FF=5296.30 PROPOSED BUILDING FINISH FLOOR ELEV

NEW SPOT ELEVATION **NEW CONSTRUCTION** ROOF DRAIN TOP OF CURB + · · · · · LIMITS OF CONSTRUCTION

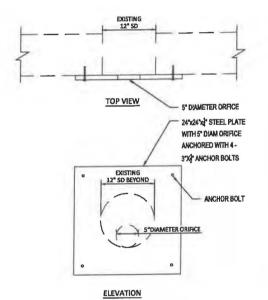


EXISTING INLET W/ORIFICE PLATE

ELEMENT HOTEL 2440 LOUISIANA BLVD NE


Scott M McGee PE

9700 Sand Verbena Trail NE Albuquerque, NM 87122 505.263.2905 scottmmcgee@gmail.com



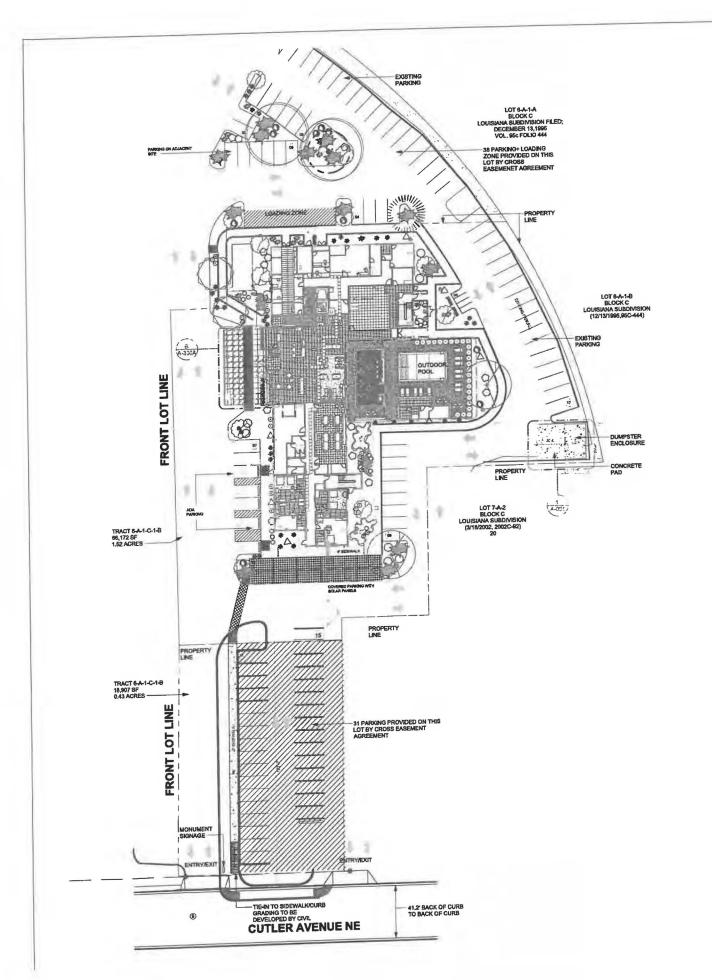



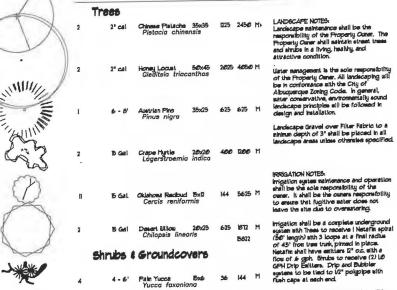

HZO USE




| 9 | 10 | 5 Gal | India Hasthorne 3x5 25 Raphiolepis indica | 250 | M |
|---|----|-------|---|-----|---|
| * | 34 | 5 Gal | Feather Reed Grass 25/2 4 Calamograstia arudinacea | B6 | M |
|) | 13 | 5 Gal | Graylesi Colonesster5x5 25 Cotoneaster glaucophyllus | 350 | M |
| 2 | 1 | 5 Gal | Butterfly Bush 5x1 49 Buddlěio dovidii | 343 | M |
| 7 | 2 | 5 Gal | Ulmer Jaseine 4xi2 144 Jasminum nudiflorum | 288 | M |
| | В | 5 Gel | Buffalo Juniper bil 144 Juniperus sabina Buffalo | П28 | н |





FEBCO MODEL 168

Marie Street are paid on the Table to realize thems! togetherists. April.

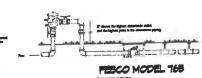

Rin time per each shiply drip valve still be approximately B situates per day. Thes chip valve shall not 15 hours, 3 times per seek. Rin the still be adjusted according to the season.

Point of connection for irrigation system is unknown at current time and will be coordinated in the field. Irrigation will be operated by automatic controller.

Location of controller to be field

irrigation naintenance shall be the responsibility of the Property Coner.

lilater and Power source shall be the responsibility of the Developer/Build

TOTAL LANDSCAPE REQUIRED (B%) TOTAL ON-9ITE LANDSCAPE PROVIDED 2455
TOTAL LIVE GROUNDCOVER PROVIDED 4049

TOTAL LOT AREA (61)
TOTAL BUILDING AREA (61)
TOTAL LOT AREA (61)
LANDSCAPE REQUIREMENT

LANDSCAPE CALCULATIONS

66297 -19485 46812














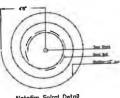

Natofirm Spiral Data?

2440 Louisiana Proposed Hotel Albuquerque, NM

Landscape Architec

STIE OF NEW OOD

DANNY D. MITCHELL

October 30, 2013

SCAPE ARCH

Plan




SCALE: F = 40'-0"

GRAPHIC SCALE

40 20 0 20 40

LS-101

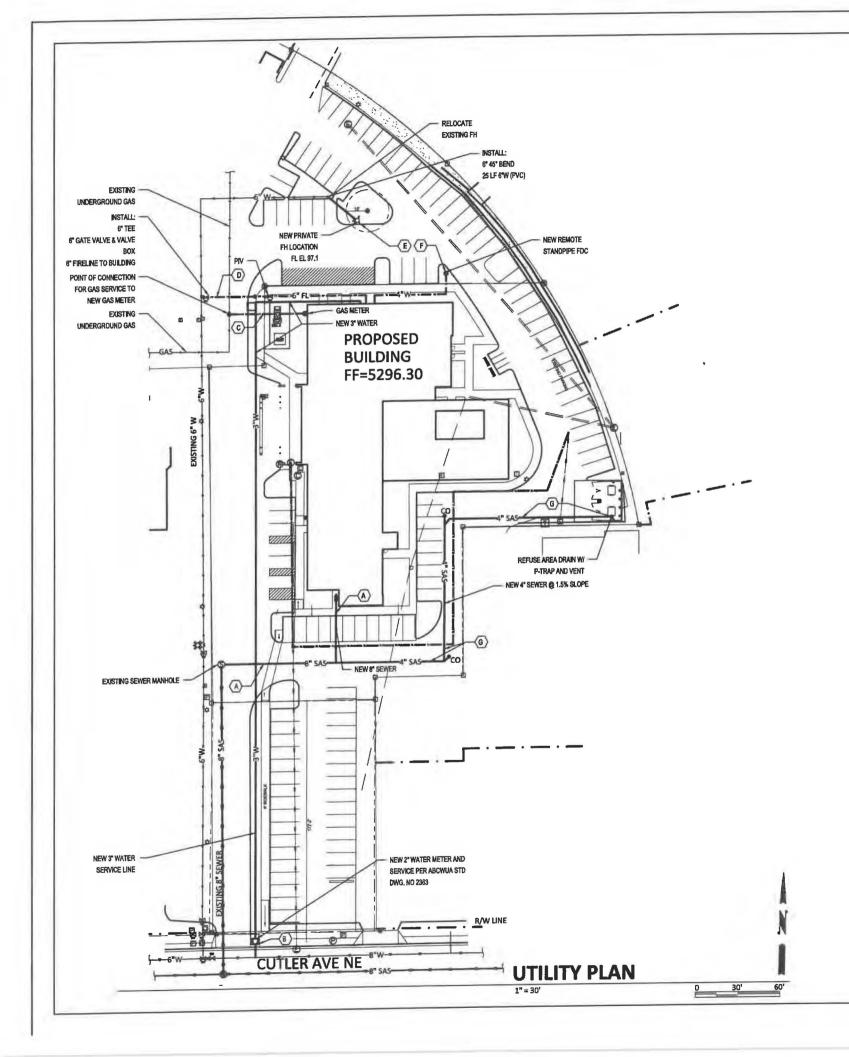



KEYED NOTES

- A. CONNECT NEW 8" SANITARY SEWER SERVICE TO EXISTING ONSITE MANHOLE AS SHOWN, SEE PLUMBING PLAN FOR CONTINUATION.
- B, NEW 2" DOMESTIC WATER SERVICE FROM WATER MAIN TO METER AND 3" WATERLINE FROM METER TO THE BUILDING, SEE PLUMBING PLAN FOR CONTINUATION.
- C. NEW GAS SERVICE TO METER—SIZE PER MECHANICAL PLAN. CONTRACTOR TO COORDINATE WITH NEW MEXICO GAS COMPANY.
- D. NEW 6" FIRELINE TO BUILDING FROM WATER MAIN, INSTALL POST INDICATOR VALVE (PIV) AS SHOWN.
- E. RELOCATE PRIVATE FIRE HYDRANT ONSITE AS SHOWN.
- F. INSTALL REMOTE STANPIPE FIRE DEPT CONNECTION (FDC) AS SHOWN.
- G. INSTALL 4" WASTE LINE FROM REFUSE AREA DRAIN AT MIN. 2% SLOPE. INSTALL DRAIN, P-TRAP, AND 2" VENT AS REQUIRED, ROUTE VENT UP ALONG REFUSE ENCLOSURE WALL TO ABOVE WALL AND BRACE AS REQUIRED.

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