




6 NORTH ELEVATION
SCALE: 1/4"=1'-0"

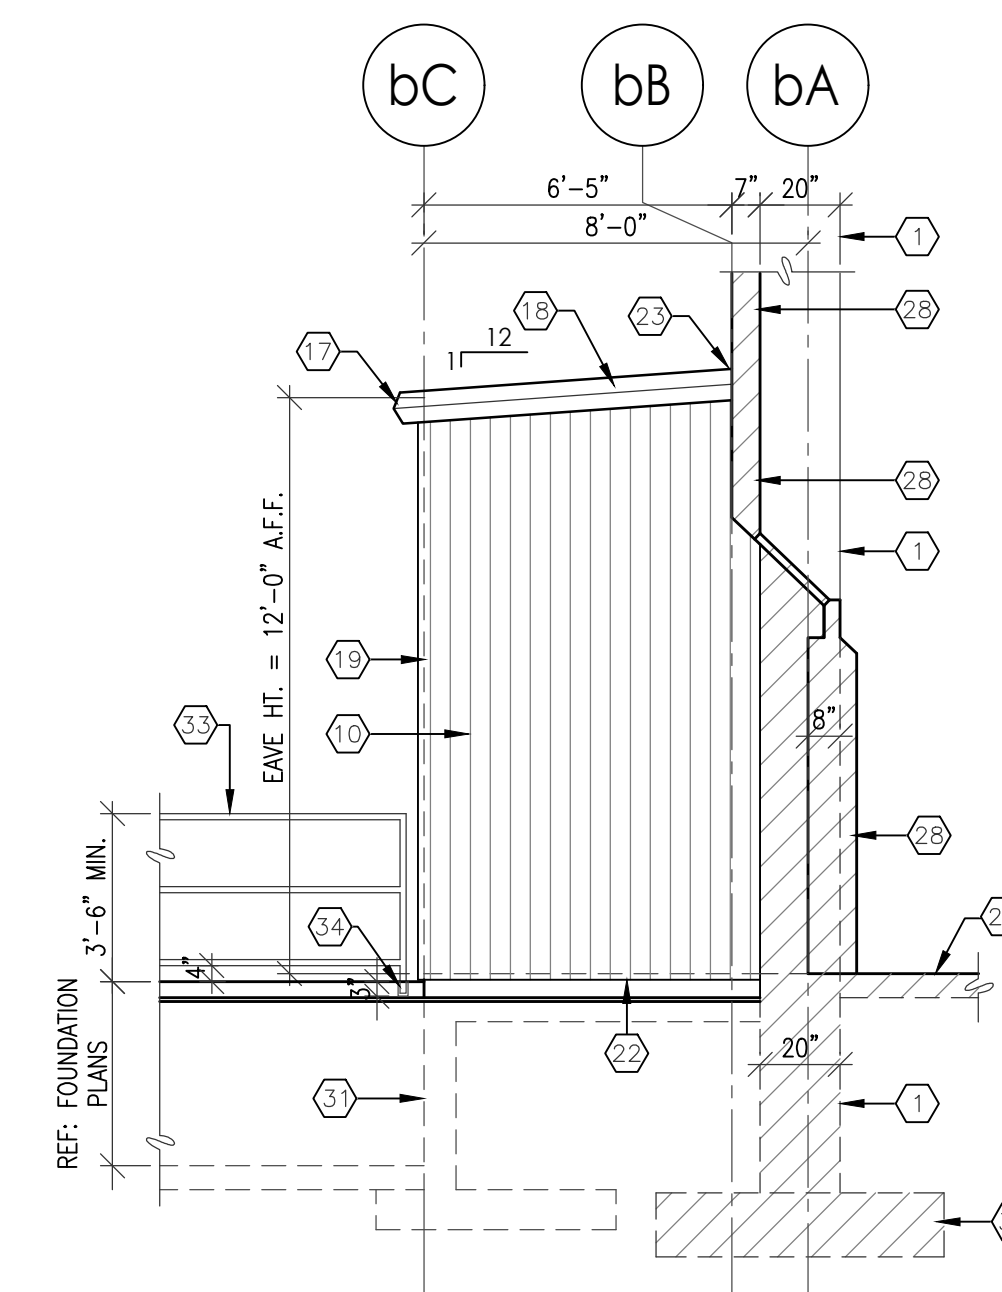

7 SOUTH ELEVATION
SCALE: 1/4"=1'-0"


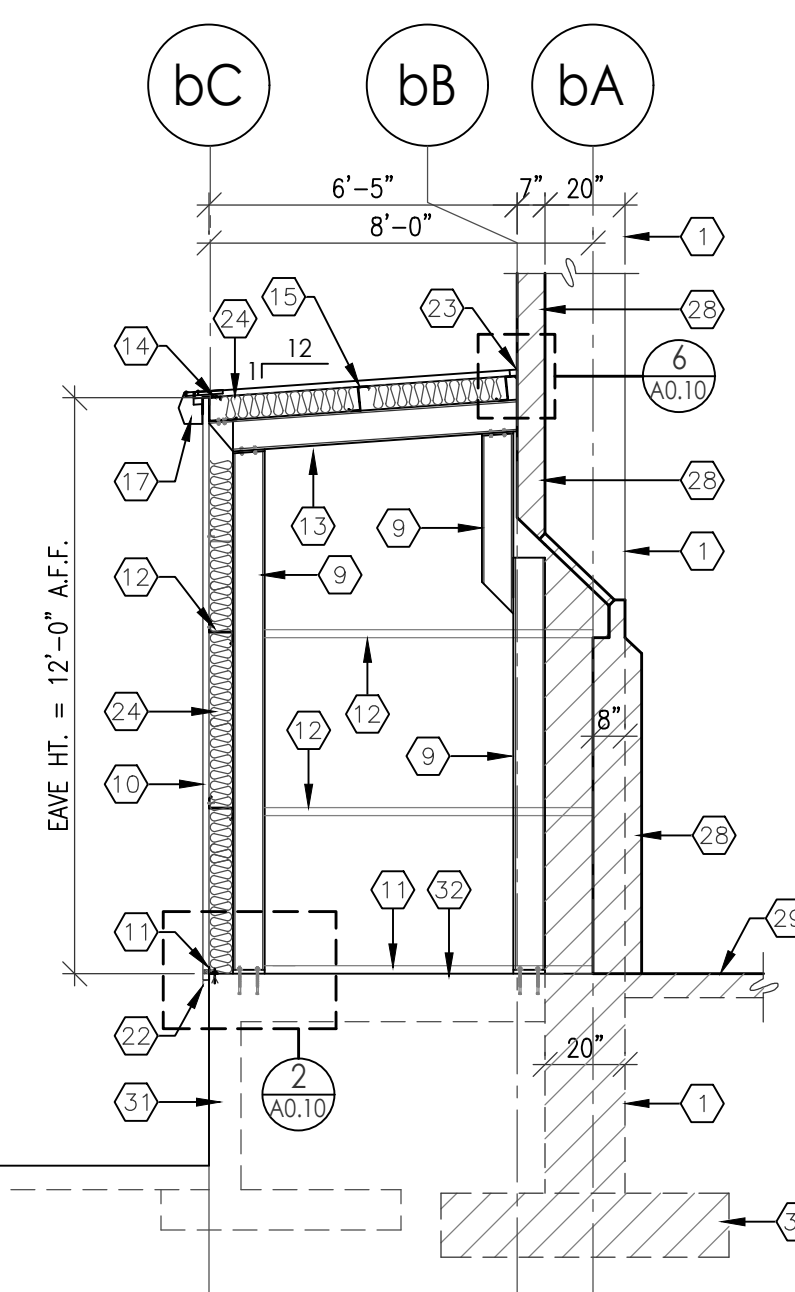


A SECTION
SCALE: 1/4"=1'-0"

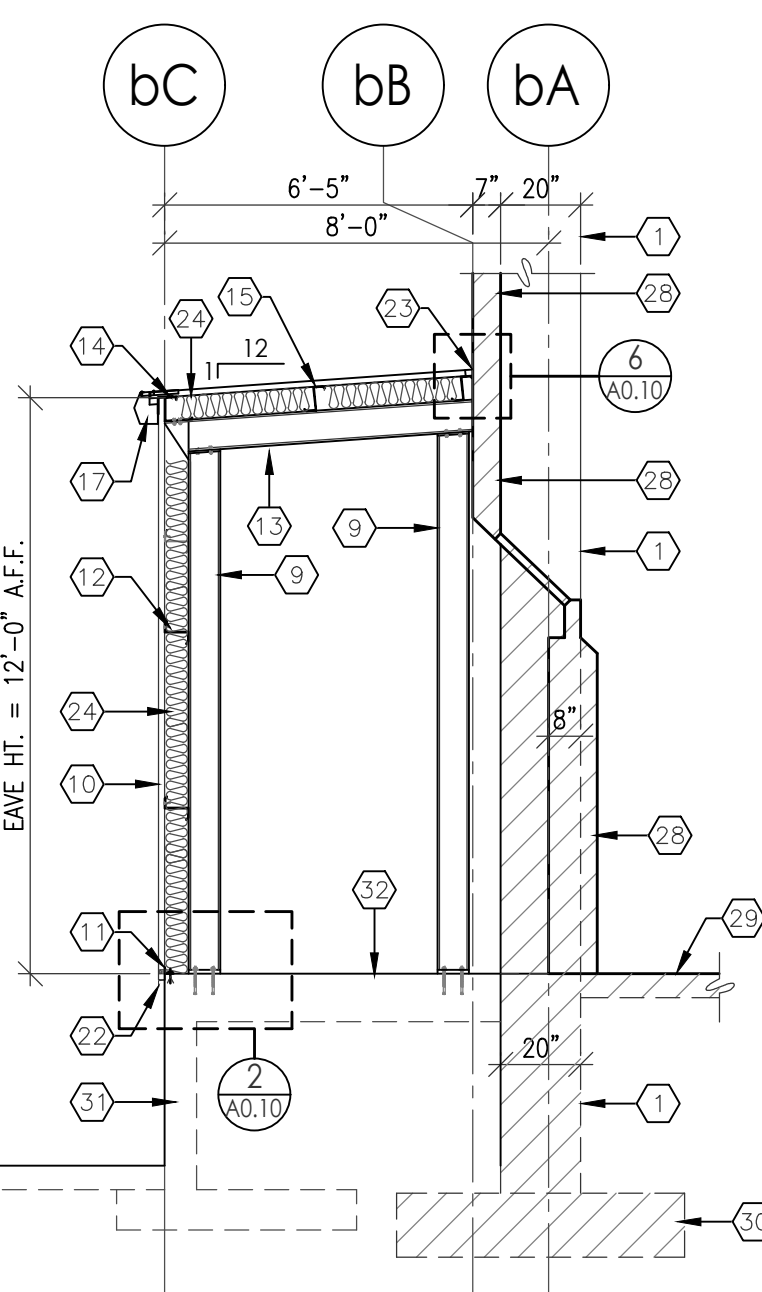


B SECTION
SCALE: 1/4"=1'-0"


- KEYED NOTES**
- EXISTING 20' x 20' CONCRETE COLUMN.
 - EXISTING EXTERIOR WALL.
 - EXISTING WALL TO BE REMOVED.
 - COMBINATION EXIT SIGN AND EMERGENCY LIGHT WITH BATTERY BACK-UP, REF: ELECTRICAL PLANS.
 - EMERGENCY LIGHT WITH BATTERY BACK-UP, REF: ELECTRICAL PLANS.
 - WALL MOUNTED FIRE EXTINGUISHER 2A-10-BC, TYP.
 - DOCK BUMPERS, TYP.
 - 3070 INSULATED METAL DOOR IN HOLLOW METAL FRAME WITH 1/2" MAX. ALUM. THRESHOLD, DOOR WITH PANIC HARDWARE, KEYS LOCKSET, DOOR STOP, WEATHER STRIPPING AND AUTO CLOSURE.
 - W8 x 10 COLUMN, TYP.
 - 26 GA. METAL WALL PANEL, TYP.
 - 14 GA. BASE ANGLE, TYP.
 - 2 1/2" x 6" x 14 GA. ZEE GIRT, TYP.
 - W8 x 10 BEAM, TYP.
 - 6" x 3" EAVE STRUT, TYP.
 - 2 1/2" x 6" x 14 GA. ZEE PURLIN, TYP.
 - 26 GA. FRB ROOF PANEL, TYP.
 - CONT. METAL EAVE GUTTER TRIM AND DOWNSPOUT (DOWNSPOUT NOT SHOWN).
 - CONT. RAKE/GABLE METAL TRIM, TYP.
 - METAL CORNER TRIM, TYP.
 - METAL HEAD TRIM, TYP.
 - METAL JAMB TRIM, TYP.
 - CONT. METAL WALL BASE TRIM, TYP.
 - CONT. METAL WALL FLASHING, TYP.
 - R-20 VINYL FACED INSULATION AT ROOF, FULL COVERAGE AND R-13 VINYL FACED INSULATION AT WALL, FULL HEIGHT OF WALL, TYP.
 - 6" x 12 GA. CEE JAMB, TYP.
 - R-13 VINYL FACED INSULATION, FULL HEIGHT OF WALL, TYP.
 - 6" x 14 GA. CEE HEADER, TYP.
 - NEW DEMISING WALL, REF: OVERALL FLOOR PLAN FOR WALL CONTINUATION AND WALL TYPE TAG.
 - CROSS HATCH DENOTES EXIST. EXTERIOR WALL.
 - EXIST. CONC. SLAB, TYP.
 - EXIST. CONC. COLUMN FOOTING, TYP.
 - NEW CONC. DOCK WALL, REF: FOUNDATION PLANS.
 - NEW CONC. SLAB AT NEW DOCK, REF: FOUNDATION PLANS.
 - 42" HIGH MIN. 1 1/4" DIA. PAINTED STEEL GUARDRAIL, G.C. TO INSTALL GUARDRAIL PER 2021 I.B.C. SECTION 1015.2. GUARDS SHALL BE LOCATED ALONG OPEN-SIDED WALKING SURFACES THAT ARE LOCATED MORE THAN 30 INCHES MEASURED VERTICALLY TO THE FLOOR OR GRADE BELOW, G.C. TO FIELD VERIFY GUARDRAIL LENGTH TO BE BUILT.
 - CORE DRILL CONC. RETAINING WALL FOR GUARDRAIL POST AND EPOXY POST IN PLACE, TYP. GUARDRAIL POSTS AT 8'-0" O.C. MAX.
 - 4" THICK x 5' x 5' CONCRETE STOOP AT EXIT DOOR, SLOPE CONC. 1/4"/FT. SLOPE MIN. AWAY FOR DOOR.

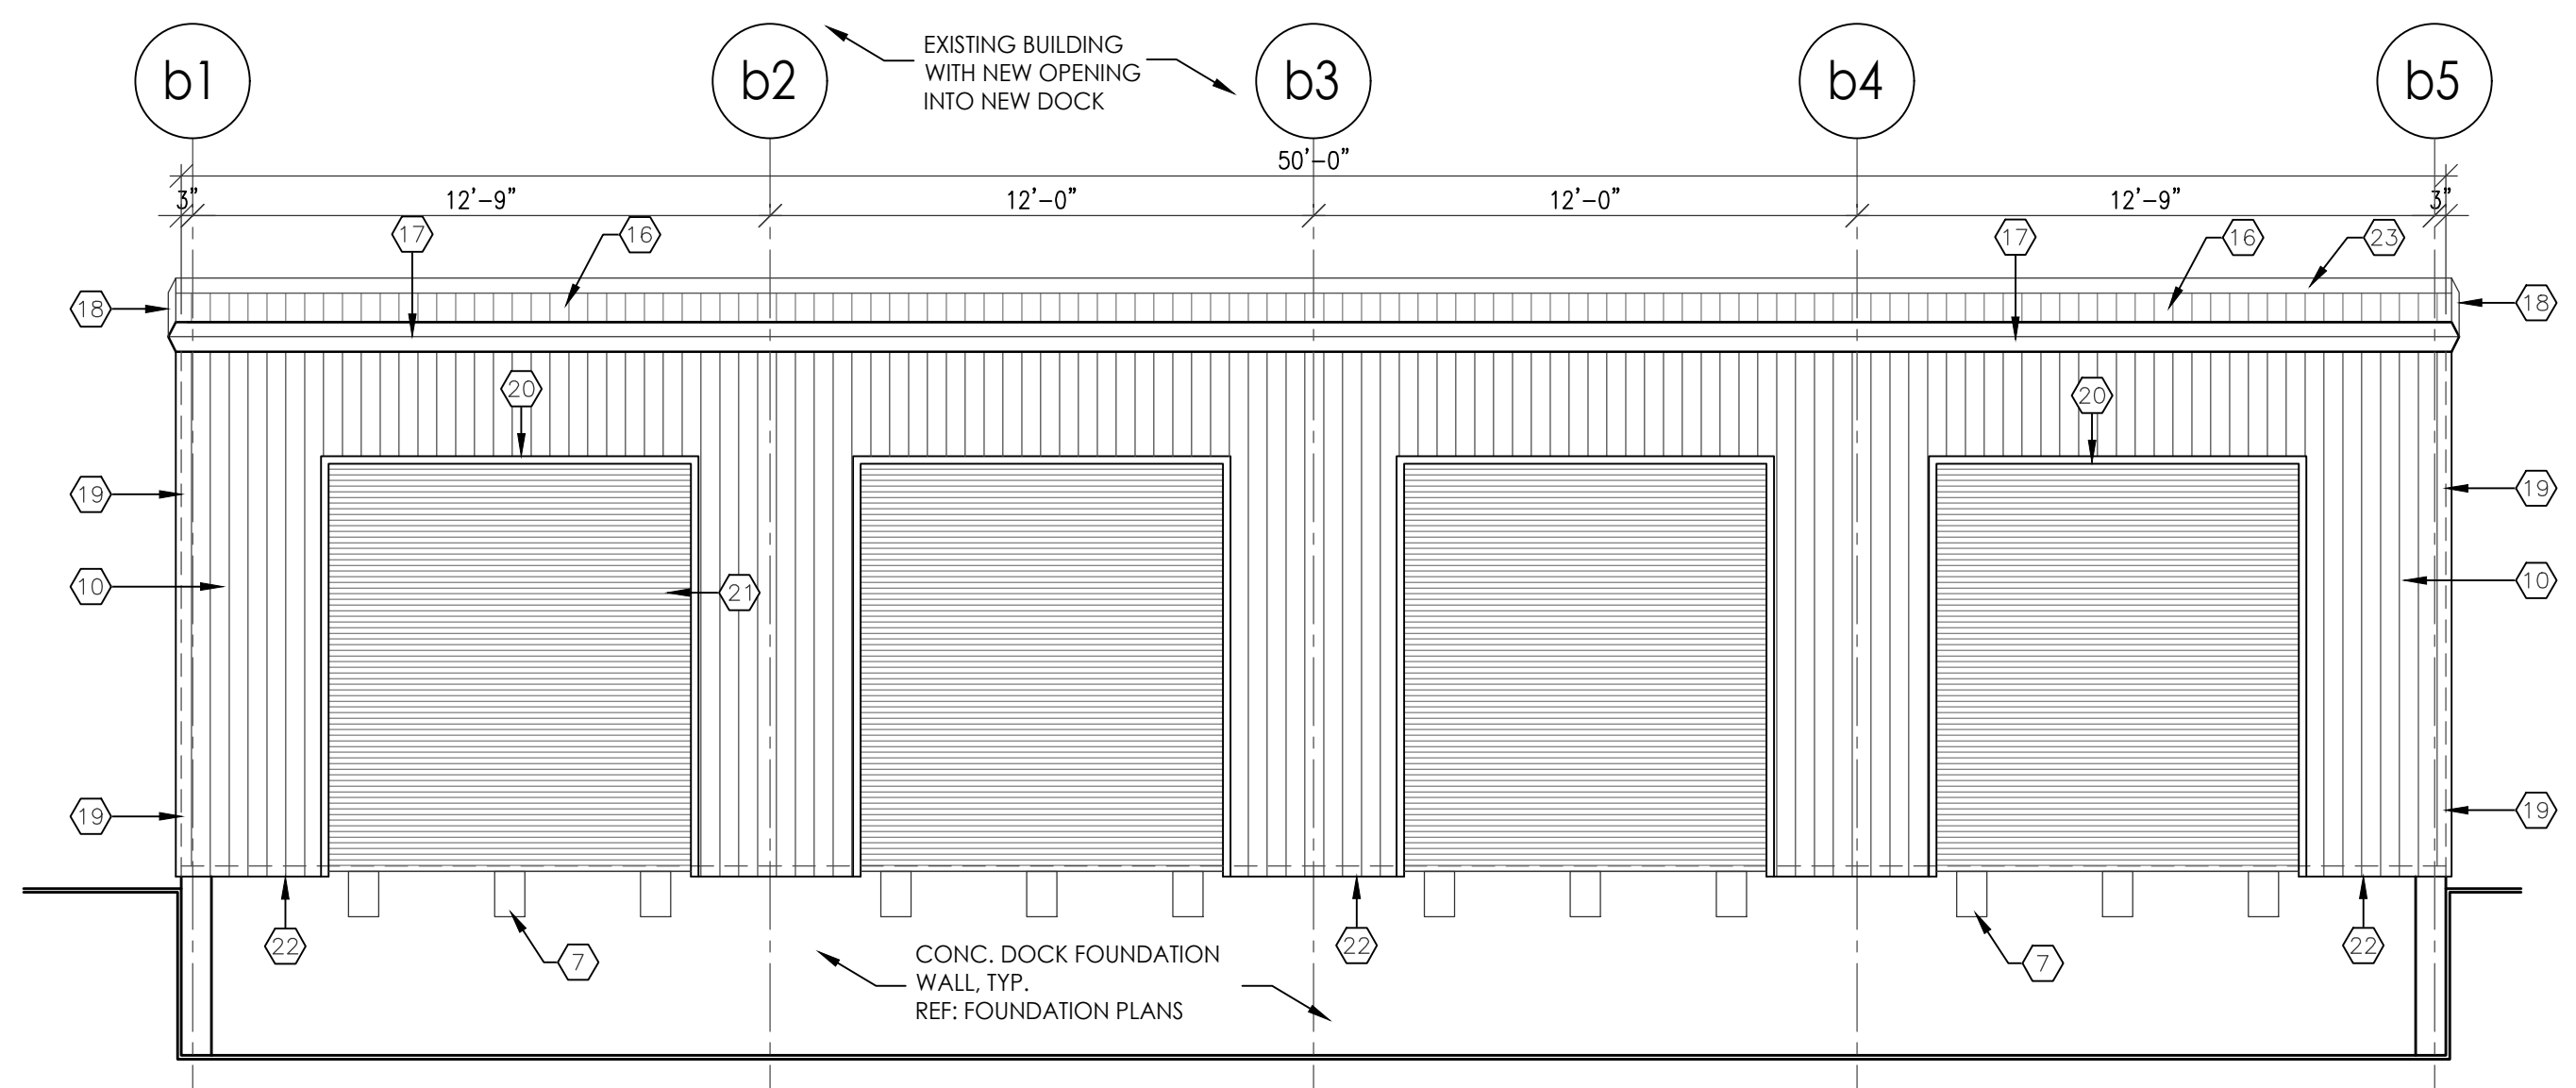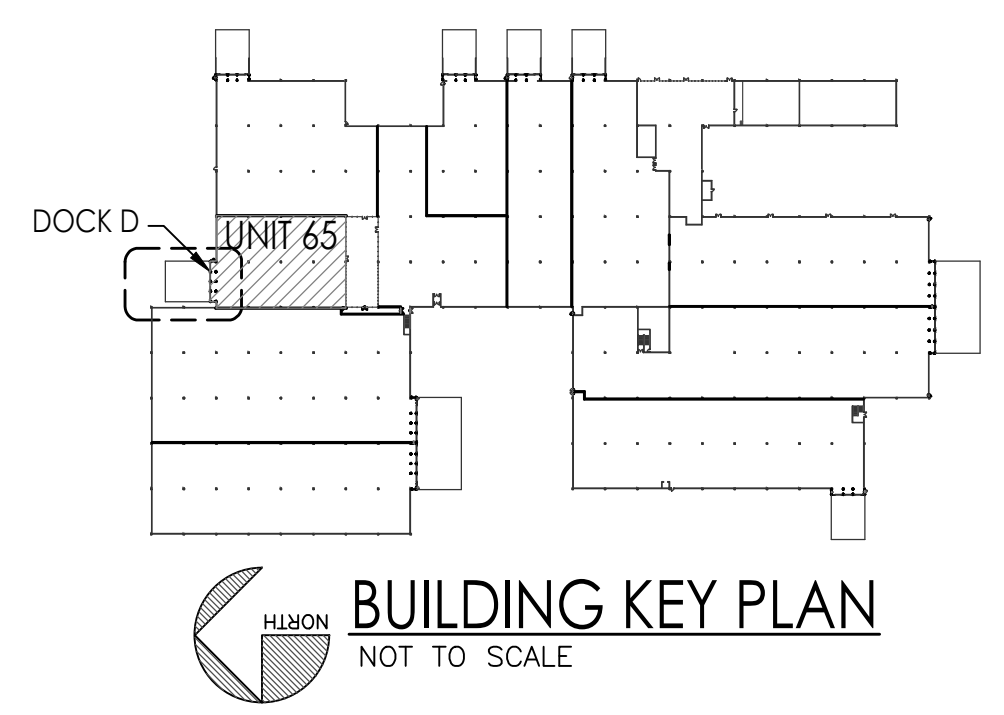


5 DOCK B NORTH ELEVATION
SCALE: 1/4"=1'-0"

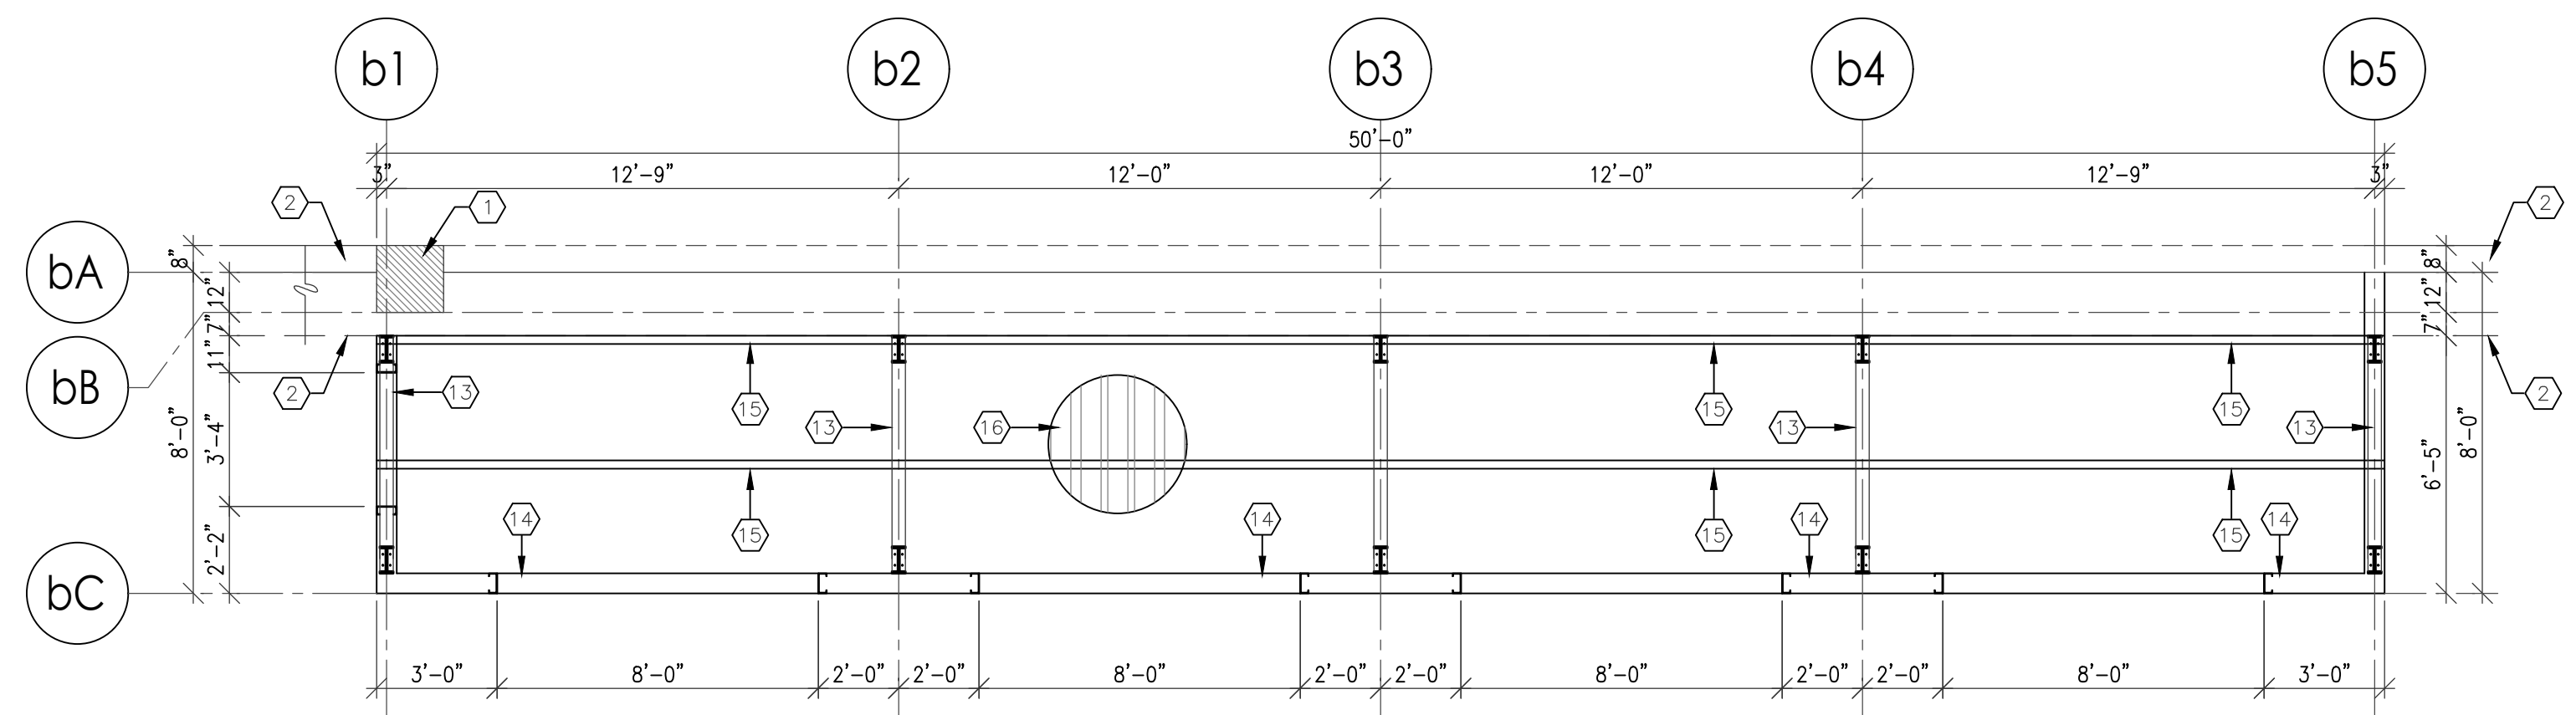


3 DOCK B ROOF FRAME PLAN
SCALE: 1/4"=1'-0"

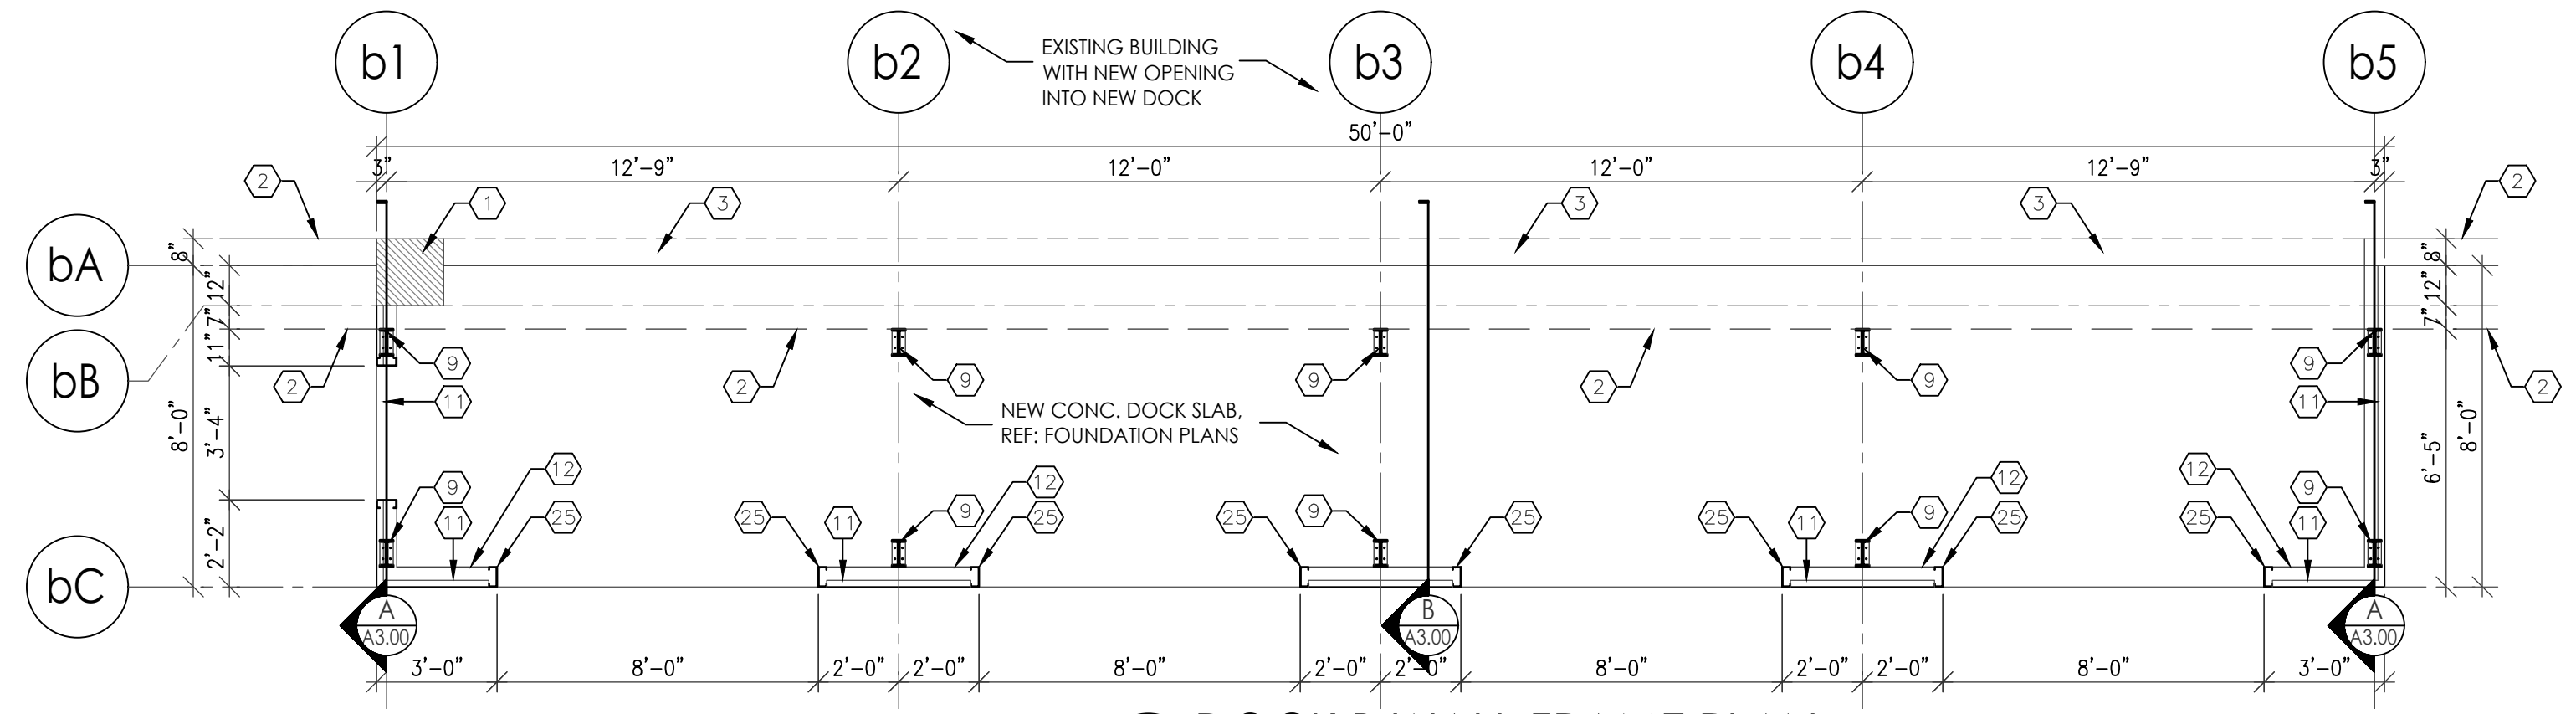

2 DOCK B WALL FRAME PLAN
SCALE: 1/4"=1'-0"

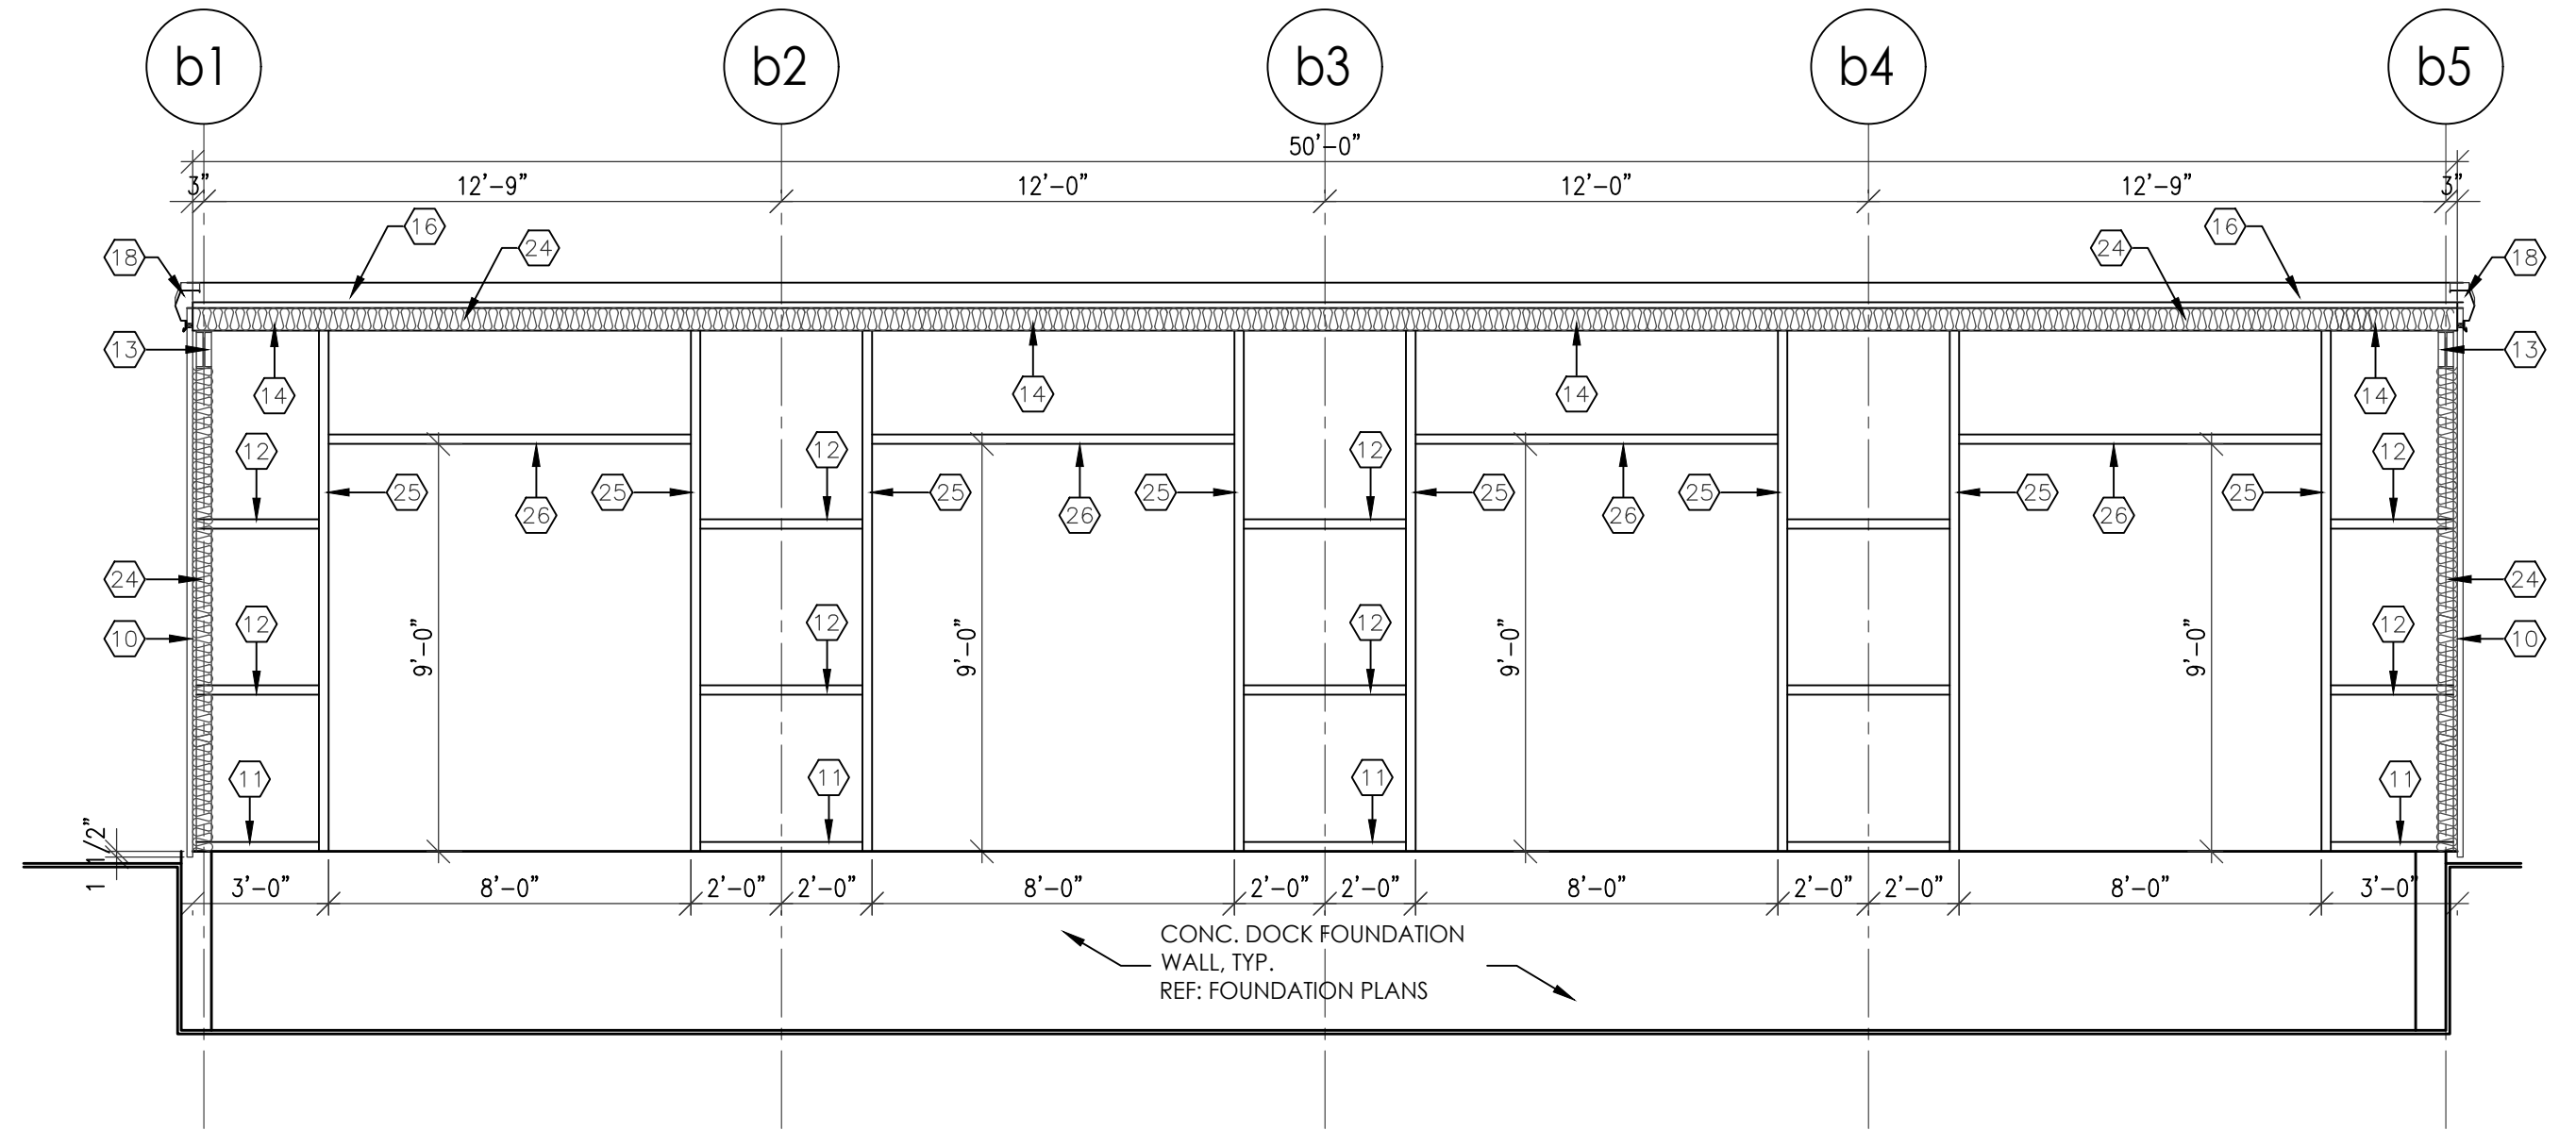

4 DOCK B WALL FRAME ELEVATION
SCALE: 1/4"=1'-0"

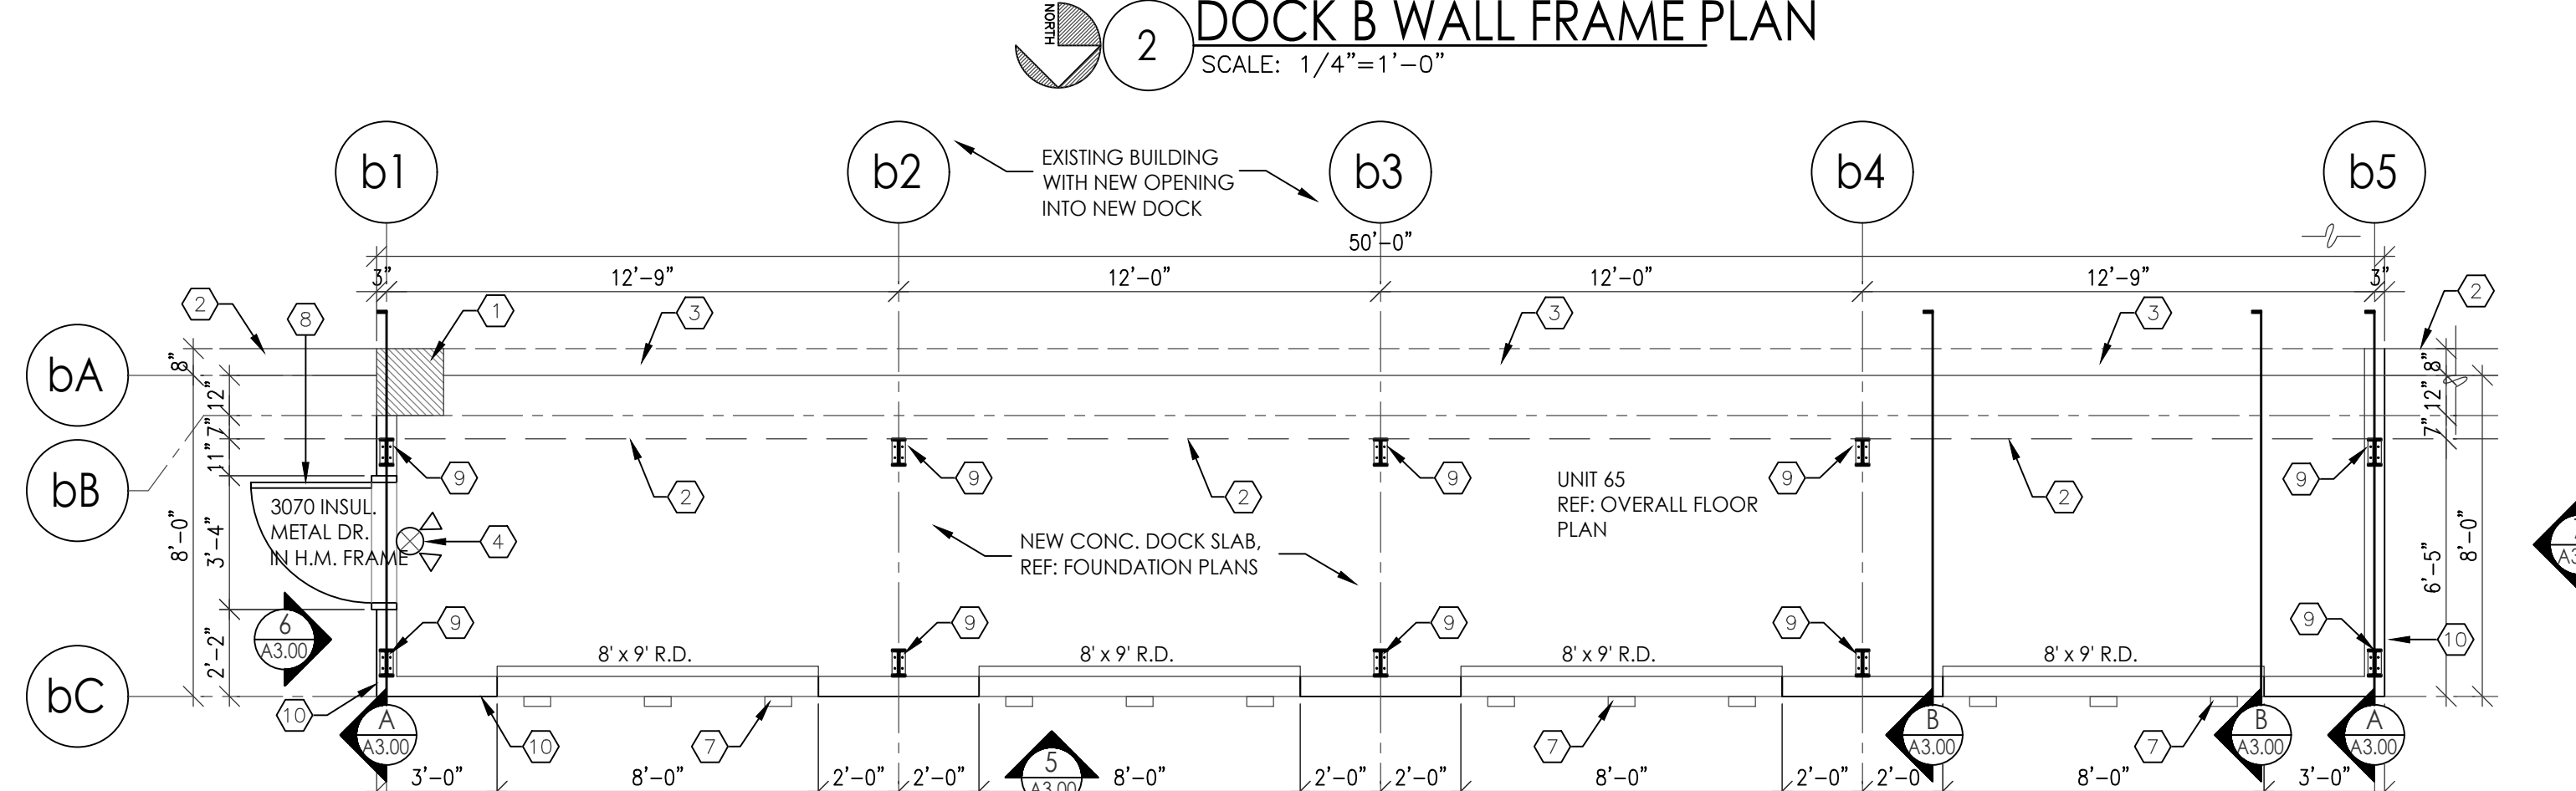


1 DOCK B FLOOR PLAN
SCALE: 1/4"=1'-0"

NEW DOCK B ADDITION
AREA = 396 S.F.

HONEYWELL WAREHOUSES
DOCK B ARCH AND STRUCTURAL PLANS
9201 SAN MATEO BLVD NE.
ALBUQUERQUE, NM 87113
#2354


REVISION DATE
DATE 3/22/2024
SHEET NUMBER A-3.00

RBA ARCHITECTURE, PC
ARCHITECTURE
PLANNING
DESIGN



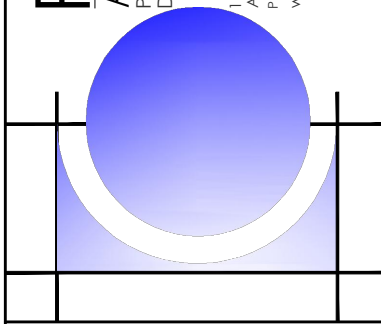


DATE
3/22/2024

SHEET NUMBER
A-3.00

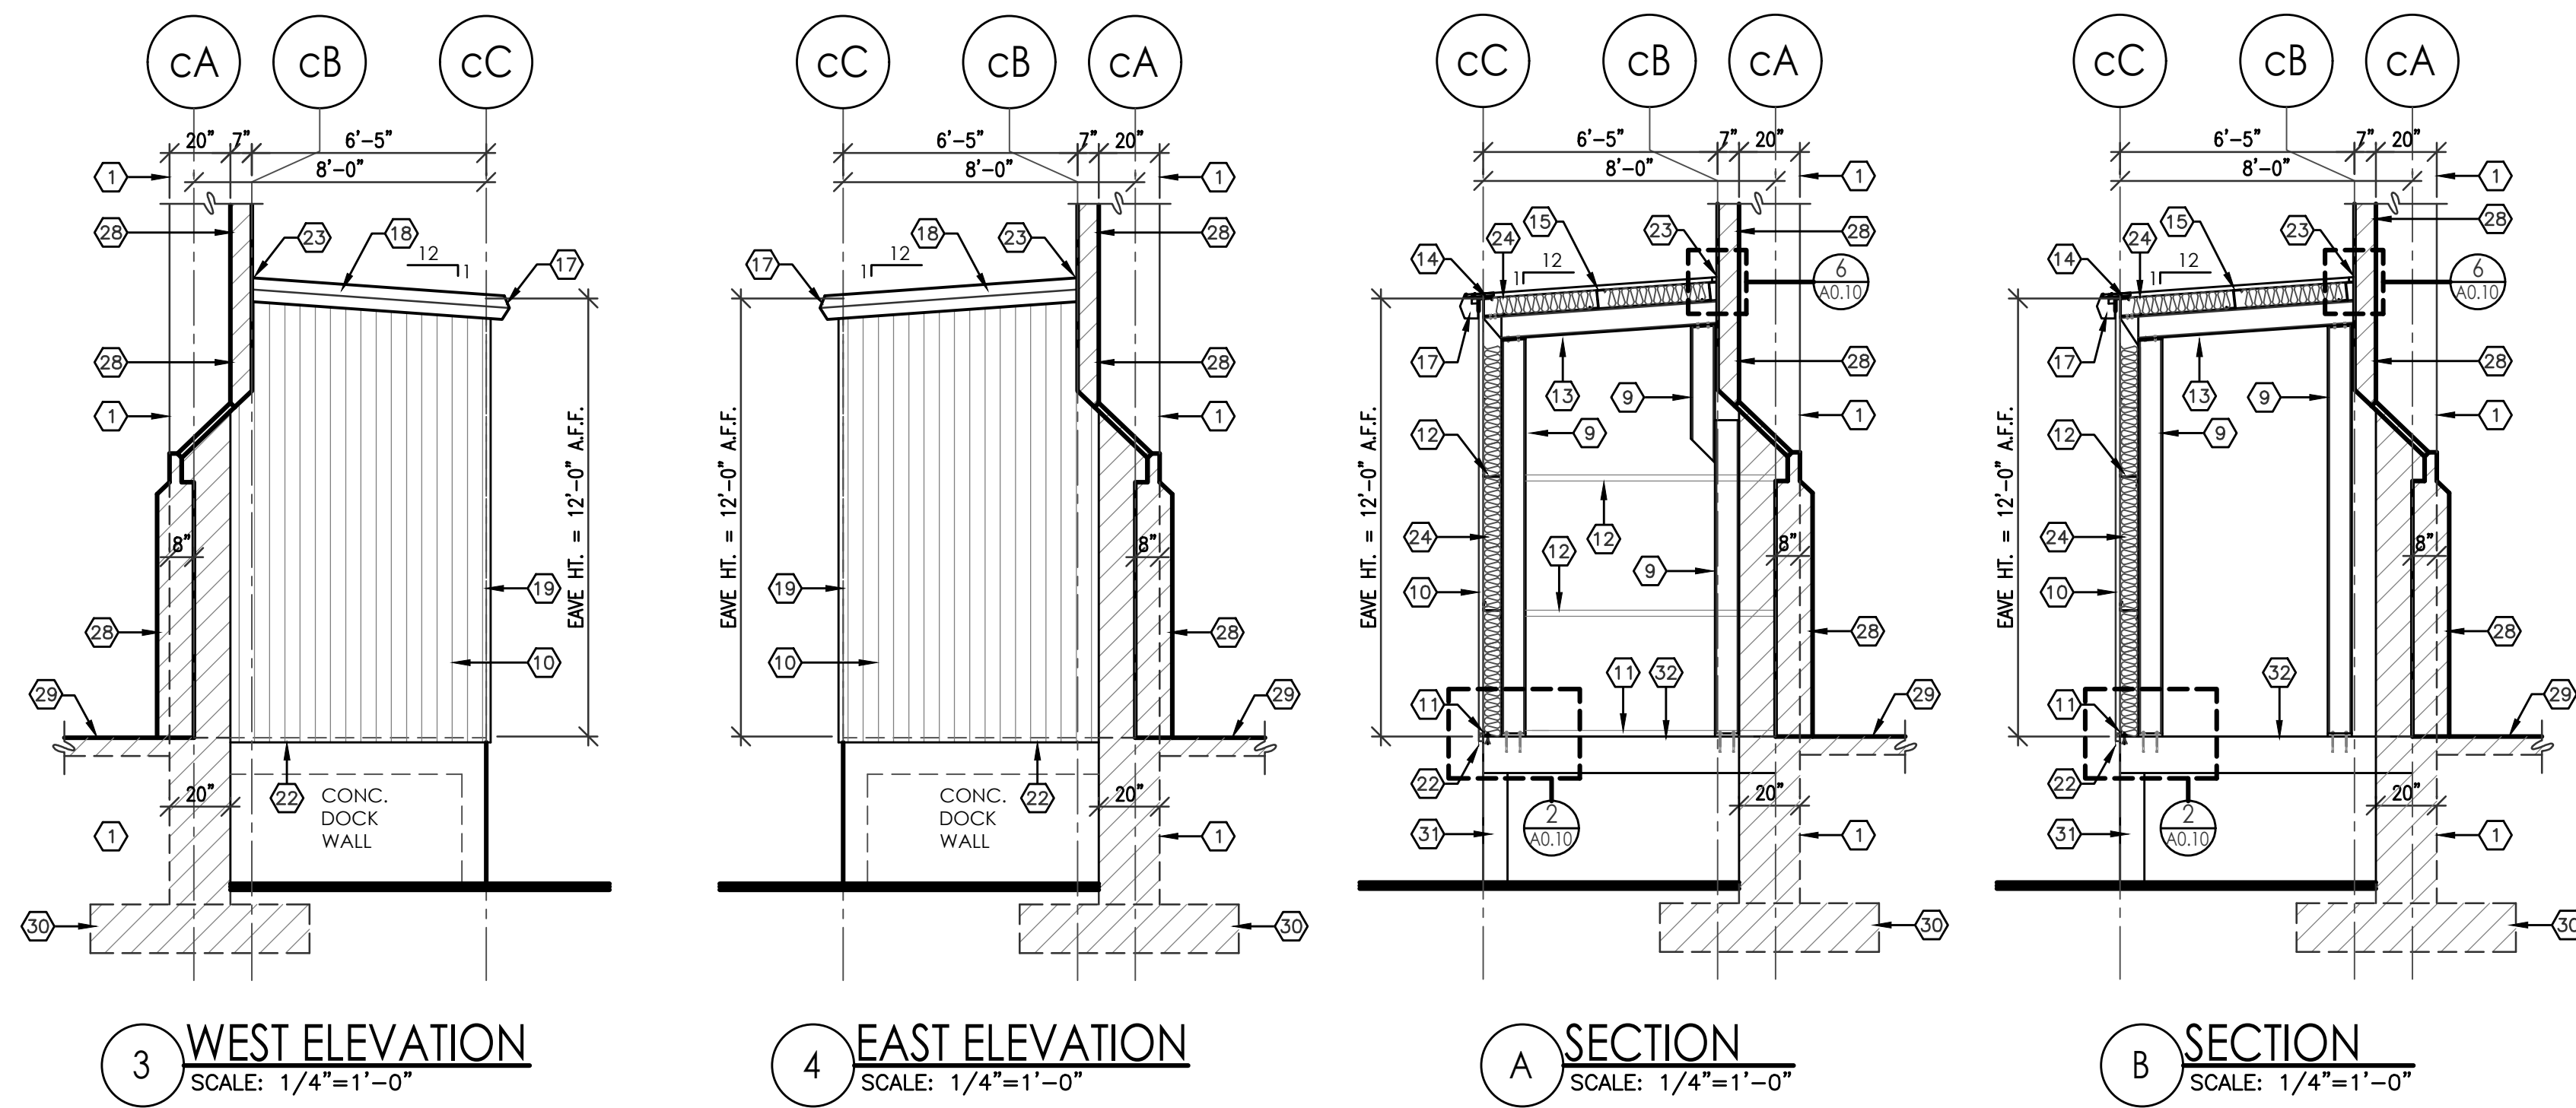


- KEYED NOTES**
- EXISTING 20' x 20' CONCRETE COLUMN.
 - EXISTING EXTERIOR WALL.
 - EXISTING WALL TO BE REMOVED.
 - COMBINATION EXIT SIGN AND EMERGENCY LIGHT WITH BATTERY BACK-UP, REF: ELECTRICAL PLANS.
 - EMERGENCY LIGHT WITH BATTERY BACK-UP, REF: ELECTRICAL PLANS.
 - WALL MOUNTED FIRE EXTINGUISHER 2A-10-BC, TYP.
 - DOCK BUMPERS, TYP.
 - 3070 INSULATED METAL DOOR IN HOLLOW METAL FRAME WITH 1/2" MAX. ALUM. THRESHOLD, DOOR WITH PANIC HARDWARE, KEYED LOCKSET, DOOR STOP, WEATHER STRIPPING AND AUTO CLOSURE.
 - W8 x 10 COLUMN, TYP.
 - 26 GA. METAL WALL PANEL, TYP.
 - 14 GA. BASE ANGLE, TYP.
 - 2 1/2" x 6" x 1/4 GA. ZEE GIRL, TYP.
 - W8 x 10 BEAM, TYP.
 - 5' x 3' EAVE STRUT, TYP.
 - 2 1/2" x 6" x 1/4 GA. ZEE PURLIN, TYP.
 - 26 GA. PRB ROOF PANEL, TYP.
 - CONT. METAL EAVE GUTTER TRIM AND DOWNSPOUT (DOWNSPOUT NOT SHOWN).
 - CONT. RAKE/GABLE METAL TRIM, TYP.
 - METAL CORNER TRIM, TYP.
 - METAL HEAD TRIM, TYP.
 - METAL JAMB TRIM, TYP.
 - CONT. METAL WALL BASE TRIM, TYP.
 - CONT. METAL WALL BASE FLASHING, TYP.
 - R-20 VINYL FACED INSULATION AT ROOF, FULL COVERAGE AND R-13 VINYL FACED INSULATION AT WALL, FULL HEIGHT OF WALL, TYP.
 - 6' x 12 GA. CEE JAMB, TYP.
 - 5' x 14 GA. CEE HEADER, TYP.
 - NEW DEMISING WALL, REF: OVERALL FLOOR PLAN FOR WALL CONTINUATION AND WALL TYPE TAG.
 - CROSS HATCH DENOTES EXIST. EXTERIOR WALL.
 - EXIST. CONC. SLAB, TYP.
 - EXIST. CONC. COLUMN FOOTING, TYP.
 - NEW CONC. DOCK WALL, REF: FOUNDATION PLANS.
 - NEW CONC. SLAB AT NEW DOCK, REF: FOUNDATION PLANS.
 - 42" HIGH MIN. 1 1/4" DIA. PAINTED STEEL GUARDRAIL, G.C. TO INSTALL GUARDRAIL PER 2021 I.B.C. SECTION 1015.2. GUARDS SHALL BE LOCATED ALONG OPEN-SIDED WALKING SURFACES THAT ARE LOCATED MORE THAN 30 INCHES MEASURED VERTICALLY TO THE FLOOR OR GRADE BELOW. G.C. TO FIELD VERIFY GUARDRAIL LENGTH TO BE BUILT.
 - CORE DRILL CONC. RETAINING WALL FOR GUARDRAIL POST AND EPOXY POST IN PLACE, TYP.; GUARDRAIL POSTS AT 8'-0" O.C. MAX.
 - 4" THICK x 5' x 5' CONCRETE STOOP AT EXIT DOOR. SLOPE CONC. 1/4"/FT. SLOPE MIN. AWAY FOR DOOR.

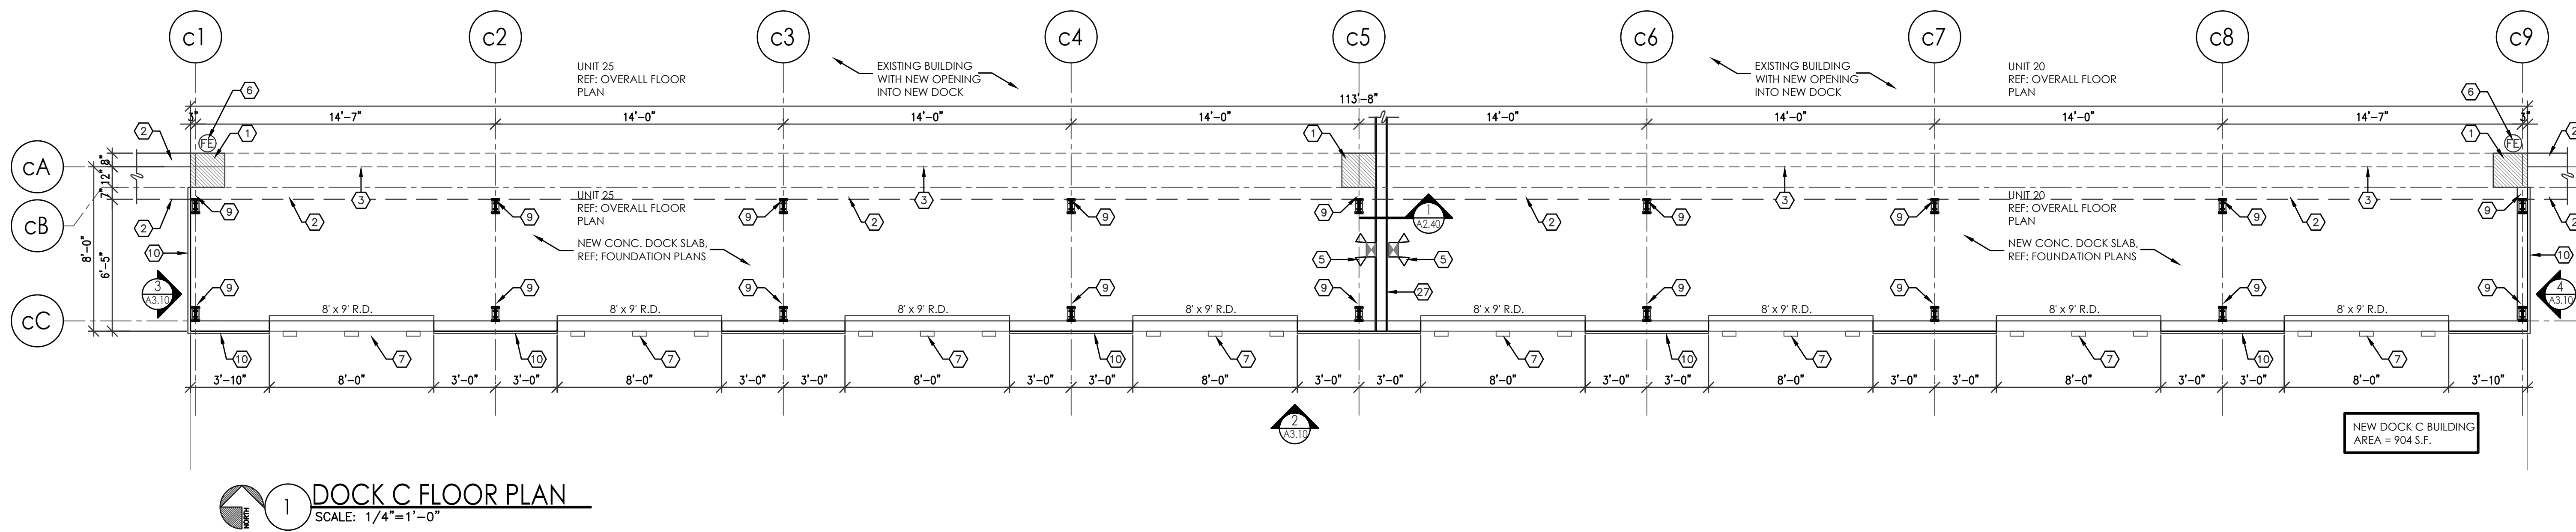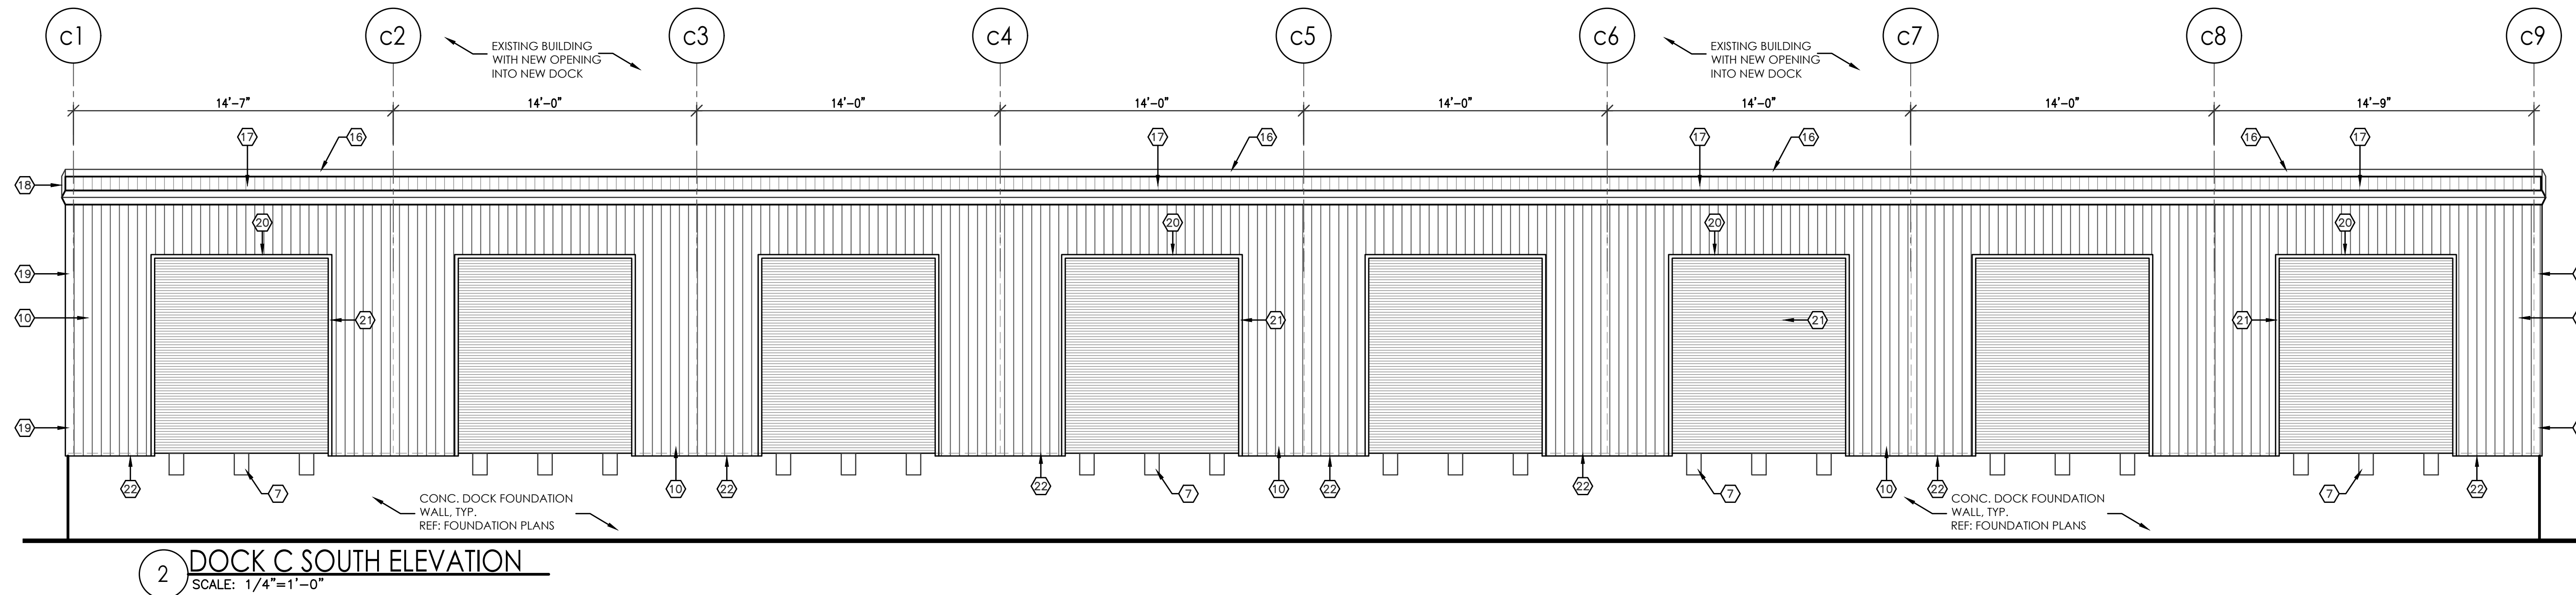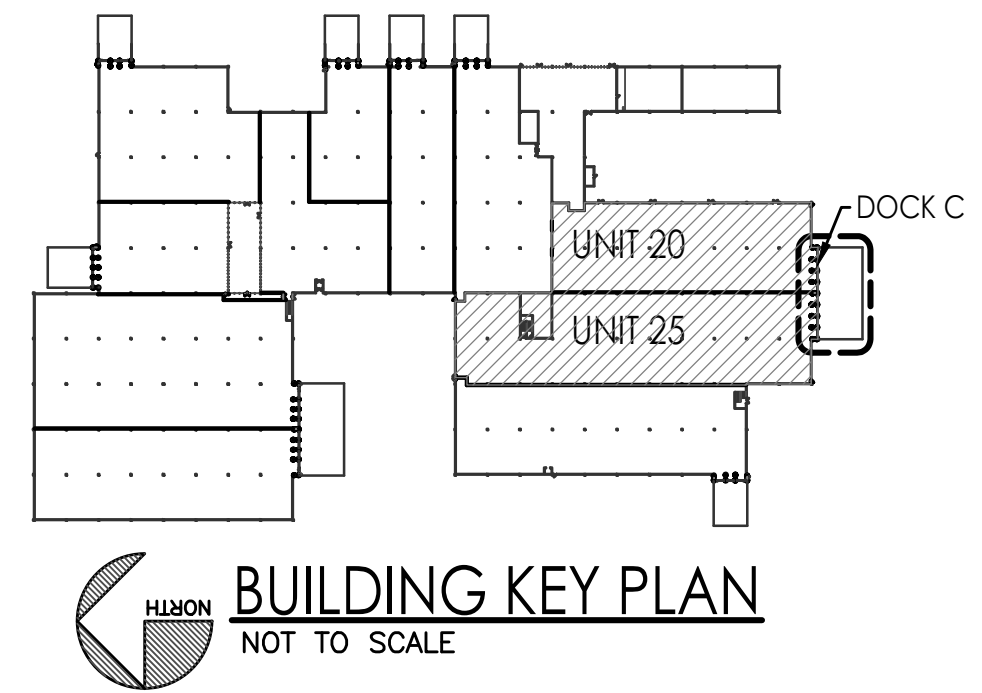


HONEYWELL WAREHOUSES
DOCK C, METAL STRUCTURE PLAN
9201 SAN MATEO BLVD NE.
ALBUQUERQUE, NM 87113
#2354


REVISION DATE
RBA ARCHITECTURE, P.C. ARCHITECTURE, PLANNING, DESIGN 1000 UNIVERSITY BLVD. NE ALBUQUERQUE, NM 87102 WWW.RBAARCH.COM
DATE 3/22/2024
SHEET NUMBER A-3.10

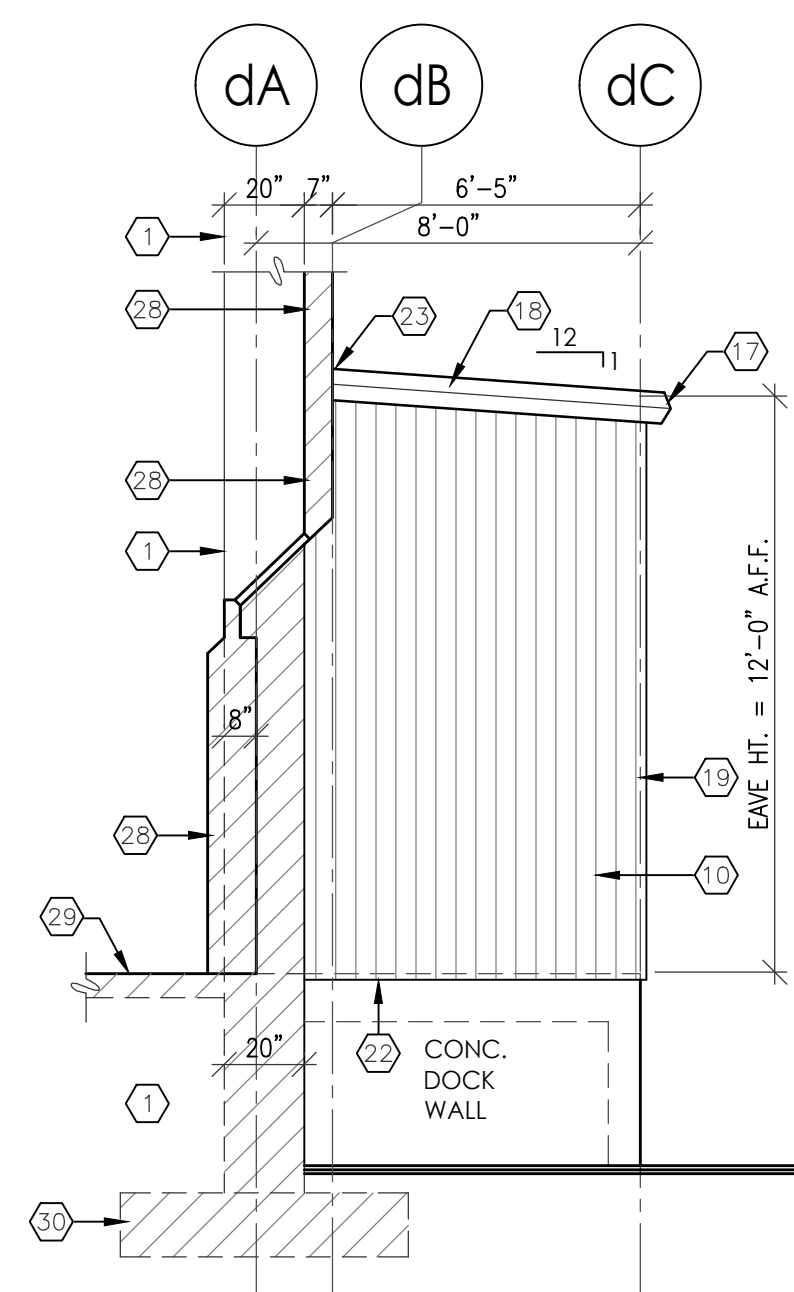


6 NORTH ELEVATION
SCALE: 1/4"=1'-0"

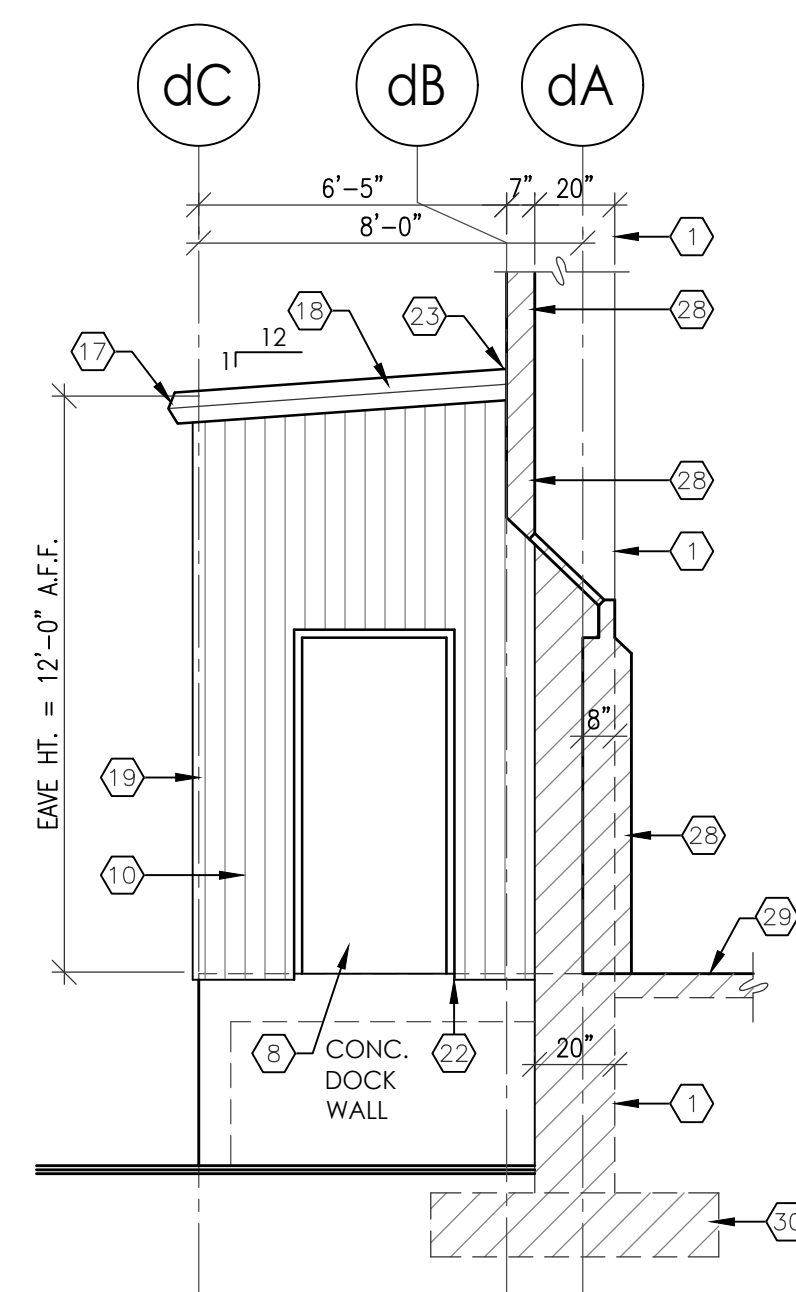

7 SOUTH ELEVATION
SCALE: 1/4"=1'-0"

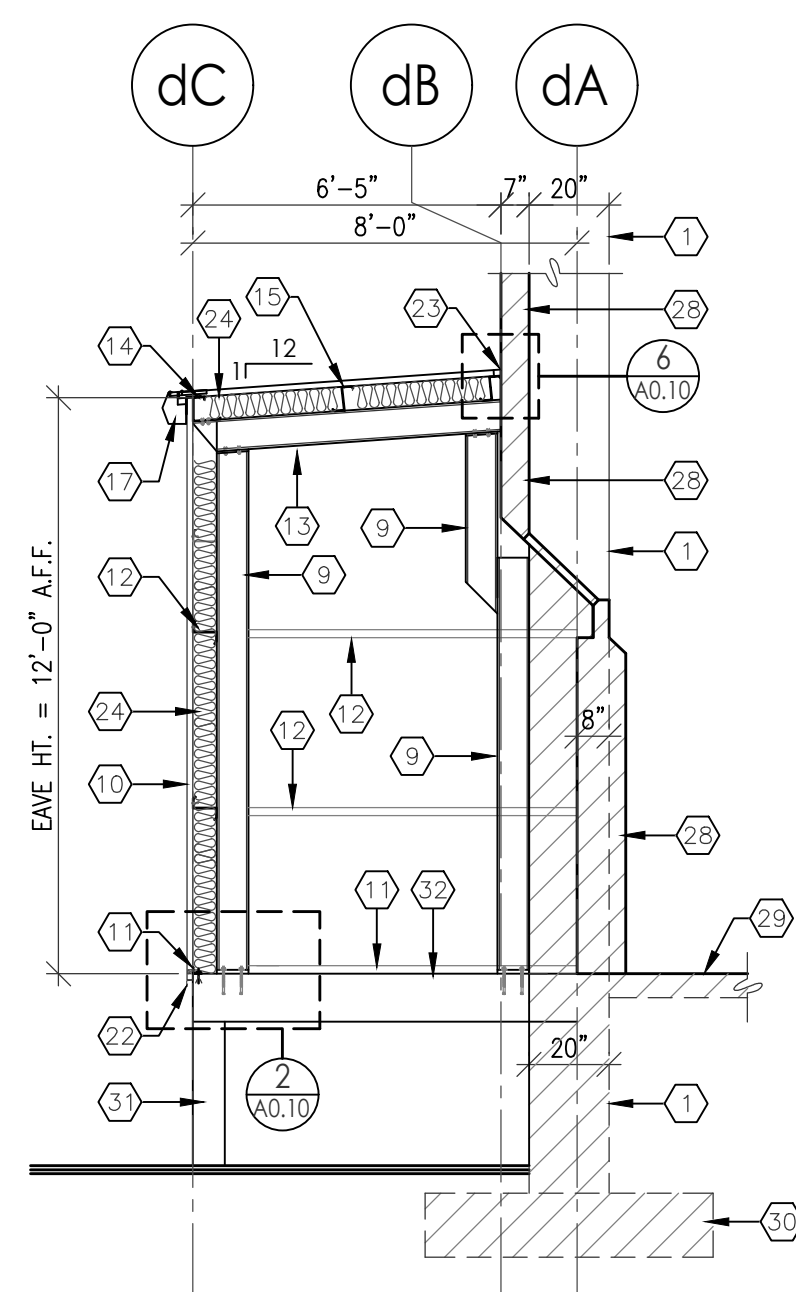


A SECTION
SCALE: 1/4"=1'-0"

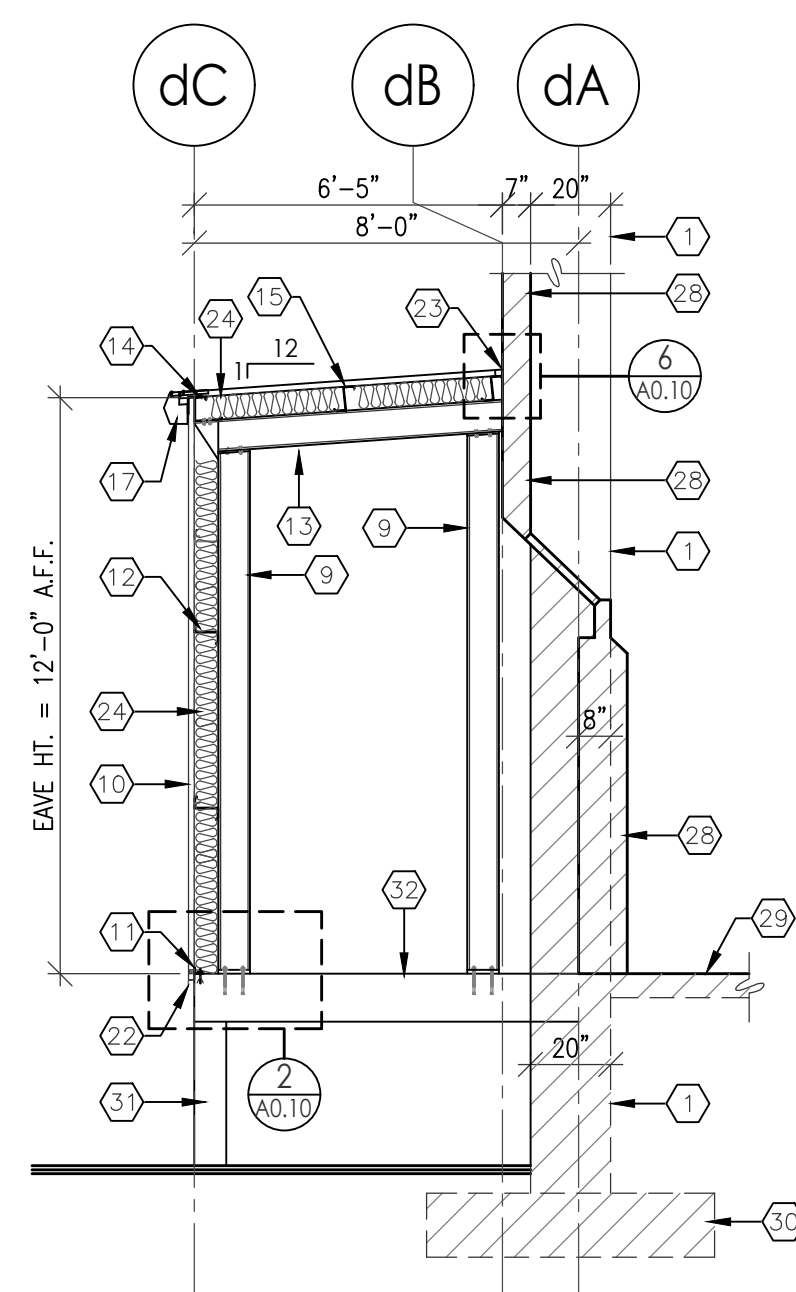


B SECTION
SCALE: 1/4"=1'-0"


- KEYED NOTES**
- EXISTING 20" x 20" CONCRETE COLUMN.
 - EXISTING EXTERIOR WALL.
 - EXISTING WALL TO BE REMOVED.
 - COMBINATION EXIT SIGN AND EMERGENCY LIGHT WITH BATTERY BACK-UP. REF: ELECTRICAL PLANS.
 - EMERGENCY LIGHT WITH BATTERY BACK-UP. REF: ELECTRICAL PLANS.
 - WALL MOUNTED FIRE EXTINGUISHER 2A-10-8C, TYP.
 - DOCK BUMPERS, TYP.
 - 3070 INSULATED METAL DOOR IN HOLLOW METAL FRAME WITH 1/2" MAX. ALUM. THRESHOLD, DOOR WITH PANIC HARDWARE, KEYS LOCKSET, DOOR STOP, WEATHER STRIPPING AND AUTO CLOSURE.
 - W8 x 10 COLUMN, TYP.
 - 24 GA. METAL WALL PANEL, TYP.
 - 14 GA. BASE ANGLE, TYP.
 - 2 1/2" x 6" x 1/4 GA. ZEE GIRT, TYP.
 - W8 x 10 BEAM, TYP.
 - 6" x 3" EAVE STRUT, TYP.
 - 2 1/2" x 6" x 1/4 GA. ZEE PURLIN, TYP.
 - 24 GA. FRB ROOF PANEL, TYP.
 - CONT. METAL EAVE GUTTER TRIM AND DOWNSPOUT (DOWNSPOUT NOT SHOWN).
 - CONT. RAKE/GABLE METAL TRIM, TYP.
 - METAL CORNER TRIM, TYP.
 - METAL HEAD TRIM, TYP.
 - METAL JAMB TRIM, TYP.
 - CONT. METAL WALL BASE TRIM, TYP.
 - CONT. METAL WALL BASE FLASHING, TYP.
 - R-20 VINYL FACED INSULATION AT ROOF, FULL COVERAGE AND R-13 VINYL FACED INSULATION AT WALL, FULL HEIGHT OF WALL, TYP.
 - 6" x 12 GA. CEE JAMB, TYP.
 - R-13 VINYL FACED INSULATION, FULL HEIGHT OF WALL, TYP.
 - 6" x 14 GA. CEE HEADER, TYP.
 - NEW DEMISING WALL, REF: OVERALL FLOOR PLAN FOR WALL CONTINUATION AND WALL TYPE TAG.
 - CROSS HATCH DENOTES EXIST. EXTERIOR WALL.
 - EXIST. CONC. SLAB, TYP.
 - EXIST. CONC. COLUMN FOOTING, TYP.
 - NEW CONC. DOCK WALL, REF: FOUNDATION PLANS.
 - NEW CONC. SLAB AT NEW DOCK, REF: FOUNDATION PLANS.
 - 42" HIGH MIN. 1 1/4" DIA. PAINTED STEEL GUARDRAIL, G.C. TO INSTALL GUARDRAIL PER 2021 I.B.C. SECTION 1015.2. GUARDS SHALL BE LOCATED ALONG OPEN SIDED WALKING SURFACES THAT ARE LOCATED MORE THAN 30 INCHES MEASURED VERTICALLY TO THE FLOOR OR GRADE BELOW, G.C. TO FIELD VERIFY GUARDRAIL LENGTH TO BE BUILT.
 - CORE DRILL CONC. RETAINING WALL FOR GUARDRAIL POST AND EPOXY POST IN PLACE, TYP. GUARDRAIL POSTS AT 8'-0" O.C. MAX.
 - 4" THICK x 5' x 5' CONCRETE STOOP AT EXIT DOOR, SLOPE CONC. 1/4"/FT. SLOPE MIN. AWAY FOR DOOR.

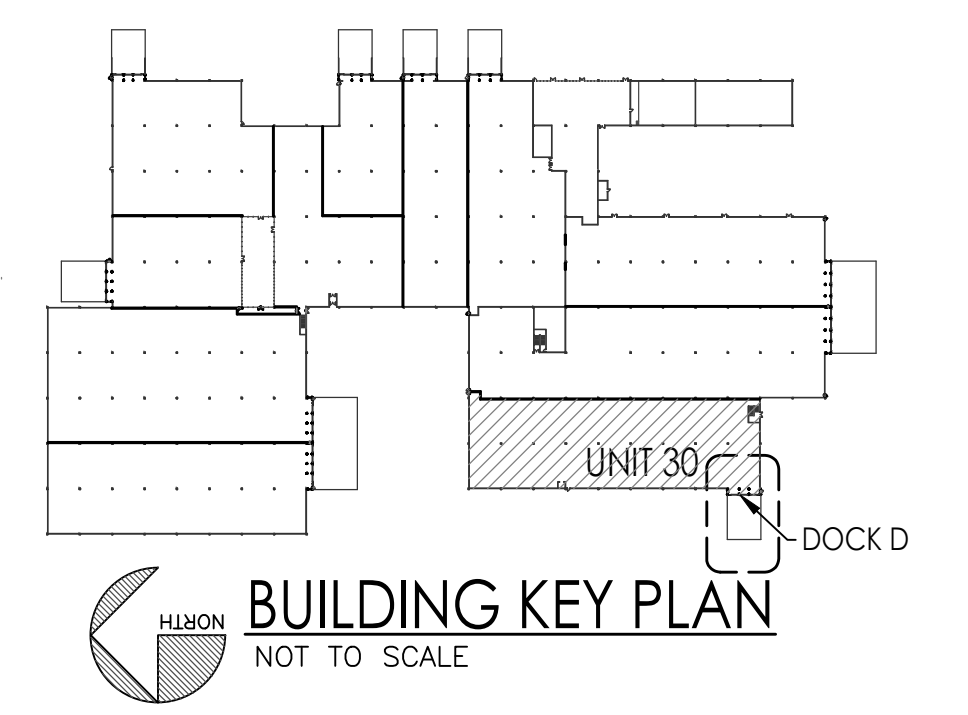


BUILDING KEY PLAN
NOT TO SCALE

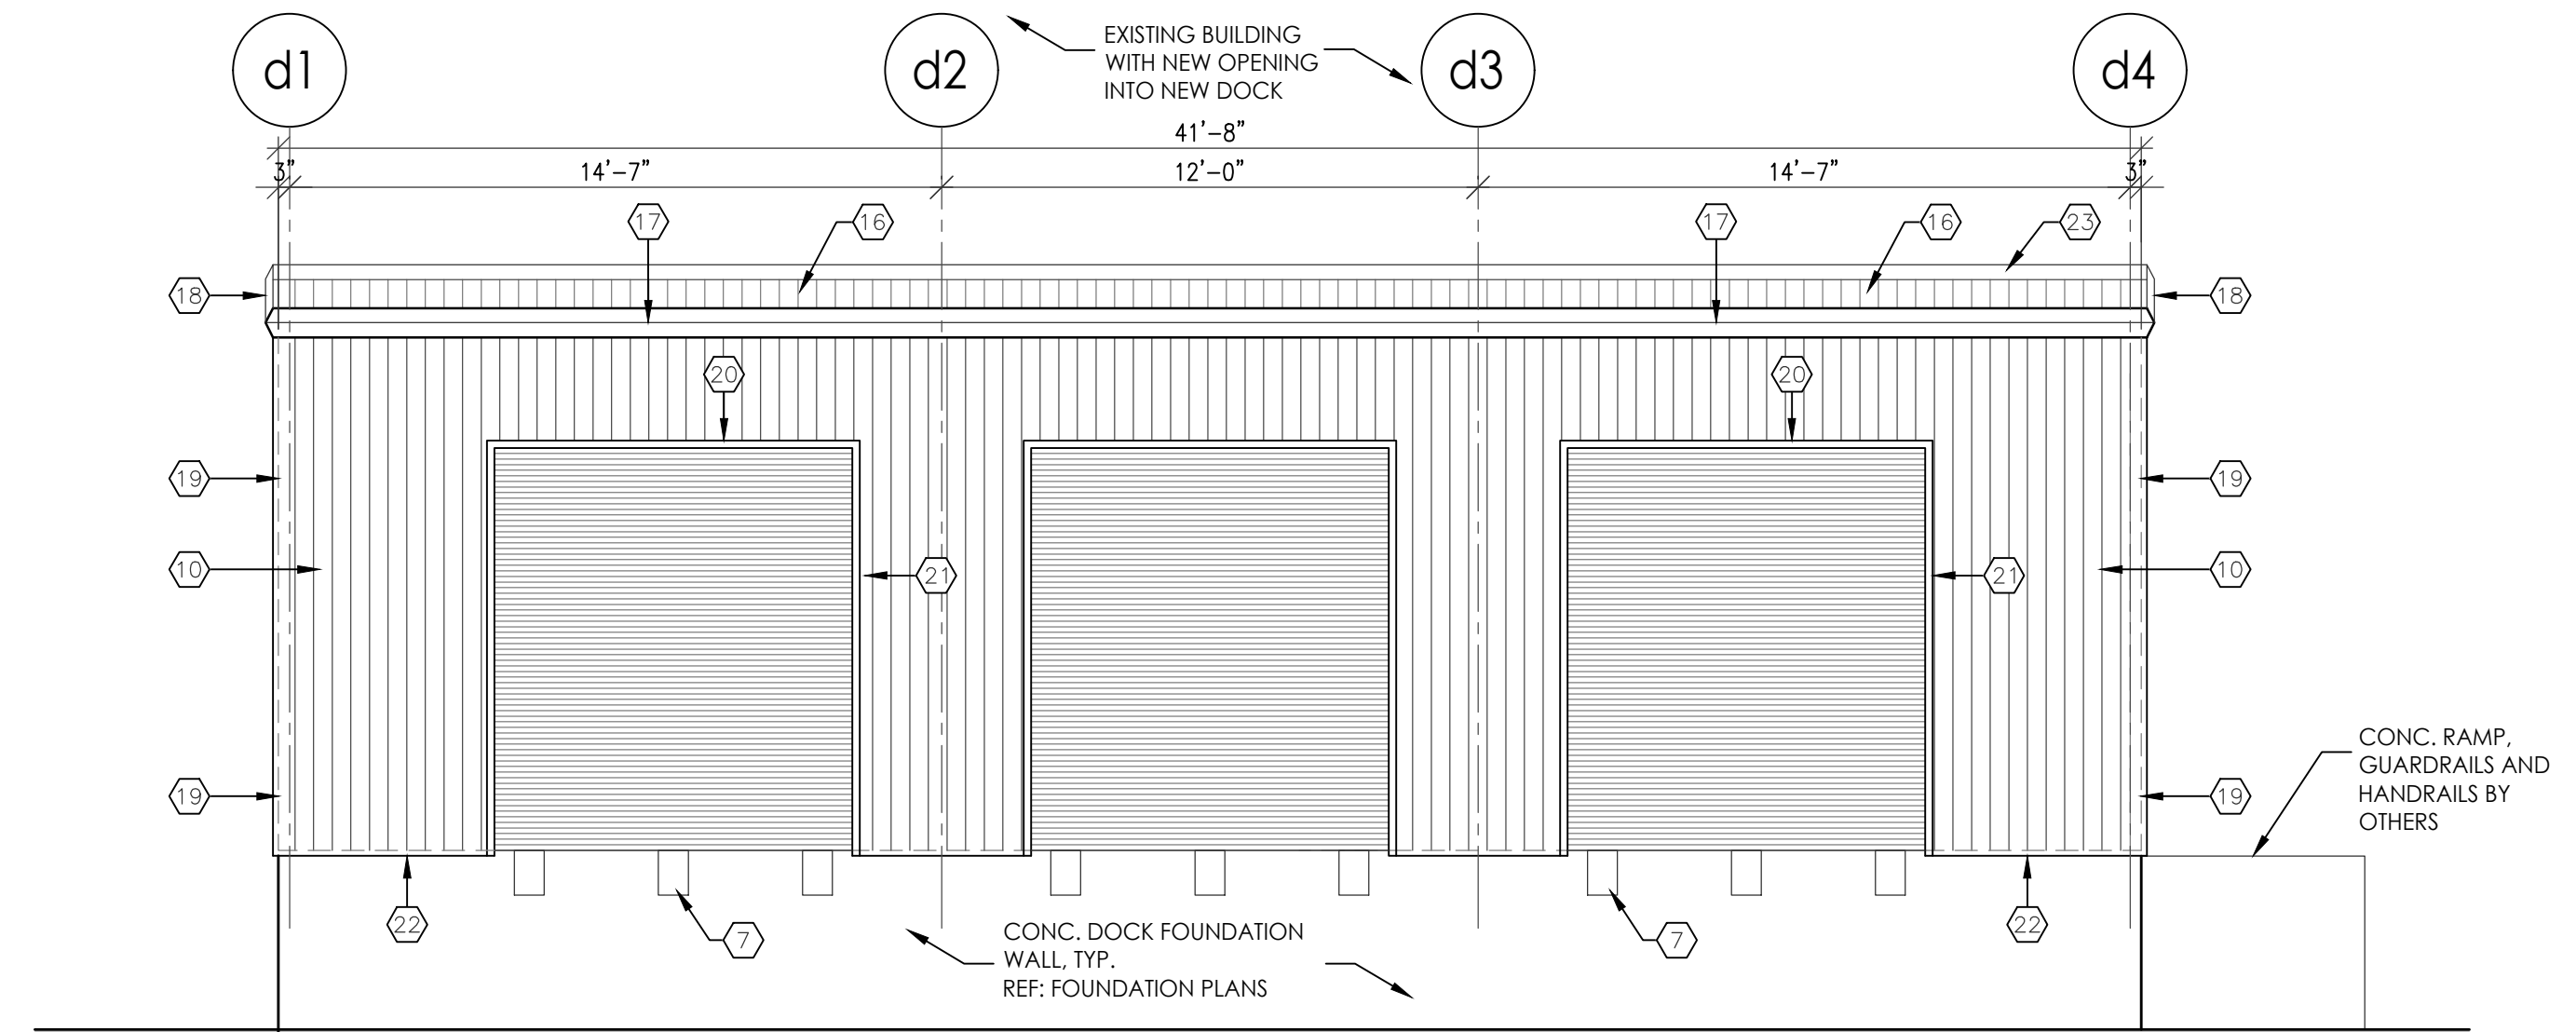


5 DOCK D WEST ELEVATION
SCALE: 1/4"=1'-0"

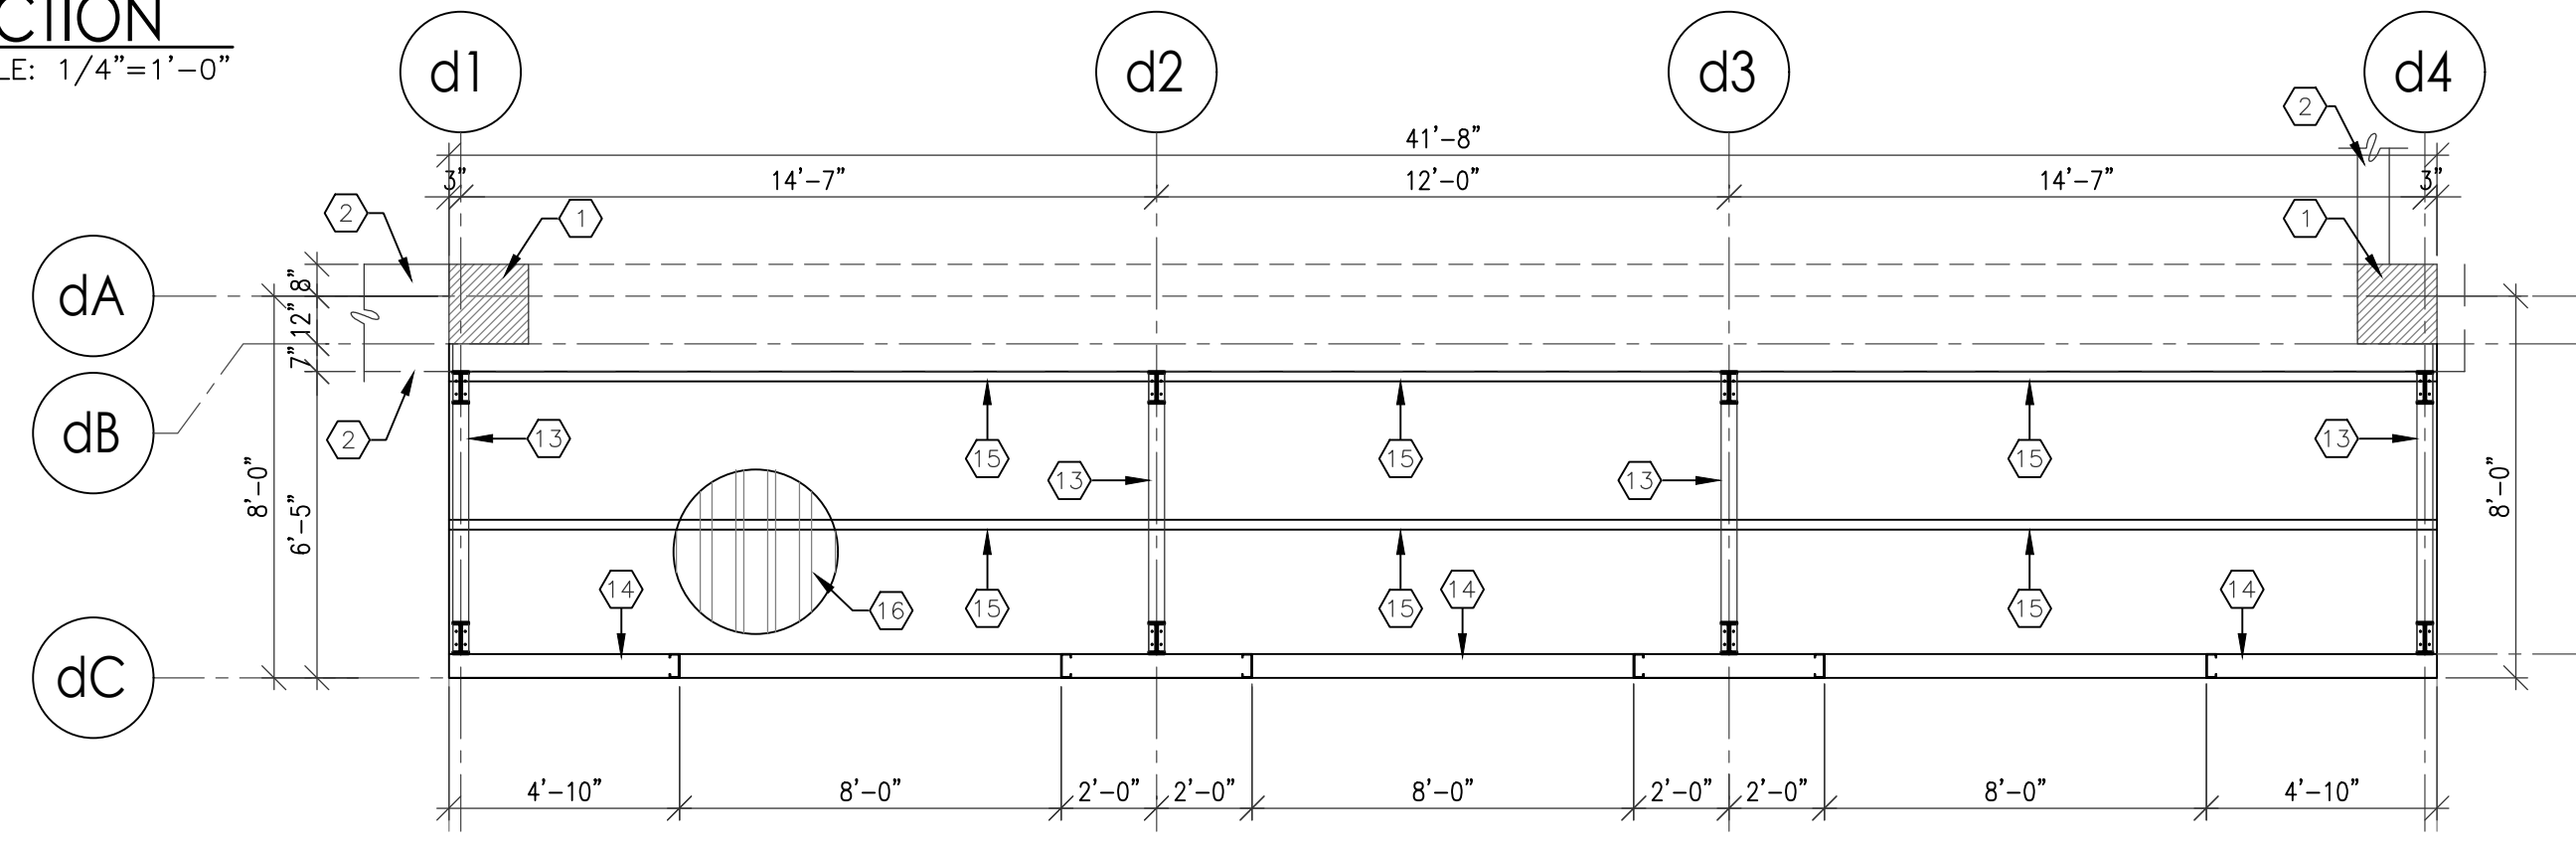


3 DOCK D ROOF FRAME PLAN
SCALE: 1/4"=1'-0"

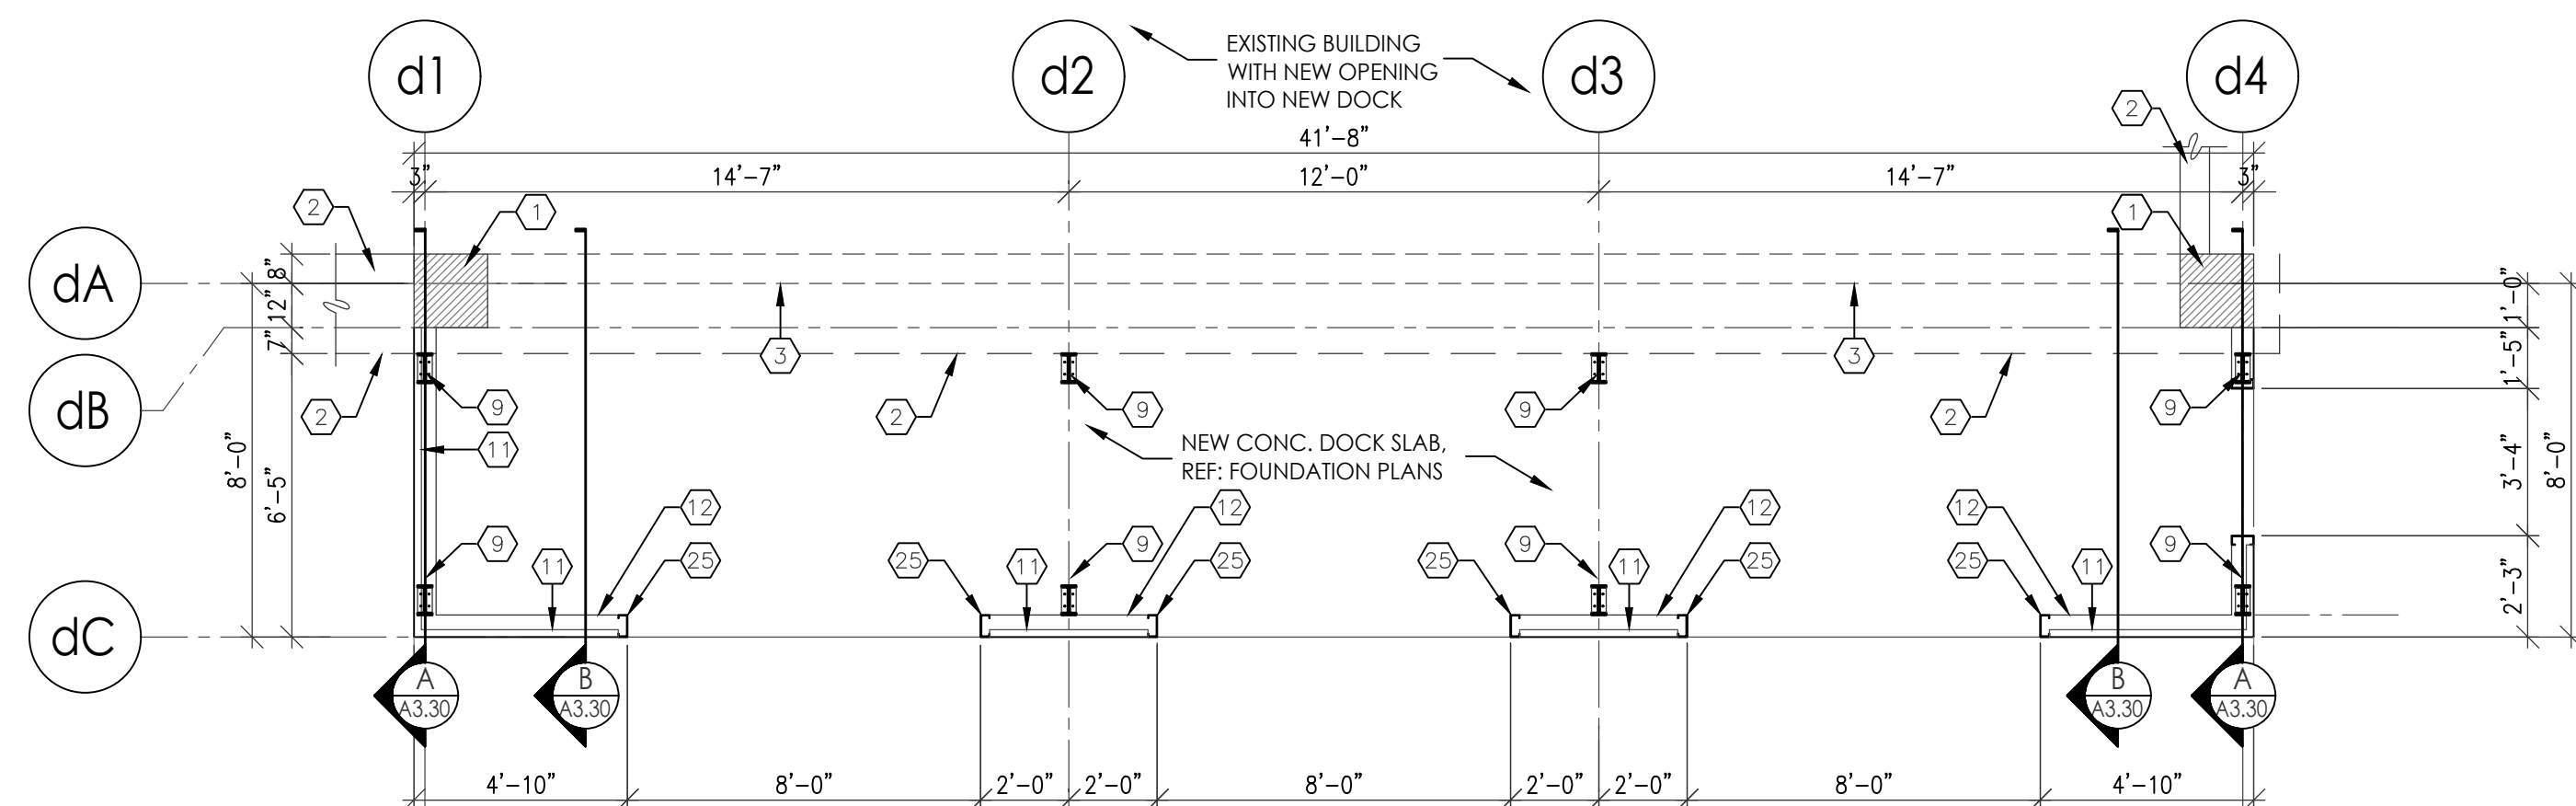

2 DOCK D WALL FRAME PLAN
SCALE: 1/4"=1'-0"

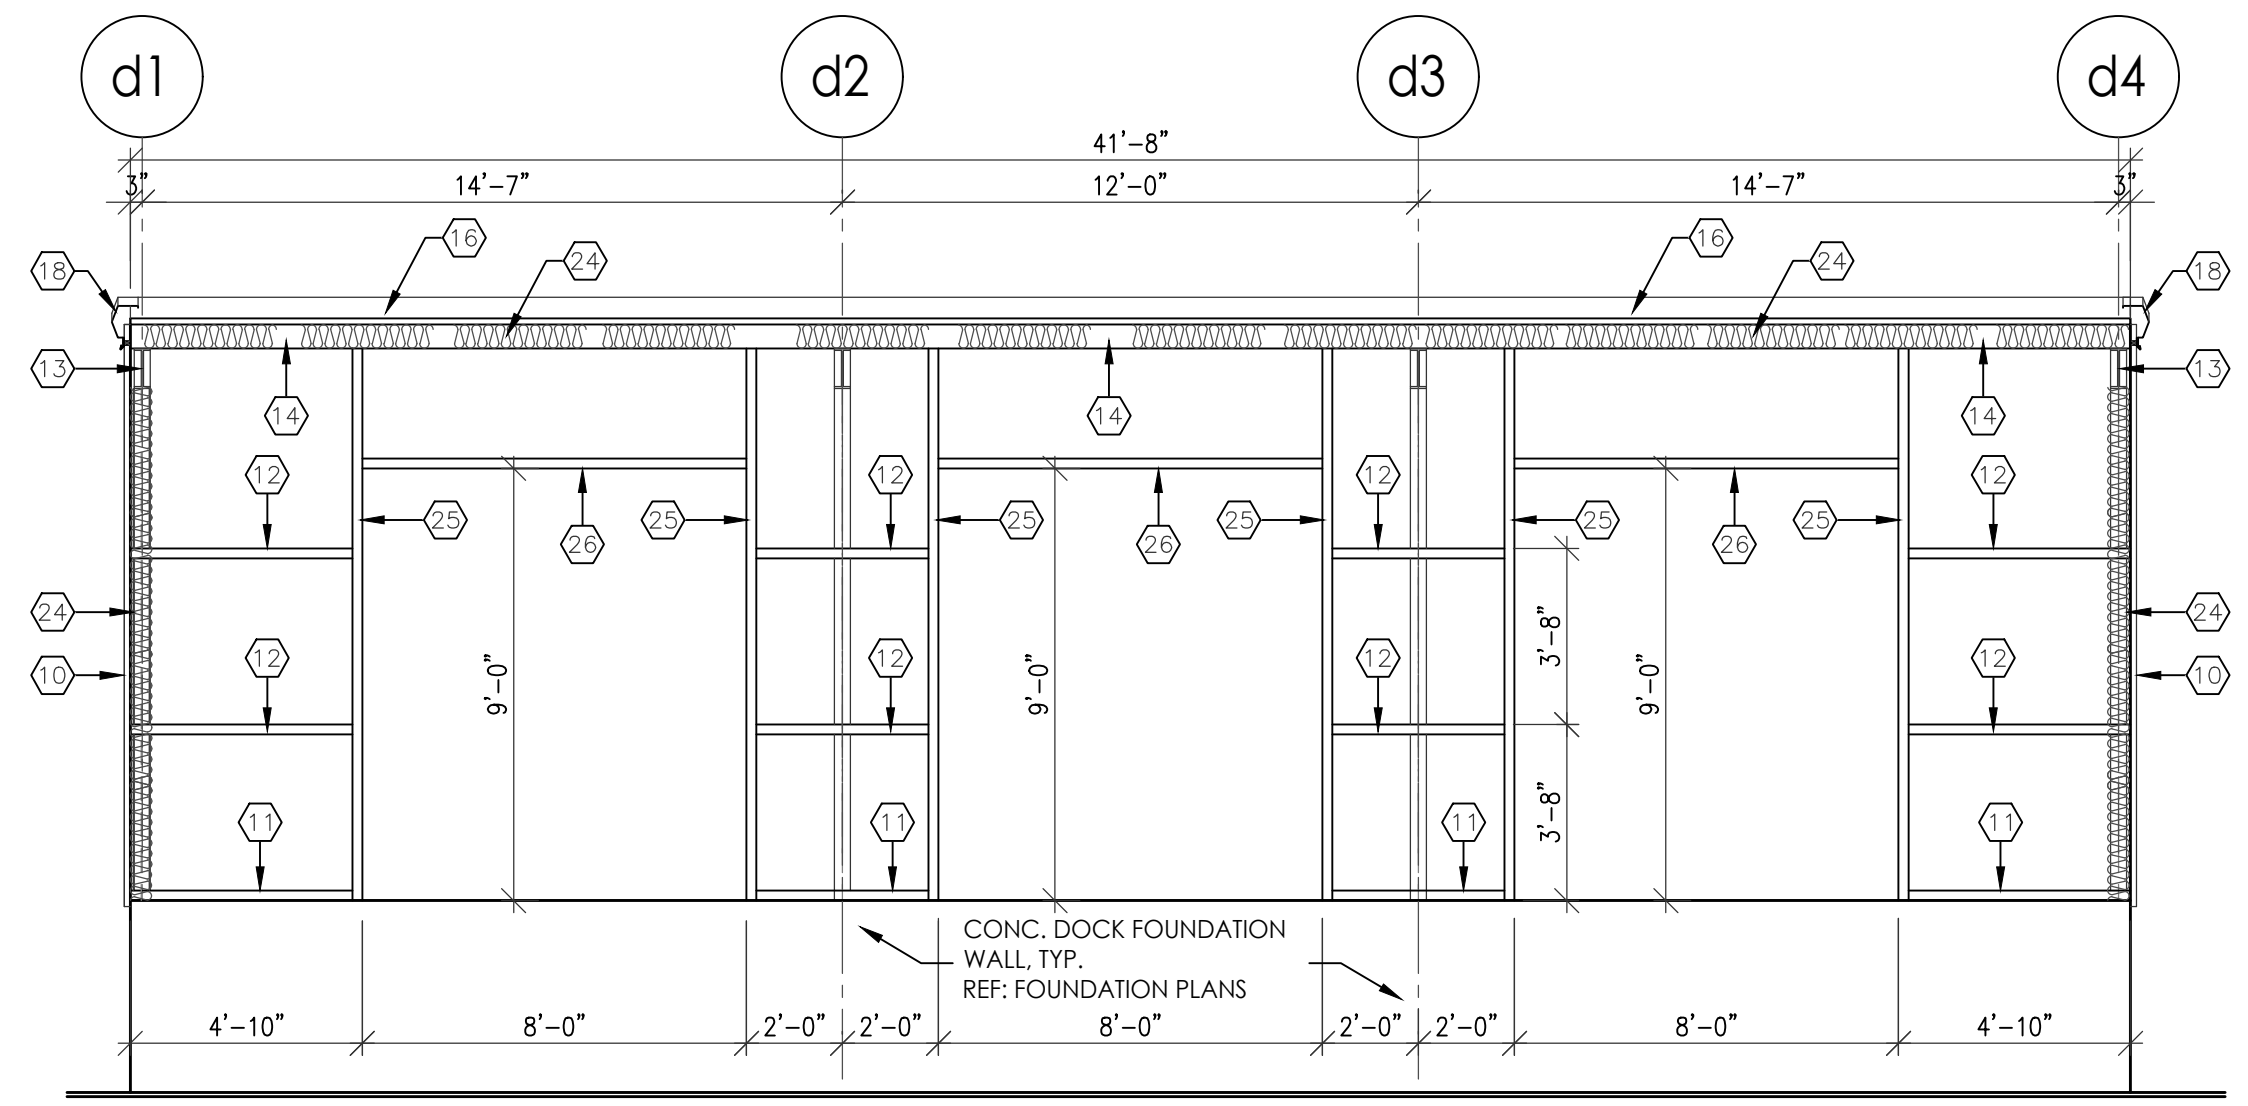


4 DOCK D WALL FRAME ELEVATION
SCALE: 1/4"=1'-0"

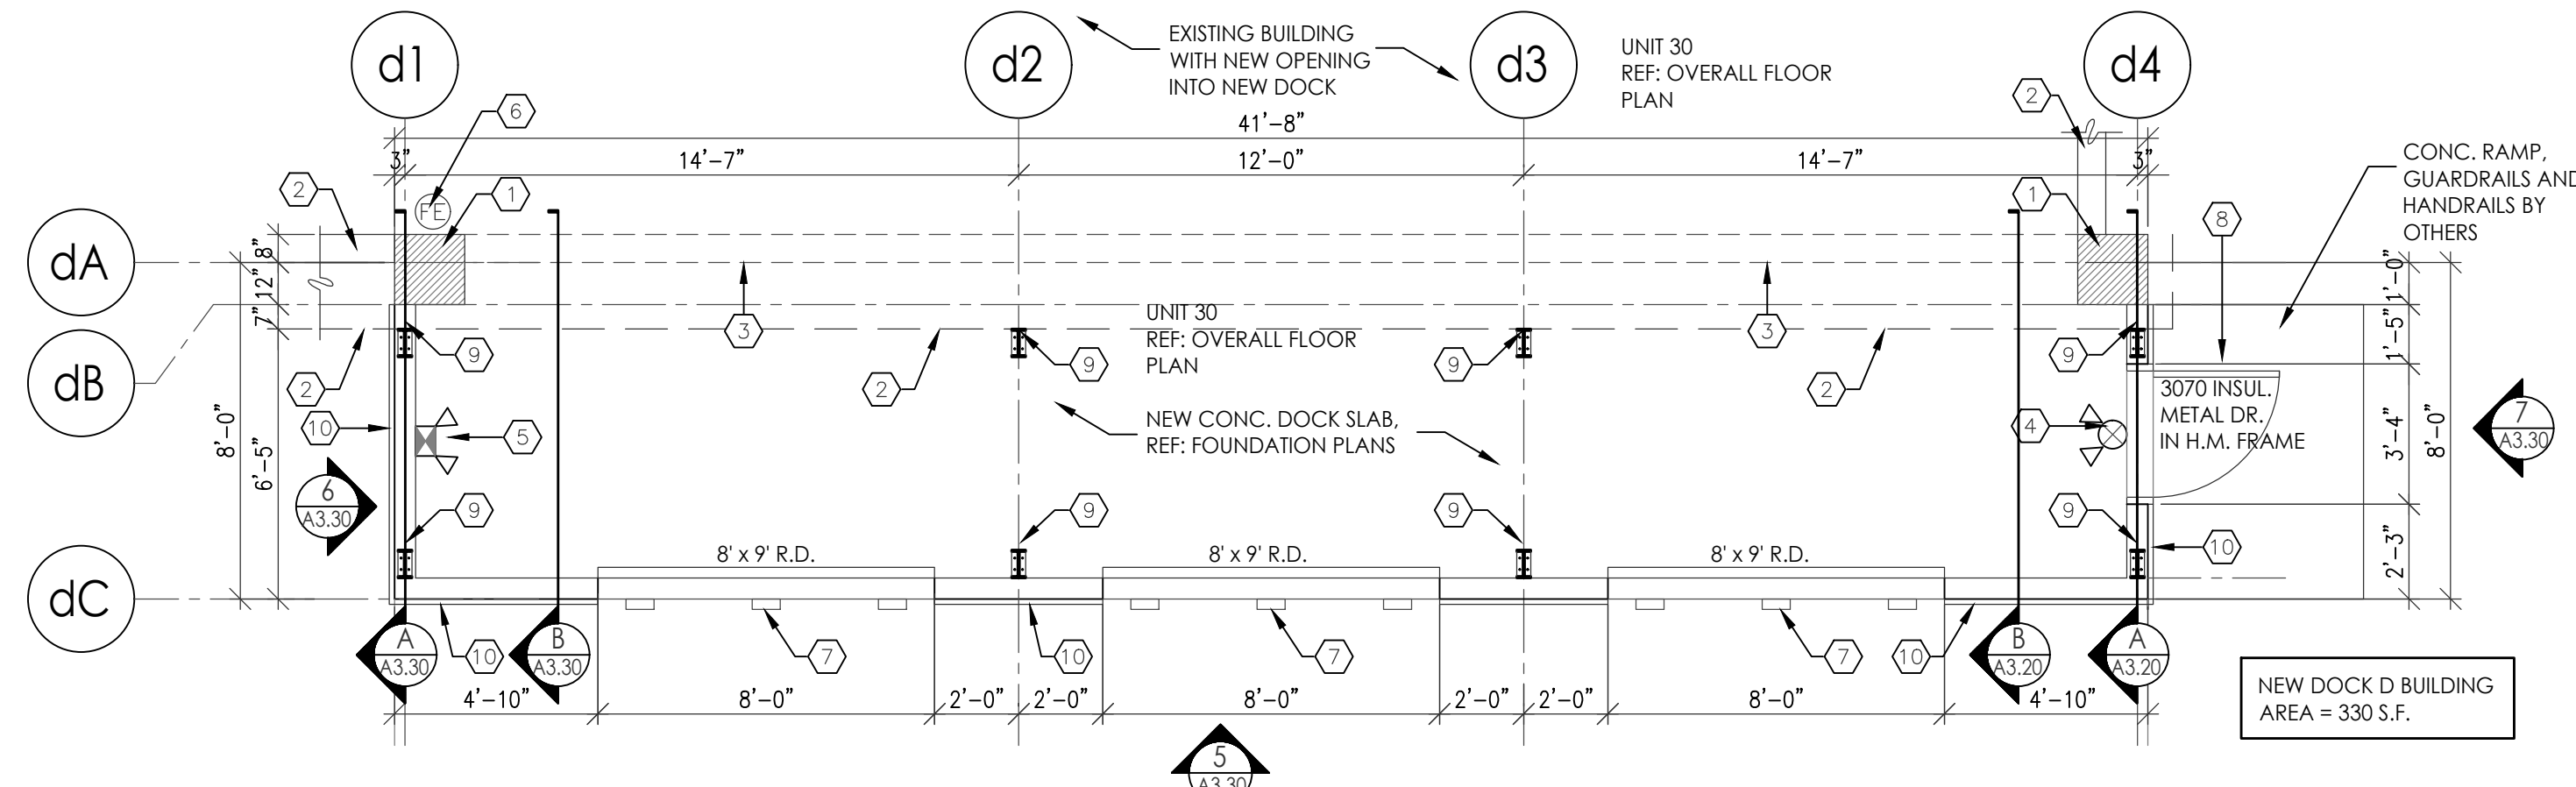

1 DOCK D FLOOR PLAN
SCALE: 1/4"=1'-0"

HONEYWELL WAREHOUSES
DOCK D ARCH AND STRUCTURAL PLANS
9201 SAN MATEO BLVD NE.
ALBUQUERQUE, NM 87113
#2354

REVISION	DATE
DATE	3/22/2024
SHEET NUMBER	A-3.30

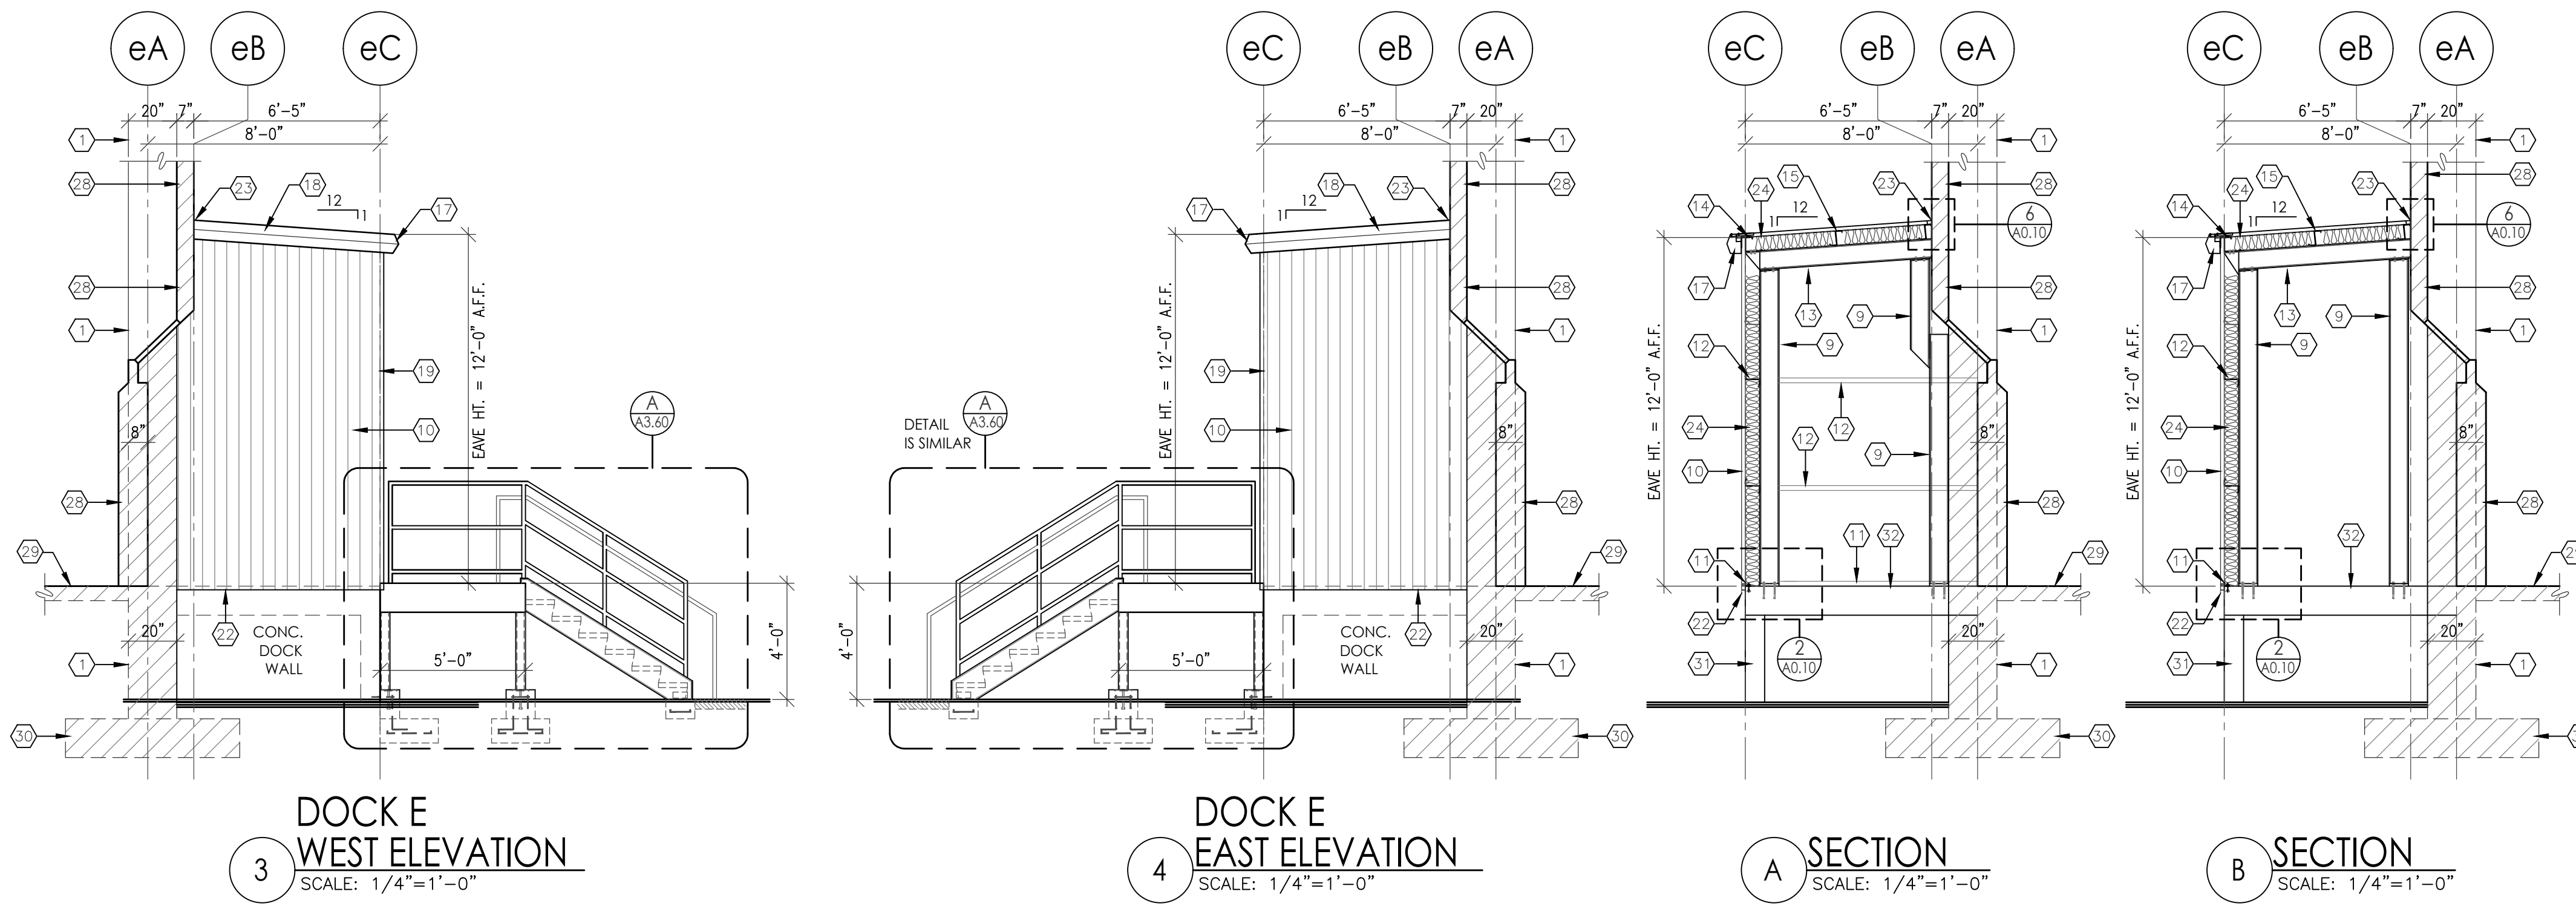



3 DOCK E WEST ELEVATION
SCALE: 1/4"=1'-0"

4 DOCK E EAST ELEVATION
SCALE: 1/4"=1'-0"


A SECTION
SCALE: 1/4"=1'-0"

B SECTION
SCALE: 1/4"=1'-0"

- KEYED NOTES**
- EXISTING 20' x 20' CONCRETE COLUMN.
 - EXISTING EXTERIOR WALL.
 - EXISTING WALL TO BE REMOVED.
 - COMBINATION EXIT SIGN AND EMERGENCY LIGHT WITH BATTERY BACK-UP. REF: ELECTRICAL PLANS.
 - EMERGENCY LIGHT WITH BATTERY BACK-UP. REF: ELECTRICAL PLANS.
 - WALL MOUNTED FIRE EXTINGUISHER 2A-10-BC, TYP.
 - DOCK BUMPERS, TYP.
 - 3070 INSULATED METAL DOOR IN HOLLOW METAL FRAME WITH 1/2" MAX. ALUM. THRESHOLD, DOOR WITH PANIC HARDWARE, KEYED LOCKSET, DOOR STOP, WEATHER STRIPPING AND AUTO CLOSURE.
 - W8 x 10 COLUMN, TYP.
 - 26 GA. METAL WALL PANEL, TYP.
 - 1/4 GA. BASE ANGLE, TYP.
 - 2 1/2" x 6" x 14 GA. ZEE GIRT, TYP.
 - W8 x 10 BEAM, TYP.
 - 6" x 3" EAVE STRUT, TYP.
 - 2 1/2" x 6" x 14 GA. ZEE PURLIN, TYP.
 - 26 GA. FRB ROOF PANEL, TYP.
 - CONT. METAL EAVE GUTTER TRIM AND DOWNSPOUT (DOWNSPOUT NOT SHOWN).
 - CONT. RAKE/GABLE METAL TRIM, TYP.
 - METAL CORNER TRIM, TYP.
 - METAL HEAD TRIM, TYP.
 - METAL JAMB TRIM, TYP.
 - CONT. METAL WALL BASE TRIM, TYP.
 - CONT. METAL WALL BASE FLASHING, TYP.
 - CROSS HATCH DENOTES EXIST. EXTERIOR WALL.
 - EXIST. CONC. SLAB, TYP.
 - EXIST. CONC. COLUMN FOOTING, TYP.
 - NEW CONC. DOCK WALL, REF: FOUNDATION PLANS.
 - NEW CONC. SLAB AT NEW DOCK, REF: FOUNDATION PLANS.

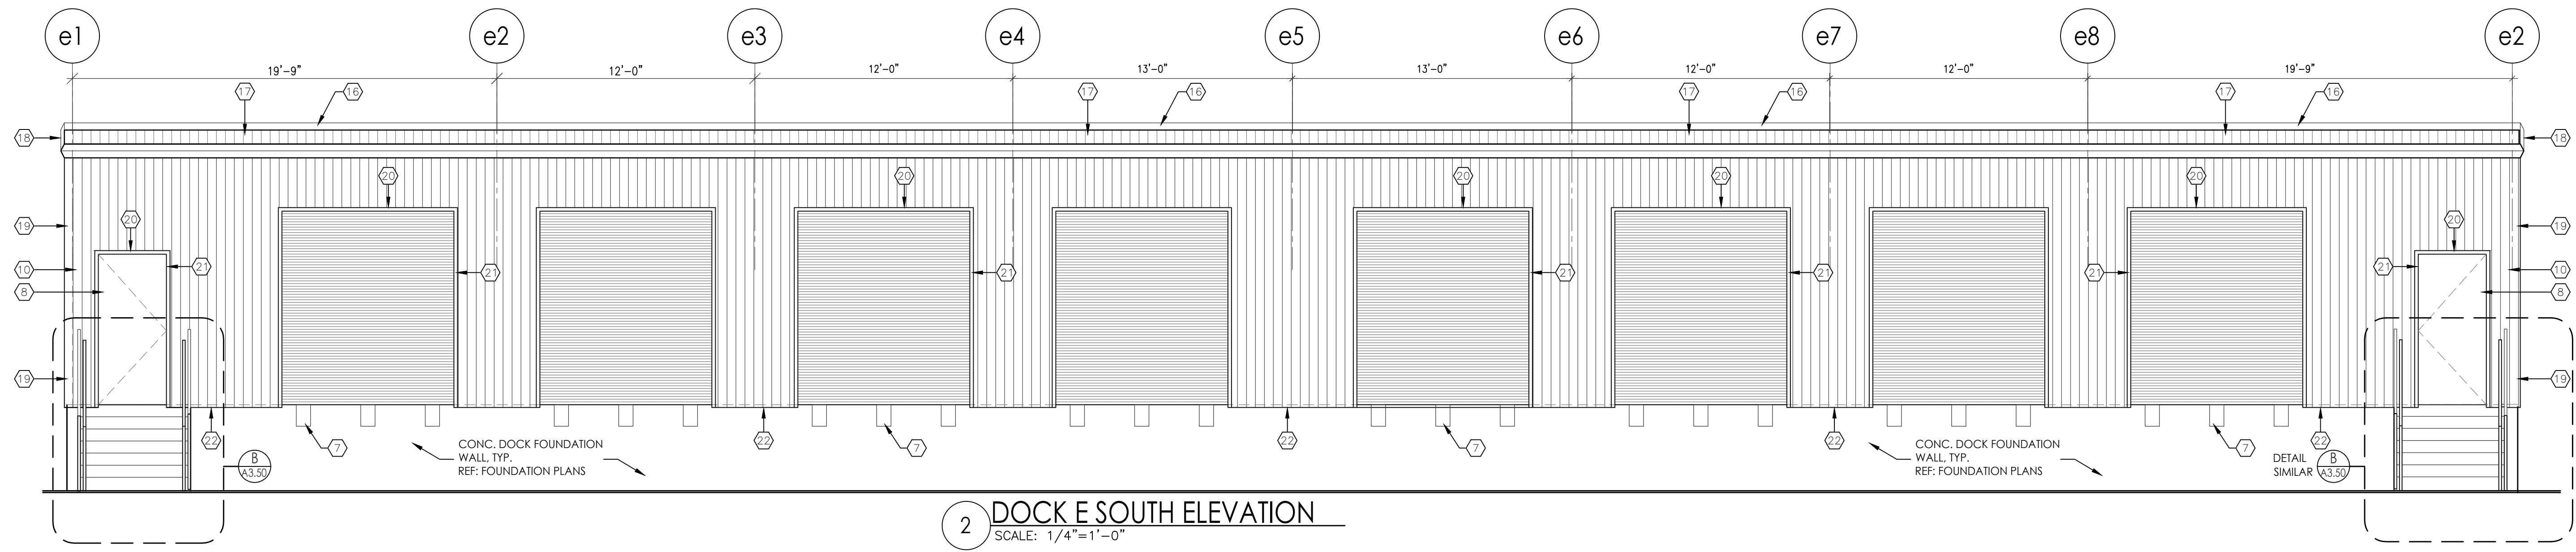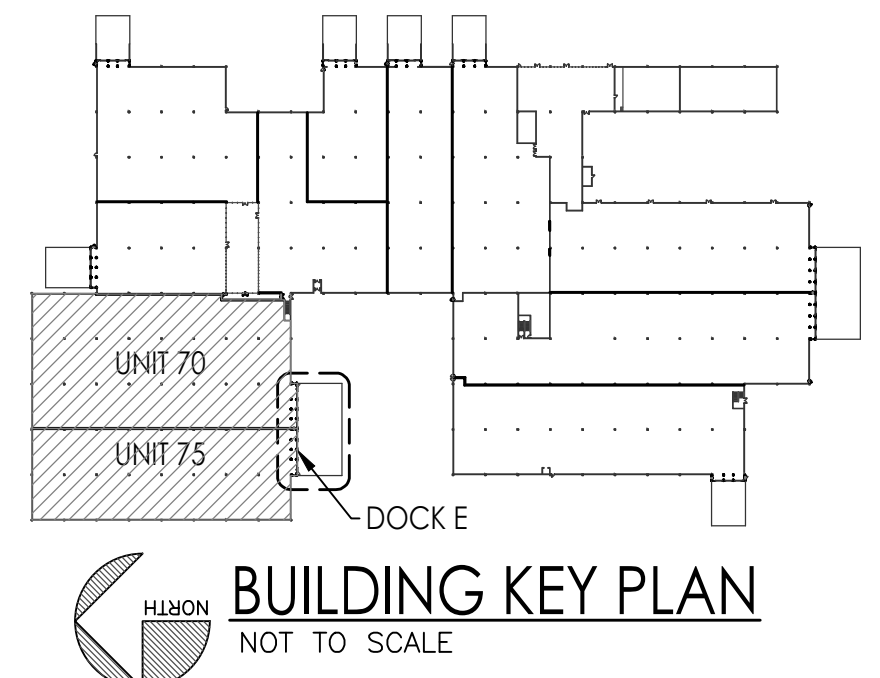


2 DOCK E SOUTH ELEVATION
SCALE: 1/4"=1'-0"

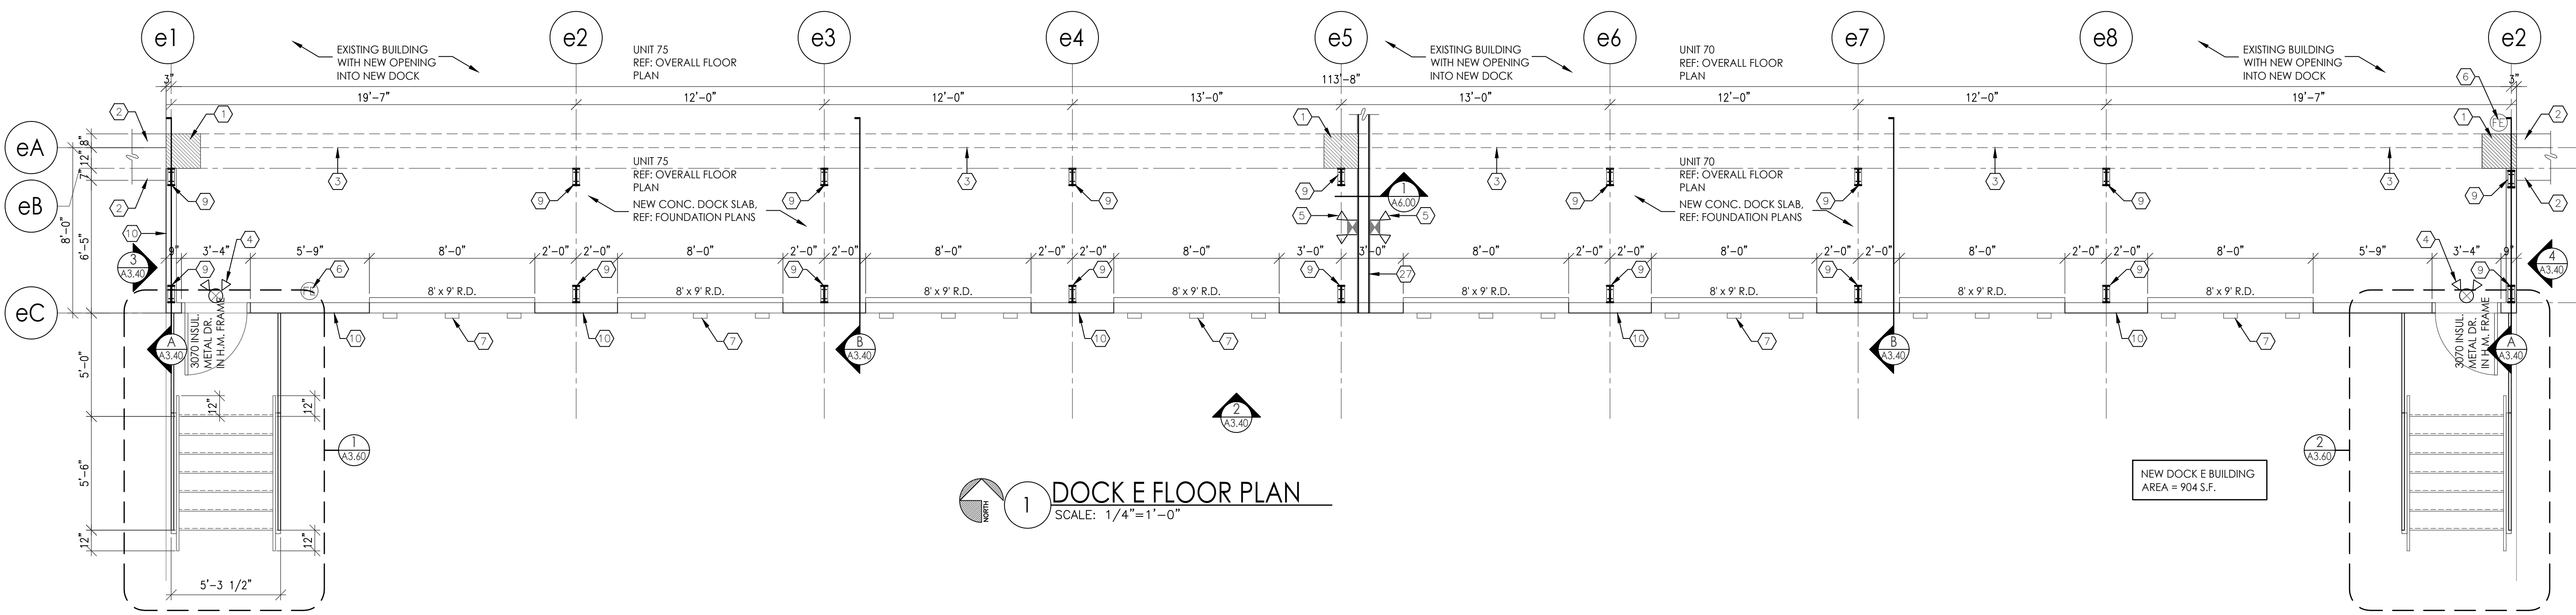



1 DOCK E FLOOR PLAN
SCALE: 1/4"=1'-0"

HONEYWELL WAREHOUSES
DOCK E FLOOR PLAN AND ELEVATIONS
9201 SAN MATEO BLVD NE.
ALBUQUERQUE, NM 87113
#2354


REVISION	DATE
DATE	3/22/2024
SHEET NUMBER	S-3.40

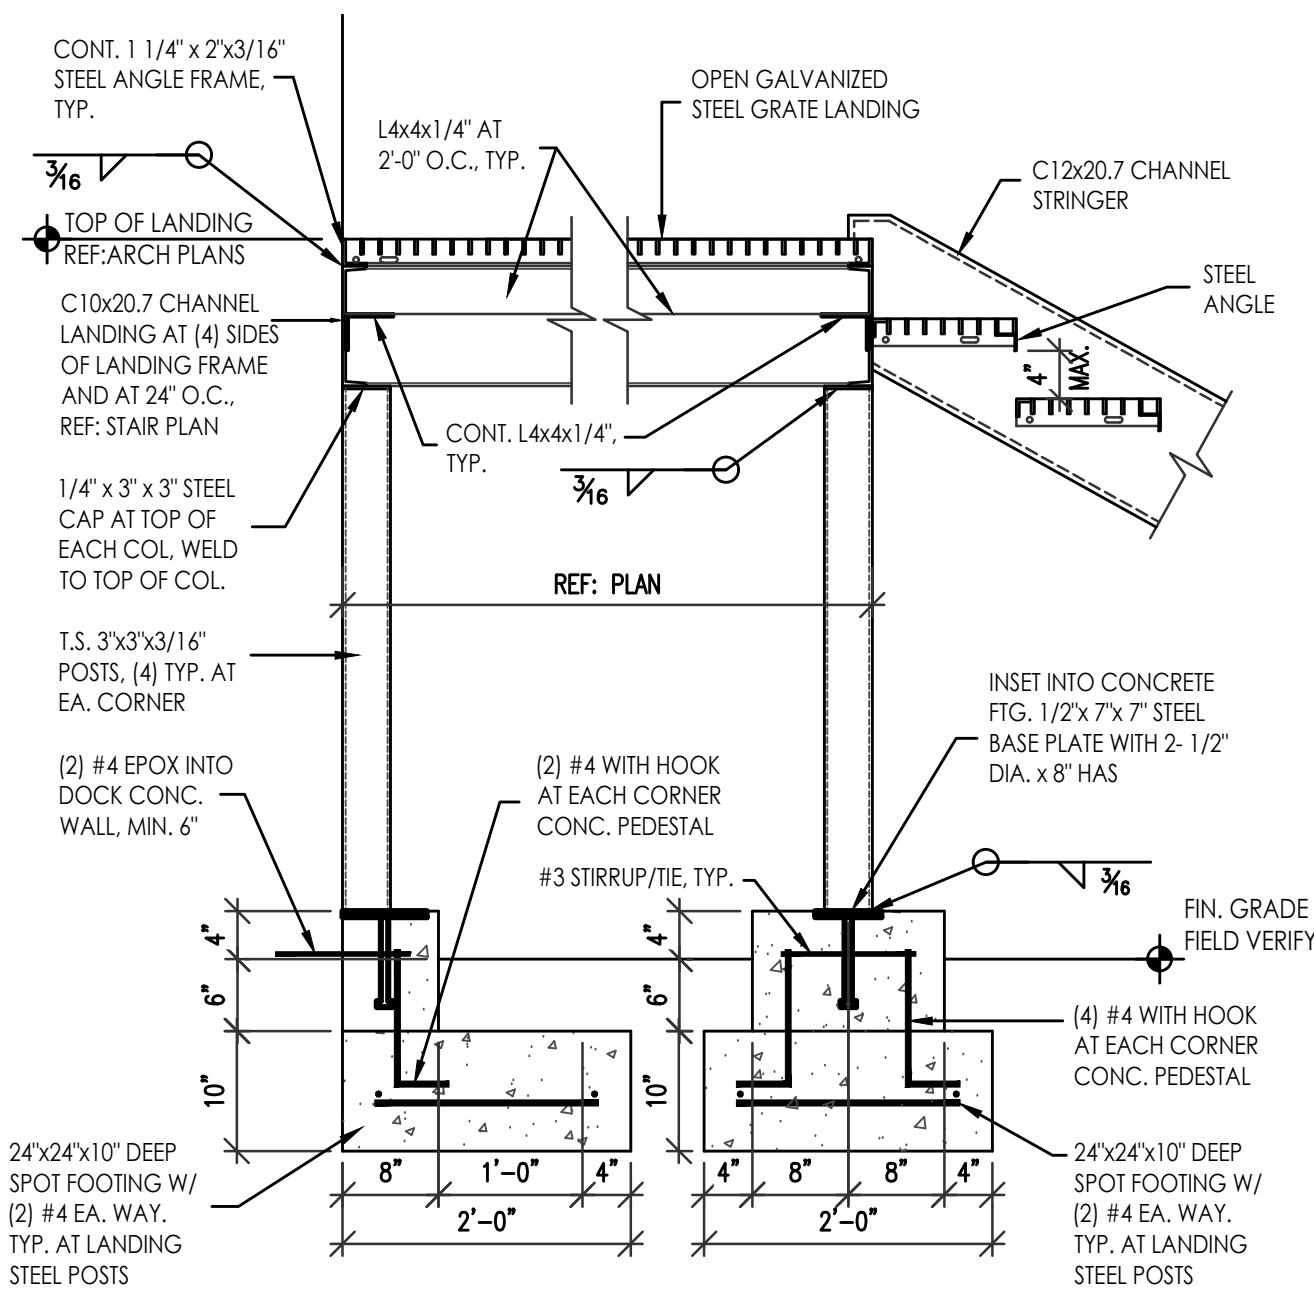


B DOCK E STAIR AND LANDING DETAIL
SCALE: 3/4"=1'-0"

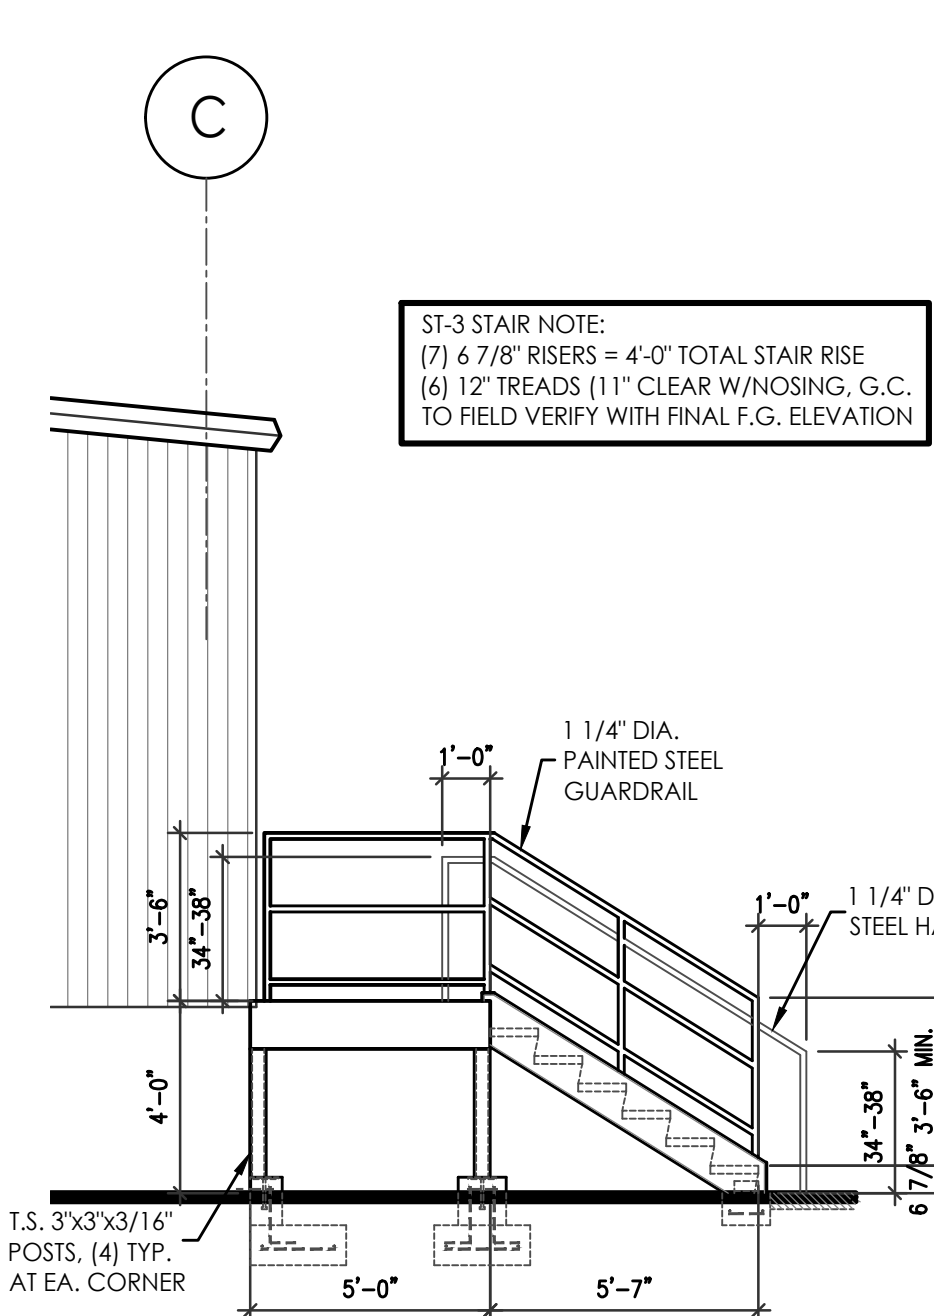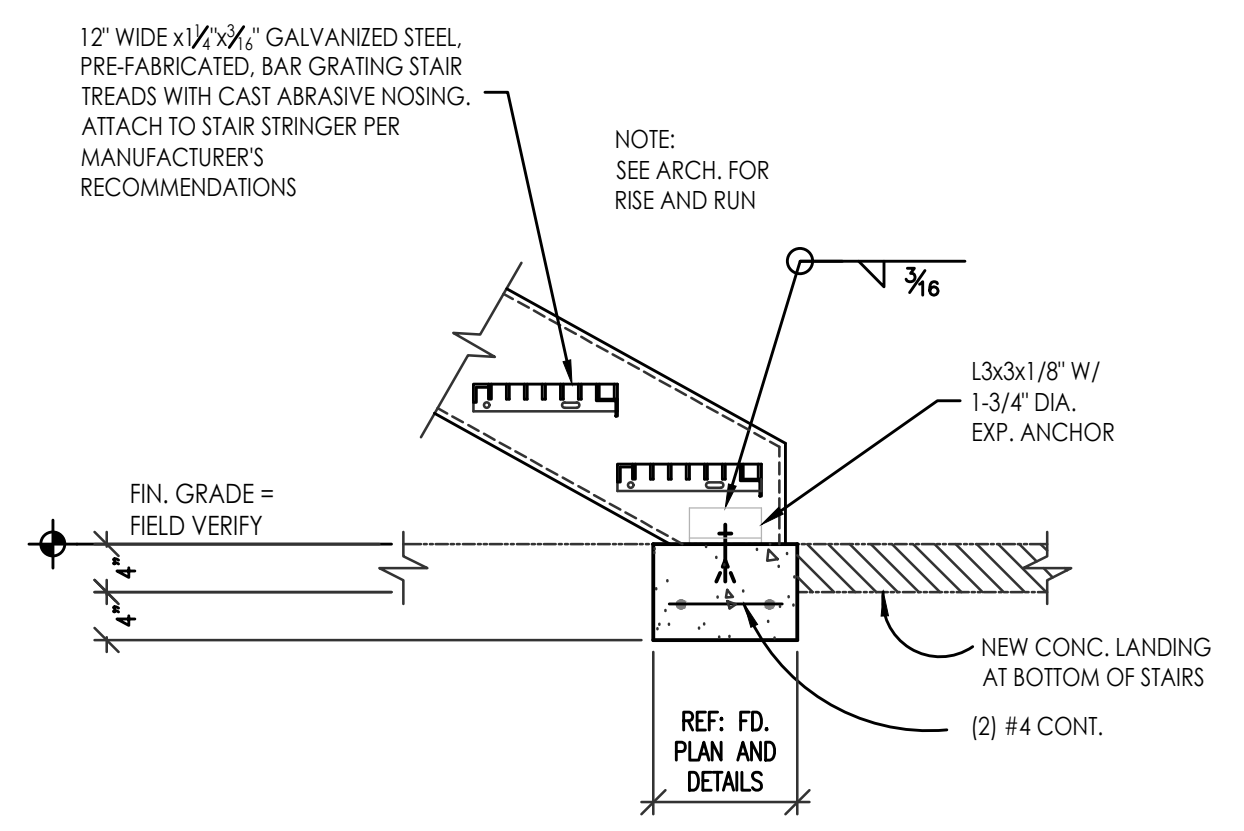


A DOCK E STAIR ELEVATION
SCALE: 1/4"=1'-0"

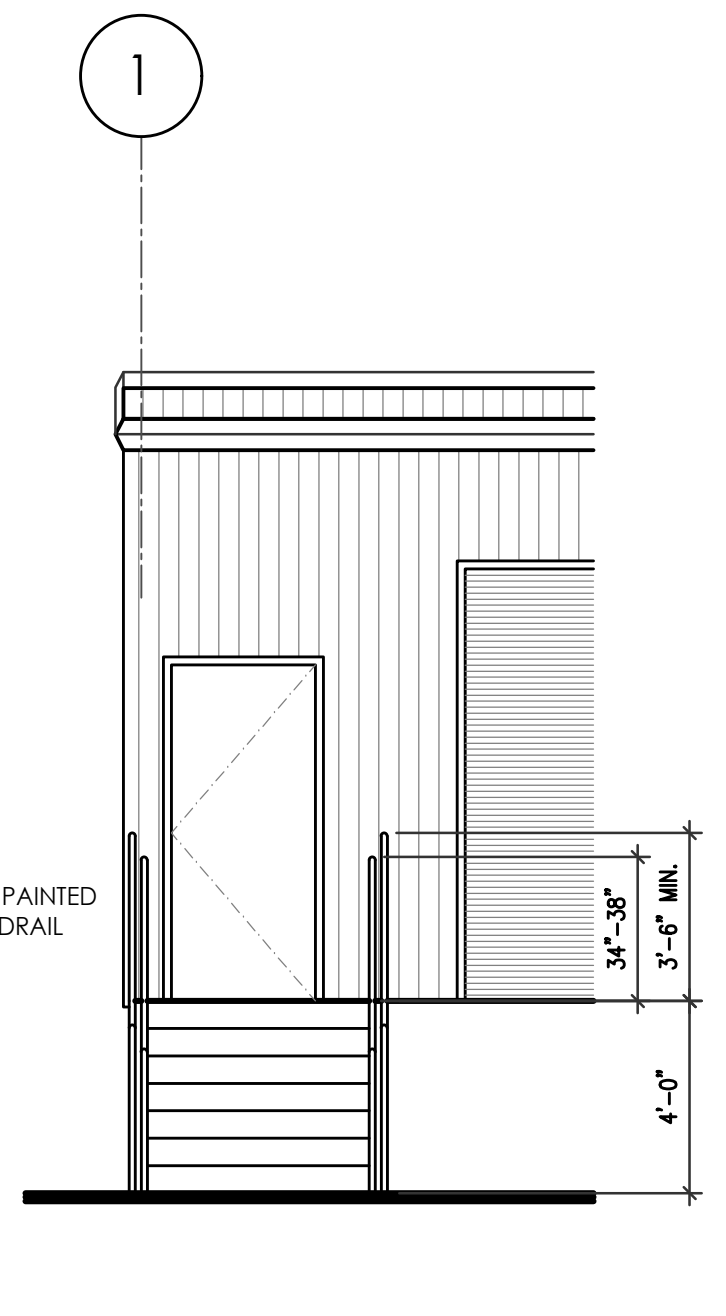

B DOCK E STAIR ELEVATION
SCALE: 1/4"=1'-0"

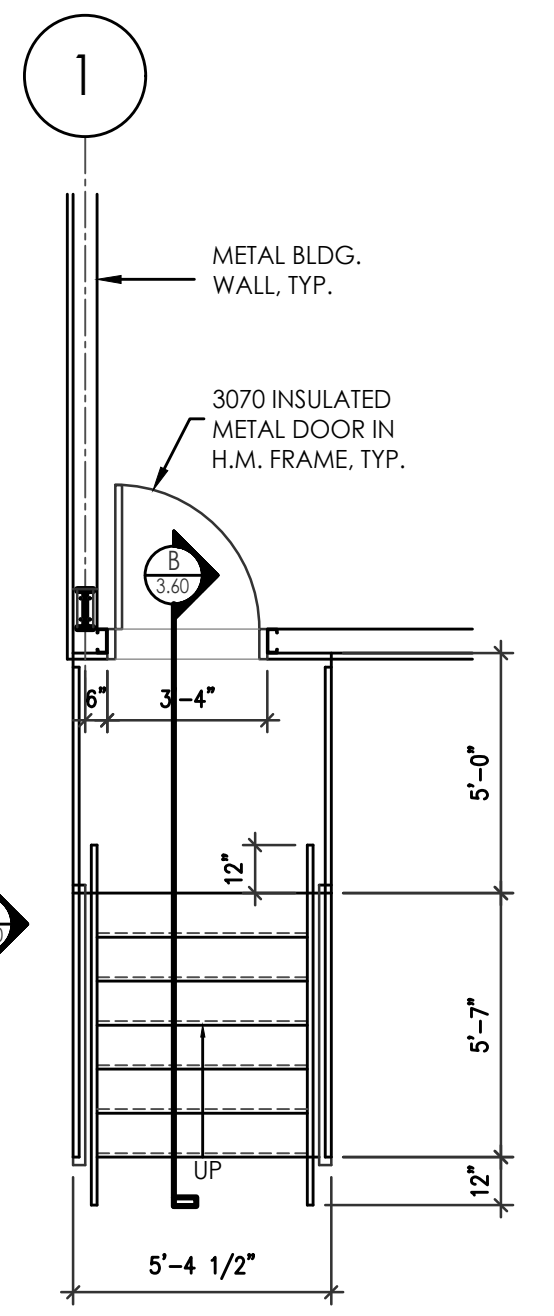

2 DOCK E STAIR PLAN
SCALE: 1/4"=1'-0"

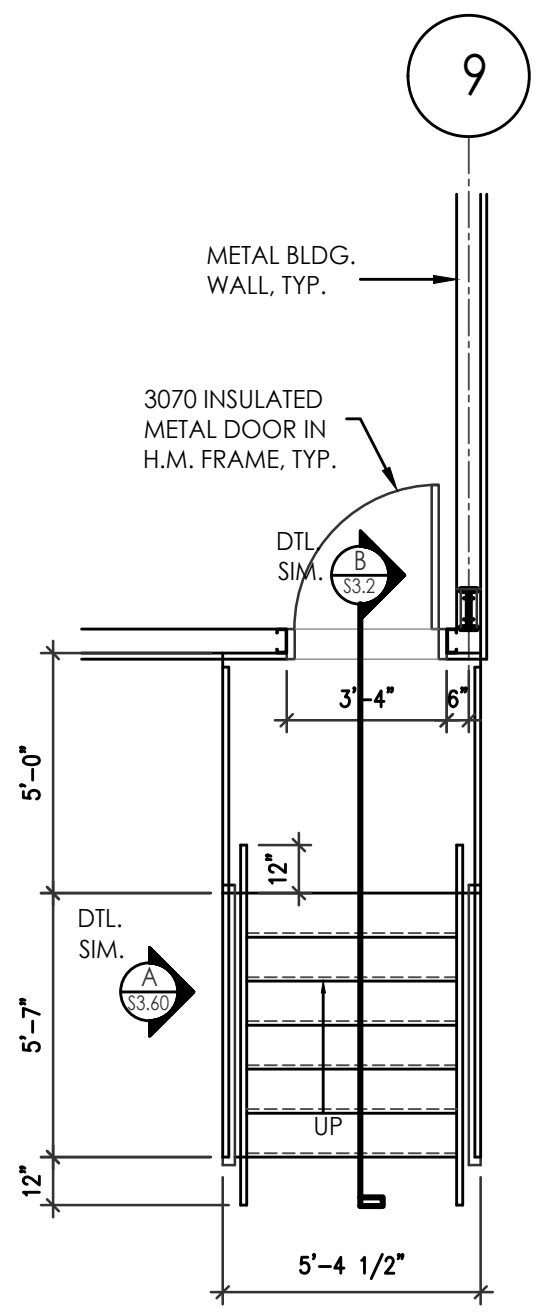


1 DOCK E STAIR PLAN
SCALE: 1/4"=1'-0"

HONEYWELL WAREHOUSES
DOCK E STAIR DETAILS
9201 SAN MATEO BLVD NE.
ALBUQUERQUE, NM 87113
#2354

REVISION	DATE


RBA ARCHITECTURE, PC
PLANNING DESIGN
10000 1st Ave. NE
Albuquerque, NM 87112
www.rba.com

DATE: 3/22/2024
SHEET NUMBER: A-3.60

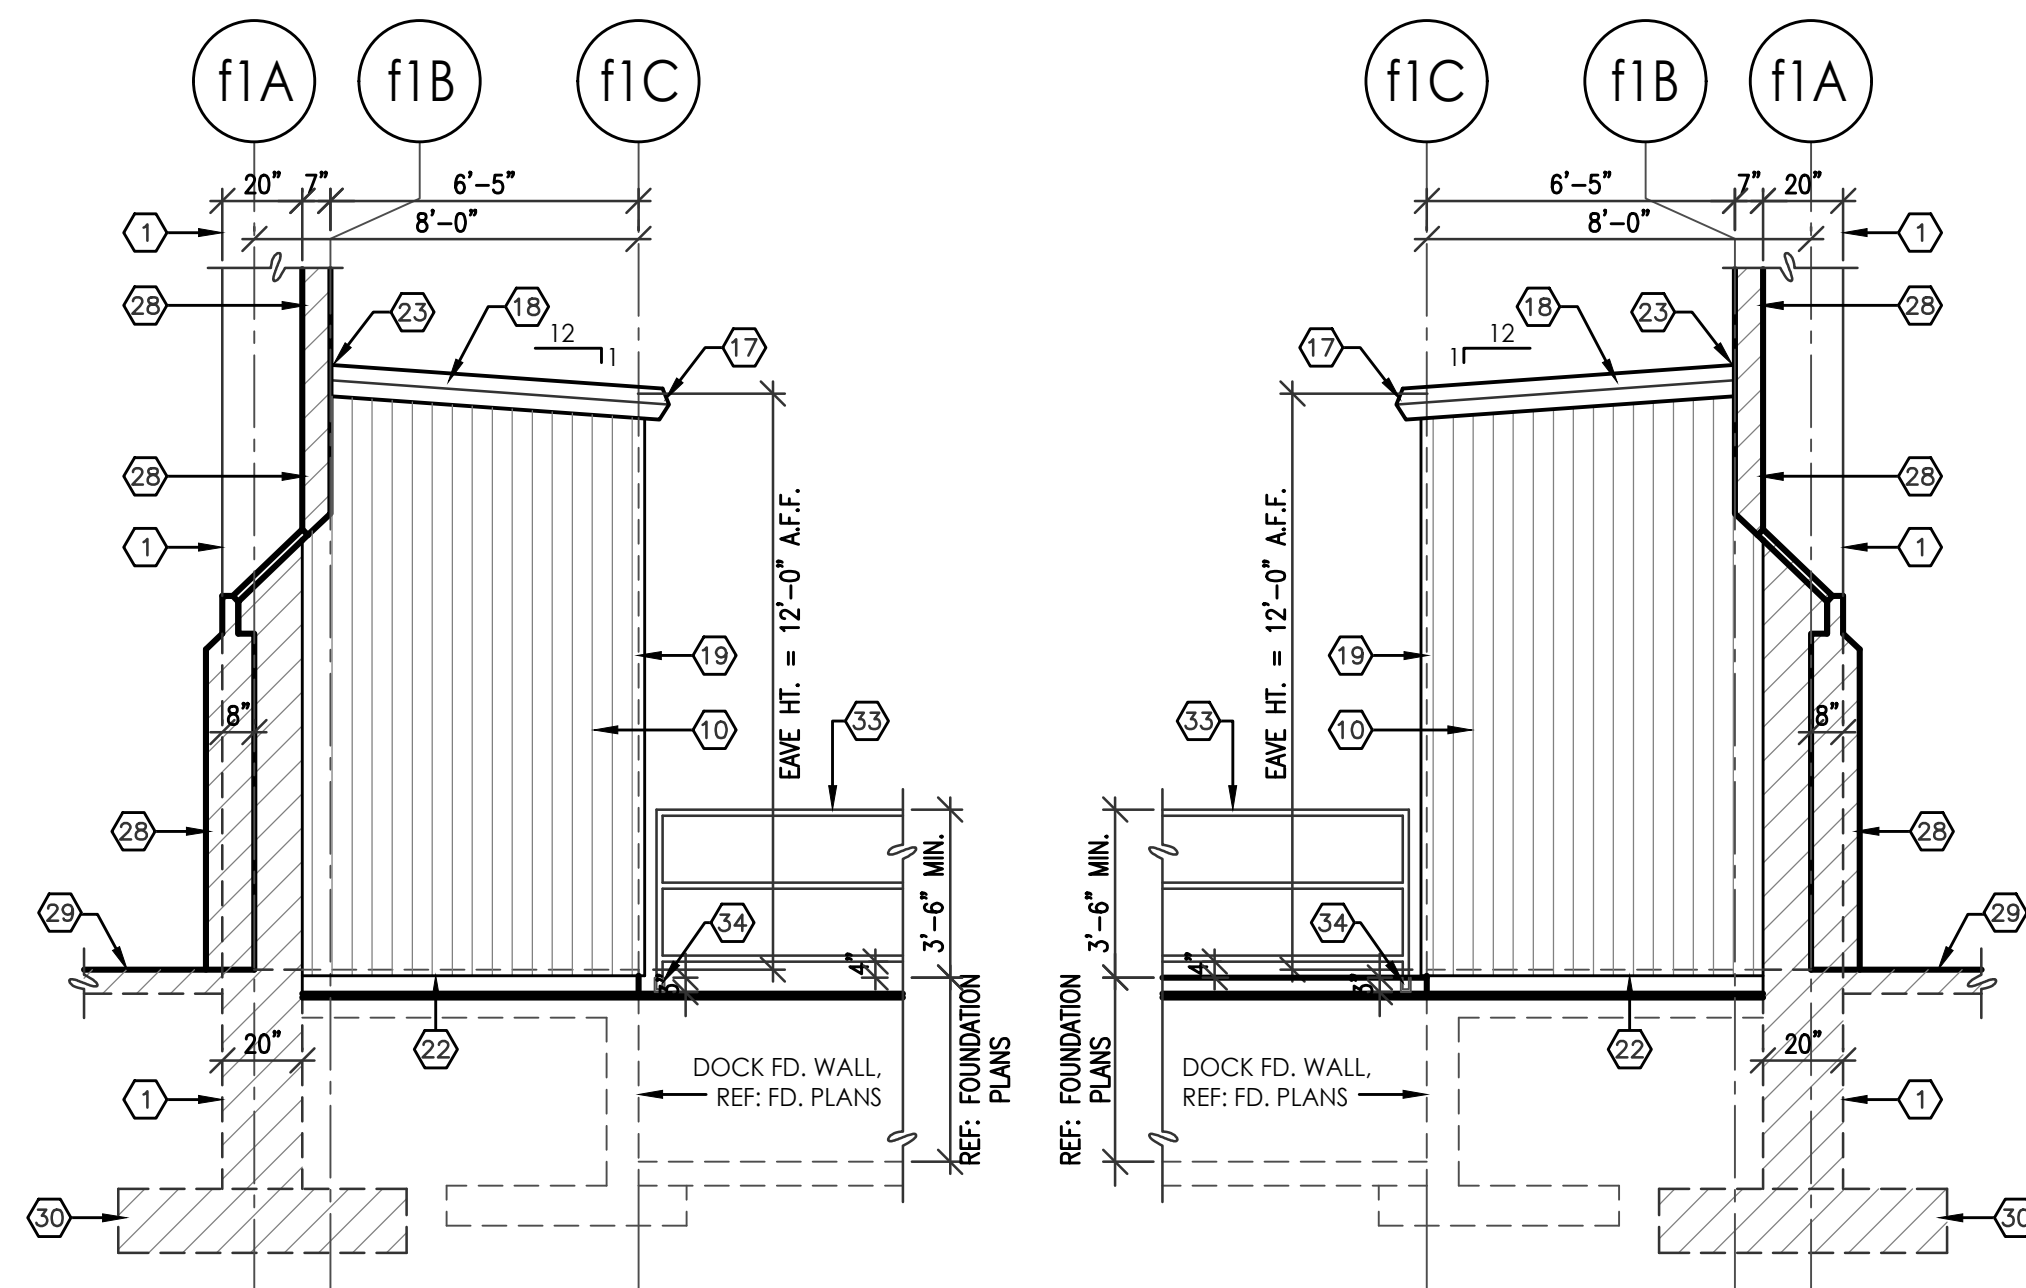

6 SOUTH ELEVATION
SCALE: 1/4"=1'-0"



7 NORTH ELEVATION
SCALE: 1/4"=1'-0"

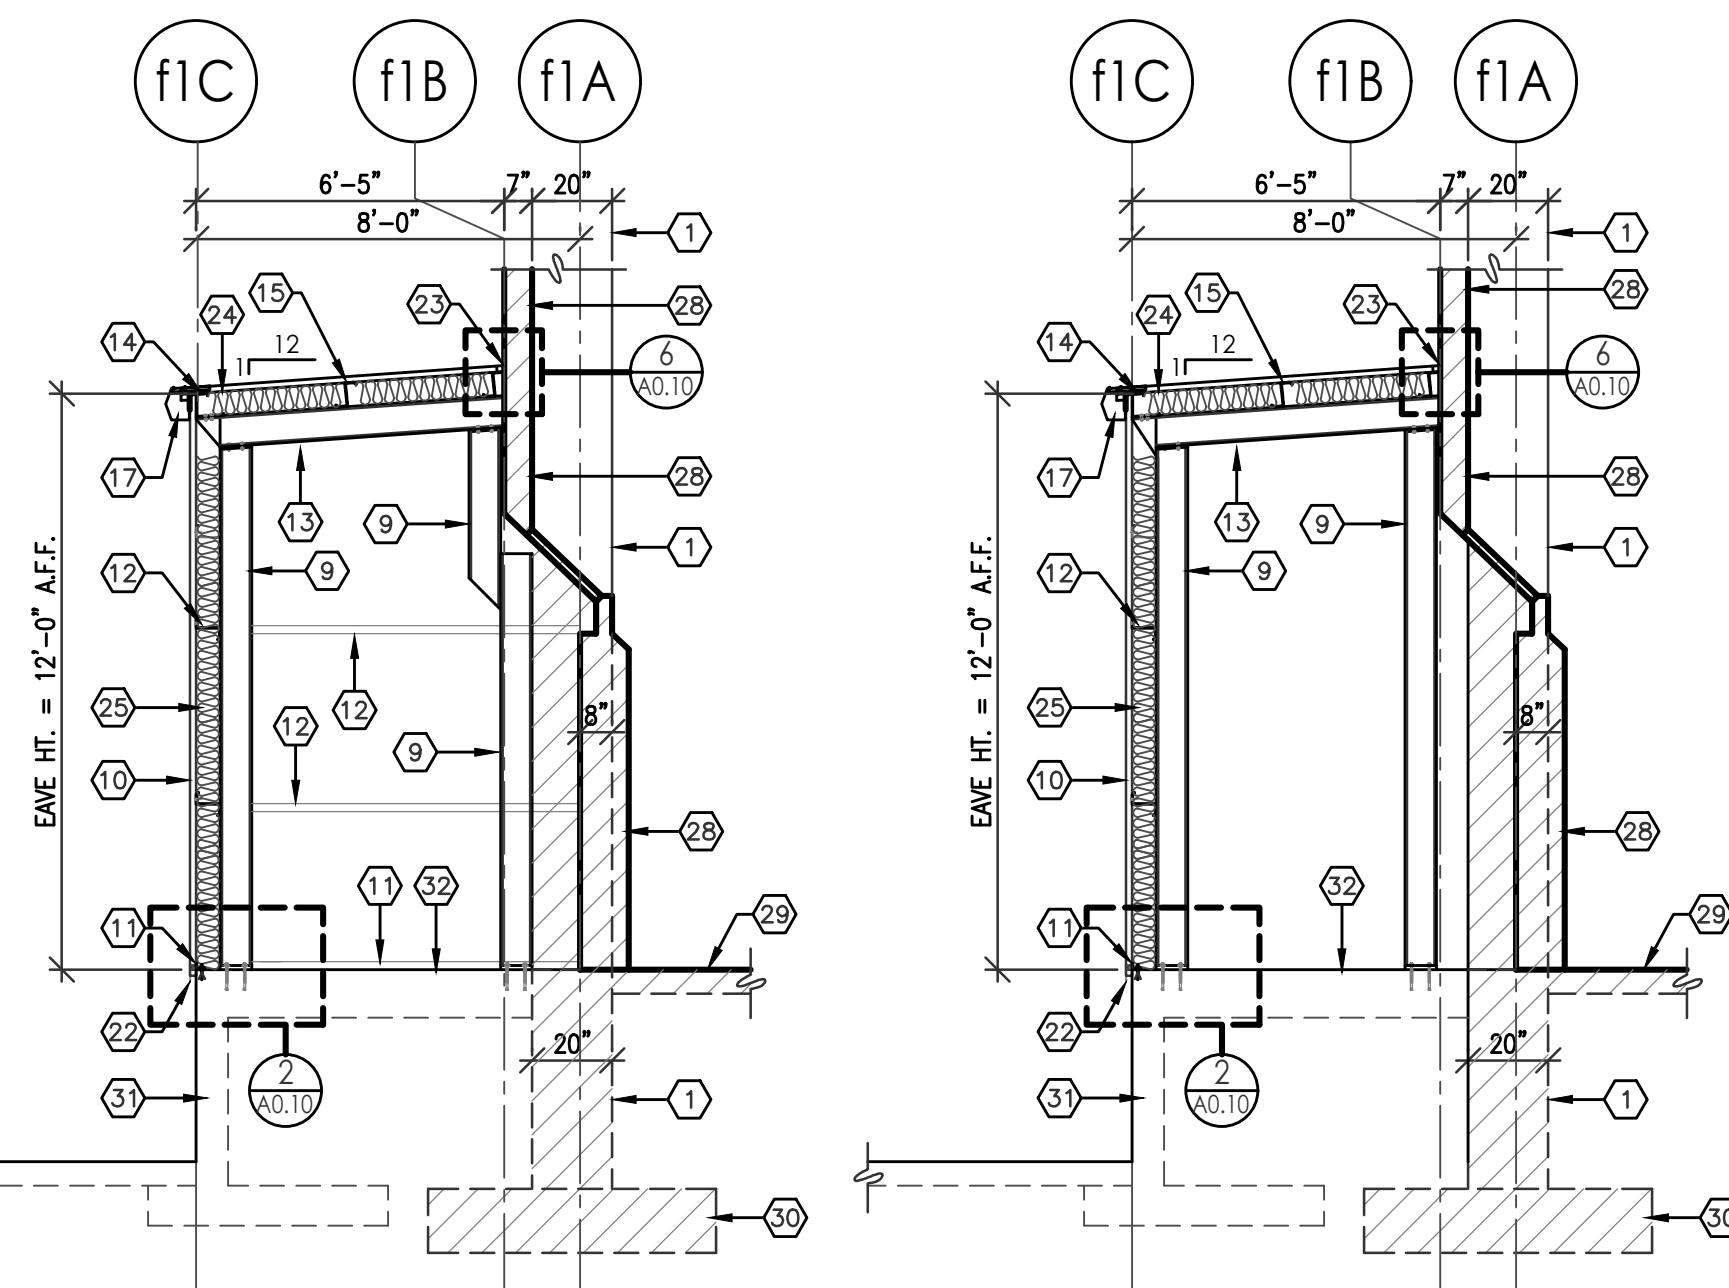


A SECTION
SCALE: 1/4"=1'-0"

B SECTION
SCALE: 1/4"=1'-0"


- KEYED NOTES**
- EXISTING 20" x 20" CONCRETE COLUMN.
 - EXISTING EXTERIOR WALL.
 - EXISTING WALL TO BE REMOVED.
 - COMBINATION EXIT SIGN AND EMERGENCY LIGHT WITH BATTERY BACK-UP, REF. ELECTRICAL PLANS.
 - EMERGENCY LIGHT WITH BATTERY BACK-UP, REF. ELECTRICAL PLANS.
 - WALL MOUNTED FIRE EXTINGUISHER 2A-10-BC, TYP.
 - DOCK BUMPER, TYP.
 - 3070 INSULATED METAL DOOR IN HOLLOW METAL FRAME WITH 1/2" MAX. ALUM. THRESHOLD, DOOR WITH PANIC HARDWARE, KEYS LOCKSET, DOOR STOP, WEATHER STRIPPING AND AUTO CLOSURE.
 - W8 x 10 COLUMN, TYP.
 - 6" x 12 GA. CEE JAMB, TYP.
 - 14 GA. BASE ANGLE, TYP.
 - 2 1/2" x 6" x 14 GA. ZEE GIRT, TYP.
 - W8 x 10 BEAM, TYP.
 - 6" x 3" EAVE STRUT, TYP.
 - 2 1/2" x 6" x 14 GA. ZEE PURLIN, TYP.
 - 26 GA. PRB ROOF PANEL, TYP.
 - CONT. METAL EAVE GUTTER TRIM AND DOWNSPOUT (DOWNSPOUT NOT SHOWN).
 - CONT. RAKE/GABLE METAL TRIM, TYP.
 - METAL CORNER TRIM, TYP.
 - METAL HEAD TRIM, TYP.
 - METAL JAMB TRIM, TYP.
 - CONT. METAL WALL BASE TRIM, TYP.
 - CONT. METAL WALL BASE FLASHING, TYP.
 - R-20 VINYL FACED INSULATION, FULL COVERAGE, TYP.
 - R-13 VINYL FACED INSULATION, FULL HEIGHT OF WALL, TYP.
 - 6" x 14 GA. CEE HEADER, TYP.
 - NEW DENING WALL, REF. OVERALL FLOOR PLAN FOR WALL CONTINUATION AND WALL TYPE TAG.
 - CROSS HATCH DENOTES EXIST. EXTERIOR WALL.
 - EXIST. CONC. SLAB, TYP.
 - EXIST. CONC. COLUMN FOOTING, TYP.
 - NEW CONC. DOCK WALL, REF. FOUNDATION PLANS.
 - NEW CONC. SLAB AT NEW DOCK.
 - 42" HIGH MIN. 1 1/4" DIA. PAINTED STEEL GUARDRAIL, G.C. TO INSTALL GUARDRAIL PER 2021 I.B.C. SECTION 1015.2. GUARDS SHALL BE LOCATED ALONG OPEN-SIDED WALKING SURFACES THAT ARE LOCATED MORE THAN 30 INCHES MEASURED VERTICALLY TO THE FLOOR OR GRADE BELOW, G.C. TO FIELD VERIFY GUARDRAIL LENGTH TO BE BUILT.
 - CORE DRILL CONC. RETAINING WALL FOR GUARDRAIL POST AND EPOXY POST IN PLACE, TYP., GUARDRAIL POSTS AT 8'-0" O.C. MAX.
 - 4" THICK x 5' x 5' CONCRETE STOOP AT EXIT DOOR, SLOPE CONC. 1/4" FT. SLOPE MIN. AWAY FOR DOOR.
 - EXIST. STOREFRONT DOOR TO REMAIN, G.C. TO ADD NEW DOOR HARDWARE, PANIC BAR, KEYS LOCKSET, DOOR STOP, AUTO CLOSURE, WEATHER STRIPPING, NEW 1/2" MAX. ALUM. THRESHOLDS AND NEW LIGHTER EXIT SIGNS WITH BATTERY BACK-UP AS REQUIRED.

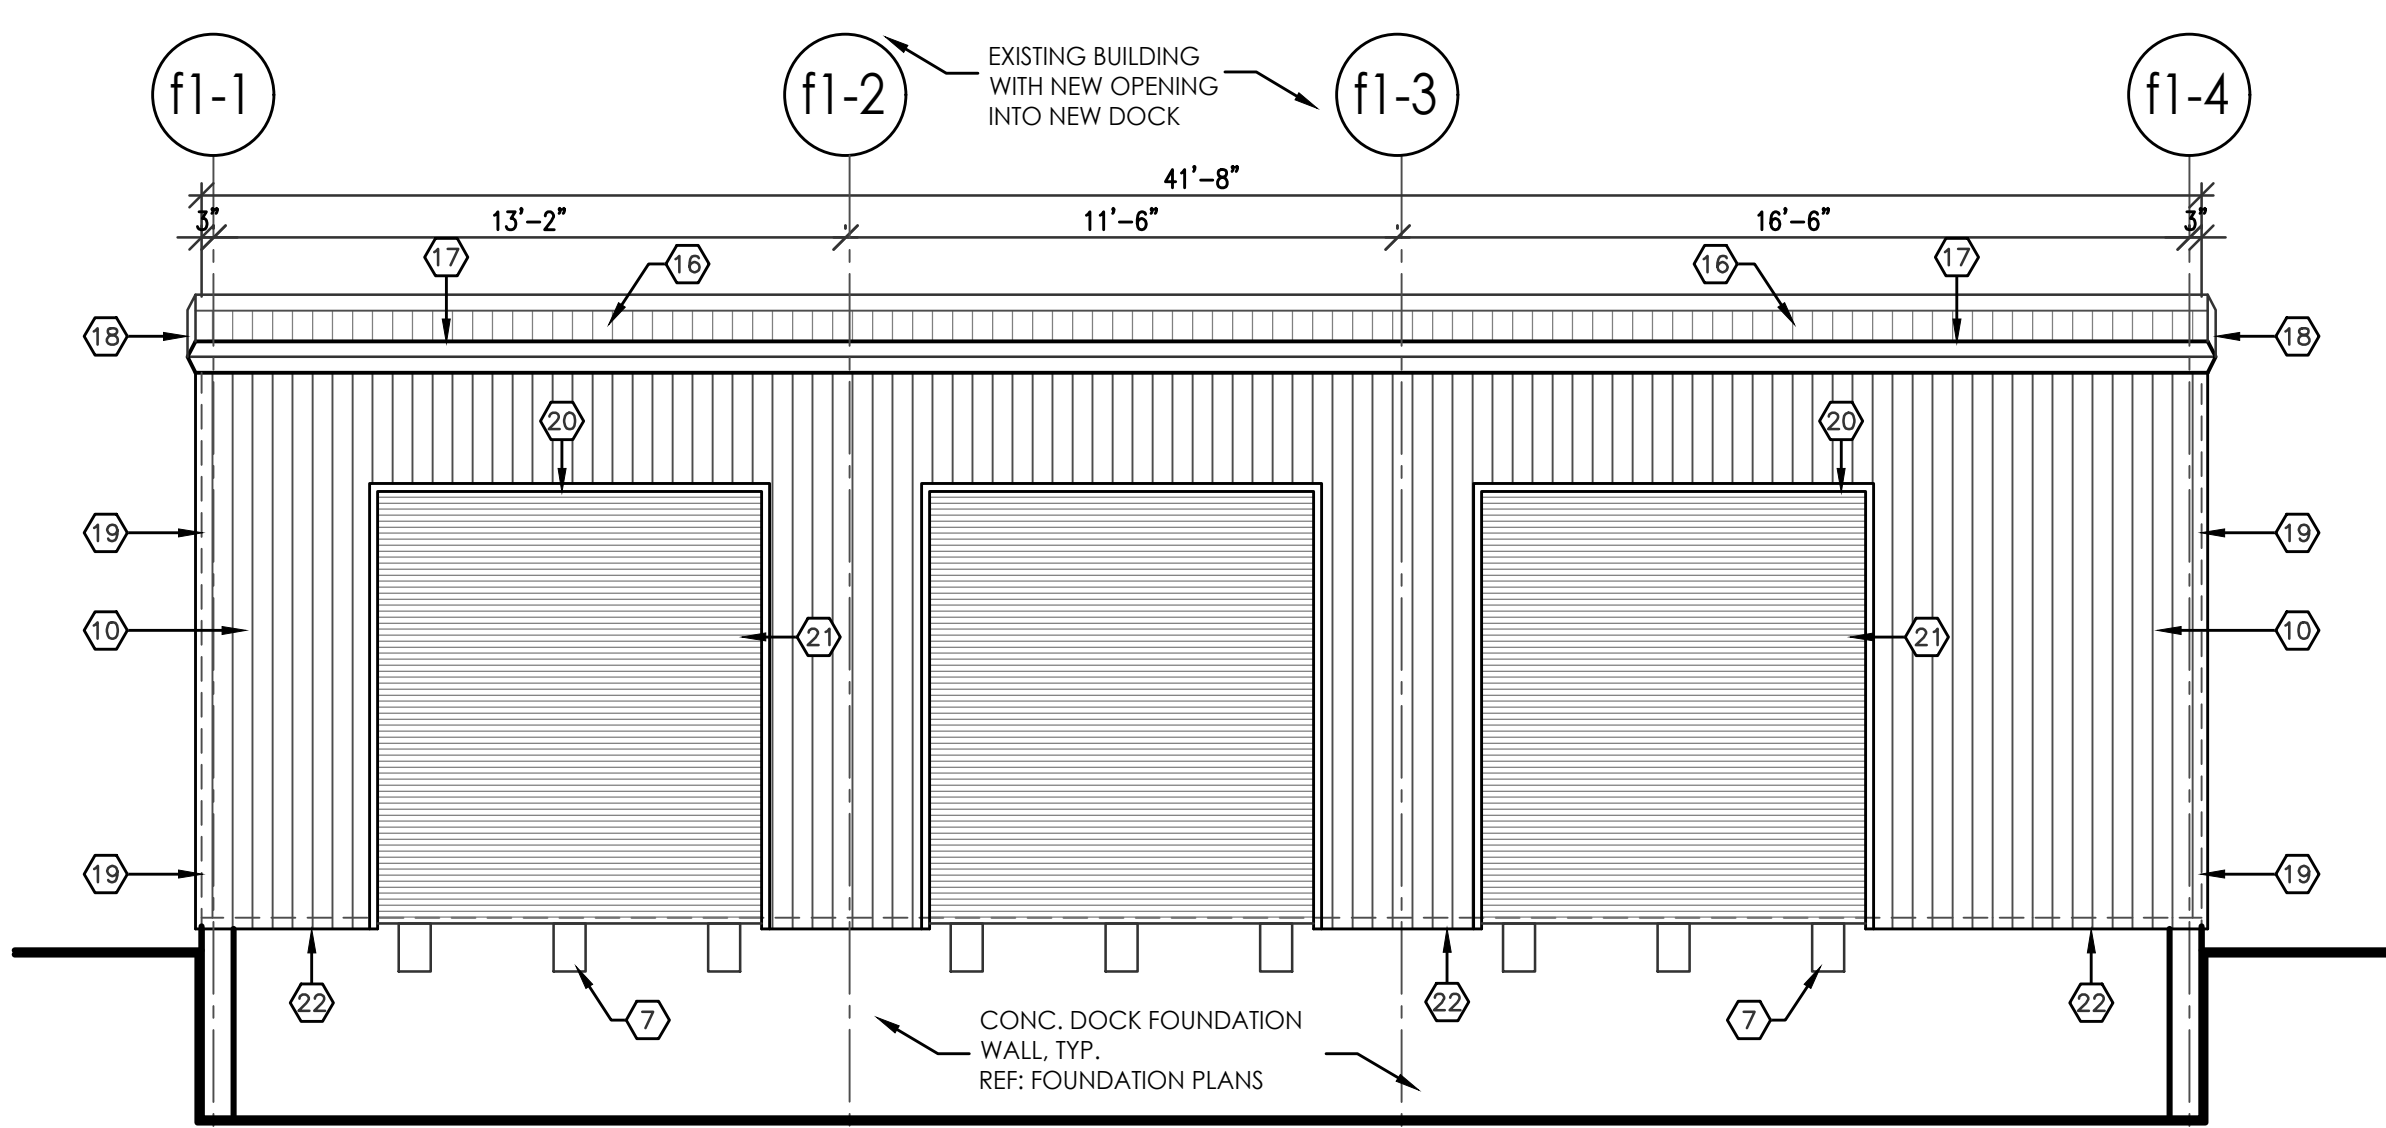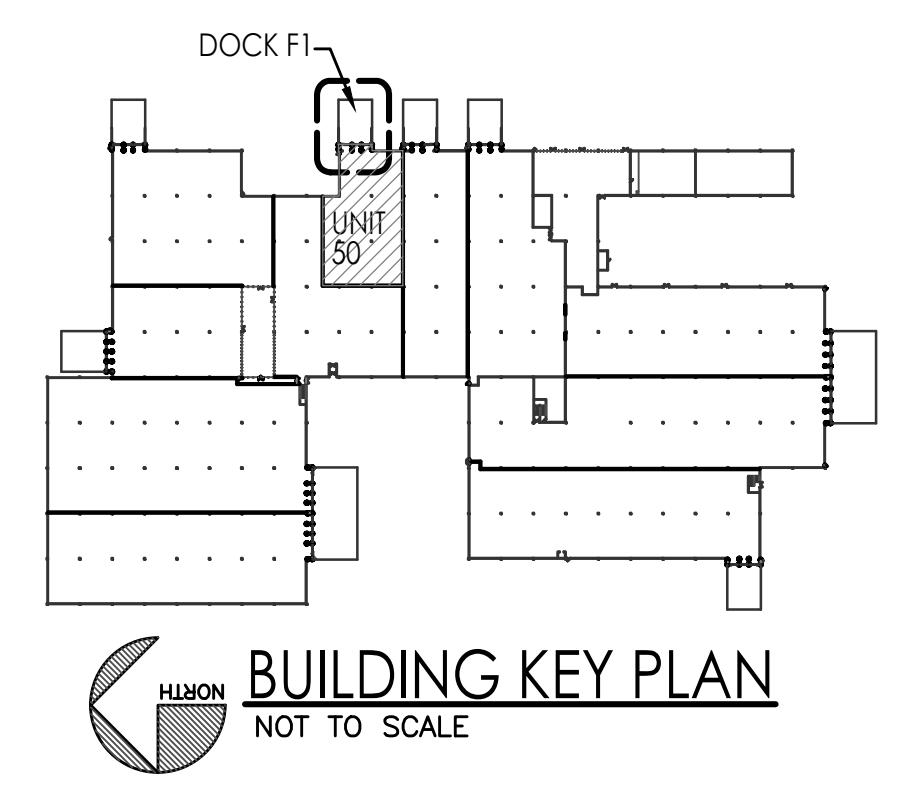


5 DOCK F1 EAST ELEVATION
SCALE: 1/4"=1'-0"

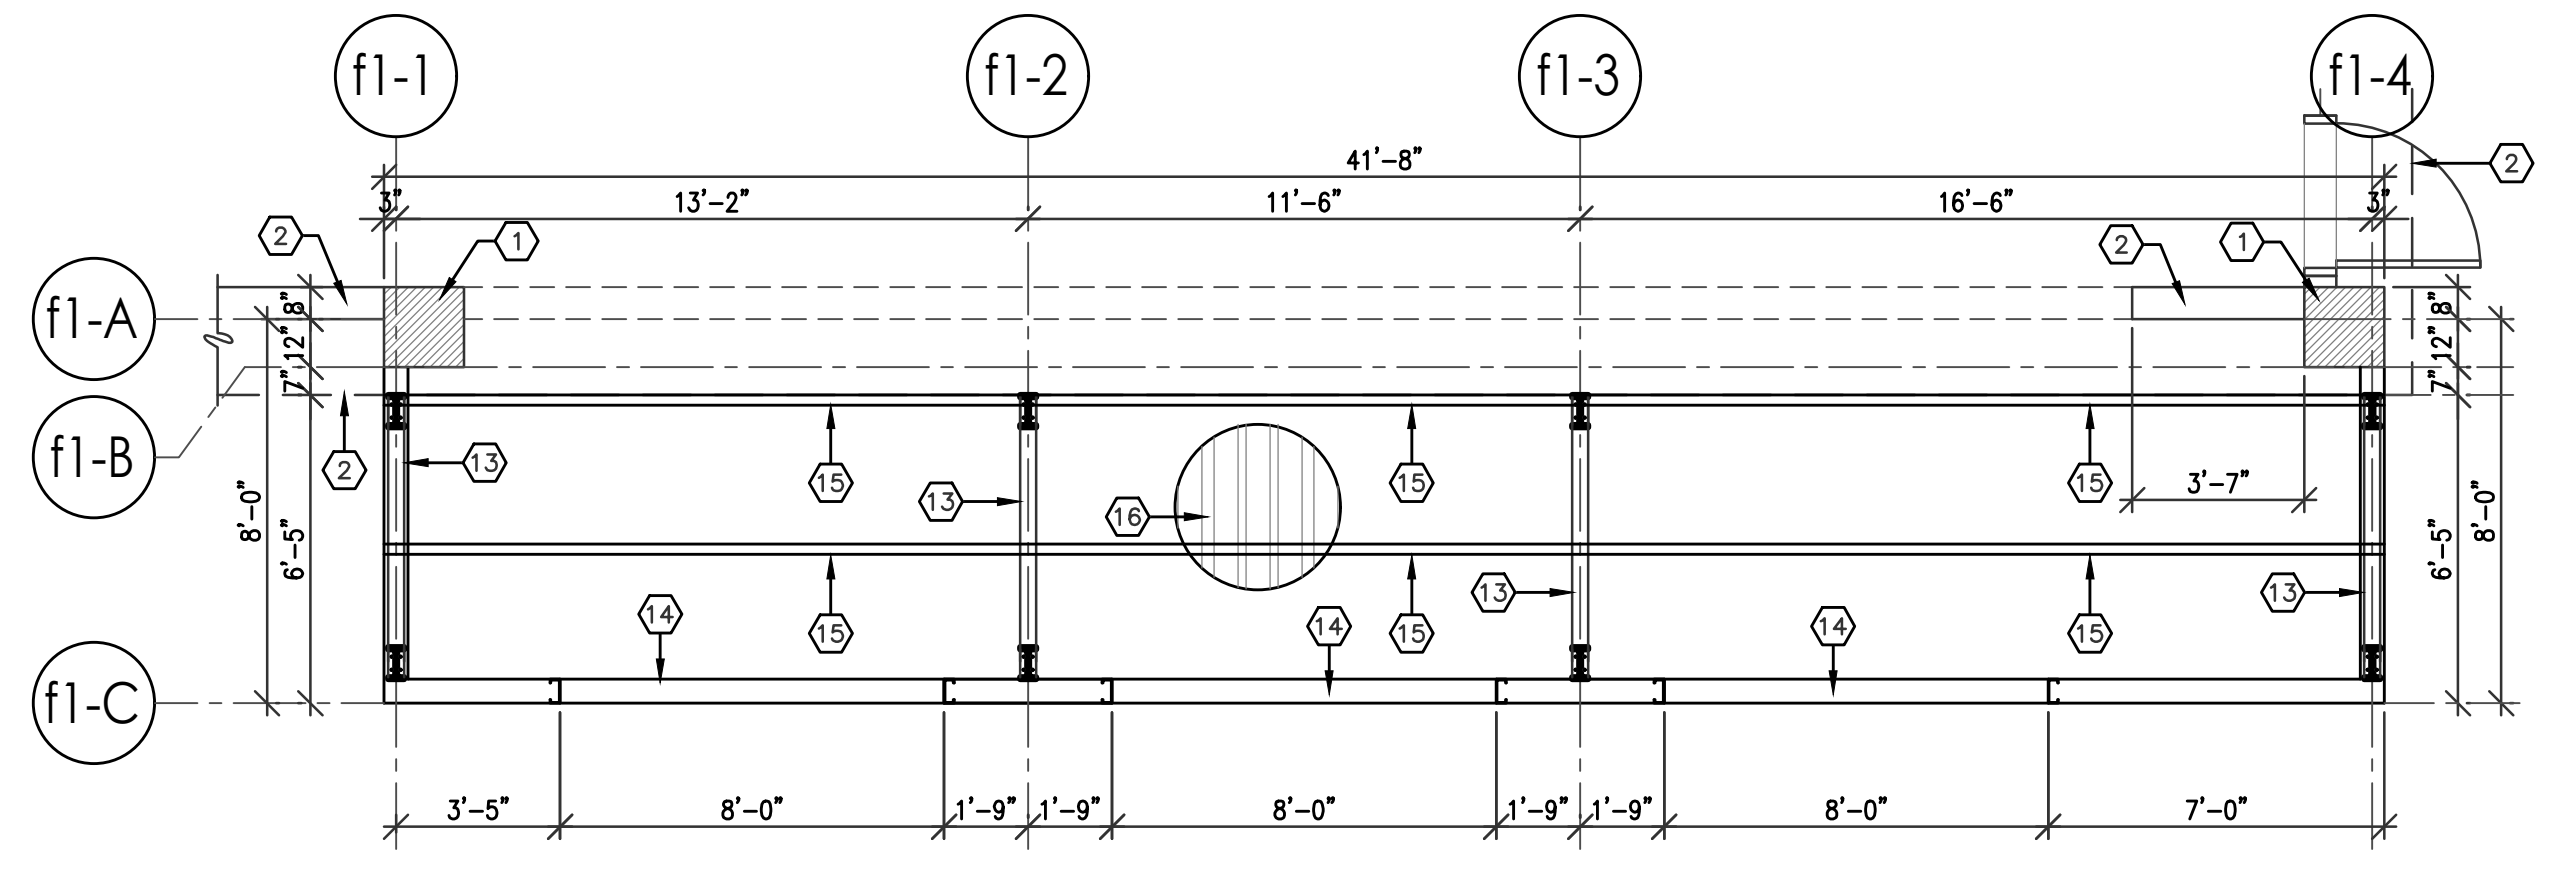


3 DOCK F1 ROOF FRAME PLAN
SCALE: 1/4"=1'-0"

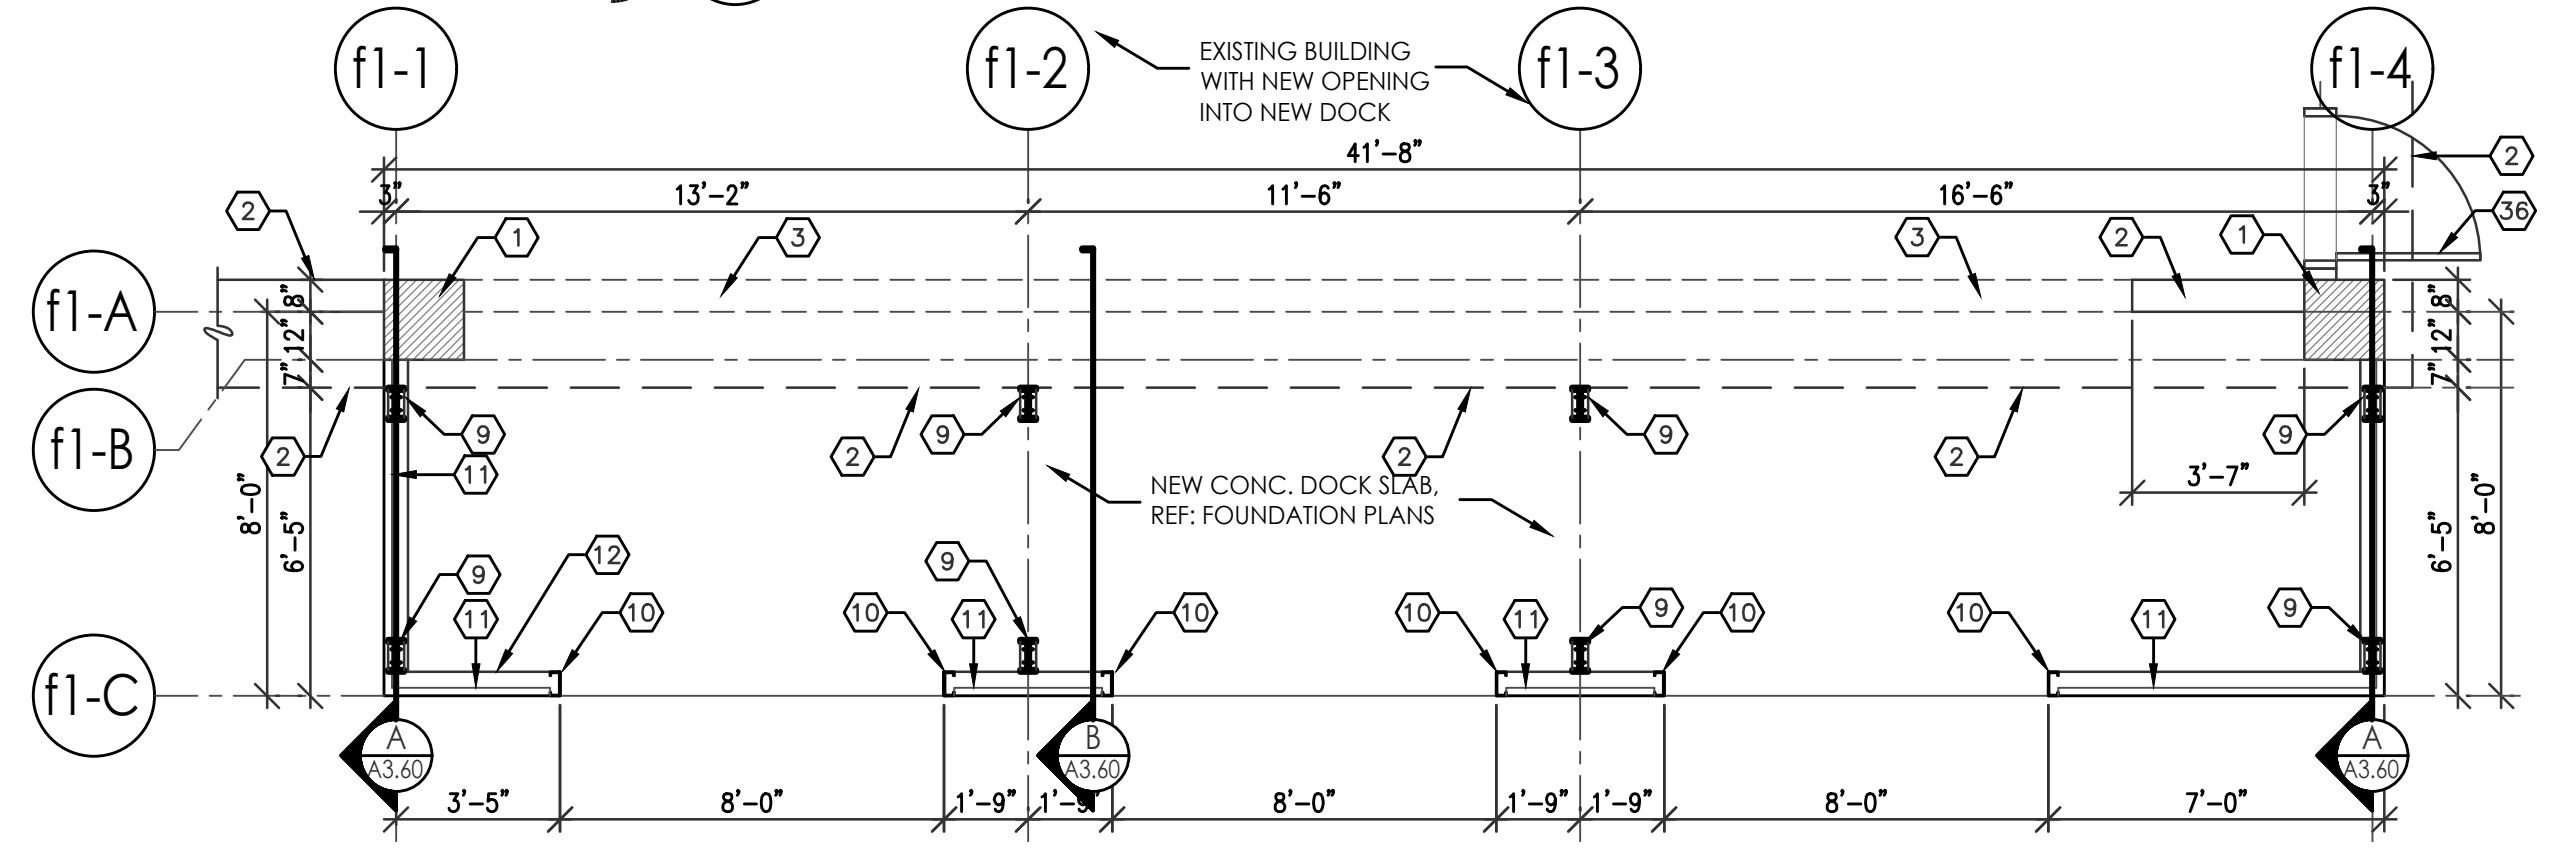

2 DOCK F1 WALL FRAME PLAN
SCALE: 1/4"=1'-0"

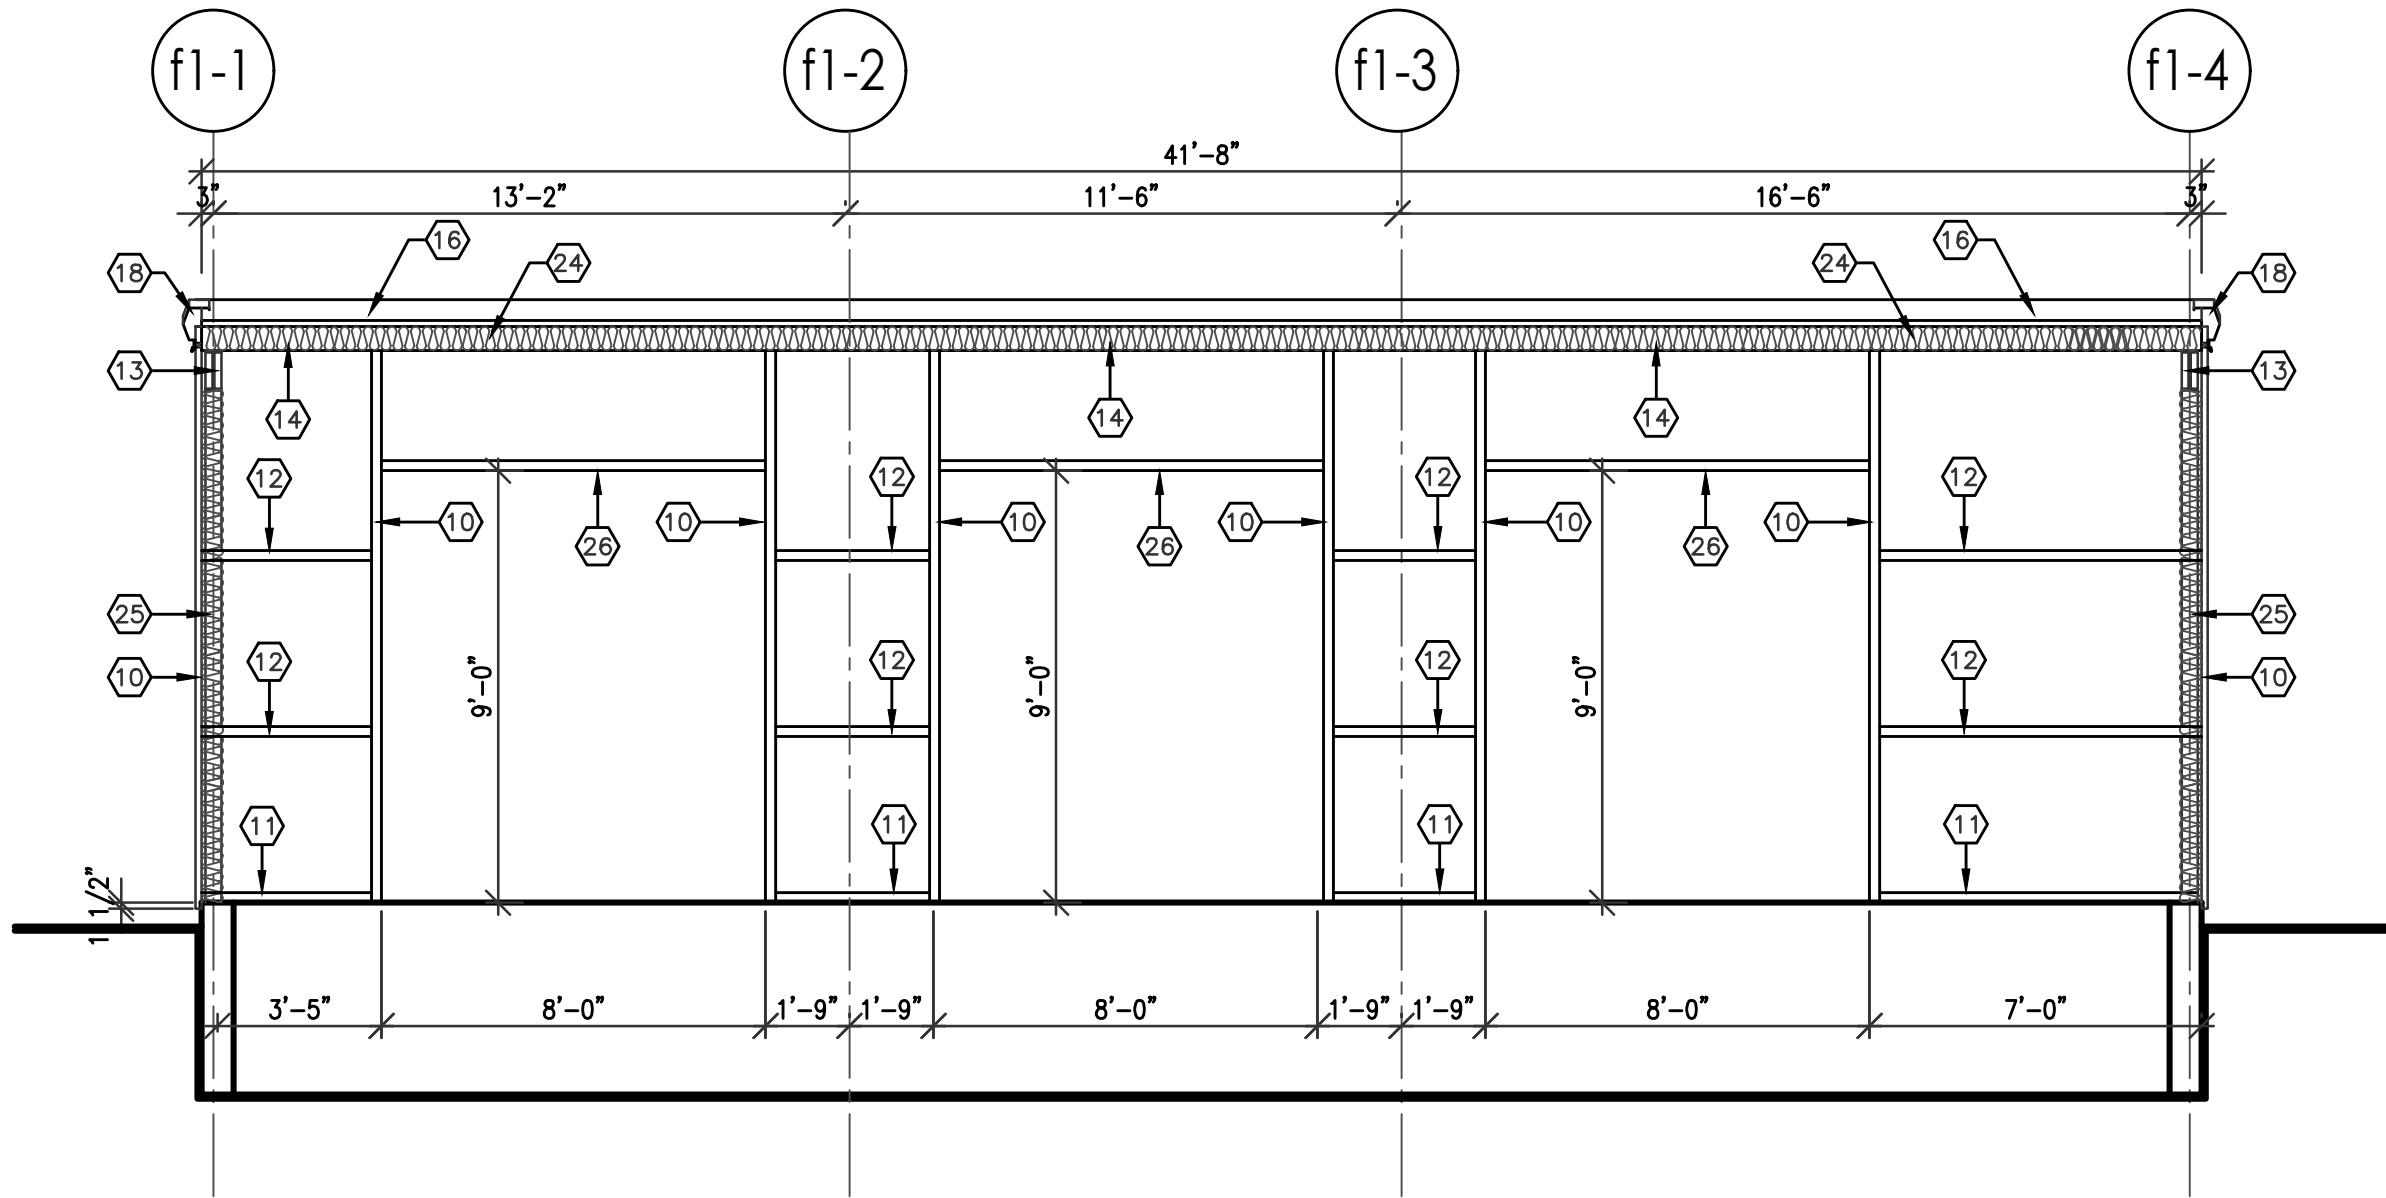

DOCK F1 WALL FRAME ELEVATION
SCALE: 1/4"=1'-0"

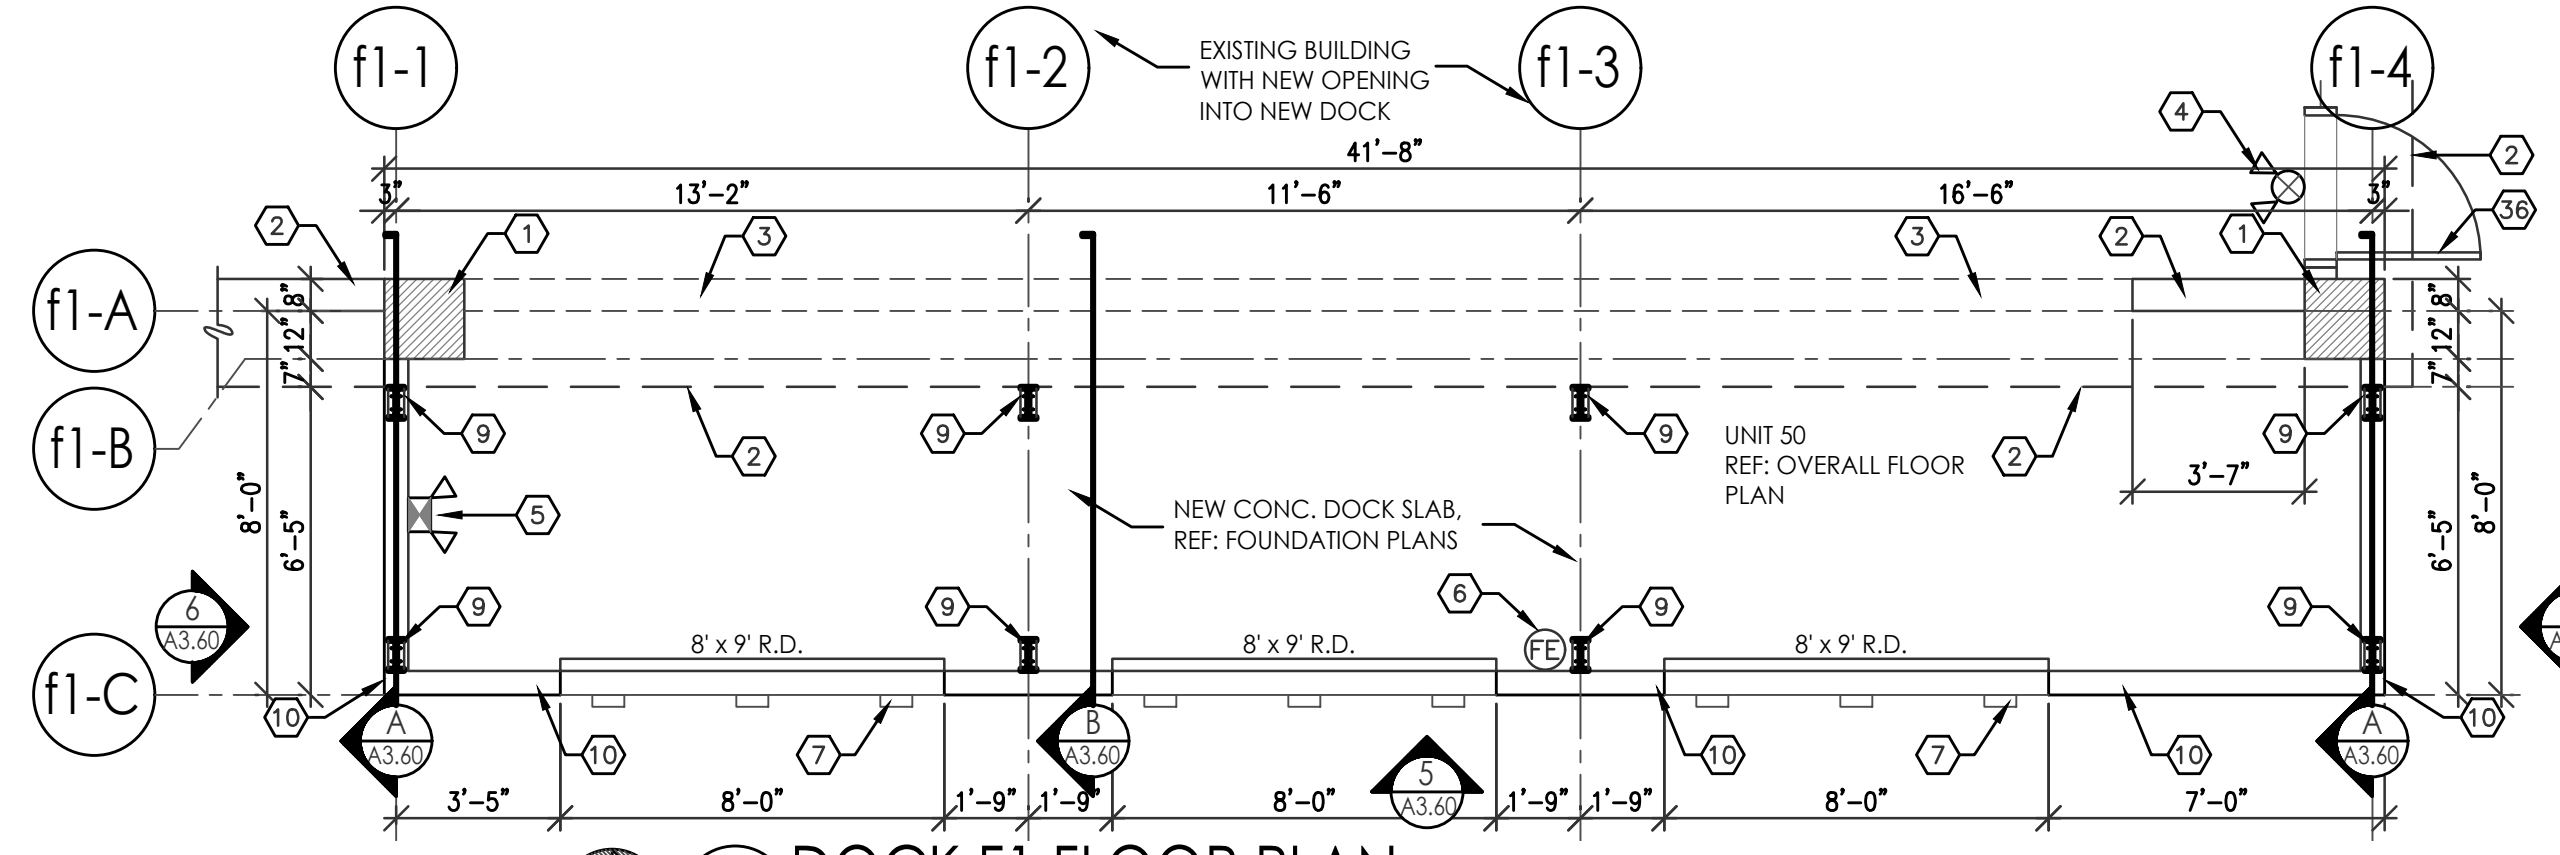


1 DOCK F1 FLOOR PLAN
SCALE: 1/4"=1'-0"







NEW DOCK F1 ADDITION
AREA = 333 S.F.

HONEYWELL WAREHOUSES
DOCK F1 ARCH AND STRUCTURAL PLANS
9201 SAN MATEO BLVD NE.
ALBUQUERQUE, NM 87113
#2354

REVISION DATE
<p>RBA ARCHITECTURE, P.C. ARCHITECTURE, PLANNING & DESIGN 10000 N. ALBUQUERQUE BLVD. SUITE 100 ALBUQUERQUE, NM 87112 WWW.RBAARCHITECTURE.COM</p>
DATE 3/22/2024
SHEET NUMBER A-3.60

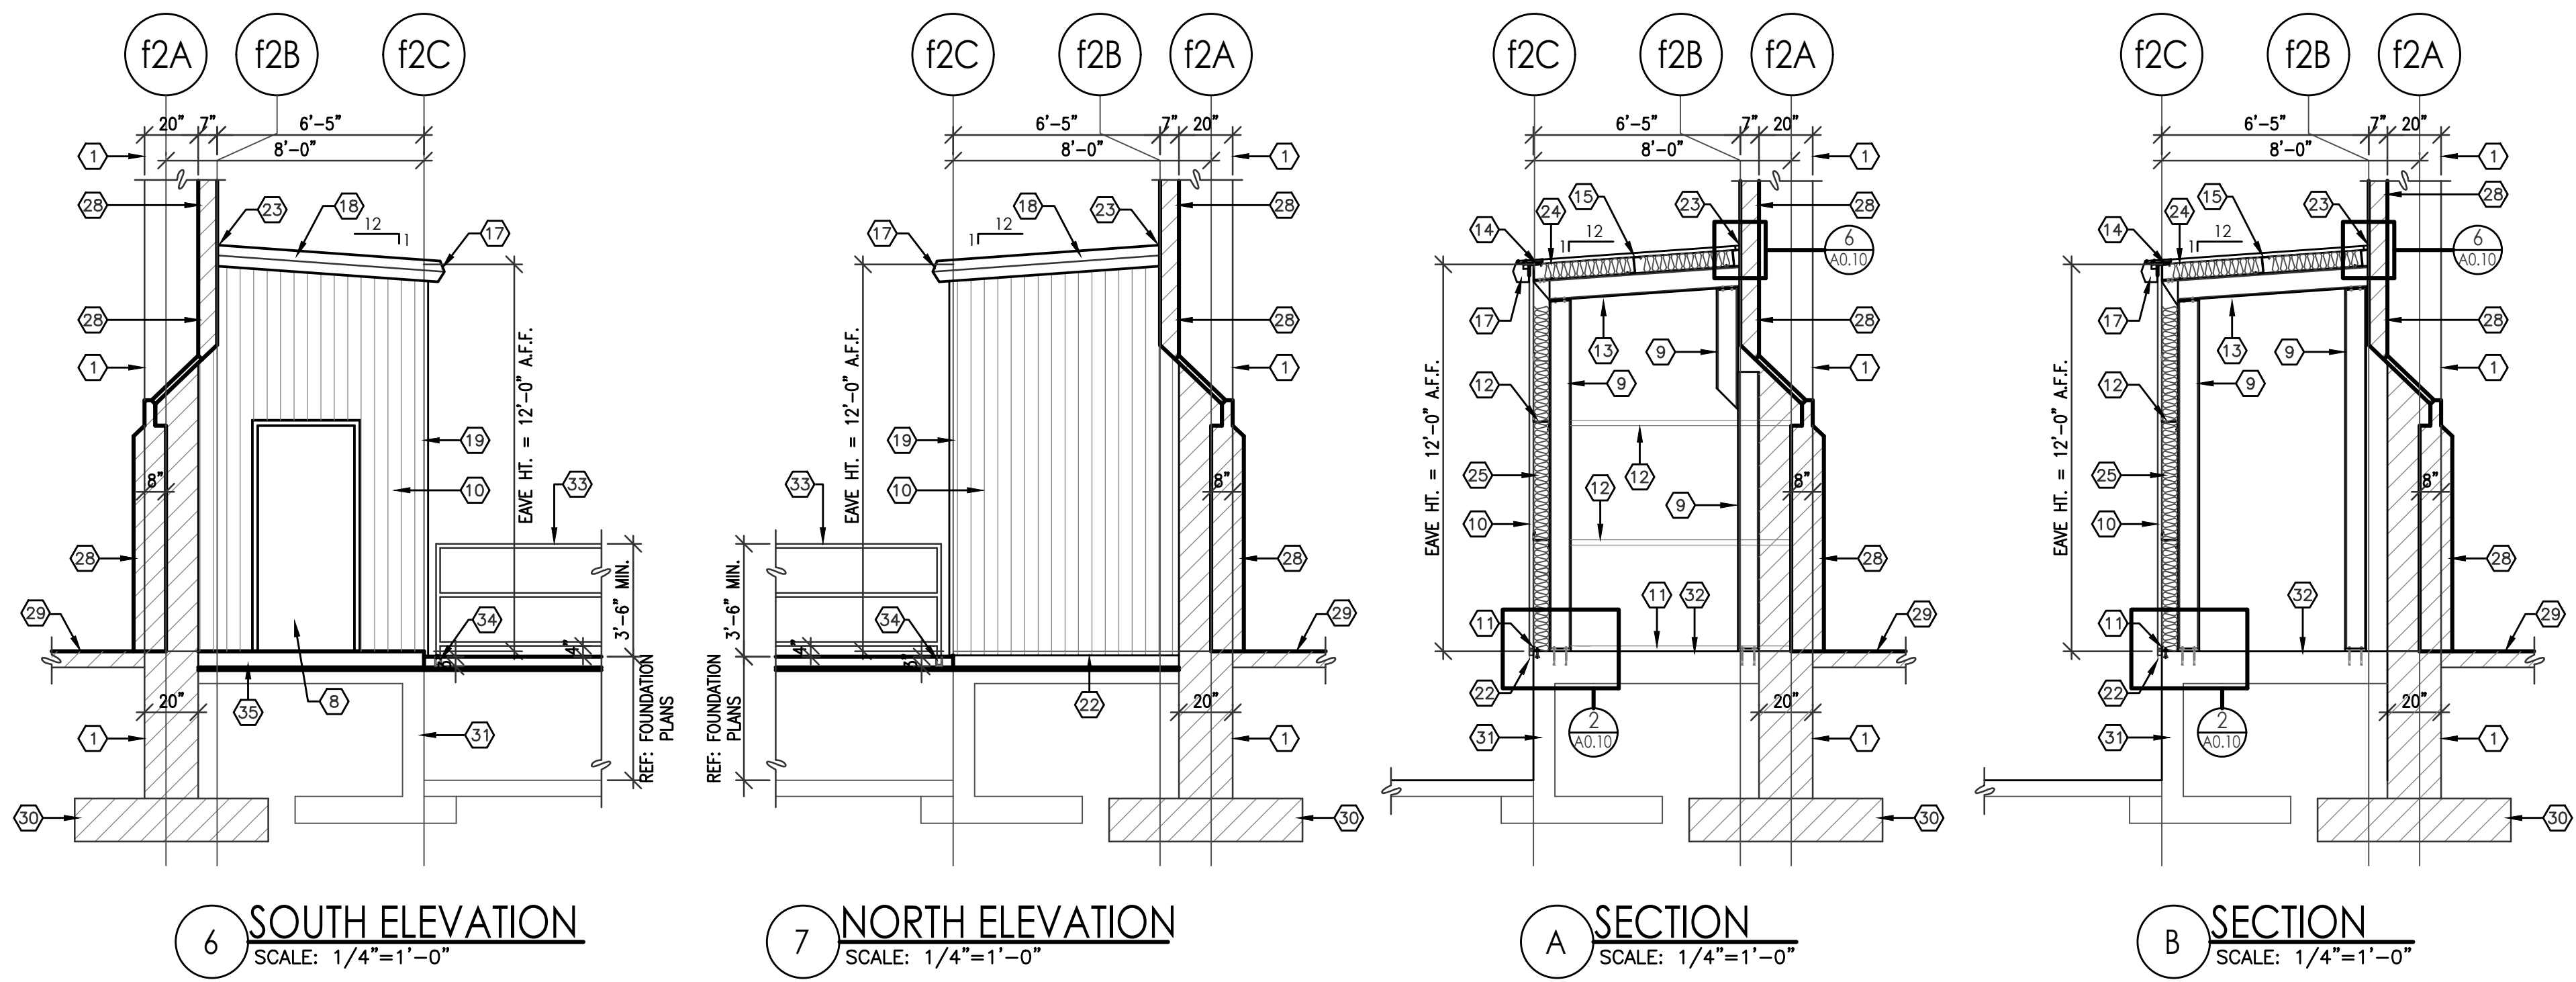


- KEYED NOTES**
- EXISTING 20" x 20" CONCRETE COLUMN.
 - EXISTING EXTERIOR WALL.
 - EXISTING WALL TO BE REMOVED.
 - COMBINATION EXIT SIGN AND EMERGENCY LIGHT WITH BATTERY BACK-UP, REF: ELECTRICAL PLANS.
 - EMERGENCY LIGHT WITH BATTERY BACK-UP, REF: ELECTRICAL PLANS.
 - WALL MOUNTED FIRE EXTINGUISHER 2A-10-BC, TYP.
 - DOCK BUMPERS, TYP.
 - 3070 INSULATED METAL DOOR IN HOLLOW METAL FRAME WITH 1/2" MAX. ALUM. THRESHOLD, DOOR WITH PANIC HARDWARE, KEYED LOCKSET, DOOR STOP, WEATHER STRIPPING AND AUTO CLOSURE.
 - W8 x 10 COLUMN, TYP.
 - 6" x 12 GA. CEE JAMB, TYP.
 - 14 GA. BASE ANGLE, TYP.
 - 2 1/2" x 6" x 14 GA. ZEE GIRT, TYP.
 - W8 x 10 BEAM, TYP.
 - 6" x 3" EAVE STRUT, TYP.
 - 2 1/2" x 6" x 14 GA. ZEE PURLIN, TYP.
 - 26 GA. PRB ROOF PANEL, TYP.
 - CONT. METAL EAVE GUTTER TRIM AND DOWNSPOUT (DOWNSPOUT NOT SHOWN).
 - CONT. RAKE/GABLE METAL TRIM, TYP.
 - METAL CORNER TRIM, TYP.
 - METAL HEAD TRIM, TYP.
 - METAL JAMB TRIM, TYP.
 - CONT. METAL WALL BASE TRIM, TYP.
 - CONT. METAL WALL BASE FLASHING, TYP.
 - R-20 VINYL FACED INSULATION, FULL COVERAGE, TYP.
 - R-13 VINYL FACED INSULATION, FULL HEIGHT OF WALL, TYP.
 - 6" x 14 GA. CEE HEADER, TYP.
 - NEW DENISING WALL, REF: OVERALL FLOOR PLAN FOR WALL CONTINUATION AND WALL TYPE TAG.
 - CROSS HATCH DENOTES EXIST. EXTERIOR WALL.
 - EXIST. CONC. SLAB, TYP.
 - EXIST. CONC. COLUMN FOOTING, TYP.
 - NEW CONC. DOCK WALL, REF: FOUNDATION PLANS.
 - NEW CONC. SLAB AT NEW DOCK.
 - 42" HIGH MIN. 1 1/4" DIA. PAINTED STEEL GUARDRAIL, G.C. TO INSTALL GUARDRAIL PER 2021 I.B.C. SECTION 1015.2. GUARDS SHALL BE LOCATED ALONG OPEN-SIDED WALKING SURFACES THAT ARE LOCATED MORE THAN 30 INCHES MEASURED VERTICALLY TO THE FLOOR OR GRADE BELOW, G.C. TO FIELD VERIFY GUARDRAIL LENGTH TO BE BUILT.
 - CORE DRILL CONC. RETAINING WALL FOR GUARDRAIL POST AND EPOXY POST IN PLACE, TYP., GUARDRAIL POSTS AT 8'-0" O.C. MAX.
 - 4" THICK x 5' x 5' CONCRETE STOOP AT EXIT DOOR, SLOPE CONC. 1/4" FT. SLOPE MIN. AWAY FOR DOOR.
 - EXIST. STOREFRONT DOOR TO REMAIN, G.C. TO ADD NEW DOOR HARDWARE, PANIC BAR, KEYED LOCKSET, DOOR STOP, AUTO CLOSURE, WEATHER STRIPPING, NEW 1/2" MAX. ALUM. THRESHOLDS AND NEW LIGHTER EXIT SIGNS WITH BATTERY BACK-UP AS REQUIRED.

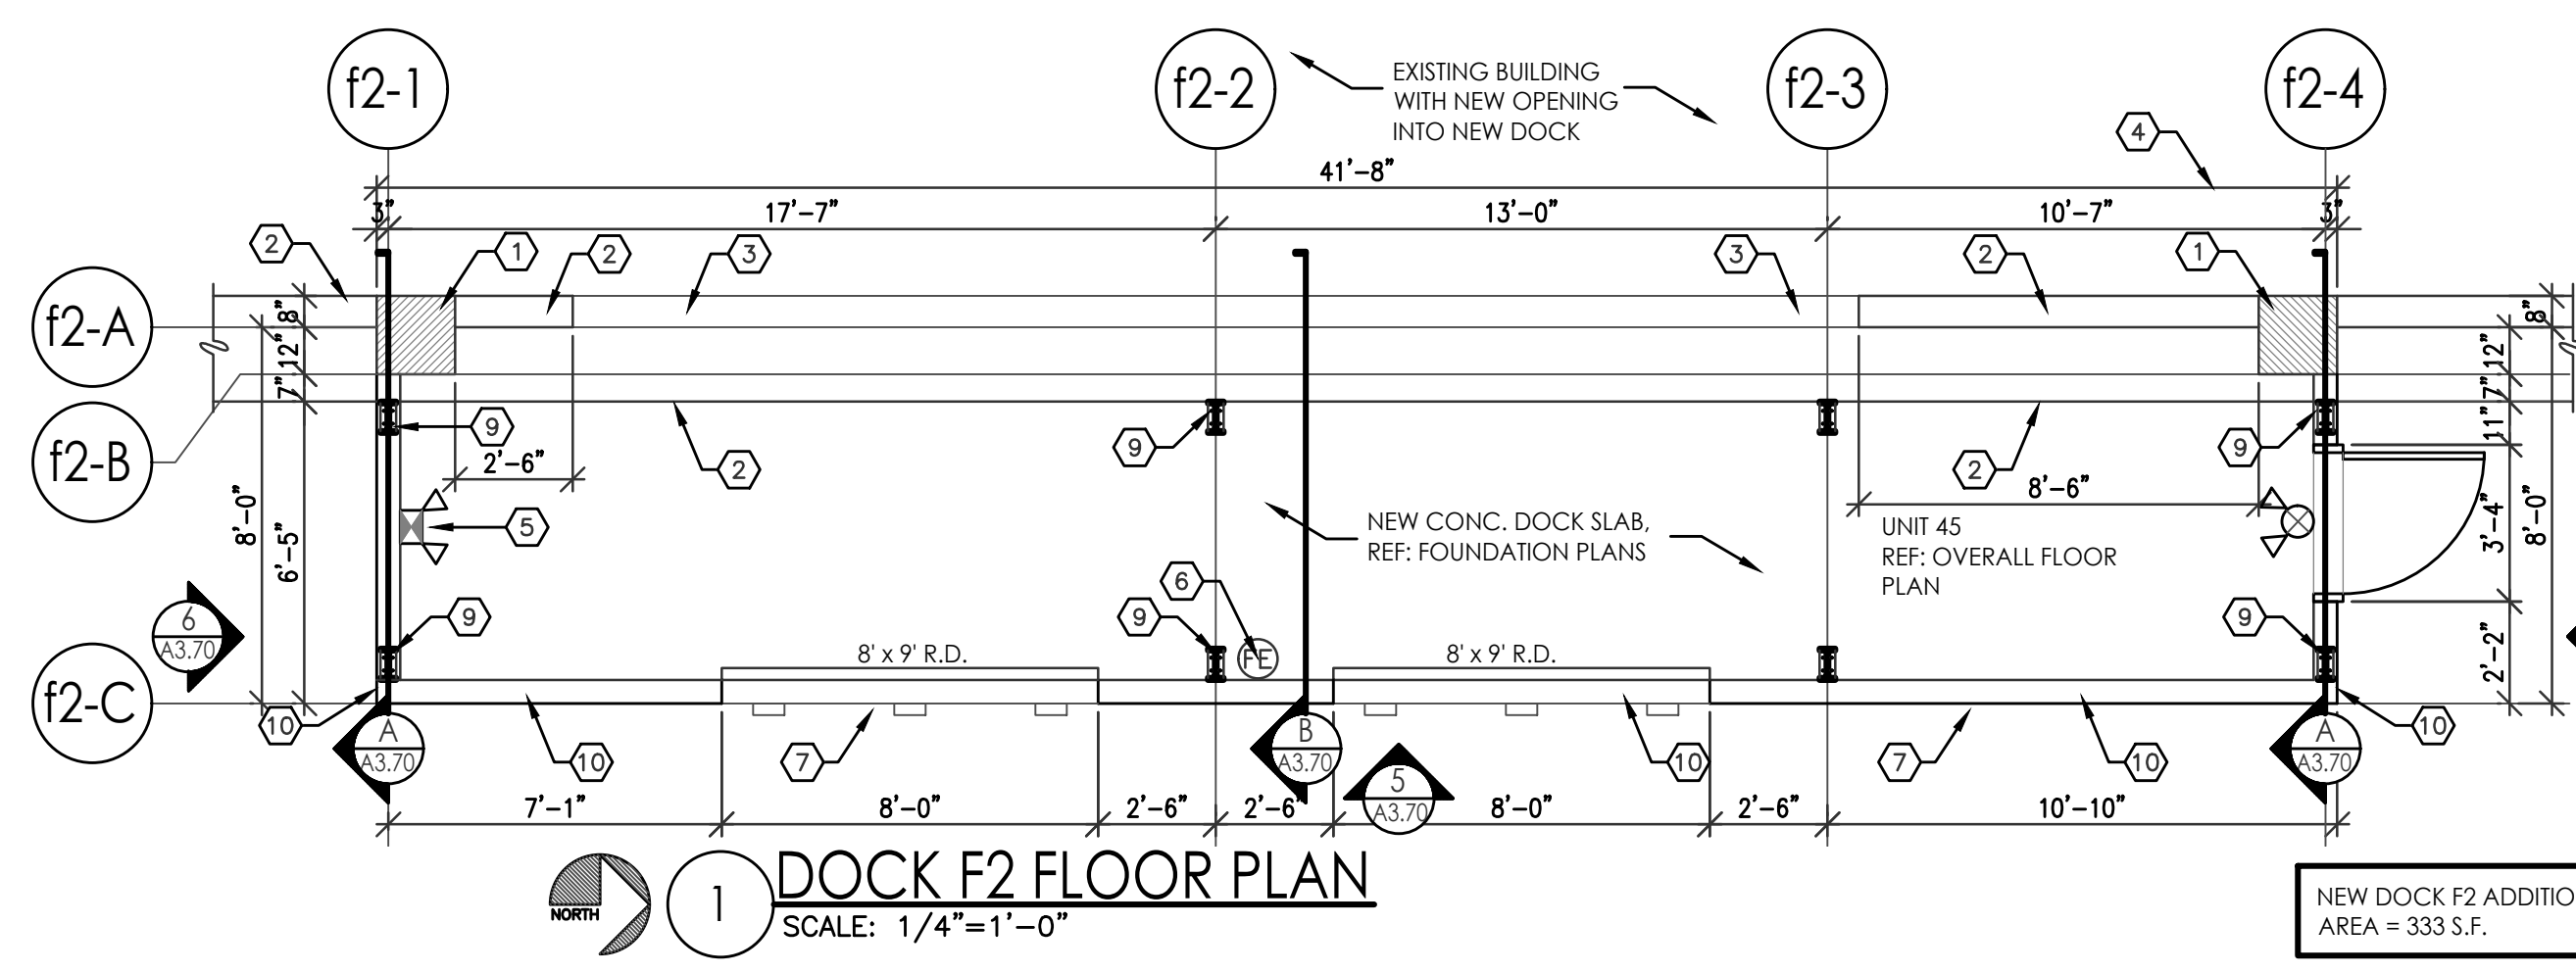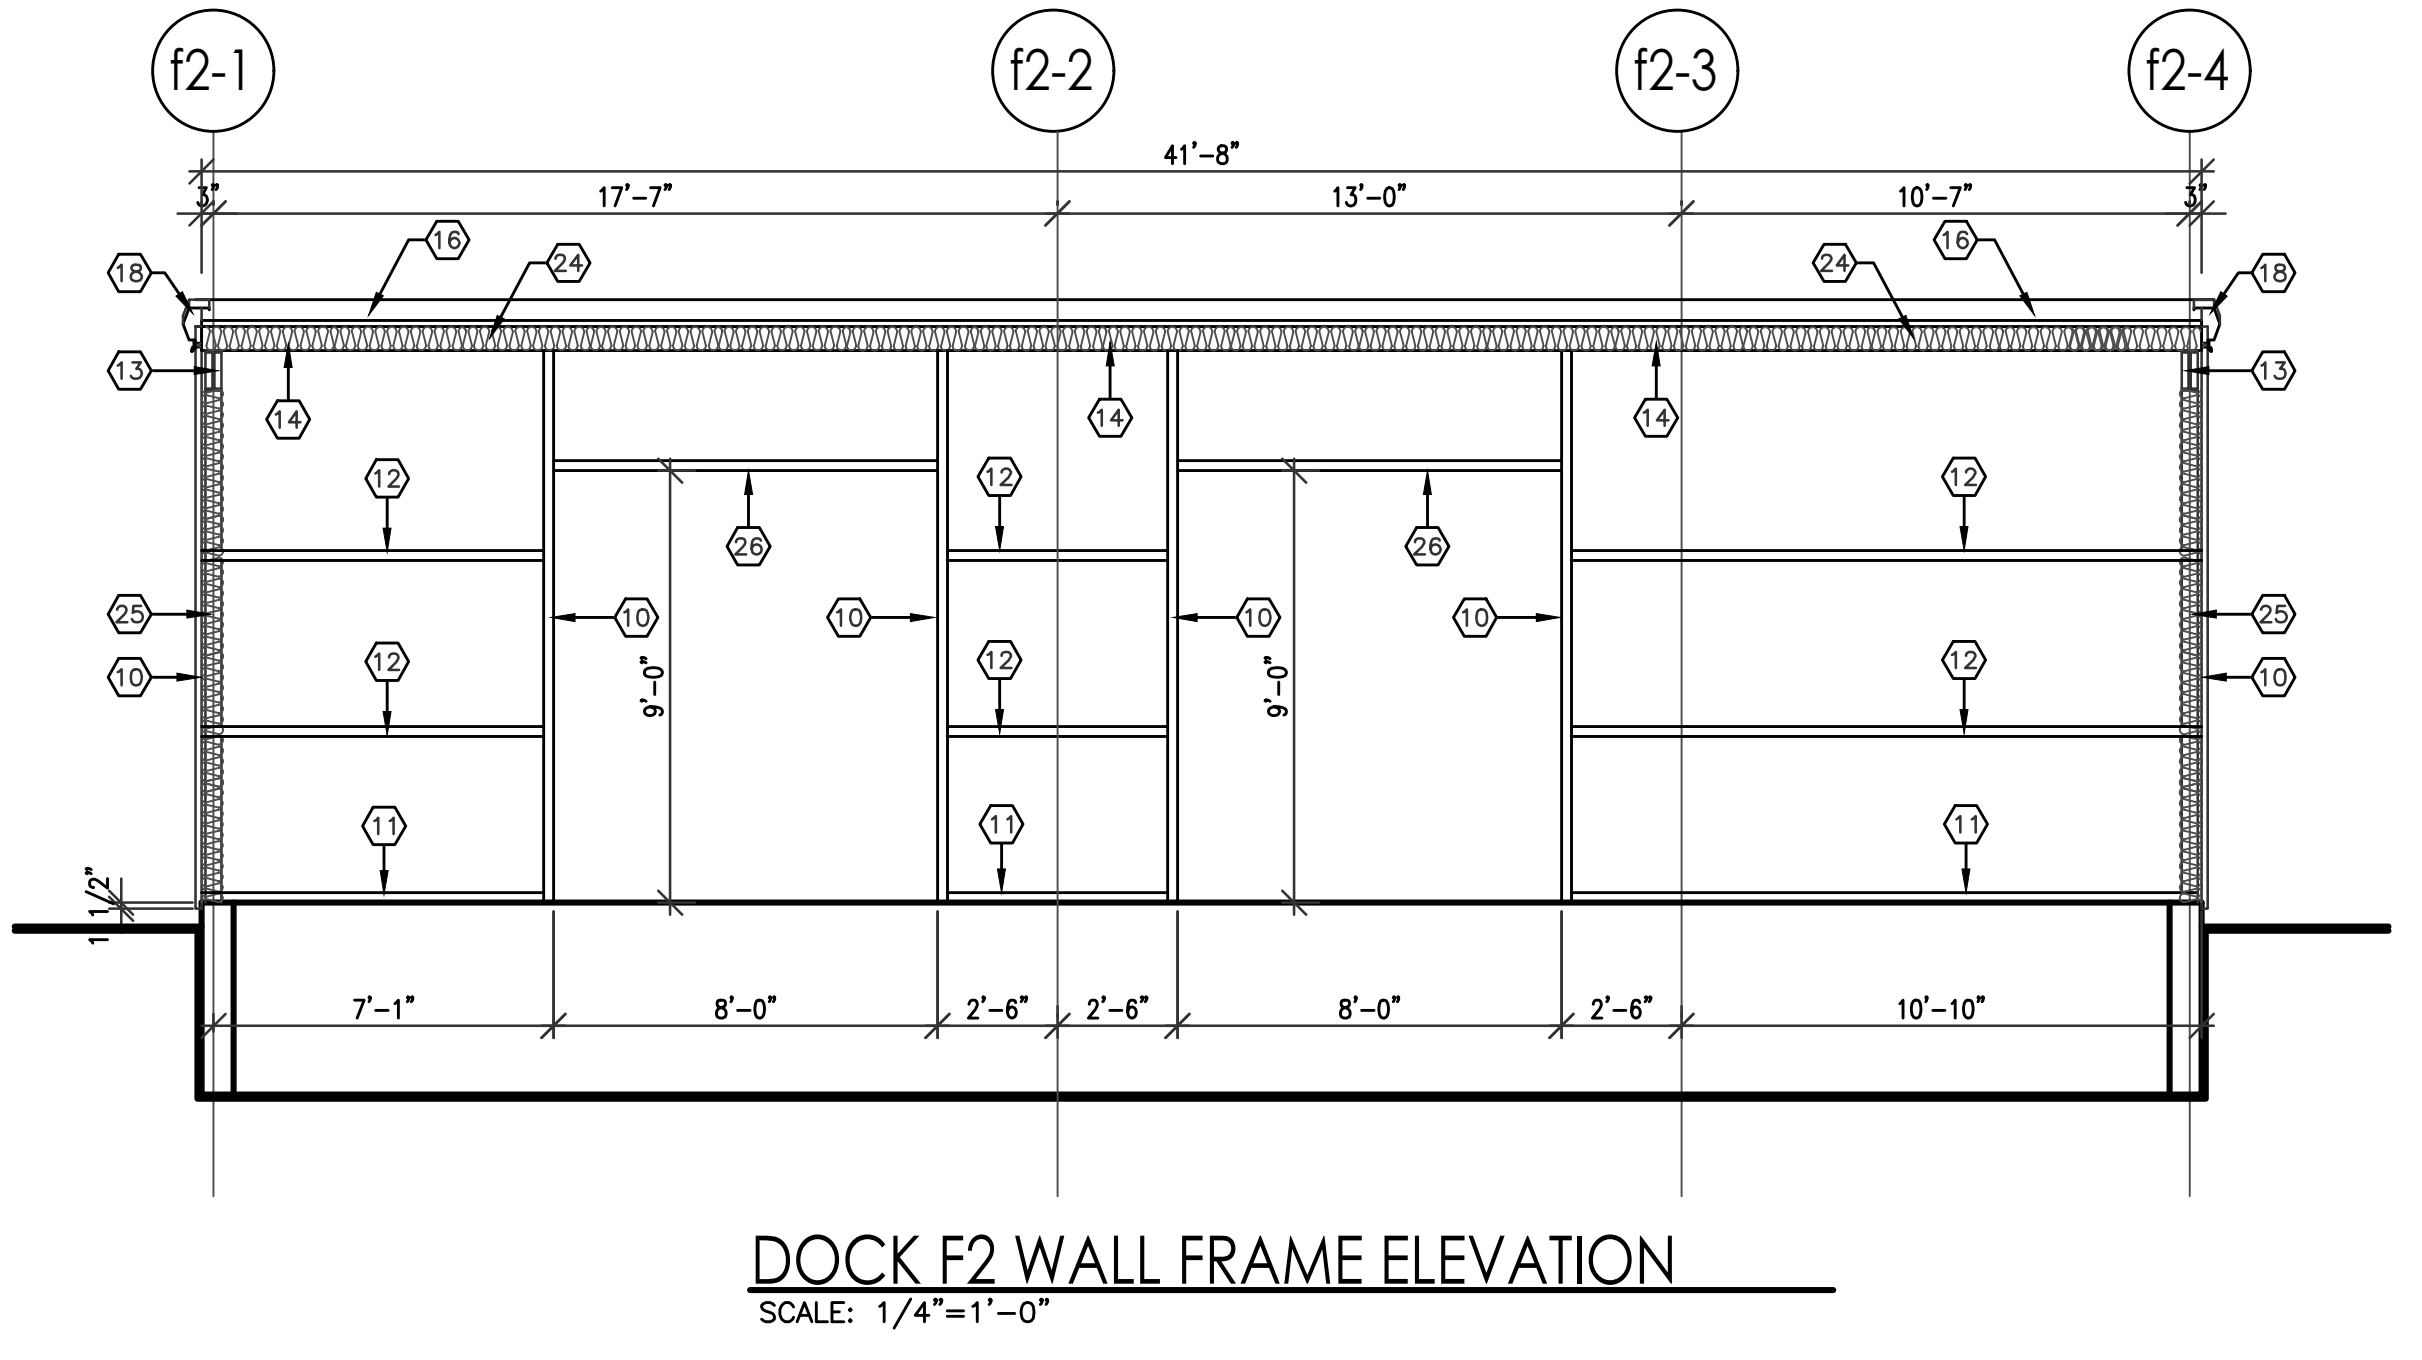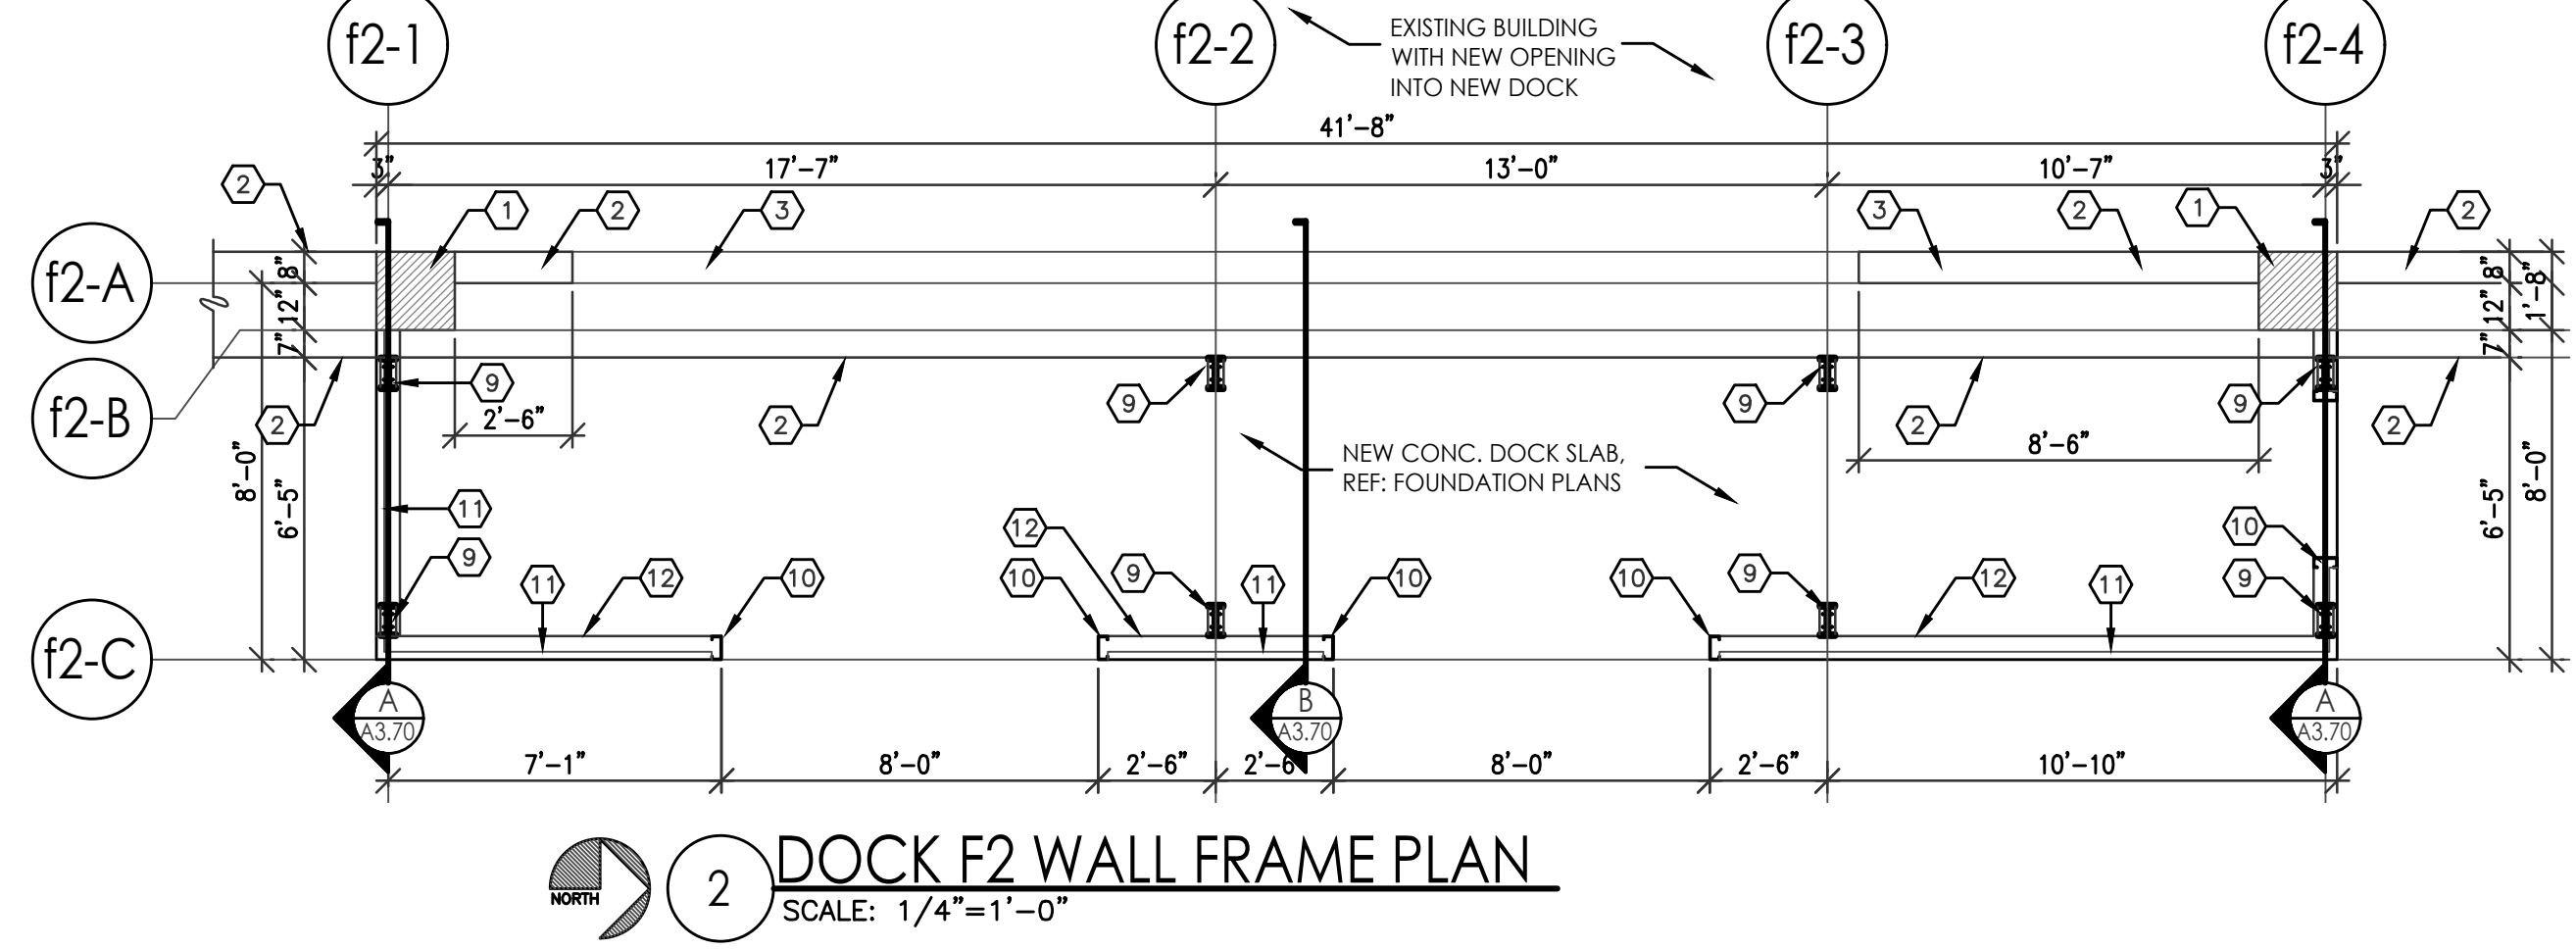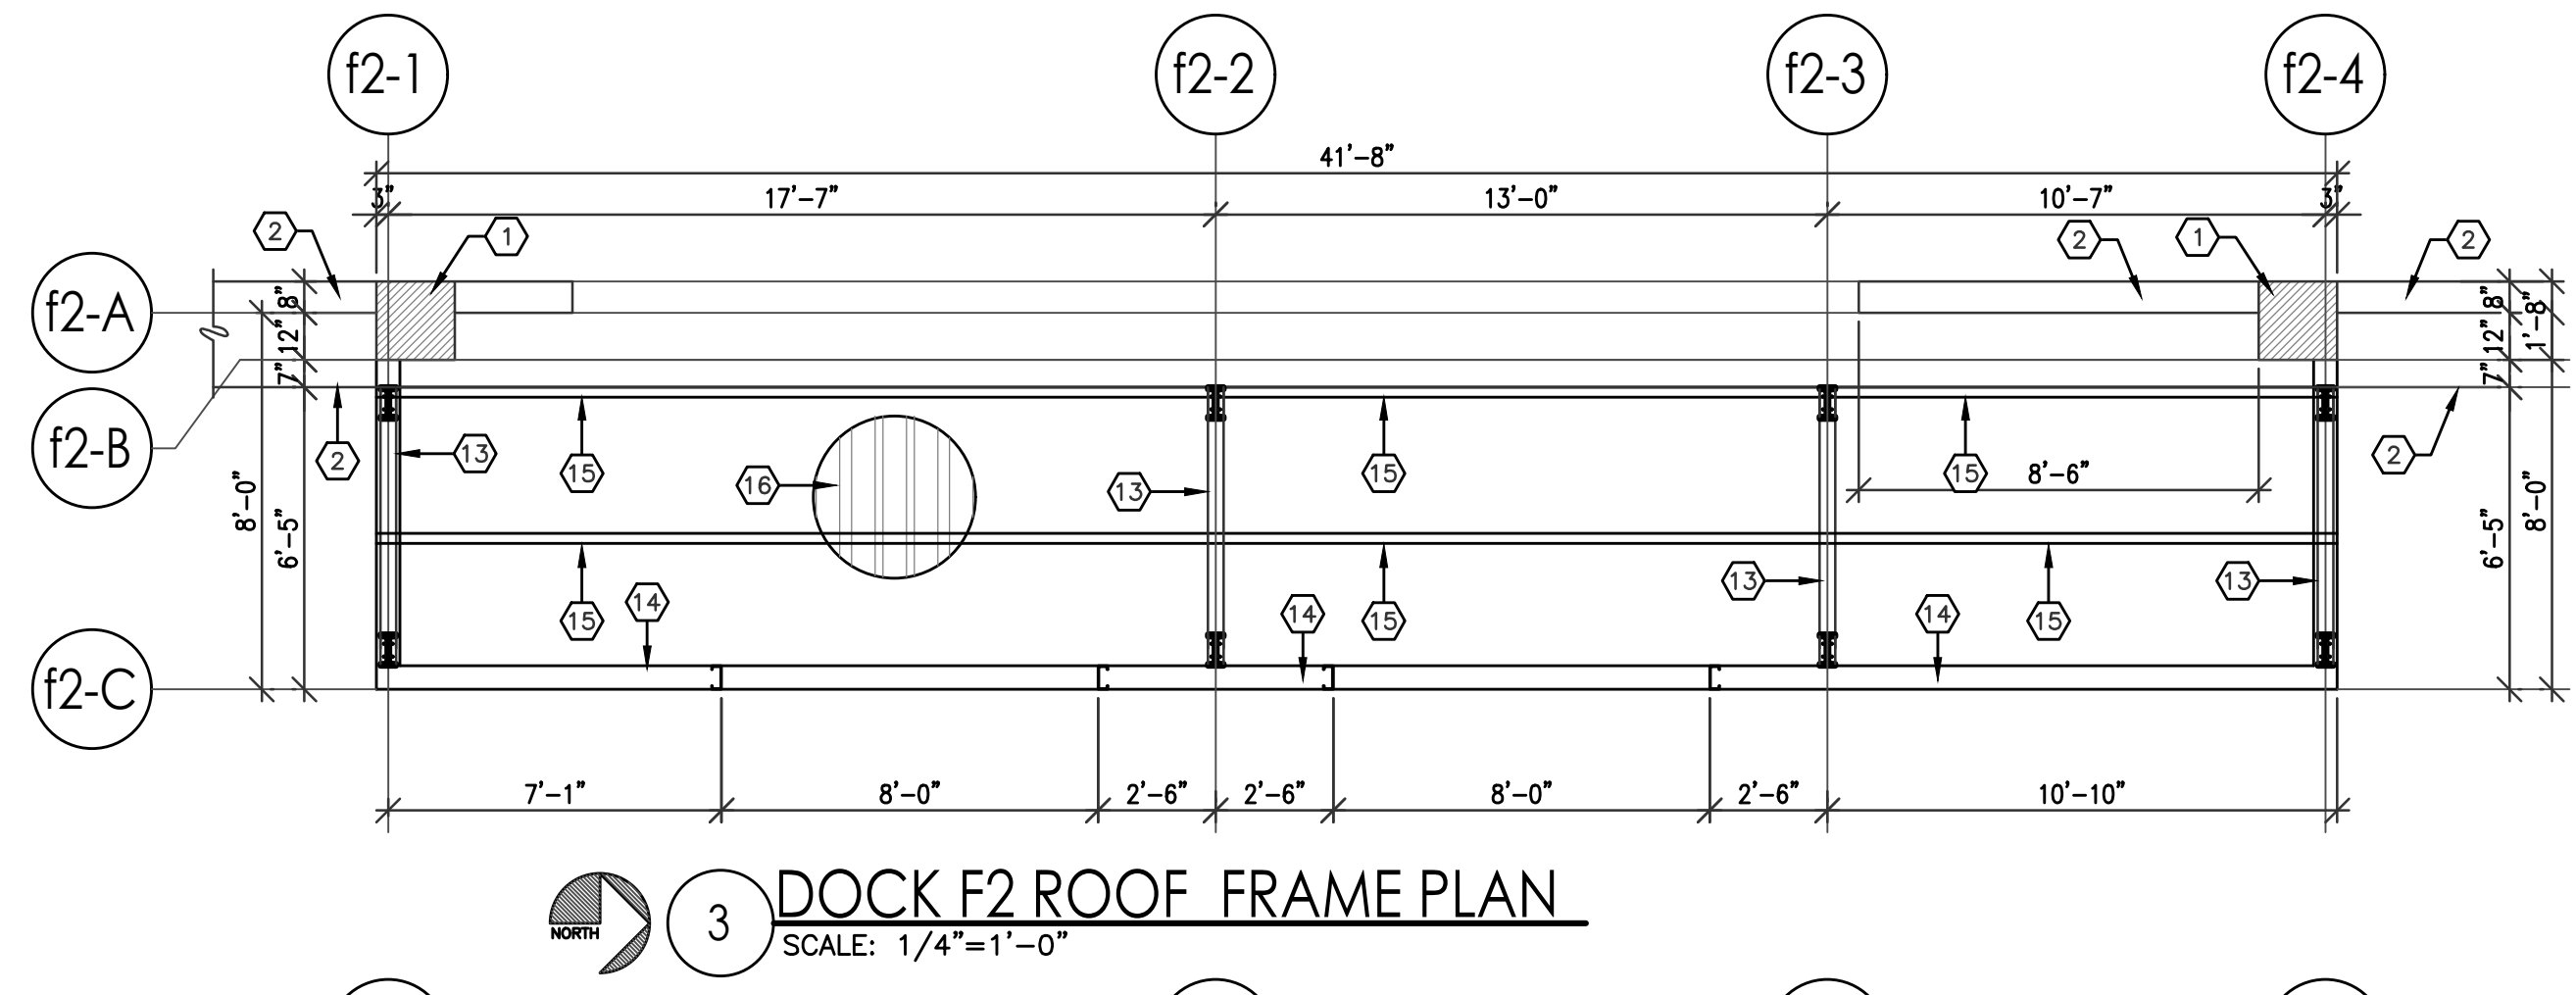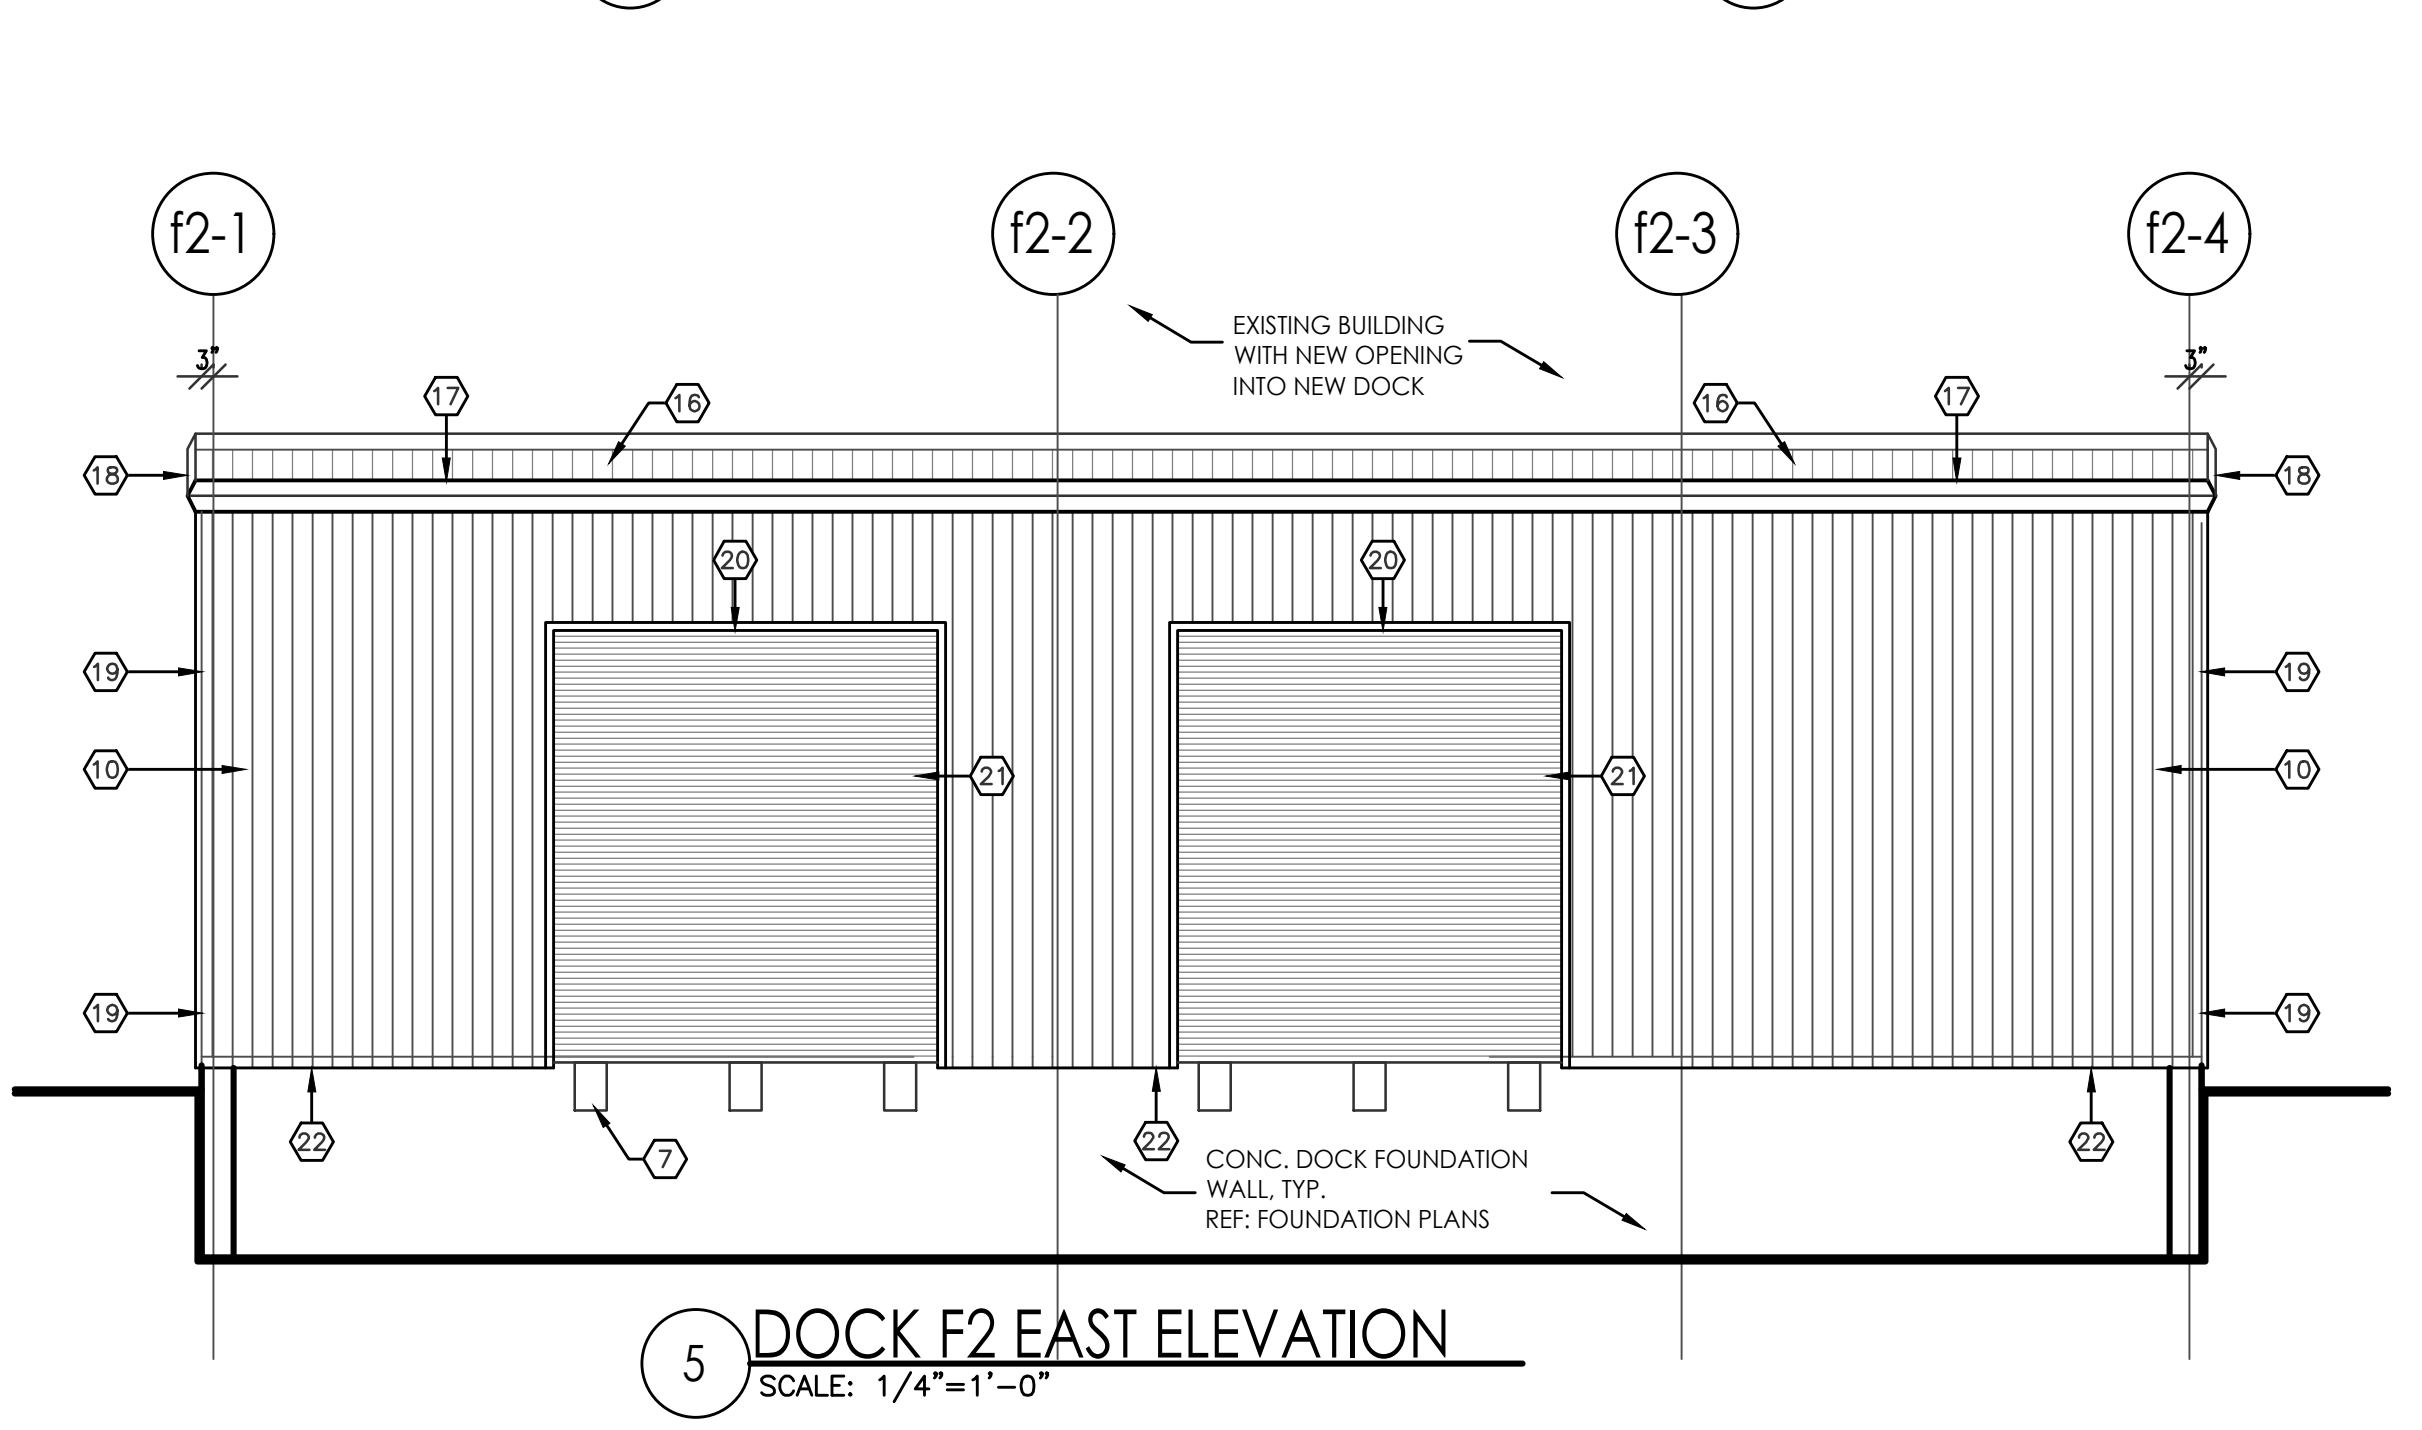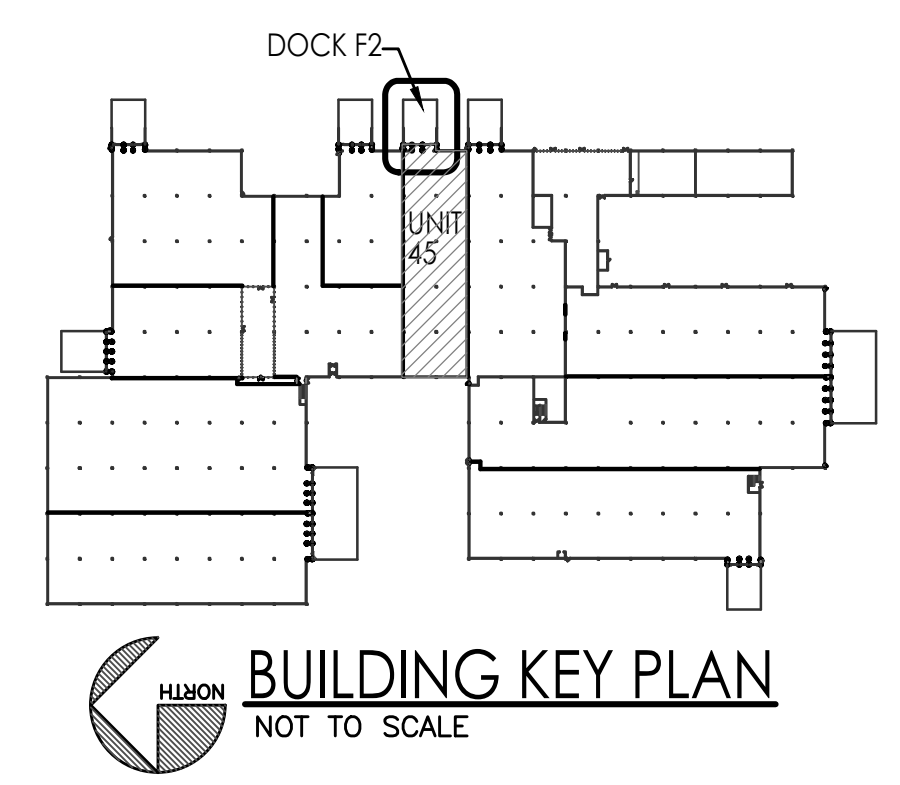


HONEYWELL WAREHOUSES
DOCK F2 ARCH AND STRUCTURAL PLANS
9201 SAN MATEO BLVD NE.
ALBUQUERQUE, NM 87113
#2354







REVISION DATE
DATE 3/22/2024
SHEET NUMBER A-3.70

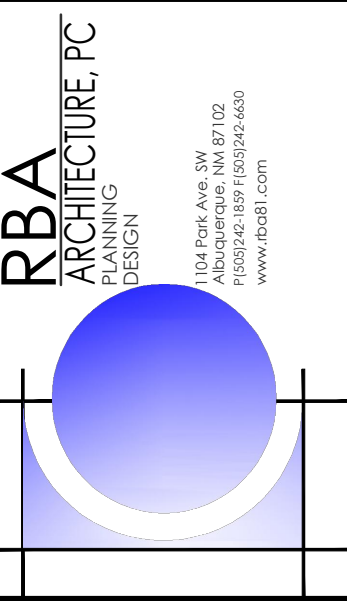

NEW DOCK F2 ADDITION
AREA = 333 S.F.

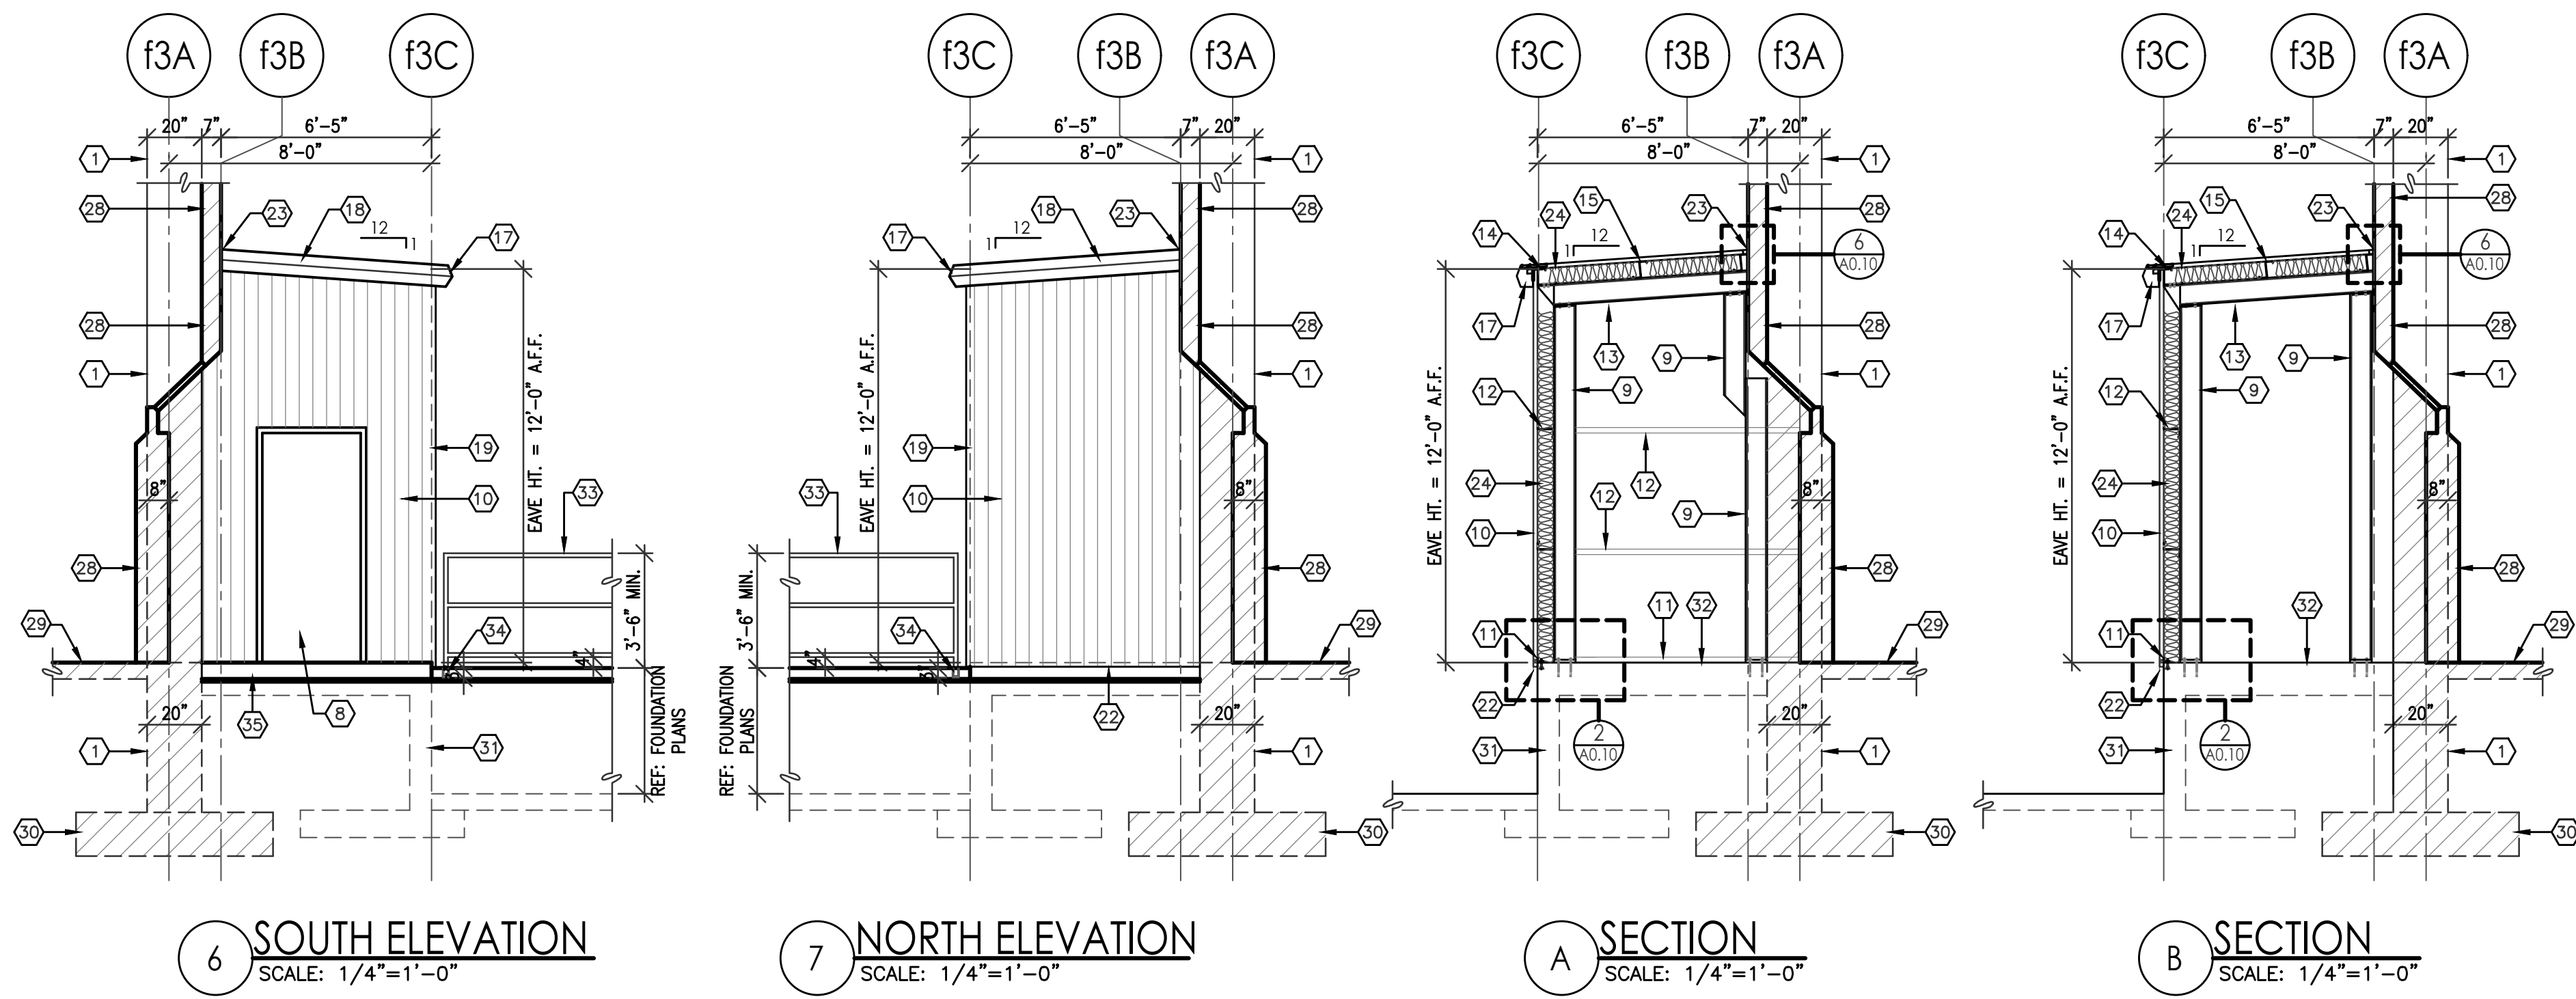


- KEYED NOTES**
- EXISTING 20" x 20" CONCRETE COLUMN.
 - EXISTING EXTERIOR WALL.
 - EXISTING WALL TO BE REMOVED.
 - COMBINATION EXIT SIGN AND EMERGENCY LIGHT WITH BATTERY BACK-UP, REF: ELECTRICAL PLANS.
 - EMERGENCY LIGHT WITH BATTERY BACK-UP, REF: ELECTRICAL PLANS.
 - WALL MOUNTED FIRE EXTINGUISHER 2A-10-BC, TYP.
 - DOCK BUMPERS, TYP.
 - 3070 INSULATED METAL DOOR IN HOLLOW METAL FRAME WITH 1/2" MAX. ALUM. THRESHOLD, DOOR WITH PANIC HARDWARE, KEYPAD LOCKSET, DOOR STOP, WEATHER STRIPPING AND AUTO CLOSURE.
 - W8 x 10 COLUMN, TYP.
 - 24 GA. METAL WALL PANEL, TYP.
 - 14 GA. BASE ANGLE, TYP.
 - 2 1/2" x 6" x 14 GA. ZEE GIRT, TYP.
 - W8 x 10 BEAM, TYP.
 - 6" x 3" EAVE STRUT, TYP.
 - 2 1/2" x 6" x 14 GA. ZEE PURLIN, TYP.
 - 26 GA. PRB ROOF PANEL, TYP.
 - CONT. METAL LEAVE GUTTER TRIM AND DOWNSPOUT (DOWNSPOUT NOT SHOWN).
 - CONT. RAKE/GABLE METAL TRIM, TYP.
 - METAL CORNER TRIM, TYP.
 - METAL HEAD TRIM, TYP.
 - METAL JAMB TRIM, TYP.
 - CONT. METAL WALL BASE TRIM, TYP.
 - CONT. METAL WALL BASE FLASHING, TYP.
 - R-20 VINYL FACED INSULATION AT ROOF, FULL COVERAGE AND R-13 VINYL FACED INSULATION AT WALL, FULL HEIGHT OF WALL, TYP.
 - 6" x 12 GA. CEE JAMB, TYP.
 - R-13 VINYL FACED INSULATION, FULL HEIGHT OF WALL, TYP.
 - 6" x 14 GA. CEE HEADER, TYP.
 - NEW DEMISING WALL, REF: OVERALL FLOOR PLAN FOR WALL CONTINUATION AND WALL TYPE TAG.
 - CROSS HATCH DENOTES EXIST. EXTERIOR WALL.
 - EXIST. CONC. SLAB, TYP.
 - EXIST. CONC. COLUMN FOOTING, TYP.
 - NEW CONC. DOCK WALL, REF: FOUNDATION PLANS.
 - NEW CONC. SLAB AT NEW DOCK, REF: FOUNDATION PLANS.
 - 42" HIGH MIN. 1 1/4" DIA. PAINTED STEEL GUARDRAIL, G.C. TO INSTALL GUARDRAIL PER 2021 I.B.C. SECTION 1015.2. GUARDS SHALL BE LOCATED ALONG OPEN-SIDED WALKING SURFACES THAT ARE LOCATED MORE THAN 30 INCHES MEASURED VERTICALLY TO THE FLOOR OR GRADE BELOW, G.C. TO FIELD VERIFY GUARDRAIL LENGTH TO BE BUILT. CORE DRILL CONC. RETAINING WALL FOR GUARDRAIL POST AND EPOXY POST IN PLACE, TYP., GUARDRAIL POSTS AT 8'-0" O.C. MAX.
 - 4" THICK x 5' x 5' CONCRETE STOOP AT EXIT DOOR, SLOPE CONC. 1/4"/FT. SLOPE MIN. AWAY FOR DOOR.

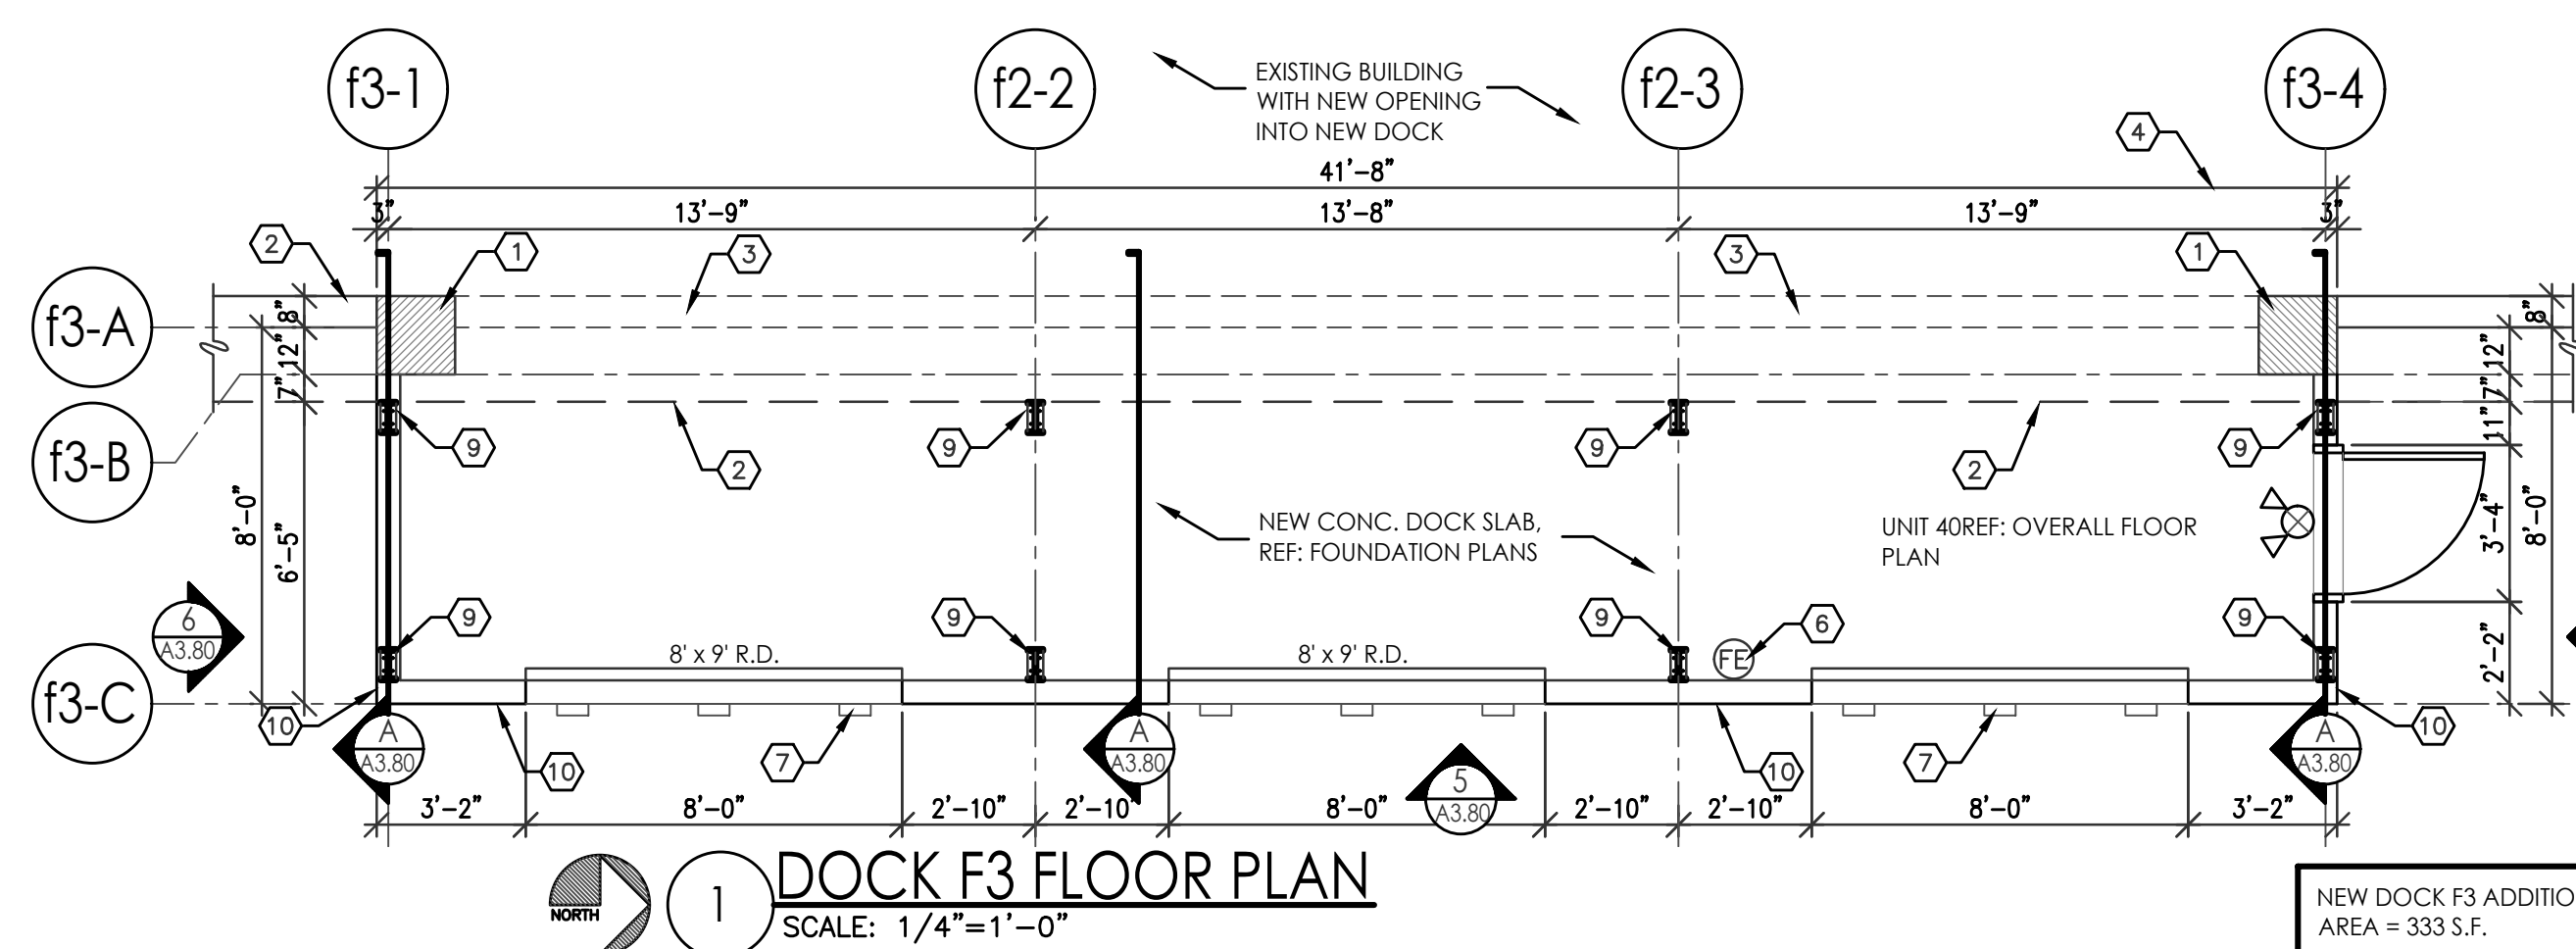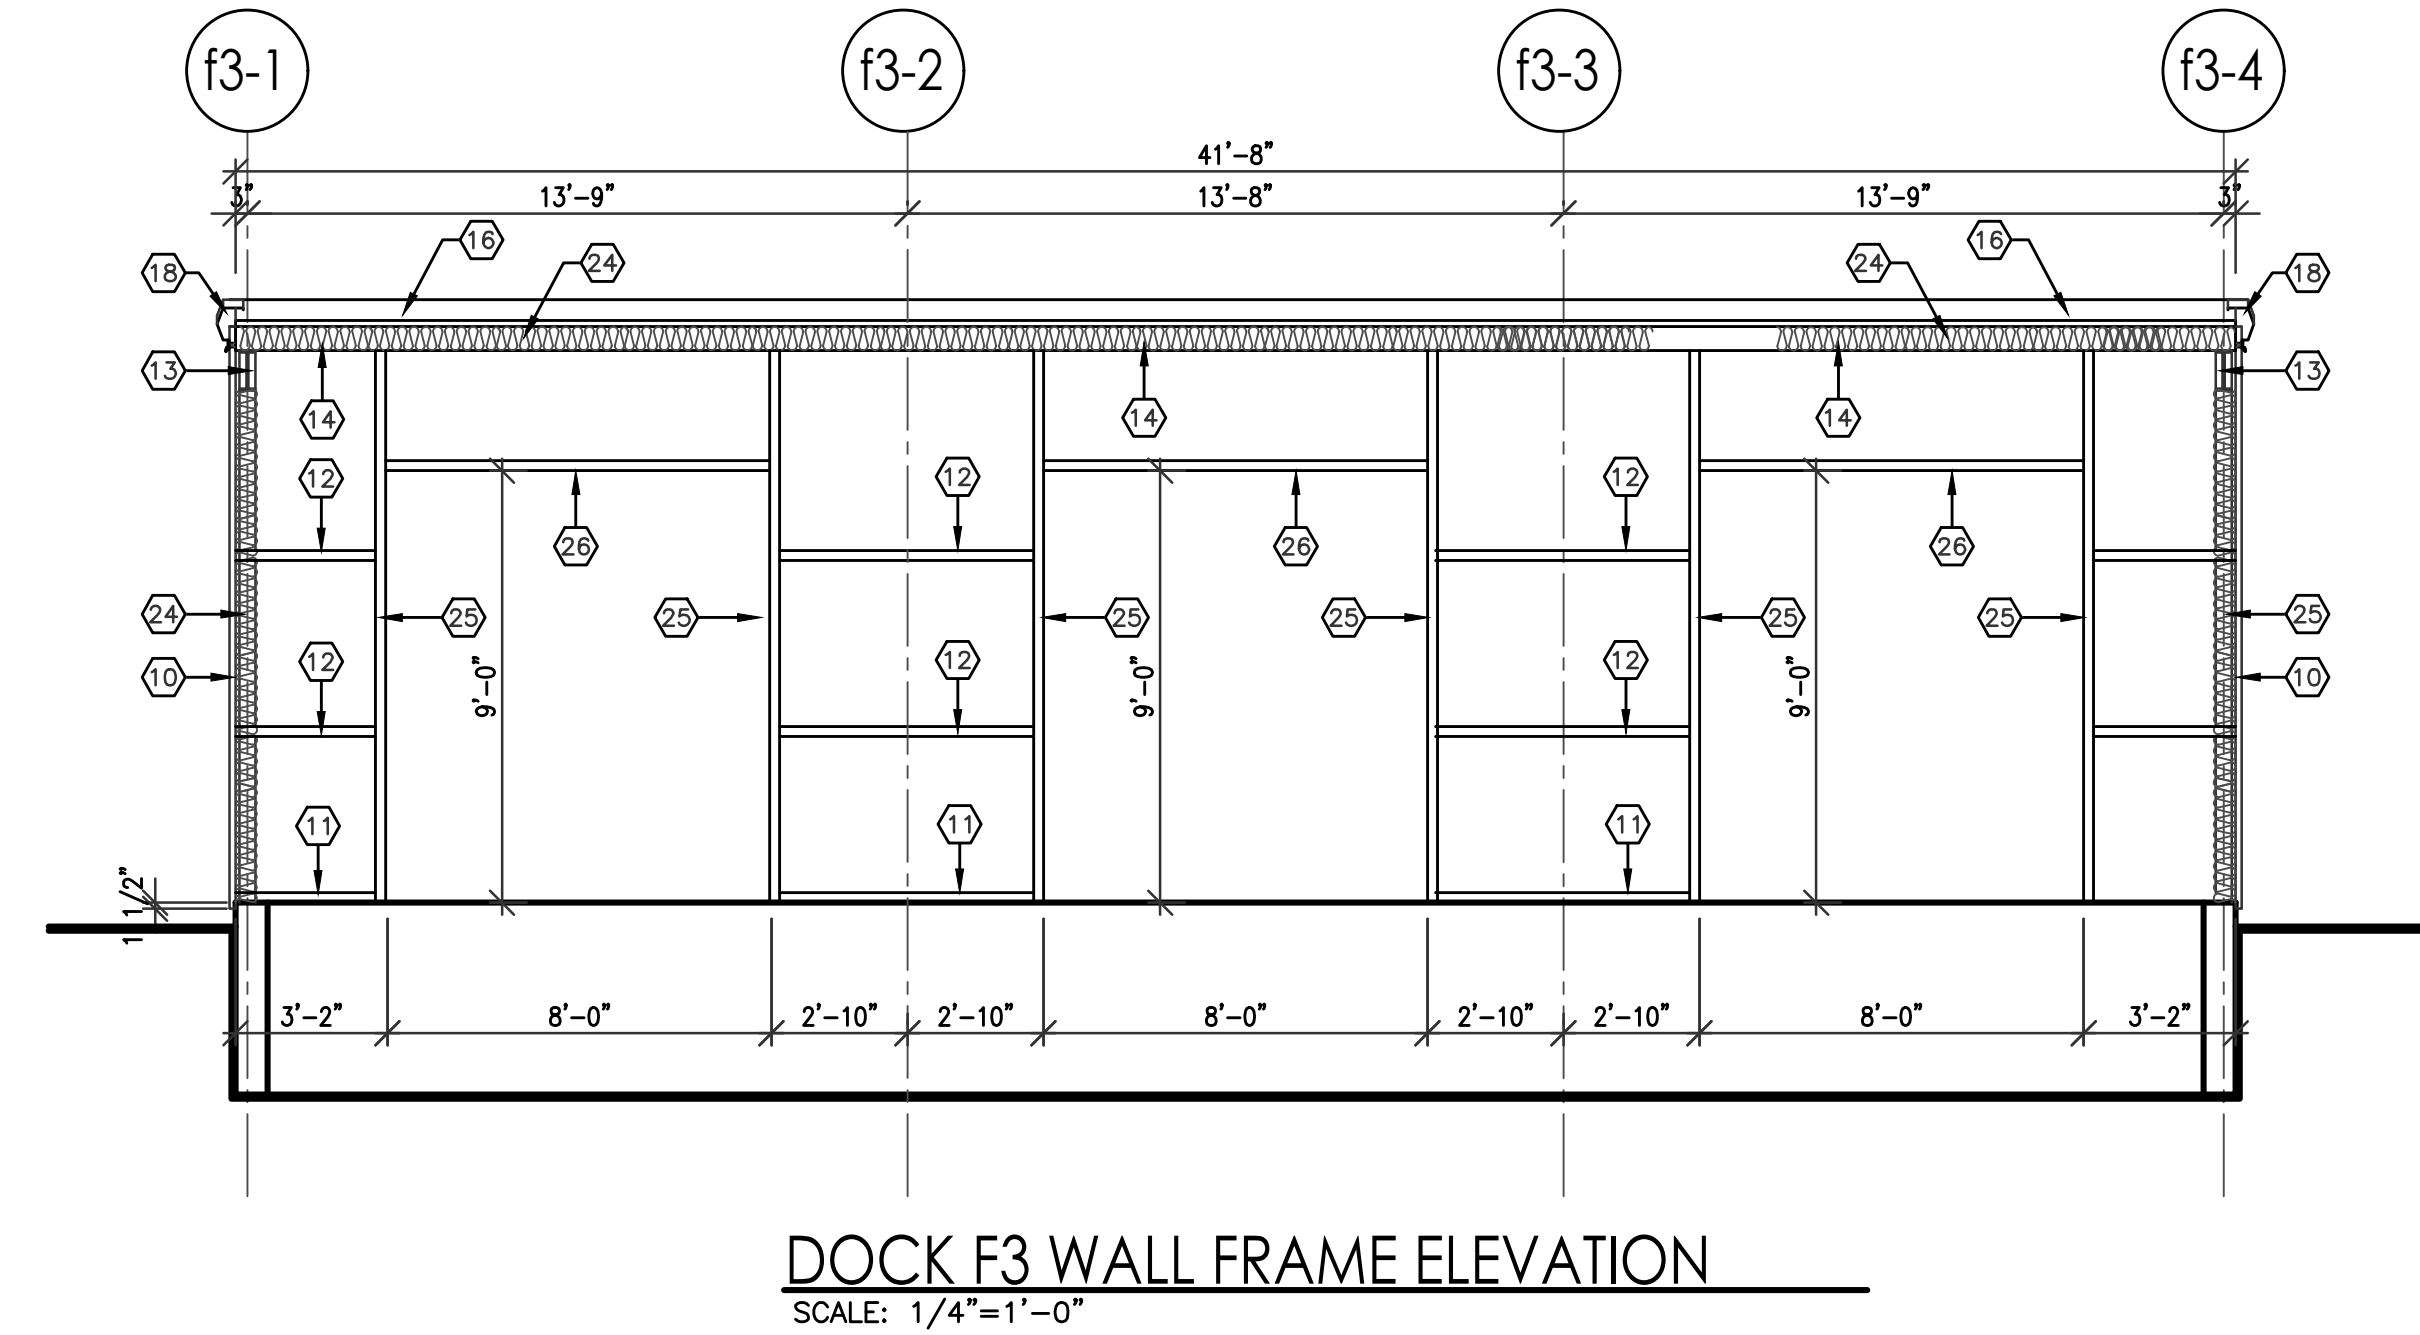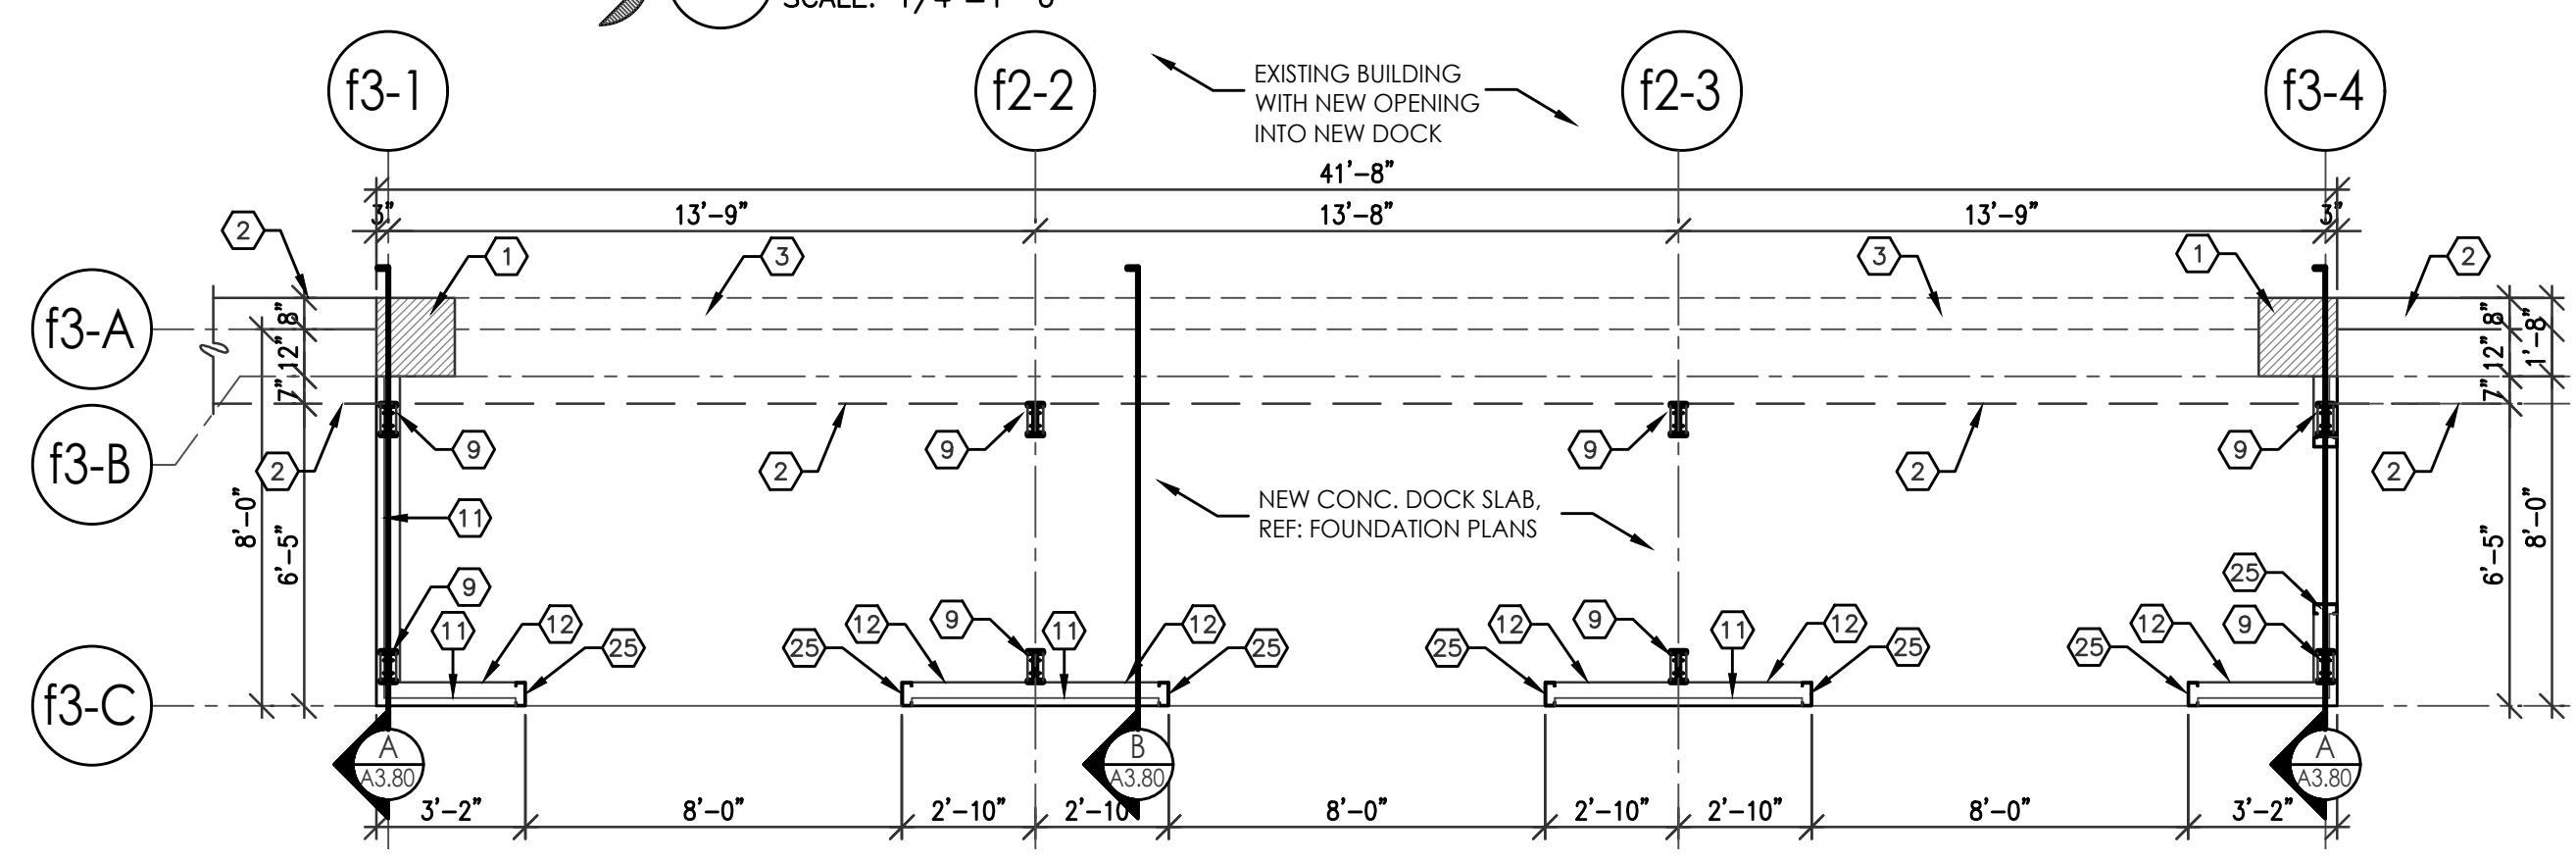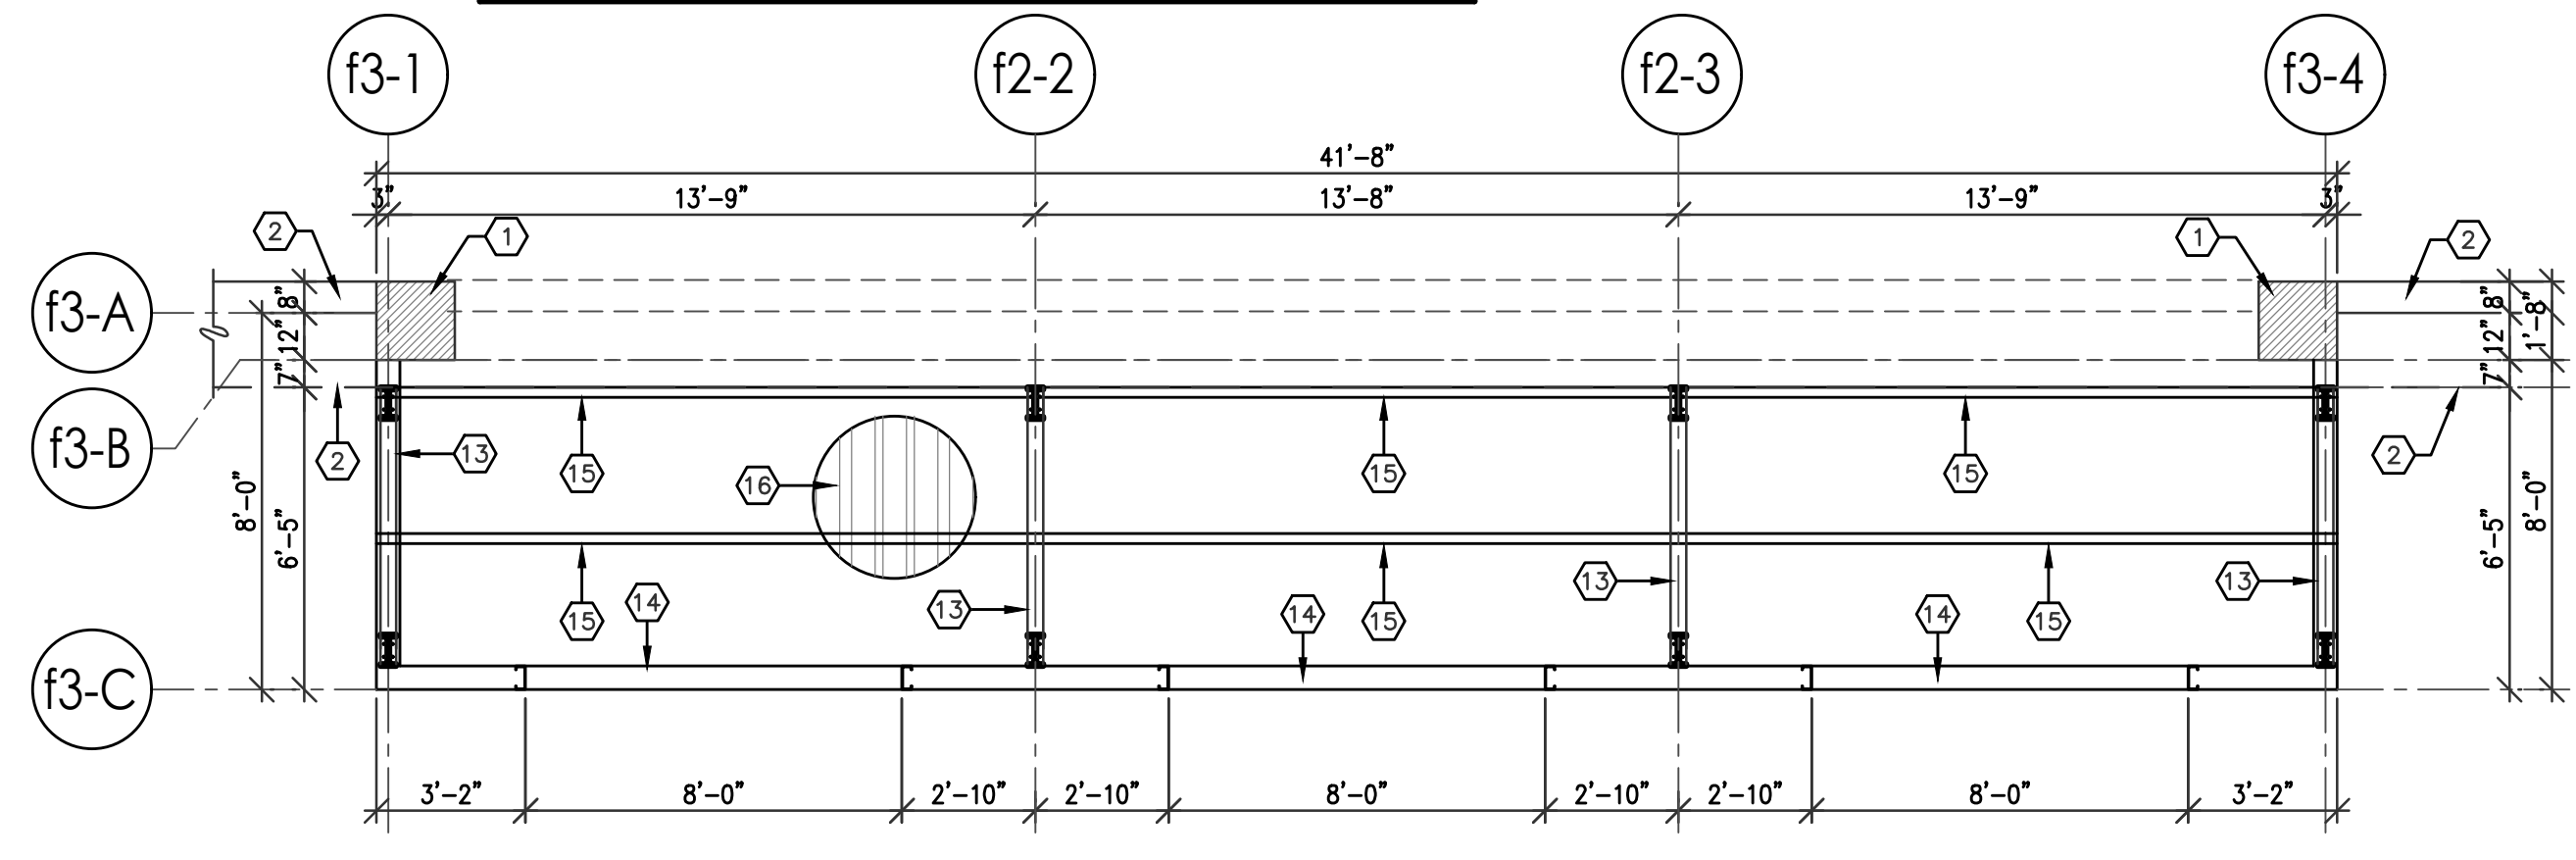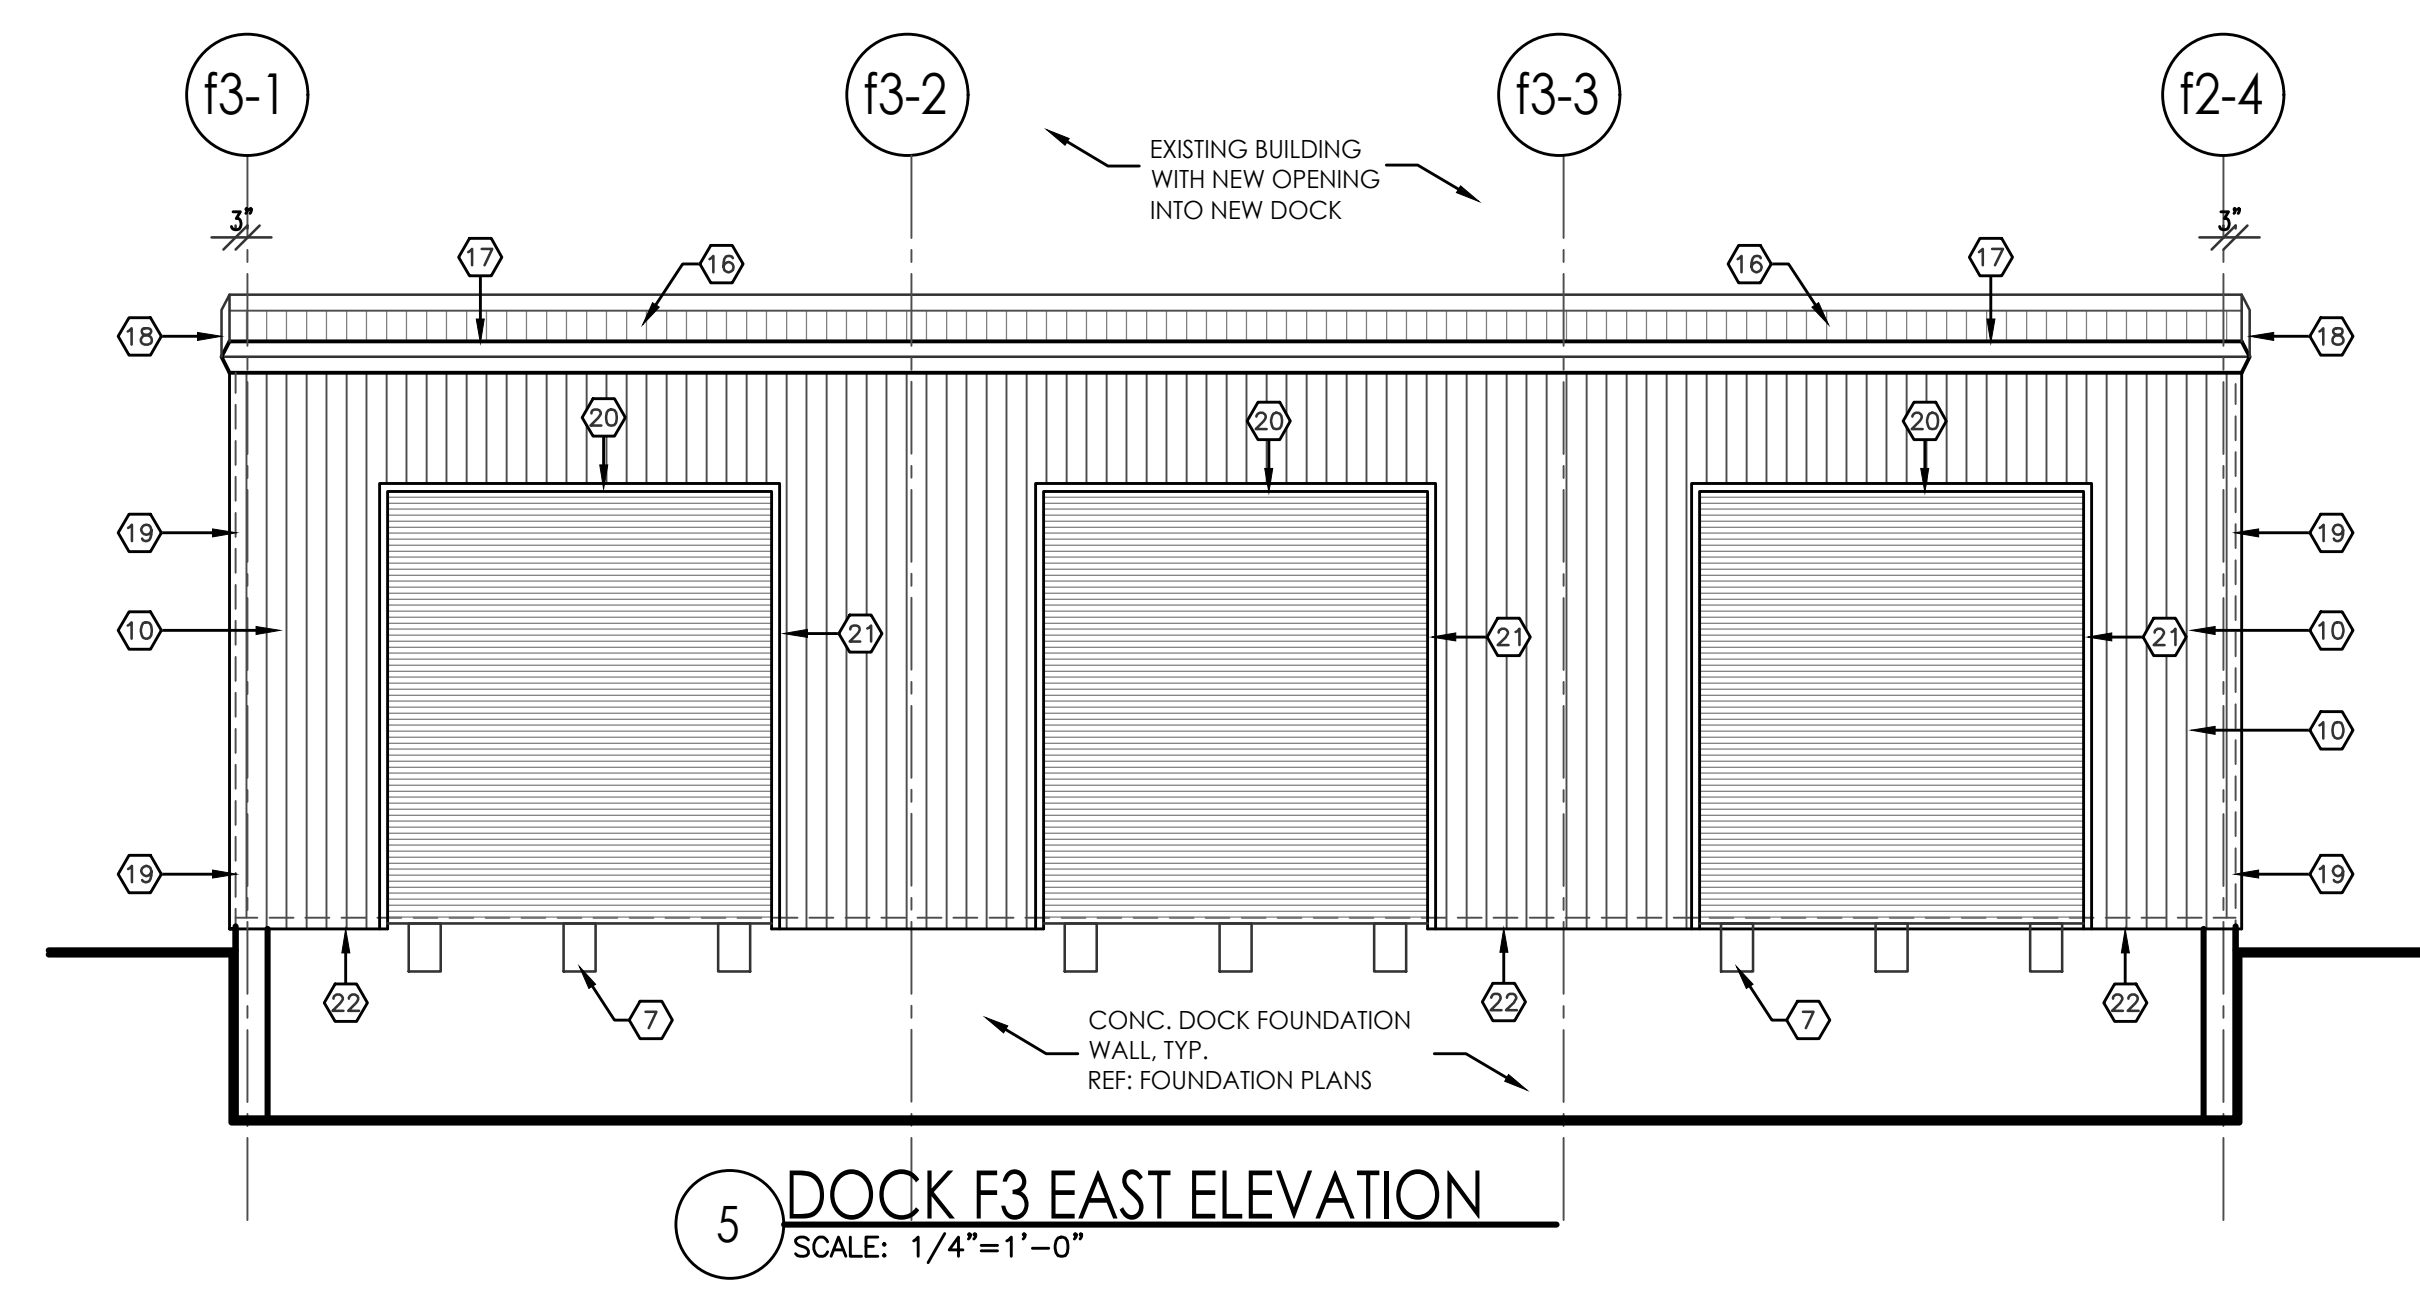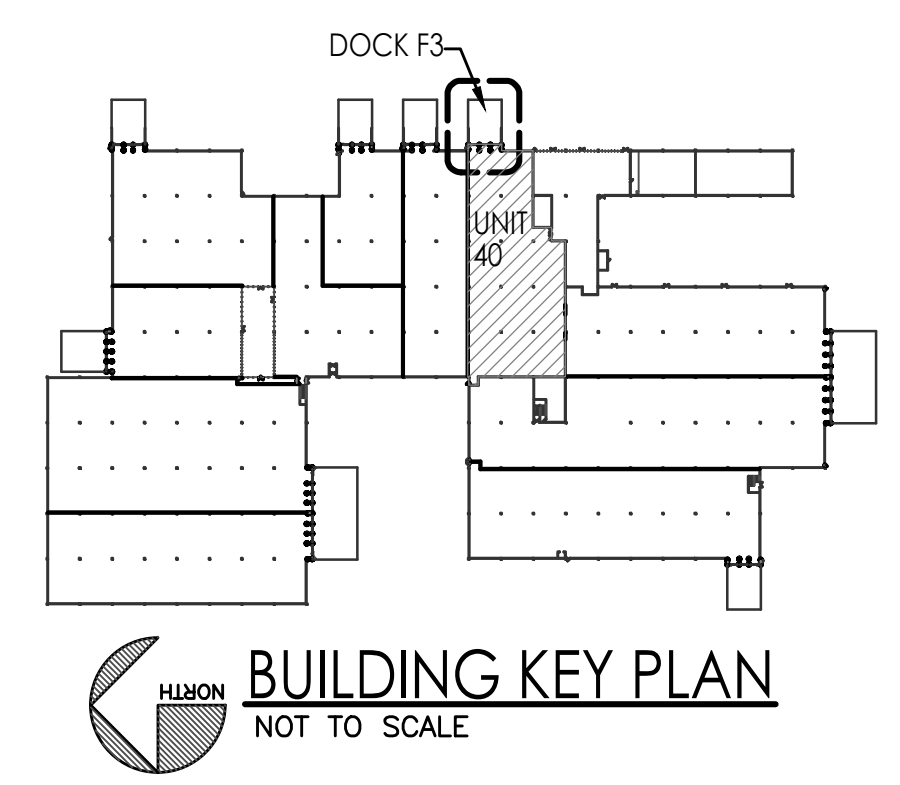







HONEYWELL WAREHOUSES
 DOCK F3 ARCH AND STRUCTURAL PLANS
 9201 SAN MATEO BLVD NE.
 ALBUQUERQUE, NM 87113
 #2354

REVISION DATE	
DATE	3/22/2024
SHEET NUMBER	A-3.80

NEW DOCK F3 ADDITION
AREA = 333 S.F.

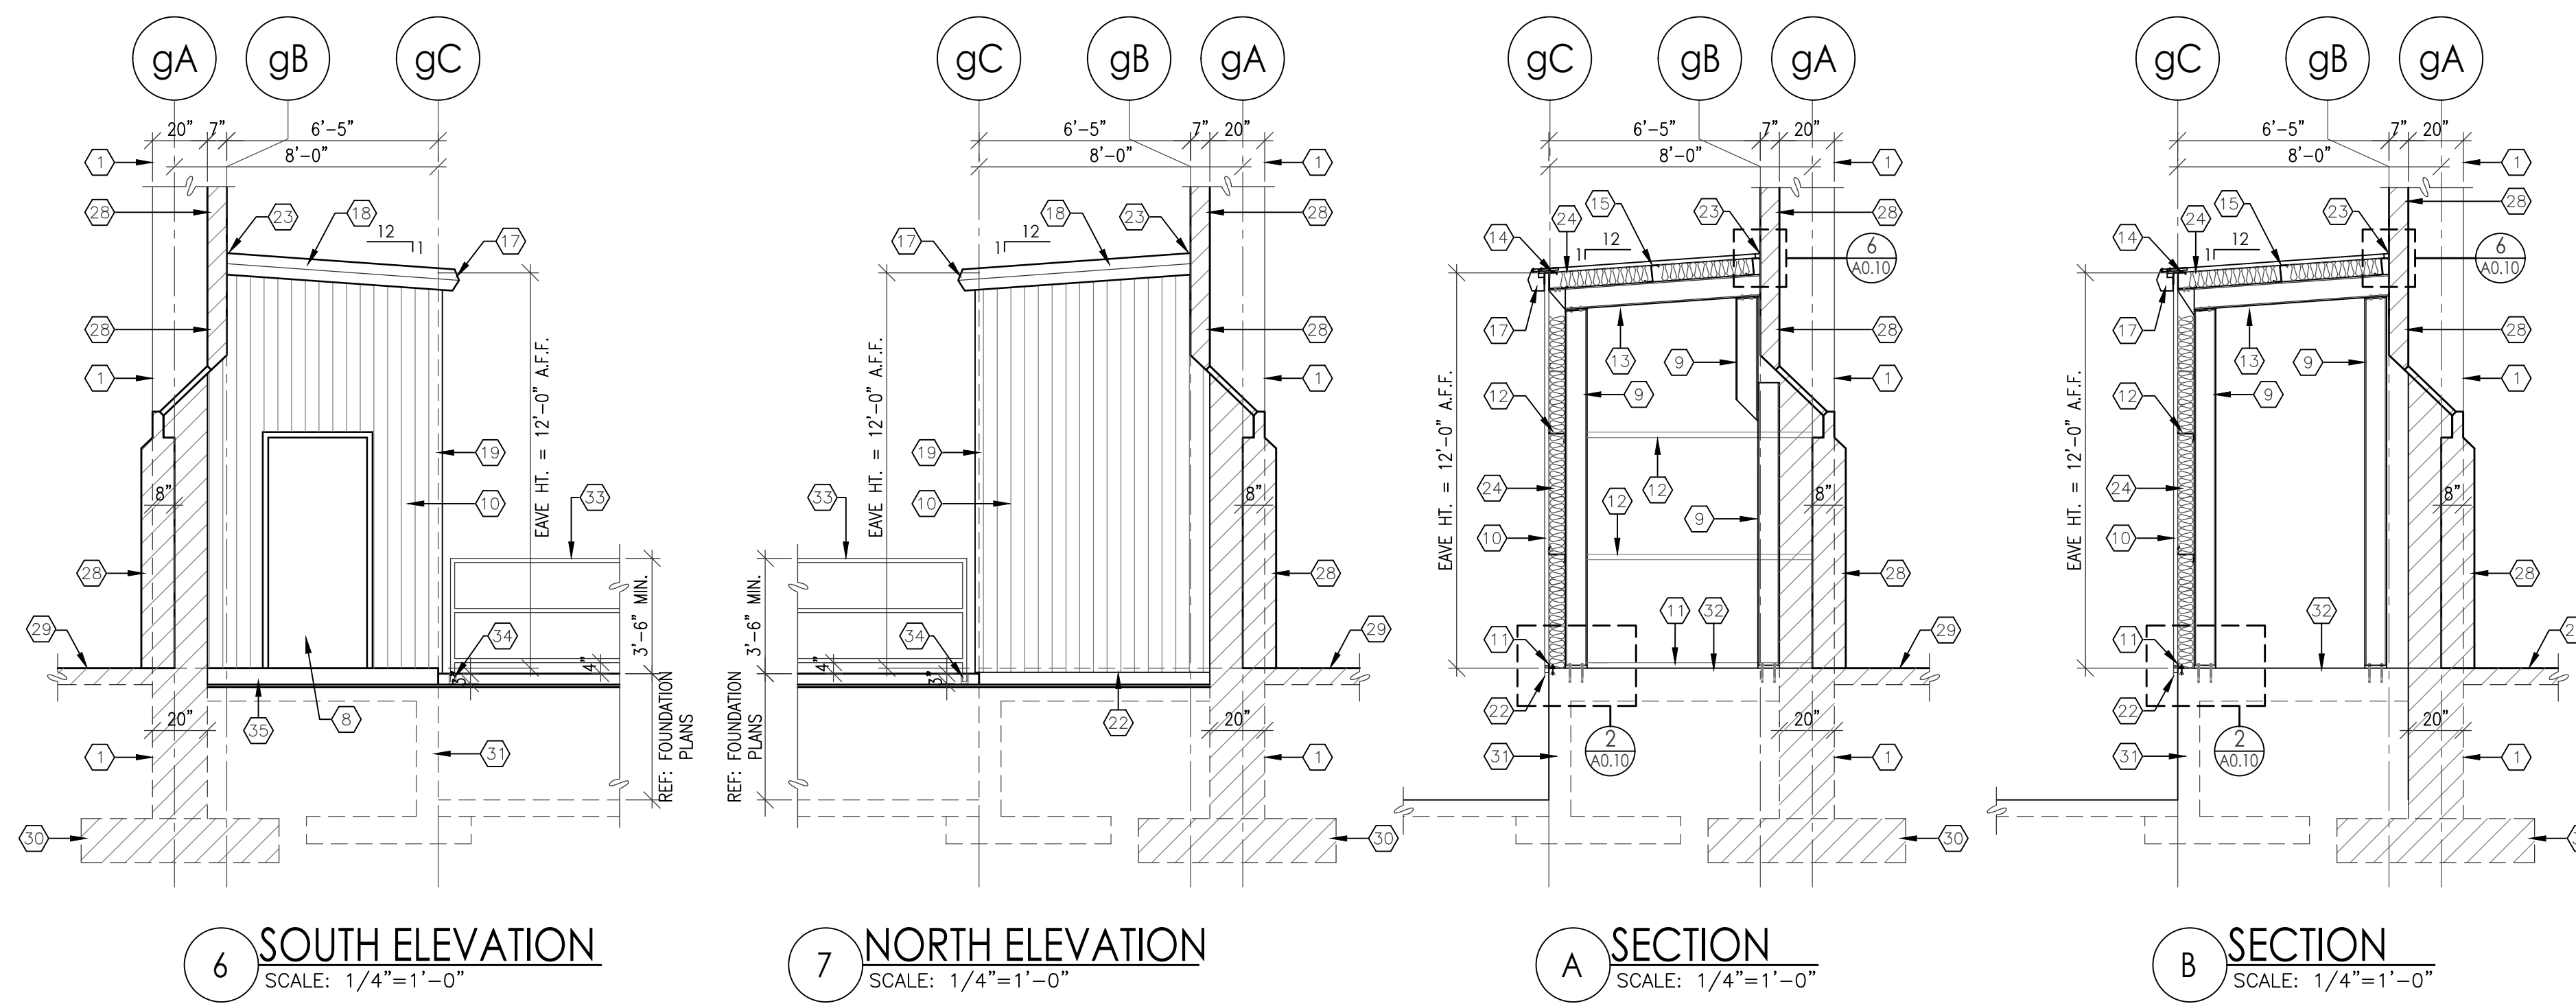

- KEYED NOTES**
- EXISTING 20" x 20" CONCRETE COLUMN.
 - EXISTING EXTERIOR WALL.
 - EXISTING WALL TO BE REMOVED.
 - COMBINATION EXIT SIGN AND EMERGENCY LIGHT WITH BATTERY BACK-UP, REF: ELECTRICAL PLANS.
 - EMERGENCY LIGHT WITH BATTERY BACK-UP, REF: ELECTRICAL PLANS.
 - WALL MOUNTED FIRE EXTINGUISHER 2A-10-BC, TYP.
 - DOCK BUMPERS, TYP.
 - 3070 INSULATED METAL DOOR IN HOLLOW METAL FRAME WITH 1/2" MAX. ALUM. THRESHOLD, DOOR WITH PANIC HARDWARE, KEYS LOCKSET, DOOR STOP, WEATHER STRIPPING AND AUTO CLOSURE.
 - W8 x 10 COLUMN, TYP.
 - 24 GA. METAL WALL PANEL, TYP.
 - 14 GA. BASE ANGLE, TYP.
 - 2 1/2" x 6" x 14 GA. ZEE GIRT, TYP.
 - W8 x 10 BEAM, TYP.
 - 6" x 3" EAVE STRUT, TYP.
 - 2 1/2" x 6" x 14 GA. ZEE PURLIN, TYP.
 - 24 GA. PRB ROOF PANEL, TYP.
 - CONT. METAL LEAVE GUTTER TRIM AND DOWNSPOUT (DOWNSPOUT NOT SHOWN).
 - CONT. RAKE/GABLE METAL TRIM, TYP.
 - METAL CORNER TRIM, TYP.
 - METAL HEAD TRIM, TYP.
 - METAL JAMB TRIM, TYP.
 - CONT. METAL WALL BASE TRIM, TYP.
 - CONT. METAL WALL BASE FLASHING, TYP.
 - R-20 VINYL FACED INSULATION AT ROOF, FULL COVERAGE AND R-13 VINYL FACED INSULATION AT WALL, FULL HEIGHT OF WALL, TYP.
 - 6" x 12 GA. CEE JAMB, TYP.
 - R-13 VINYL FACED INSULATION, FULL HEIGHT OF WALL, TYP.
 - 6" x 14 GA. CEE HEADER, TYP.
 - NEW DEMISING WALL, REF: OVERALL FLOOR PLAN FOR WALL CONTINUATION AND WALL TYPE TAG.
 - CROSS HATCH DENOTES EXIST. EXTERIOR WALL.
 - EXIST. CONC. SLAB, TYP.
 - EXIST. CONC. COLUMN FOOTING, TYP.
 - NEW CONC. DOCK WALL, REF: FOUNDATION PLANS.
 - NEW CONC. SLAB AT NEW DOCK, REF: FOUNDATION PLANS.
 - 42" HIGH MIN. 1 1/4" DIA. PAINTED STEEL GUARDRAIL, G.C. TO INSTALL GUARDRAIL PER 2021 I.B.C. SECTION 1015.2. GUARDS SHALL BE LOCATED ALONG OPEN-SIDED WALKING SURFACES THAT ARE LOCATED MORE THAN 30 INCHES MEASURED VERTICALLY TO THE FLOOR OR GRADE BELOW, G.C. TO FIELD VERIFY GUARDRAIL LENGTH TO BE BUILT.
 - CORE DRILL CONC. RETAINING WALL FOR GUARDRAIL POST AND EPOXY POST IN PLACE, TYP., GUARDRAIL POSTS AT 8'-0" O.C. MAX.
 - 4" THICK x 5' x 5' CONCRETE STOOP AT EXIT DOOR, SLOPE CONC. 1/4"/FT. SLOPE MIN. AWAY FOR DOOR.

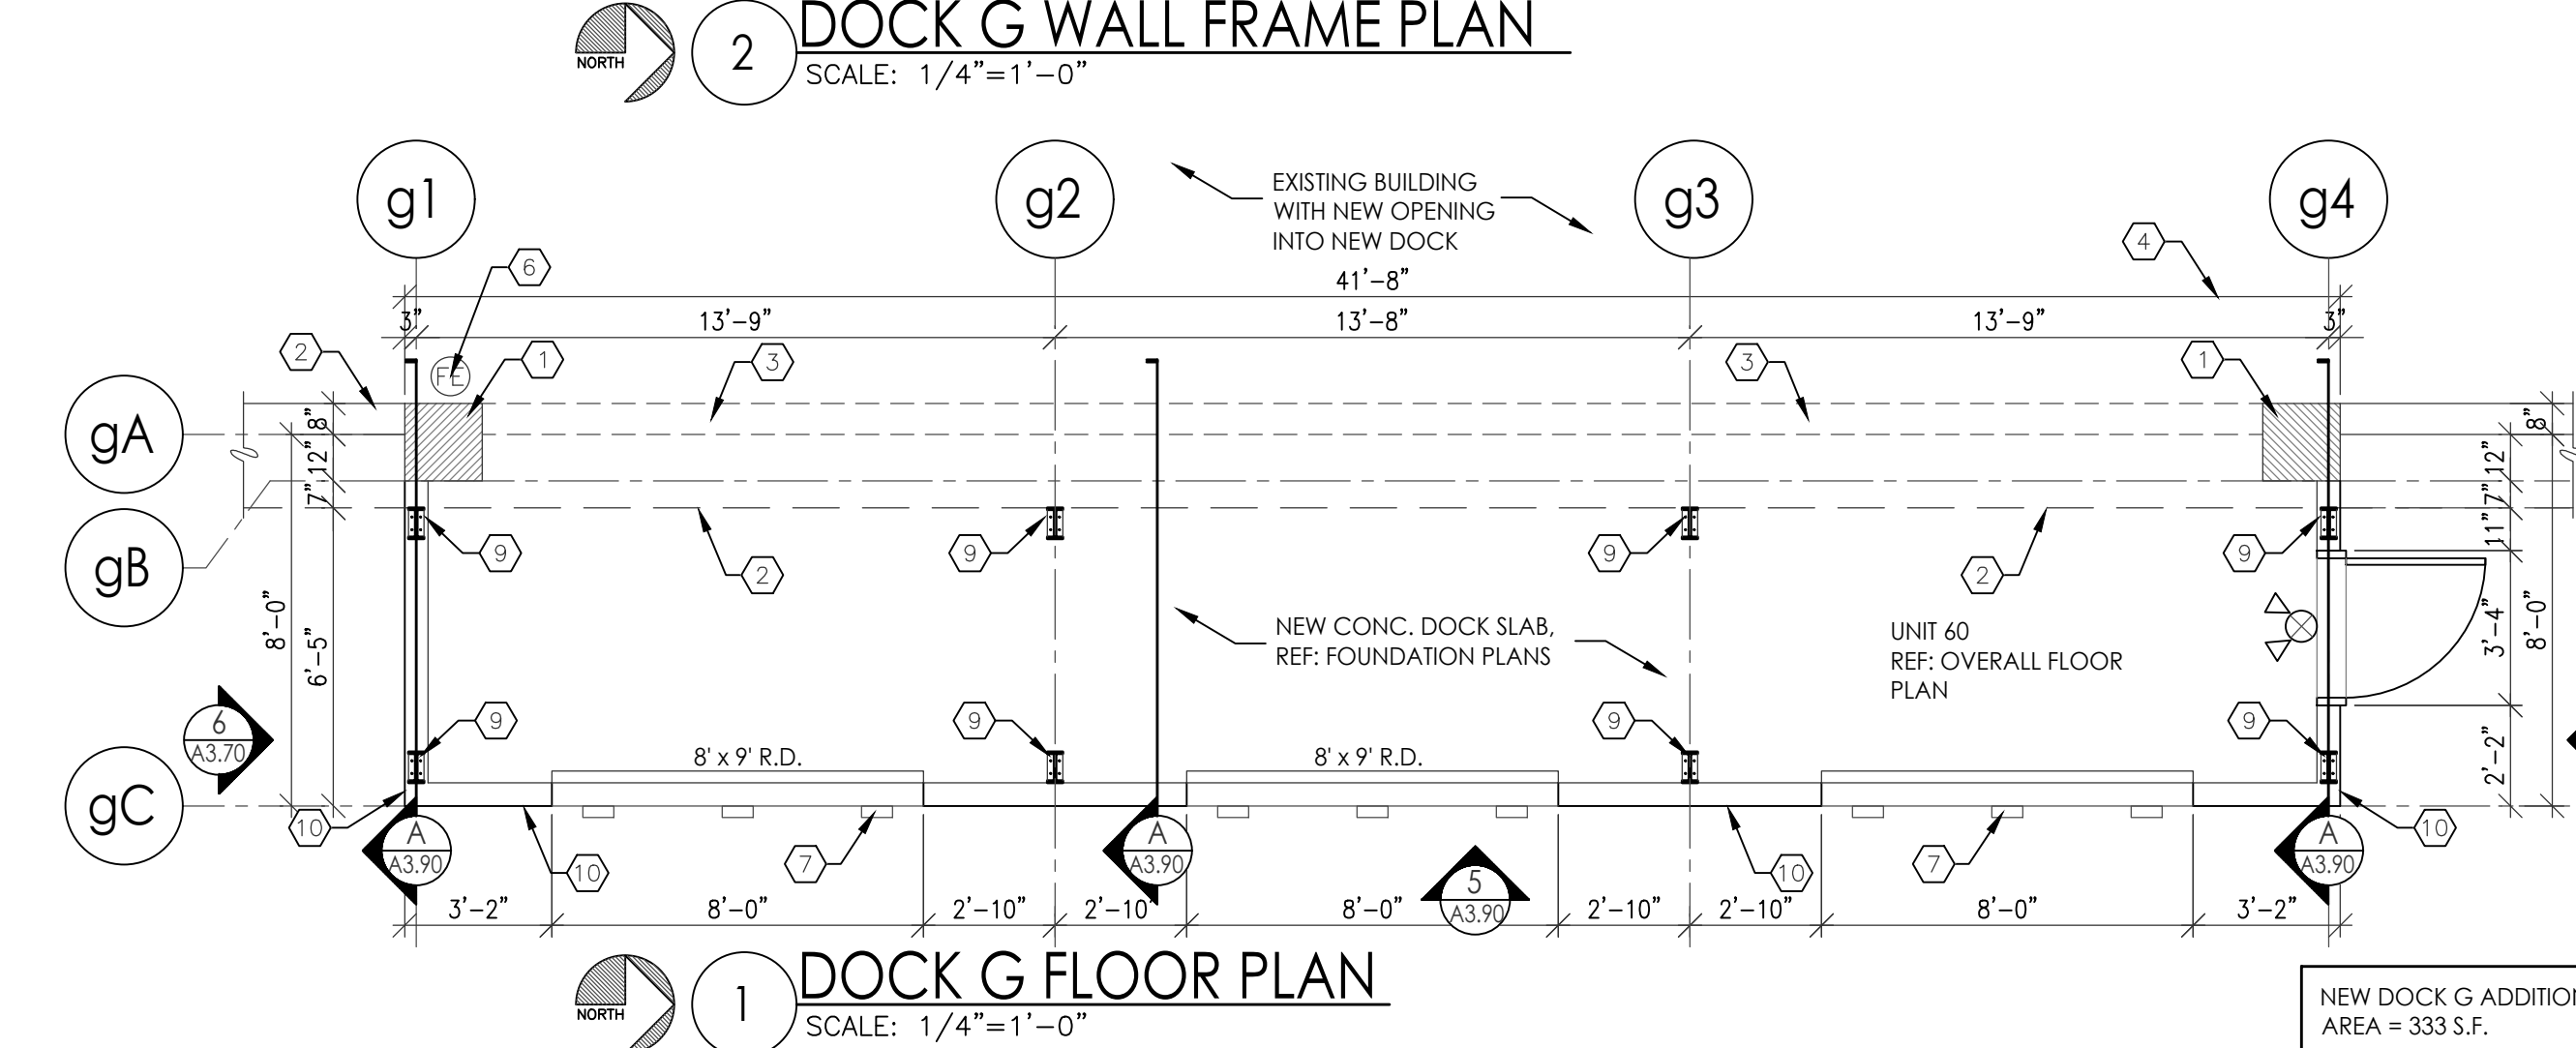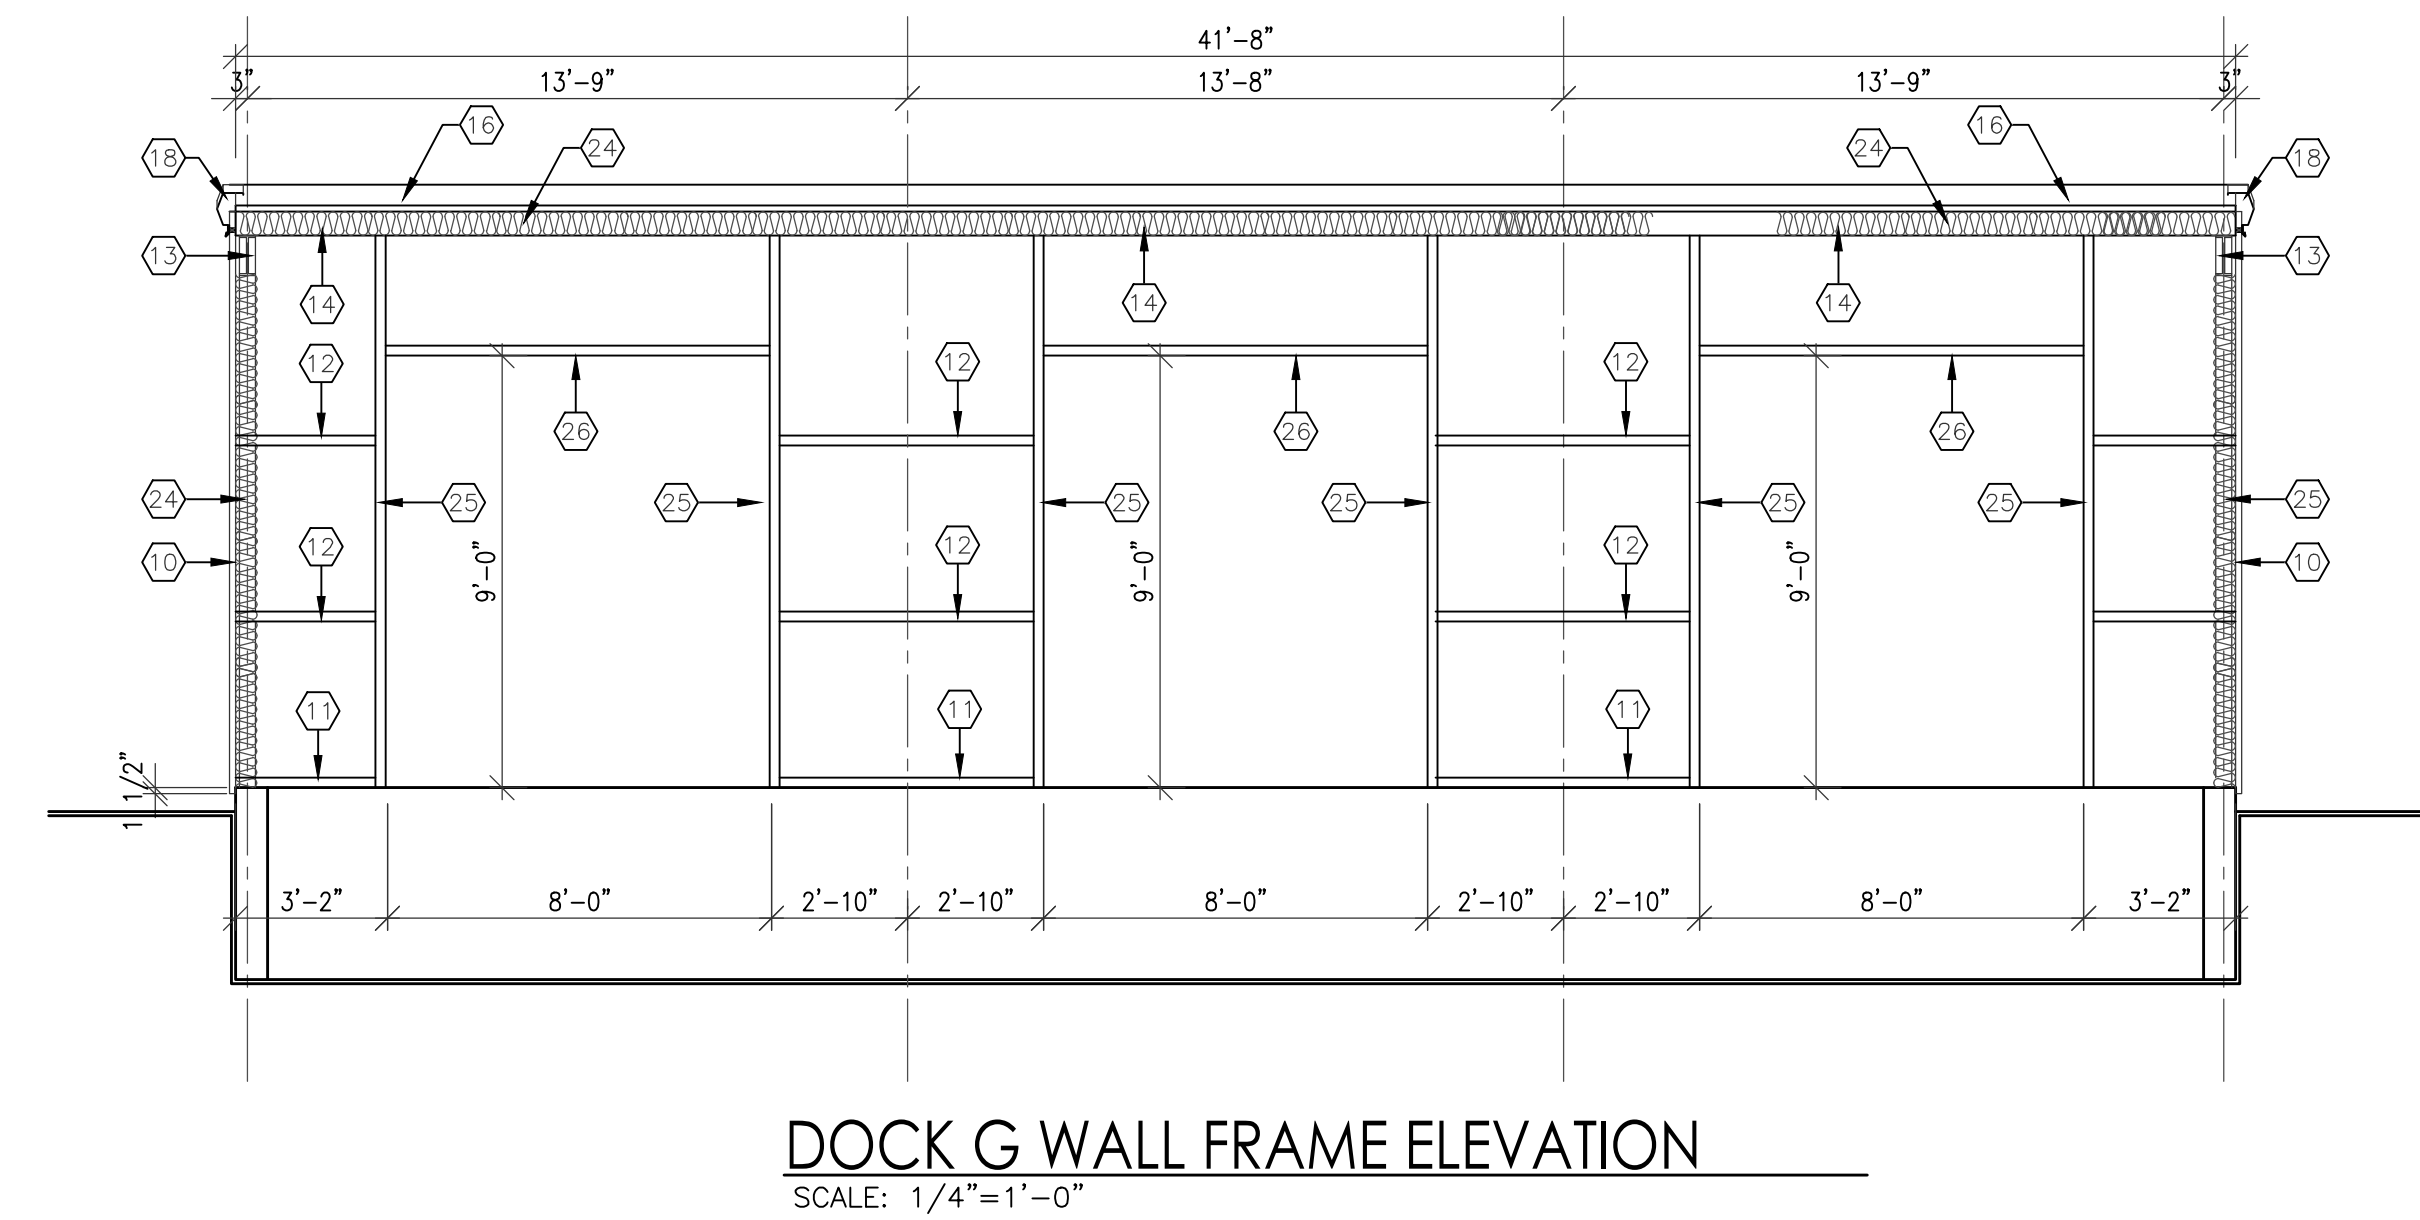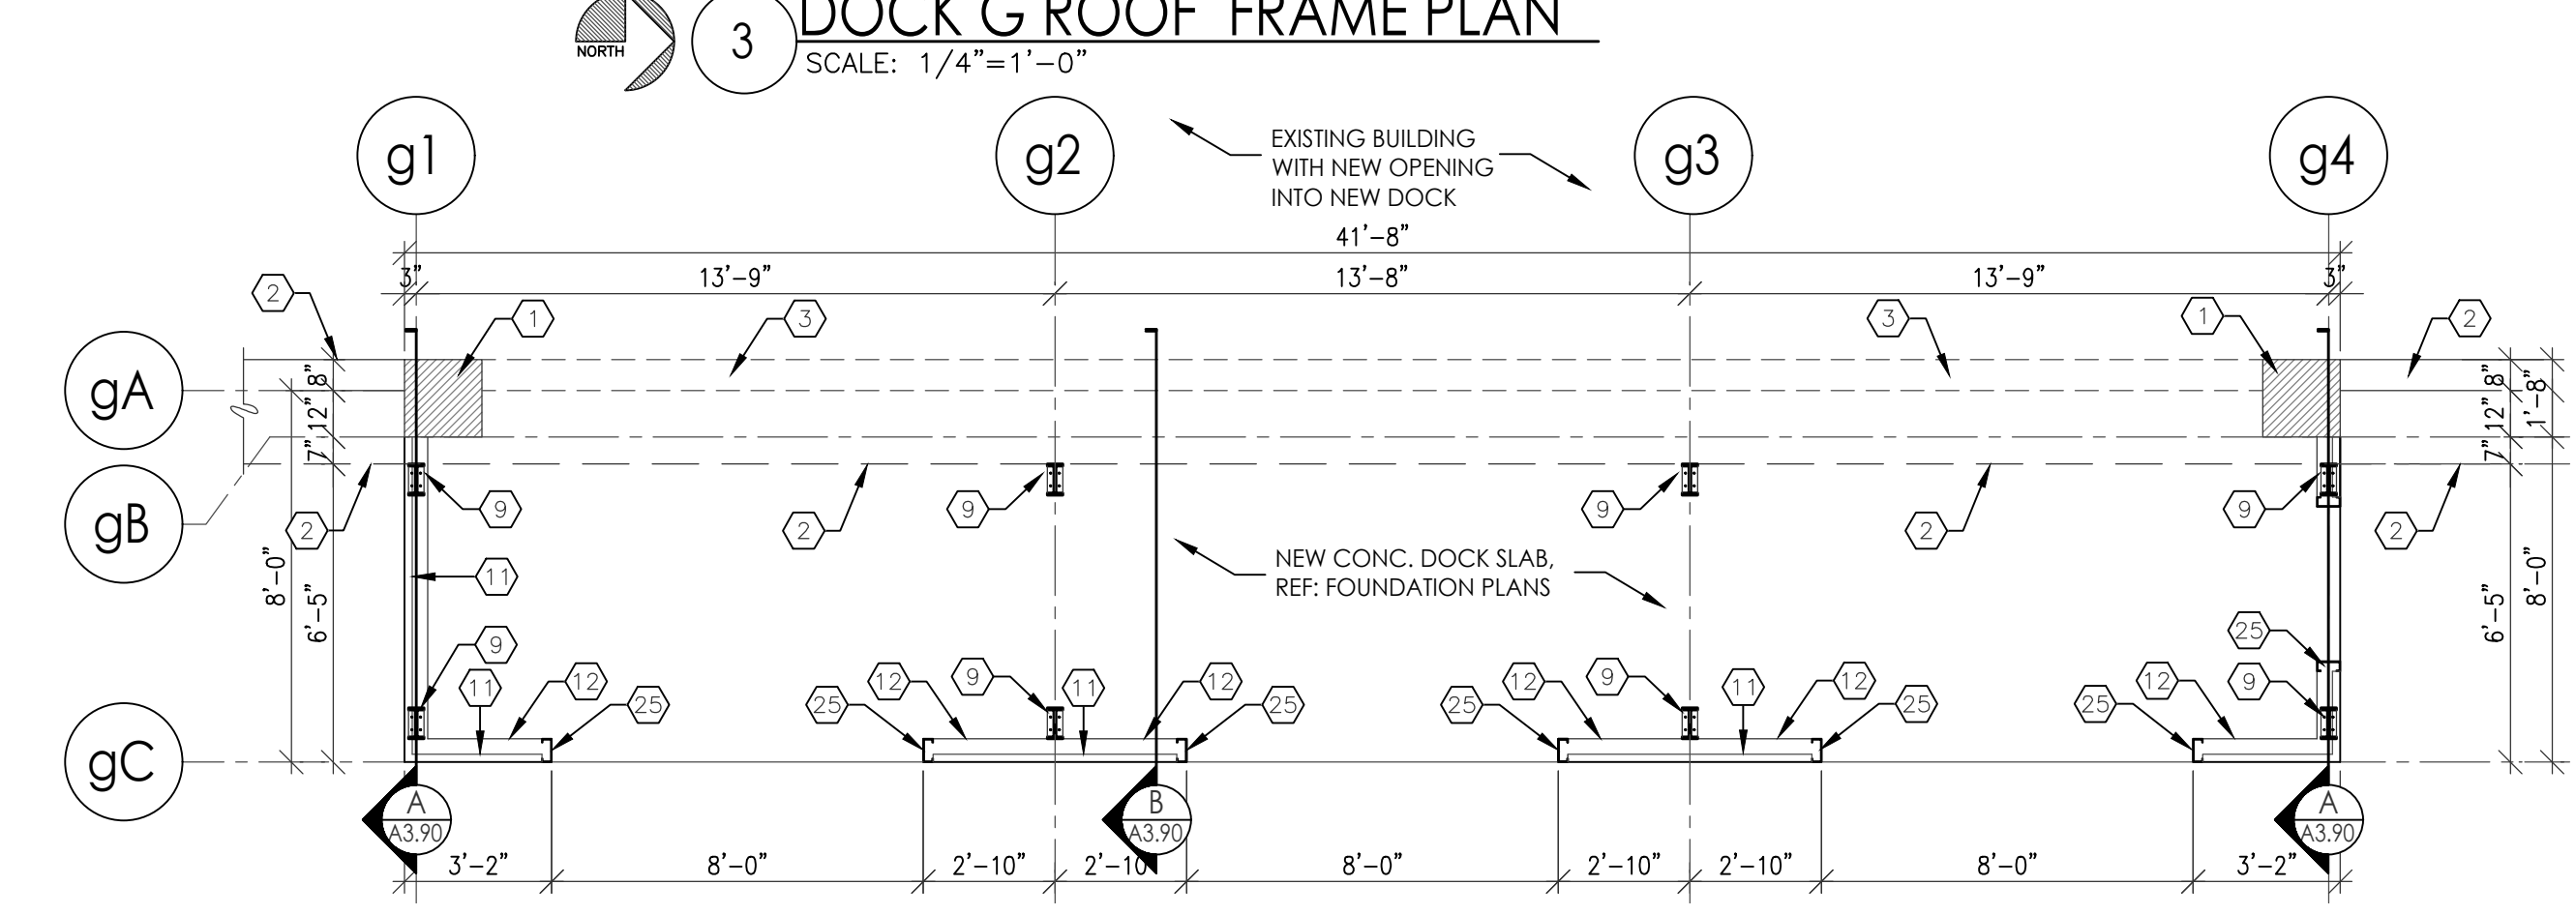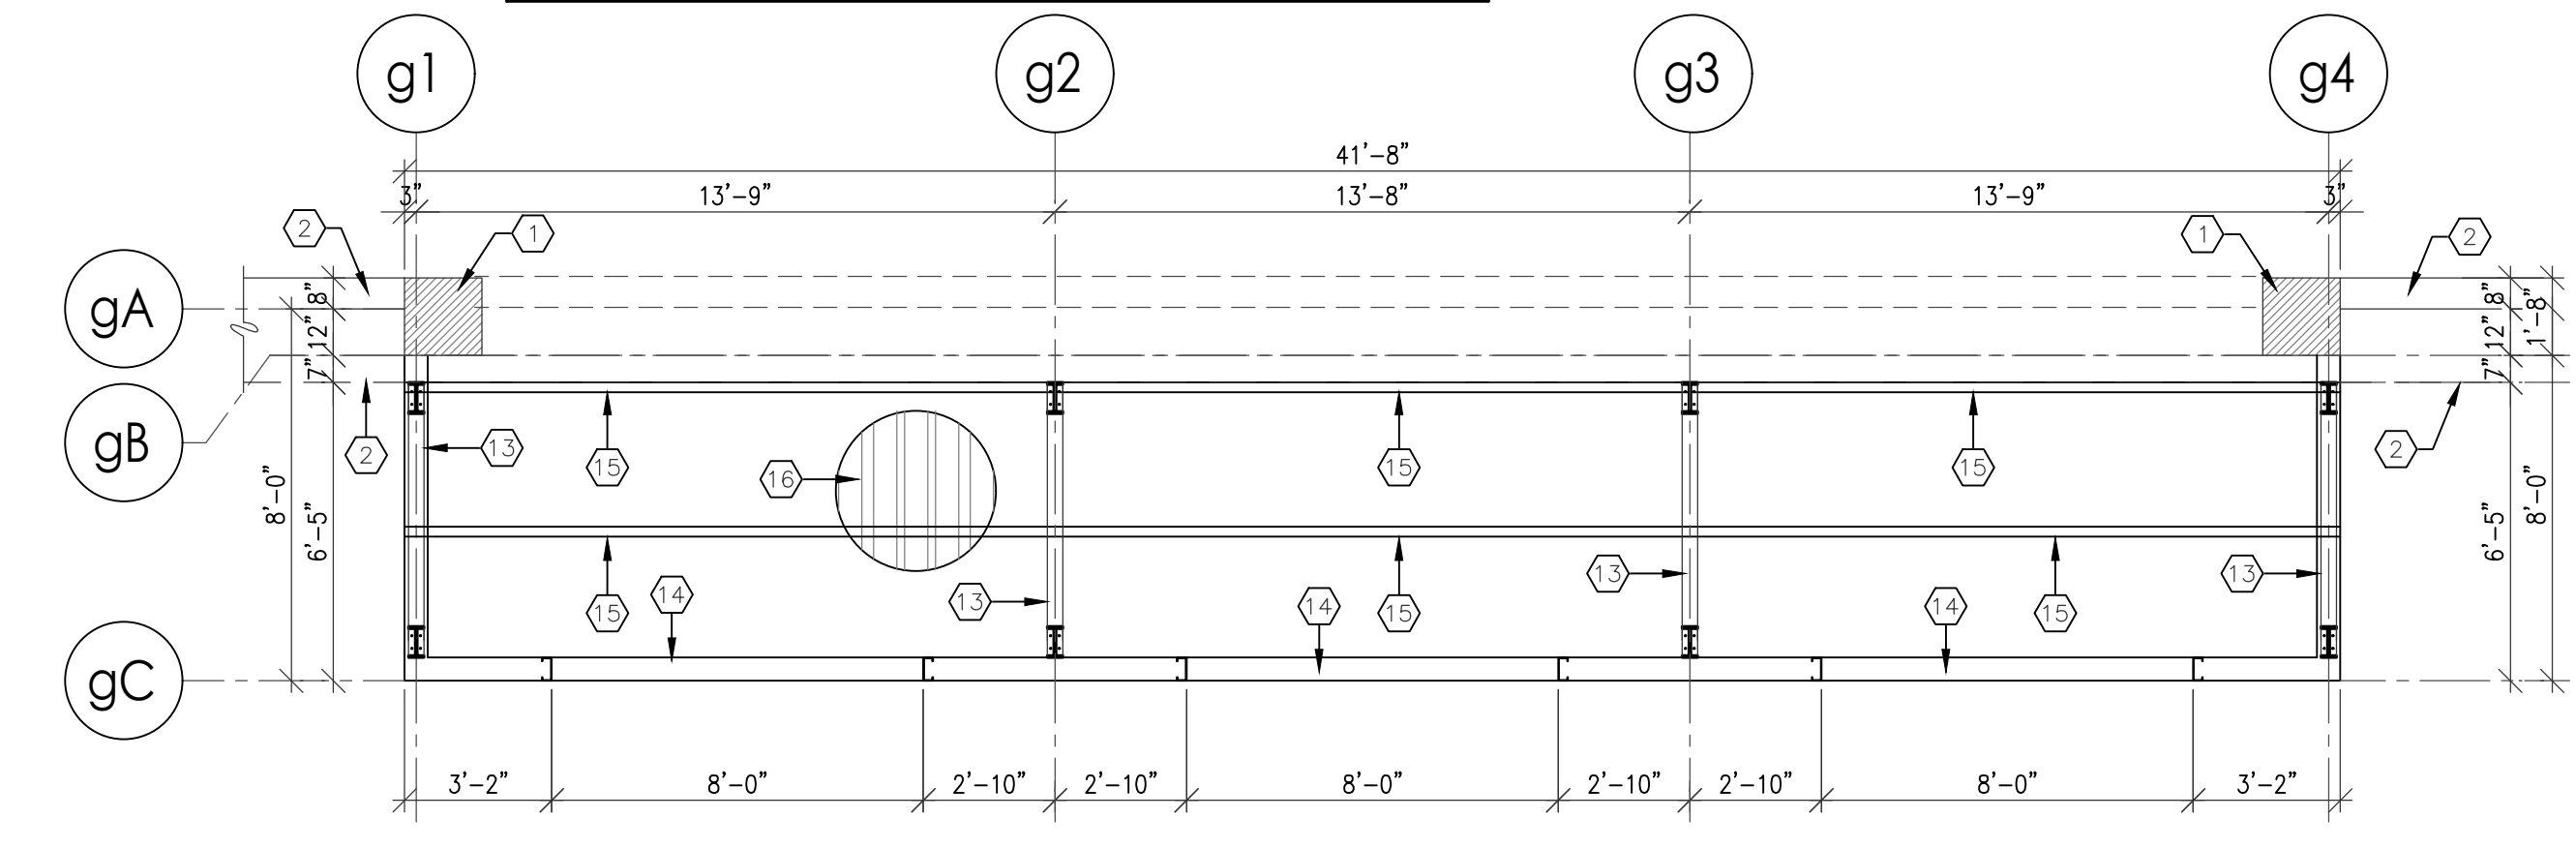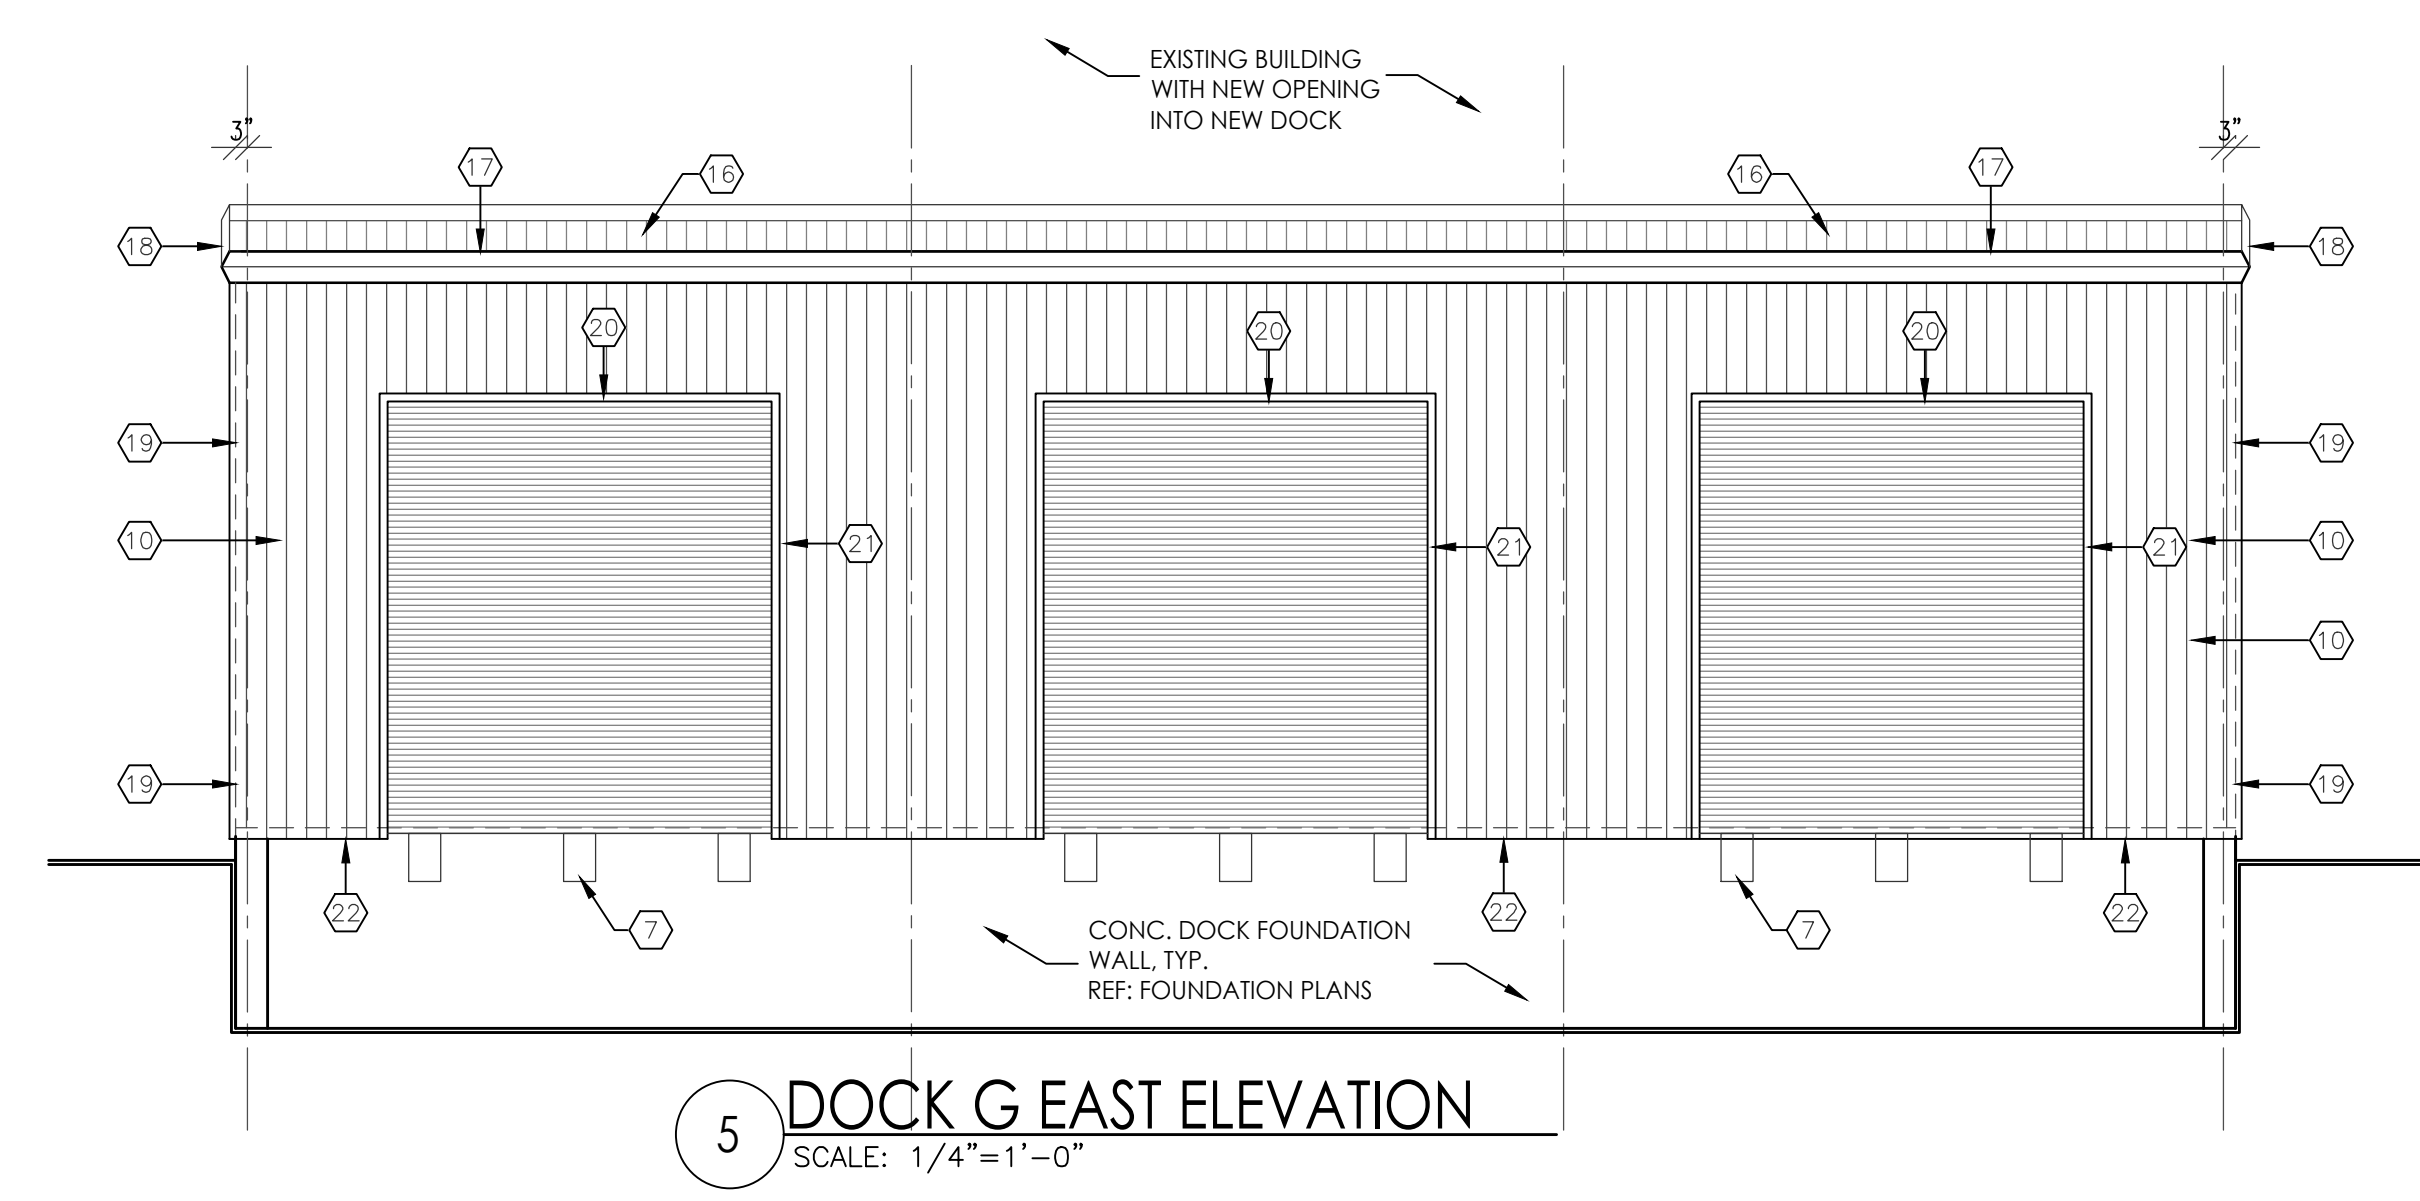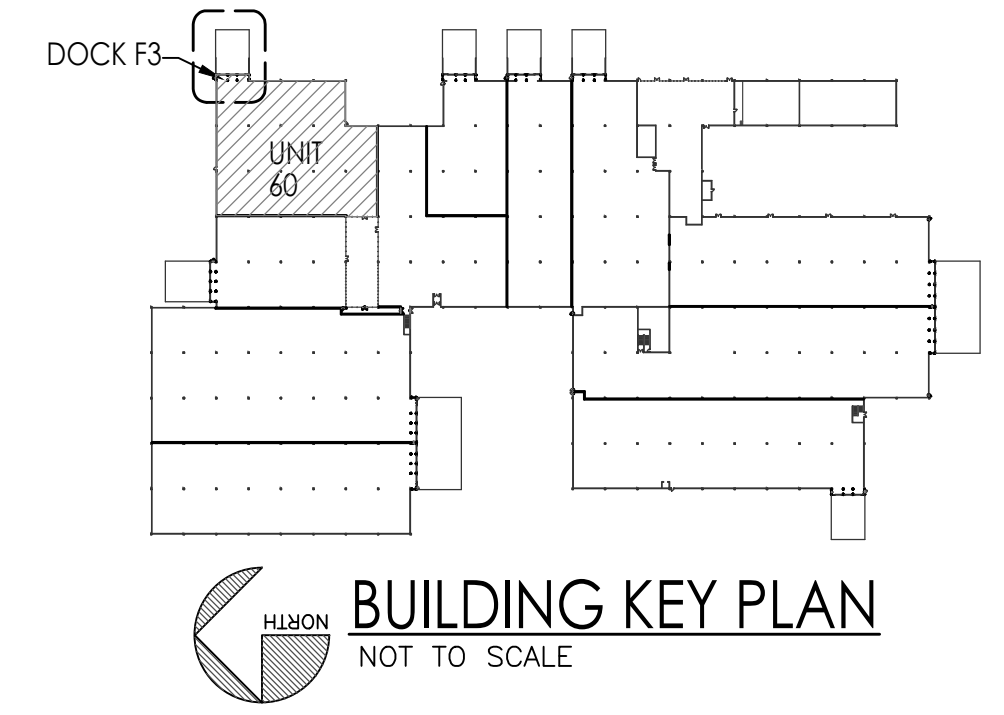

HONEYWELL WAREHOUSES
DOCK G ARCH AND STRUCTURAL PLANS
9201 SAN MATEO BLVD NE.
ALBUQUERQUE, NM 87113
#2354

REVISION DATE
DATE 3/22/2024
SHEET NUMBER A-3.90

