



DEVELOPMENT REVIEW APPLICATION

Effective 5/17/18

Please check the appropriate box and refer to supplemental forms for submittal requirements. All fees must be paid at the time of application.					
Administrative Decisions	☐ Historic Certificate of Ap (Form L)	propriateness – Major	☐ Wireless Telecommunications Facility Waiver (Form W2)		
☐ Archaeological Certificate (Form P3)	☐ Historic Design Standard	ds and Guidelines (Form L)	Policy Decisions		
☐ Historic Certificate of Appropriateness – Minor (Form L)	☐ Master Development Pla	an <i>(Form P1)</i>	☐ Adoption or Amendment of Comprehensive Plan or Facility Plan (Form Z)		
☐ Alternative Signage Plan (Form P3)	☐ Site Plan – EPC includin (Form P1)	g any Variances – EPC	☐ Adoption or Amendment of Historic Designation (Form L)		
☐ WTF Approval <i>(Form W1)</i>	☐ Site Plan – DRB (Form F	P2)	☐ Amendment of IDO Text (Form Z)		
Minor Amendment to Site Plan (Form P3)	\square Subdivision of Land – M	inor (Form S2)	☐ Annexation of Land (Form Z)		
Decisions Requiring a Public Meeting or Hearing	☐ Subdivision of Land – M	ajor <i>(Form S1)</i>	☐ Amendment to Zoning Map – EPC (Form Z)		
☐ Conditional Use Approval (Form ZHE)	☐ Vacation of Easement or	Right-of-way (Form V)	☐ Amendment to Zoning Map – Council (Form Z)		
☐ Demolition Outside of HPO (Form L)	☐ Variance – DRB (Form \	/)	Appeals		
☐ Expansion of Nonconforming Use or Structure (Form ZHE)	☐ Variance – ZHE (Form 2	ZHE)	☐ Decision by EPC, LC, DRB, ZHE, or City Staff (Form A)		
APPLICATION INFORMATION					
Applicant: CU Anytime, LLC Attn	: Patricia Holland		Phone: 505-346-2058		
Address: 3121 Carlisle Blvd NE			Email: pholland@cuatm.org		
City: Albuquerque		State: NM	Zip: 87110		
Professional/Agent (if any): Formative Arch		Phone: 505-947-6809			
Address: 209 Gold Ave SW		,	Email: owenk@formativearchitecture.com		
city: Albuquerque		State: NM	Zip: 87102		
Proprietary Interest in Site: N/A List all owners: Rio Grande Credit Union					
BRIEF DESCRIPTION OF REQUEST					
The addition of two ATM Kiosks a	nd drive aisles.				
SITE INFORMATION (Accuracy of the existing le	egal description is crucial!	<u>.</u>	necessary.)		
Lot or Tract No.: P1		Block: 0000	Unit:		
Subdivision/Addition: ATRISCO BUSINESS PA	RK UNIT 3	MRGCD Map No.: 39	UPC Code: 101005847812340608		
Zone Atlas Page(s): J-10-Z	Existing Zoning: NR-B	P	Proposed Zoning: NR-BP		
# of Existing Lots: 1	# of Proposed Lots: 1		Total Area of Site (acres): 1.9573		
LOCATION OF PROPERTY BY STREETS					
Site Address/Street: 485 Coors Blvd NW	Between: Los Volcan	es Rd NW	and: Bluewater Rd NW		
CASE HISTORY (List any current or prior project and case number(s) that may be relevant to your request.)					
Signature: Um llan			Date: 3/19/2020		
Printed Name: Owen Kramme ☐ Applicant or 🂢 Agent			☐ Applicant or X Agent		
FOR OFFICIAL USE ONLY					
Case Numbers		Action	Fees		
SI-2020-00081		AA			
-					
-					
Meeting/Hearing Date:	Meeting/Hearing Date: Fee Total:				
Staff Signature:		Date:	Project #PR-2020-003561		

FORM P3: ADMINISTRATIVE DECISIONS AND MINOR AMENDMENTS

A single PDF file of the complete application including all plans and documents being submitted must be emailed to <u>PLNDRS@cabg.gov</u> prior to making a submittal. Zipped files or those over 9 MB cannot be delivered via email, in which case the PDF must be provided on a CD.

☑ INFORMATION REQUIRED FOR ALL ADMINISTRATIVE DECISIONS OR AMENDMENTS

- X Letter of authorization from the property owner if application is submitted by an agent
- X Zone Atlas map with the entire site clearly outlined and labeled

□ ARCHEOLOGICAL CERTIFICATE

- __ Archaeological Compliance Documentation Form with property information section completed
- Only the information above is required unless the City Archaeologist determines that the application does not qualify for a Certificate of No Effect, in which case a treatment plan prepared by a qualified archaeologist that adequately mitigates any archeological impacts of the proposed development must be submitted and reviewed for a Certificate of Approval per the criteria in IDO Section 14-16-6-5(A)(3)(b)

■ MINOR AMENDMENT TO SITE PLAN – ADMIN, EPC, or DRB

- Justification letter describing, explaining, and justifying the request per the criteria in IDO Section 14-16-6-4(X)(2)
- Three (3) copies of all applicable sheets of the approved Site Plan being amended, folded
- Copy of the Official Notice of Decision associated with the prior approval
- Three (3) copies of the proposed Site Plan, with changes circled and noted
 - Refer to the Site Plan Checklist for information needed on the proposed Site Plan.

Minor Amendments must be within the thresholds established in IDO TABLE 6-4-5. Any amendment beyond these thresholds is considered a Major Amendment and must be processed through the original decision-making body for the request.

$oldsymbol{oldsymbol{eta}}$ MINOR AMENDMENT TO SITE DEVELOPMENT PLAN APPROVED PRIOR TO THE EFFECTIVE DATE OF THE IDO

- X Justification letter describing, explaining, and justifying the request per the criteria in IDO Section 14-16-6-4(Y)(1)(a)
- X Three (3) copies of all applicable sheets of the approved Site Development Plan being amended, folded
- X Copy of the Official Notice of Decision associated with the prior approval
- Three (3) copies of the proposed Site Development Plan, with changes circled and noted Refer to the Site Plan Checklist for information needed on the proposed Site Plan.

Minor Amendments must be within the thresholds established in IDO TABLE 6-4-5. Any amendment beyond these thresholds is considered a Major Amendment and must be processed through the original decision-making body for the request.

AL.	TERNATIVE SIGNAGE PLAN
	Proposed Alternative Signage Plan compliant with IDO Section 14-16-5-12(F)(5)
	Justification letter describing, explaining, and justifying the request per the criteria in IDO Section 14-16-6-5(F)(4)(c)
	Required notices with content per IDO Section 14-16-6-4(K)(6)
	Office of Neighborhood Coordination notice inquiry response and proof of emailed notice to affected Neighborhood
	Association representatives
	Sign Posting Agreement

I, the applicant or agent, acknowledge that if any required information is not submitted with this application, the application will not be scheduled for a public meeting or hearing, if required, or otherwise processed until it is complete.					
Signature: Ju Man	Date: 3/19/2020				
Printed Name: Owen Kramme	☐ Applicant or ☒ Agent				
FOR OFFICIAL USE ONLY					
Project Number:	Case Numbers	1 1 0 11			
PR-2020-003561	SI-2020 - 00081	The state of the s			
	-				
	y -	(1/1/16)			
Staff Signature:	MEXICA				
Date:		AAAAAAA			



March 25, 2020

City of Albuquerque Permit Desk 600 2nd Street NW Albuquerque, NM 87102

RE:

Permit Request

Tract P-1, Atrisco Business Park, Unit 2 Bernalillo County, New Mexico

Rio Grande Credit Union

To Whom It May Concern:


Rio Grande Credit Union is the owner of Tract P-1, Atrisco Business Park, Unit 2 Bernalillo County, New Mexico. Rio Grande Credit Union Is working with CU Anytime, LLC and Formative Architecture for improvements needed for a new and improved ATM site at our branch at 485 Coors NM, Albuquerque, NM. They have permission to act as our agents in all matters as it pertains to these improvements. If you have any questions or concerns, please feel free to contact me at (505) 366-5061 or via email at mike@riograndecu.org.

Sincerely,


Mike Athens

President/CEO

xc: Pat Holland, President and CEO

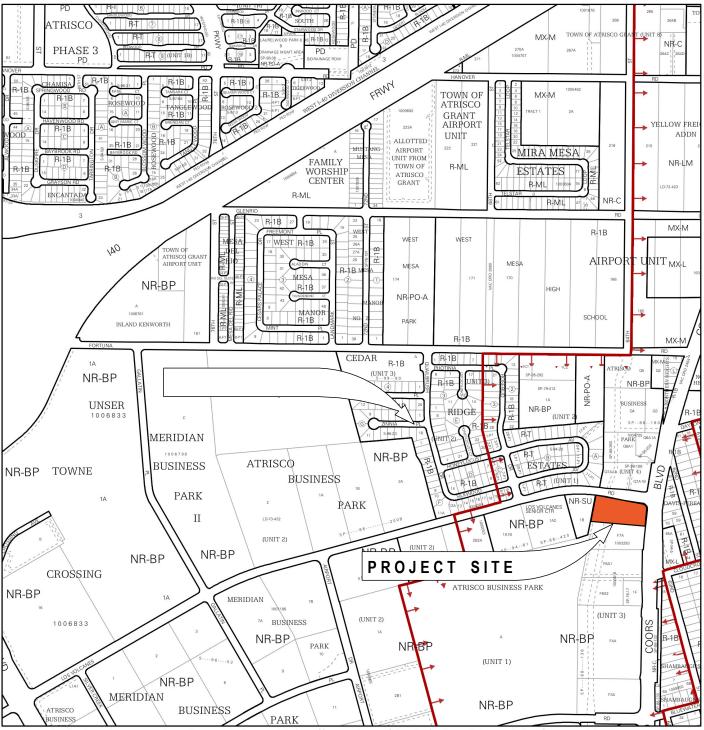

For more details about the Integrated Development Ordinance visit: http://www.cabq.gov/planning/codes-policies-regulations/integrated-development-ordinance

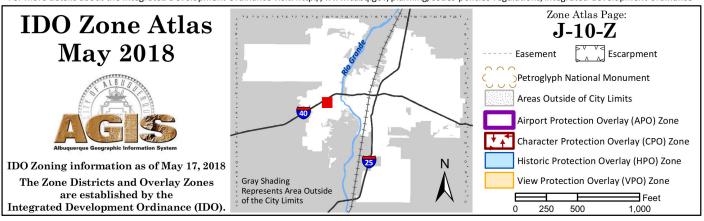

March 19, 2020

City of Albuquerque
Development Review Application
Form P3: Administrative Decisions and Minor Amendments



REFERENCE: MINOR AMENDMENT TO SITE DEVELOPMENT PLAN APPROVED PRIOR TO THE EFFECTIVE DATE OF THE IDO

We are requesting a Minor Amendment To Site Development Plan Approved Prior To The Effective Date Of The IDO (Application Number: 03DRB-00807) per the criteria in IDO Section 14-16-6-4(Y)(1)(a)(2). The requested change is within the thresholds for Administrative Amendments established in Table 6-4-5, cumulative of prior deviations or administrative amendments. This amendment would be categorized as "Any other numerical standard" under Table 6-4-5: Allowable Minor Amendments. The total lot square footage is 85,260 with the new improvements totaling 2,591 square feet of new paving and flatwork. This new work is approximately 3% of the total site square footage, within the threshold set forth by table 6-4-5.

If you have any questions, concerns, or need additional information regarding anything contained herein, please do not hesitate to contact me directly at 505-947-6809.


Sincerely, FORMATIVE Architecture

Owen Kramme, AIA Principal / Architect


architecture interiors planning engineering

Albuquerque, NM 87109

PLAN FOR BUILDING

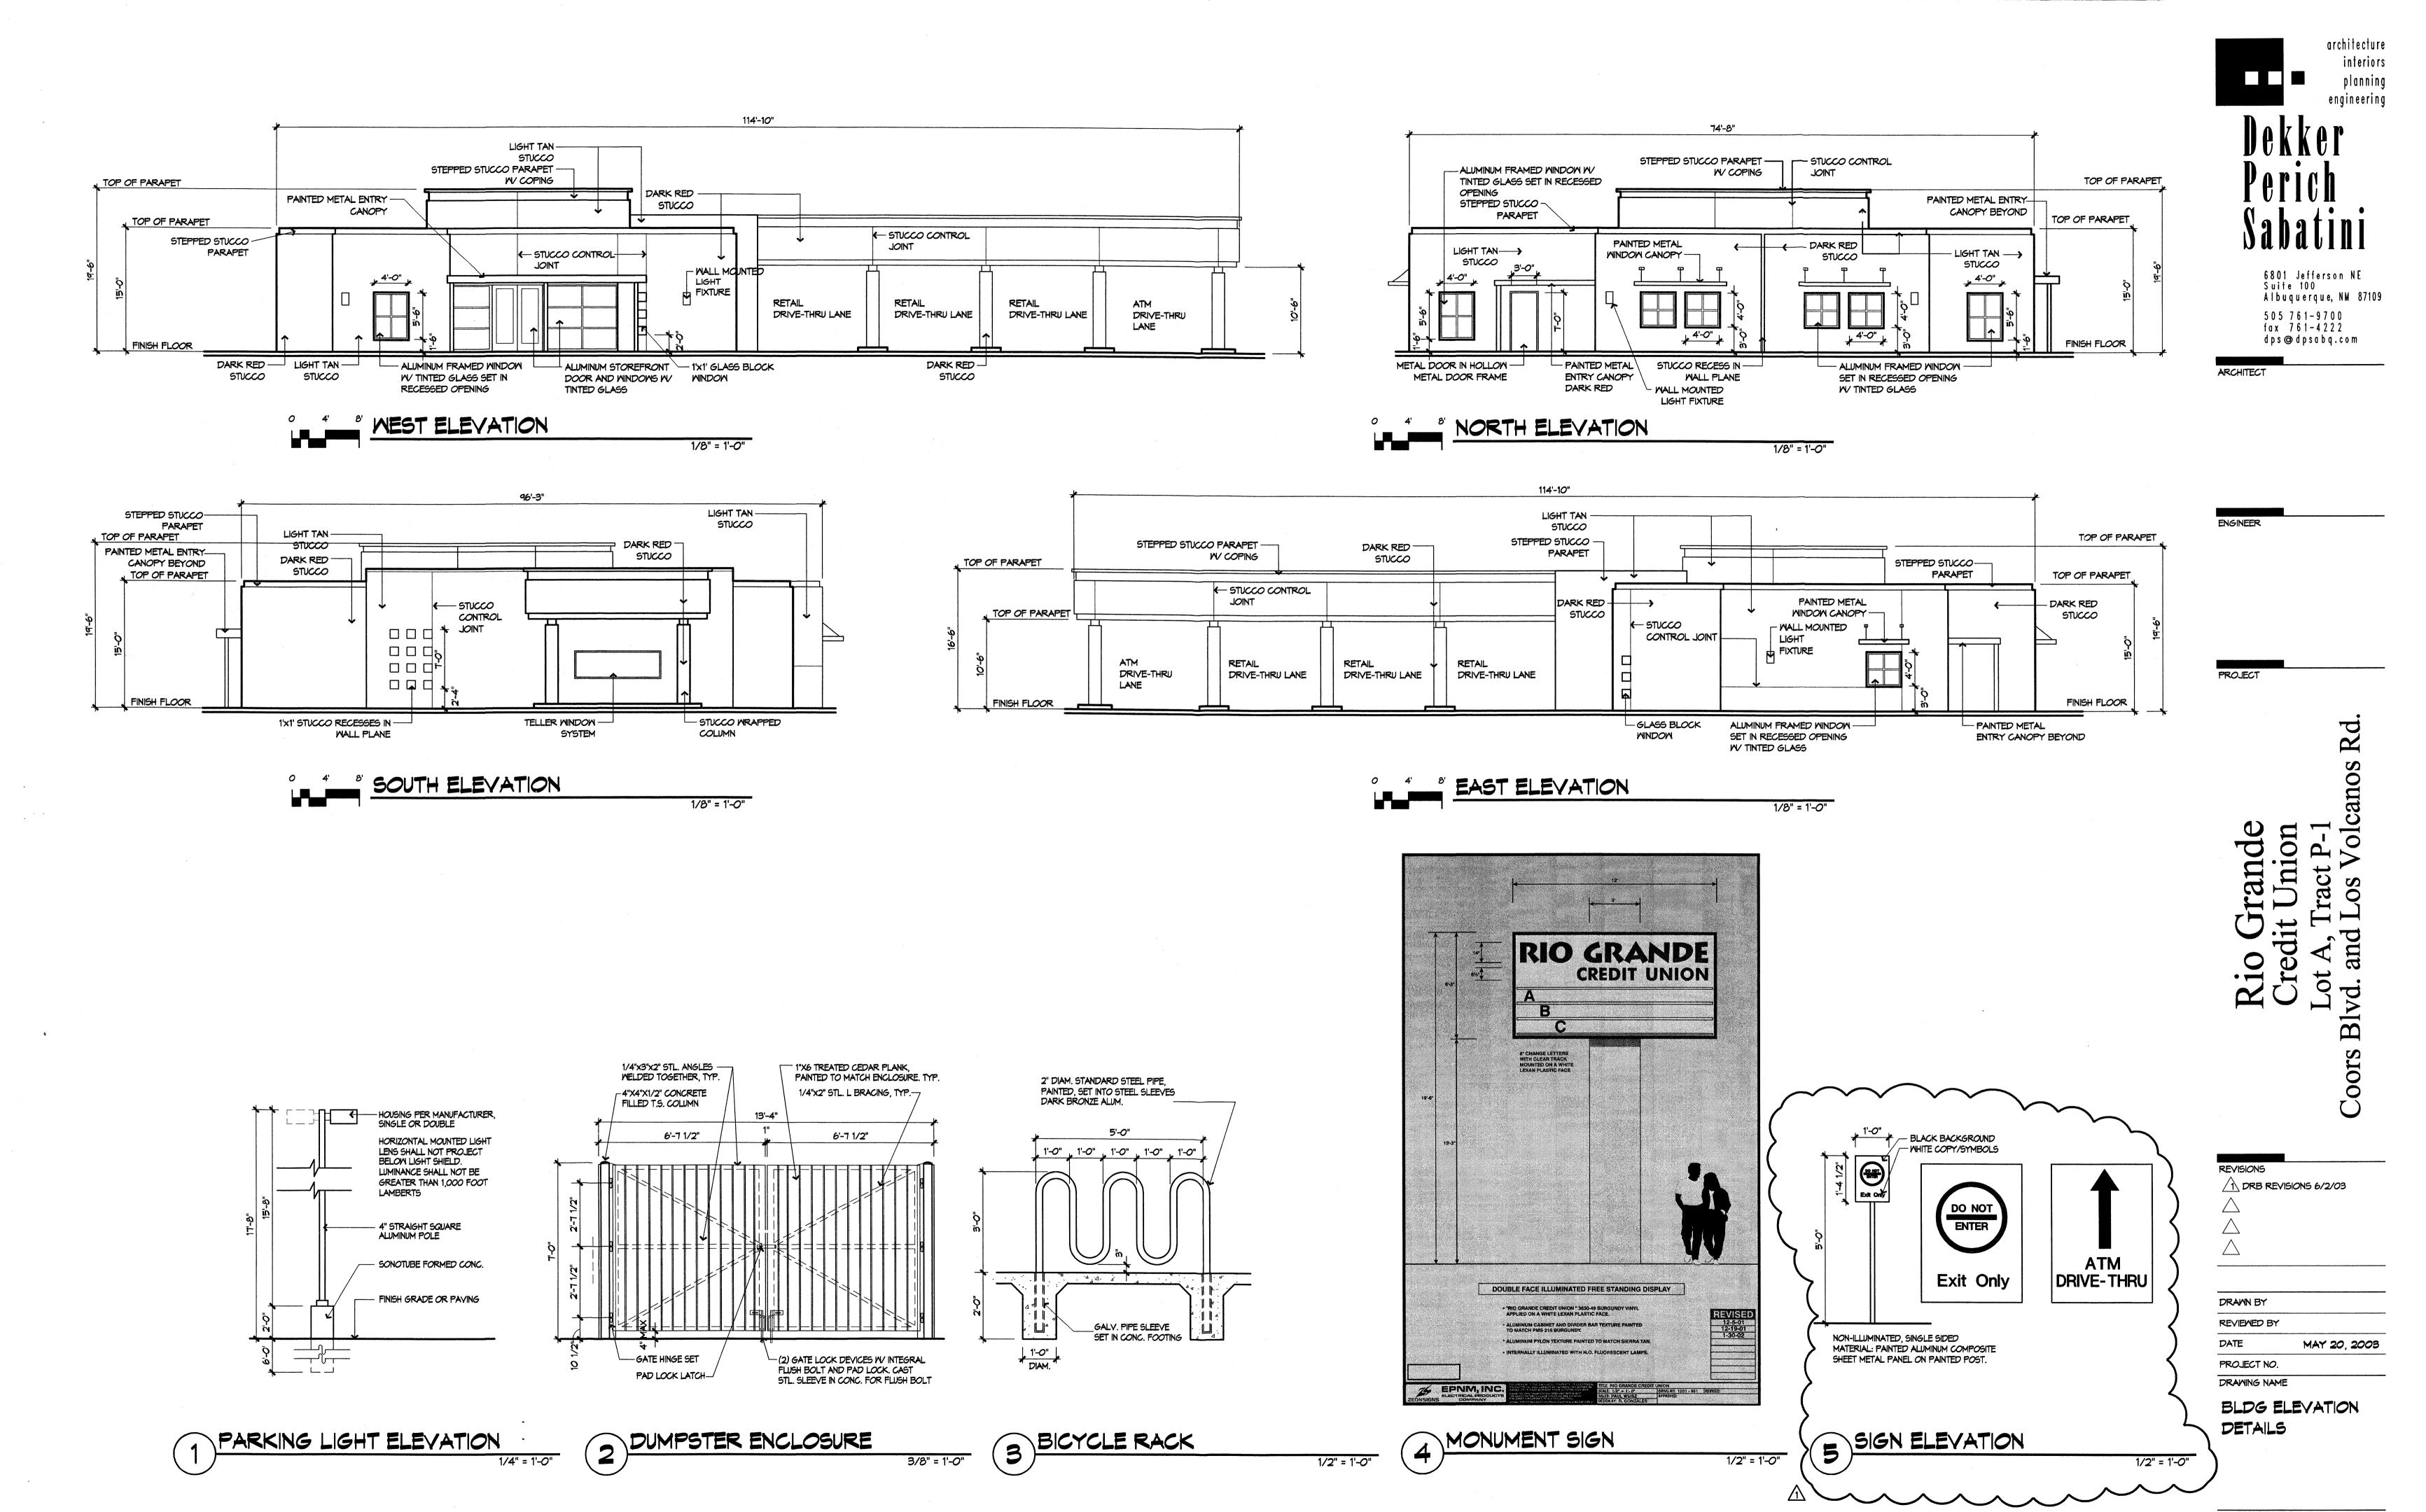

SHEET NO.

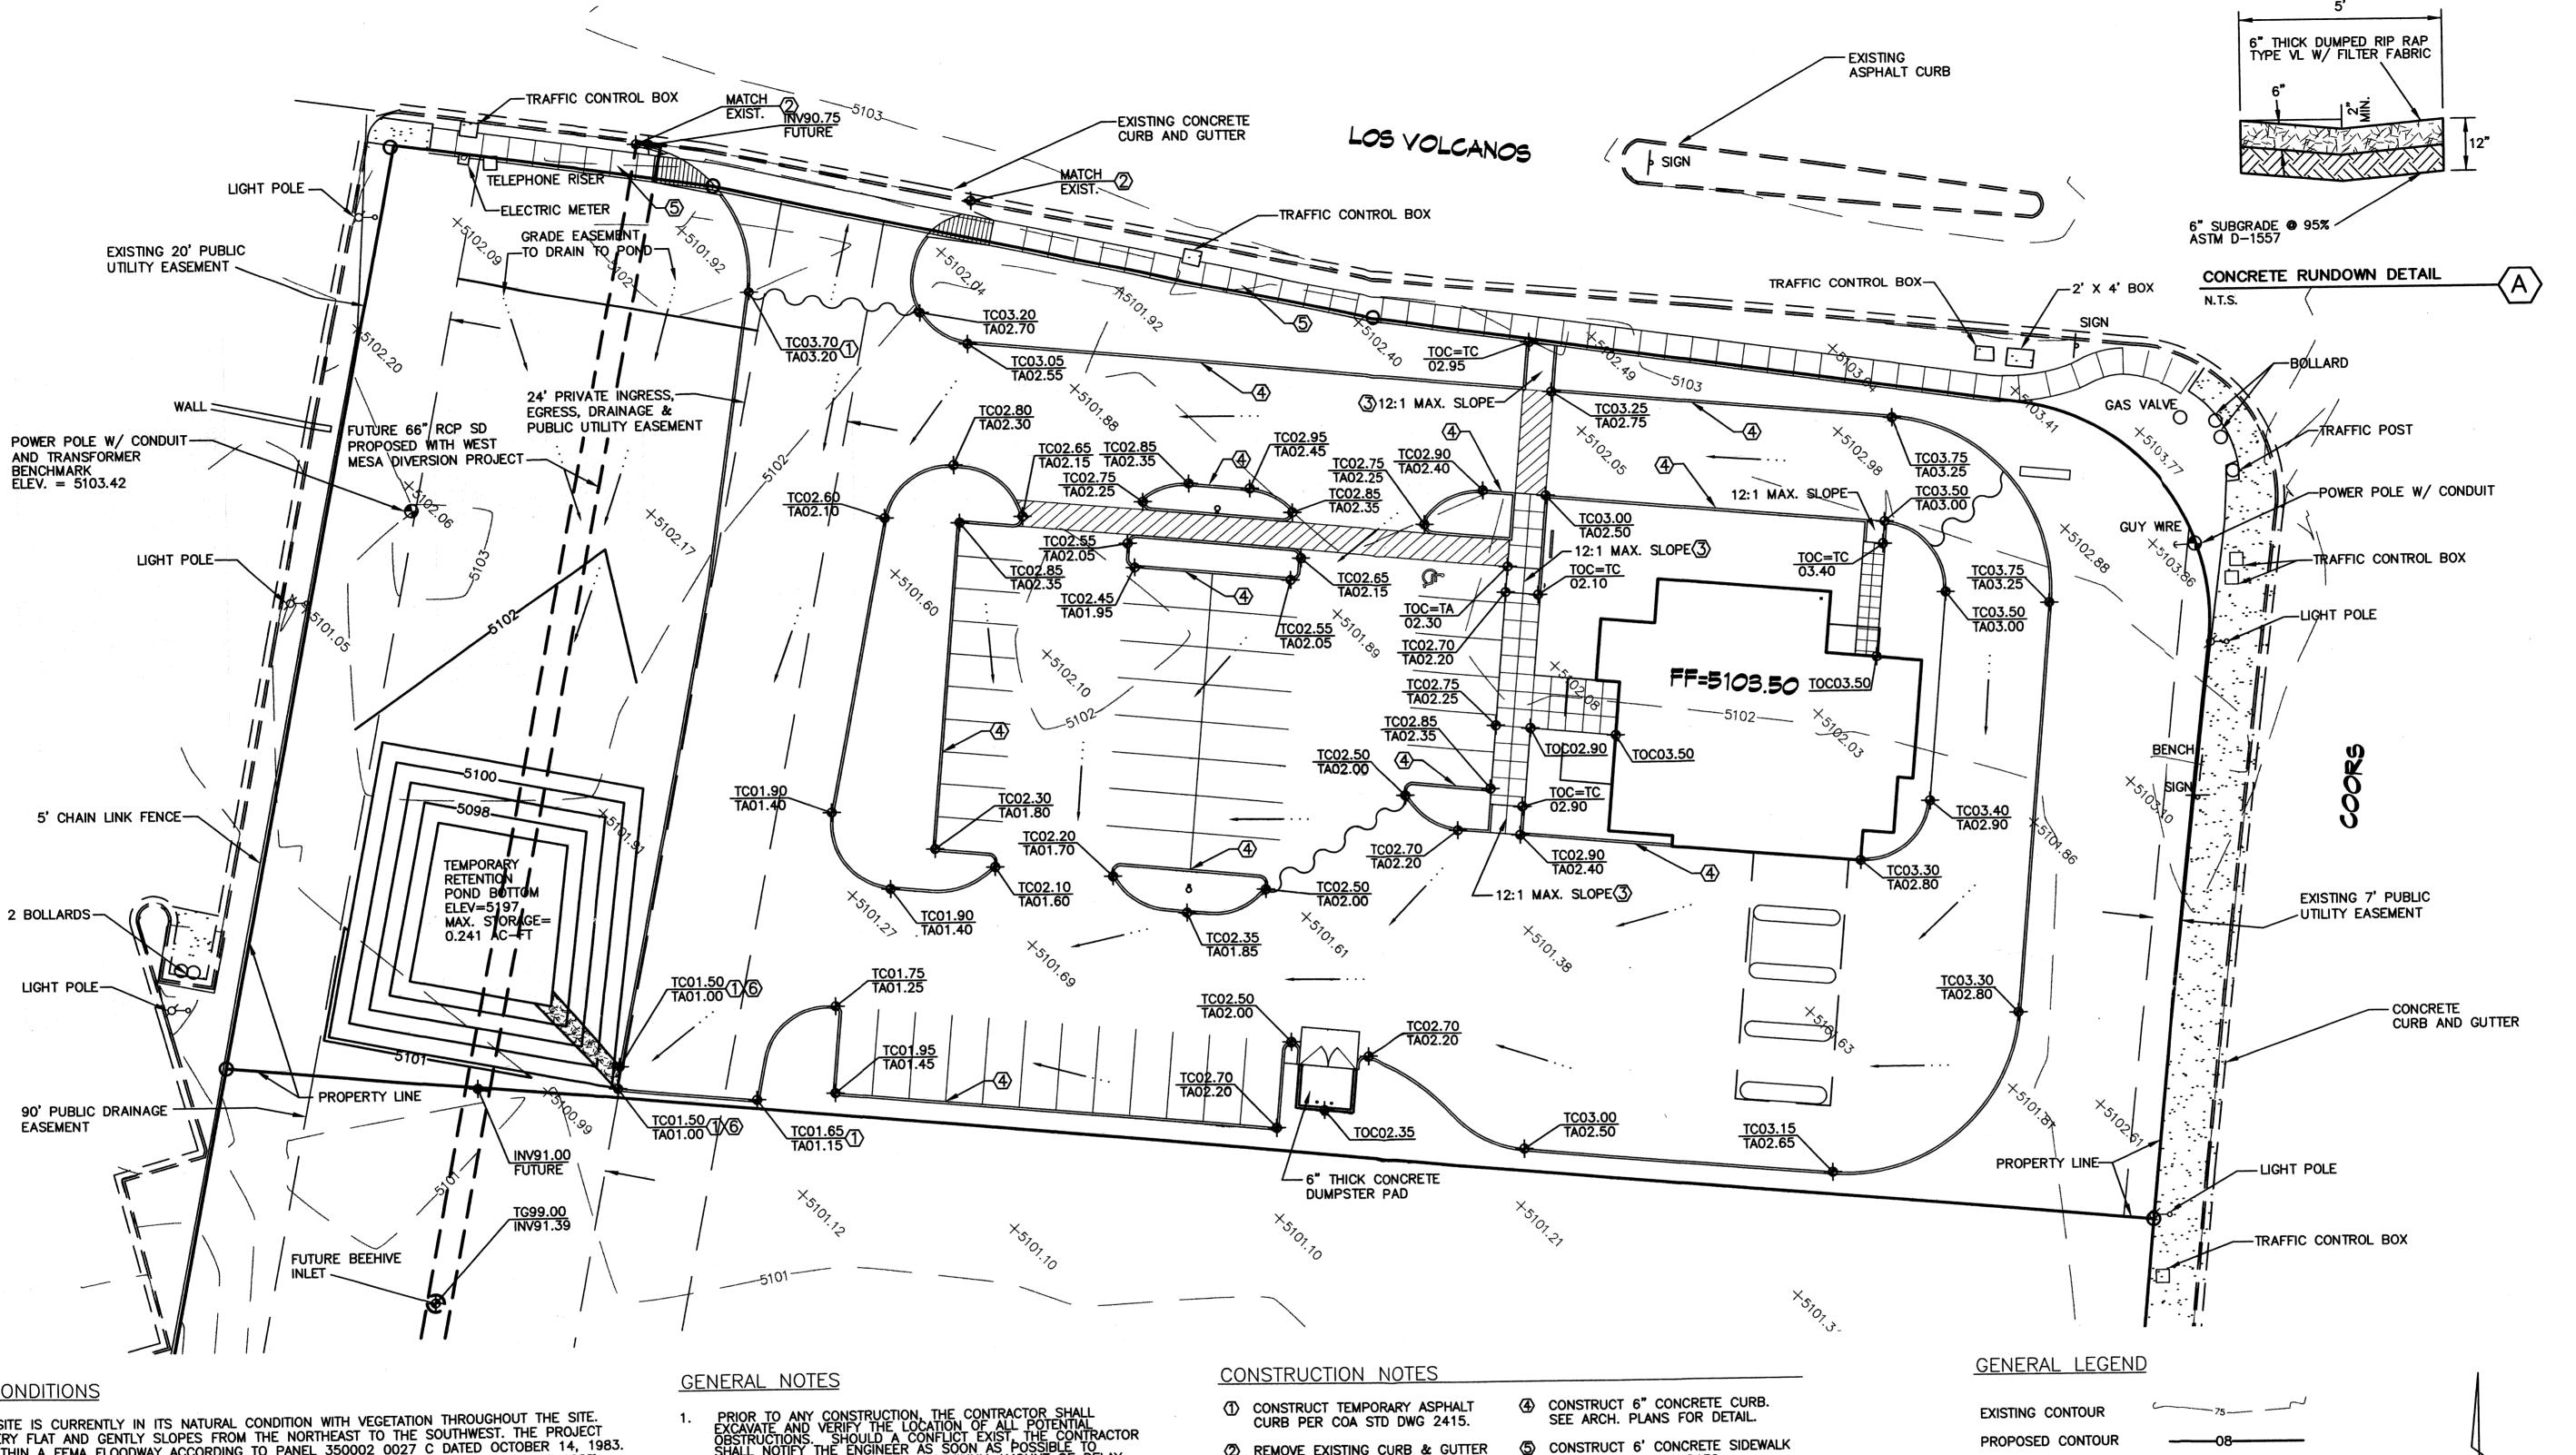

EXISTING CONDITIONS

THE PROJECT SITE IS CURRENTLY IN ITS NATURAL CONDITION WITH VEGETATION THROUGHOUT THE SITE. THE SITE IS VERY FLAT AND GENTLY SLOPES FROM THE NORTHEAST TO THE SOUTHWEST. THE PROJECT SITE IS NOT WITHIN A FEMA FLOODWAY ACCORDING TO PANEL 350002 0027 C DATED OCTOBER 14, 1983. THE EXISTING CONDITIONS ON THE SITE PRODUCE 2.05 CFS WITH TYPE 'A' LAND TREATMENT OF 100%.

PROPOSED CONDITIONS

A MAJORITY OF THE PROJECT SITE WILL BE PAVED. THE SITE WILL RETAIN ITS NATURAL FLOW DIRECTION, NORTHEAST TO SOUTHWEST. NO OFF-SITE STORM WATER RUNOFF WILL ENTER THE SITE. STORM WATER FROM THE SITE WILL SHEET FLOW TO THE SOUTHWEST CORNER WHERE IT WILL DRAIN INTO A TEMPORARY DETENTION POND. THE POND WILL COLLECT RUNOFF FROM THE PARKING LOT, BUILDING AND ADJACENT UTILITY AND DRAINAGE EASEMENTS ON THE WEST END OF THE SITE. THE POND WILL BE FILLED IN WITH THE CONSTRUCTION OF THE STORM DRAIN PIPE WITHIN THE THE 90' DRAINAGE EASEMENT. THE STORM DRAIN PIPE WILL BE PLACED IN THE EASEMENT WITH THE WEST MESA DIVERSION PROJECT PHASE 2 (CITY PROJECT NO. 538102). THE WEST MESA DIVERSION PROJECT PHASE 2 WILL ALLOW FREE DISCHARGE INTO INLETS TO BE CONSTRUCTED WITHIN THE DRAINAGE EASEMENT. PROPOSED CONDITIONS ON THE SITE DISCHARGING TO THE RETENTION POND IS FOR OFF WITH A RECUIRED RETENTION STORAGE OF 0.241 AC-DISCHARGING TO THE RETENTION POND IS 5.05 CFS WITH A REQUIRED RETENTION STORAGE OF 0.241 AC-FT. DEVELOPED LAND TREATMENTS FOR THIS PROJECT ARE AS FOLLOWS: %A=0, %B=35, %C=0 AND %D=65 FOR THE BASIN DISCHARGING TO THE RETENTION POND. THE SMALL AREA OF LANDSCAPING DISCHARGING TO THE STREET (BASIN 102.D) LAND TREATMENTS WERE AS FOLLOWS: %A=0, %B=50, %C=50 AND %D=0.

DURING CONSTRUCTION OF THE FUTURE STORM DRAIN PIPE, RUNOFF FROM THE SITE WILL FLOW IN THE

DIRECTION OF THE PROPOSED BEEHIVE TEE MANHOLE LOCATED JUST SOUTH OF THE RETENTION POND.

- THE CONTRACTOR SHALL OBTAIN ANY AND ALL PERMITS REQUIRED BY THE CITY OF ALB. FOR THE COMPLETION OF THE WORK PRIOR TO BEGINNING CONSTRUCTION.

- ② REMOVE EXISTING CURB & GUTTER AND PROVIDE DRIVE WAY PER COA
- STD DWG 2426. (3) CONSTRUCT HANDICAP RAMP. SEE
- ARCH. PLANS FOR DETAIL.

HYDROLOGY CALCULATIONS


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*5 Rio Grande Credit Unio	on							
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*S*****		00257	1.74				1.069 PER IMP=	.00
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ADD HYD		******	*****	******				
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*S ON-SITE BASIN 101	.D - DRAIN- 3	TO ADJACENT	STREETS	.017	.68403	1.500	2.129 FBR 2.1	
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PER COA STD DWG 2430.

6 CONSTRUCT RIP RAP RUNDOWN

PER DETAIL 'A' THIS SHEET.



TOP OF GRATE

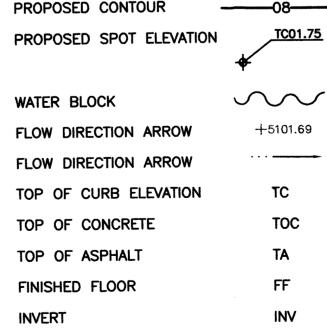DESIGN BUILDERS

6300 Riverside Plaza Ln NW Suite 220 Albuquerque, NM 87120 (505) 891-2528

333 Rio Rencho Drive NE, Suite 101 Rio Rancho, New Mexico 67124 Phone (505) 892-5141 Fex (505) 892-3250

architecture interiors engineering

> Suite 100 Albuquerque, NM 87109 505 761-9700 fax 761-4222 dps@dpsabq.com

6801 Jefferson NE

ARCHITECT

ENGINEER



PROJECT


ande

REVISIONS

DRAWN BY REVIEWED BY May 20, 2003 DATE PROJECT NO.


DRAWING NAME GRADING & DRAINAGE PLAN

SHEET NO.

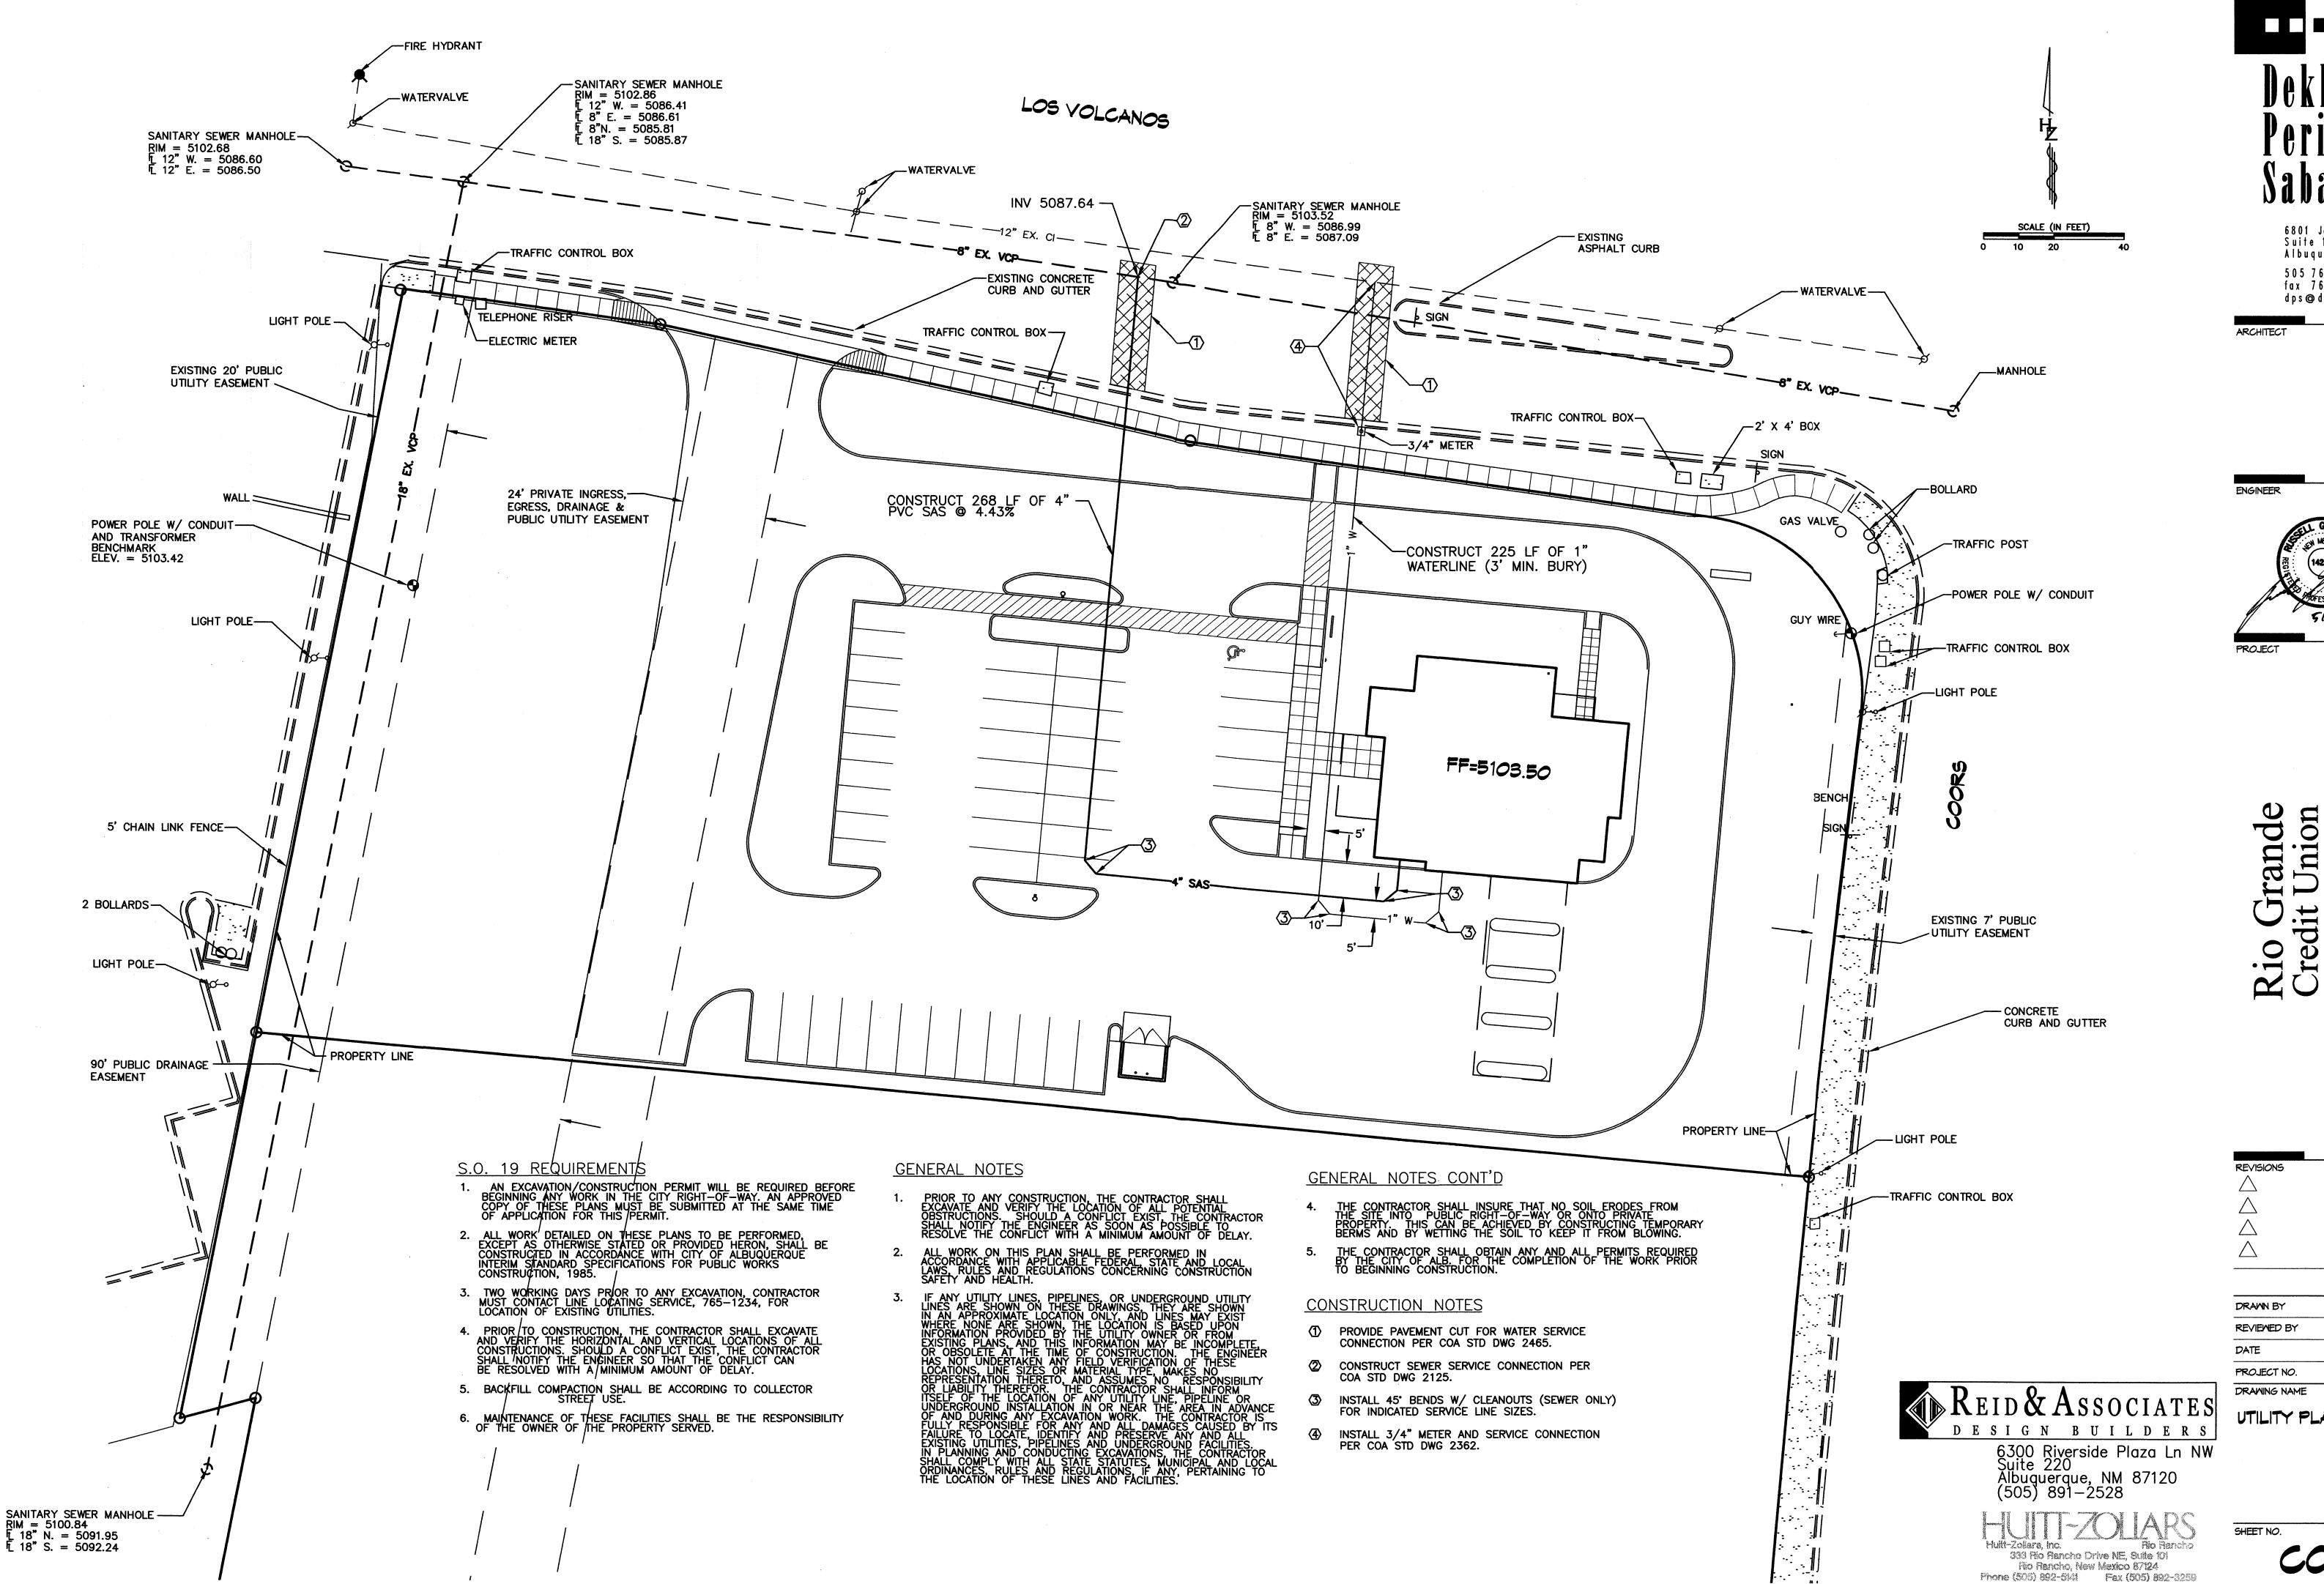

architecture planning engineering

6801 Jefferson NE Suite 100 Albuquerque, NM 87109 505 761-9700 fax 761-4222 dps@dpsabq.com

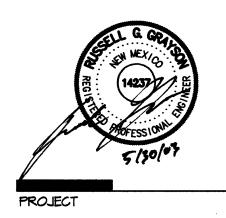

Frande t Union Tract P-1 Ó

Bj

DRAWN BY May 20, 2003

PROJECT NO.

UTILITY PLAN

SHEET NO.

LANDSCAPE NOTES:

Landscape maintenance shall be the responsibility of the Property Owner.

It is the intent of this plan to comply with the City Of Albuquerque Water Conservation Landscaping and Water Waste Ordinance planting restriction approach.

Approval of this plan does not constitute or imply exemption from water waste provisions of the Water Conservation Landscaping and Water Waste Ordinance. Water management is the sole responsibility of the Property Owner.

All landscaping will be in conformance with the City of Albuquerque Zoning Code, Street Tree Ordinance, Pollen Ordinance, and Water Conservation Landscaping and Water Waste Ordinance. In general, water conservative, environmentally sound landscape principles will be followed in design and installation.

Plant beds shall achieve 75% live ground cover at maturity.

S.F. Brown Gravel over Filter Fabric shall be placed in all landscape areas which are not designated to receive native seed.

IRRIGATION NOTES:

Irrigation shall be a complete underground system with Trees to receive (5) 1.0 GPH Drip Emitters and Shrubs to receive (2) 1.0 GPH Drip Emitters. Drip and Bubbler systems to be tied to 1/2" polypipe with flush caps at each end.

Run time per each drip valve will be approximately 15 minutes per day, to be adjusted according to the season.

Point of connection for irrigation system is unknown at current time and will be coordinated in the field.

Irrigation will be operated by automatic controller. Location of controller to be field determined and power source for controller to be provided by others.

Irrigation maintenance shall be the responsibility of the Property Owner.


LANDSCAPE CALCULATIONS

NET LANDSCAPE AREA

TOTAL	LOT AREA	85,260	square	feet
TOTAL	BUILDINGS AREA	3,610	square	
OFFSITE	E AREA	5,192	square	
NET LO	OT AREA	76,458	square	
LANDSC	CAPE REQUIREMENT	15%	, , , , , ,	
TOTAL I	LANDSCAPE REQUIREMENT	11,468	square	feet
TOTAL	LANDSCAPE PROVIDED	43,074	square	feet
TOTAL	BED PROVIDED	24,191	square	
TOTAL	SOD PROVIDED	0	square	
TOTAL	NATIVE SEED PROVIDED	18,883	square	

square feet

ASH (M+) AND HONEY LOCUST (M) 11 Fraxinus pennsylvanica Gleditsia triacanthos 2" Cal.

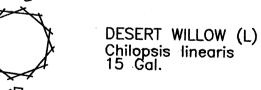

DESERT WILLOW (L) 6

PALM YUCCA (L) 2

RUSSIAN SAGE (M) 9

Perovskia atriplicifolia 5 Gal. 25sf

MAIDENGRASS (M) 24 Miscanthus sinensis 5 Gal. 16sf

Raphiolepis indica

Fallugia paradoxa 5 Gal. 25sf


3/4" GRAY GRAVEL


WITH FILTER FABRIC

5 Gal.

INDIAN HAWTHORN (M) 13

APACHE PLUME (L) 27

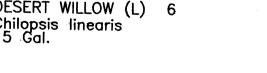

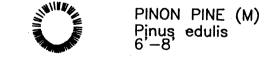



NEW MEXICO OLIVE (M)

Forestiera neomexicana

CRABAPPLES (H) 5

Malus cultivars

GAURA (M) 31 Gaura lindheimeri 1 Gal. 16sf

5 Gal.

15 Gal.

PURPLE SILVER GRASS (M) 46 Miscanthus sinensis 'pupurascans'

> LITTLE BUNNY FOUNTAIN GRASS (M) 16 Pennisetum alopecuroides 'Little Bunny' 1 Gal.

BLUE MIST SPIREA (M) 32 Caryopteris clandonensis 5 Gal.

CRIMP STRAW/NATIVE SEED



POTENTILLA (M) 54 Potentilla fruticosa 2 Gal.


AUTUMN SAGE (M) 45 Salvia greggii 2 Gal. 9sf

HONEYSUCKLE (M) 30 Lonicera sempervirens 1 Gal. 200sf Unstaked—Groundcover

> CHAMISA (L) 21 Chrysothamnus nauseosus 1 Gal. 25sf

WILDFLOWER 66 1 Gal.

CREEPING ROSEMARY (M) 18 Rosmarinus officinalis 'Prostrata' 5 Gal. Symbol indicates 3 plants

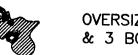

OVERSIZED GRAVEL & 3 BOULDERS



Cont. Lic. #26458 7909 Edith N.E. Albuquerque, NM 87184 Ph. (505) 898-9690 Fax (505) 898-7737 cmd@hilltoplandscaping.com
All creative ideas contained Herein remains the
property of The Hilltop Landscape Architects and
Contractors and are protected by copyright laws. This is
an original design and must not be released or conject an original design and must not be released or copied unless applicable fees have been paid or job order placed.

JES

MAY 20, 2003

LANDSCAPE PLAN FOR BUILDING PERMIT

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and


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PROPOSED RENDERING




GENERAL SYMBOLS LEGEND

NORTH ARROW

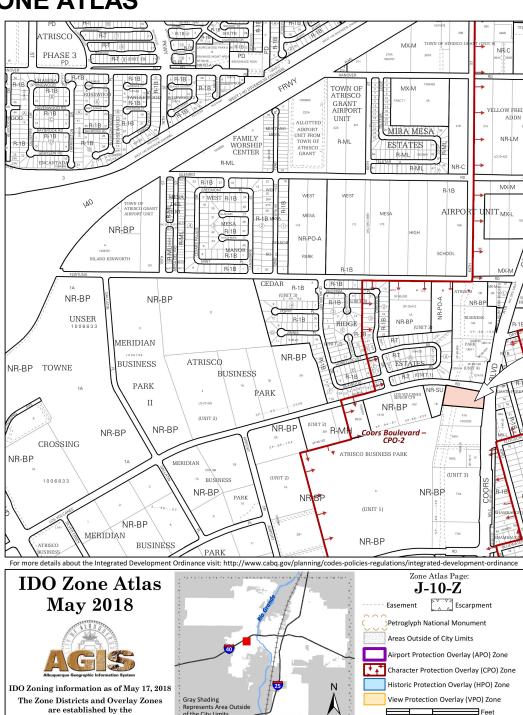


BUILDING SECTION / WALL SECTION

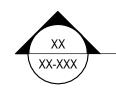

EXTERIOR ELEVATIONS



ENLARGED DETAIL DRAWING

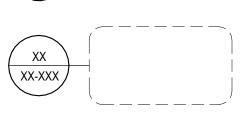

GENERAL NOTES

CONTRACTORS SUBMITTING PROPOSALS FOR THIS WORK SHALL FIRST EXAMINE THE SITE AND BECOME FAMILIAR WITH ALL CONDITIONS THEREON. ALL PROPOSALS SHALL TAKE INTO CONSIDERATION ALL SUCH AS MAY AFFECT THE WORK UNDER THIS CONTRACT.

 STATED DIMENSIONS SHALL TAKE PRECEDENCE OVER GRAPHICS. DO NOT SCALE THESE DRAWINGS. THE DESIGNER SHALL BE NOTIFIED IF ANY DISCREPANCIES OCCUR PRIOR TO

3. GENERAL CONTRACTOR SHALL OBTAIN APPROVALS, INSPECTIONS, CERTIFICATE OF OCCUPANCY AS REQUIRED, UNLESS NOTED OTHERWISE.

4. ALL GRADES, LINES AND BENCH MARKS FOR THE NEW CONSTRUCTION SHALL BE ESTABLISHED AND MAINTAINED BY THE CONTRACTOR, WHO SHALL BE RESPONSIBLE FOR THE SAME.
5. GENERAL CONTRACTOR SHALL BE RESPONSIBLE FOR ALL SAFETY PRECAUTIONS AND

REQUIREMENTS OF CONSTRUCTION.

6. THE DESIGNER DOES NOT ASSUME RESPONSIBILITY FOR JOB SITE SAFETY FOR ANY PERSONS INCLUDING WORKMEN, VISITORS OR ANY ENTITY WHICH MAY ENTER ONTO THE SITE.

7. CONTRACTOR'S CHOICE AS TO THE MEANS OF CONSTRUCTION, THE SEQUENCE OF CONSTRUCTION,

RESPONSIBILITY.

THE CONTRACTOR SHALL VERIFY DRAWING DIMENSIONS AGAINST ACTUAL SITE CONDITIONS AND BOUNDARIES AND SHALL NOTIFY THE DESIGNER OF ANY AREAS WHICH WOULD DIFFER FROM THE INTENT OF THE DRAWINGS, OR THAT SHOW DISCREPANCY BETWEEN SECTIONS OF THE DRAWINGS AND/OR ACTUAL SITE CONDITIONS PRIOR TO CONSTRUCTION. IN THE EVENT OF THE CONTRACTOR'S FAILURE TO GIVE SUCH NOTICE, HE WILL BE HELD RESPONSIBLE FOR THE RESULTS OF COST

9. DETAILS ARE INTENDED TO SHOW METHOD AND MANNER OF ACCOMPLISHING THE WORK. MINOR MODIFICATIONS MAY BE REQUIRED TO SUIT JOB REQUIREMENTS OR CONDITIONS AND SHALL BE INCLUDED AS PART OF WORK.

10. WORK NOT EXPLICIT IN THE DRAWINGS BUT CLEARLY IMPLIED AS NECESSARY TO COMPLETE THE PROJECT SHALL BE INCLUDED AS FULLY DRAWN.

11. NO GUARANTEE FOR QUALITY OF CONSTRUCTION IS IMPLIED OR INTENDED BY THESE DRAWINGS.
CONTRACTOR SHALL ASSUME FULL RESPONSIBILITY FOR ANY CONSTRUCTION DEFICIENCIES.
12. DESIGNER WILL NOT BE RESPONSIBLE FOR CONTRACTOR'S FAILURE TO CARRY OUT THE WORK IN

ACCORDANCE WITH THE CONTRACT DOCUMENTS.

13. DESIGNER WILL NOT HAVE CONTROL OR CHARGE OF AND WILL NOT BE RESPONSIBLE FOR ACTS OR OMISSIONS OF THE CONTRACTOR, SUBCONTRACTORS, THEIR AGENTS OR EMPLOYEES OR ANY OTHER PERSONS PERFORMING PORTIONS OF THE WORK.

14. AFTER JOB COMPLETION, SITE SHALL BE SWEPT CLEAN, AND ALL SURFACES SHALL BE CLEANED.

THE CONTRACTOR IS RESPONSIBLE FOR REMOVING ALL CONSTRUCTION DEBRIS

15. MOISTURE PROTECTION DURING CONSTRUCTION IS THE CONTRACTOR'S RESPONSIBILITY. SHOUL ANY SPECIAL SITUATIONS OR CLIMATIC CONDITIONS OCCUR DURING CONSTRUCTION, THE

MATERIALS AND ASSEMBLIES.

16. ALL WORK SHALL BE DONE TO IN ACCORDANCE WITH LOCAL CODES AND ORDINANCES.

17. GC SHALL NOTIFY THE DESIGNER OF ANY DISCREPANCIES, OMISSIONS, AND OR DIMENSIONAL ERRORS PRIOR TO THE START OF CONSTRUCTION.
18. ALL MATERIALS, PRODUCTS, AND EQUIPMENT SHALL BE INSTALLED PER ALL MANUFACTURER RECOMMENDATIONS. IN THE EVENT THAT THESE DRAWINGS CONTRADICT MEANS. METHODS. O

CONFIGURATIONS REQUIRED BY THE MANUFACTURER, NOTIFY THE DESIGNER PRIOR TO INSTALLATION.

19. ALL VEGETATION ON SITE WILL BE PRESERVED TO THE GREATEST EXTENT POSSIBLE

20. ACCESS TO SITE WILL BE THROUGH DESIGNATED AREAS ONLY
21. ALL CONCRETE WORK SHALL CONFORM TO AMERICAN CONCRETE INSTITUTE.

DRAWING INDEX

GENERAL
GI000 PROJECT LOCATION, DRAWING INDEX, SYMBOLS

ARCHITECTURE

A101 SITE PLAN
A102 ENLARGED SITE PLAN AND KIOSK PLAN

A102 ENLARGED SITE PLAN AND I A103 GENERAL DETAILS

D101 SIGN ENGINEER DETAILS
 D102 ACCESSIBLE SPECIFICATIONS AND MANUFACTURER DETAILS

PROJECT TEAM

OWNER CU ATM SERVICES, LLC / CU ANYTIME, LLC 3121 CARLISLE BLVD NE ALBUQUERQUE, NM 87110

ARCHITECT FORMATIVE ARCHITECTURE 209 GOLD AVENUE SW ALBUQUERQUE NM, 87102

(505) 510-4600

(505) 346-2058

PROJECT DATA

PROJECT NAME: PROJECT ADDRESS:

LEGAL DESCRIPTION:

ZONE DISTRICT:

DESIGNATION:

ATLAS PG:

UPC: PROJECT PROPERTY OWNER: OWNER ADDRESS:

TR P-1 CORRECTED PLAT OF ATRISCO BUSINESS PARK UNIT 3 A REPL OF TRS E & F ATRISCO BUSINESS PARK UNIT 1 & TRS O & P ATRISCO BUSINESS PARK UNIT 2 CONT 85,260 SQ FT OR 1.9573 AC M/L 1.9573

485 COORS BLVD NW

101005847812340608

1401 SAN PEDRO NE

ALBUQUERQUE, NM 87121

RIO GRANDE CREDIT UNION

ALBUQUERQUE NM, 87110

CU ANYTIME ATM @ RIO GRANDE CREDIT UNION

1.9573 NR-BP NON-RESIDENTIAL - BUSINESS PARK

APPLICABLE CODES

2015 INTERNATIONAL BUILDING CODE (IBC) 2012 UNIFORM PLUMBING CODE (UPC) 2012 UNIFORM MECHANICAL CODE (UMC)

2014 NATIONAL ELECTRICAL CODE (NEC)
2009 INTERNATIONAL ENERGY CONSERVATION CODE (IECC)
ICC/ANSI A117.1 - 2009, ACCESSIBLE AND USABLE BUILDINGS AND FACILITIES

IN ADDITION TO THE ABOVE REFERENCED CODES, CONSTRUCTION IS SUBJECT TO STATE AND LOCAL AMENDMENTS.

PROJECT OVERVIEW

PROVIDE A NEW DRIVE AISLE, (2) TWO NEW ATM KIOSKS AND ASSOCIATED WORK

SCOPE OF WORK

- INSTALL (2) NEW ATM KIOSKSEXTEND ELECTRICAL TO NEW KIOSKS
- EXTEND ELECTRICAL TO NEW KIOSKS
 PROVIDE NEW DRIVE ASISLES
- PROVIDE NEW DRIVE ASISLES
 PAINT NEW DIRECTIONAL PAVEMENT MARKINGS
 INSTALL NEW BOLLARDS

CU ANYTIME ATM@ 485 COORS BLVD NW



PROJECT ADDRESS

ADDRESS

ADDRESS

ADDRESS

ADDRESS

ADDRESS

ADDRESS

ADDRESS

505.510.4600 | formativearchitecture.com

SU ANY LIME ALM GRANDE CREDIT

CONSTRUCTION DOCUMENTS

REVISIONS

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DRAWN BY

REVIEWED BY

ROJECT NO #

DRAWING NAME

PROJECT LOCATION, DRAWING INDEX, SYMBOLS

SHEET NO

G1000

i/2020 1:09:06 PM

UNION BLVD NW NM 87121

ADDRESS

PAVEMENT SUPPORT FILL SHALL BE COMPACTED TO A DEPTH OF 8" AT 95% (MINIMUM) OF MAXIMUM DRY DENSITY. ALL BACKFILL FOR UTILITY LINE TRENCHES SHALL ALSO BE COMPACTED TO 95% (MINIMUM) OF MAXIMUM DRY DENSITY. FILL MATERIAL SHALL BE NON-EXPANSIVE SOIL EITHER GRAVEL, SAND, OR A COMBINATION THEREOF WITH A PLASTICITY INDEX (PI) OF 12 OR LESS.

LEGEND

NEW ASPHALT PAVING

GENERAL SHEET NOTES

CONFLICT WITH A MINIMUM AMOUNT OF DELAY.

TO THE LOCATION OF THESE LINES AND FACILITIES

SUBGRADE PREPARATION NOTES

CLEARING AND GRUBBING WILL BE REQUIRED FOR ALL AREAS SHOWN ON THE PLANS TO BE

EXCAVATION CONSISTS OF REMOVAL AND DISPOSAL OF ALL MATERIALS ENCOUNTERED TO

EXCAVATED OR ON WHICH FILL IS TO BE CONSTRUCTED. ALL VEGETATION, ORGANIC

MATERIAL, AND INCIDENTAL TOPSOIL SHALL BE REMOVED BENEATH A FILL AREA. ANY REMOVED TOPSOIL MAY BE STOCKPILED AND LATER USED IN THE TOP 6 INCHES OF FILLS

OBTAIN THE REQUIRED ELEVATIONS. EXCAVATIONS SHALL BE MADE TO THE PROPER

PERFORM THE COMPACTION OF SOIL MATERIALS USING SUITABLE SOIL COMPACTION EQUIPMENT FOR THE MATERIALS TO BE COMPACTED AND THE WORK AREA LOCATIONS. CONTROL SOIL COMPACTION DURING CONSTRUCTION FOR COMPLIANCE WITH

PERCENTAGE OF MAXIMUM DENSITY. THE EXPOSED CUT SURFACE, AS WELL AS SURFACES TO RECEIVE FILL, SHALL BE SCARIFIED TO A MINIMUM DEPTH OF 8" AND WATERED AS NECESSARY TO BRING THE SOIL TO WITHIN 2% +/- OF OPTIMUM MOISTURE CONTENT. THE UPPER 8" OF THE NATIVE SOILS SHALL THEN BE COMPACTED TO A MINIMUM OF 95% OF

SHALL BE REMOVED FROM THE SITE AND LEGALLY DISPOSED OFF-SITE.

MAXIMUM DRY DENSITY AS DETERMINED IN ACCORDANCE WITH ASTM D1557.

DEPTH, WITH ALLOWANCES MADE FOR CLEARANCES TO INSTALL SERVICES AND FORMS.

CUTS SHALL BE ACCURATELY SHAPED TO THE CROSS-SECTIONS AND GRADES INDICATED. EXCESS MATERIAL FROM EXCAVATIONS WHICH IS NOT REQUIRED FOR FILL OR BACKFILL

CONSTRUCTION SAFETY AND HEALTH.

CONSTRUCTION.

OUTSIDE PAVED AREAS.

A. PRIOR TO ANY CONSTRUCTION, THE CONTRACTOR SHALL EXCAVATE AND VERIFY LOCATION OF ALL POTENTIAL OBSTRUCTIONS. SHOULD A CONFLICT EXIST, THE CONTRACTOR SHALL NOTIFY THE ENGINEER AS SOON AS POSSIBLE TO RESOLVE THE

B. ALL WORK ON THIS PLAN SHALL BE PERFORMED IN ACCORDANCE WITH APPLICABLE FEDERAL, STATE AND LOCAL LAWS, RULES AND REGULATIONS CONCERNING

C. THE CONTRACTOR SHALL ENSURE THAT NO SOIL ERODES FROM THE SITE INTO THE PUBLIC RIGHT-OF-WAY OR ONTO PRIVATE PROPERTY. THIS CAN BE ACHIEVED BY CONSTRUCTING TEMPORARY BERMS AND BY WETTING THE SOIL TO KEEP IT FROM

D. THE CONTRACTOR SHALL OBTAIN ANY AND ALL PERMITS REQUIRED BY THE CITY OF ALBUQUERQUE FOR THE COMPLETION OF THE WORK PRIOR TO BEGINNING

E. IF ANY UTILITY LINES, PIPELINES, OR UNDERGROUND UTILITY LINES ARE SHOWN ON THESE DRAWINGS, THEY ARE SHOWN IN APPROXIMATE LOCATIONS ONLY, AND LINES MAY EXIST WHERE NONE ARE SHOWN. THE LOCATION IS BASED UPON INFORMATION PROVIDED BY THE UTILITY OWNER OR FROM EXISTING PLANS, AND THIS INFORMATION MAY BE INCOMPLETE OR OBSOLETE AT THE TIME OF CONSTRUCTION. THE DESIGN PROFFESIONAL HAS NOT UNDERTAKEN ANY FIELD VERIFICATION OF THESE

LOCATIONS, LINES SIZES OR MATERIAL TYPE, MAKES NO REPRESENTATION THERETO, AND ASSUMES NO RESPONSIBILITY OR LIABILITY THEREFOR. THE CONTRACTOR SHALL INFORM ITSELF OF THE LOCATION OF ANY UTILITY LINE, PIPELINE OR UNDERGROUND INSTALLATION IN OR NEAR THE AREA IN ADVANCE OF AND DURING ANY EXCAVATION WORK. THE CONTRACTOR IS FULLY RESPONSIBLE FOR ANY AND ALL DAMAGES CAUSED BY ITS FAILURE TO LOCATE, IDENTIFY AND PRESERVE ANY AND ALL EXISTING UTILITIES, PIPELINES AND UNDERGROUND FACILITIES. IN PLANNING AND CONDUCTING EXCAVATIONS, THE CONTRACTOR SHALL COMPLY WITH ALL STATE STATUTES, MUNICIPAL AND LOCAL ORDINANCES, RULES AND REGULATIONS, IF ANY, PERTAINING

GRAVEL INFILL W/ GEOTEXTILE FABRIC BELOW

KEY PLAN

PROPERTY LINE

SITE PLAN

0' 16' 32' 48'

Scale: 3/64" = 1' - 0"

LOS VOLCANOS ROAD

20' BUSINESS PARK LANDSCAPE AND BUILDING SETBACK

S 89° 55' 22" E 150.74'

30' BUSINESS PARK BUILDING SETBACK

EXISTING DRIVE-IN BANK

CONSTRUCTION DOCUMENTS

REVISIONS

REVISIONS

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DRAWN BY

REVIEWED BY

OK

DATE

03/26/2020

DRAWING NAME

PROJECT NO

SITE PLAN

#20-0003

SHEET NO

A101

0 12:45:09 PM

EXISTING TELEPHONE

S 81° 55' 22" E 74.02'

∖ A102 /

10' SIDE YARD ATRISCO BUSINESS PARK BUILDING SETBACK

NOTE: ASPHALT ABUTTING THE EXISTING PARKING LOT TO BE AT SAME

ELEVATION. SLOPE ALL NEW PAVING AT 2% SLOPE TO THE WEST. INSPECTOR

PROPERTY LINE

PROVIDE UNDERGROUD
SECONDARY SERVICE TO
ATM KIOSK AND LIGHT

24' PRIVATE INGRESS, EGRESS, DRAINAGE & PUBLIC

UTILITY EASEMENT

UPC: 101005847812340608 1.9573 AC 85,260 SQ.FT.

PROPERTY LINE

POLE

EXISTING TRAFFIC

EXISTING ELECTRIC

EXISTING LIGHT POLE—

PROPERTY LINE

EXISTING POWER POLE W/ CONDUIT AND UTILITY

TRANSFORMER 120/240V

POLE MOUNT

1PH, 3W. VERIFY

LOCATION IN FIELD

EXISTING LIGHT POLE—

2" CONDUIT SCH. 40 PVC

UNDERGROUND WITH SERVICE RISER ON— UTILITY POLE - (3) RUNS

#1 ALUMINUM

CONTROL BOX

ADDRESS

NW

DRAWN BY **REVIEWED BY** DATE 03/26/2020 PROJECT NO #20-0003

DRAWING NAME

ENLARGED SITE PLAN AND KIOSK **PLAN**

SHEET NO

A102

GENERAL SHEET NOTES

A. PRIOR TO ANY CONSTRUCTION. THE CONTRACTOR SHALL EXCAVATE AND VERIFY LOCATION OF ALL POTENTIAL OBSTRUCTIONS. SHOULD A CONFLICT EXIST, THE CONTRACTOR SHALL NOTIFY THE ENGINEER AS SOON AS POSSIBLE TO RESOLVE THE CONFLICT WITH A MINIMUM AMOUNT OF DELAY.

FEDERAL, STATE AND LOCAL LAWS, RULES AND REGULATIONS CONCERNING CONSTRUCTION SAFETY AND HEALTH.

B. ALL WORK ON THIS PLAN SHALL BE PERFORMED IN ACCORDANCE WITH APPLICABLE C. THE CONTRACTOR SHALL ENSURE THAT NO SOIL ERODES FROM THE SITE INTO THE PUBLIC RIGHT-OF-WAY OR ONTO PRIVATE PROPERTY. THIS CAN BE ACHIEVED BY

CONSTRUCTING TEMPORARY BERMS AND BY WETTING THE SOIL TO KEEP IT FROM BLOWING D. THE CONTRACTOR SHALL OBTAIN ANY AND ALL PERMITS REQUIRED BY THE CITY OF ALBUQUERQUE FOR THE COMPLETION OF THE WORK PRIOR TO BEGINNING

CONSTRUCTION. E. IF ANY UTILITY LINES, PIPELINES, OR UNDERGROUND UTILITY LINES ARE SHOWN ON THESE DRAWINGS. THEY ARE SHOWN IN APPROXIMATE LOCATIONS ONLY, AND LINES MAY EXIST WHERE NONE ARE SHOWN. THE LOCATION IS BASED UPON INFORMATION PROVIDED BY THE UTILITY OWNER OR FROM EXISTING PLANS, AND THIS INFORMATION MAY BE INCOMPLETE OR OBSOLETE AT THE TIME OF CONSTRUCTION. THE DESIGN PROFFESIONAL HAS NOT UNDERTAKEN ANY FIELD VERIFICATION OF THESE LOCATIONS, LINES SIZES OR MATERIAL TYPE, MAKES NO REPRESENTATION THERETO, AND ASSUMES NO RESPONSIBILITY OR LIABILITY THEREFOR. THE CONTRACTOR SHALL INFORM ITSELF OF THE LOCATION OF ANY UTILITY LINE, PIPELINE OR UNDERGROUND INSTALLATION IN OR NEAR THE AREA IN ADVANCE OF AND DURING ANY EXCAVATION WORK. THE CONTRACTOR IS FULLY RESPONSIBLE FOR ANY AND ALL DAMAGES CAUSED BY ITS FAILURE TO LOCATE, IDENTIFY AND PRESERVE ANY AND ALL EXISTING UTILITIES, PIPELINES AND UNDERGROUND FACILITIES. IN PLANNING AND CONDUCTING EXCAVATIONS, THE CONTRACTOR SHALL COMPLY WITH ALL STATE STATUTES, MUNICIPAL AND LOCAL ORDINANCES, RULES AND REGULATIONS, IF ANY, PERTAINING TO THE LOCATION OF THESE LINES AND FACILITIES

SUBGRADE PREPARATION NOTES

CLEARING AND GRUBBING WILL BE REQUIRED FOR ALL AREAS SHOWN ON THE PLANS TO BE EXCAVATED OR ON WHICH FILL IS TO BE CONSTRUCTED. ALL VEGETATION, ORGANIC MATERIAL, AND INCIDENTAL TOPSOIL SHALL BE REMOVED BENEATH A FILL AREA. ANY REMOVED TOPSOIL MAY BE STOCKPILED AND LATER USED IN THE TOP 6 INCHES OF FILLS OUTSIDE PAVED AREAS.

EXCAVATION CONSISTS OF REMOVAL AND DISPOSAL OF ALL MATERIALS ENCOUNTERED TO OBTAIN THE REQUIRED ELEVATIONS. EXCAVATIONS SHALL BE MADE TO THE PROPER DEPTH, WITH ALLOWANCES MADE FOR CLEARANCES TO INSTALL SERVICES AND FORMS. CUTS SHALL BE ACCURATELY SHAPED TO THE CROSS-SECTIONS AND GRADES INDICATED. EXCESS MATERIAL FROM EXCAVATIONS WHICH IS NOT REQUIRED FOR FILL OR BACKFILL SHALL BE REMOVED FROM THE SITE AND LEGALLY DISPOSED OFF-SITE.

PERFORM THE COMPACTION OF SOIL MATERIALS USING SUITABLE SOIL COMPACTION EQUIPMENT FOR THE MATERIALS TO BE COMPACTED AND THE WORK AREA LOCATIONS. CONTROL SOIL COMPACTION DURING CONSTRUCTION FOR COMPLIANCE WITH PERCENTAGE OF MAXIMUM DENSITY. THE EXPOSED CUT SURFACE, AS WELL AS SURFACES TO RECEIVE FILL, SHALL BE SCARIFIED TO A MINIMUM DEPTH OF 8" AND WATERED AS NECESSARY TO BRING THE SOIL TO WITHIN 2% +/- OF OPTIMUM MOISTURE CONTENT. THE UPPER 8" OF THE NATIVE SOILS SHALL THEN BE COMPACTED TO A MINIMUM OF 95% OF MAXIMUM DRY DENSITY AS DETERMINED IN ACCORDANCE WITH ASTM D1557.

PAVEMENT SUPPORT FILL SHALL BE COMPACTED TO A DEPTH OF 8" AT 95% (MINIMUM) OF MAXIMUM DRY DENSITY. ALL BACKFILL FOR UTILITY LINE TRENCHES SHALL ALSO BE COMPACTED TO 95% (MINIMUM) OF MAXIMUM DRY DENSITY. FILL MATERIAL SHALL BE NON-EXPANSIVE SOIL EITHER GRAVEL, SAND, OR A COMBINATION THEREOF WITH A PLASTICITY INDEX (PI) OF 12 OR LESS.

LEGEND

GRAVEL INFILL W/ GEOTEXTILE FABRIC BELOW

NEW ASPHALT PAVING

KEY PLAN

FACE OF ATM FOR ADDITIONAL ATM - AUTOMATED INFORMATION TELLER MACHINE; REFER 0 0 TO D103 FOR ADDITIONAL INFORMATION 4" DIA STEEL PIPE BOLLARD; REFER A103/B5 4"X4"X3/8" STEEL ANGLE ANCHORS PER BOLTED TO CONCRETE 6 1/2" 6 1/2" PAD W/ 5/8" 5" ANTI-THEFT-201' - 4" ANCHOR BOLTS BY OWNER INFORMATION PROVIDE UNDERGROUD 4" DIA STEEL PIPE SECONDARY SERVICE TO ATM KIOSK AND LIGHT 4" DIA STEEL PIPE ADDITIONAL BOLLARD; REFER A103/B4 INFORMATION 4" DIA STEEL PIPE CONCRETE CURB AND GUTTER; REFER TO-A103/C5 PEDESTAL MODEL GRAVEL INFILL W/ CP3B51115A22 BY GEOTEXTILE FABRIC MILBANK; BASIS OF BELOW. VALLEY GOLD 1" -DESIGN. DESIGN BY BUILDOLOGY; BASIS OF DESIGN SPECIFICATIONS. FRONT FACE OF

7' - 0"

4"X4"X3/8" STEEL ANGLE

BOLTED TO CONCRETE

ANCHOR BOLTS BY

OWNER

PAD W/ 5/8" 5" ANTI-THEFT-

CANOPY FRAME; REFER

TO D101 AND D102 FOR

HSS 4"X6"X1/4" SUPPORT

TELLER MACHINE; REFER TO D103 FOR ADDITIONAL

BOLLARD; REFER A103/B5

8"X16"X1/2" BASE PLATE

W/ EXPANSION ANCHORS.

(6) SIX 1/2" X 5 1/2" WEDGE

BASEPLATE W/ TAMPER

D101 FOR ADDTIONAL

12" SOLID CONCRETE

PAD; REFER TO D101 FOR

#4 REBAR MAT; REFER TO

—D101 FOR ADDITIONAL

8" DIA SONOTUBE OR

-COORDINATE LOCATION

INFORMATION

EQUIVALANT.

W/ ATM POWER

RECEPTACLE

PROOF HEADS; REFER TO

POST; REFER TO D101

FOR ADDITIONAL

ATM - AUTOMATED

INFORMATION

INFORMATION

4" DIA STEEL PIPE

ANCHORS PER

INFORMATION

ADDITIONAL

INFORMATION

ADDITIONAL

INFORMATION

8"X16"X1/2" BASE PLATE (6) SIX 1/2" X 5 1/2" WEDGE ANCHORS PER 3' - 0" FACE OF CONCRETE PAD—— 1' - 0" 6" BASEPLATE W/ TAMPER PROOF HEADS; REFER TO D101 FOR ADDTIONAL 4"X4"X3/8" STEEL ANGLE INFORMATION BOLTED TO CONCRETE 4" DIA STEEL PIPE PAD W/ 5/8" 5" ANTI-THEFT BOLLARD; REFER A103/B5 ANCHOR BOLTS BY OWNER HSS 4"X6"X1/4" SUPPORT POST; REFER TO D101 FOR ADDITIONAL 4" DIA STEEL PIPE INFORMATION BOLLARD; REFER A103/B5 4" DIA STEEL PIPE 4"X4"X3/8" STEEL ANGLE BOLLARD; REFER A103/B5 BOLTED TO CONCRETE -PAD W/ 5/8" 5" ANTI-THEFT 8" DIA SONOTUBE OR ANCHOR BOLTS BY EQUIVALANT. OWNER COORDINATE LOCATION-W/ ATM POWER RECEPTACLE 2' - 6" HSS 4"X6"X1/4" SUPPORT POST; REFER TO D101 STUB UP FOR POWER TO CANOPY AS REQUIRED 8"X16"X1/2" BASE PLATE W/ EXPANSION ANCHORS (6) SIX 1/2" X 5 1/2" WEDGE BASEPLATE W/ TAMPER PROOF HEADS; REFER TO D101 FOR ADDTIONAL BOLLARD; REFER A103/B5 12" SOLID CONCRETE PAD; REFER TO D101 FOR BOLLARD; REFER A103/B4 ELECTRICAL SERVICE

ENLARGED KIOSK PLAN

INCLUDING MOUNTING BASE, FOUNDATION AND ANCHOR BOLTS PER PNM

3' - 11"

CANOPY FRAME; REFER

TO D101 AND D102 FOR

HSS 4"X6"X1/4" SUPPORT

POST; REFER TO D101

FOR ADDITIONAL

ATM - AUTOMATED

TELLER MACHINE; REFER

TO D103 FOR ADDITIONAL

BOLLARD; REFER A103/B5

PAD; REFER TO D101 FOR

12" SOLID CONCRETE

CONCRETE CURB AND

TO A103/D5

#4 REBAR MAT; REFER TO

-D101 FOR ADDITIONAL

8" DIA SONOTUBE OR

ASPHALT PAVING; REFER

CONCRETE CURB AND GUTTER; REFER TO-

PROVIDE BROKEN CURB

NEW DOUBLE HEADED

LIGHT POLE - 20FT

CLS-SSS20B4 BY

BASIS OF DESIGN.

PRO MODEL#

LIGHT POLE, SEE A103/A5

FOR FOUNDATION DETAIL.

SQUARE STRAIGHT STEEL

- 4 BOLT BASE MODEL#

AFFORDABLE LIGHTING;

LIGHTING HEAD - LIGHTER

SLP16145LED BY ATLAS

LIGHTING PRODUCTS;

NEW CAPOPY AND ATM;

2" CONDUIT SCH. 40 PVC

UNDERGROUND WITH

UTILITY POLE - (3) RUNS

PROVIDE BROKEN CURB

OUTLET FOR WATER-

CONCRETE CURB AND

GUTTER; REFER TO-

REFER TO A102 FOR

BASIS OF DESIGN

ADDITIONAL

INFORMATION

SERVICE RISER ON 5

DRAINAGE

A103/C5

ASPHALT PAVING; REFER

CONCRETE CURB AND

GUTTER; REFER TO-

TO A103/D5

A103/C5

#1 ALUMINUM

OUTLET FOR WATER-

TO A103/D5

A103/C5

-COORDINATE LOCATION

INFORMATION

EQUIVALANT.

W/ ATM POWER

RECEPTACLE

ASPHALT PAVING; REFER

-GUTTER; REFER TO

INFORMATION

INFORMATION

4" DIA STEEL PIPE

ADDITIONAL

A103/C5

INFORMATION

ADDITIONAL

INFORMATION

2' - 11"

PEDESTAL

NOTE: ASPHALT ABUTTING THE EXISTING PARKING LOT TO BE AT SAME

TO VERIFY

'ATM DRIVE THRU' SIGN;

CONCRETE CURB AND

GUTTER; REFER TO-

A103/C5

12' - 0"

A2 `

∖ A102 🗸

16' - 6"

2' - 0"—

2% SLOPE

TYP @ ALL

NEW PAVING

REFER TO A103/A3

2% SLOPE

TYP @ ALL

NEW PAVING

2% SLOPE

TYP @ ALL

NEW PAVING

-

ELEVATION. SLOPE ALL NEW PAVING AT 2% SLOPE TO THE WEST. INSPECTOR

EXISTING CONCRETE

-CURB AND GUTTER TO

NEW CONCRETE CURB

EXISTING CURB AND

AND GUTTER TO TIE INTO

RFMAIN

GUTTER

REMOVE EXISTING

INSTALLED

ABUTTING EXISTING

PARKING LOT

NEW DIRECTIONAL

—PAVEMENT MARKING TYP; REFER TO A103/A2

'ATM DRIVE THRU' SIGN; REFER TO A103/A3

CONCRETE CURB AND

—GUTTER; REFER TO

GRAVEL INFILL W/

OF DESIGN

TO A103/D5

GEOTEXTILE FABRIC

—BELOW. VALLEY GOLD 1"

BY BUILDOLOGY; BASIS

ASPHALT PAVING; REFER

PROVIDE UNDERGROUD

NEW CAPOPY AND ATM;

'ONE WAY DO NOT ENTER'

SIGN; REFER TO A103/A3

REFER TO A102 FOR

ADDITIONAL

INFORMATION

LINE OF ASPHALT PAVING

-PAVEMENT MARKING TYP;

-ENTIRETY TO ALLOW FOR

NEW DRIVE AISLES TO BE

'ONE WAY DO NOT ENTER'

SIGN; REFER TO A103/A3

NEW CONCRETE CURB TO

TIE INTO EXISTING -CONCRETE CULVERT. VERIFY LOCATION IN

-ABUTTING EXISTING

NEW DIRECTIONAL

REFER TO A103/A2

REMOVE EXISTING ASPHALT CURB IN ITS

PARKING LOT

SECONDARY SERVICE TO ATM KIOSK AND LIGHT

A103/C5

ASPHALT CURB IN ITS

-ENTIRETY TO ALLOW FOR


NEW DRIVE AISLES TO BE


LINE OF ASPHALT PAVING

16' - 8"

∖∵% 15' - 0"

ENLARGED SITE PLAN

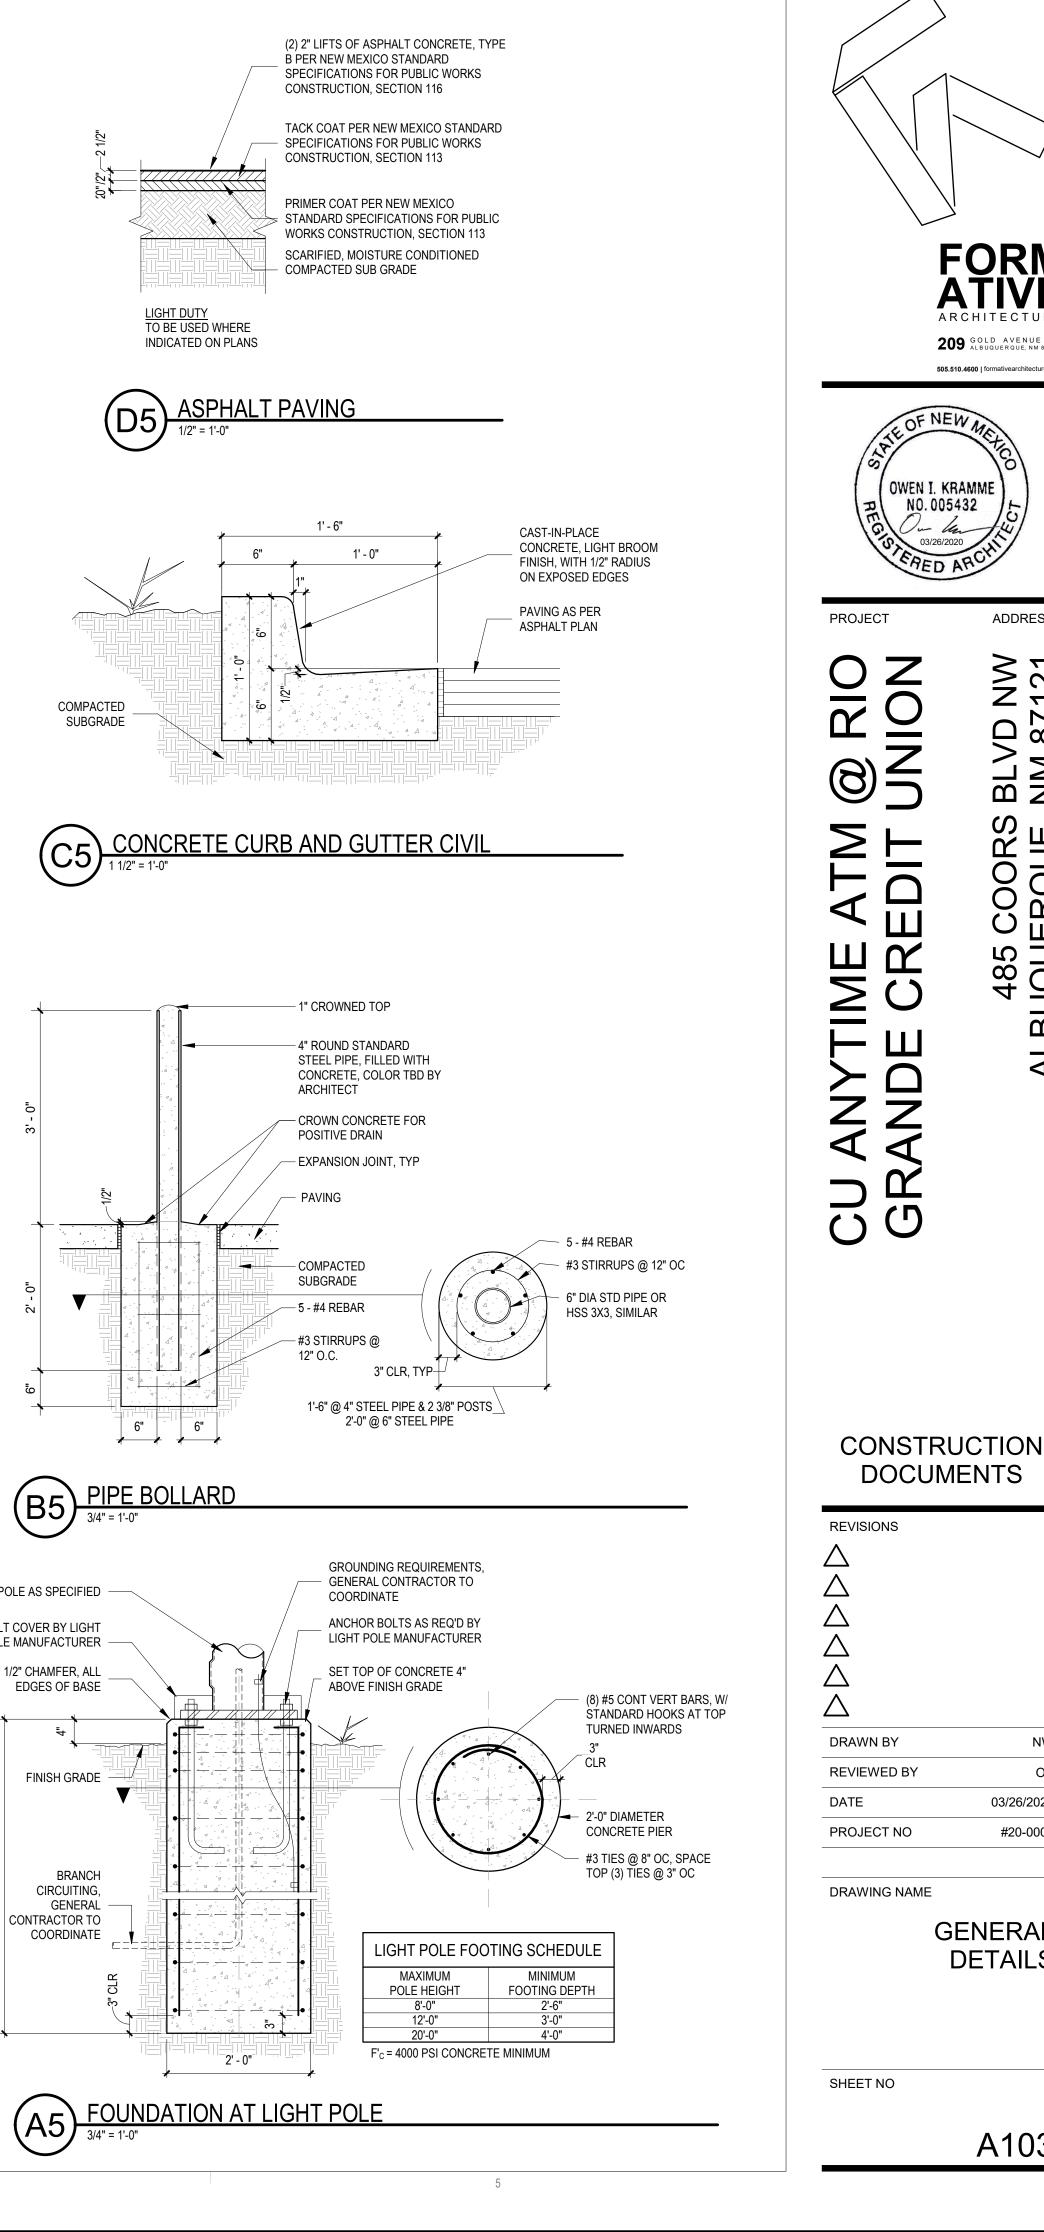

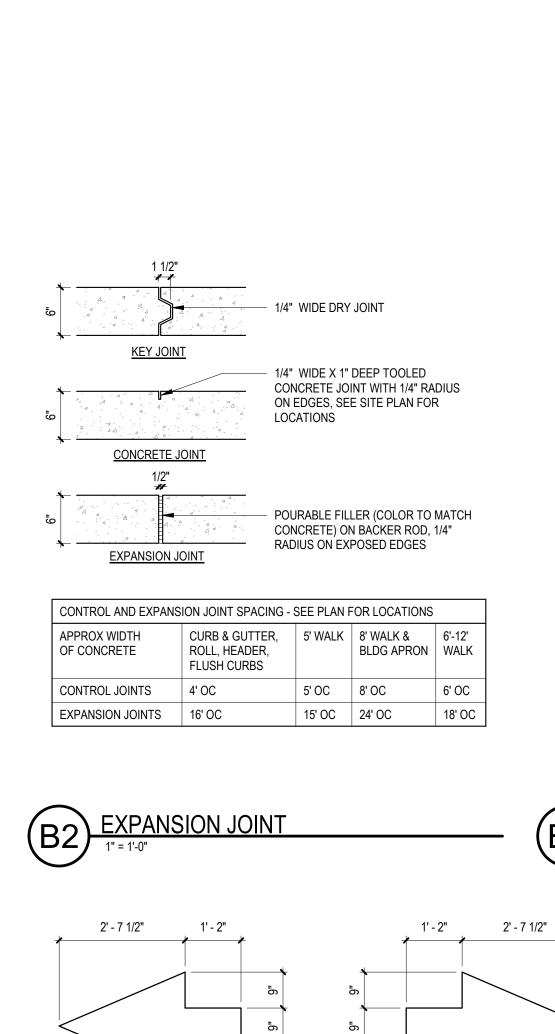


1' - 1 1/2" 9"

TYPICAL PAINTED DIRECTIONAL GRAPHICS

2. PAINT ARROWS WHERE SHOWN ON PLAN, COLOR: WHITE

9" [1' - 1 1/2" [

DIRECTIONAL PAVEMENT MARKINGS

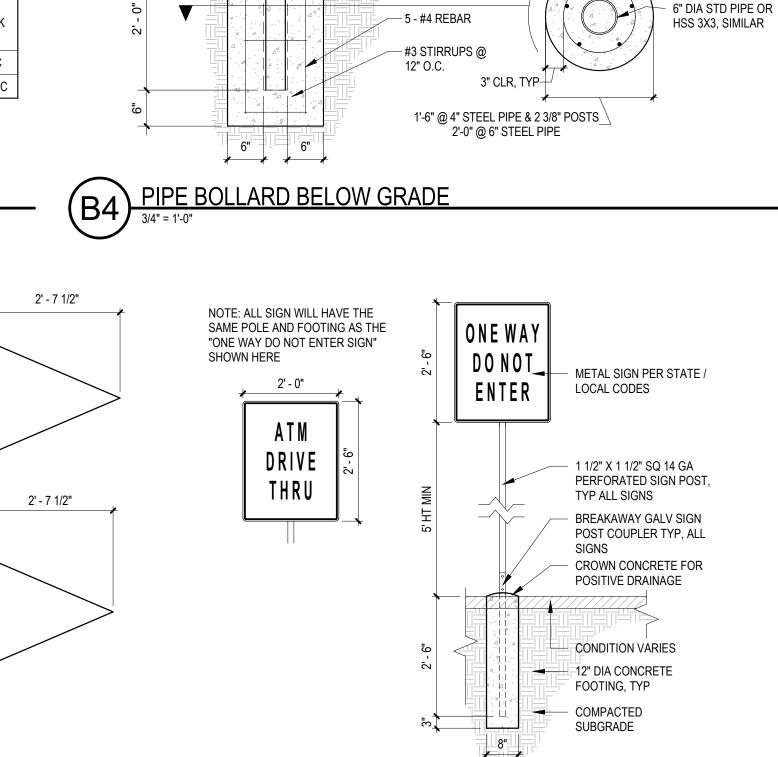

- 1" CROWNED TOP

ARCHITECT

POSITIVE DRAIN

- COMPACTED SUBGRADE

— COMPACTED

SUBGRADE

- PAVING

- 4" ROUND STANDARD


STEEL PIPE, FILLED WITH

CROWN CONCRETE FOR

5 - #4 REBAR

#3 STIRRUPS @ 12" OC

CONCRETE, COLOR TBD BY

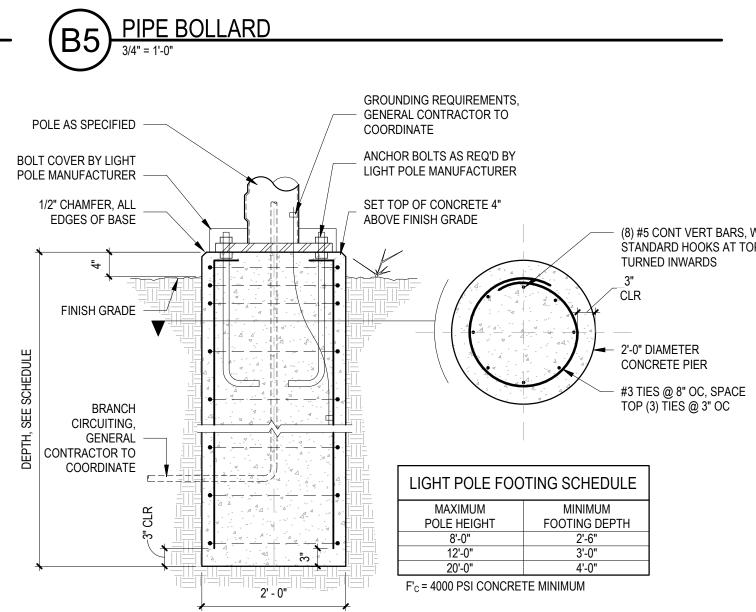

COMPACTED

SUBGRADE

485 COORS E ALBUQUERQUE, N 4

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ADDRESS

BLVD I NM 87

NW

OK

03/26/2020

#20-0003

A103

GENERAL

DETAILS

M & J SIGNS

CU Anytime ATM - GEN 7X

SIGN LOCATION:

SIGN DESCRIPTION:

5900 2nd St. NW Albuquerque, NM 87104 (505) 344-2475

Double Pole-Expansion Anchor-Rectangular Footing

THAMES

ENGINEERING AND DESIGN

LICENSE NO. 10815

5165 GOLDMAR DR. • IRONDALE, AL 35210 • 505-944-6216

FORM ATIVE
ARCHITECTURE
209 GOLD AVENUE SW ALBUQUERQUE, NM 87102
505.510.4600 | formativearchitecture.com

OWEN I. KRAMME
NO. 005432
O3/26/2020
OMEN I. KRAMME
NO. 005432
O3/26/2020
O3/26/2020

ADDRESS

BLVD NW NM 87121

485 COORS ALBUQUERQUE,

PROJECT

IME AIM (Ø) CREDIT UN

CONSTRUCTION DOCUMENTS

DRAWN BY

REVIEWED BY

REVISIONS

DRAWN BY NW
REVIEWED BY OK
DATE 03/26/2020
PROJECT NO #20-0003

DRAWING NAME

SIGN ENGINEER DETAILS

SHEET NO

THAMES Engineering and Design License No. 10815

5165 GOLDMAR DR. - IRONDALE, AL 35210 - 505-944-6216

D101

220 Automatic Teller Machines and Fare Machines

220.1 General. Where automatic teller machines or self-service fare vending, collection, or adjustment machines are provided, at least one of each type provided at each location shall comply with 707. Where bins are provided for envelopes, waste paper, or other purposes, at least one of each type shall comply with 811.

Advisory 220.1 General. If a bank provides both interior and exterior ATMs, each such installation is considered a separate location. Accessible ATMs, including those with speech and those that are within reach of people who use wheelchairs, must provide all the functions provided to customers at that location at all times. For example, it is unacceptable for the accessible ATM only to provide cash withdrawals while inaccessible ATMs also sell theater tickets.

707 Automatic Teller Machines and Fare Machines

Advisory 707 Automatic Teller Machines and Fare Machines. Interactive transaction machines (ITMs), other than ATMs, are not covered by Section 707. However, for entities covered by the ADA, the Department of Justice regulations that implement the ADA provide additional guidance regarding the relationship between these requirements and elements that are not directly addressed by these requirements. Federal procurement law requires that ITMs purchased by the Federal government comply with standards issued by the Access Board under Section 508 of the Rehabilitation Act of 1973, as amended. This law covers a variety of products, including computer hardware and software, websites, phone systems, fax machines, copiers, and similar technologies. For more information on Section 508 consult the Access Board's website at www.access-board.gov.

707.1 General. Automatic teller machines and fare machines shall comply with 707.

Advisory 707.1 General. If farecards have one tactually distinctive corner they can be inserted with greater accuracy. Token collection devices that are designed to accommodate tokens which are perforated can allow a person to distinguish more readily between tokens and common coins. Place accessible gates and fare vending machines in close proximity to other accessible elements when feasible so the facility is easier to use.

707.2 Clear Floor or Ground Space. A clear floor or ground *space* complying with 305 shall be

EXCEPTION: Clear floor or ground *space* shall not be required at drive-up only automatic teller machines and fare machines.

707.3 Operable Parts. Operable parts shall comply with 309. Unless a clear or correct key is provided, each operable part shall be able to be differentiated by sound or touch, without activation. **EXCEPTION:** Drive-up only automatic teller machines and fare machines shall not be required to

comply with 309.2 and 309.3. 707.4 Privacy. Automatic teller machines shall provide the opportunity for the same degree of privacy of

Advisory 707.4 Privacy. In addition to people who are blind or visually impaired, people with limited reach who use wheelchairs or have short stature, who cannot effectively block the ATM screen with their bodies, may prefer to use speech output. Speech output users can benefit from an option to render the visible screen blank, thereby affording them greater personal security and privacy.

input and output available to all individuals.

707.5 Speech Output. Machines shall be speech enabled. Operating instructions and orientation, visible transaction prompts, user input verification, error messages, and all displayed information for full use shall be accessible to and independently usable by individuals with vision impairments. Speech shall be delivered through a mechanism that is readily available to all users, including but not limited to, an industry standard connector or a telephone handset. Speech shall be recorded or digitized human, or

EXCEPTIONS: 1. Audible tones shall be permitted instead of speech for visible output that is not displayed for security purposes, including but not limited to, asterisks representing personal

2. Advertisements and other similar information shall not be required to be audible unless they convey information that can be used in the transaction being conducted. 3. Where speech synthesis cannot be supported, dynamic alphabetic output shall not be required to

Advisory 707.5 Speech Output. If an ATM provides additional functions such as dispensing coupons, selling theater tickets, or providing copies of monthly statements, all such functions must be available to customers using speech output. To avoid confusion at the ATM, the method of initiating the speech mode should be easily discoverable and should not require specialized training. For example, if a telephone handset is provided, lifting the handset can initiate the speech mode.

707.5.1 User Control. Speech shall be capable of being repeated or interrupted. Volume control shall be provided for the speech function.

EXCEPTION: Speech output for any single function shall be permitted to be automatically interrupted when a transaction is selected.

707.5.2 Receipts. Where receipts are provided, speech output devices shall provide audible balance inquiry information, error messages, and all other information on the printed receipt necessary to complete or verify the transaction.

EXCEPTIONS: 1. Machine location, date and time of transaction, customer account number, and the machine identifier shall not be required to be audible.

2. Information on printed receipts that duplicates information available on-screen shall not be required to be presented in the form of an audible receipt.

3. Printed copies of bank statements and checks shall not be required to be audible. 707.6 Input. Input devices shall comply with 707.6.

707.6.1 Input Controls. At least one tactilely discernible input control shall be provided for each function. Where provided, key surfaces not on active areas of display screens, shall be raised above surrounding surfaces. Where membrane keys are the only method of input, each shall be tactilely discernable from surrounding surfaces and adjacent keys.

707.6.2 Numeric Keys. Numeric keys shall be arranged in a 12-key ascending or descending telephone keypad layout. The number five key shall be tactilely distinct from the other keys.

Advisory 707.6.2 Numeric Keys. Telephone keypads and computer keyboards differ in one significant feature, ascending versus descending numerical order. Both types of keypads are acceptable, provided the computer-style keypad is organized similarly to the number pad located at the right on most computer keyboards, and does not resemble the line of numbers located above the computer keys.

123	789
456	456
789	123
*0#	*0#
(a)	(b)
12-key	12-key
ascending	descending

Figure 707.6.2 Numeric Key Layout

707.6.3 Function Keys. Function keys shall comply with 707.6.3.

707.6.3.1 Contrast. Function keys shall contrast visually from background surfaces. Characters and symbols on key surfaces shall contrast visually from key surfaces. Visual contrast shall be either light-on-dark or dark-on-light. EXCEPTION: Tactile symbols required by 707.6.3.2 shall not be required to comply with

707.6.3.2 Tactile Symbols. Function key surfaces shall have tactile symbols as follows: Enter or Proceed key: raised circle; Clear or Correct key: raised left arrow; Cancel key: raised letter ex;

Add Value key: raised plus sign; Decrease Value key: raised minus sign.

707.7 Display Screen. The display screen shall comply with 707.7.

EXCEPTION: Drive-up only automatic teller machines and fare machines shall not be required to

707.7.1 Visibility. The display screen shall be visible from a point located 40 inches (1015 mm) above the center of the clear floor space in front of the machine.

707.7.2 Characters. Characters displayed on the screen shall be in a sans serif font. Characters shall be 3/16 inch (4.8 mm) high minimum based on the uppercase letter "I". Characters shall contrast with their background with either light characters on a dark background or dark characters

707.8 Braille Instructions. Braille instructions for initiating the speech mode shall be provided. Braille shall comply with 703.3.

708 Two-Way Communication Systems

on a light background.

708.1 General. Two-way communication systems shall comply with 708.

Advisory 708.1 General. Devices that do not require handsets are easier to use by people who have a limited reach.

708.2 Audible and Visual Indicators. The system shall provide both audible and visual signals.

Advisory 708.2 Audible and Visual Indicators. A light can be used to indicate visually that assistance is on the way. Signs indicating the meaning of visual signals should be

708.3 Handsets. Handset cords, if provided, shall be 29 inches (735 mm) long minimum.


708.4 Residential Dwelling Unit Communication Systems. Communications systems between a residential dwelling unit and a site, building, or floor entrance shall comply with 708.4.

708.4.1 Common Use or Public Use System Interface. The common use or public use system interface shall include the capability of supporting voice and TTY communication with the residential dwelling unit interface.


708.4.2 Residential Dwelling Unit Interface. The residential dwelling unit system interface shall include a telephone jack capable of supporting voice and TTY communication with the common use or public use system interface.

> FOR ADDITIONAL BRAILLE INFORMATION REFER TO D102/A1

POWER RISER DIAGRAM

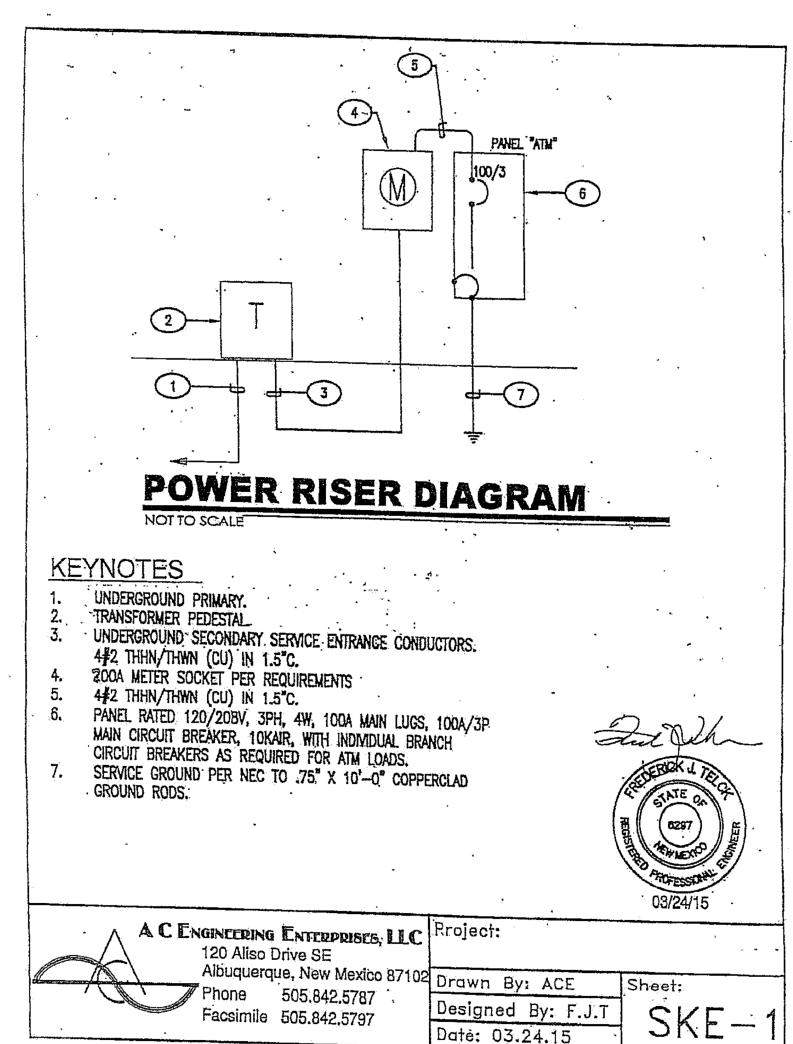

ENCLOSURE SPECIFICATIONS

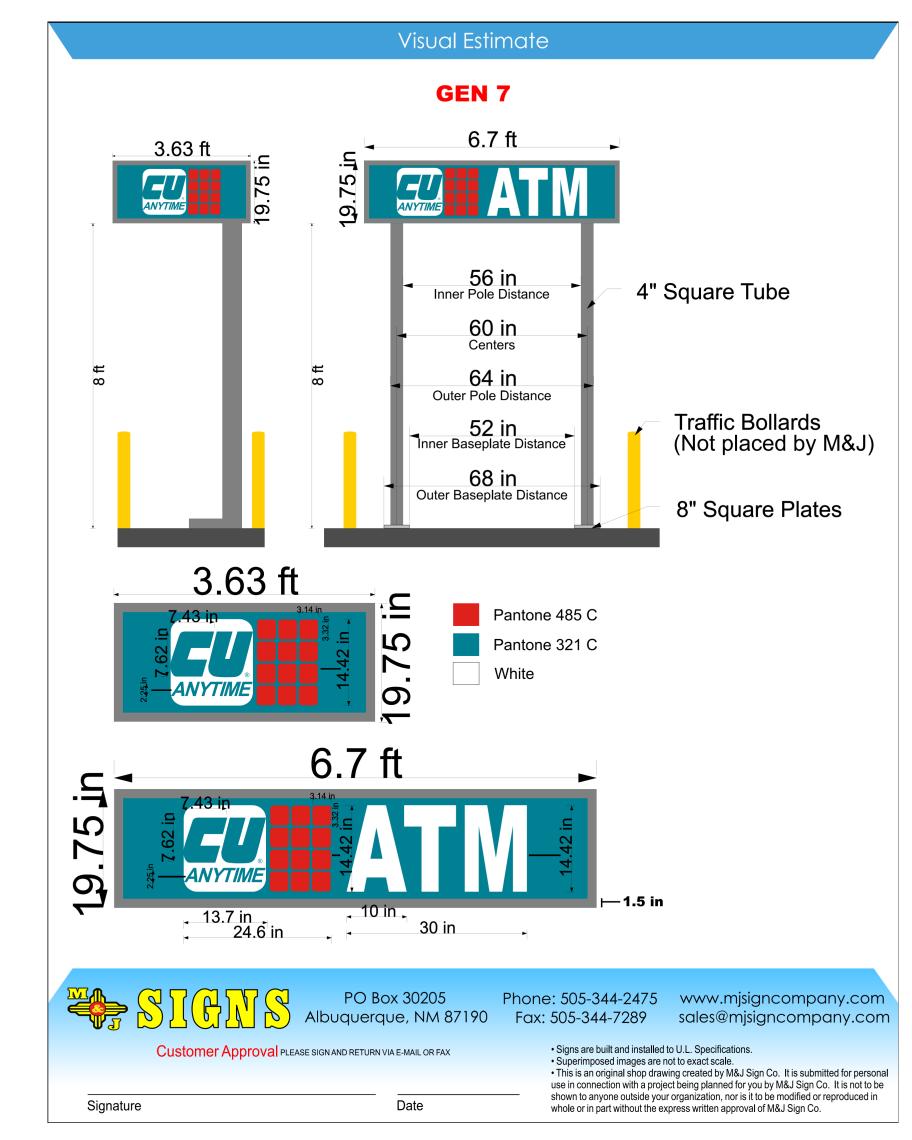

INSERT CARD •••• REMOVE CASH DEPOSIT CHECKS **BRAILLE DIMENSIONS** DOT BASE DIAMETER .059 - .063 DISTANCE BETWEEN TWO DOTS IN SAME CELL DISTANCE BETWEEN .300 CORRESPONDING DOTS IN ADJACENT CELLS

REMOVE STATEMENT

DOT HEIGHT .025 - .037 DISTANCE BETWEEN .395 - .400 CORRESPONDING DOTS FROM ONE CELL DIRECTLY BELOW

(2010 ADA STANDARDS FOR ACCESIBLE DESIGN 703.3.1 BRAILLE DIMENSIONS)

BRAILLE - FOR REFERECE ONLY DECALS PROVIDED BY ATM MANUFACTURER

D102

л 87 BLV NM 485 ALBUQUE

CONSTRUCTION **DOCUMENTS**

REVISIONS

DRAWN BY NW OK REVIEWED BY DATE 03/26/2020 PROJECT NO #20-0003

DRAWING NAME

ACCESSIBLE SPECIFICATIONS MANUFACTURER DETAILS

SHEET NO