
APPLICATION

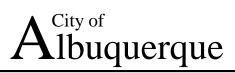



DEVELOPMENT REVIEW APPLICATION

Effective 4/17/19

Please check the appropriate box and refer to supplemental forms for submittal requirements. All fees must be paid at the time of application.									
Administrative Decisions	D	ecisio	ons Requiring a Pul	blic Meeting or Hearing	Policy Decisions				
☐ Archaeological Certificate (Form P3		☐ Site Plan – EPC including any Variances – EPC (Form P1)				☐ Adoption or Amendment of Comprehensive Plan or Facility Plan (Form Z)			
☐ Historic Certificate of Appropriatene (Form L)	ess – Minor	∃ Mas	ter Development Pla	n (Form P1)		☐ Adoption or Amendment of Historic Designation (Form L)			
☐ Alternative Signage Plan (Form P3,		☐ Histo		oropriateness – Major	□ Ame	☐ Amendment of IDO Text (Form Z)			
Minor Amendment to Site Plan (For	rm P3)	Dem	nolition Outside of HF	PO (Form L)	□ Ann	☐ Annexation of Land (Form Z)			
☐ WTF Approval (Form W1)		Histo	oric Design Standard	ls and Guidelines (Form L)	☐ Amendment to Zoning Map – EPC (Form Z)				
		□ Wire Form		ations Facility Waiver	☐ Amendment to Zoning Map – Council (Form Z)				
					Appea	ls			
					□ Dec <i>A)</i>	ision by EPC, LC, ZHE	, or City Staff (Form		
APPLICATION INFORMATION	_								
Applicant: John Binnert, Cottonwo	od Classical Pr	epara	tory School		Pho	one: 505.998.1021			
Address: 7801 Jefferson Street NE					Em	ail: john.binnert@cotto	onwoodclassical.org		
City: Albuquerque				State: NM	Zip	87109			
Professional/Agent (if any): Sanjay K	adu, Dekker Pe	rich S	abatini		Pho	one: 505.761.9700			
Address: 7601 Jefferson NE, Suite 1	00				Em	ail: SanjayK@dpsdes	ign.org		
City: Albuquerque				State: NM	Zip: 87109				
Proprietary Interest in Site:			List <u>all</u> owners:						
BRIEF DESCRIPTION OF REQUEST									
Expansion of the campus' northeastern parking lot by 15 spaces.									
SITE INFORMATION (Accuracy of the existing legal description is crucial! Attach a separate sheet if necessary.)									
Lot or Tract No.: TR 5-B-1-A-2-A PLAT OF TRACTS 5-B-1-A-1-A, 5-B-1-A-2-A &5-B-1-B-1 JOURNAL CENTER CONT 6.2374 AC			Block:	Uni	t:				
Subdivision/Addition:			MRGCD Map No.:	UPC Code: 101706338140010115					
Zone Atlas Page(s): D-17 Existing Zoning: NR-E			BP	Pro	posed Zoning: NR-BP)			
			f Proposed Lots: 1		Tot	al Area of Site (acres):	6.2		
LOCATION OF PROPERTY BY STREETS									
Site Address/Street: 7801 Jefferson S	Street NE	Bet	ween: Jefferson St	reet	and: H	eadline Blvd.			
CASE HISTORY (List any current or prior project and case number(s) that may be relevant to your request.)									
1000378, 1005221									
Signature:				Date: 04.14.2020					
Printed Name: Dekker/Perich/Sabatini Sanjay Kadu, AIA, Principal/Architect					Applicant or 🙀 Agent				
FOR OFFICIAL USE ONLY									
Case Numbers	Action		Fees	Case Numbers		Action	Fees		
SI-2020-00157	AA								
2 2 2 1 2 1									
Meeting/Hearing Date:					Fee	e Total:			
Staff Signature:				Date:	Pro	ject # PR-2020	-003646		

LETTER OF AUTHORIZATION



April, 6 2020

Russell Brito
Urban Design & Development Director
City of Albuquerque Planning Department
600 Second Street NW | Albuquerque, NM 87102

RE: Minor Amendment to Approved Site Development Plan Cottonwood Classical Preparatory School (CCPS) 7801 Jefferson St. NE Albuquerque NM 87109

Dear Mr. Brito:

This Letter authorizes Dekker/Perich/Sabatini LLC to represent Cottonwood Classical Foundation Inc. with regard to the design and approval of all necessary steps related to the regulatory and permitting process with the city of Albuquerque. This letter authorizes Dekker/Perich/Sabatini LLC to act as Cottonwood Classical Foundation Inc.'s agent as necessary with the permitting and associated approval processes required for the proposed action on the property referenced above.

Please contact me at 505-998-1021, ext. 200, if there are any questions.


Sincerely,


John J Binnert Executive Director

john.binnert@cottonwoodclassical.org

John of Binnest

ZONE ATLAS MAP

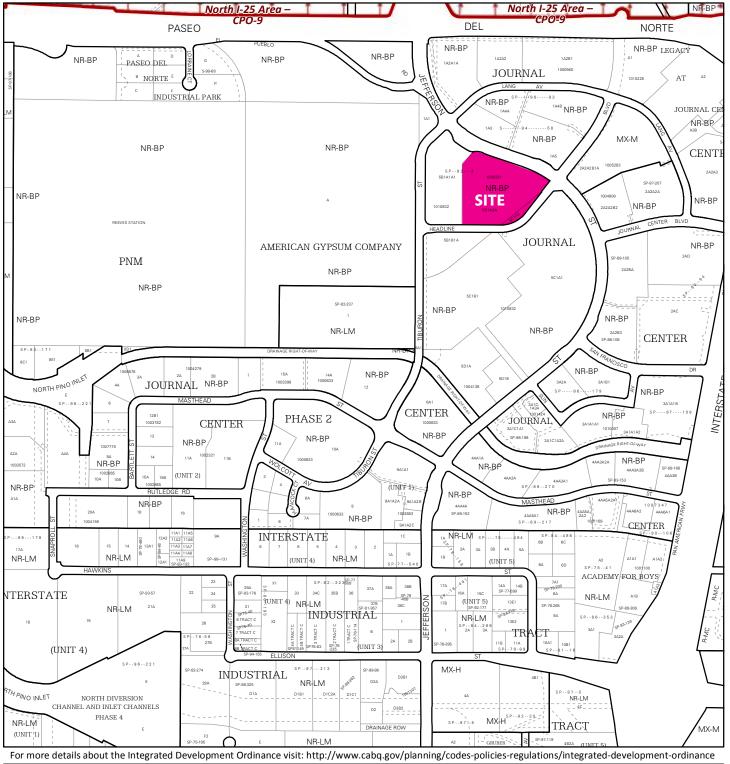

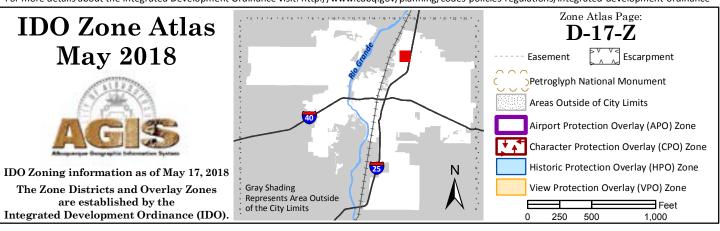

FORM P3

FORM P3: ADMINISTRATIVE DECISIONS AND MINOR AMENDMENTS

A single PDF file of the complete application including all plans and documents being submitted must be emailed to PLNDRS@cabq.gov
prior to making a submittal. Zipped files or those over 9 MB cannot be delivered via email, in which case the PDF must be provided on a CD.

☐ INFORMATION REQUIRED FOR ALL ADMINISTRATIVE DECISIONS OR AMENDMENTS

- 02 Letter of authorization from the property owner if application is submitted by an agent
- 03 Zone Atlas map with the entire site clearly outlined and labeled

□ ARCHEOLOGICAL CERTIFICATE

- __ Archaeological Compliance Documentation Form with property information section completed
- Only the information above is required unless the City Archaeologist determines that the application does not qualify for a Certificate of No Effect, in which case a treatment plan prepared by a qualified archaeologist that adequately mitigates any archeological impacts of the proposed development must be submitted and reviewed for a Certificate of Approval per the criteria in IDO Section 14-16-6-5(A)(3)(b)

■ MINOR AMENDMENT TO SITE PLAN – ADMIN, EPC, or DRB

- ___ Justification letter describing, explaining, and justifying the request per the criteria in IDO Section 14-16-6-4(X)(2)
- __ Three (3) copies of all applicable sheets of the approved Site Plan being amended, folded
- Copy of the Official Notice of Decision associated with the prior approval
- Three (3) copies of the proposed Site Plan, with changes circled and noted
 - Refer to the Site Plan Checklist for information needed on the proposed Site Plan.

Minor Amendments must be within the thresholds established in IDO TABLE 6-4-5. Any amendment beyond these thresholds is considered a Major Amendment and must be processed through the original decision-making body for the request.

☐ MINOR AMENDMENT TO SITE DEVELOPMENT PLAN APPROVED PRIOR TO THE EFFECTIVE DATE OF THE IDO

- 05 Justification letter describing, explaining, and justifying the request per the criteria in IDO Section 14-16-6-4(Y)(1)(a)
- 06 Three (3) copies of all applicable sheets of the approved Site Development Plan being amended, folded
- Copy of the Official Notice of Decision associated with the prior approval
- 07 Three (3) copies of the proposed Site Development Plan, with changes circled and noted Refer to the Site Plan Checklist for information needed on the proposed Site Plan.

Minor Amendments must be within the thresholds established in IDO TABLE 6-4-5. Any amendment beyond these thresholds is considered a Major Amendment and must be processed through the original decision-making body for the request.

□ ALTERNATIVE SIGNAGE PLAN

- Proposed Alternative Signage Plan compliant with IDO Section 14-16-5-12(F)(5)
- Justification letter describing, explaining, and justifying the request per the criteria in IDO Section 14-16-6-5(F)(4)(c)
- Required notices with content per IDO Section 14-16-6-4(K)(6)
 - __ Office of Neighborhood Coordination notice inquiry response and proof of emailed notice to affected Neighborhood Association representatives
- Sign Posting Agreement

I, the applicant or agent, acknowledge that if any required information is not submitted with this application, the application will not be scheduled for a public meeting or hearing, if required, or otherwise processed until it is complete.				
Signature:		Date: 04.16.2020		
Printed Name: Dekker/Perich/Sabatini Sanjay S. Kadu		☐ Applicant or ☐ Agent		
FOR OFFICIAL USE ONLY				
Project Number:	Case Numbers	THE PARTY OF THE P		
PR-2020-003646	SI-2020-00157			
	<u>-</u>			
	-	1706		
Staff Signature:		MENT		
Date:		AAAAA		

JUSTIFICATION LETTER



April 8, 2020

Russell Brito
Urban Design & Development Director
City of Albuquerque Planning Department
600 Second Street NW | Albuquerque, NM 87102

RE: Minor Amendment to Approved Site Development Plan Cottonwood Classical Preparatory School (CCPS) 7801 Jefferson St. NE Albuquerque NM 87109

Dear Russell Brito,

Cottonwood Classical Foundation Inc., owner of the subject property, is seeking to amend the existing site development plan for the Cottonwood Classical Preparatory School (CCPS) located at 7801 Jefferson St NE. This request will facilitate the expansion of the campus' northeast parking lot by 15 spaces needed to accommodate the school's student body and staff.

This request complies with the criteria for Minor Amendments to Prior Approval outlined in section 14-16-6-4(Y)(1)(a) of the IDO as outlined below.

1. The existing site development plan specifies the requirements in place at the time of approval, and the requested change still meets the original requirement.

The originally approved site plan does not include development standards drafted for the CCPS site. This request therefore defaults to the development standards of the Integrated Development Ordinance (IDO) for requirements such as off-street parking, with which the site is in compliance.

2. The requested change is within the thresholds for Administrative Amendments established in Table 6-4-5, cumulative of prior deviations or administrative amendments.

The table below summarizes the proposed change to the off-street parking spaces resulting from the proposed site plan modifications.

Comparison Item	Previous Plan	Proposed AA	Proposed Change	% Change
Total Parking Spaces	151* Spaces	166 Spaces	Net Gain 15 Spaces	9.9 % Change
			Total Change	9.9 %

^{*} This 151 space count reflects the parking spaces that are actually shown on the latest site plan and were physically constructed on site. This number is different from number utilized in the parking calculations table on the plan, which identifies the total number of spaces provided as 144. As there was an error or typo in the parking calculations, we are using the number of spaces that are illustrated on the site plan and that physically exist on the site.

The requested site improvements outlined above equate to a total 9.9% change from the approved site plan and therefore fall within the allowable 10% threshold for minor amendments established in Table 6-4-5, which can be approved administratively by the Zoning Enforcement Officer (ZEO).

Based upon the rationale presented in this letter, we respectfully request administrative approval of the proposed amendment to the approved Site Development Plan to facilitate the expansion of the Cottonwood Classical Preparatory School parking lot. If you have any questions or need clarification of anything contained herein, please contact me by phone at (505)761-9700.

Sincerely_

Dekker/Perich/Sabatini


Sanjay S. Kadu, AIA, Principal/architect

Agent for Cottonwood Classical Foundation Inc.

06 PRIOR APPROVED SITE PLAN

A. Latest 2015 AA for Cottonwood Classical

Public records request was unable to located signed-off version, but this site plan indicates the existing site conditions.

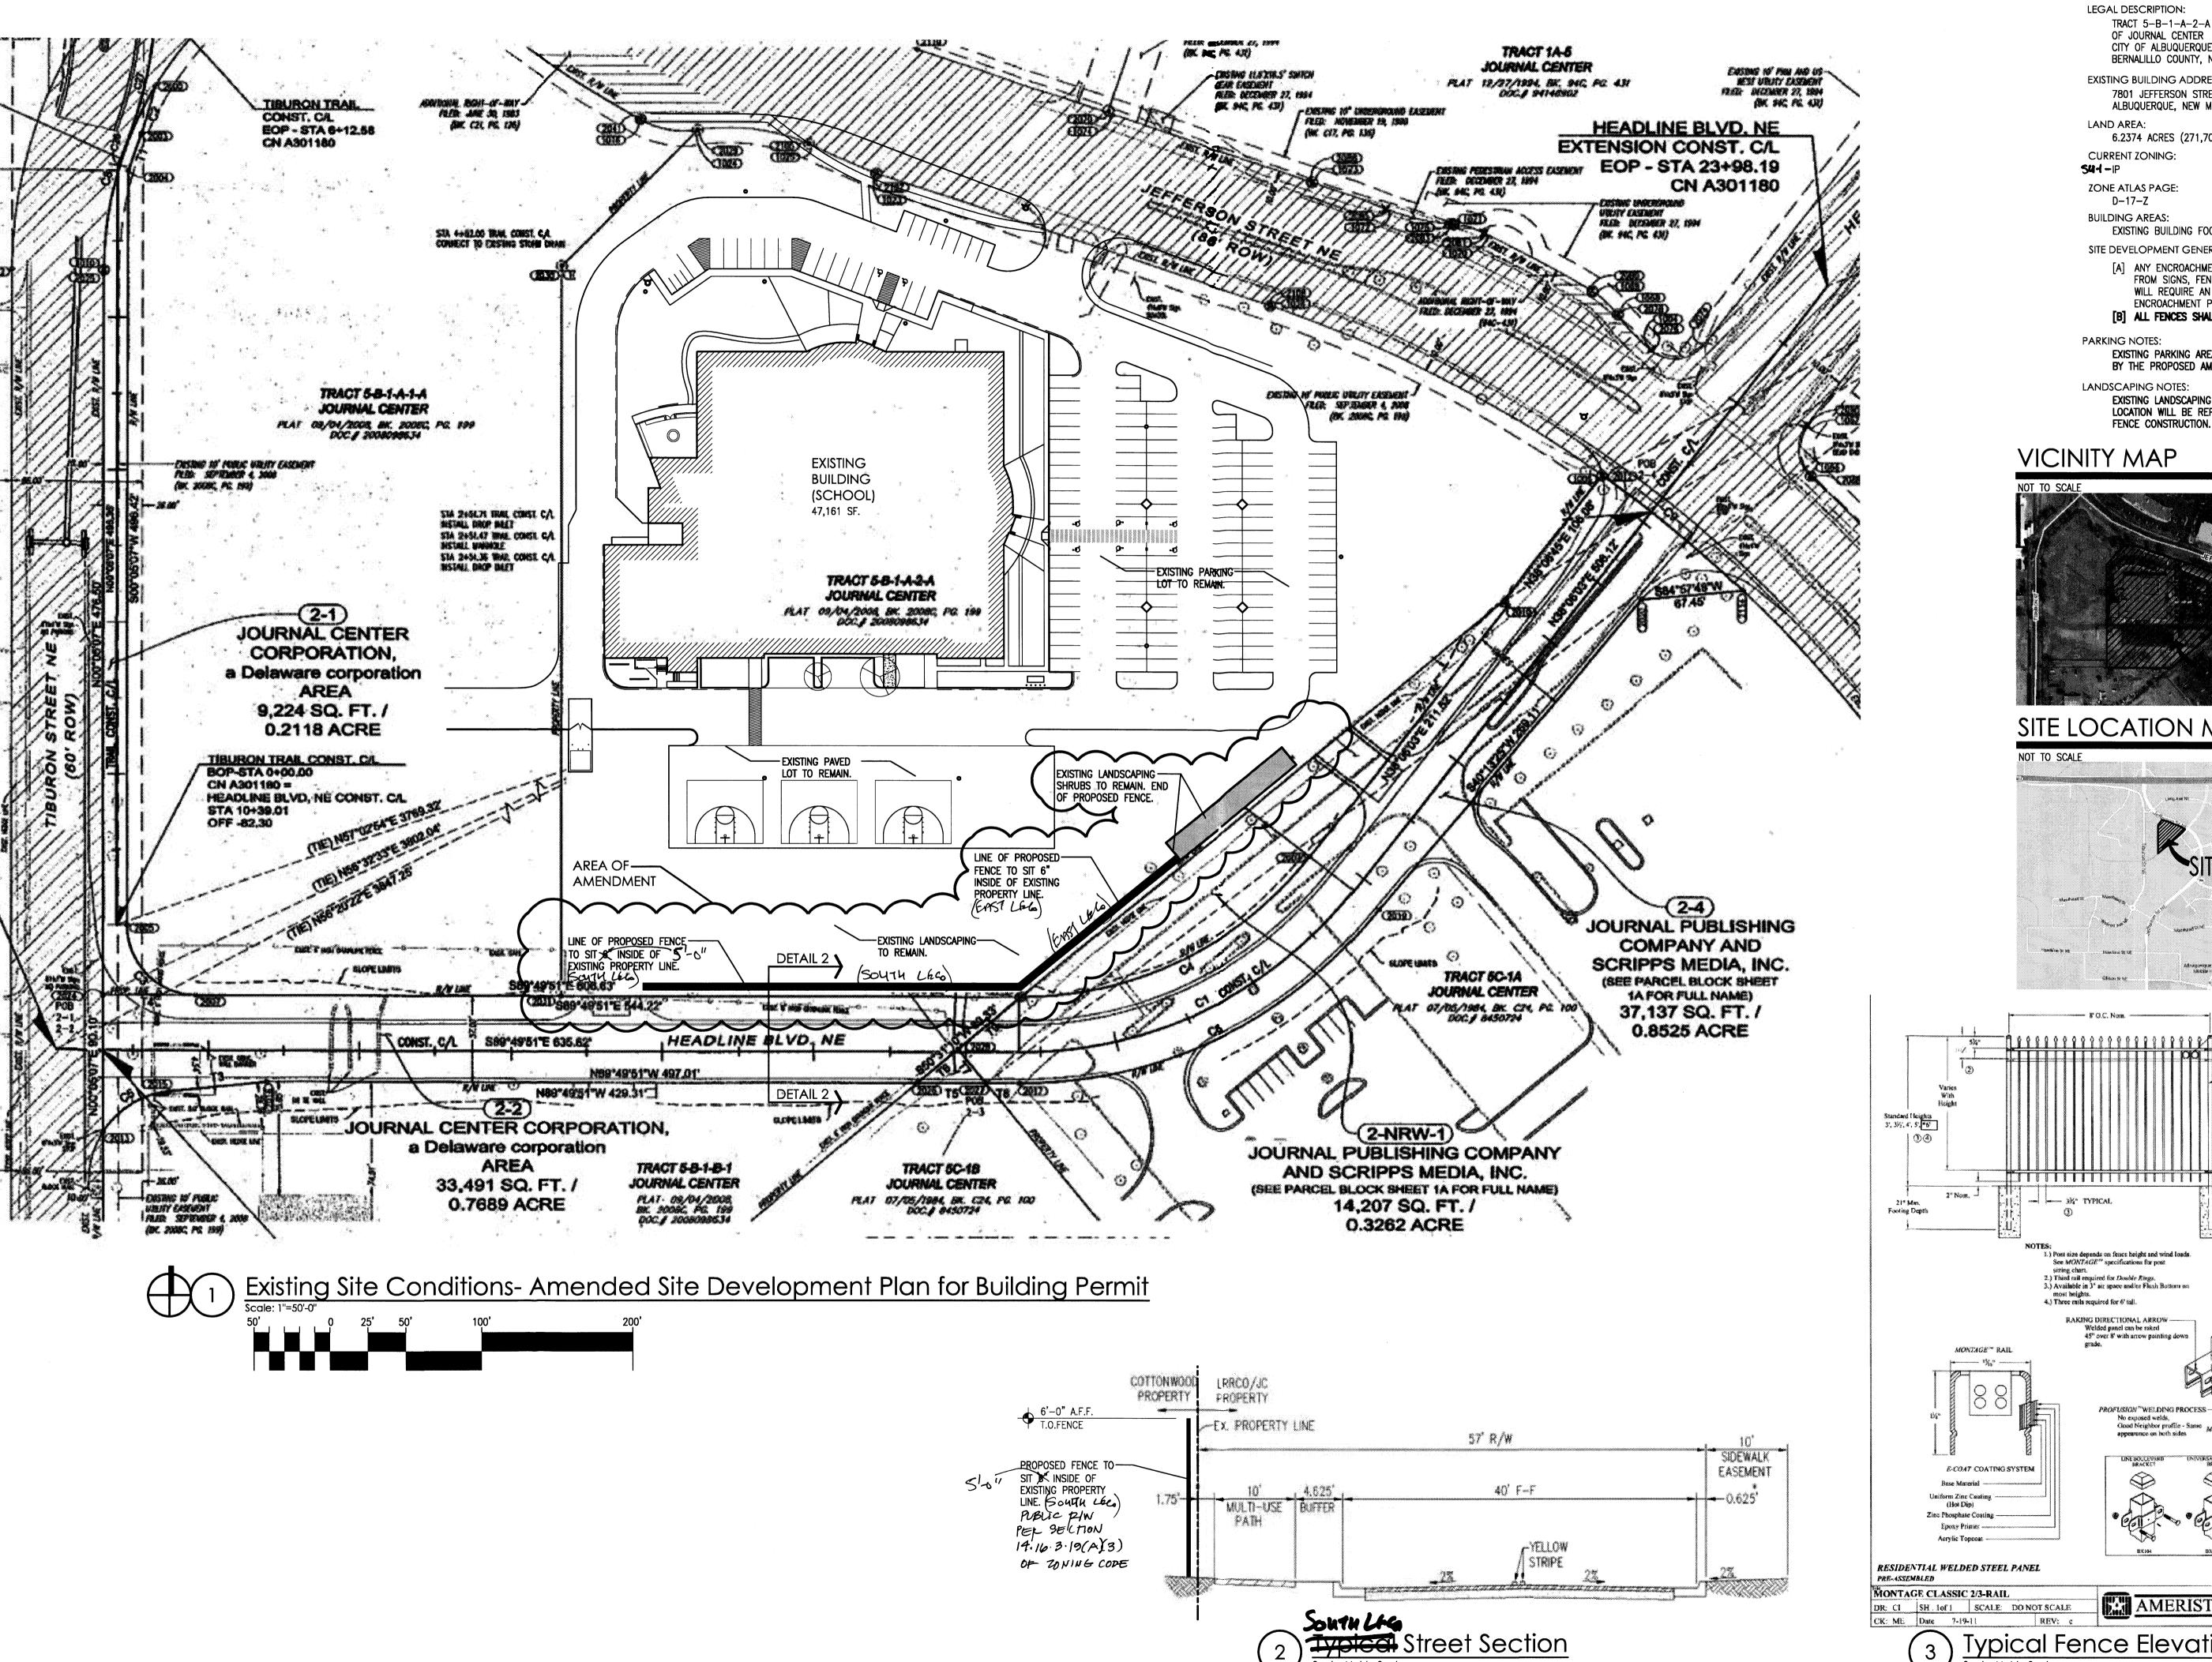

TRACT 5-B-1-A-2-A CITY OF ALBUQUERQUE, BERNALILLO COUNTY, NEW MEXICO EXISTING BUILDING ADDRESS: 7801 JEFFERSON STREET, NE. ALBUQUERQUE, NEW MEXICO 87109 6.2374 ACRES (271,701 SQ. FT.) OVERALL PROPERTY EXISTING BUILDING FOOTPRINT 47,161 SF. SITE DEVELOPMENT GENERAL NOTES: [A] ANY ENCROACHMENT OR OVERHANG INTO THE ROW FROM SIGNS, FENCES, CANOPY, ROOF LINES, ETC. WILL REQUIRE AN ANNUAL REVOCABLE ENCROACHMENT PERMIT. [B] ALL FENCES SHALL BE UNDER SEPARATE PERMIT. EXISTING PARKING AREAS WILL NOT BE AFFECTED BY THE PROPOSED AMENDMENT. EXISTING LANDSCAPING AROUND PROPOSED FENCE LOCATION WILL BE REPAIRED OR REPLACED DUE TO FENCE CONSTRUCTION. SITE LOCATION MAP / 1½" x 'Y," MONTAGE" Rail (See Cross Service Robert PROFESSON WELDING PROCESS -No exposed welds,

Ocood Neighbor profile - Same MONTAGE RAIL

appearance on both sides

Specially formed high strength Values shows are nominal and not to be used for installation purposes. See product specification for installation requirements. AMERISTAR® 1555 N. Mingo
Tulsa, OK. 74116
1-888-333-3422 Typical Fence Elevation

SITE DEVELOPMENT DATA:

Mullen Heller

Architecture P.C. 1718 Central Avenue SW


Suite D Albuquerque, NM 87104 505 268 4144[p]

Cottonwood (eet Mexi Fence rson Stre

Adminstrative

AA-1

AMENDED SITE PLAN & APPLICABLE SHEETS

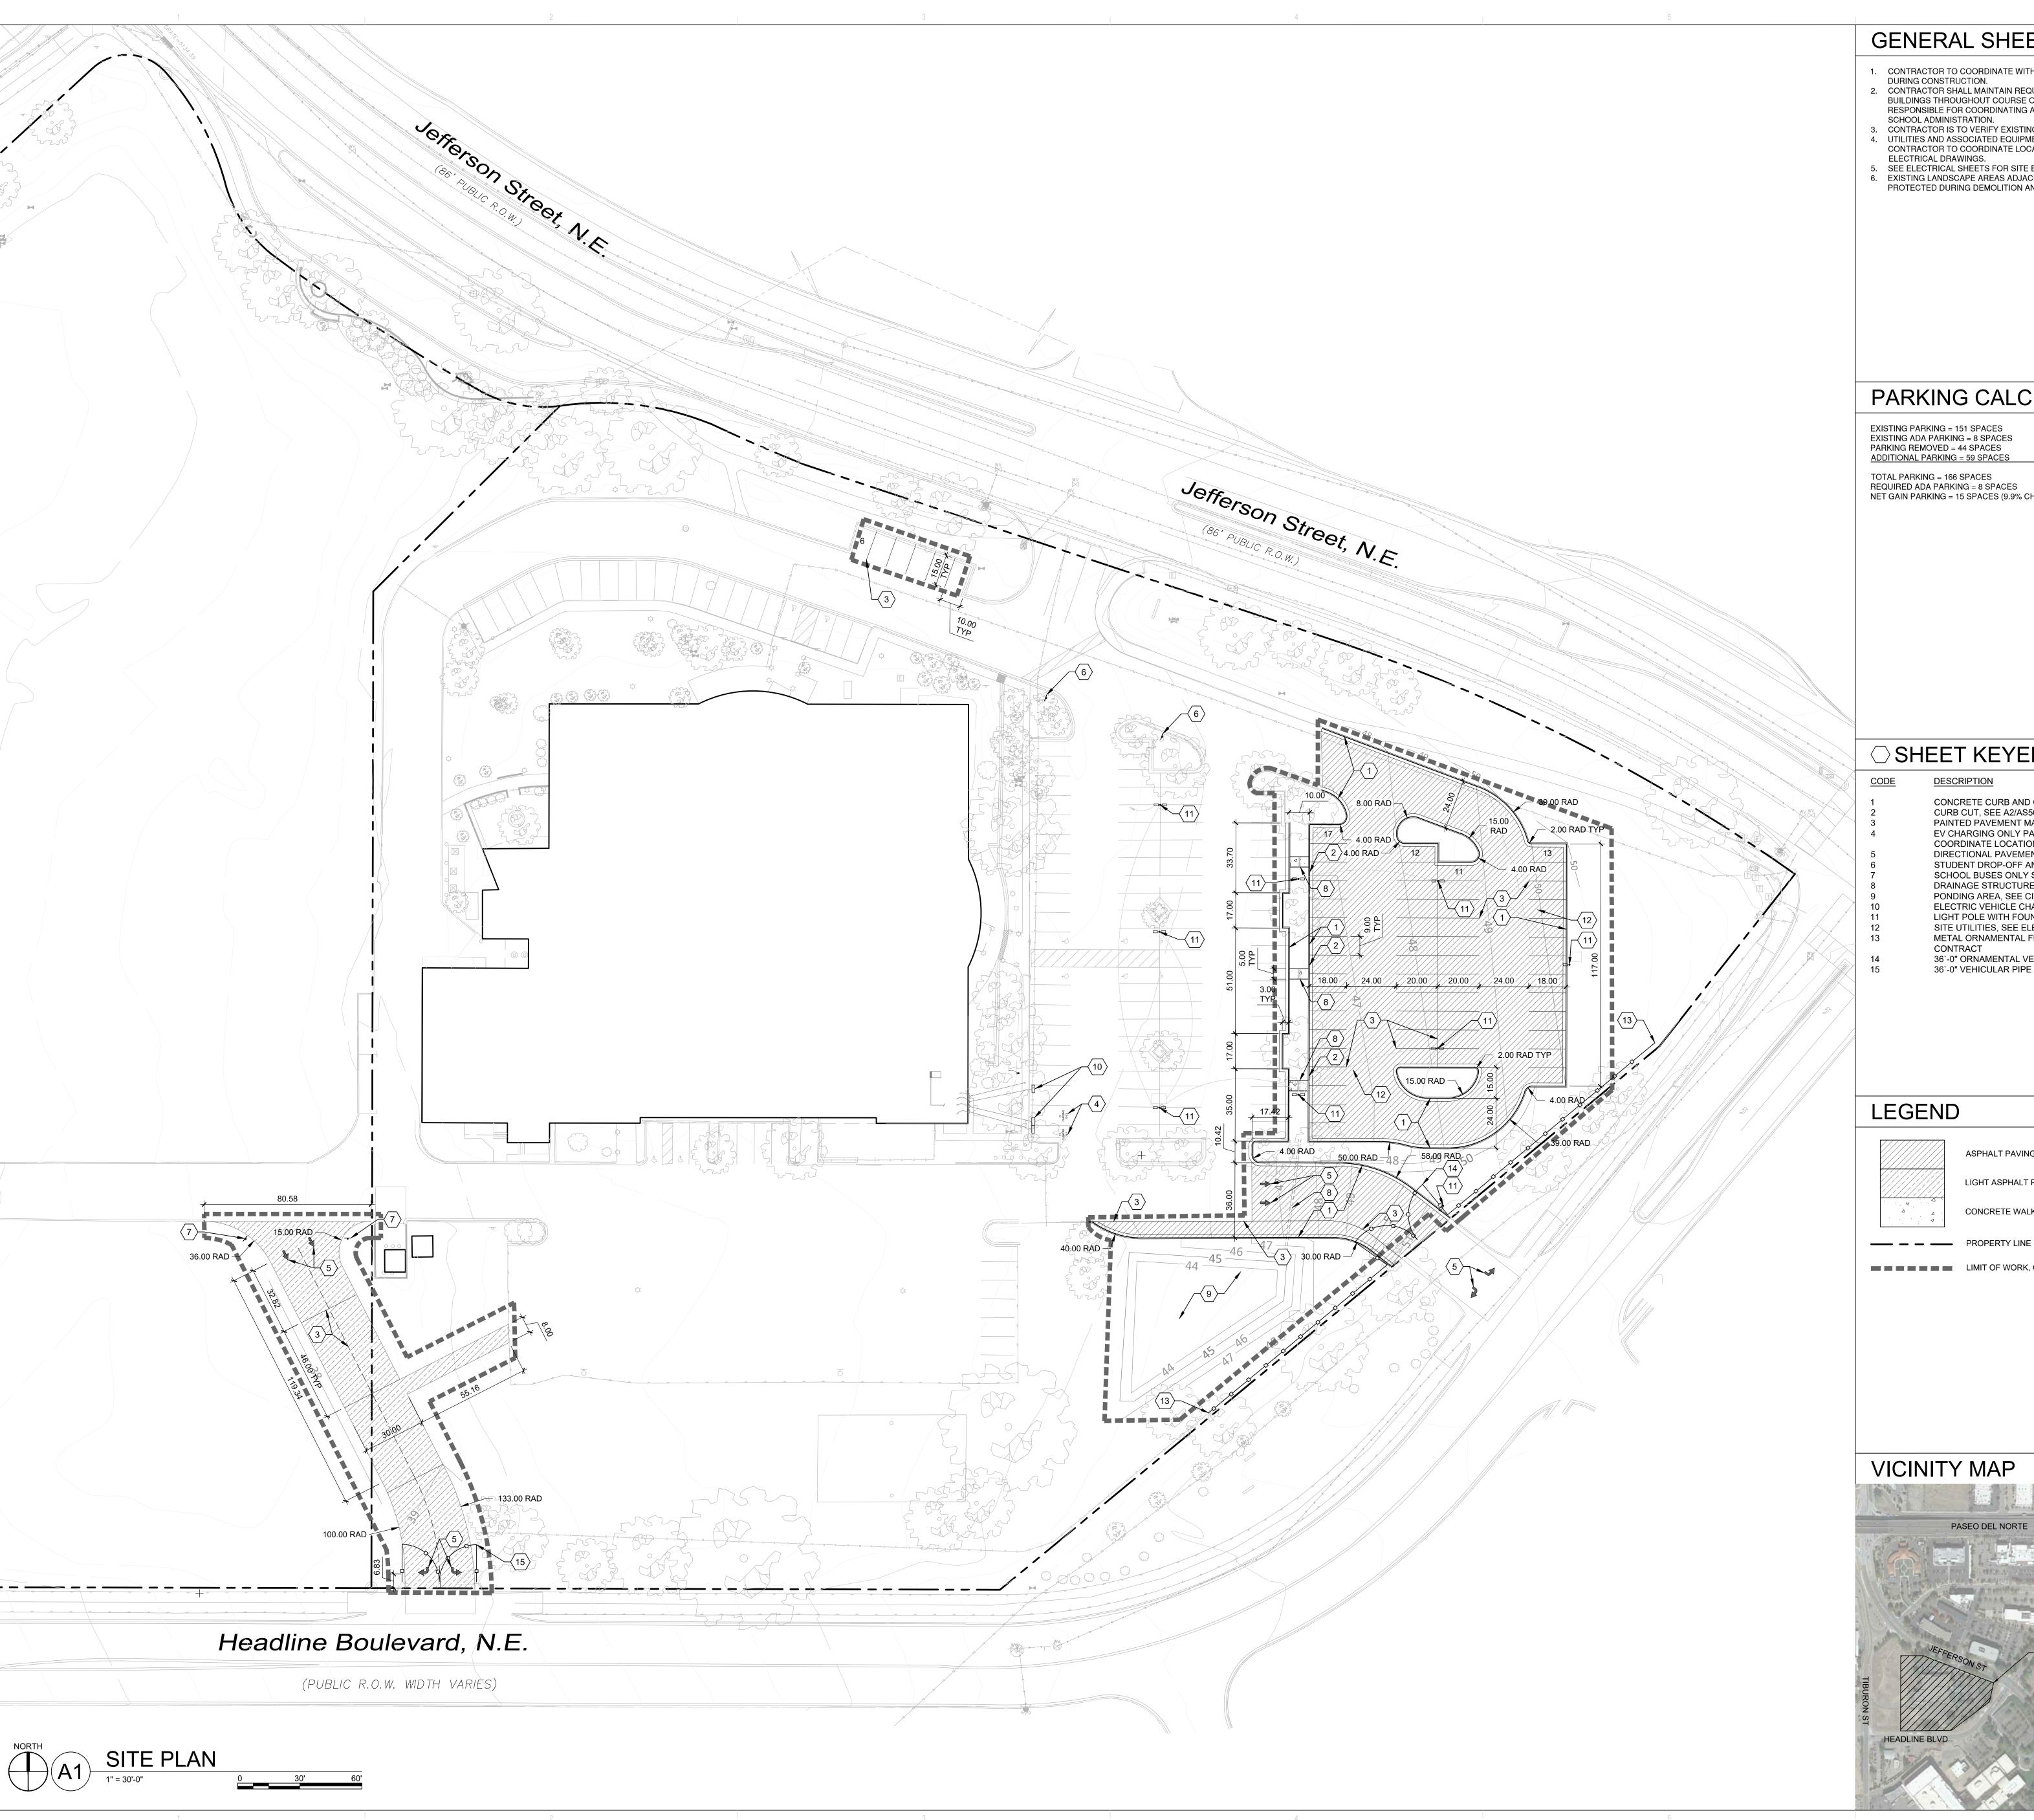


GENERAL SHEET NOTES

- 1. CONTRACTOR TO COORDINATE WITH OWNER FOR ALLOWABLE STAGING AREAS DURING CONSTRUCTION. 2. CONTRACTOR SHALL MAINTAIN REQUIRED EXITS FROM EXISTING OCCUPIED BUILDINGS THROUGHOUT COURSE OF CONSTRUCTION, AND CONTRACTOR IS RESPONSIBLE FOR COORDINATING ALL WORK WITH THE ACCESS NEEDS OF THE SCHOOL ADMINISTRATION.
- CONTRACTOR IS TO VERIFY EXISTING UTILITY LOCATIONS BEFORE EXCAVATION. 4. UTILITIES AND ASSOCIATED EQUIPMENT SHOWN FOR REFERENCE ONLY.
 CONTRACTOR TO COORDINATE LOCATION AND INSTALLATION. SEE CIVIL AND
- 5. SEE ELECTRICAL SHEETS FOR SITE ELECTRICAL DEMOLITION PLANS. 6. EXISTING LANDSCAPE AREAS ADJACENT TO THE PROJECT SITE ARE TO BE PROTECTED DURING DEMOLITION AND CONSTRUCTION.

DEKKER PERICH SABATINI

ARCHITECTURE DESIGN **INSPIRATION**

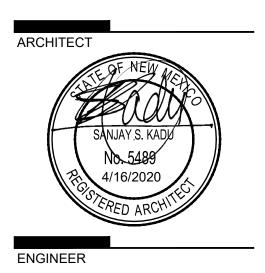

PARKING CALCULATIONS

EXISTING PARKING = 151 SPACES EXISTING ADA PARKING = 8 SPACES PARKING REMOVED = 44 SPACES

TOTAL PARKING = 166 SPACES REQUIRED ADA PARKING = 8 SPACES NET GAIN PARKING = 15 SPACES (9.9% CHANGE)

SHEET KEYED NOTES

CONCRETE CURB AND GUTTER, SEE CIVIL CURB CUT, SEE A2/AS501 AND CIVIL FOR LOCATIONS PAINTED PAVEMENT MARKINGS, 4" WIDE. COLOR: WHITE EV CHARGING ONLY PAVEMENT MARKING, COLOR: WHITE, COORDINATE LOCATION WITH INSTALLATION OF CHARGERS DIRECTIONAL PAVEMENT ARROW, SEE C1/AS501 STUDENT DROP-OFF AND PICK-UP SIGN, SEE C2/AS501 SCHOOL BUSES ONLY SIGN, SEE D2/AS501 DRAINAGE STRUCTURE, SEE CIVIL

PONDING AREA, SEE CIVIL ELECTRIC VEHICLE CHARGER, SEE ELECTRICAL LIGHT POLE WITH FOUNDATION, SEE B1/AS501 AND ELECTRICAL SITE UTILITIES, SEE ELECTRICAL METAL ORNAMENTAL FENCE TO MATCH EXISTING, NOT IN

36`-0" ORNAMENTAL VEHICULAR GATE, NOT IN CONTRACT 36`-0" VEHICULAR PIPE GATE, NOT IN CONTRACT

PROJECT LOCATION

ASPHALT PAVING, SEE CIVIL LIGHT ASPHALT PAVING, SEE CIVIL CONCRETE WALK, SEE A1/AS501


LIMIT OF WORK, COORDINATE WITH CIVIL

CONSTRUCTION **DRAWINGS**

DRAWN BY	BG
REVIEWED BY	SK, MB
DATE	13 APR 2020
PROJECT NO.	19-0093
DRAWING NAME	


SITE PLAN

AS101

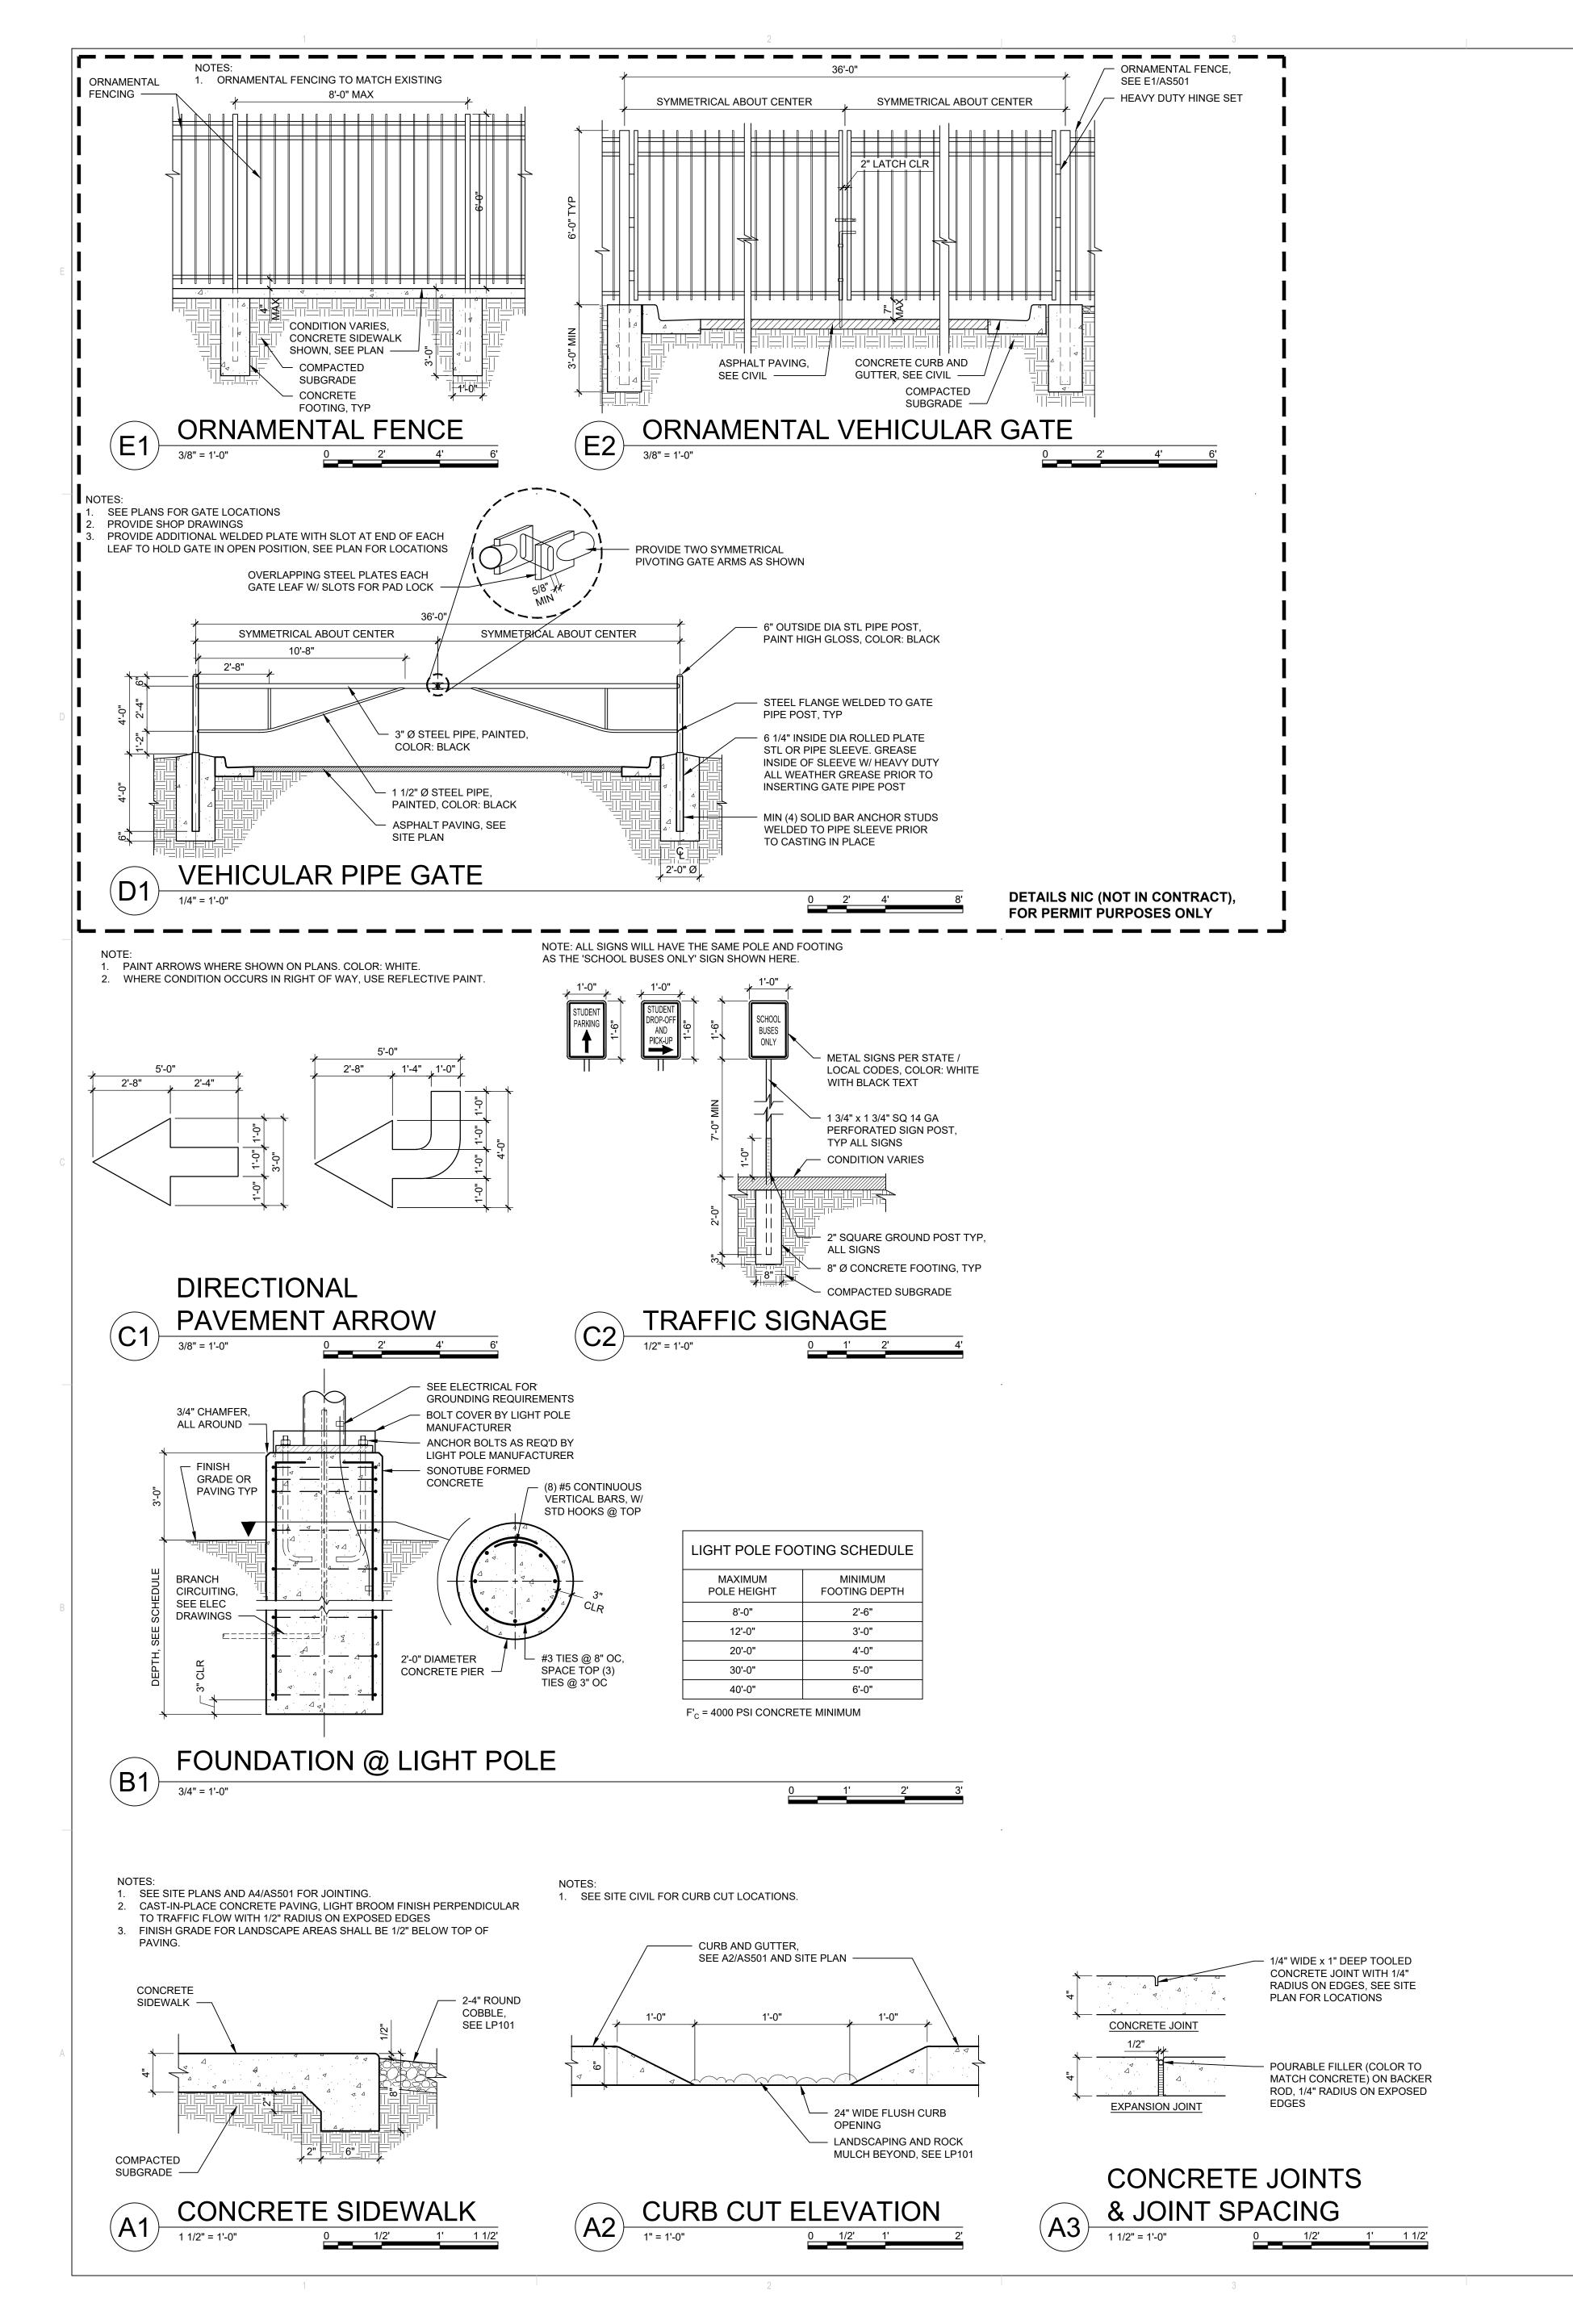

DEKKER PERICH SABATINI

ARCHITECTURE DESIGN INSPIRATION

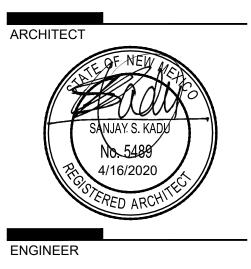

PROJECT

PARKING EXPANSION
7801 JEFFERSON ST NE
ALBIGIEROIF NM 87109


100% CONSTRUCTION DRAWINGS

DR
REVISIONS
\triangle
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DRAWN BY	BG
REVIEWED BY	SK, MB
DATE	13 APR 2020
PROJECT NO.	19-0093
DRAWING NAME	

SITE DETAILS

AS501

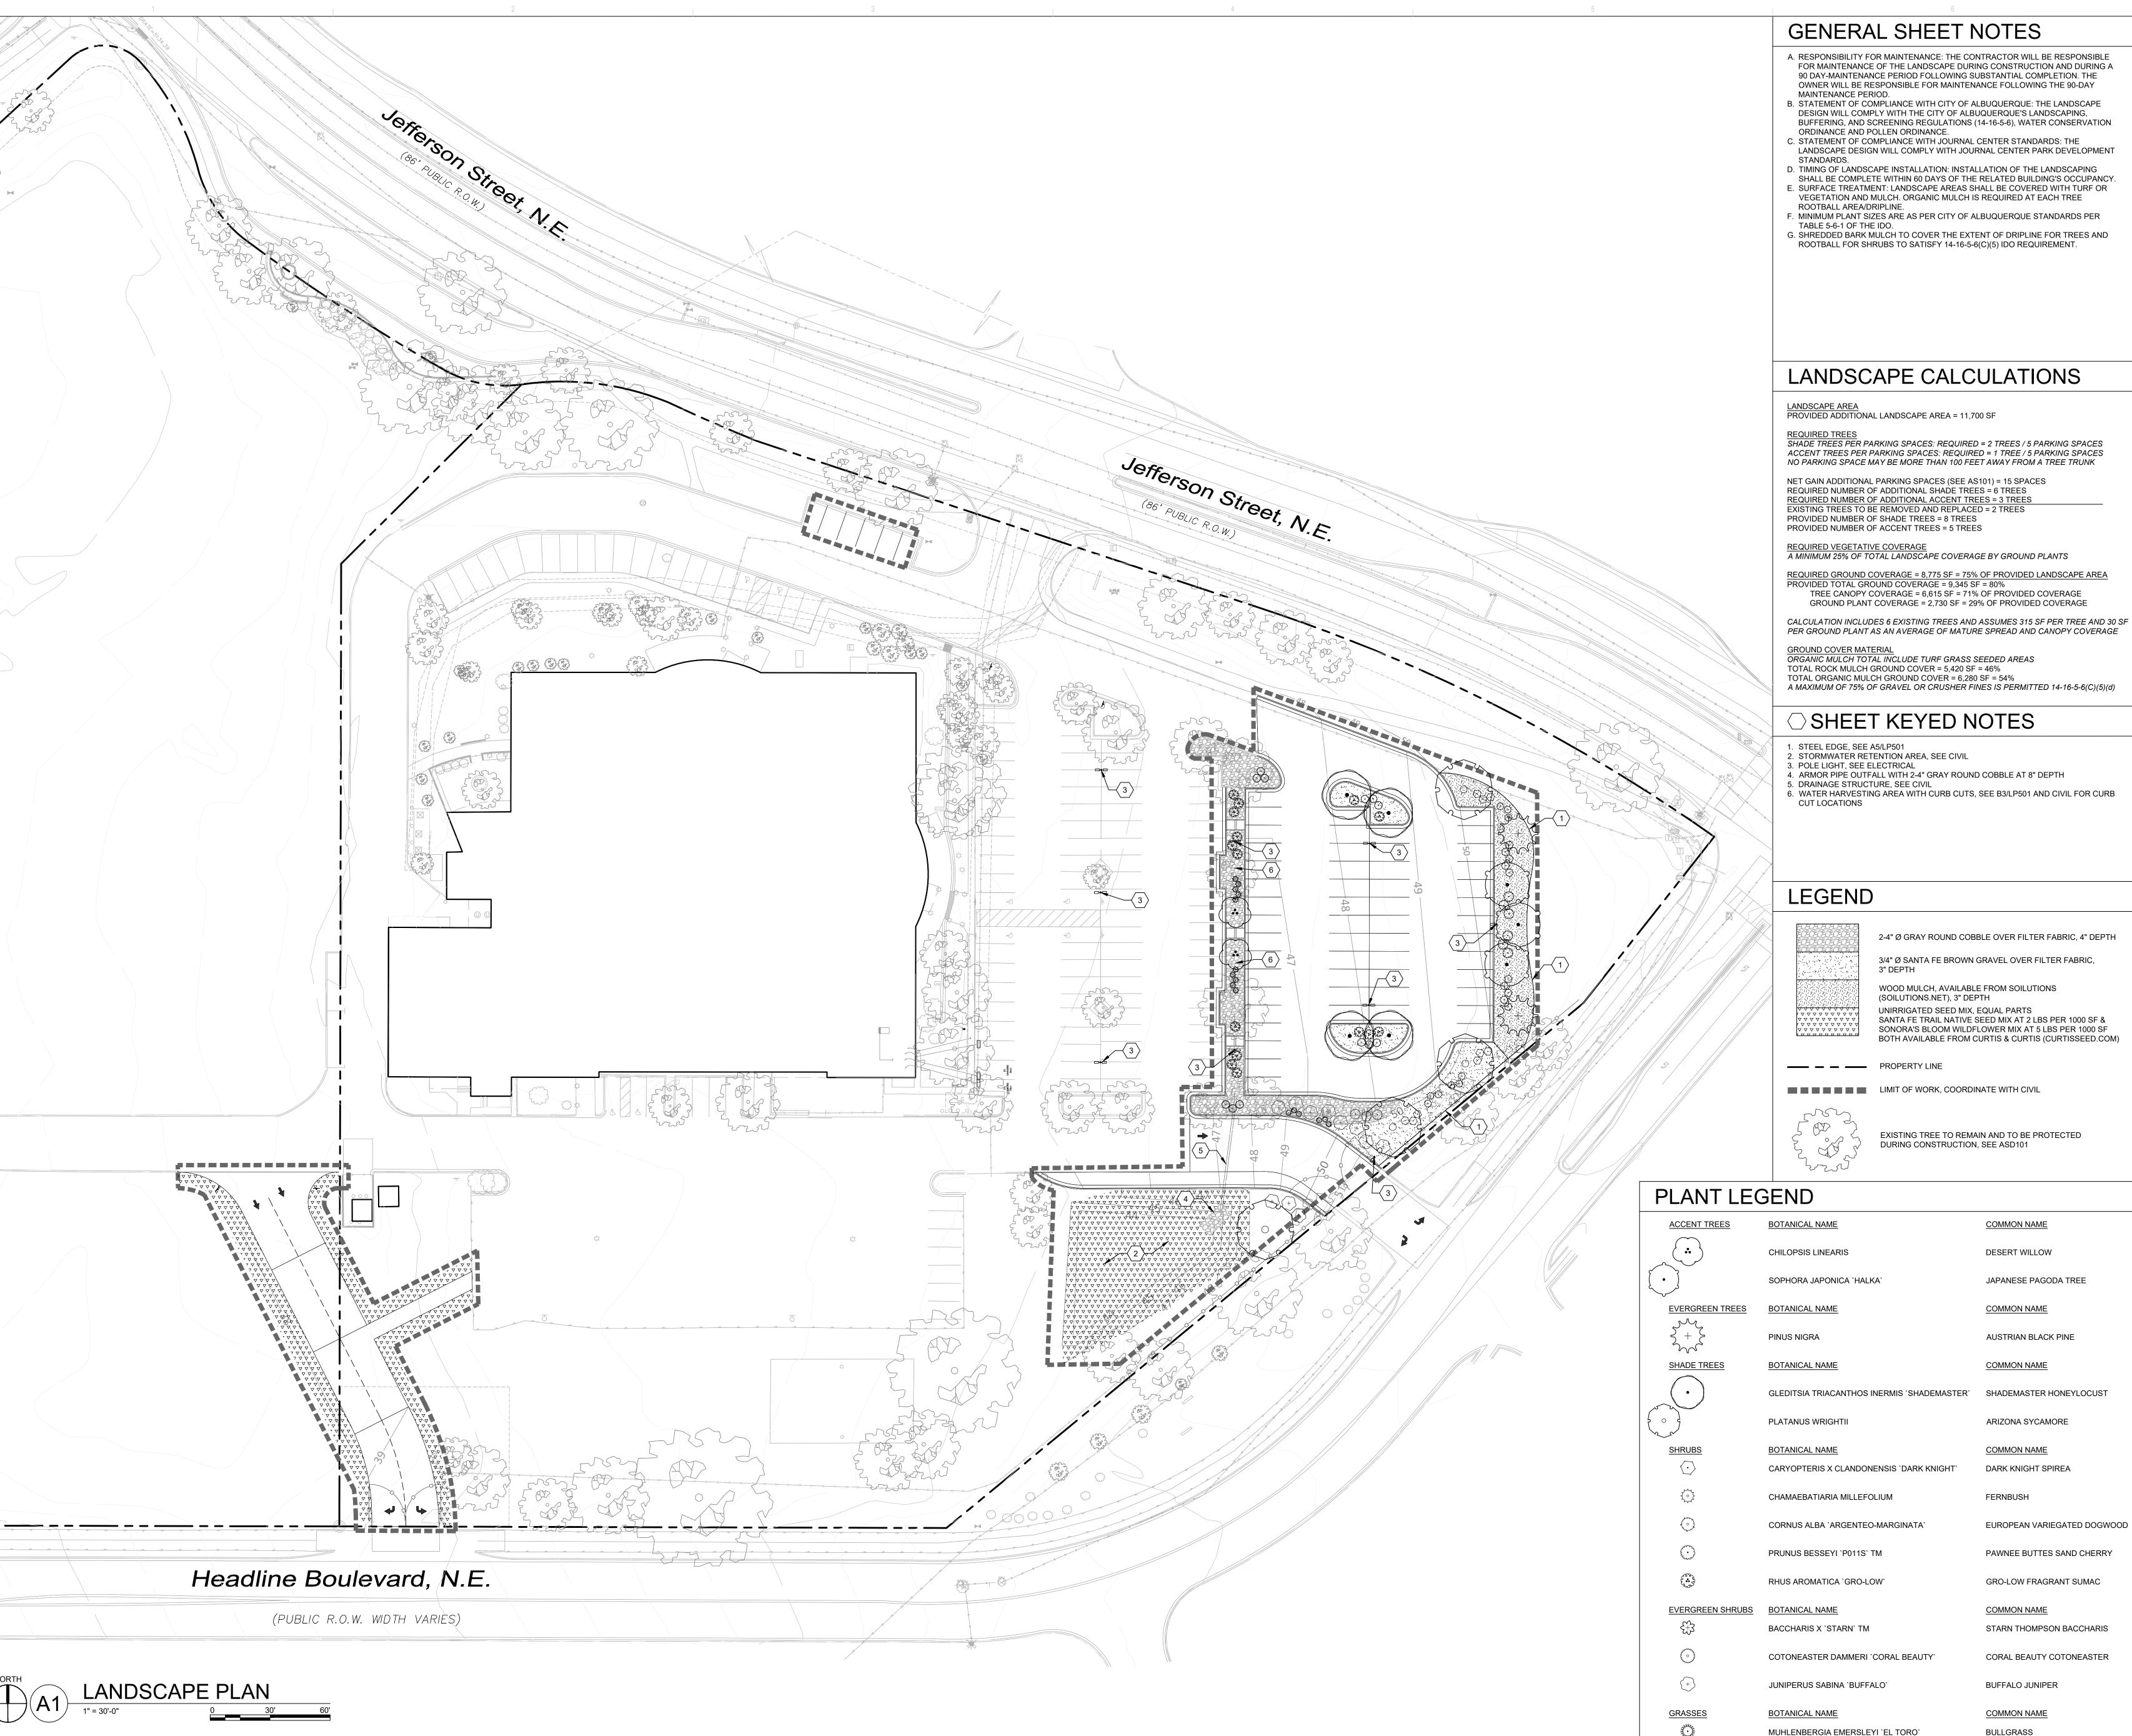

GENERAL SHEET NOTES DEKKER A. RESPONSIBILITY FOR MAINTENANCE: THE CONTRACTOR WILL BE RESPONSIBLE

PERICH

ARCHITECTURE DESIGN **INSPIRATION**

SABATINI


ENGINEER

PROJECT

ORGANIC MULCH TOTAL INCLUDE TURF GRASS SEEDED AREAS TOTAL ROCK MULCH GROUND COVER = 5,420 SF = 46% TOTAL ORGANIC MULCH GROUND COVER = 6,280 SF = 54%

SHEET KEYED NOTES

- 2. STORMWATER RETENTION AREA, SEE CIVIL
- 3. POLE LIGHT, SEE ELECTRICAL
- FOLE LIGHT, SEE ELECTRICAL
 ARMOR PIPE OUTFALL WITH 2-4" GRAY ROUND COBBLE AT 8" DEPTH
 DRAINAGE STRUCTURE, SEE CIVIL
 WATER HARVESTING AREA WITH CURB CUTS, SEE B3/LP501 AND CIVIL FOR CURB
- **CUT LOCATIONS**

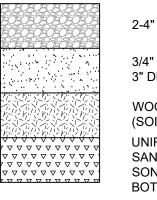

2-4" Ø GRAY ROUND COBBLE OVER FILTER FABRIC, 4" DEPTH 3/4" Ø SANTA FE BROWN GRAVEL OVER FILTER FABRIC,

WOOD MULCH, AVAILABLE FROM SOILUTIONS (SOILUTIONS.NET), 3" DEPTH UNIRRIGATED SEED MIX, EQUAL PARTS SANTA FE TRAIL NATIVE SEED MIX AT 2 LBS PER 1000 SF & SONORA'S BLOOM WILDFLOWER MIX AT 5 LBS PER 1000 SF BOTH AVAILABLE FROM CURTIS & CURTIS (CURTISSEED.COM)

COMMON NAME

LIMIT OF WORK, COORDINATE WITH CIVIL

EXISTING TREE TO REMAIN AND TO BE PROTECTED DURING CONSTRUCTION, SEE ASD101

•	CHILOPSIS LINEARIS	DESERT WILLOW
•	SOPHORA JAPONICA 'HALKA'	JAPANESE PAGODA TREE
EVERGREEN TREES	BOTANICAL NAME	COMMON NAME
3 + X	PINUS NIGRA	AUSTRIAN BLACK PINE
SHADE TREES	BOTANICAL NAME	COMMON NAME
	GLEDITSIA TRIACANTHOS INERMIS 'SHADEMASTER'	SHADEMASTER HONEYLOCUST
	PLATANUS WRIGHTII	ARIZONA SYCAMORE
SHRUBS	BOTANICAL NAME	COMMON NAME
$\langle \cdot \rangle$	CARYOPTERIS X CLANDONENSIS 'DARK KNIGHT'	DARK KNIGHT SPIREA
₹° }	CHAMAEBATIARIA MILLEFOLIUM	FERNBUSH
\odot	CORNUS ALBA `ARGENTEO-MARGINATA`	EUROPEAN VARIEGATED DOGV
de construction de la constructi	PRUNUS BESSEYI 'P011S' TM	PAWNEE BUTTES SAND CHERR
2 4 2 2 2 2 2 2 2 2 2 2 2 2 2 2 2 2 2 2	RHUS AROMATICA `GRO-LOW`	GRO-LOW FRAGRANT SUMAC
EVERGREEN SHRUBS	BOTANICAL NAME	COMMON NAME
\	BACCHARIS X `STARN` TM	STARN THOMPSON BACCHARIS
	COTONEASTER DAMMERI 'CORAL BEAUTY'	CORAL BEAUTY COTONEASTER
+	JUNIPERUS SABINA 'BUFFALO'	BUFFALO JUNIPER
GRASSES	BOTANICAL NAME	COMMON NAME
one of the same	MUHLENBERGIA EMERSLEYI `EL TORO`	BULLGRASS

CONSTRUCTION

DRAWINGS

DRAWN BY **REVIEWED BY** 13 APR 2020 19-0093 PROJECT NO. DRAWING NAME

LANDSCAPE PLAN

LP101

2-4" Ø GRAY ROUND COBBLE OVER FILTER FABRIC, 4" DEPTH 3/4" Ø SANTA FE BROWN GRAVEL OVER FILTER FABRIC, 3" DEPTH WOOD MULCH, AVAILABLE FROM SOILUTIONS (SOILUTIONS.NET), 3" DEPTH

SANTA FE TRAIL NATIVE SEED MIX AT 2 LBS PER 1000 SF & SONORA'S BLOOM WILDFLOWER MIX AT 5 LBS PER 1000 SF

BOTH AVAILABLE FROM CURTIS & CURTIS (CURTISSEED.COM)

₹°}

£ ... 2

+

EVERGREEN SHRUBS BOTANICAL NAME

SEE B1 &

CHAMAEBATIARIA MILLEFOLIUM

PRUNUS BESSEYI 'P011S' TM

RHUS AROMATICA 'GRO-LOW'

BACCHARIS X `STARN` TM

JUNIPERUS SABINA 'BUFFALO'

B2/LP501 MUHLENBERGIA EMERSLEYI `EL TORO`

CORNUS ALBA 'ARGENTEO-MARGINATA'

COTONEASTER DAMMERI 'CORAL BEAUTY'

UNIRRIGATED SEED MIX, EQUAL PARTS

		5			6			
PLANT SCHEDULE								
ACCENT TRI	EES SEE A1 &	BOTANICAL NAME	COMMON NAME	SIZE/COND.	MAT. HT.	MAT. DIA.	WATER USE	QTY
•	A2/LP501	CHILOPSIS LINEARIS	DESERT WILLOW	24" BOX	25.00	20.00	LOW	2
		SOPHORA JAPONICA `HALKA`	JAPANESE PAGODA TREE	2.5" CAL	40.00	30.00	MED+	3
EVERGREEN	N TREES	BOTANICAL NAME	COMMON NAME	SIZE/COND.	MAT. HT.	MAT. DIA.	WATER USE	QTY
	SEE A1 & A2/LP501	PINUS NIGRA	AUSTRIAN BLACK PINE	6' HT	40.00	25.00	MED	2
SHADE TRE		BOTANICAL NAME	COMMON NAME	SIZE/COND.	MAT. HT.	MAT. DIA.	WATER USE	<u>QTY</u>
	SEE A1 & A2/LP501	GLEDITSIA TRIACANTHOS INERMIS 'SHADEMASTER'	SHADEMASTER HONEYLOCUST	2.5" CAL	35.00	30.00	MED	4
		PLATANUS WRIGHTII	ARIZONA SYCAMORE	2.5" CAL	50.00	40.00	HIGH	4
<u>SHRUBS</u>	055 84 0	BOTANICAL NAME	COMMON NAME	SIZE/COND.	MAT. HT.	MAT. DIA.	WATER USE	<u>QTY</u>
$\langle \cdot \rangle$	SEE B1 & B2/LP501	CARYOPTERIS X CLANDONENSIS 'DARK KNIGHT'	DARK KNIGHT SPIREA	5 GAL	5.00	5.00	LOW	9

FERNBUSH

EUROPEAN VARIEGATED DOGWOOD

PAWNEE BUTTES SAND CHERRY

GRO-LOW FRAGRANT SUMAC

STARN THOMPSON BACCHARIS

CORAL BEAUTY COTONEASTER

COMMON NAME

BUFFALO JUNIPER

COMMON NAME


BULLGRASS

5 GAL

5 GAL

1.00

2. SLOPE SHOULD PASS THROUGH THE POINT WHERE THE TRUNK BASE MEETS 1. PRIOR TO BACKFILLING, ALL MATERIAL SUCH AS CONTAINERS, SUBSTRATE/SOIL. 3. CENTER BERM ON DOWNHILL SIDE OF ROOTBALL FOR 240°. WIRE, BURLAP AND ROPE SHALL BE COMPLETELY REMOVED. ROOT FLARE TO BE FLUSH WITH FINISH GRADE. REMOVE SOIL TO EXPOSE ROOT FLARE - ROTARY TILL PLANT PIT; REMOVE SOIL. BACKFILL PER SPECIFICATIONS MULCH PER DRAWINGS WEED BARRIER FABRIC ROUGH-UP SIDES OF PLANTING PIT ROOTBALL ON UNDISTURBED SOIL 3 TIMES ROOTBALL DIAMETER 1. PRIOR TO BACKFILLING, ALL MATERIAL SUCH AS CONTAINERS, WIRE, BURLAP AND ROPE SHALL BE COMPLETELY REMOVED. SUBSTRATE SOIL. - ROOT FLARE TO BE FLUSH WITH FINISH GRADE. NO MULCH 1"-2" FROM TRUNK FLARE SLOPE GRADE AWAY FROM TRUNK ROTARY TILL PLANT PIT; REMOVE SOIL, BACKFILL PER SPECIFICATIONS ROUND TOPPED SOIL TREE TO BE — MULCH PER DRAWINGS BERM 4" HIGH 8" SET PLUMB WIDE ABOVE ROOT BALL SURFACE — WEED BARRIER FABRIC 1 MAX - ROUGH-UP SIDES OF PLANTING PIT - ROOTBALL ON 3 TIMES ROOTBALL DIAMETER UNDISTURBED SOIL

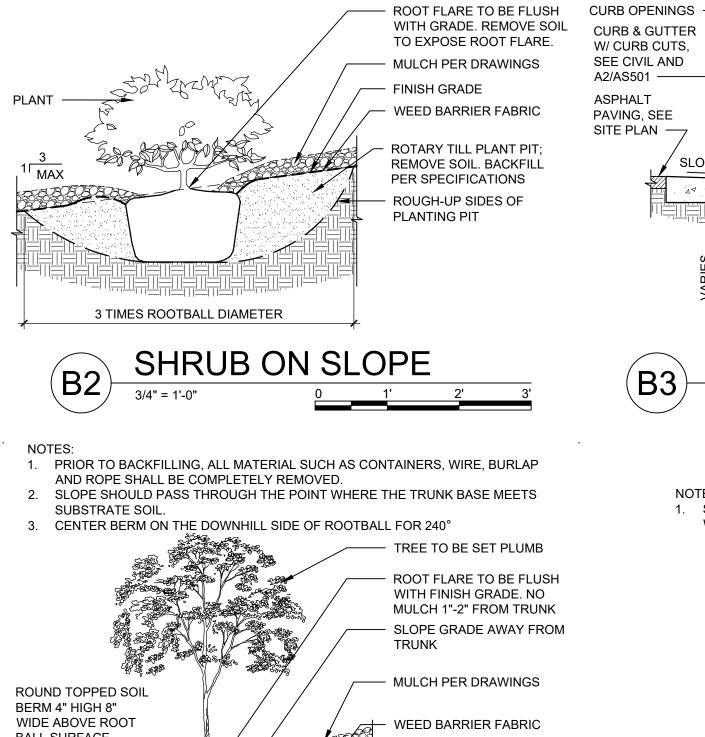

3 TIMES ROOTBALL DIAMETER

TREE ON SLOPE

- ROTARY TILL PLANT PIT;

ROUGH-UP SIDES OF

PER SPECS.

PLANTING PIT


ROOTBALL ON


UNDISTURBED SOIL


REMOVE SOIL. BACKFILL

1. PRIOR TO BACKFILLING, ALL MATERIAL SUCH AS CONTAINERS, WIRE, BURLAP AND

ROPE SHALL BE COMPLETELY REMOVED.

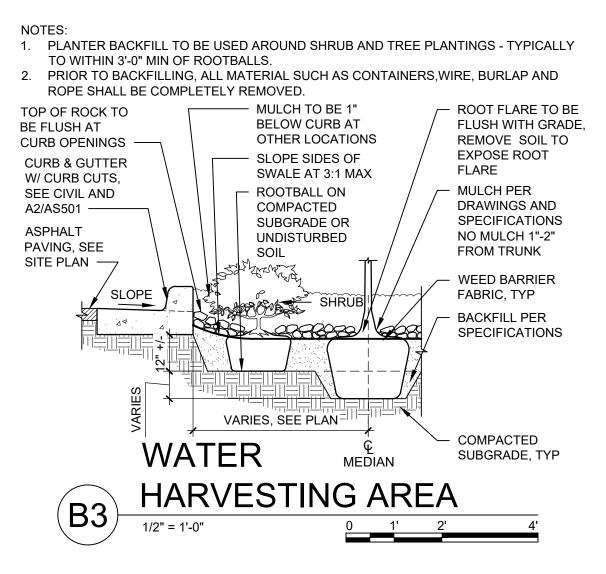


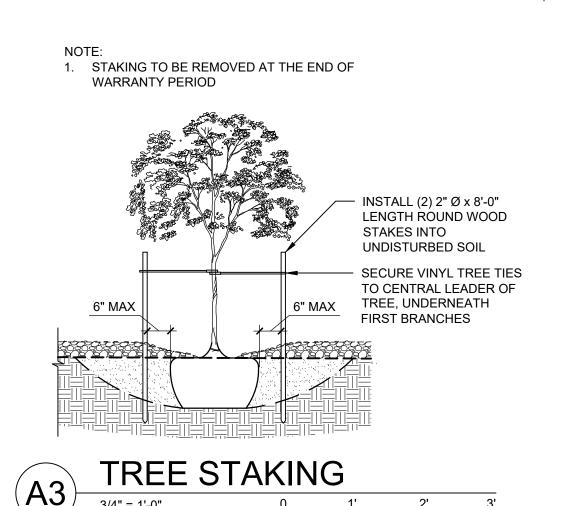

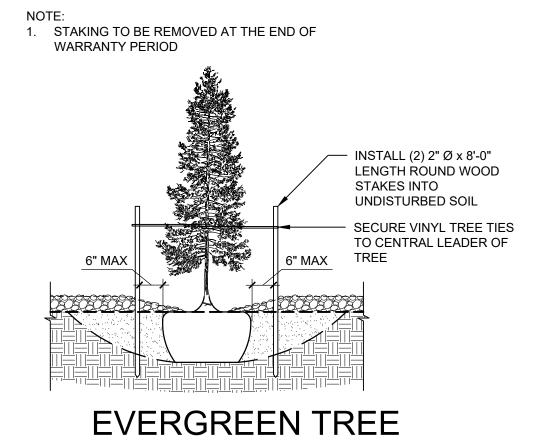

STAKING

3/4" = 1'-0"

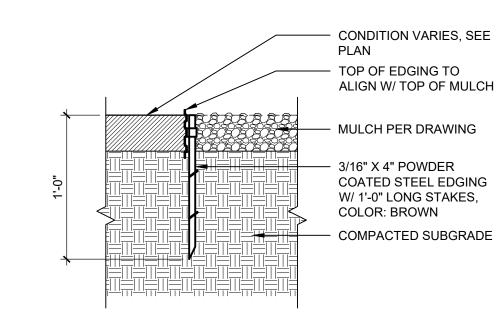

STEEL EDGING 1 1/2" = 1'-0"

PERICH SABATINI

ARCHITECTURE DESIGN **INSPIRATION**

LOW

HIGH

MED

MED

MED

WATER USE QTY

WATER USE QTY

5.00

5.00

6.00

8.00

MAT. DIA.



ENGINEER

PROJECT

CONSTRUCTION DRAWINGS

REVISIONS

DRAWN BY	BG
REVIEWED BY	SK, MB
DATE	13 APR 2020
PROJECT NO.	19-0093
DRAWING NAME	

PLANTING DETAILS

SHEET NO.

ENGINEER


CONSTRUCTION DOCUMENTS

REVISIONS

AWN BY	JK
VIEWED BY	SMM
TE	12 APR 2020
OJECT NO.	19-0093
AWING NAME	

GRADING & DRAINAGE PLAN

SHEET NO. G101

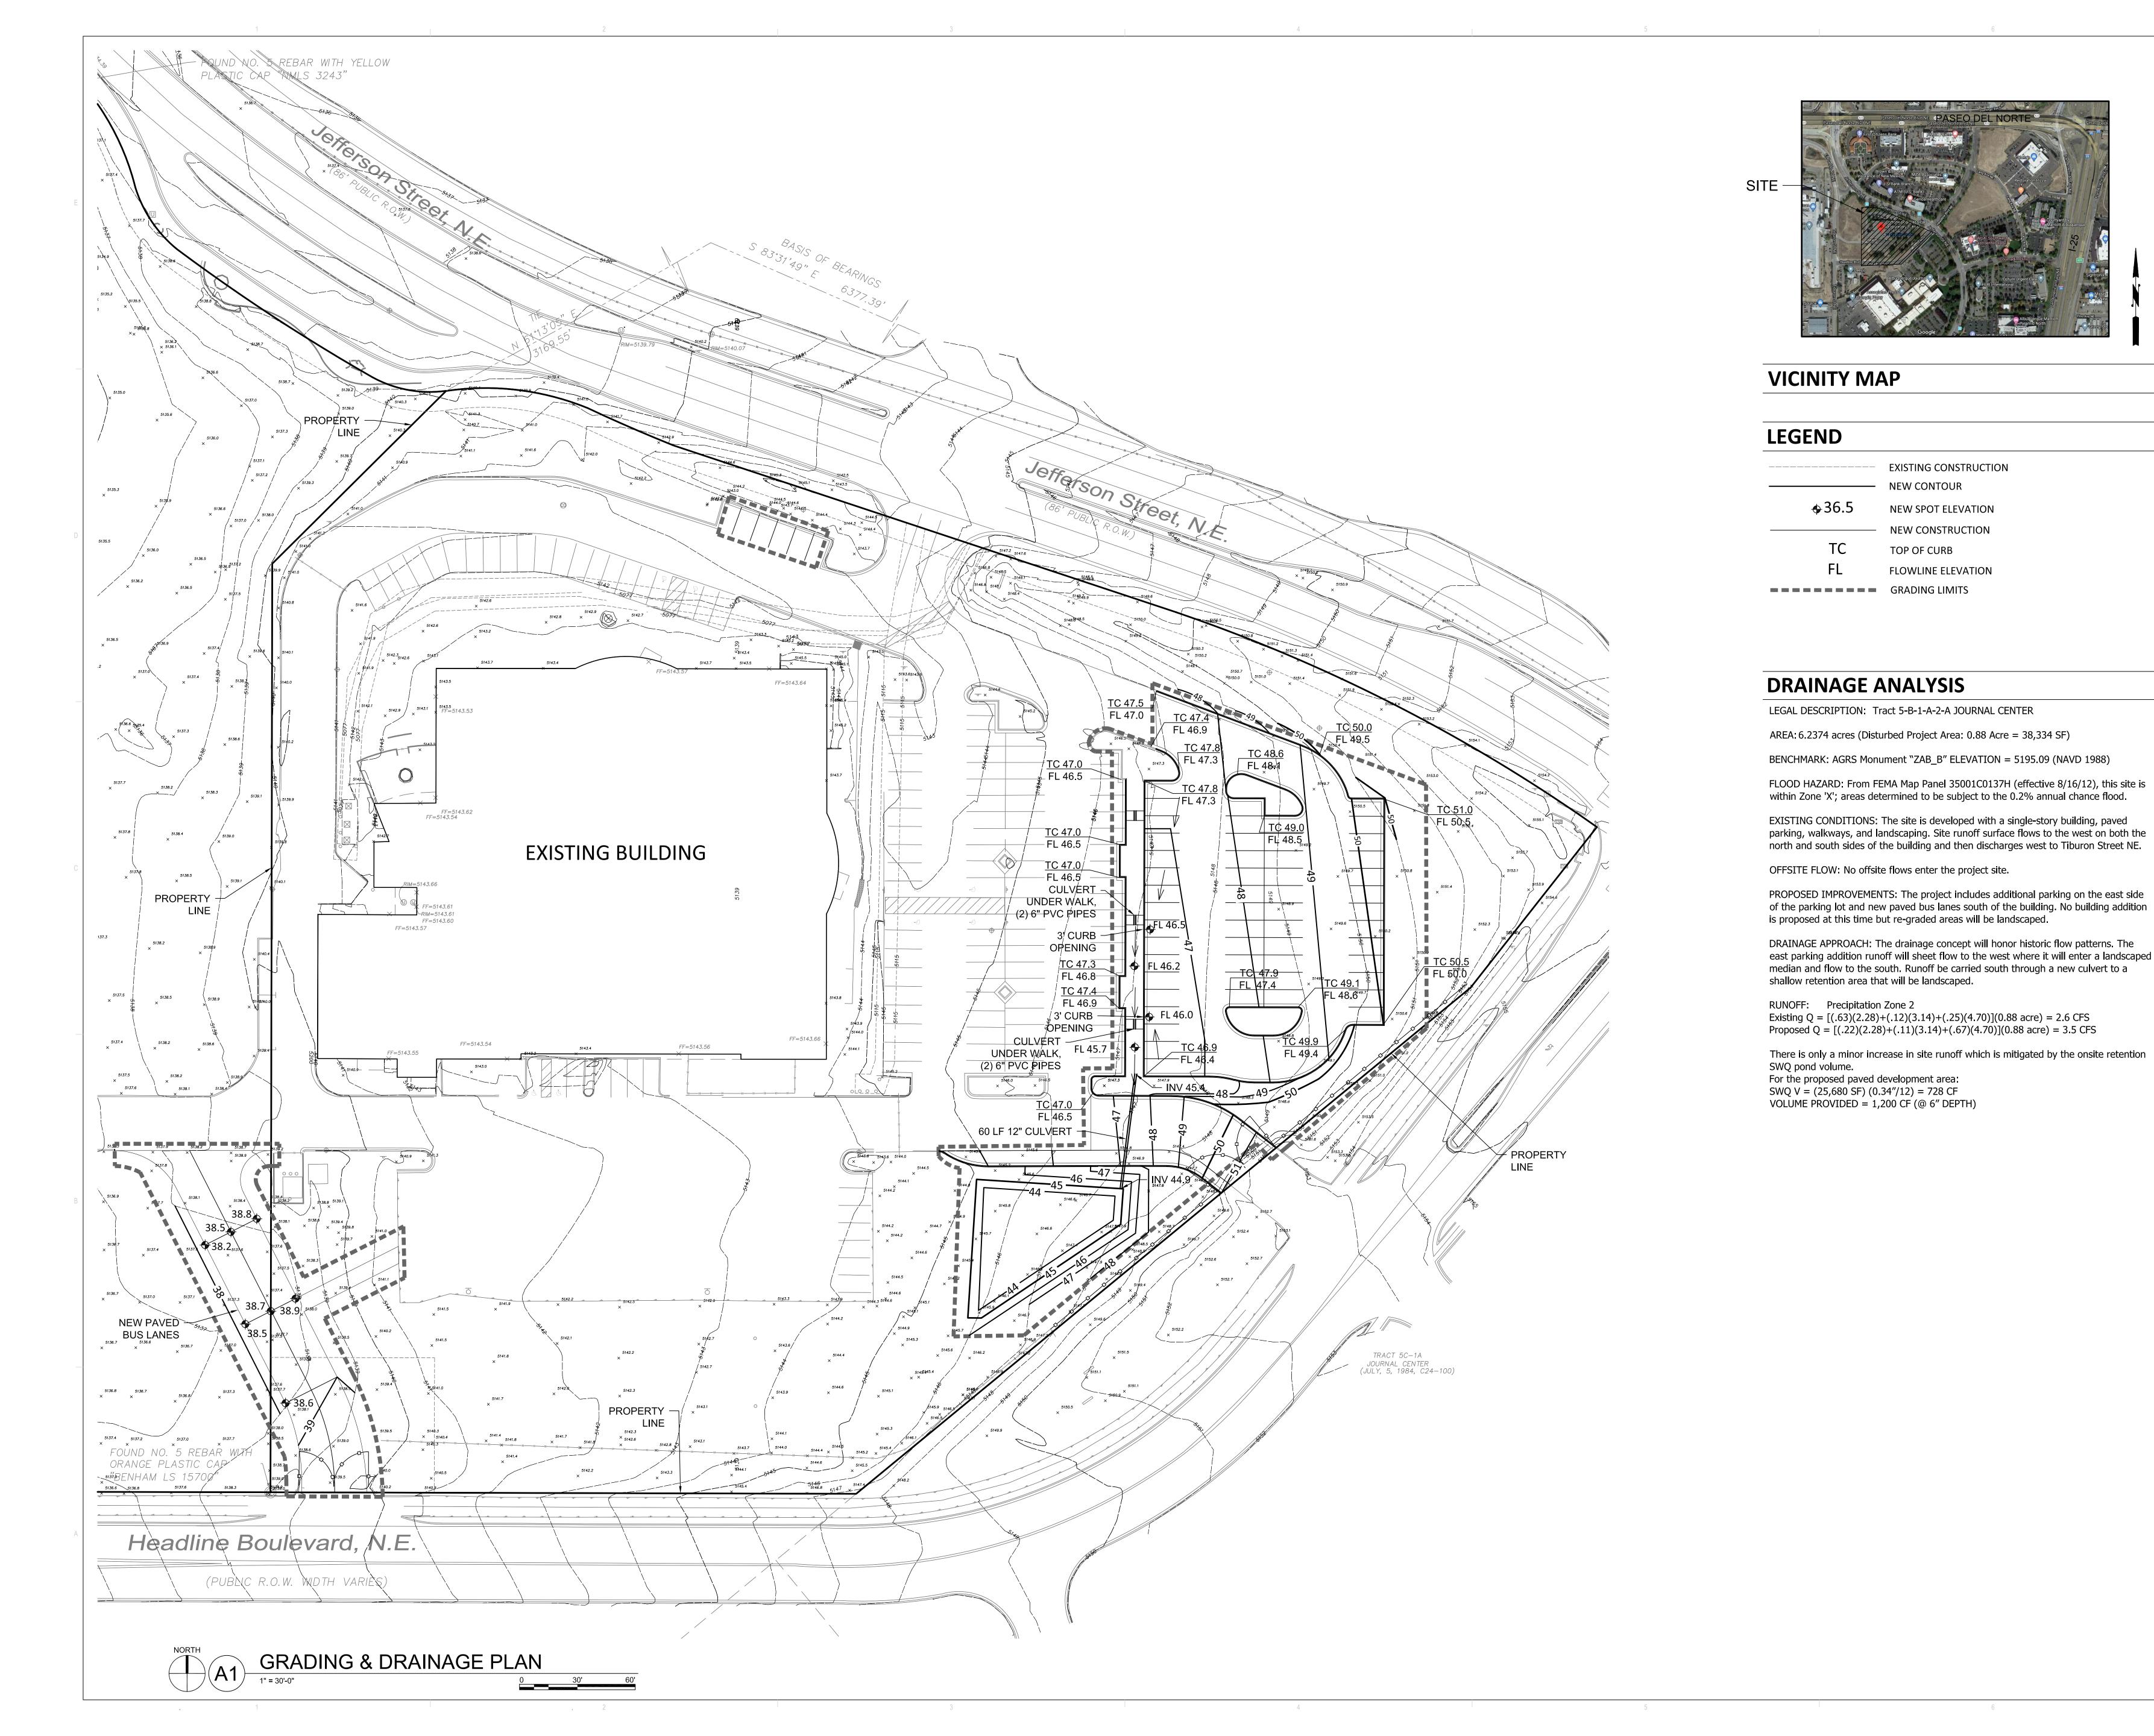




VICINITY MAP

PARKING CALCULATIONS


EXISTING PARKING = 151 SPACES EXISTING ADA PARKING = 8 SPACES PARKING REMOVED = 44 SPACES ADDITIONAL PARKING = 59 SPACES

166 SPACES TOTAL PARKING = REQUIRED ADA PARKING = 8 SPACES NET GAIN PARKING = 15 SPACES (9.9% CHANGE)

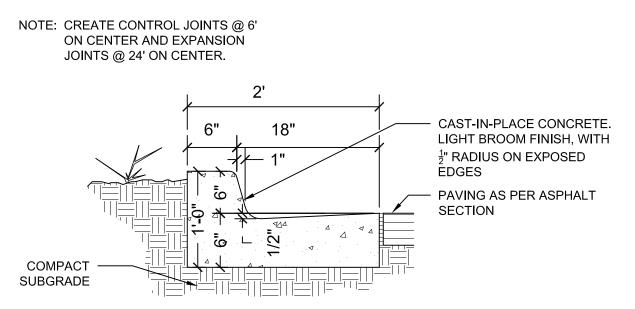

CONCRETE CURB & GUTTER

SCALE: NOT TO SCALE

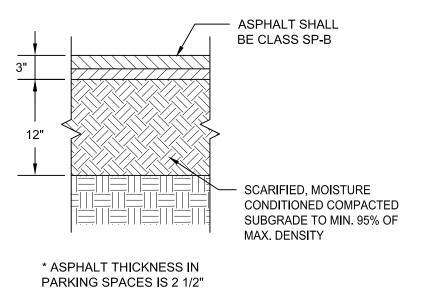

ASPHALT SECTION

SCALE: NOT TO SCALE

DRAWN BY REVIEWED BY DATE
PROJECT NO. 12 APR 2020 19-0093 DRAWING NAME

> TRAFFIC CIRCULATION LAYOUT PLAN


SHEET NO.

DEKKER PERICH SABATINI

INSPIRATION

ARCHITECTURE


DESIGN

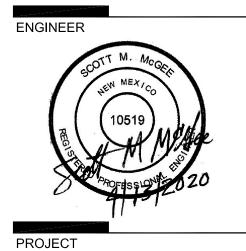

CONSTRUCTION DOCUMENTS

REVISIONS

G110

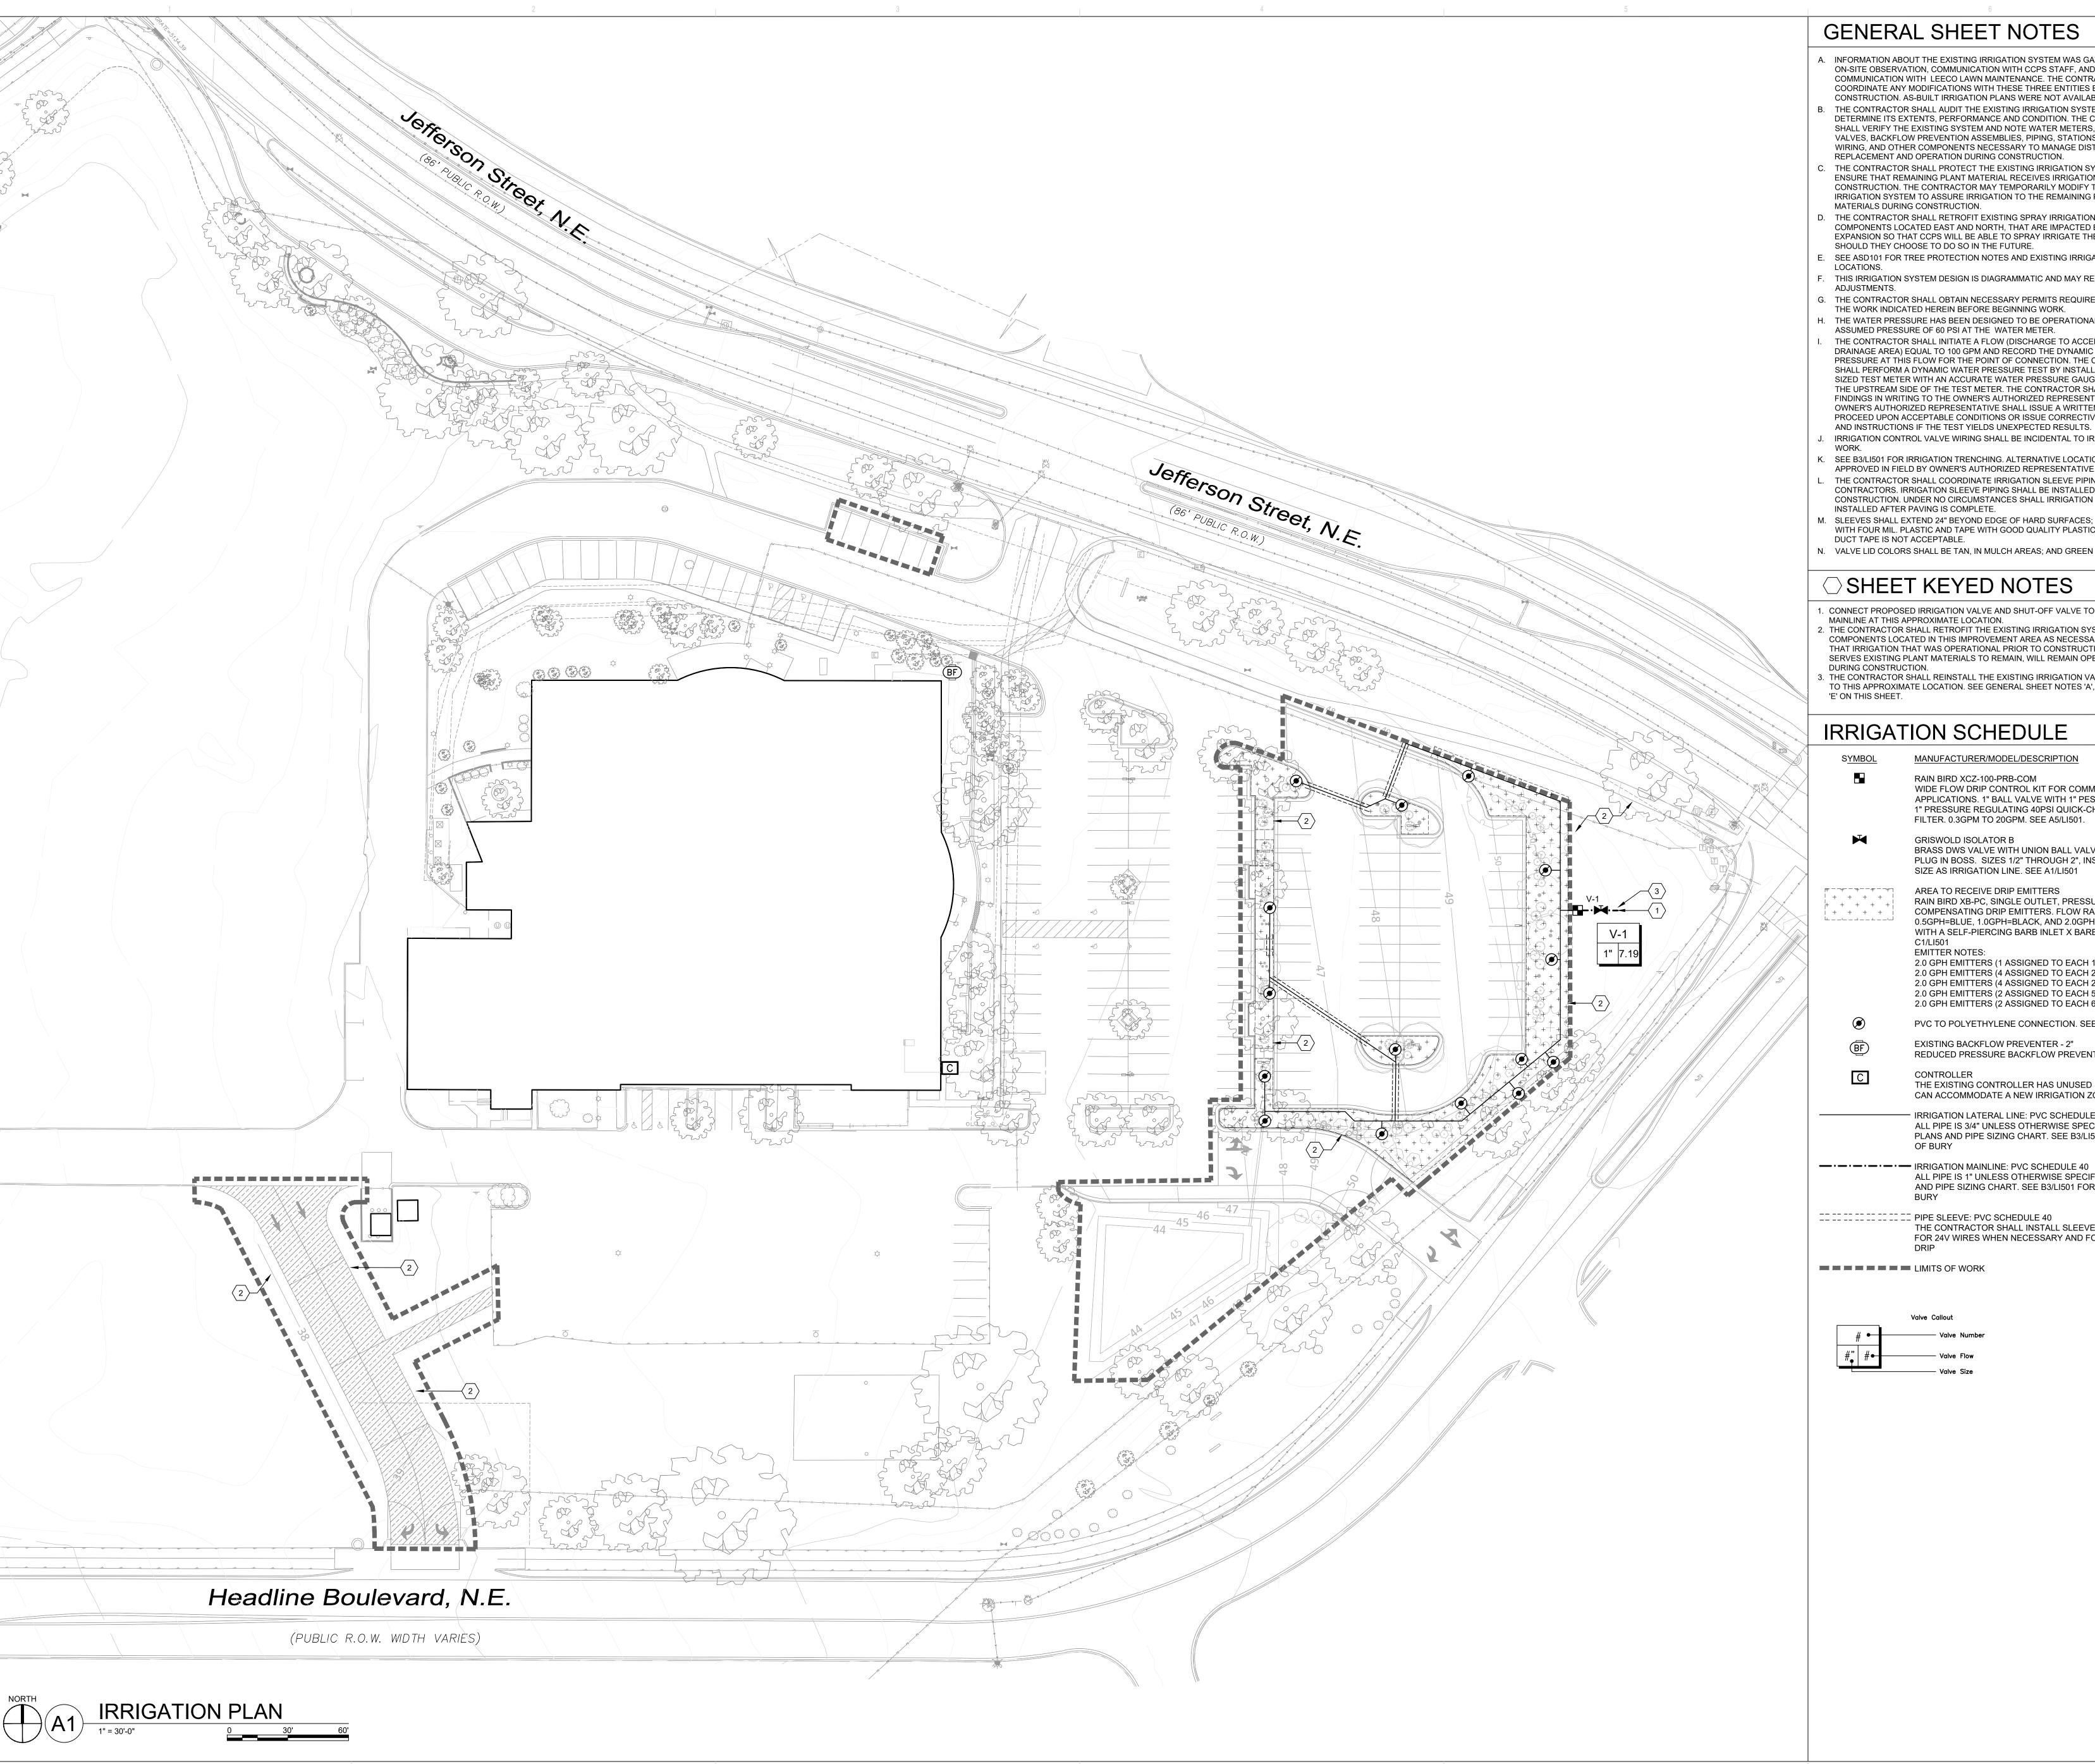

GENERAL SHEET NOTES

- A. INFORMATION ABOUT THE EXISTING IRRIGATION SYSTEM WAS GATHERED BY ON-SITE OBSERVATION, COMMUNICATION WITH CCPS STAFF, AND COMMUNICATION WITH LEECO LAWN MAINTENANCE. THE CONTRACTOR SHALL COORDINATE ANY MODIFICATIONS WITH THESE THREE ENTITIES BEFORE CONSTRUCTION. AS-BUILT IRRIGATION PLANS WERE NOT AVAILABLE.
- B. THE CONTRACTOR SHALL AUDIT THE EXISTING IRRIGATION SYSTEM TO DETERMINE ITS EXTENTS, PERFORMANCE AND CONDITION. THE CONTRACTOR SHALL VERIFY THE EXISTING SYSTEM AND NOTE WATER METERS, SHUT-OFF VALVES, BACKFLOW PREVENTION ASSEMBLIES, PIPING, STATIONS, CONTROLLER WIRING, AND OTHER COMPONENTS NECESSARY TO MANAGE DISTURBANCE, REPLACEMENT AND OPERATION DURING CONSTRUCTION.
- THE CONTRACTOR SHALL PROTECT THE EXISTING IRRIGATION SYSTEM TO ENSURE THAT REMAINING PLANT MATERIAL RECEIVES IRRIGATION DURING CONSTRUCTION. THE CONTRACTOR MAY TEMPORARILY MODIFY THE EXISTING IRRIGATION SYSTEM TO ASSURE IRRIGATION TO THE REMAINING PLANT
- MATERIALS DURING CONSTRUCTION. D. THE CONTRACTOR SHALL RETROFIT EXISTING SPRAY IRRIGATION SYSTEM COMPONENTS LOCATED EAST AND NORTH, THAT ARE IMPACTED BY THE EXPANSION SO THAT CCPS WILL BE ABLE TO SPRAY IRRIGATE THESE AREAS,
- SHOULD THEY CHOOSE TO DO SO IN THE FUTURE. E. SEE ASD101 FOR TREE PROTECTION NOTES AND EXISTING IRRIGATION
- THIS IRRIGATION SYSTEM DESIGN IS DIAGRAMMATIC AND MAY REQUIRE FIELD
- ADJUSTMENTS. G. THE CONTRACTOR SHALL OBTAIN NECESSARY PERMITS REQUIRED TO PERFORM
- H. THE WATER PRESSURE HAS BEEN DESIGNED TO BE OPERATIONAL FOR AN ASSUMED PRESSURE OF 60 PSI AT THE WATER METER. THE CONTRACTOR SHALL INITIATE A FLOW (DISCHARGE TO ACCEPTABLE
- DRAINAGE AREA) EQUAL TO 100 GPM AND RECORD THE DYNAMIC WATER PRESSURE AT THIS FLOW FOR THE POINT OF CONNECTION. THE CONTRACTOR SHALL PERFORM A DYNAMIC WATER PRESSURE TEST BY INSTALLING A PROPERLY SIZED TEST METER WITH AN ACCURATE WATER PRESSURE GAUGE ATTACHED TO THE UPSTREAM SIDE OF THE TEST METER. THE CONTRACTOR SHALL REPORT HIS FINDINGS IN WRITING TO THE OWNER'S AUTHORIZED REPRESENTATIVE. THE OWNER'S AUTHORIZED REPRESENTATIVE SHALL ISSUE A WRITTEN NOTICE TO PROCEED UPON ACCEPTABLE CONDITIONS OR ISSUE CORRECTIVE MEASURES
- IRRIGATION CONTROL VALVE WIRING SHALL BE INCIDENTAL TO IRRIGATION
- (. SEE B3/LI501 FOR IRRIGATION TRENCHING. ALTERNATIVE LOCATIONS TO BE APPROVED IN FIELD BY OWNER'S AUTHORIZED REPRESENTATIVE. THE CONTRACTOR SHALL COORDINATE IRRIGATION SLEEVE PIPING WITH PAVING CONTRACTORS. IRRIGATION SLEEVE PIPING SHALL BE INSTALLED DURING SITE CONSTRUCTION. UNDER NO CIRCUMSTANCES SHALL IRRIGATION SLEEVES BE
- M. SLEEVES SHALL EXTEND 24" BEYOND EDGE OF HARD SURFACES; WRAP ENDS WITH FOUR MIL. PLASTIC AND TAPE WITH GOOD QUALITY PLASTIC TAPE. GRAY
- DUCT TAPE IS NOT ACCEPTABLE. N. VALVE LID COLORS SHALL BE TAN, IN MULCH AREAS; AND GREEN ON TURF AREAS.

SHEET KEYED NOTES

. CONNECT PROPOSED IRRIGATION VALVE AND SHUT-OFF VALVE TO EXISTING MAINLINE AT THIS APPROXIMATE LOCATION. . THE CONTRACTOR SHALL RETROFIT THE EXISTING IRRIGATION SYSTEM COMPONENTS LOCATED IN THIS IMPROVEMENT AREA AS NECESSARY TO ENSURE THAT IRRIGATION THAT WAS OPERATIONAL PRIOR TO CONSTRUCTION, AND THAT SERVES EXISTING PLANT MATERIALS TO REMAIN, WILL REMAIN OPERATIONAL DURING CONSTRUCTION.

THE CONTRACTOR SHALL REINSTALL THE EXISTING IRRIGATION VALVES TO REMAIN TO THIS APPROXIMATE LOCATION. SEE GENERAL SHEET NOTES 'A', 'B', 'C', 'D', AND 'E' ON THIS SHEET.

IRRIGATION SCHEDULE

MANUFACTURER/MODEL/DESCRIPTION

RAIN BIRD XCZ-100-PRB-COM WIDE FLOW DRIP CONTROL KIT FOR COMMERCIAL APPLICATIONS. 1" BALL VALVE WITH 1" PESB VALVE AND 1" PRESSURE REGULATING 40PSI QUICK-CHECK BASKET FILTER. 0.3GPM TO 20GPM. SEE A5/LI501.

> GRISWOLD ISOLATOR B BRASS DWS VALVE WITH UNION BALL VALVE. INCLUDES PLUG IN BOSS. SIZES 1/2" THROUGH 2", INSTALL SAME

SIZE AS IRRIGATION LINE. SEE A1/LI501 AREA TO RECEIVE DRIP EMITTERS RAIN BIRD XB-PC, SINGLE OUTLET, PRESSURE COMPENSATING DRIP EMITTERS. FLOW RATES OF

0.5GPH=BLUE, 1.0GPH=BLACK, AND 2.0GPH=RED. COMES WITH A SELF-PIERCING BARB INLET X BARB OUTLET. SEE **EMITTER NOTES:** 2.0 GPH EMITTERS (1 ASSIGNED TO EACH 1 GAL SHRUB)

2.0 GPH EMITTERS (4 ASSIGNED TO EACH 2.5" CAL TREÉ) 2.0 GPH EMITTERS (4 ASSIGNED TO EACH 24" BOX TREE) 2.0 GPH EMITTERS (2 ASSIGNED TO EACH 5 GAL SHRUB) 2.0 GPH EMITTERS (2 ASSIGNED TO EACH 6' HT TREE) PVC TO POLYETHYLENE CONNECTION. SEE A3/LI501

EXISTING BACKFLOW PREVENTER - 2"

REDUCED PRESSURE BACKFLOW PREVENTER

THE EXISTING CONTROLLER HAS UNUSED STATIONS AND CAN ACCOMMODATE A NEW IRRIGATION ZONE.

- IRRIGATION LATERAL LINE: PVC SCHEDULE 40 ALL PIPE IS 3/4" UNLESS OTHERWISE SPECIFIED ON PLANS AND PIPE SIZING CHART. SEE B3/LI501 FOR DEPTH

ALL PIPE IS 1" UNLESS OTHERWISE SPECIFIED ON PLANS AND PIPE SIZING CHART. SEE B3/LI501 FOR DEPTH OF


TITE TO THE STREET PIPE STREET. THE CONTRACTOR SHALL INSTALL SLEEVE PIPES ONLY FOR 24V WIRES WHEN NECESSARY AND FOR 3/4" POLY

LIMITS OF WORK

DEKKER PERICH SABATINI

ARCHITECTURE DESIGN

ARCHITECT

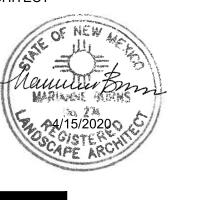

ENGINEER

PROJECT

CONSTRUCTION

DRAWINGS REVISIONS

DRAWN BY **REVIEWED BY** 13 APR 2020 DATE PROJECT NO. 19-0093 DRAWING NAME

IRRIGATION PLAN

LI101

CONSTRUCTION

DRAWINGS REVISIONS

DRAWN BY

SK, MB REVIEWED BY DATE 13 APR 2020 19-0093 PROJECT NO. DRAWING NAME

IRRIGATION DETAILS

SHEET NO. LI501

A. PLACE EMITTERS ON SLOPES BY ADJUSTING THE SPACING OF THE EMITTERS TOWARDS THE HIGH SIDE OF THE SLOPE. B. THE CONTRACTOR SHALL ENSURE THAT ONLY THE DRIP EMITTER IS VISIBLE ABOVE THE MULCH MATERIAL. C. THE CONTRACTOR SHALL SEE SPECIFICATIONS FOR ADDITIONAL PRODUCT AND INSTALLATION INFORMATION. D. INSTALL ON-SURFACE DRIPLINE FLUSH POINT AT ENDS, SEE C3/LI501. 1. 3/4" POLY DRIP TUBING (TYPICAL) MAXIMUM LENGTH OF RUN SHALL BE 50' OR

2. 1/4" BARBED CONNECTOR AT EACH CONNECTION (TYPICAL)

3. 1/4" POLY (OR VINIL) DISTRIBUTION TUBING (TYPICAL). NOTES: USE ONLY ONE EMITTER PER RUN OF TUBING. 1/4" POLY TUBING 'S MAXIMUM LENGTH OF RUN SHALL BE 10' OR LESS

4. DRIP EMITTER (TYPICAL). SPACE EQUALLY WITHIN WETTED PATTERN COVERAGE/ROOT ZONE

5. SHRUB TRUNK/STEM 6. EMITTER DRIP COVERAGE

1 FINISH GRADE

5 PVC MAIN LINE

(7) FROST DEPTH LINE

2 DETECTABLE LOCATOR TAPE

4) DIRECT BURIAL LOW VOLTAGE CONTROL WIRES


(8) EXCAVATED MATERIAL SHALL BE FINELY SCREENED


(6) NON-PRESSURIZED LINE (LATERAL LINE)


WITH NO ROCKS LARGER THAN $\frac{1}{2}$ "

(3) PAVEMENT, SEE PLANS

7. WETTED PATTERN COVERAGE/ ROOT ZONE

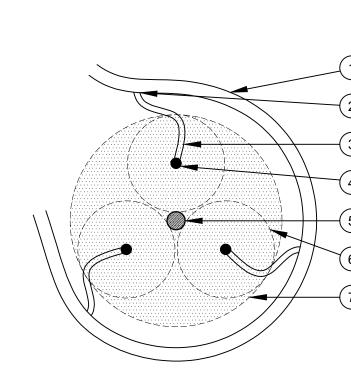

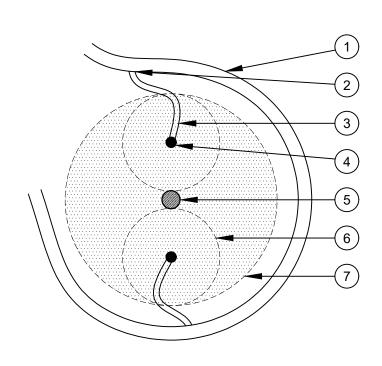

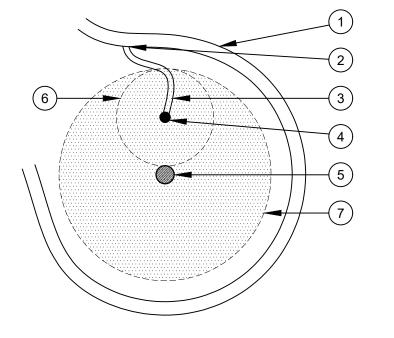

24" MIN.

DRIP EMITTER LAYOUT NOT TO SCALE

IN ORDER TO DIRECT FLUSHED WATER OUTSIDE VALVE BOX.

1. ALLOW A MINIMUM OF 6-INCHES OF DRIPLINE TUBING IN VALVE BOX

6 7 8 9 10

ON-SURFACE DRIPLINE FLUSH POINT

1 MULCH (2) FLUSH CAP FOR EASY FIT (3) EASY FIT COUPLING: RAIN BIRD MDCFCOUP

(4) EMITTER BOX WITH COVER. COLORS: TAN

(5) RAIN BIRD XF BLANK TUBING

(6) FINISH GRADE

7 PVC EXHAUST HEADER 8 PVC SCH 40 TEE OR EL


9 BARB X MALE FITTING: RAIN BIRD XFF-MA FITTING (TYPICAL)

00 ON-SURFACE DRIPLINE: RAIN BIRD XF SERIES DRIPLINE POTABLE: XFD DRIPLINE

(11) 3-INCH MINIMUM DEPTH OF ¾" WASHED GRAVEL

(12) BRICK (1 OF 2)

IRRIGATION TRENCHING

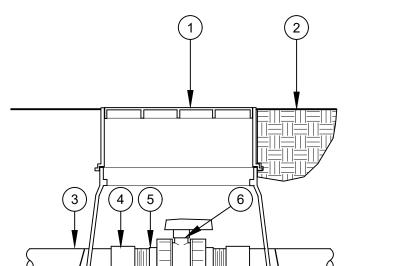

1) 10"X15" RECTANGULAR BOX WITH 6" EXTENSION WITH COVER. COLORS: TAN

2 SET BOX FLUSH TO GRADE


3 PVC MAIN LINE

4 ADAPTER


(5) SCHEDULE 80 THREADED NIPPLE AS REQUIRED

6) ISOLATION BALL VALVE, SEE IRRIGATION PLAN SHEET

7 TWO 6X2X16 CONCRETE BLOCK CAPS, ONE ON EACH SIDE OF BOX

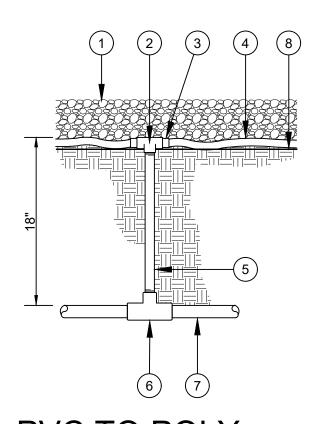

1) MULCH AS PER LANDSCAPE LEGEND (2) LATERAL FITTING - 3/4" OUTLET (FIPT)

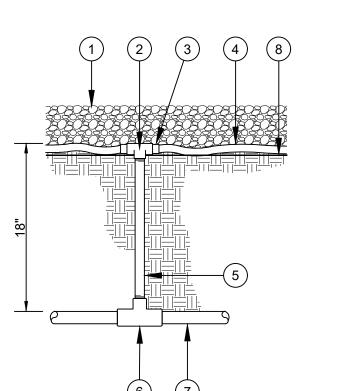

PVC TO POLY

3 SOLVENT WELD PVC TO POLYETHLENE COMPRESSION - TYPE FITTING (4) 3/4" POLYETHYLENE TUBING (5) 3/4" SCH. 40 PVC RISER 6 LATERAL FITTING - 3/4" OUTLET (FIPT) 7 LATERAL PIPE 8 WEED BARRIER FABRIC, SEE LANDSCAPE SHEETS

DRIP CONTROL VALVE KIT

(14) PVC SCH 40 TEE OR ELL (15) MAINLINE PIPE (16) 3-INCH MINIMUM DEPTH OF 3/4-INCH WASHED GRAVEL RAINBIRD © DETAIL OPEN SOURCE FREE TO USE (17) PVC SCH 80 NIPPLE, CLOSE (INCLUDED IN XCZ-PRB-100-COM KIT) (18) BRICK (1 OF 4)

1) FINISH GRADE/TOP OF MULCH

9 PVC SCH 40 FEMALE ADAPTOR

(11) PVC SCH 80 NIPPLE (LENGTH AS REQUIRED)

(10) LATERAL PIPE

(12) PVC SCH 40 ELL

6 ID TAG

2 VALVE BOX WITH COVER. COLORS: TAN

3) 30-INCH LINEAR LENGTH OF WIRE, COILED

(4) WATERPROOF CONNECTION: RAIN BIRD DB SERIES

(5) 1-INCH BALL VALVE (INCLUDED IN XCZ-PRB-100-COM KIT)

7 REMOTE CONTROL VALVE: RAIN BIRD PESB (INCLUCED IN XCZ-PRB-100-COM KIT)

8 PRESSURE REGULATING QUICK CHECK BASKET FILTER: RAIN BIRD PRB-QKCHK-100 (INCLUDED IN XCZ-PRB-100-COM KIT)

(13) PVC SCH 80 NIPPLE (2-INCH LENGTH, HIDDEN) AND PVC SCH 40 ELL

TRUE UNION BALL/ ISOLATION VALVE

RAINBIRD[©] DETAIL OPEN SOURCE FREE TO USE

RAINBIRD[©] DETAIL OPEN SOURCE FREE TO USE

GENERAL SHEET NOTES

- A. THE CONTRACTOR SHALL FAMILIARIZED HIMSELF WITH THE EXISTING CONDITIONS IN ORDER TO ALLOW HIM TO SUBMIT A COMPLETE BID FOR REMOVALS WITHIN THE SCOPE OF THE DRAWINGS. ANY QUESTIONS ARISING DURING THE BID PERIOD IN REGARD TO THE INTENT OF THE DRAWINGS SHALL BE BROUGHT UP FOR CLARIFICATION WITH ENGINEER.
- B. IT SHALL BE THIS CONTRACTOR'S RESPONSIBILITY TO FIELD VERIFY THE EXTENT OF REMOVALS PRIOR TO BID, WHICH MAY AFFECT HIS BID.
- C. WHERE NECESSARY, THE CONTRACTOR SHALL REMOVE AND/OR RECONNECT CIRCUIT RUNS TO MAINTAIN CONTINUITY OF CIRCUIT.
- D. THE OWNER SHALL HAVE FIRST SALVAGE RIGHTS TO ALL REMOVAL EQUIPMENT. CONTACT THE OWNER'S REPRESENTATIVE FOR THE PROPER DISPOSAL OF ALL EQUIPMENT.
- E. COORDINATE SITE POLE LUMINAIRE LOCATION WITH LANDSCAPE AND TREES BEFORE ROUGH-IN.

ARCHITECT

DESIGN

ARCHITECTURE

INSPIRATION

DEKKER

PERICH

SABATINI



PROJECT

SHEET KEYED NOTES

- INSTALL NEW LED HEADS IN EXISTING POLE. REFER TO LUMINAIRE SCHEDULE FOR LUMINARIES SPECIFICATION. PULL NEW WIRE THROUGH POLE AS NEEDED FOR NEW HEAD INSTALLATION.
- EXTEND NEW #10s CONDUCTORS IN 3/4" CONDUIT FROM EXISTING SITE POLE CIRCUIT. IDENTIFY BEST CONNECTION POINT ON SITE PER EXISTING CONDITIONS, INTERCEPT AND EXTEND CIRCUIT TO NEW LIGHTS AS NEEDED.
- PROVIDE NEW SURFACE MOUNT PANELBOARD WHERE OLD PANELBOARD WAS LOCATED. EXTEND AND RE-USE EXISTING FEEDER AND TERMINATE IN NEW PANEL. ALL EXISTING 20A BRANCH CIRCUITS WILL BE RECONNECTED TO NEW PANELBOARD. REFER TO PANEL SCHEDULE FOR ADDITIONAL INFORMATION. PANELBOARD LOCATION SHOWN IS APPROXIMATE, NEW PANELBOARD SHALL BE INSTALLED WHERE OLD PANELBOARD WAS LOCATED IN HALLWAY BETWEEN MUSIC CLASSROOMS.
- EXISTING SITE LIGHTING HOMERUN BACK TO MAIN ELECTRICAL ROOM TO REMAIN. EXISTING PARKING LOT ARE BEING CONTROLLED BY ROOF MOUNTED PHOTOCELL SYSTEM. EXISTING CONTROLS ARE TO REMAIN.
- RUN BRANCH CIRCUIT(S) FOR CAR CHARGING STATION EXPOSED THROUGH CLASSROOM AND DOWN TO AN UNDERGROUND DISTRIBUTION, ROUTING AS SHOWN IS APPROXIMATE - INSTALL CONDUIT AS CONCEALED AS POSSIBLE PER EXISTING CONDITIONS.
- 6. ELECTRIC VEHICLE (EV) CHARGING STATION PROVIDED BY OTHERS. PROVIDE #8 BONDING JUMPER AND GROUNDING ELECTRODE SYSTEM PER N.M. NEC ART. 250. COORDINATE EXACT CHARGING STATION LOCATION WITH ARCHITECT AND OWNER.
- PROVIDE 3#8 & 1#10GND IN 3/4"CONDUIT (EACH) FOR ELECTRIC CAR CHARGING STATION. COORDINATE EXACT DISCONNECT LOCATION WITH EXISTING CONDITIONS.
- 8. PROVIDE TYPE "D" HANDHOLE / PULLBOX. INSTALL FLUSH IN CONCRETE/GRADING. COORDINATE LOCATION WITH LANDSCAPE AND SITÉ. REFER TO DETAIL 1 ON SHEET E-601 FOR HANDHOLE DETAIL.
- 9. PROVIDE NEW IN-CASE WEATHERPROOF RECEPTACLE MOUNTED TO UNISTRUT.
- 10. PROVIDE ASPHALT TRENCHING AND REPAIRS FOR NEW POLE AND UNDERGROUND BRANCH CIRCUIT INSTALLATION.

100% CONSTRUCTION DRAWINGS


DRAWN BY	-
REVIEWED BY	-
DATE	13 APR 2020
PROJECT NO.	19-0093
DRAWING NAME	

ELECTRICAL SITE PLAN


ES-101

08 ADDITONAL PERTINENT INFORMATION

A. Off-Street Parking Clarification Exhibit

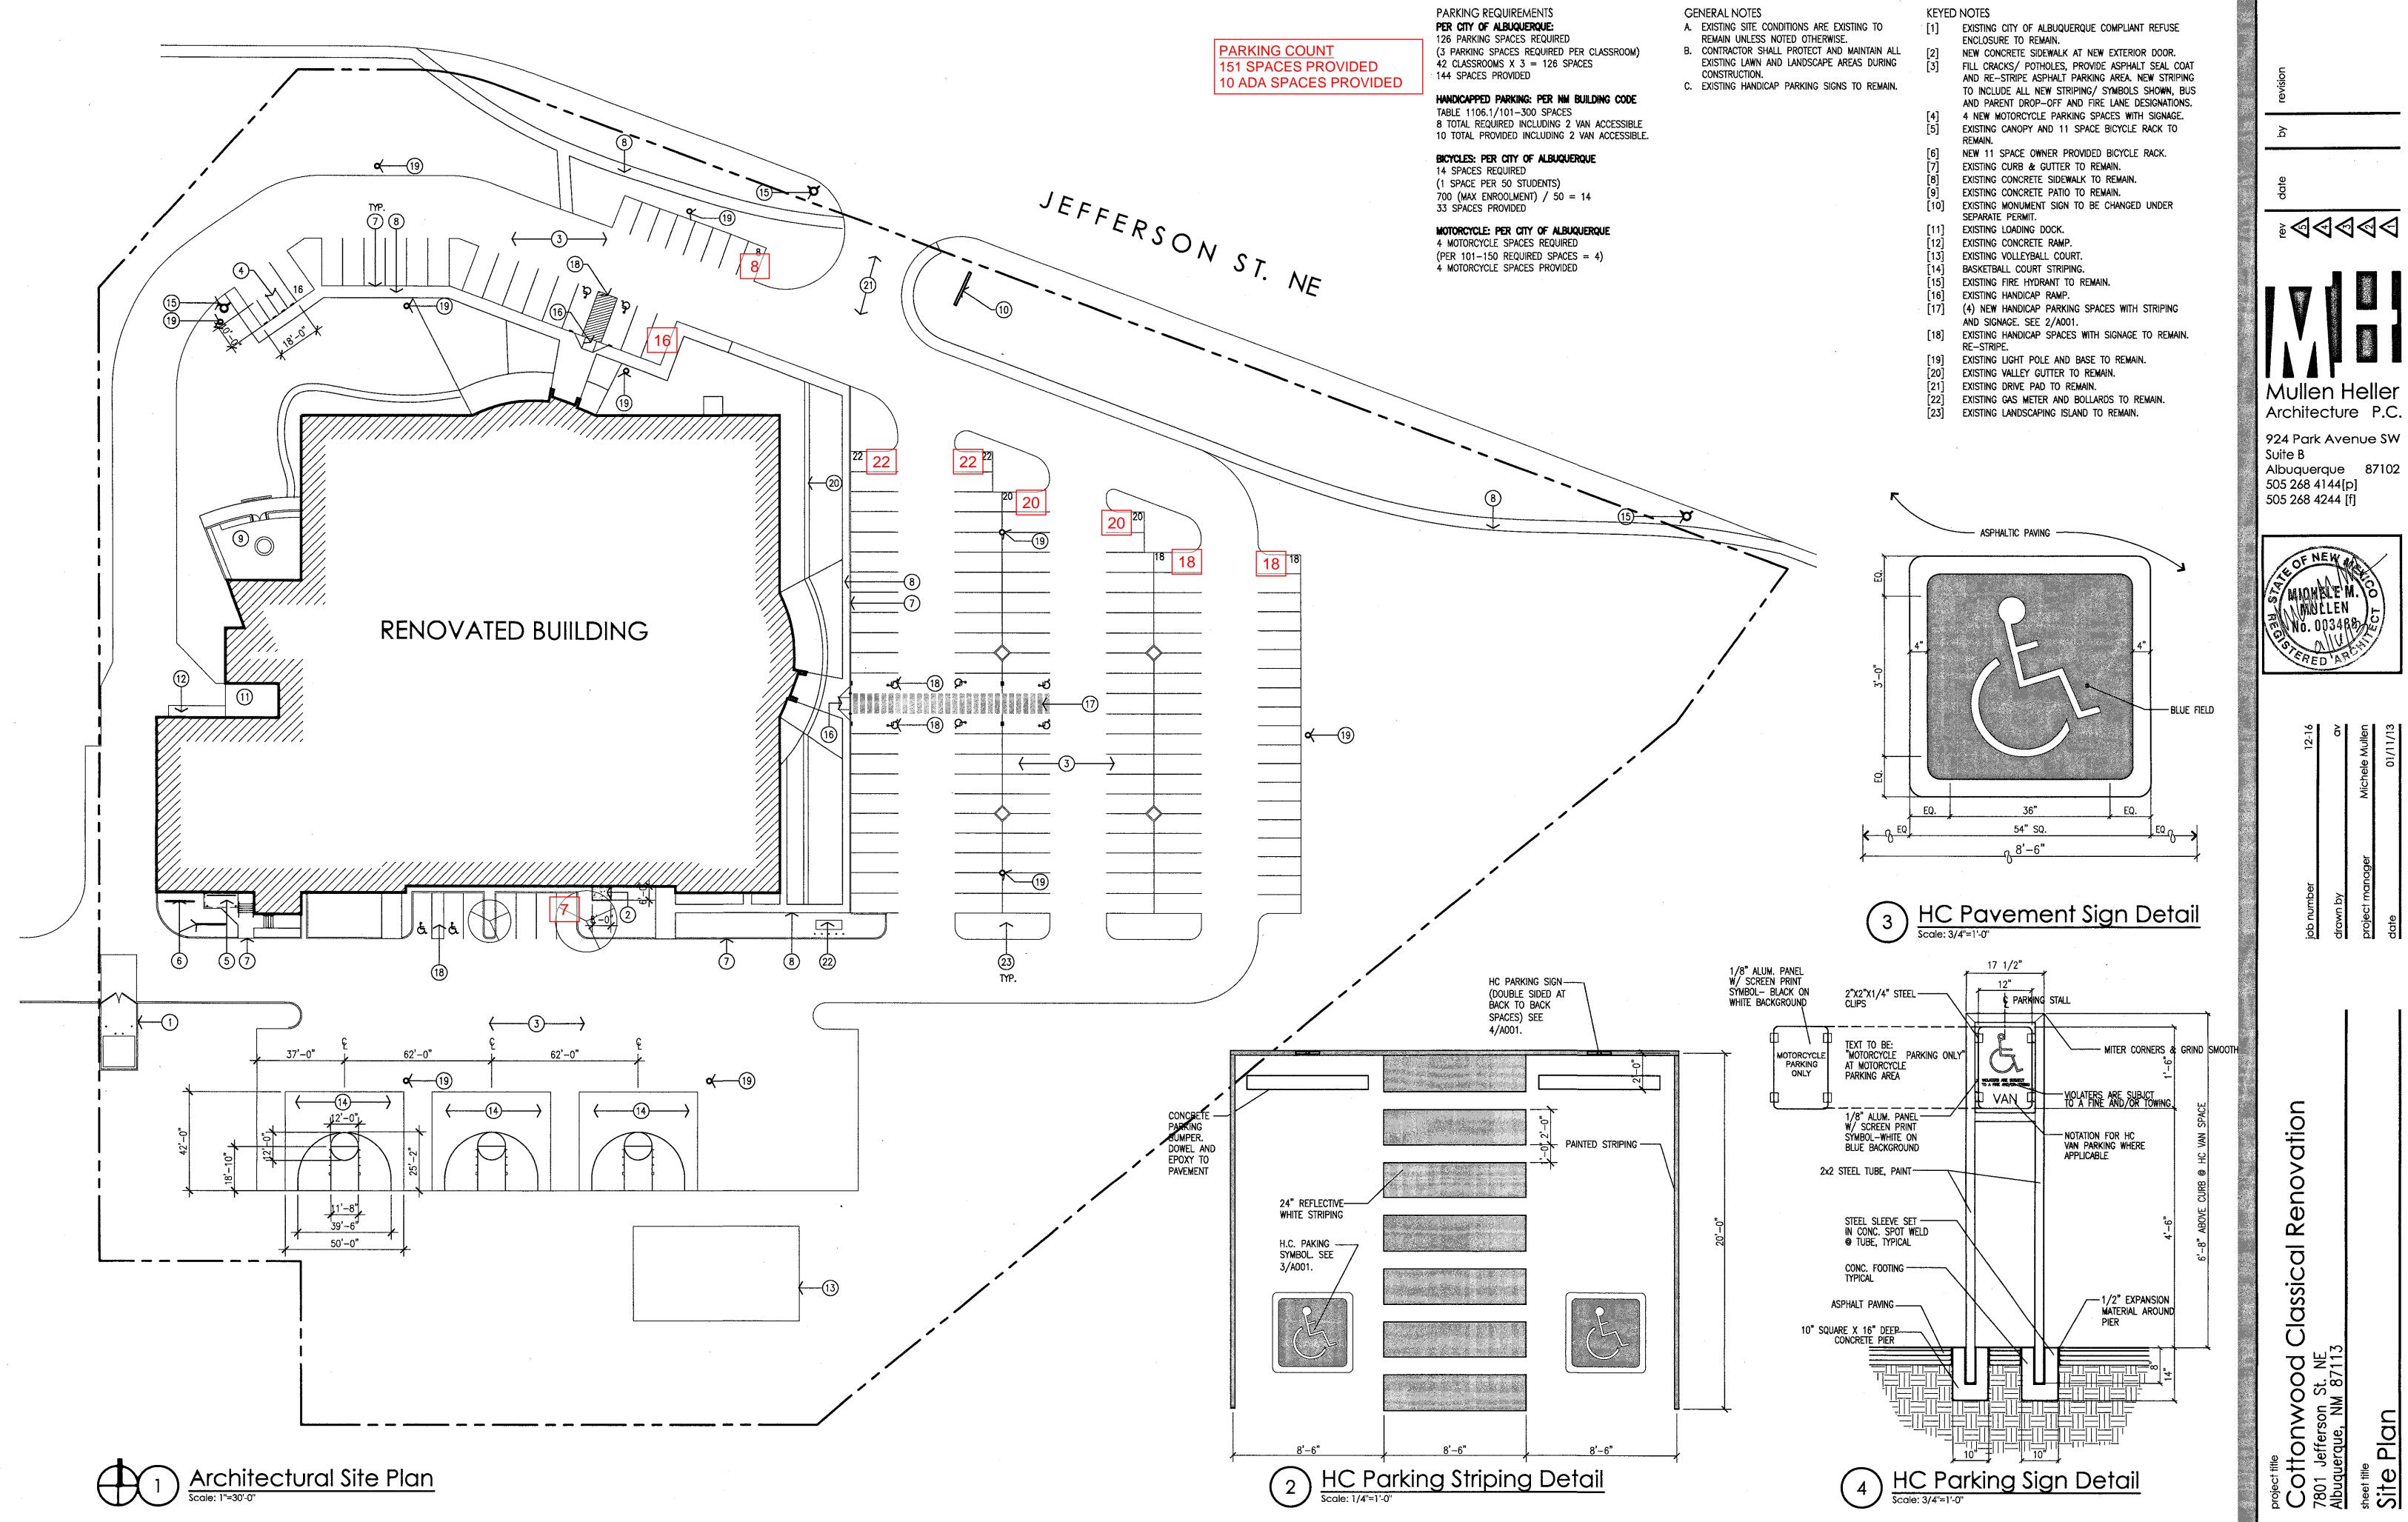

Architecture P.C. 924 Park Avenue SW

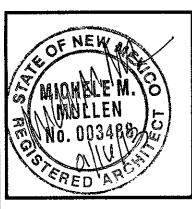

A001

08 ADDITONAL PERTINENT INFORMATION

B. Journal Center ARC Approval

Brian Griffith

From: Christopher R. Gunning

Sent: Thursday, April 16, 2020 12:12 PM **To:** Brian Griffith; LAH7575@aol.com

Cc: Sanjay S. Kadu; Mimi Burns; Courtney L. McKelvey

Subject: RE: Cottonwood Classical - 90% Reviews

Brian,

Lowell Hare and I have reviewed the memo and revised drawings submitted April 15, 2020, which were provided in response to the Journal Center Corporation Architectural Review Committee's written comments. We find the explanations and drawing revisions acceptable relative to the Journal Center's Design Standards. Therefore, on behalf of the JCC-ARC we approve the revised drawings as submitted. Please accept this email as our approval letter for use in submitting to the City of Albuquerque for Administrative Amendment to the approved Site Development Plan.

For the Journal Center Corporation Architectural Review Committee,



Christopher R. Gunning, LEED AP Registered Architect, Oklahoma #2751 Dekker/Perich/Sabatini 505.761.9700 / dpsdesign.org

From: Brian Griffith <BrianG@dpsdesign.org> Sent: Wednesday, April 15, 2020 9:22 PM

To: Christopher R. Gunning <chrisg@dpsdesign.org>; LAH7575@aol.com

Cc: Sanjay S. Kadu <SanjayK@dpsdesign.org>; Mimi Burns <mimib@dpsdesign.org>; Courtney L. McKelvey

<courtneym@dpsdesign.org>

Subject: RE: Cottonwood Classical - 90% Reviews

Hello Chris and Lowell,

Attached, please find a memo detailing our responses to your comments along with the pertinent sheets. If you find these changes acceptable, please issue approval of the project at your earliest convenience. Please call me with any questions or concerns. My cell phone number is (505) 977-3489.

Thank you,

Brian

From: Christopher R. Gunning <chrisg@dpsdesign.org>

Sent: Wednesday, April 8, 2020 2:00 PM

To: Brian Griffith < BrianG@dpsdesign.org; LAH7575@aol.com

Cc: Sanjay S. Kadu <<u>SanjayK@dpsdesign.org</u>>; Mimi Burns <<u>mimib@dpsdesign.org</u>>; Courtney L. McKelvey

<courtneym@dpsdesign.org>

Subject: RE: Cottonwood Classical - 90% Reviews

Brian,

Please find attached a memo with our comments and questions. Please let Lowell or me know if you need any clarification.

Thanks Chris



Christopher R. Gunning, LEED AP Registered Architect, Oklahoma #2751 Dekker/Perich/Sabatini 505.761.9700 / dpsdesign.org

From: Brian Griffith < BrianG@dpsdesign.org>
Sent: Wednesday, April 08, 2020 10:18 AM

To: Christopher R. Gunning <<u>chrisg@dpsdesign.org</u>>; <u>LAH7575@aol.com</u>

Cc: Sanjay S. Kadu <<u>SanjayK@dpsdesign.org</u>>; Mimi Burns <<u>mimib@dpsdesign.org</u>>; Courtney L. McKelvey

<courtneym@dpsdesign.org>

Subject: Re: Cottonwood Classical - 90% Reviews

Thanks Chris. We're submitting this to the city as an Administrative Amendment since the changes to the existing site plan are minor.

Brian

REFERENCE

PROJECT# - 2020-003646

CASE# - SI-2020-00157

FOR ALL DOCUMENTATION

(FINAL SIGN OFF IS STAMPED INCORRECTLY - SI-2020-000157)

G. Delgado UD&D