



DEVELOPMENT REVIEW APPLICATION

Effective 4/17/19

| Please check the appropriate box and | l refer to supp | olemental forms | for subi | mittal requ | uirements. All fe | es must | be paid at the time of | application. | | |
|--|-----------------|-----------------------------|------------|--------------------|-------------------|---------|---|------------------------|--|--|
| Administrative Decisions | De | ecisions Requirir | ng a Pul | blic Meetir | ng or Hearing | Policy | Decisions | | | |
| ☐ Archaeological Certificate (Form P3) | | Site Plan – EPC form P1) | includin | g any Varia | ances – EPC | | option or Amendment of r Facility Plan <i>(Form Z)</i> | Comprehensive | | |
| ☐ Historic Certificate of Appropriateness (Form L) | s – Minor | Master Developn | nent Pla | n <i>(Form P</i> | 1) | | ☐ Adoption or Amendment of Historic Designation (Form L) | | | |
| ☐ Alternative Signage Plan (Form P3) | | Historic Certificat | te of App | oropriatene | ess – Major | □ Am | ☐ Amendment of IDO Text (Form Z) | | | |
| ☑ Minor Amendment to Site Plan (Form | P3) 🗆 | Demolition Outsi | de of HF | PO (Form L | -) | ☐ Anr | ☐ Annexation of Land (Form Z) | | | |
| ☐ WTF Approval (Form W1) | | Historic Design S | Standard | ls and Guid | delines (Form L) | □ Am | endment to Zoning Map | – EPC <i>(Form Z)</i> | | |
| | | Wireless Telecor orm W2) | nmunica | ations Facil | lity Waiver | □ Am | ☐ Amendment to Zoning Map – Council (Form Z) | | | |
| | | | | | | Appea | ıls | | | |
| | | | | | | □ Ded | cision by EPC, LC, ZHE | E, or City Staff (Form | | |
| | | | | | | A) | | | | |
| APPLICATION INFORMATION | | | | | | | | | | |
| Applicant: Molly Mendoza | | | | | | Ph | one: 714-705-1398 | 3 | | |
| Address: 765 The City Dr. #200 | | | 1 | | | | nail: molly.mendoz | a@kimley-horn.c | | |
| City: Orange | | | | State: C | A | Zip | 92868 | | | |
| Professional/Agent (if any): Kimley-H | orn | | | | | Ph | one: | | | |
| Address: | | | 1 | | | En | nail: | | | |
| City: | | | | State: | | Zip |): | | | |
| Proprietary Interest in Site: | | | | List <u>all</u> ov | wners: | | | | | |
| BRIEF DESCRIPTION OF REQUEST | | | | | | | | | | |
| Kimley-Horn Requests an | ammendn | nent to origin | al app | roved s | ite plan for th | ne Tar | get on 2120 Louis | siana Blvd. | | |
| to allow up for sign and fac | cade updat | es. | | | | | | | | |
| SITE INFORMATION (Accuracy of the | existing lega | description is c | rucial! | Attach a s | eparate sheet if | necessa | ary.) | | | |
| Lot or Tract No.: 1007316 | | | | Block: | | Un | it: | | | |
| Subdivision/Addition: | | | | MRGCD Map No.: UPC | | | PC Code: | | | |
| Zone Atlas Page(s): J-19-Z | | Existing Zoning: | MX-H | l | | Pro | Proposed Zoning: | | | |
| # of Existing Lots: | | # of Proposed L | .ots: | | | То | tal Area of Site (acres): | | | |
| LOCATION OF PROPERTY BY STREE | TS | | | | | | | | | |
| Site Address/Street: 2120 Lousiana | a Blvd. | Between: Lous | siana E | Blvd | | and: U | ptown Loop Rd. | | | |
| CASE HISTORY (List any current or p | rior project a | nd case number(| (s) that r | may be re | levant to your re | quest.) | | | | |
| 4 4- | | | | | | | | | | |
| Signature: | | | | | | Da | te: May 11, 2020 | | | |
| Printed Name: Molly Mendoza | | | | | | ☑ | Applicant or Agent | | | |
| FOR OFFICIAL USE ONLY | | | | | | | | | | |
| Case Numbers | Action | Fees | 3 | | Case Numbers | | Action | Fees | | |
| SI-2020-00271 | MA | \$50 | | | | | | | | |
| | | | | | | | | | | |
| | | | | | | | | | | |
| Meeting/Hearing Date: N/A | | | | | | Fe | e Total: \$50 | | | |
| Staff Signature: Vanana A | Somin | a. | | Date: | 5/12/2020 | Pro | oject # PR-2020 | -003736 | | |


FORM P3: ADMINISTRATIVE DECISIONS AND MINOR AMENDMENTS

A single PDF file of the complete application including all plans and documents being submitted must be emailed to PLNDRS@cabq.gov prior to making a submittal. Zipped files or those over 9 MB cannot be delivered via email, in which case the PDF must be provided on a CD. INFORMATION REQUIRED FOR ALL ADMINISTRATIVE DECISIONS OR AMENDMENTS Letter of authorization from the property owner if application is submitted by an agent Zone Atlas map with the entire site clearly outlined and labeled **ARCHEOLOGICAL CERTIFICATE** Archaeological Compliance Documentation Form with property information section completed Only the information above is required unless the City Archaeologist determines that the application does not qualify for a Certificate of No Effect, in which case a treatment plan prepared by a qualified archaeologist that adequately mitigates any archeological impacts of the proposed development must be submitted and reviewed for a Certificate of Approval per the criteria in IDO Section 14-16-6-5(A)(3)(b) MINOR AMENDMENT TO SITE PLAN - ADMIN, EPC, or DRB Justification letter describing, explaining, and justifying the request per the criteria in IDO Section 14-16-6-4(X)(2) Three (3) copies of all applicable sheets of the approved Site Plan being amended, folded Copy of the Official Notice of Decision associated with the prior approval Three (3) copies of the proposed Site Plan, with changes circled and noted Refer to the Site Plan Checklist for information needed on the proposed Site Plan. Minor Amendments must be within the thresholds established in IDO TABLE 6-4-5. Any amendment beyond these thresholds is considered a Major Amendment and must be processed through the original decision-making body for the request. MINOR AMENDMENT TO SITE DEVELOPMENT PLAN APPROVED PRIOR TO THE EFFECTIVE DATE OF THE IDO ✓ Justification letter describing, explaining, and justifying the request per the criteria in IDO Section 14-16-6-4(Y)(1)(a) Three (3) copies of all applicable sheets of the approved Site Development Plan being amended, folded Copy of the Official Notice of Decision associated with the prior approval Three (3) copies of the proposed Site Development Plan, with changes circled and noted Refer to the Site Plan Checklist for information needed on the proposed Site Plan.

Minor Amendments must be within the thresholds established in IDO TABLE 6-4-5. Any amendment beyond these thresholds is considered a Major Amendment and must be processed through the original decision-making body for the request.

| AL. | TERNATIVE SIGNAGE PLAN |
|-----|--|
| | Proposed Alternative Signage Plan compliant with IDO Section 14-16-5-12(F)(5) |
| | Justification letter describing, explaining, and justifying the request per the criteria in IDO Section 14-16-6-5(F)(4)(c) |
| | Required notices with content per IDO Section 14-16-6-4(K)(6) |
| | Office of Neighborhood Coordination notice inquiry response and proof of emailed notice to affected Neighborhood |
| | Association representatives |
| | Sign Posting Agreement |

| I, the applicant or agent, acknowledge that in scheduled for a public meeting or hearing, if re | | with this application, the application will not be applete. |
|--|---------------|--|
| Signature: | | Date: May 11, 2020 |
| Printed Name: Molly Mendoza | | ☑ Applicant or ☐ Agent |
| FOR OFFICIAL USE ONLY | | |
| Project Number: | Case Numbers | THE PARTY OF THE P |
| PR-2020-003763 | SI-2020-00271 | AL MARKET |
| | - | |
| | - | (1706) |
| Staff Signature: Vanessa A Segui | ra | N E VI |
| Date: 5/12/2020 | | AAAAAAAA |

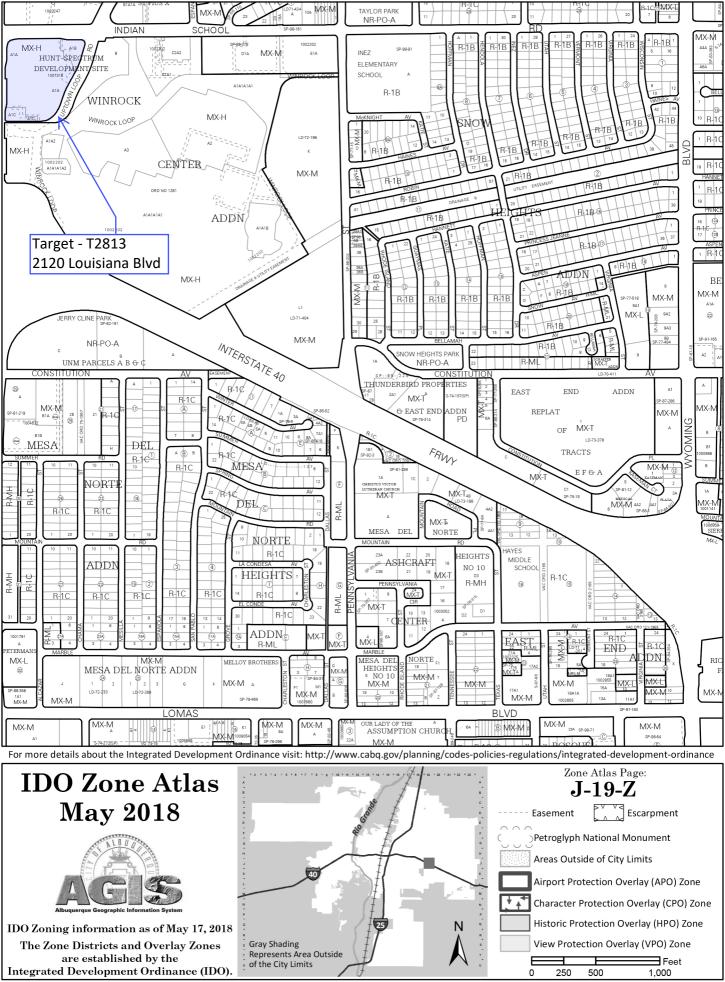

Application for Administrative Amendment Letter of Justification



To: City of Albuquerque,, Planning Department

From: Molly Mendoza

Kimley-Horn and Associates, Inc.

Date: 5/11/2020

Subject: Administrative Amendment for 2120 Louisiana Boulevard, Target T2813

Kimley-Horn on behalf of Target Corporation is submitting an application for an Administrative Amendment replace and update the signage and façade at the 2120 Louisiana Boulevard.

On April 14, 2020, Kimley Horn sent a preliminary sign elevation review to Jay Rodenbeck. The City provided feedback and comments via email on April 28, 2020. The City noted that the site is governed first by the original approved site plan, and second, where the site plan is silent, by the MH-XH Zone and the standards as established in the Integrated Design Ordinance, specifically Section 14-16 Design Standards, 5-12 Sign Standards. Additionally, post-preliminary reviews, staff recommended an application for an Administrative Amendment to the original approved site plan.


The proposed updates to the 2120 Target include the following:

- Replacement of five (5) bullseye signs where size and location will remain the same;
- color replacement for two (2) monument signs where size and location will remain the same and no structural changes will be made;
- replacement of two (2) bullseye signs with lowercase "target" letter stack; and,
- repainting of exterior façade, compatible with existing design styles.

Please see attached site plan and all relative cutsheets for additional information.

Per the City's IDO, buildings within the MX-H zone are allowed a maximum wall signage of no more than fifteen (15) percent of the total façade area. Based on Kimley-Horn's review of existing and proposed signage and because no additional signs are proposed, the signage and façade update is within the City's guidelines and standards. Additionally, all proposed color changes are compatible with existing approved designs.

If you have additional questions, please contact Molly Mendoza (714-705-1398). Thank you.

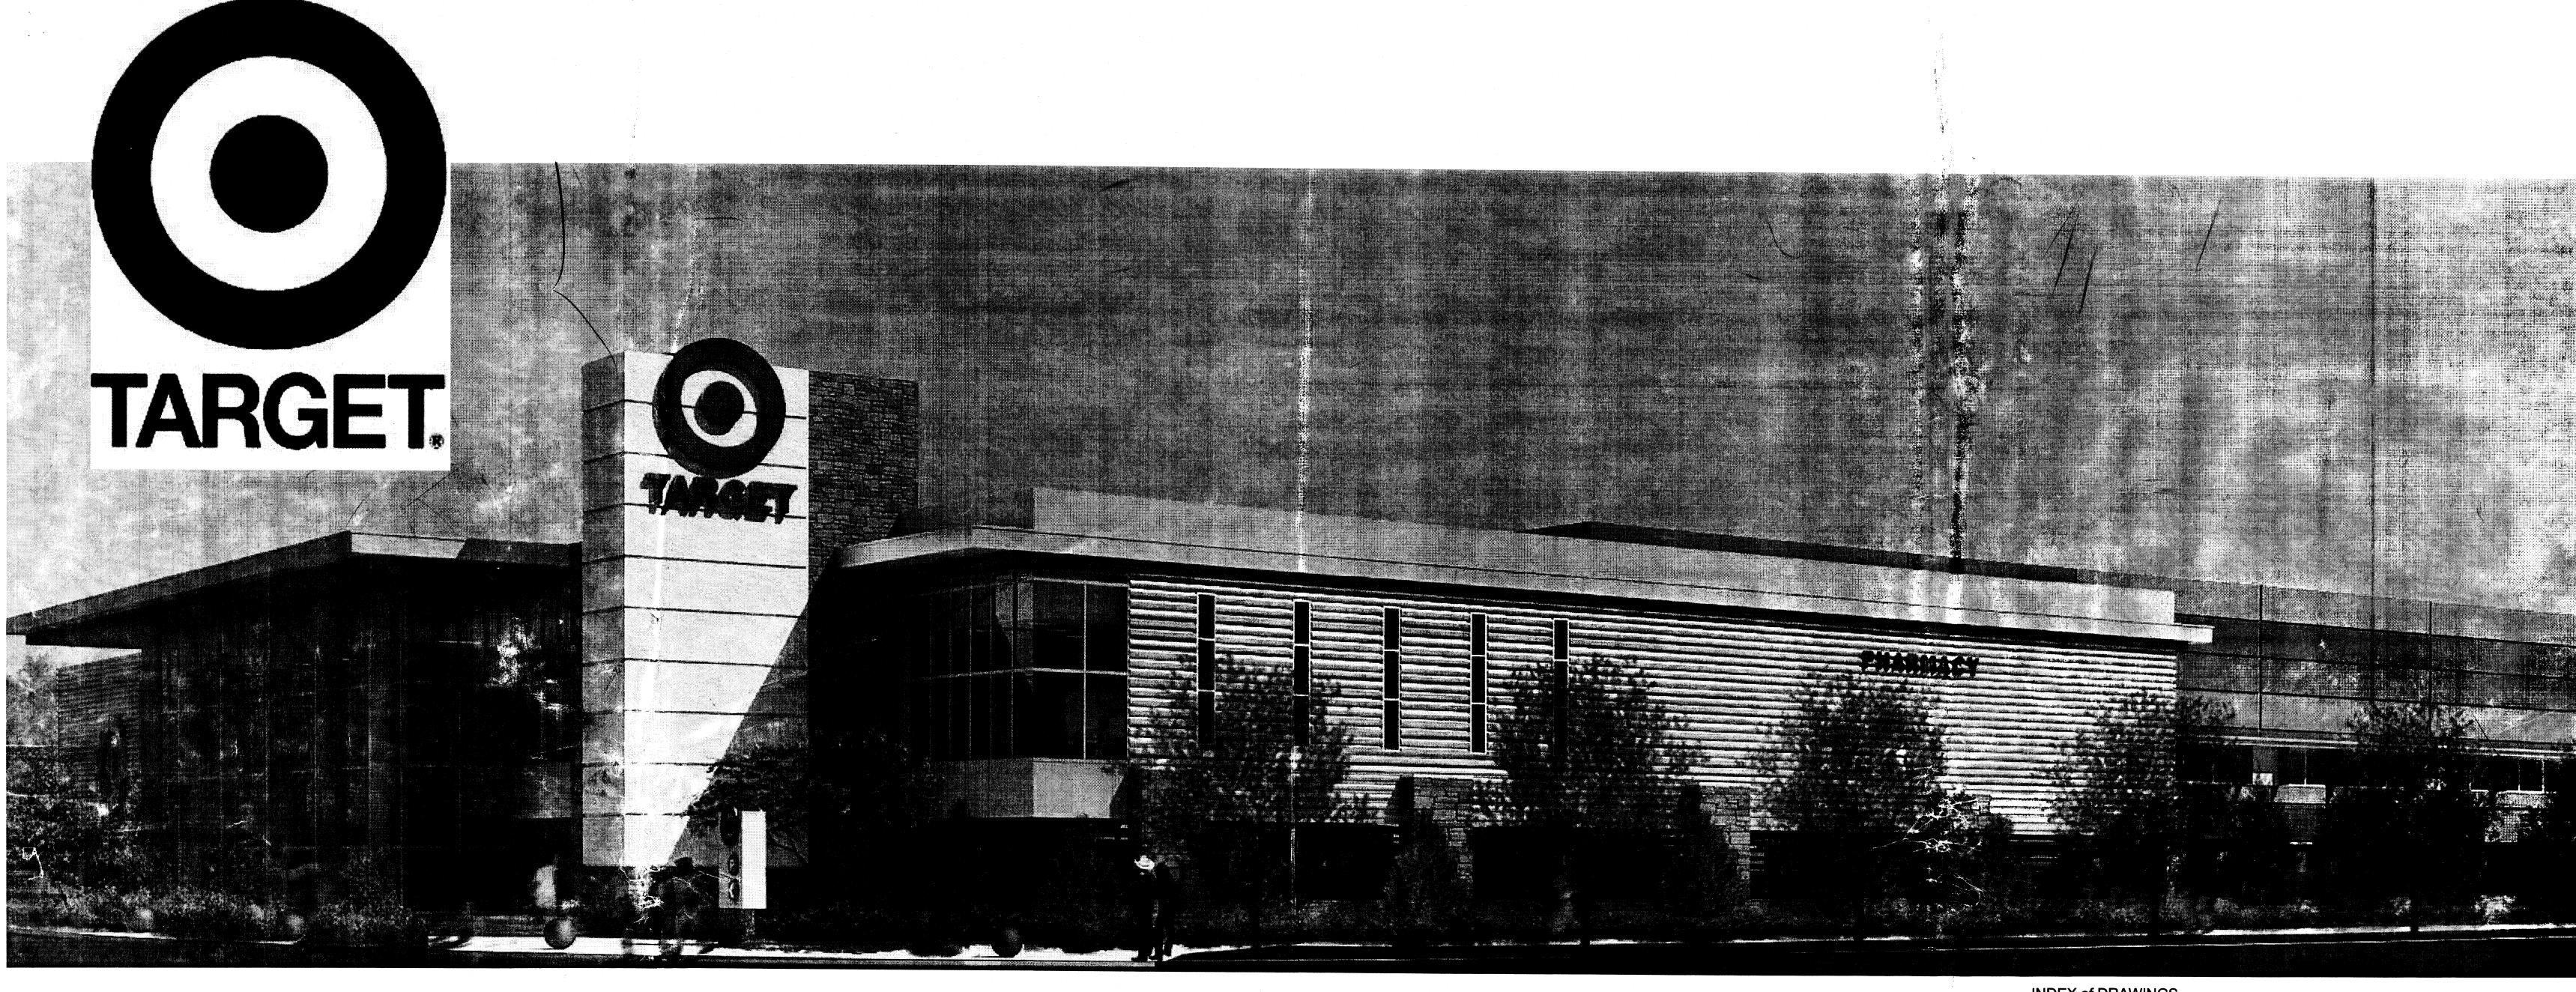

SITE DEVELOPMENT PLAN FOR BUILDING PERMIT DRB RE-SUBMITTAL - 11/10/11

Notice of Decision Planning Conditions addressed 12/12/11

TARGET @ ABQ UPTOWN

Albuquerque, New Mexico





Lawrence A. Cates & Associates, LLP Consulting Engineers



EIDAHL ENVIRONMENTAL

INDEX of DRAWINGS

- SITE DEVELOPMENT PLAN PHASE II SITE DEVELOPMENT PLAN - PHASE I
- SITE DETAILS
- **ENLARGED PLAZA PLAN, SITE DETAILS**

- LANDSCAPE PLAN PHASE II
- **ENLARGED LANDSCAPE PLAN PHASE II**
- LANDSCAPE PLAN PHASE I
- **ENLARGED LANDSCAPE PLAN PHASE I**


- DIMENSION CONTROL PLAN
- **GRADING PLAN**
- PLAZA AREA GRADING PLAN
- DRAINAGE PLAN
- **WATER & SANITARY SEWER PLAN**
- TRUCK ACCESS PLAN


Elevations & Perspectives


- **LOT 2 MIXED USE ELEVATIONS**
- **LOT 3 PAD ELEVATIONS**
- **TARGET ELEVATIONS**
- TARGET PERSPECTIVES
- ARTICULATION COMPLIANCE

- WAYFINDING RECOMMENDATIONS
- WAYFINDING RECOMMENDATIONS

COVER SHEET

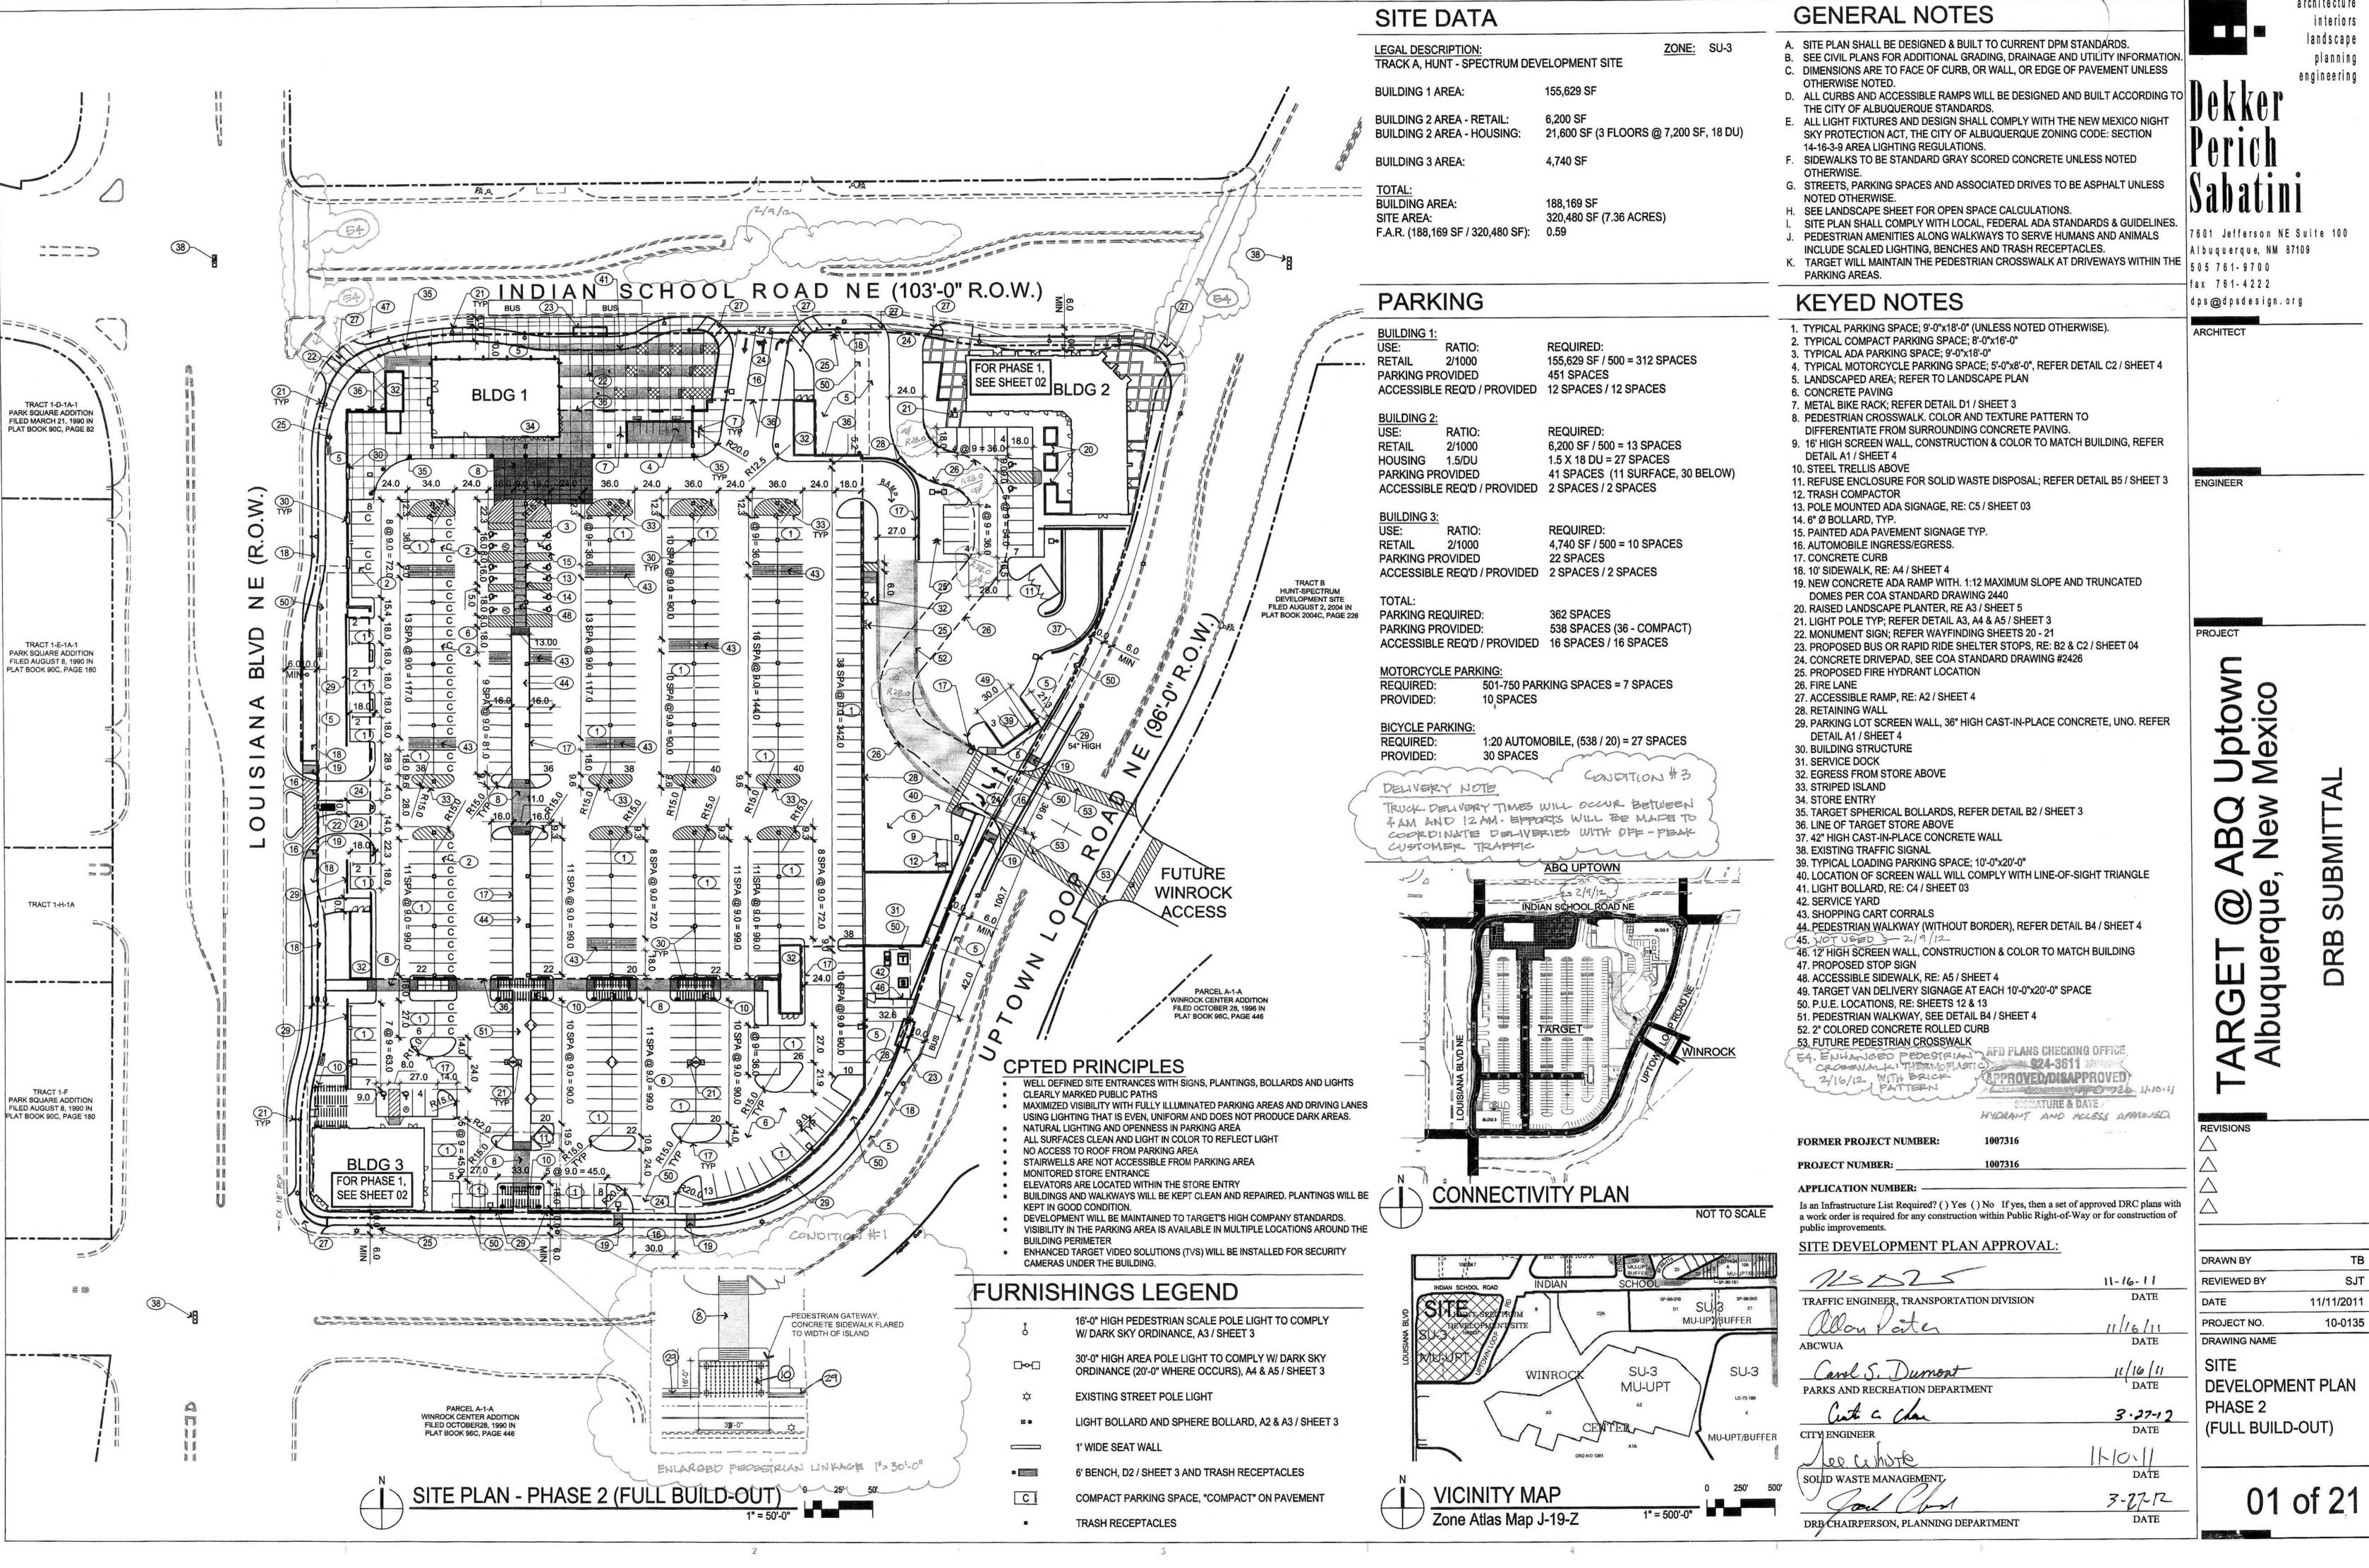


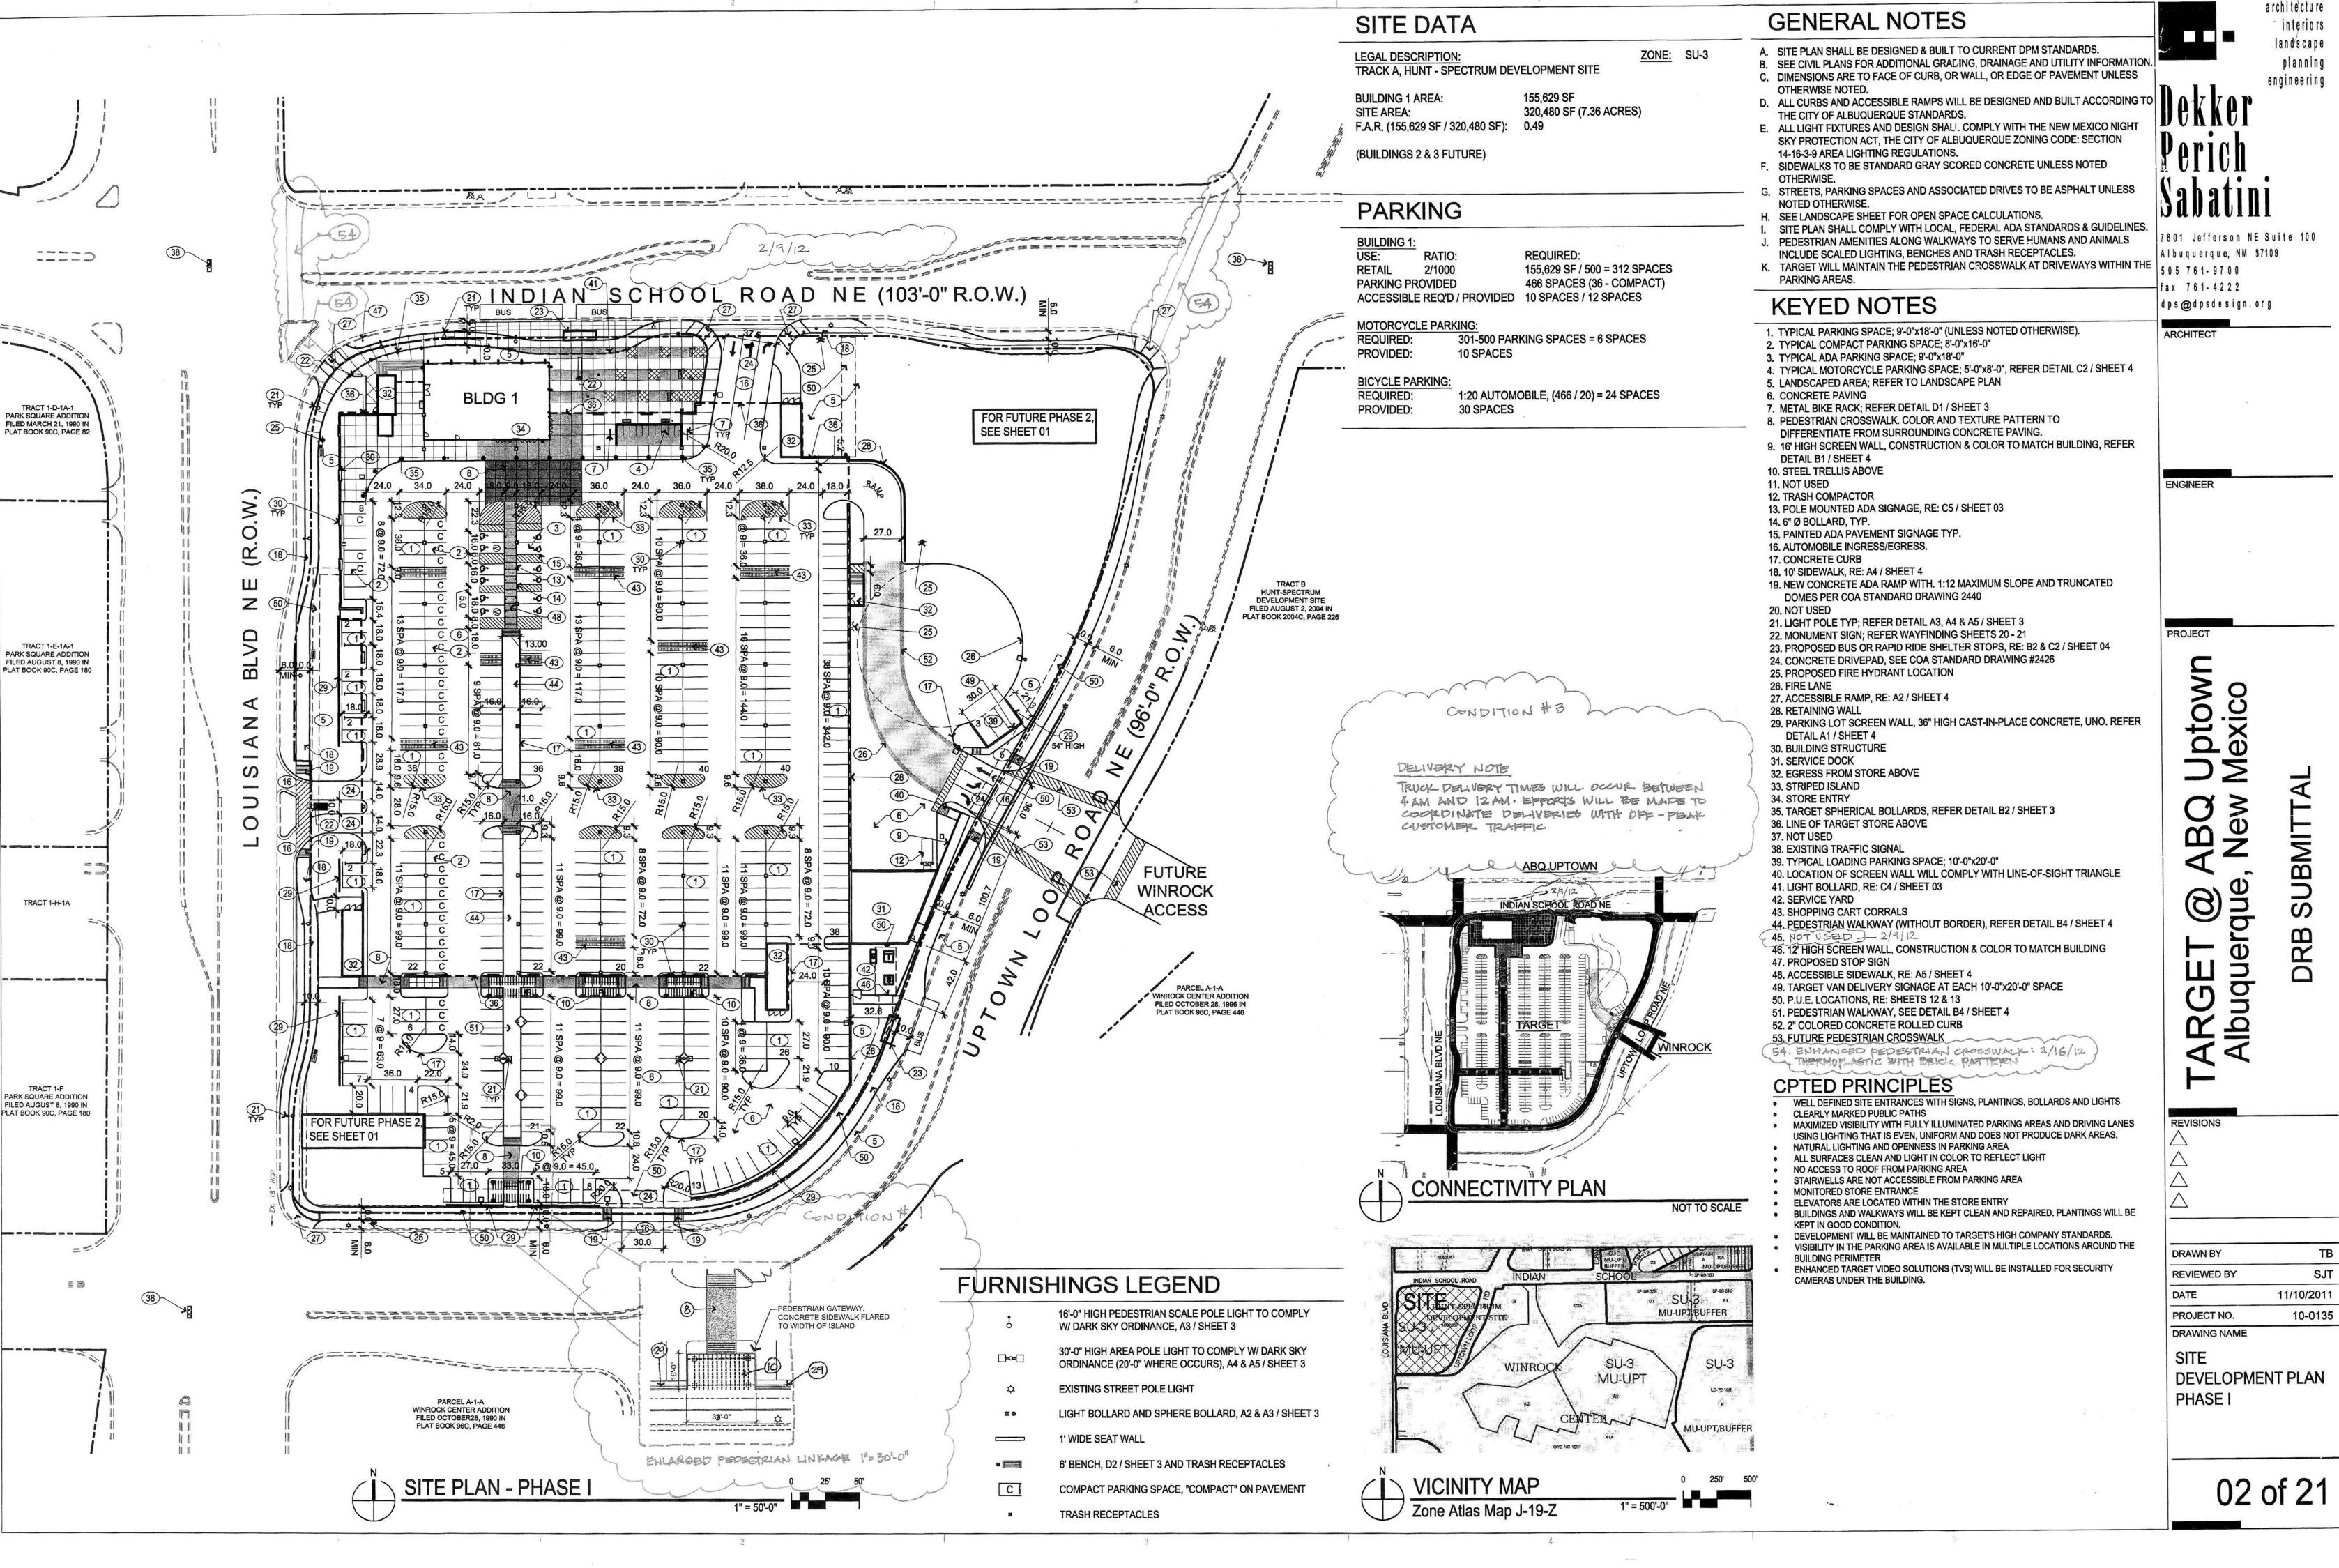

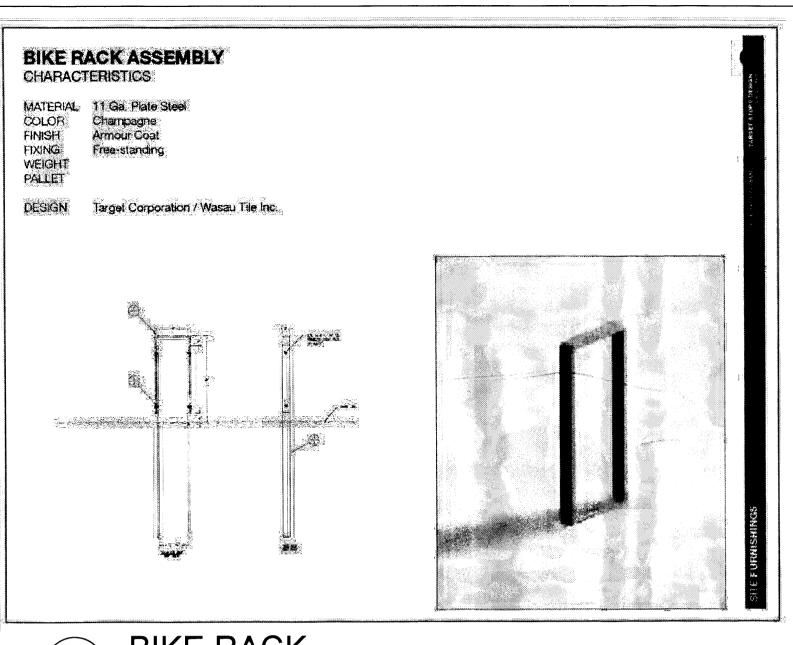


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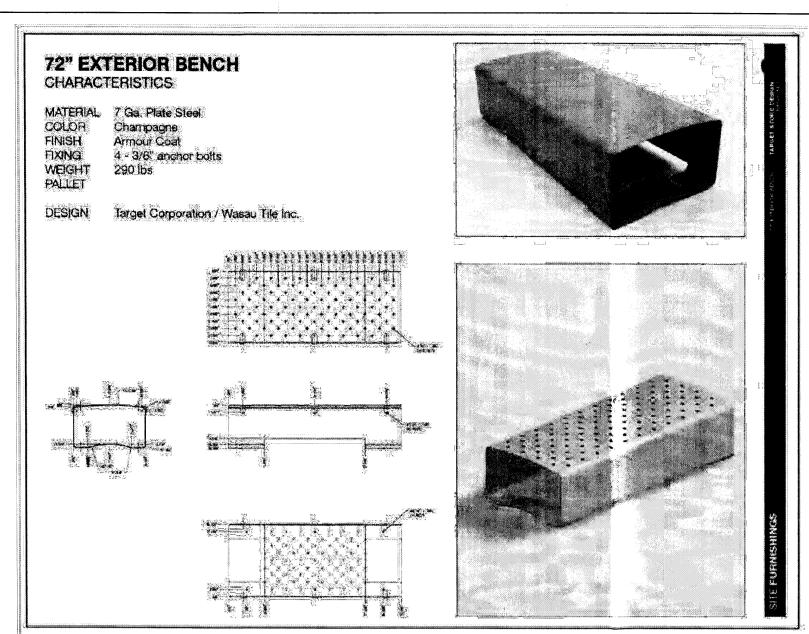


B1 ASH SNUFFER

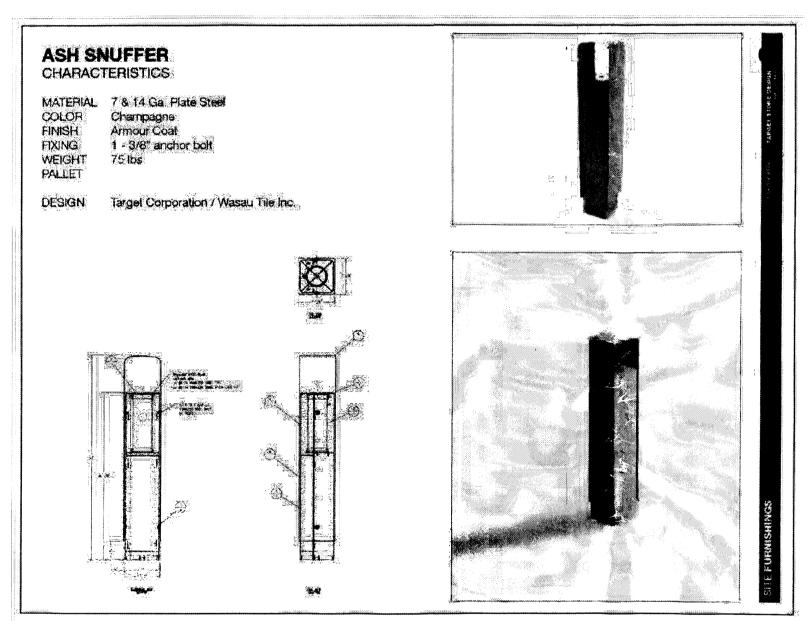


TRASH RECEPTACLE

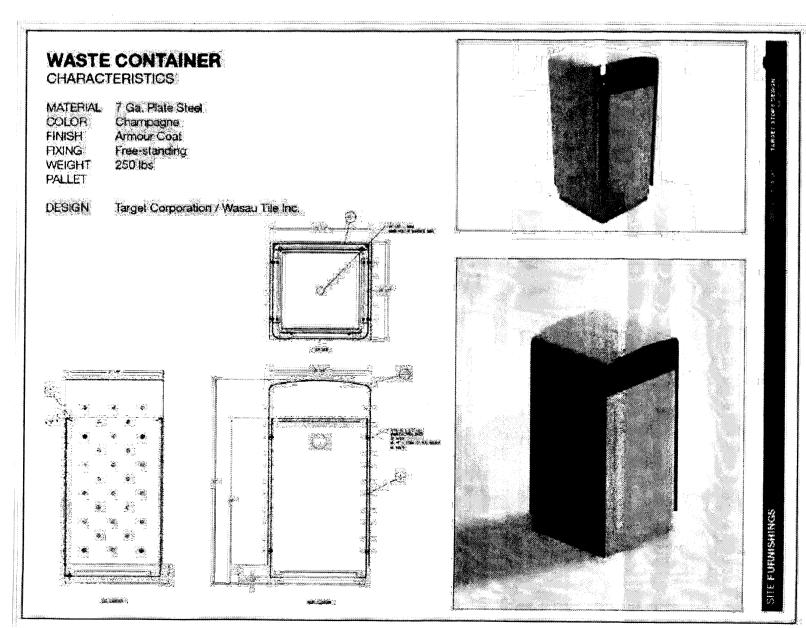
NO SCALE





D2 BENCH NO SCALE

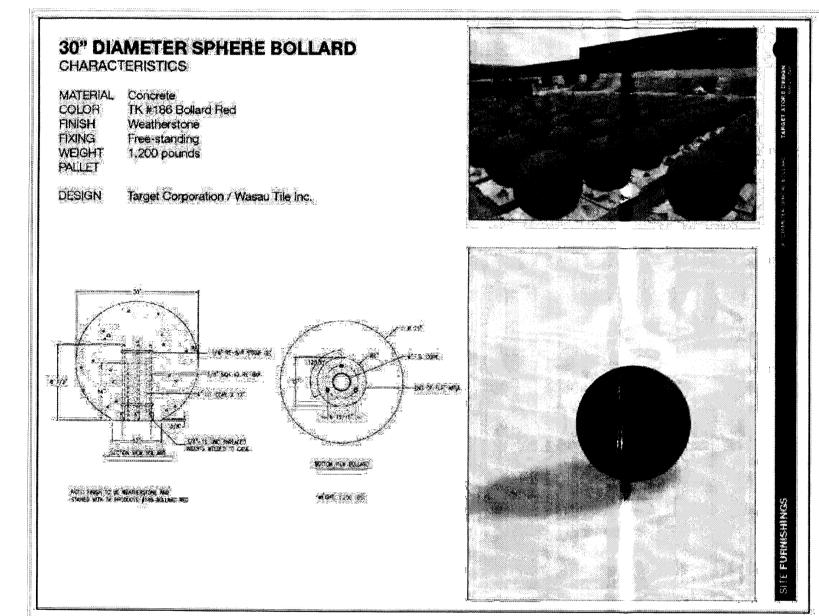



B2 SPHERE BOLLARD

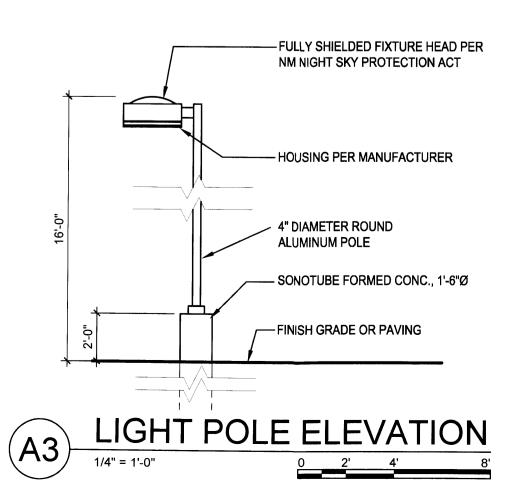


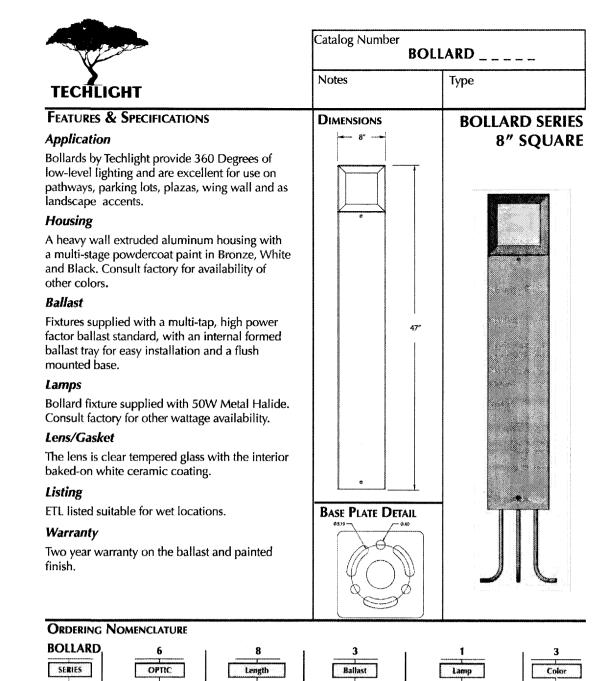


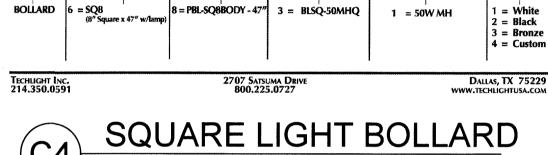


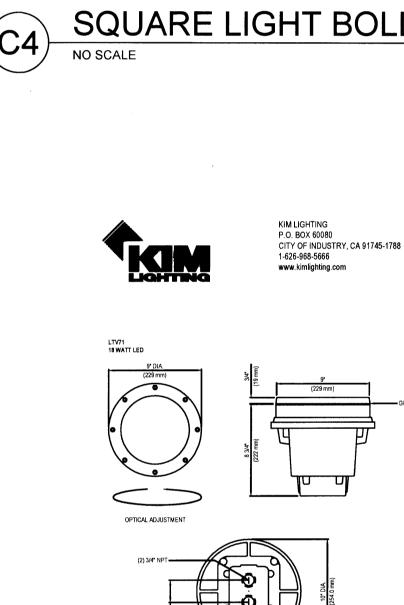


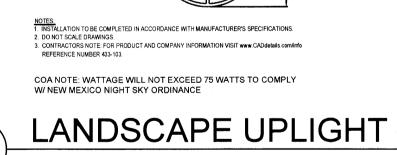


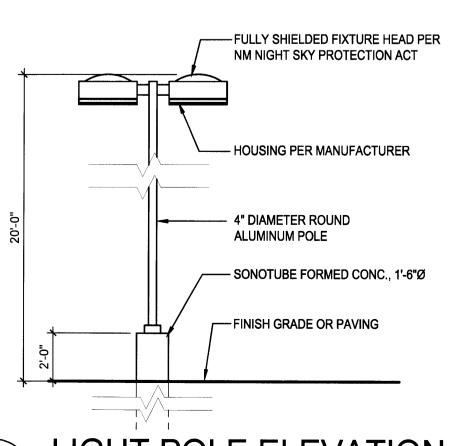

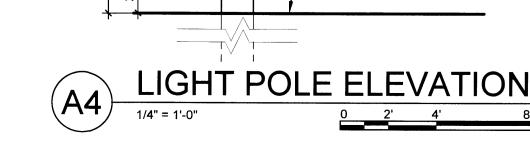

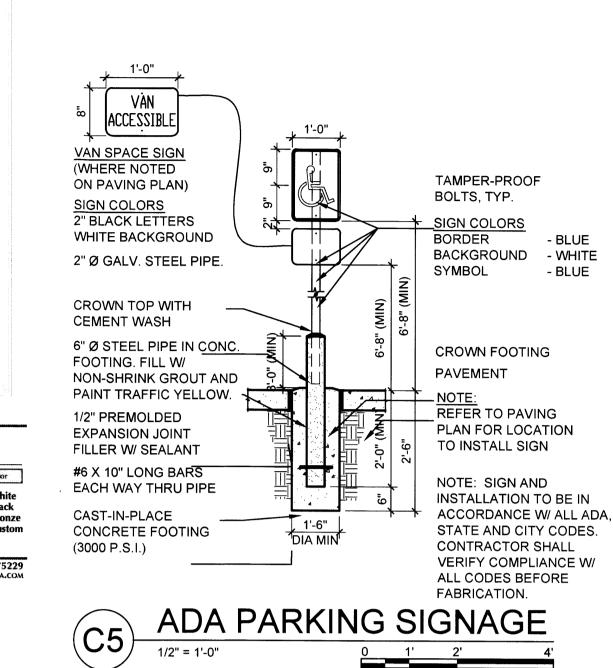

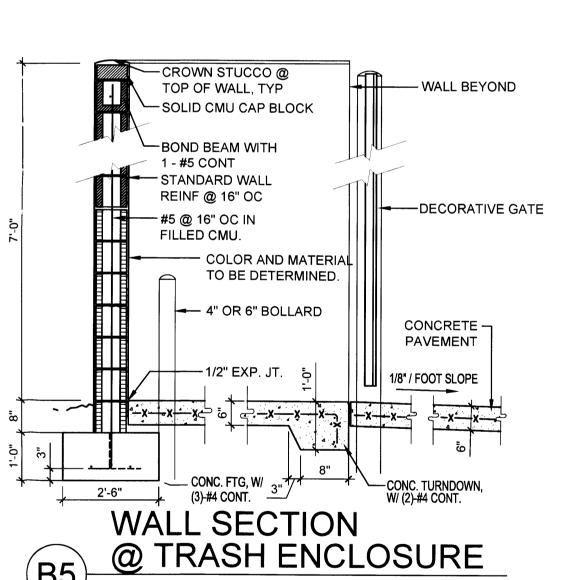

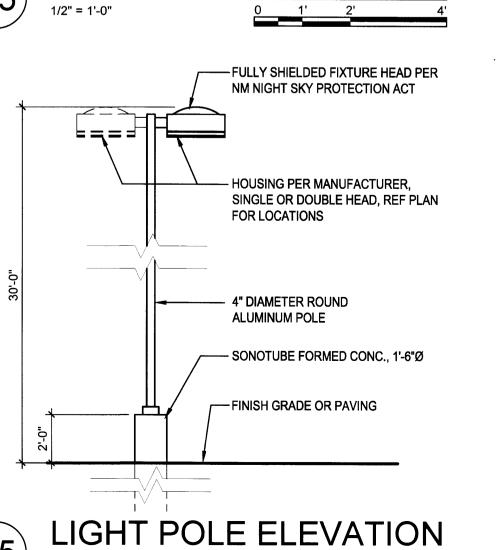

TARGET @ ABQ Uptown Albuquerque, New Mexico
DRB SUBMITTAL

a rchite ctu re

landscape

planning

engineering

7601 Jefferson NE Suite 100

Albuquerque, NM 87109

dps@dpsdesign.org

505 761-9700

fax 761-4222

ARCHITECT

DRAWN BY

TB

REVIEWED BY


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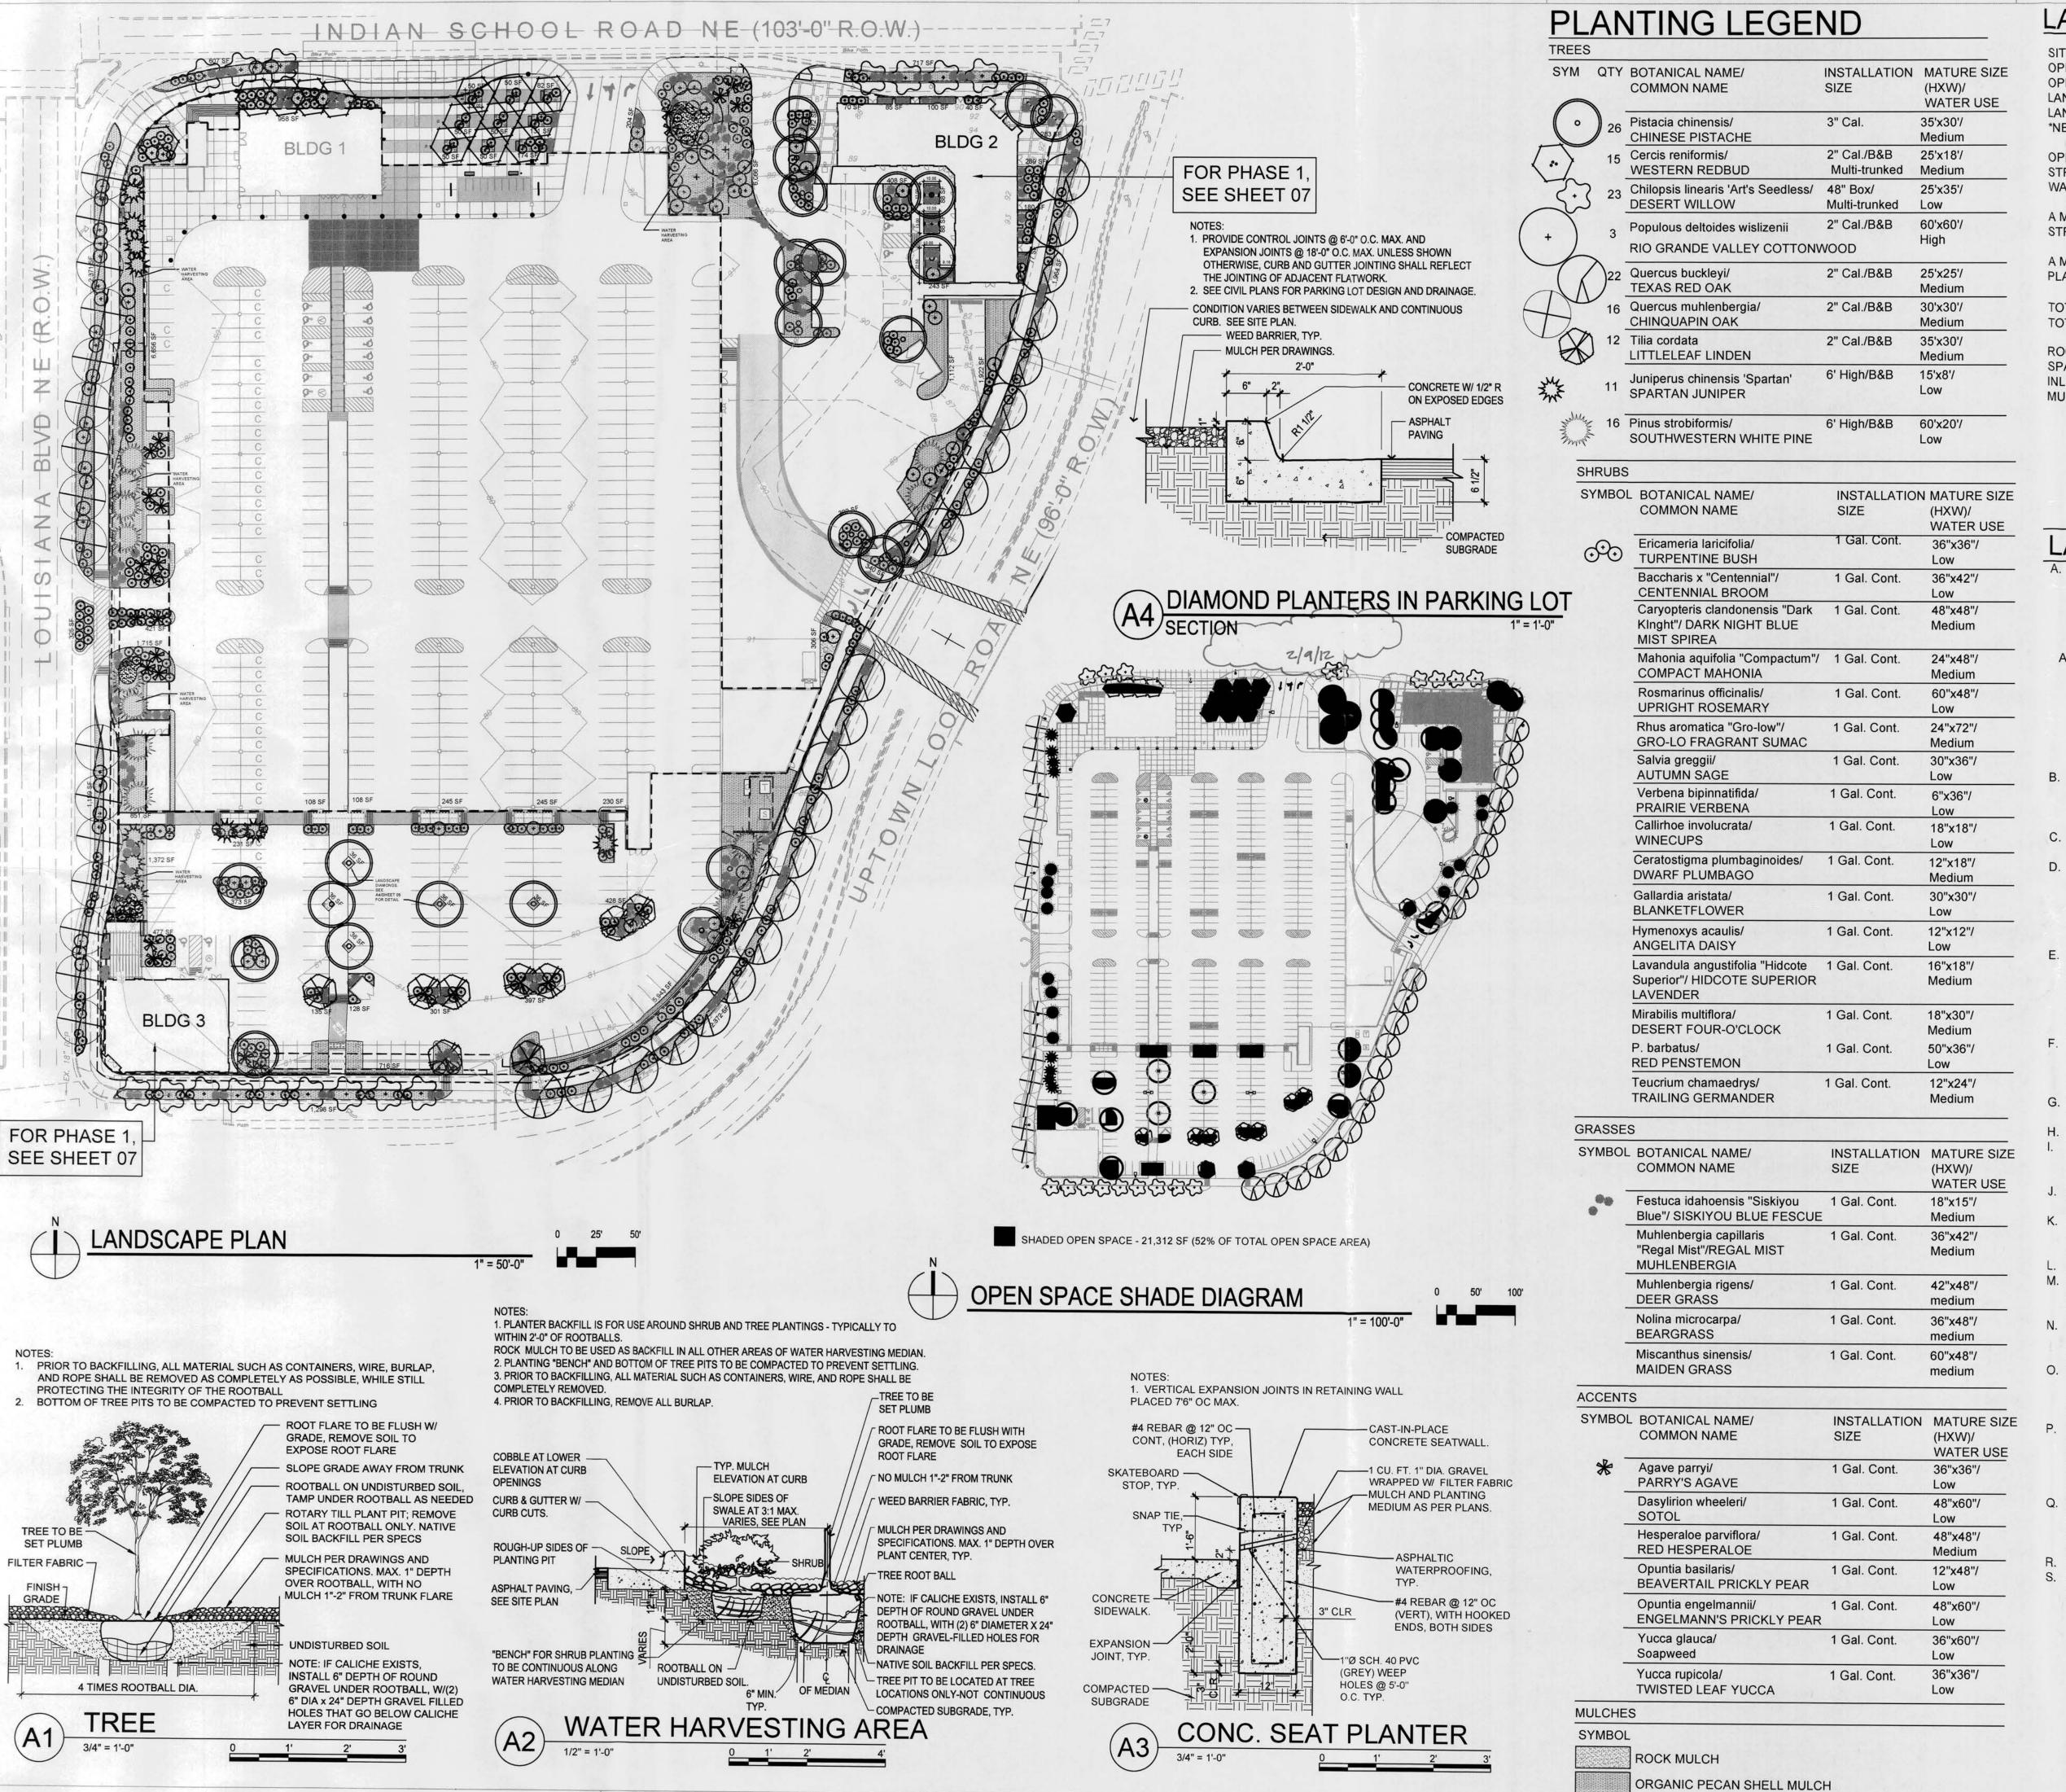
11/10/2011

PROJECT NO

DRAWING NAME

SITE DETAILS



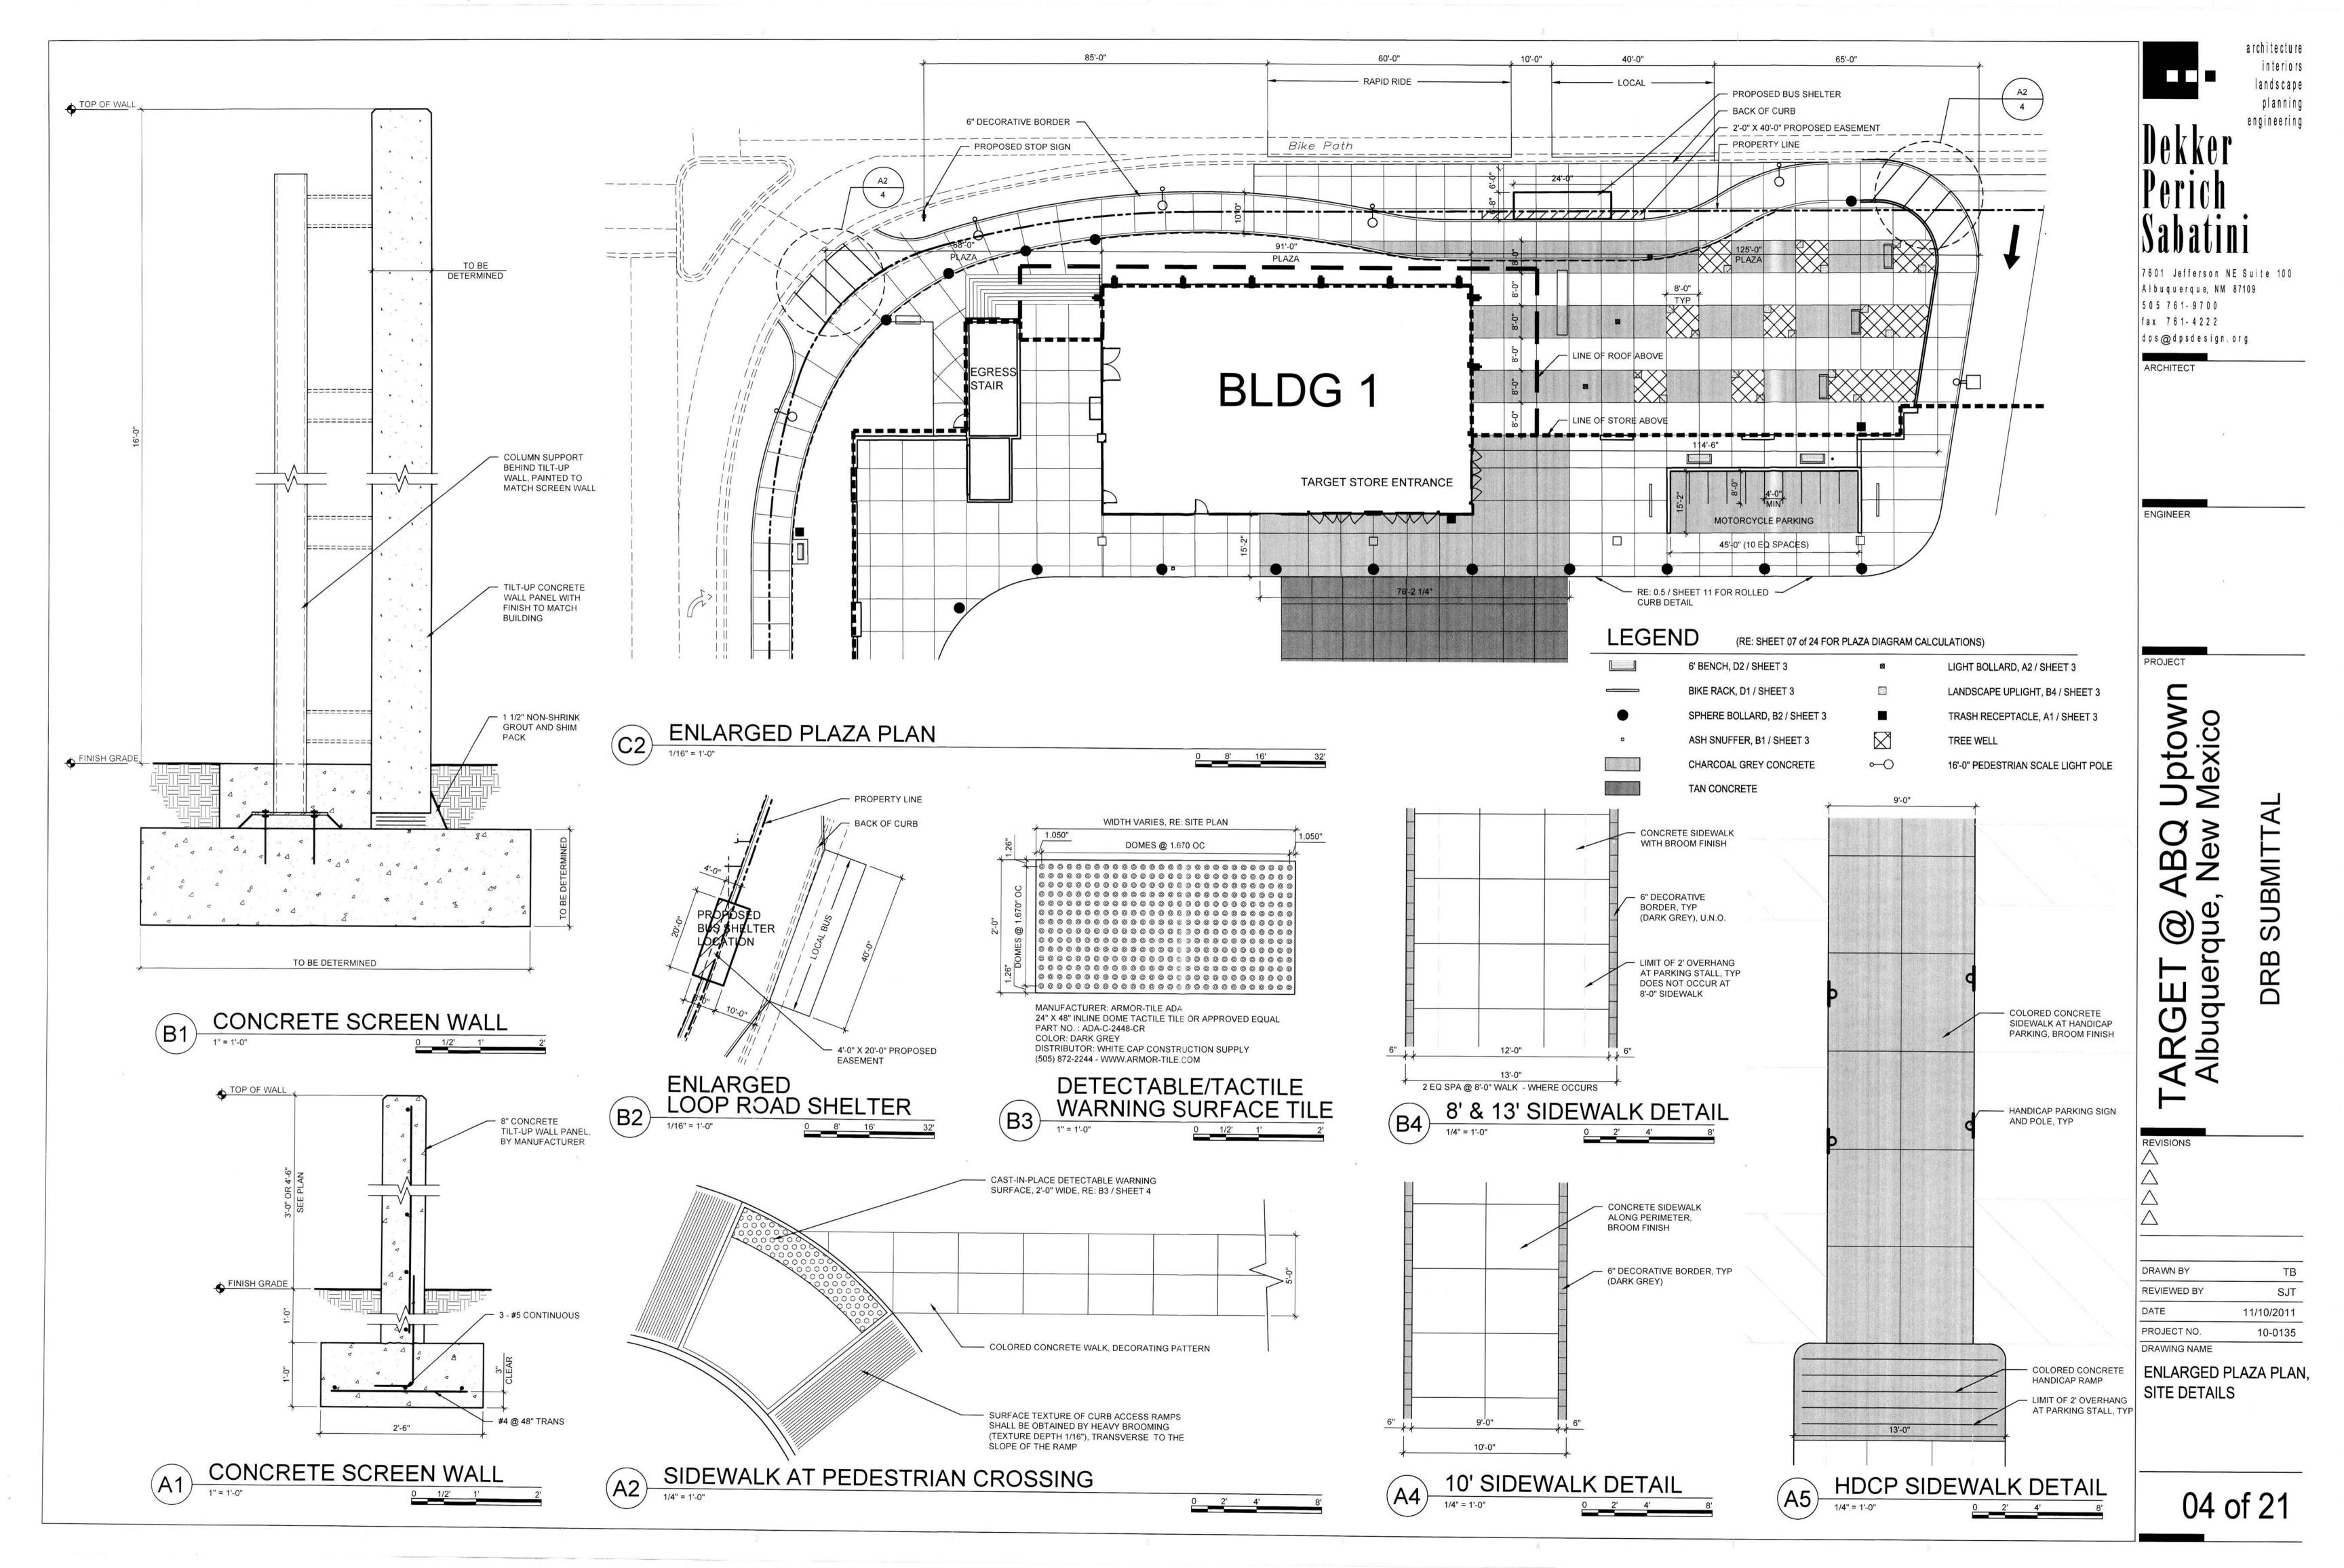

LANDSCAPE CALCULATIONS

SITE AREA: 7.3572 AC (AFTER R.O.W. DEDICATION)
OPEN SPACE REQUIREMENT (10% OF THE SITE): 32,048 SF
OPEN SPACE PROVIDED: 41,036 SF
LANDSCAPE REQUIREMENT (40% OF OPEN SPACE): 16,414 SF
LANDSCAPE AREA PROVIDED: 39,179 SF
*NET LOT AREA WAS NOT USED IN THESE CALCULATIONS.

OPEN SPACE CALCULATIONS DO NOT INCLUDE REQUIRED LANDSCAPE STRIPS ALONG THE STREET OR WALKWAYS EXCEPT ANY PORTION OF A WALKWAY THAT IS WIDER THAN 10 FEET.

A MINIMUM OF 75% OF LANDSCAPE AREAS AND 60%-75% OF PLANTING STRIPS SHALL BE COVERED WITH LIVE VEGETATIVE MATERIALS.

A MINIMUM OF 10% OF LANDSCAPE AREAS WILL HAVE FLOWERING PLANTS OR SHRUBS.

TOTAL SHADE TREES: 80 (% OF TREES)
TOTAL SIGNATURE TREES: 38 (% OF TREES)

ROCK MULCH HAS BEEN LIMITED TO LESS THAN 5% OF ANY OPEN SPACE AREA AND USED ONLY WHERE NECESSARY AROUND DRAINAGE INLETS. ALL OTHER MULCH AREAS UTILIZE ORGANIC PECAN SHELL MULCH.

LANDSCAPE NOTES

- A. DESIGN: THE PLANTING DESIGN INCLUDES A DIVERSE PALETTE OF DESERT AND HIGH DESERT PLANTS THAT WILL COMPLEMENT THE ARCHITECTURE OF THE PROJECT. THE INTENT IS TO LANDSCAPE THIS MIXED-USE, URBAN ENVIRONMENT WITH DESERT AND HIGH DESERT PLANTS THAT REINFORCE A SENSE OF PLACE AND ARE APPROPRIATE TO ALBUQUERQUE'S CLIMATE.
- A.A. GRASSES AND ACCENT PLANTS SUCH AS YUCCA, SOTOL AND PRICKLY PEAR CACTUS WILL BE USED IN HIGHLY VISIBLE AND APPROPRIATE LOCATIONS. THE USE OF REGIONALLY NATIVE TREES FOR STREET TREES, WHILE UNORTHODOX, WILL REINFORCE THE SENSE OF PLACE, BUFFER PEDESTRIANS FROM VEHICULAR AREAS AND PROVIDE A COMFORTABLE PEDESTRIAN SCALE TO THE STREETS.
- B. PLANTING AND IRRIGATION INSTALLATION DETAILS SHALL MEET CITY OF ALBUQUERQUE REQUIREMENTS AND THE USDP REQUIREMENTS. EACH TREE SHALL HAVE A MINIMUM OF 36 SQUARE FEET OF PLANTING SPACE.
- C. PLANTING AND IRRIGATION MAINTENANCE SHALL BE THE RESPONSIBILITY OF THE PROPERTY OWNER.
- D. CONTROLLER: THE IRRIGATION SYSTEM SHALL BE RUN WITH A FULLY AUTOMATED IRRIGATION CONTROLLER. THE RUN TIME FOR THE VARIOUS ZONES SHALL BE APPROXIMATELY 45 MINUTES FOR THE DRIP ZONES. RUN TIME WILL BE ADJUSTED ACCORDING TO SEASON, LOCATION, AND PLANT PERFORMANCE DRIP EMITTERS SHALL BE USED FOR ALL PLANT MATERIAL.
- POINT OF CONNECTION: THERE IS LIKELY TO BE MORE THAN ONE POINT OF CONNECTION FOR THIS PROJECT. THE WATER CONNECTION LOCATIONS WILL BE COORDINATED WITH THE OVERALL WATER SERVICE DESIGN FOR THE SITE. THE EXACT LOCATIONS FOR CONNECTIONS AND CONTROLLERS IN UNKNOWN AT THIS TIME.
- F. MULCH: ALL PLANTING BEDS SHALL BE COVERED WITH MULCH. GRAVEL, BARK AND PECAN SHELL MULCHES WILL BE USED APPROPRIATELY TO ADD VISUAL INTEREST AND PROTECT SOIL MOISTURE.
- G. THE PARKING AREA TREES SELECTED FOR USE AT TARGET @
 TREE AND SHRUB PITS TO BE 4 TIMES THE ROOTBALL DIAMETER.
 H. THERE IS NO HIGH WATER USE TURF USED ON THIS PROJECT.
- THE LANDSCAPE DESIGN SHALL COMPLY WITH THE INTENT OF THE CITY OF ALBUQUERQUE WATER CONSERVATION, LANDSCAPING AND WATER WASTE ORDINANCE.
 SOIL PREPARATION AND AERATION WITHIN ROW IS REQUIRED TO
- DE-COMPACT LANDSCAPE ZONE PRIOR TO PLANTING.

 K. PASSIVE WATER HARVESTING, SUCH AS HARVESTING OF STORM WATER SURFACE RUNOFF AND ROOF RUNOFF, SHALL BE
- UTILIZED WHERE FEASIBLE AND CAPTURED IN SWALES.

 L. SOIL AMENDMENTS WILL BE USED FOR PLANT MATERIAL.

 M. PLANT AND IRRIGATION MAINTENANCE WILL BE THE RESPONSIBILITY OF THE OWNER FOLLOWING SUBSTANTIAL
- N. THE LANDSCAPE DESIGN REQUIRES A PERMANENT, FULLY AUTOMATIC IRRIGATION SYSTEM TO SUPPORT THE PLANT MATERIAL.
- O. THE IRRIGATION SYSTEM WILL BE CONNECTED TO CITY WATER. THE POINT OF CONNECTION WILL CONSIST OF A WATER METER, BACKFLOW PREVENTER AND MASTERVALVE, SEE COA STD DETAIL #2701.
- P. THE CONTRACTOR SHALL CREATE AN IRRIGATION PLAN TO PERMANENTLY IRRIGATE THE PROPOSED PLANTINGS, AND SHALL SUBMIT THIS TO THE ARCHITECT FOR REVIEW AND APPROVAL. THE PLAN SHALL INCLUDE A PIPING AND EMITTER LAYOUT WITH SIZING, VALVE SCHEDULE AND CONSTRUCTION DETAILS.
- Q. CONTROLLER: THE IRRIGATION SYSTEM SHALL BE RUN WITH FULLY AUTOMATED IRRIGATION CONTROLLER. RUN TIME WILL BE ADJUSTED ACCORDING TO PLANT MATURITY, SEASON, LOCATION, AND PLANT PERFORMANCE.
- R. DRIP EMITTERS SHALL BE USED FOR ALL PLANT MATERIAL.
 S. REFER TO DRAINAGE PLAN FOR GRADING INFORMATION AND WATER HARVESTING LOCATIONS.

architecture interiors landscape planning engineering

Dekker Perich Sabatini

Albuquerque, NM 87109 505 761-9700 fax 761-4222 dps@dpsdesign.org

7601 Jefferson NE Suite 100

ARCHITECT

ENGINEER

PROJECT

RGET @ ABQ Uptown ouquerque, New Mexico

DRAWN BY

REVIEWED BY

MB


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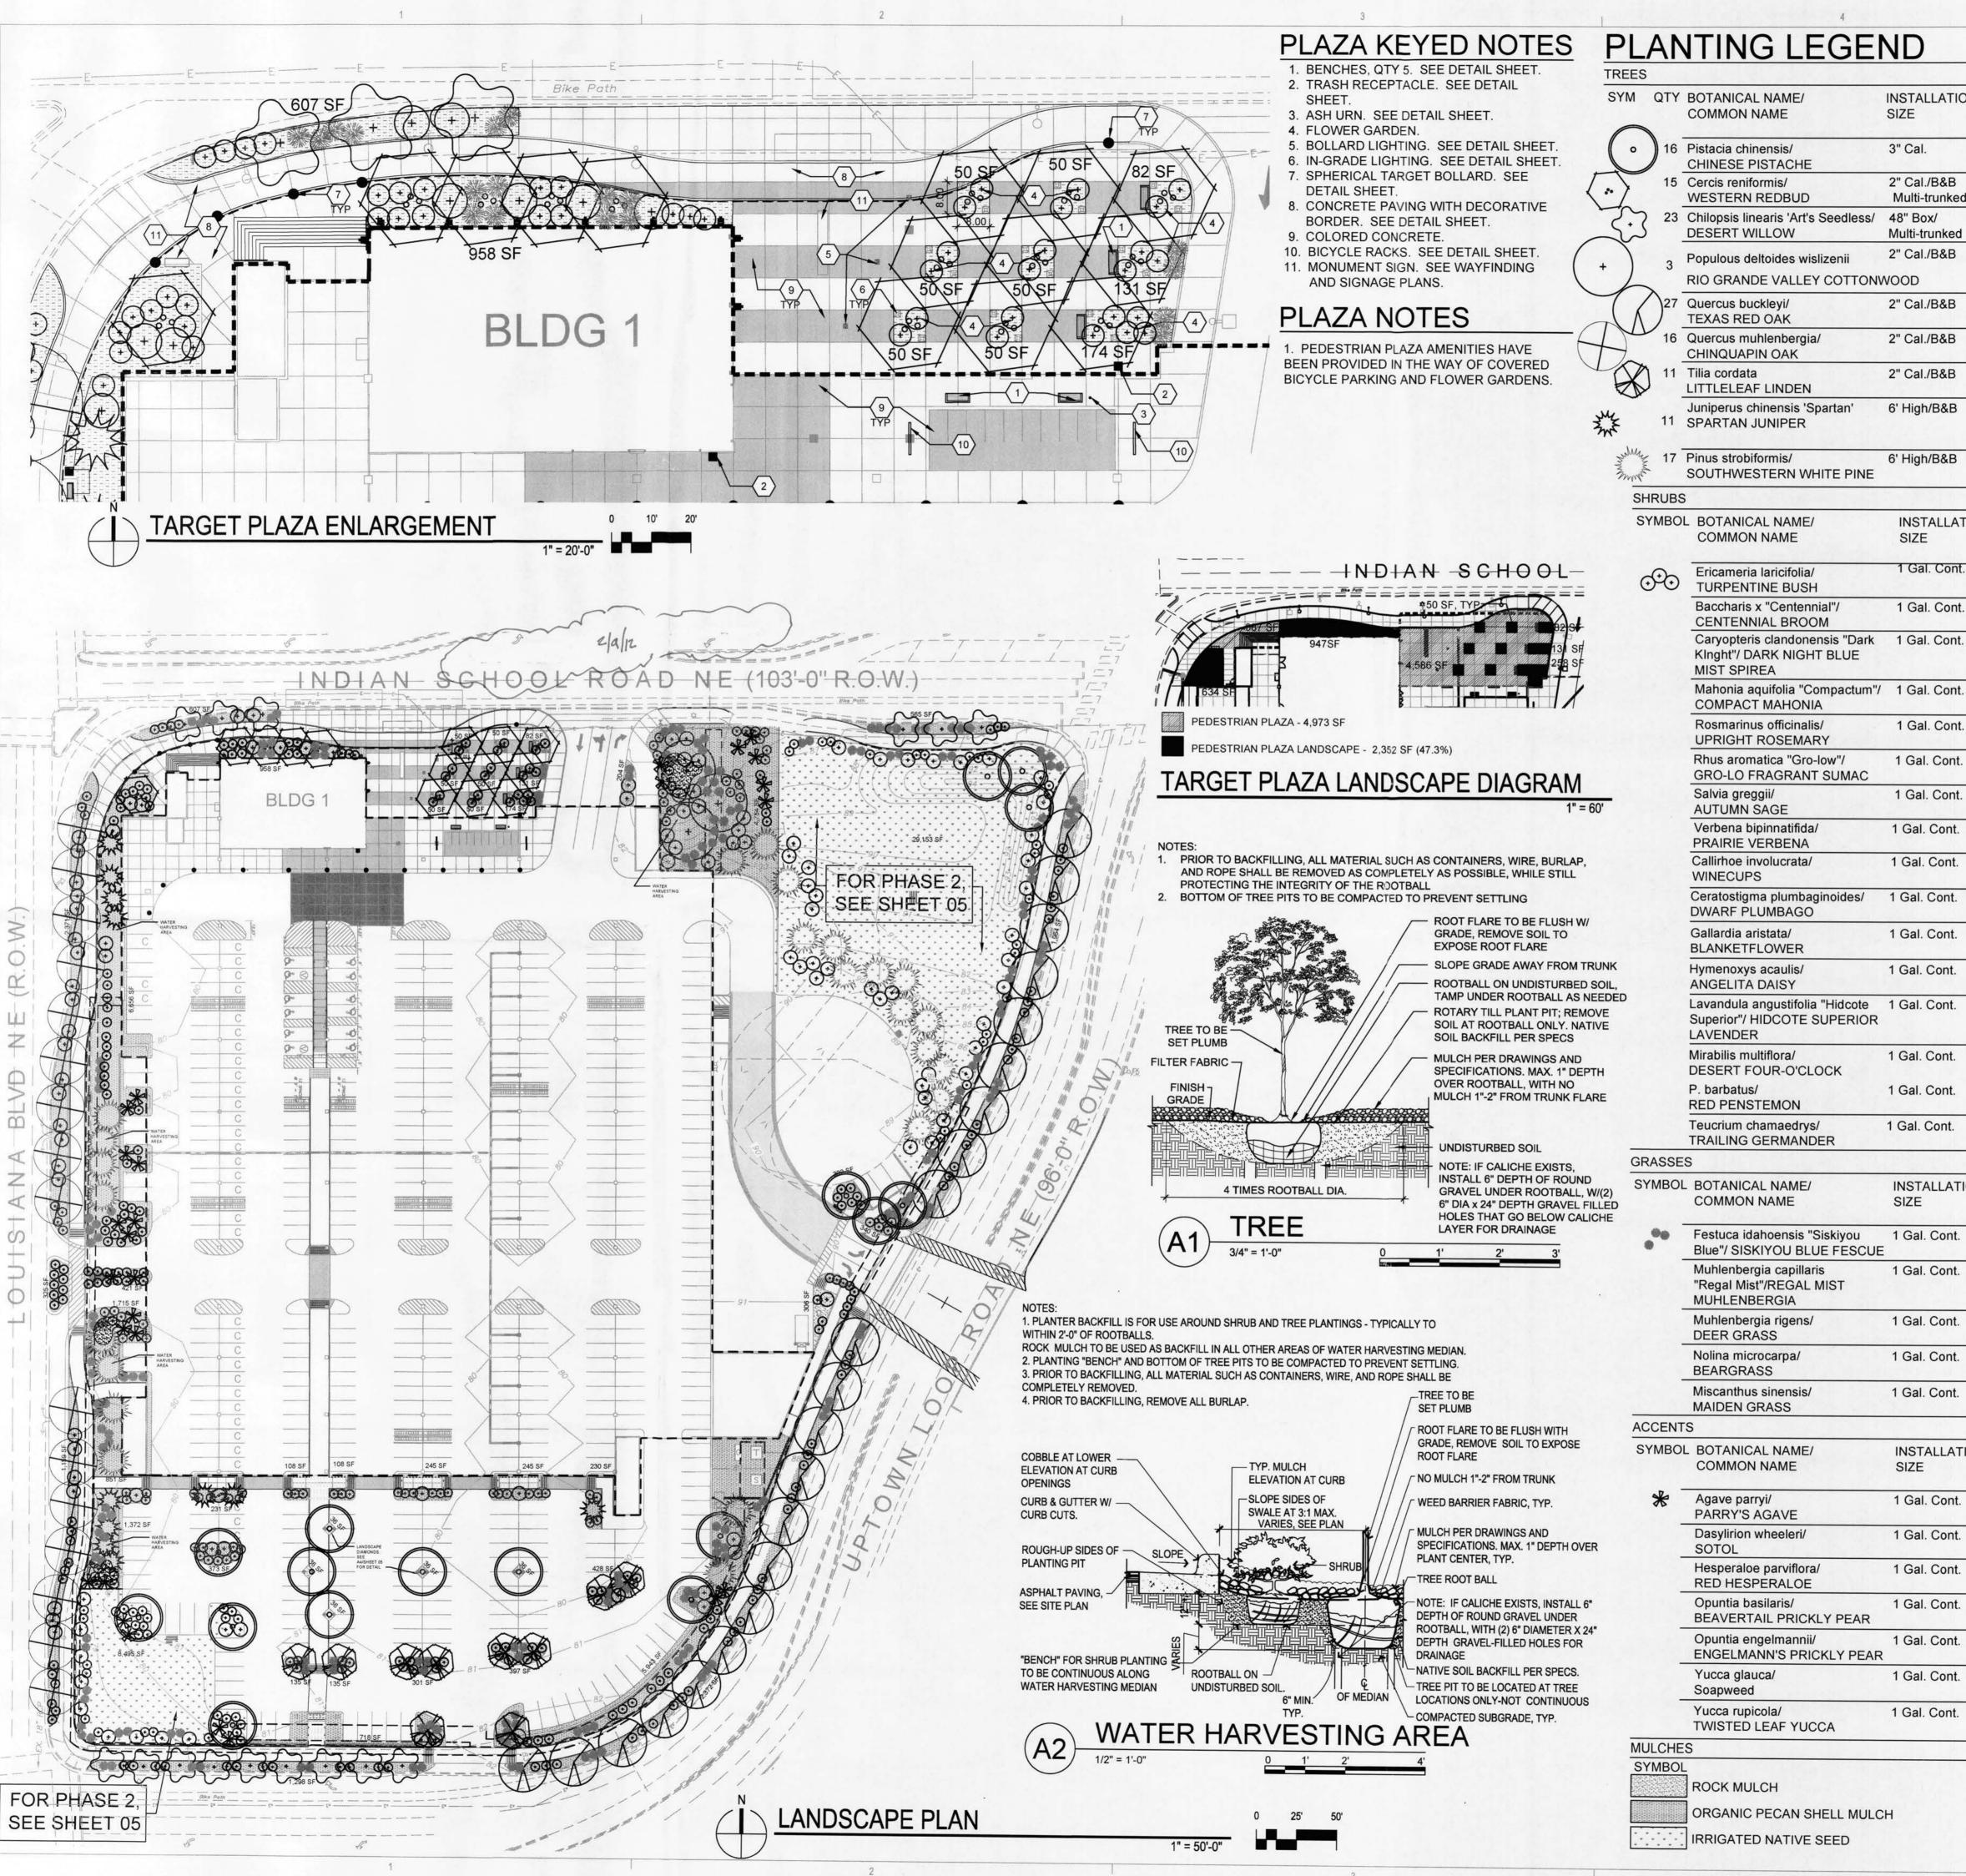
11/10/2011

PROJECT NO. 10-0135

DRAWING NAME

LANDSCAPE PLAN -PHASE II



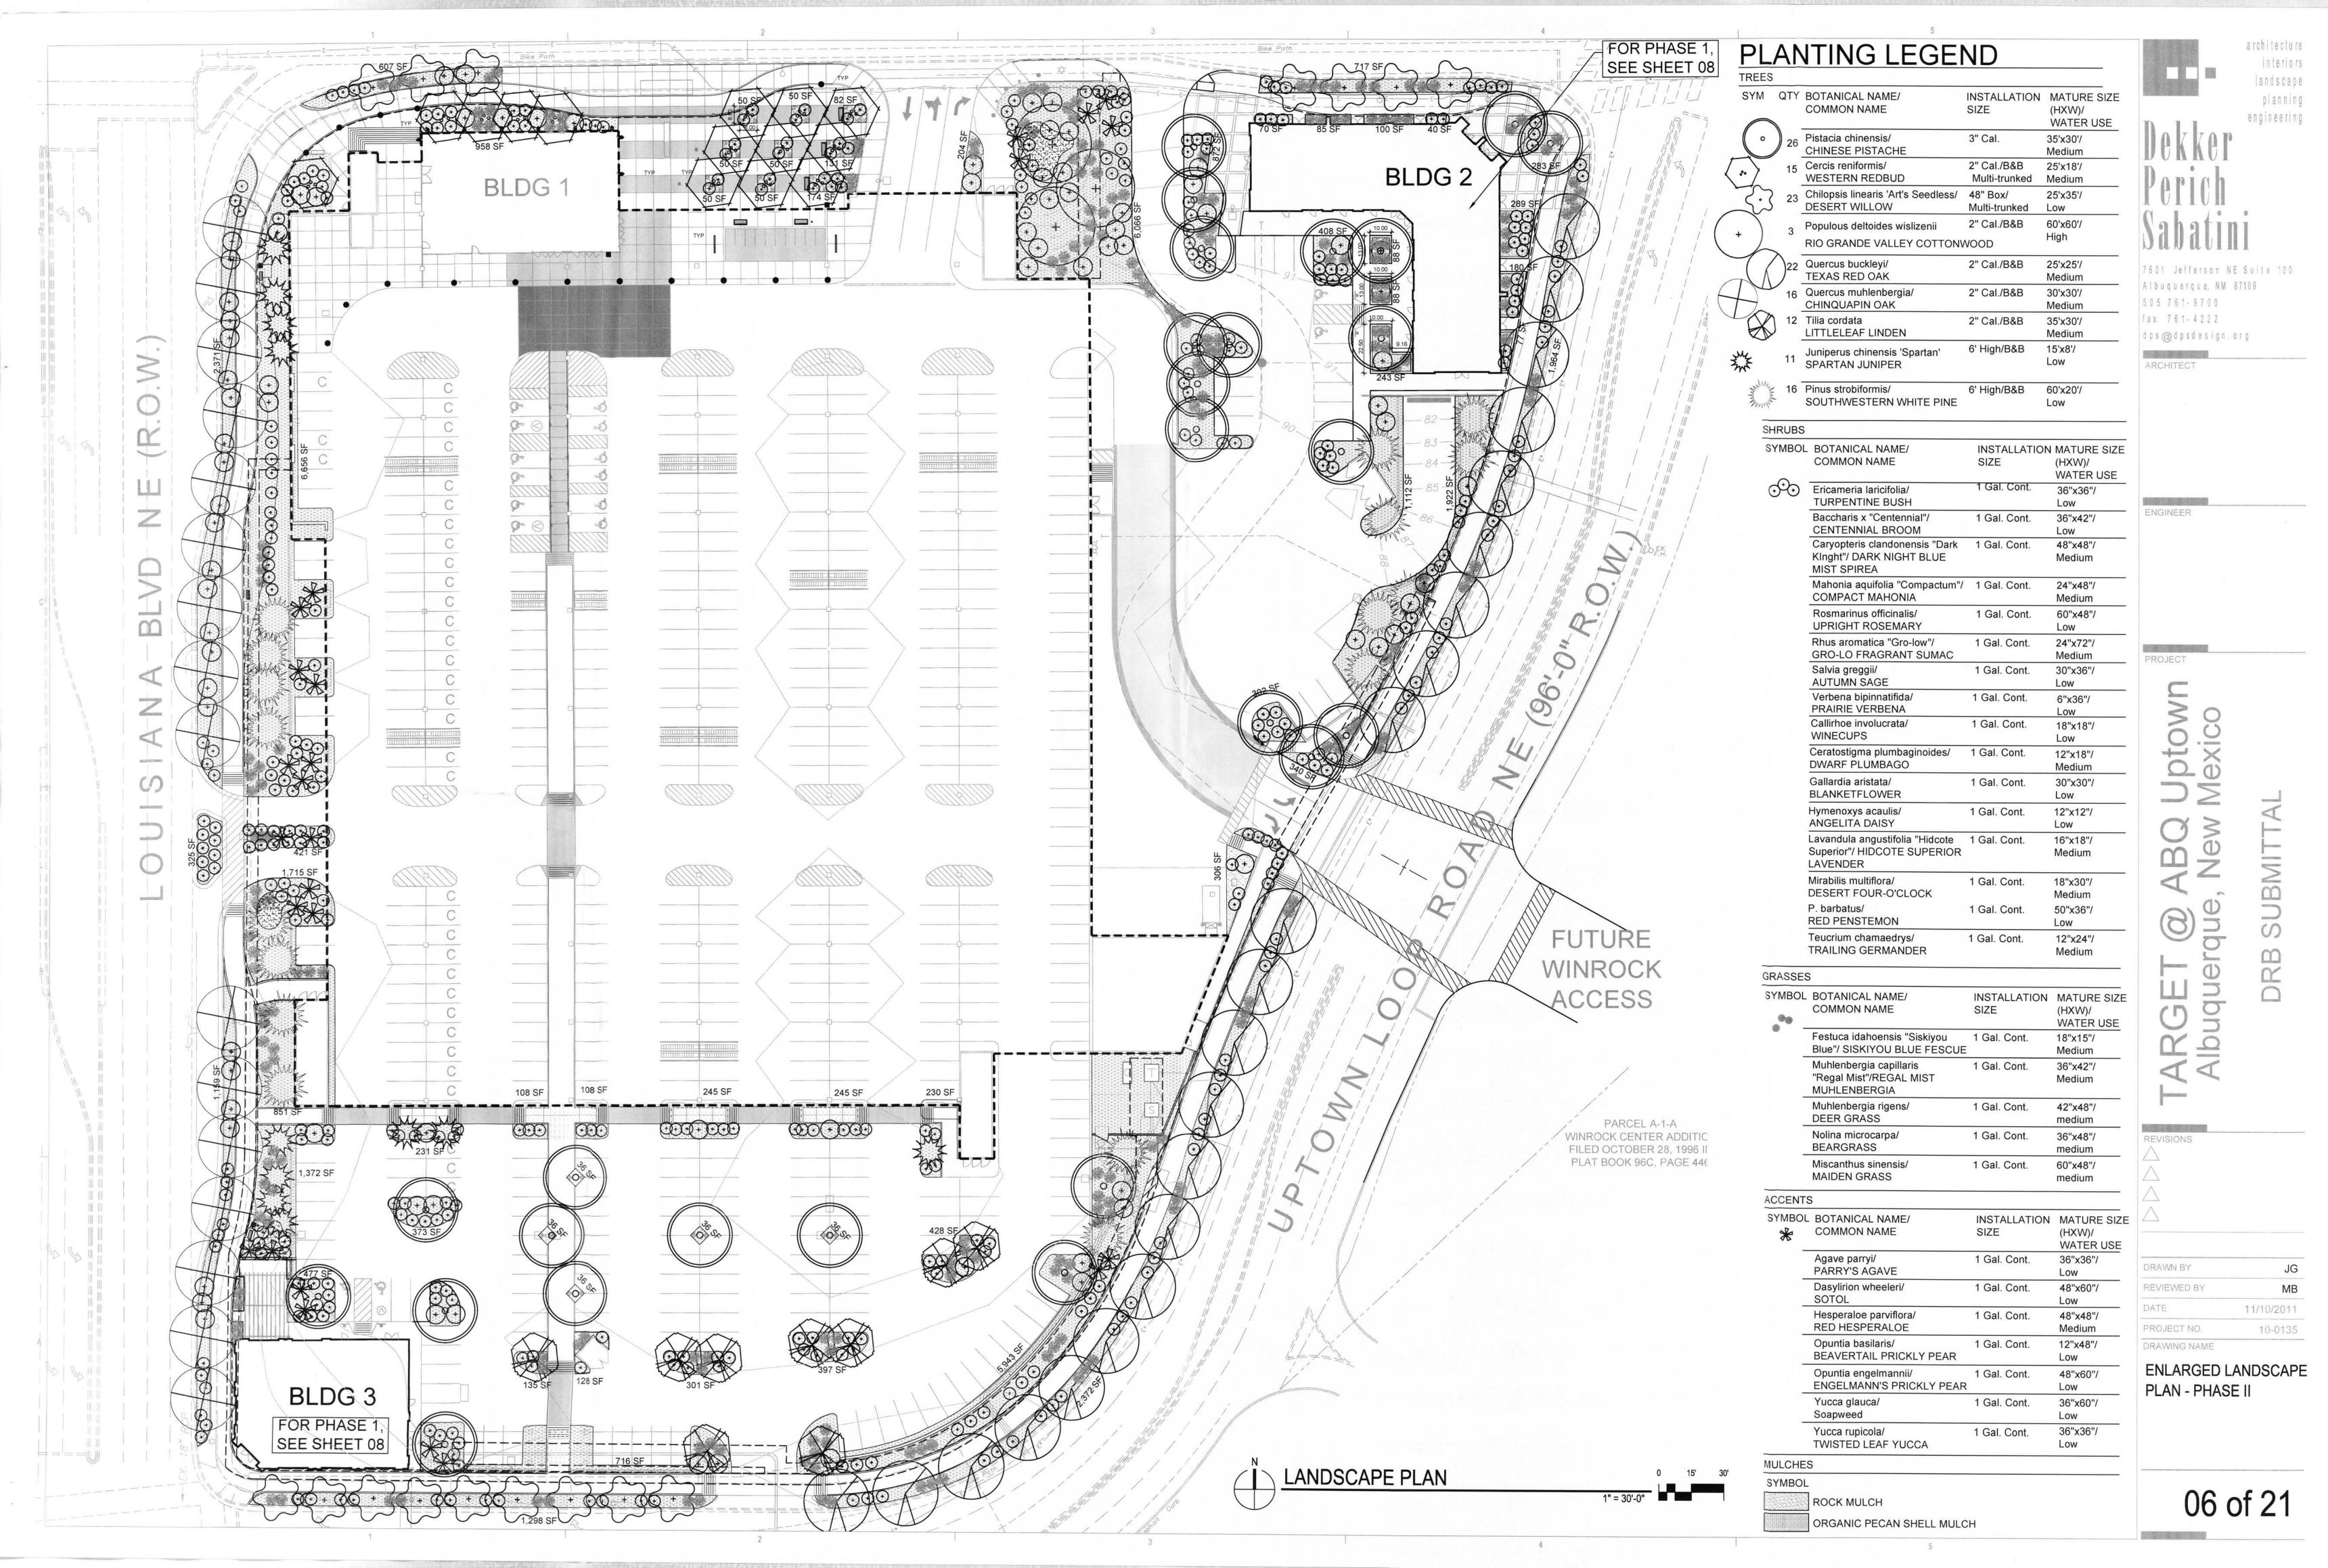

| REES | | | | |
|-----------------|-----|--|------------------------------|------------------------------------|
| SYM | QTY | BOTANICAL NAME/ COMMON NAME | INSTALLATION SIZE | MATURE SIZE (HXW)/ WATER USE |
| C | 16 | Pistacia chinensis/ CHINESE PISTACHE | 3" Cal. | 35'x30'/ Medium |
| $\cdot \rangle$ | 15 | Cercis reniformis/ WESTERN REDBUD | 2" Cal./B&B Multi-trunked | 25'x18'/ Medium |
| ₹;} | 23 | Chilopsis linearis 'Art's Seedless/ DESERT WILLOW | 48" Box/ Multi-trunked | 25'x35'/ Low |
|) | 3 | Populous deltoides wislizenii RIO GRANDE VALLEY COTTON | 2" Cal./B&B WOOD | 60'x60'/ High |
| ((| 27 | Quercus buckleyi/ TEXAS RED OAK | 2" Cal./B&B | 25'x25'/ Medium |
| 7 | 16 | Quercus muhlenbergia/ CHINQUAPIN OAK | 2" Cal./B&B | 30'x30'/ Medium |
| X | 11 | Tilia cordata LITTLELEAF LINDEN | 2" Cal./B&B | 35'x25'/ Medium |
| * | 11 | Juniperus chinensis 'Spartan' SPARTAN JUNIPER | 6' High/B&B | 15'x8'/ Low |
| Sully | 17 | Pinus strobiformis/ | 6' High/B&B | 60'x20'/ |

SOUTHWESTERN WHITE PINE

24"x48"/

Medium

60"x48"/

24"x72"/

Medium

30"x36"/

6"x36"/

18"x18"/

12"x18"/

Medium

30"x30"/

12"x12"/

16"x18"/

Medium

18"x30"/

Medium

50"x36"/

12"x24"/

Medium

(HXW)/

18"x15"/

Medium

36"x42"/

Medium

42"x48"/

medium

36"x48"/

medium

60"x48"/

medium

(HXW)/

36"x36"/

48"x60"/

48"x48"/

Medium

12"x48"/

48"x60"/

36"x60"/

36"x36"/

Low

Low

Low

Low

Low

Low

WATER USE

INSTALLATION MATURE SIZE

WATER USE

Low

INSTALLATION MATURE SIZE

Low

Low

Low

Low

Low

1 Gal. Cont.

SIZE

| SYMBOL | BOTANICAL NAME/ COMMON NAME | INSTALLATION SIZE | MATURE SIZE (HXW)/ WATER USE |
|--------|---|----------------------|------------------------------------|
| 9 | Ericameria laricifolia/ TURPENTINE BUSH | 1 Gal. Cont. | 36"x36"/ Low |
| | Baccharis x "Centennial"/ CENTENNIAL BROOM | 1 Gal. Cont. | 36"x42"/ Low |
| | Caryopteris clandonensis "Dark KInght"/ DARK NIGHT BLUE MIST SPIREA | 1 Gal. Cont. | 48"x48"/ Medium |
| | | | |

ROCK MULCH

RRIGATED NATIVE SEED

LANDSCAPE CALCULATIONS

SITE AREA: 7.3572 AC (AFTER R.O.W. DEDICATION) REQUIRED OPEN SPACE: 32,048 SF (10% OF THE SITE) PROVIDED OPEN SPACE: 72.143 SF REQUIRED LANDSCAPE AREA: 28,857 SF (40% OF REQ. OPEN SPACE) PROVIDED LANDSCAPE AREA: 67,239 SF

*NET LOT AREA WAS NOT USED IN THESE CALCULATIONS.

OPEN SPACE CALCULATIONS DO NOT INCLUDE REQUIRED LANDSCAPE STRIPS ALONG THE STREET OR WALKWAYS EXCEPT ANY PORTION OF A WALKWAY THAT IS WIDER THAN 10 FEET.

A MINIMUM OF 75% OF LANDSCAPE AREAS AND 60%-75% OF PLANTING STRIPS SHALL BE COVERED WITH LIVE VEGETATIVE MATERIALS.

A MINIMUM OF 10% OF LANDSCAPE AREAS WILL HAVE FLOWERING PLANTS OR SHRUBS.

TOTAL SHADE TREES: 71 (3/3 OF TREES)

TOTAL SIGNATURE TREES: 41 (1/3 OF TREES)

ROCK MULCH HAS BEEN LIMITED TO LESS THAN 5% OF ANY OPEN SPACE AREA AND USED ONLY WHERE NECESSARY AROUND DRAINAGE INLETS. ALL OTHER MULCH AREAS UTILIZE ORGANIC PECAN SHELL

LANDSCAPE NOTES

A. DESIGN: THE PLANTING DESIGN INCLUDES A DIVERSE PALETTE OF DESERT AND HIGH DESERT PLANTS THAT WILL COMPLEMENT THE ARCHITECTURE OF THE PROJECT. THE INTENT IS TO LANDSCAPE THIS MIXED-USE, URBAN ENVIRONMENT WITH DESERT AND HIGH DESERT PLANTS THAT REINFORCE A SENSE OF PLACE AND ARE APPROPRIATE TO ALBUQUERQUE'S CLIMATE

A.A. GRASSES AND ACCENT PLANTS SUCH AS YUCCA, SOTOL AND PRICKLY PEAR CACTUS WILL BE USED IN HIGHLY VISIBLE AND APPROPRIATE LOCATIONS. THE USE OF REGIONALLY NATIVE TREES FOR STREET TREES, WHILE BUFFER PEDESTRIANS FROM VEHICULAR AREAS AND PROVIDE A COMFORTABLE PEDESTRIAN SCALE TO THE

PLANTING AND IRRIGATION INSTALLATION DETAILS SHALL MEET CITY OF ALBUQUERQUE AND THE USDP REQUIREMENTS. EACH TREE SHALL HAVE A MINIMUM OF 36 SQUARE FEET OF PLANTING

C. PLANTING AND IRRIGATION MAINTENANCE SHALL BE THE RESPONSIBILITY OF THE PROPERTY OWNER

D. CONTROLLER: THE IRRIGATION SYSTEM SHALL BE RUN WITH A MINUTES FOR THE DRIP ZONES. RUN TIME WILL BE ADJUSTED ACCORDING TO SEASON, LOCATION, AND PLANT PERFORMANCE. DRIP EMITTERS SHALL BE USED FOR ALL PLANT MATERIAL

E. POINT OF CONNECTION: THERE IS LIKELY TO BE MORE THAN ONE POINT OF CONNECTION FOR THIS PROJECT. THE WATER CONNECTION LOCATIONS WILL BE COORDINATED WITH THE OVERALL WATER SERVICE DESIGN FOR THE SITE. THE EXACT LOCATIONS FOR CONNECTIONS AND CONTROLLERS IN UNKNOWN AT THIS TIME

F. MULCH: ALL PLANTING BEDS SHALL BE COVERED WITH MULCH. GRAVEL, BARK AND PECAN SHELL MULCHES WILL BE USED APPROPRIATELY TO ADD VISUAL INTEREST AND PROTECT SOIL MOISTURE

G. TREE AND SHRUB PITS TO BE 4 TIMES THE ROOTBALL DIAMETER H. THERE IS NO HIGH WATER USE TURF USED ON THIS PROJECT. THE LANDSCAPE DESIGN SHALL COMPLY WITH THE INTENT OF

LANDSCAPING AND WATER WASTE ORDINANCE J. SOIL PREPARATION AND AERATION WITHIN ROW IS REQUIRED TO

DE-COMPACT LANDSCAPE ZONE PRIOR TO PLANTING K. PASSIVE WATER HARVESTING, SUCH AS HARVESTING OF STORM WATER SURFACE RUNOFF AND ROOF RUNOFF, SHALL BE

UTILIZED WHERE FEASIBLE AND CAPTURED IN SWALES. L. SOIL AMENDMENTS WILL BE USED FOR PLANT MATERIAL. M. PLANT AND IRRIGATION MAINTENANCE WILL BE THE RESPONSIBILITY OF THE OWNER FOLLOWING SUBSTANTIAL

THE CITY OF ALBUQUERQUE WATER CONSERVATION

COMPLETION OR ANY MAINTENANCE PERIODS N. THE LANDSCAPE DESIGN REQUIRES A PERMANENT, FULLY AUTOMATIC IRRIGATION SYSTEM TO SUPPORT THE PLANT

O. THE IRRIGATION SYSTEM WILL BE CONNECTED TO CITY WATER THE POINT OF CONNECTION WILL CONSIST OF A WATER METER. BACKFLOW PREVENTER AND MASTERVALVE, SEE COA STD DETAIL

P. THE CONTRACTOR SHALL CREATE AN IRRIGATION PLAN TO PERMANENTLY IRRIGATE THE PROPOSED PLANTINGS, AND SHALL SUBMIT THIS TO THE ARCHITECT FOR REVIEW AND APPROVAL THE PLAN SHALL INCLUDE A PIPING AND EMITTER LAYOUT WITH

SIZING, VALVE SCHEDULE AND CONSTRUCTION DETAILS. Q. CONTROLLER: THE IRRIGATION SYSTEM SHALL BE RUN WITH FULLY AUTOMATED IRRIGATION CONTROLLER. RUN TIME WILL BE ADJUSTED ACCORDING TO PLANT MATURITY, SEASON, LOCATION. AND PLANT PERFORMANCE.

R. DRIP EMITTERS SHALL BE USED FOR ALL PLANT MATERIAL S. REFER TO DRAINAGE PLAN FOR GRADING INFORMATION AND

WATER HARVESTING LOCATIONS T. THE LANDSCAPE BERM WILL BE CONSTRUCTED A MINIMUM OF 5'-0" AWAY FROM THE SIDEWALK AND WILL HAVE A MAXIMUM SLOPE OF 4:1. IRRIGATION SPRAY HEADS WILL BE LOCATED A MINIMUM OF 2'-0" AWAY FROM THE SIDEWALK. THE LANDSCAPE AREA WILL NOT BE IRRIGATED IN THE WINTER. THESE DESIGN OPERATION PARAMETERS SHOULD ELIMINATE ANY ICING, OVERSPRAY AND DRAINAGE ISSUES.

landscape planning engineering 7601 Jefferson NE Suite 100 Albuquerque, NM 87109 505 761-9700

architecture

interiors

fax 761-4222 |dps@dpsdesign.org ARCHITECT


ENGINEER

PROJECT

REVISIONS

DRAWN BY JG REVIEWED BY MB DATE 11/10/2011 PROJECT NO. 10-0135 DRAWING NAME

LANDSCAPE PLAN -PHASE I

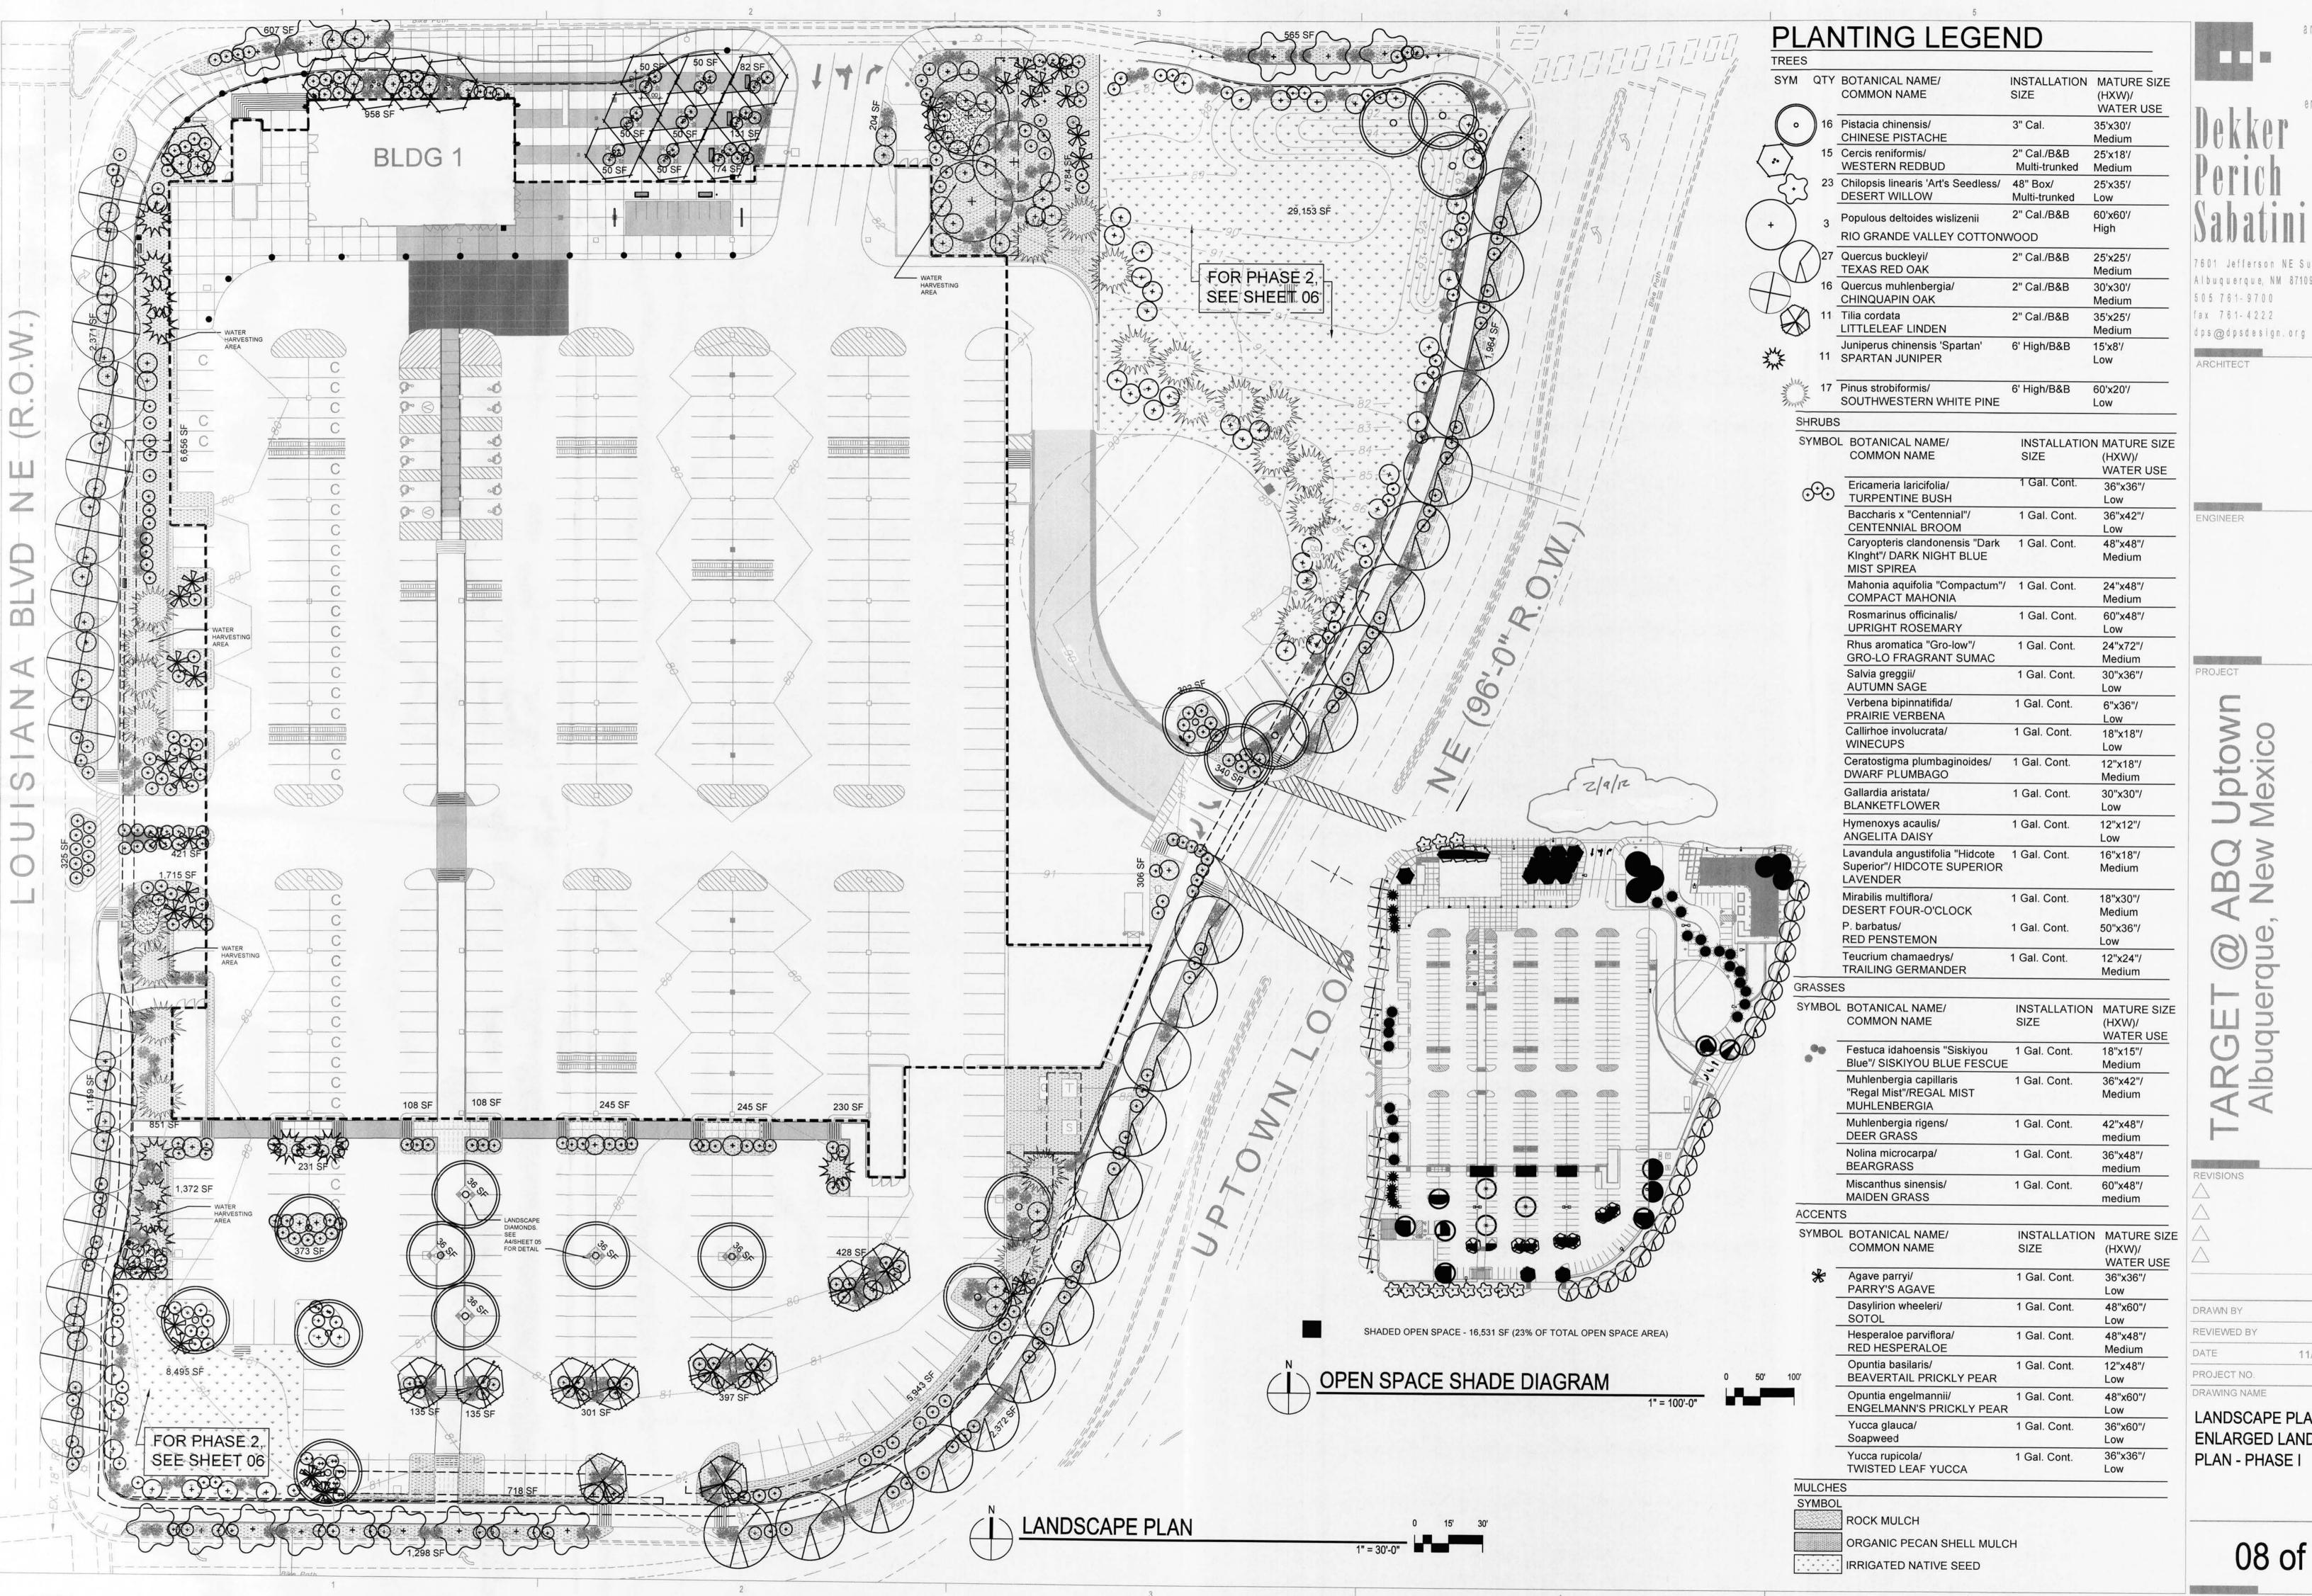



architecture interiors landscape planning engineering


7601 Jefferson NE Suite 100 Albuquerque, NM 87109


11/10/2011 10-0135


LANDSCAPE PLAN **ENLARGED LANDSCAPE** PLAN - PHASE I

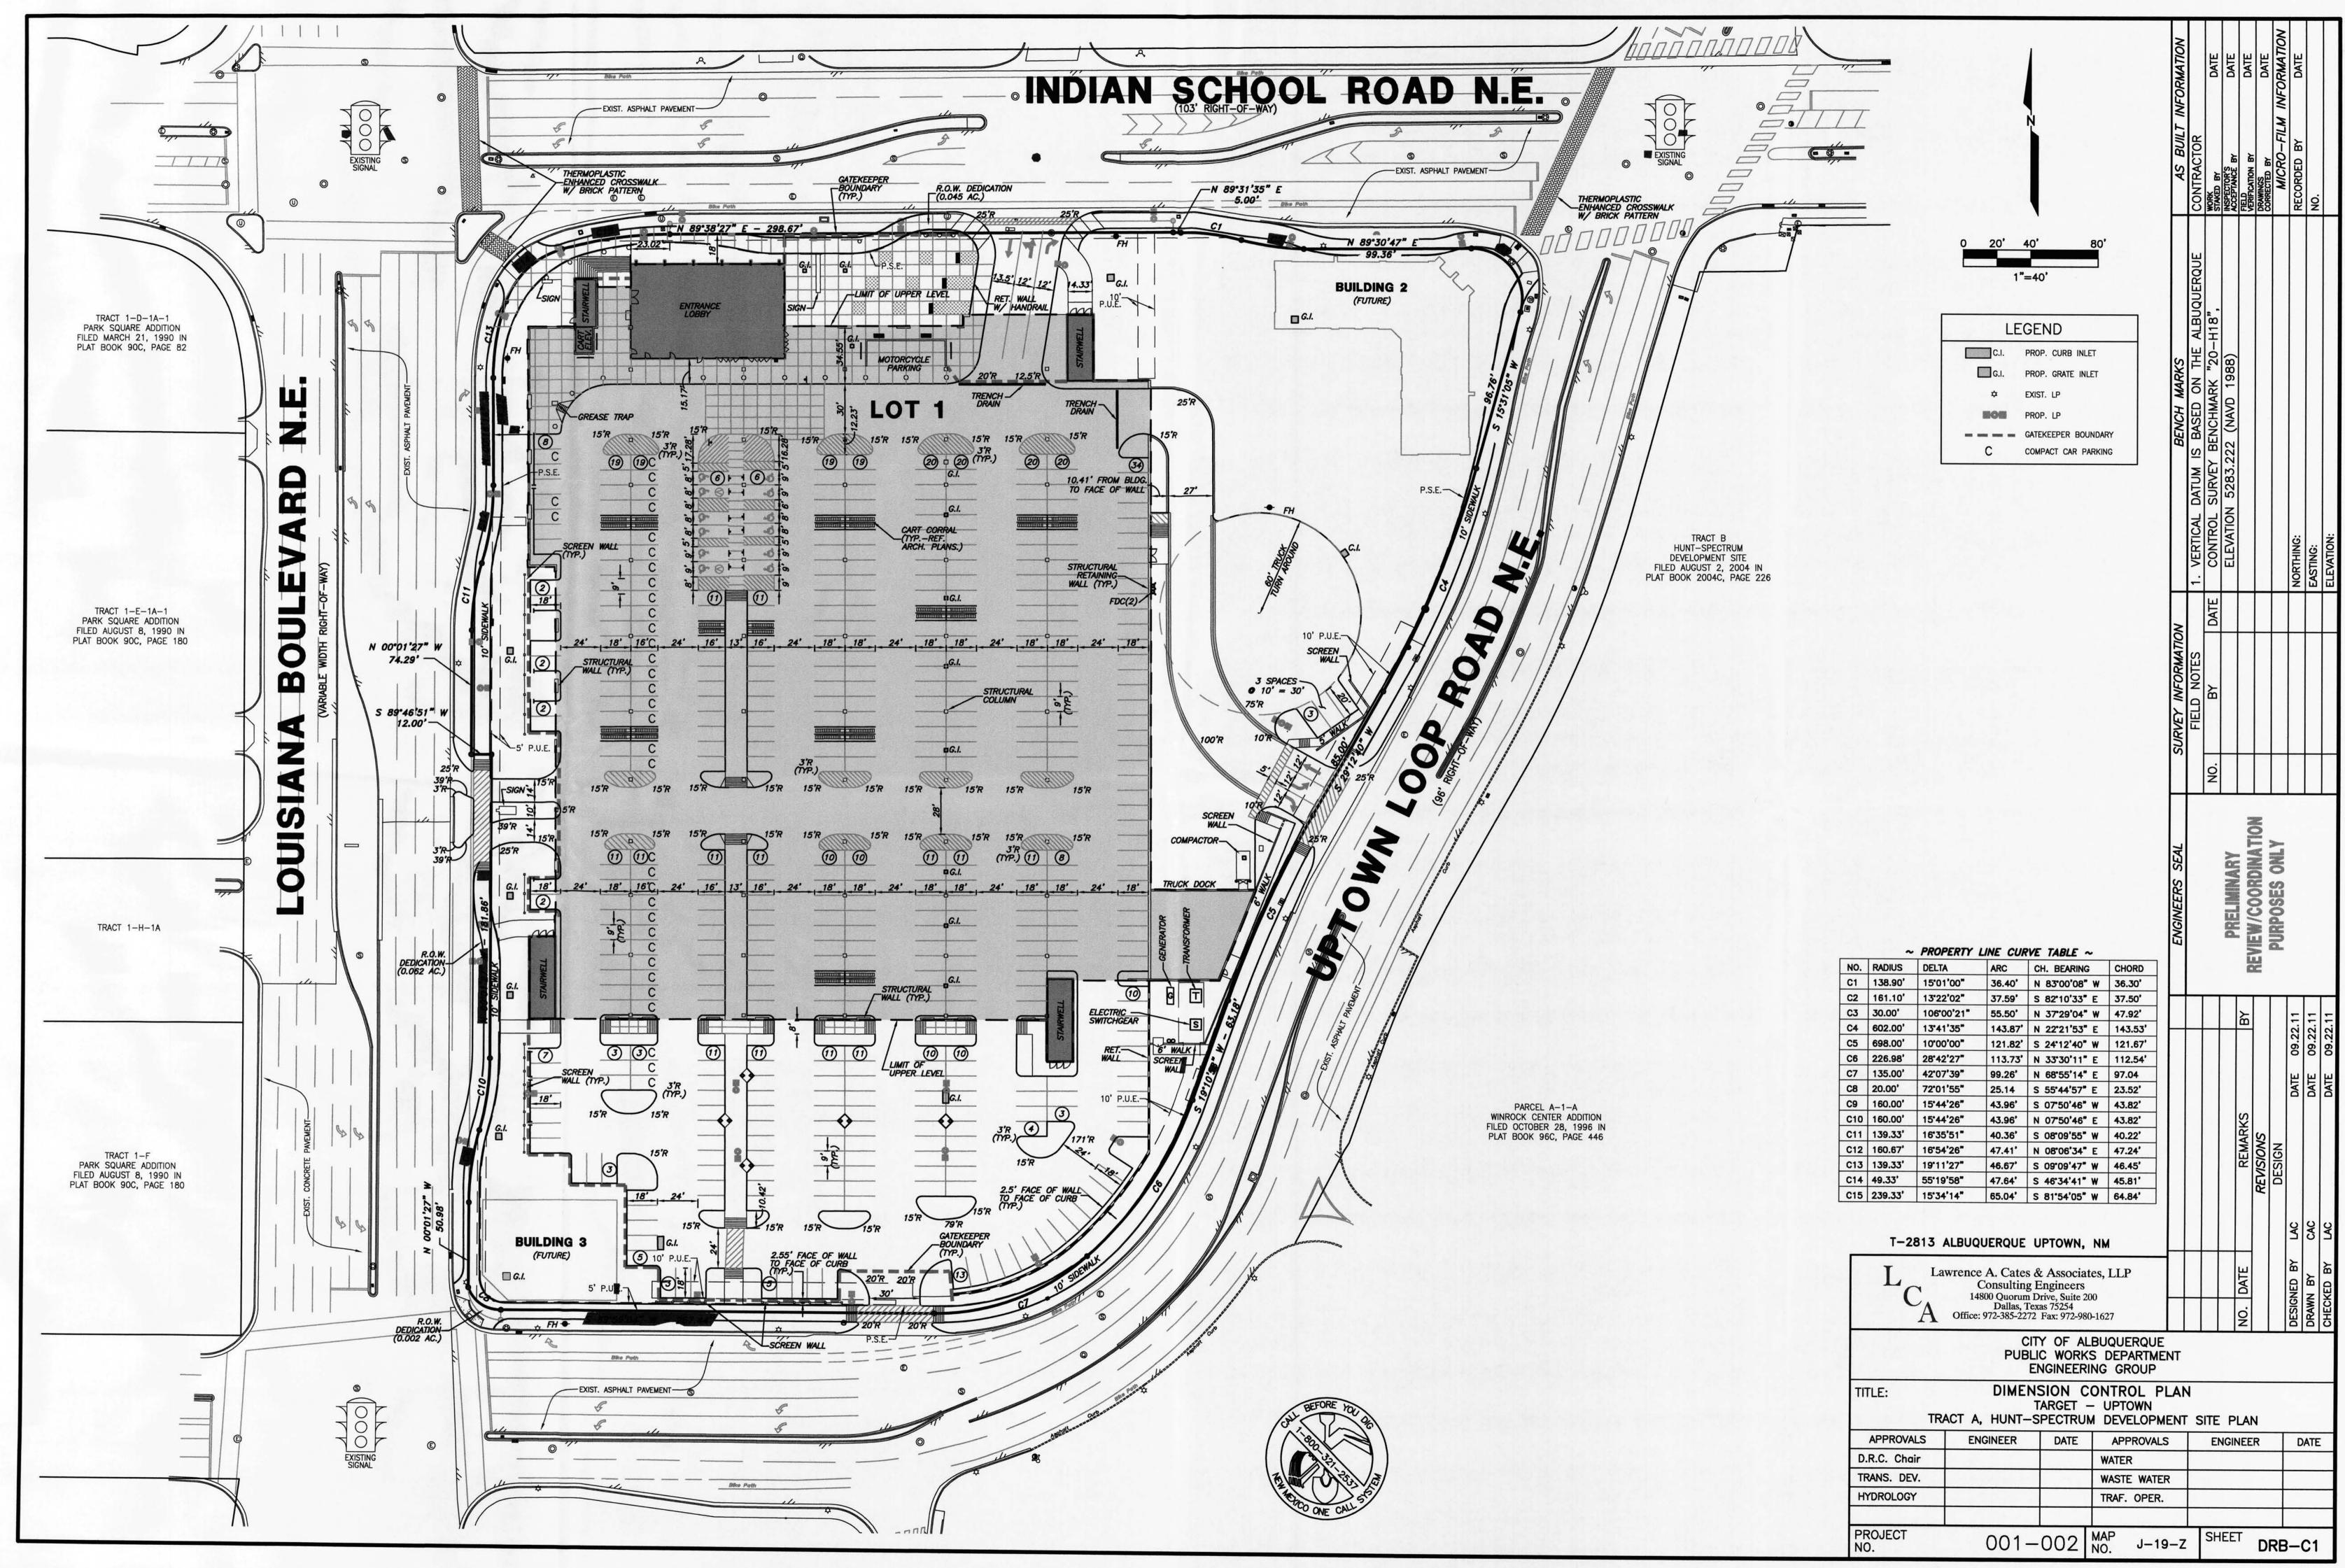


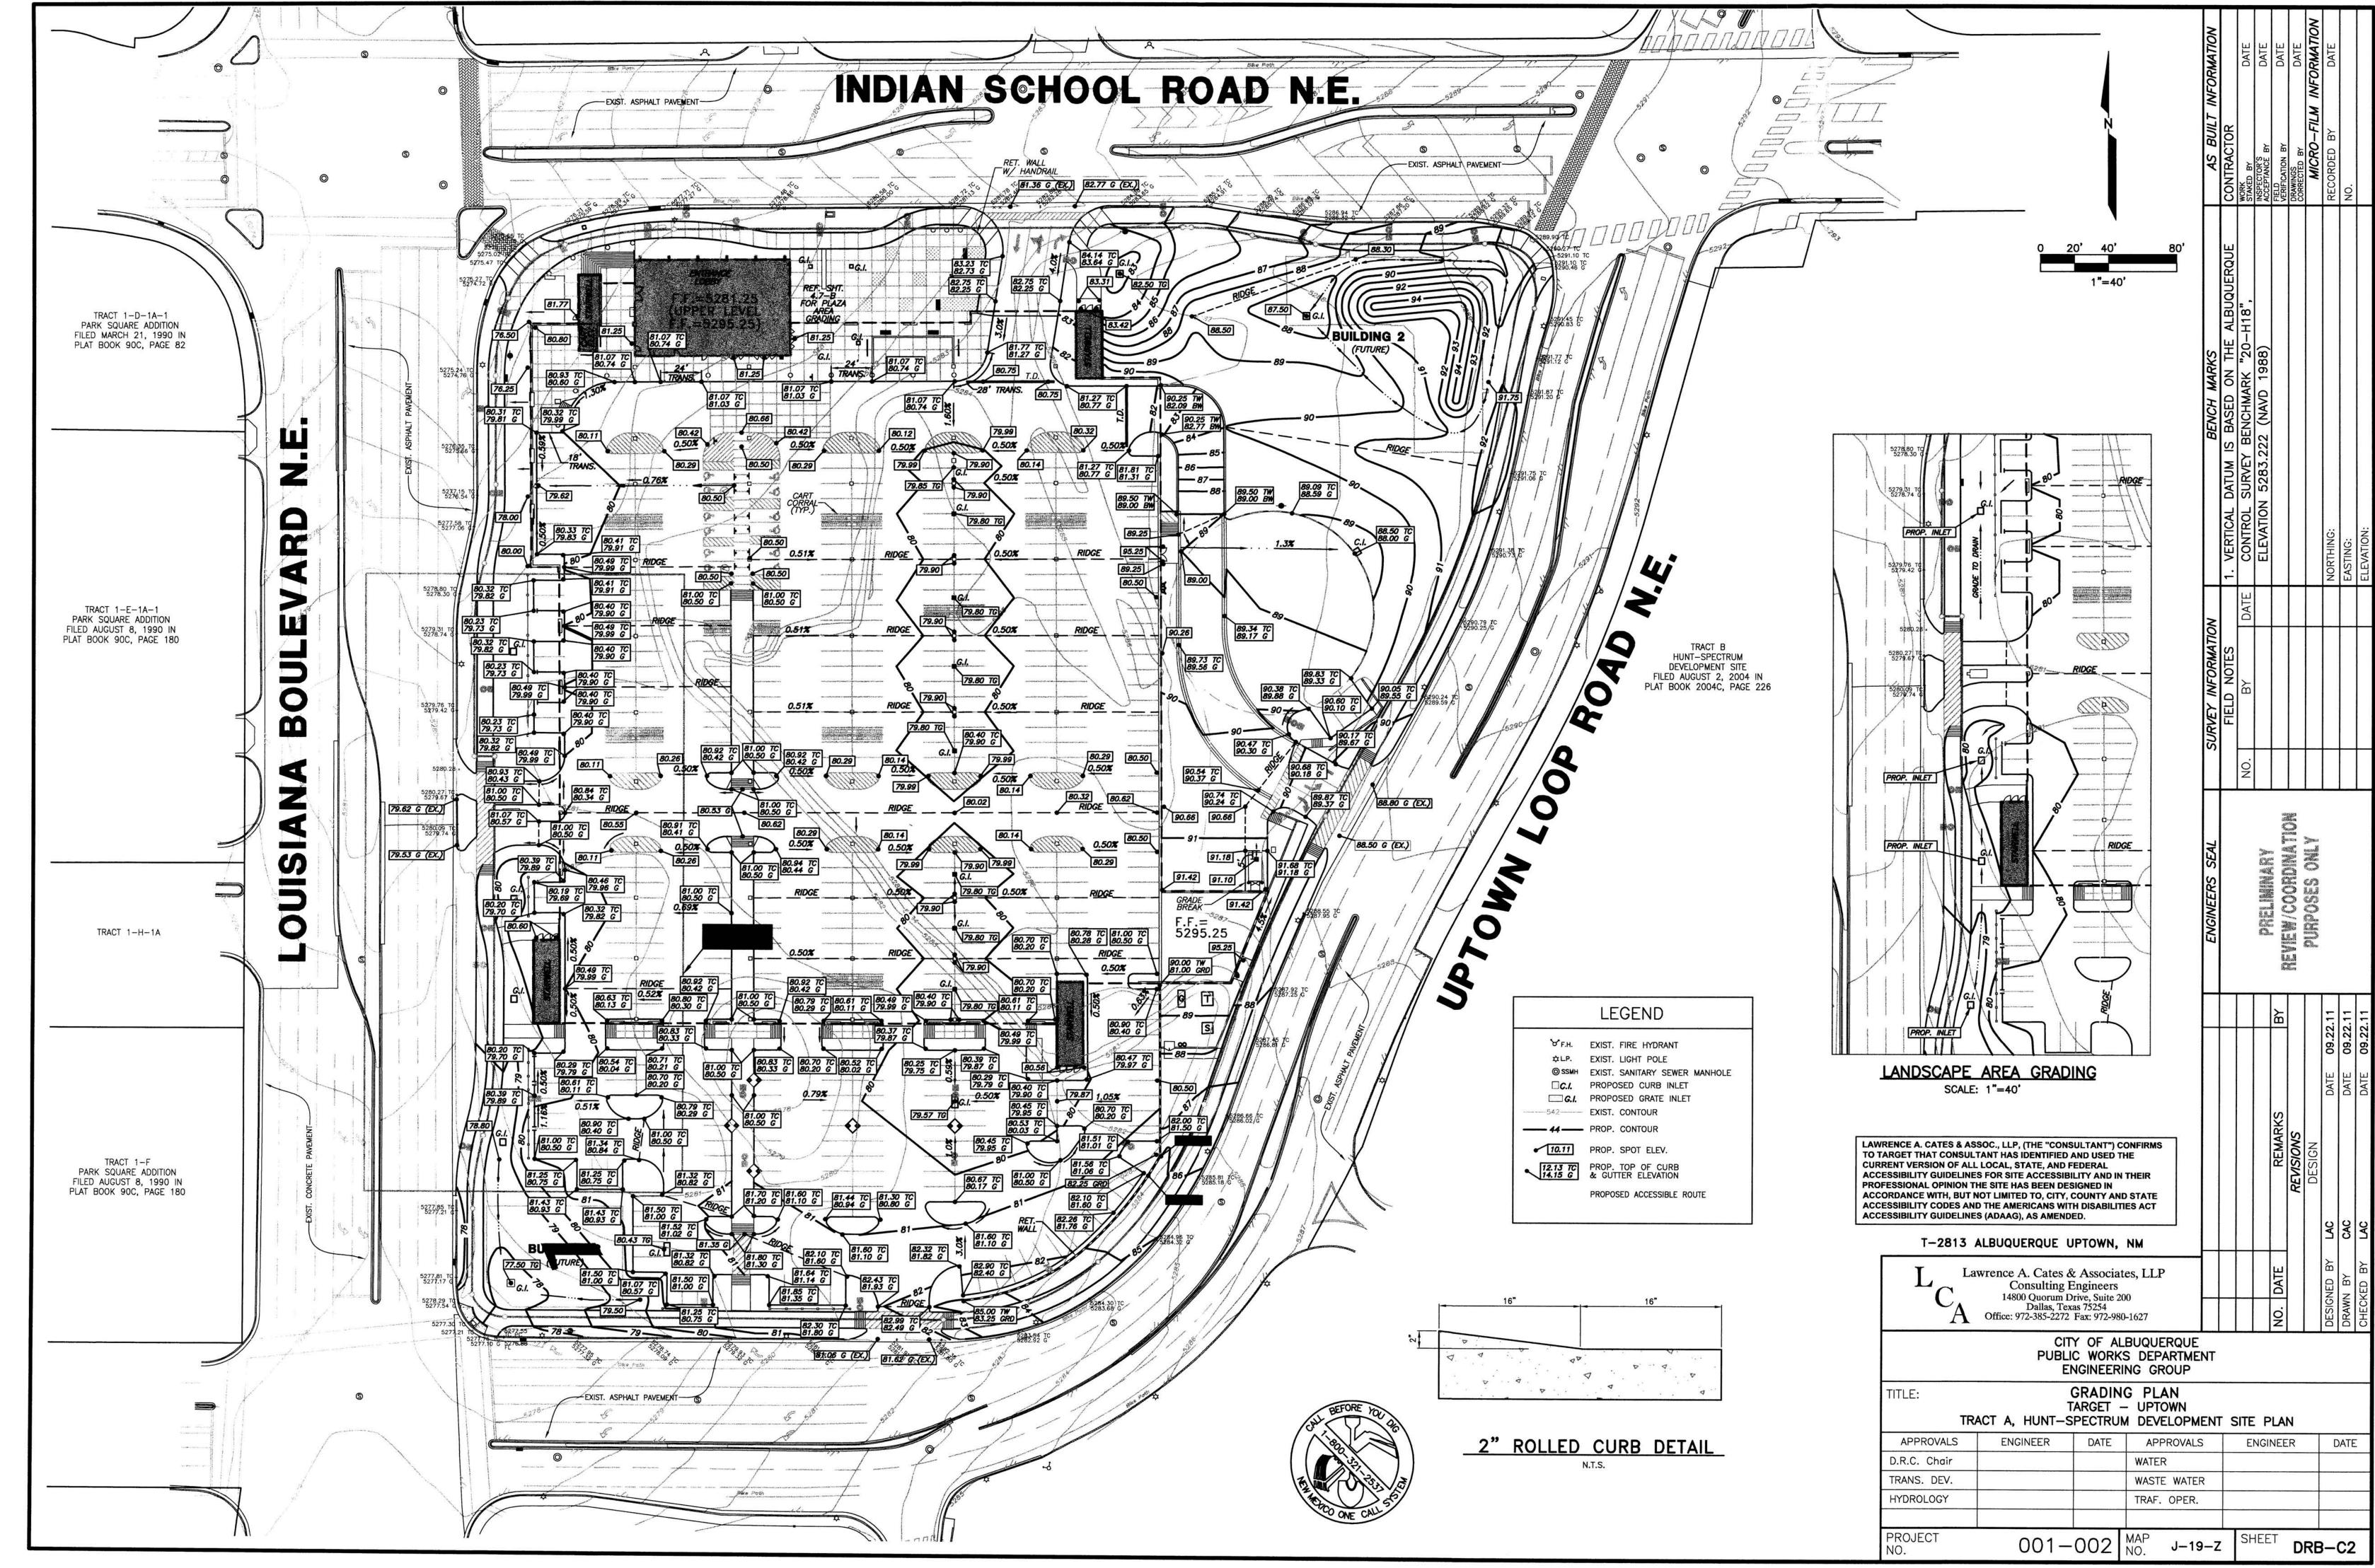


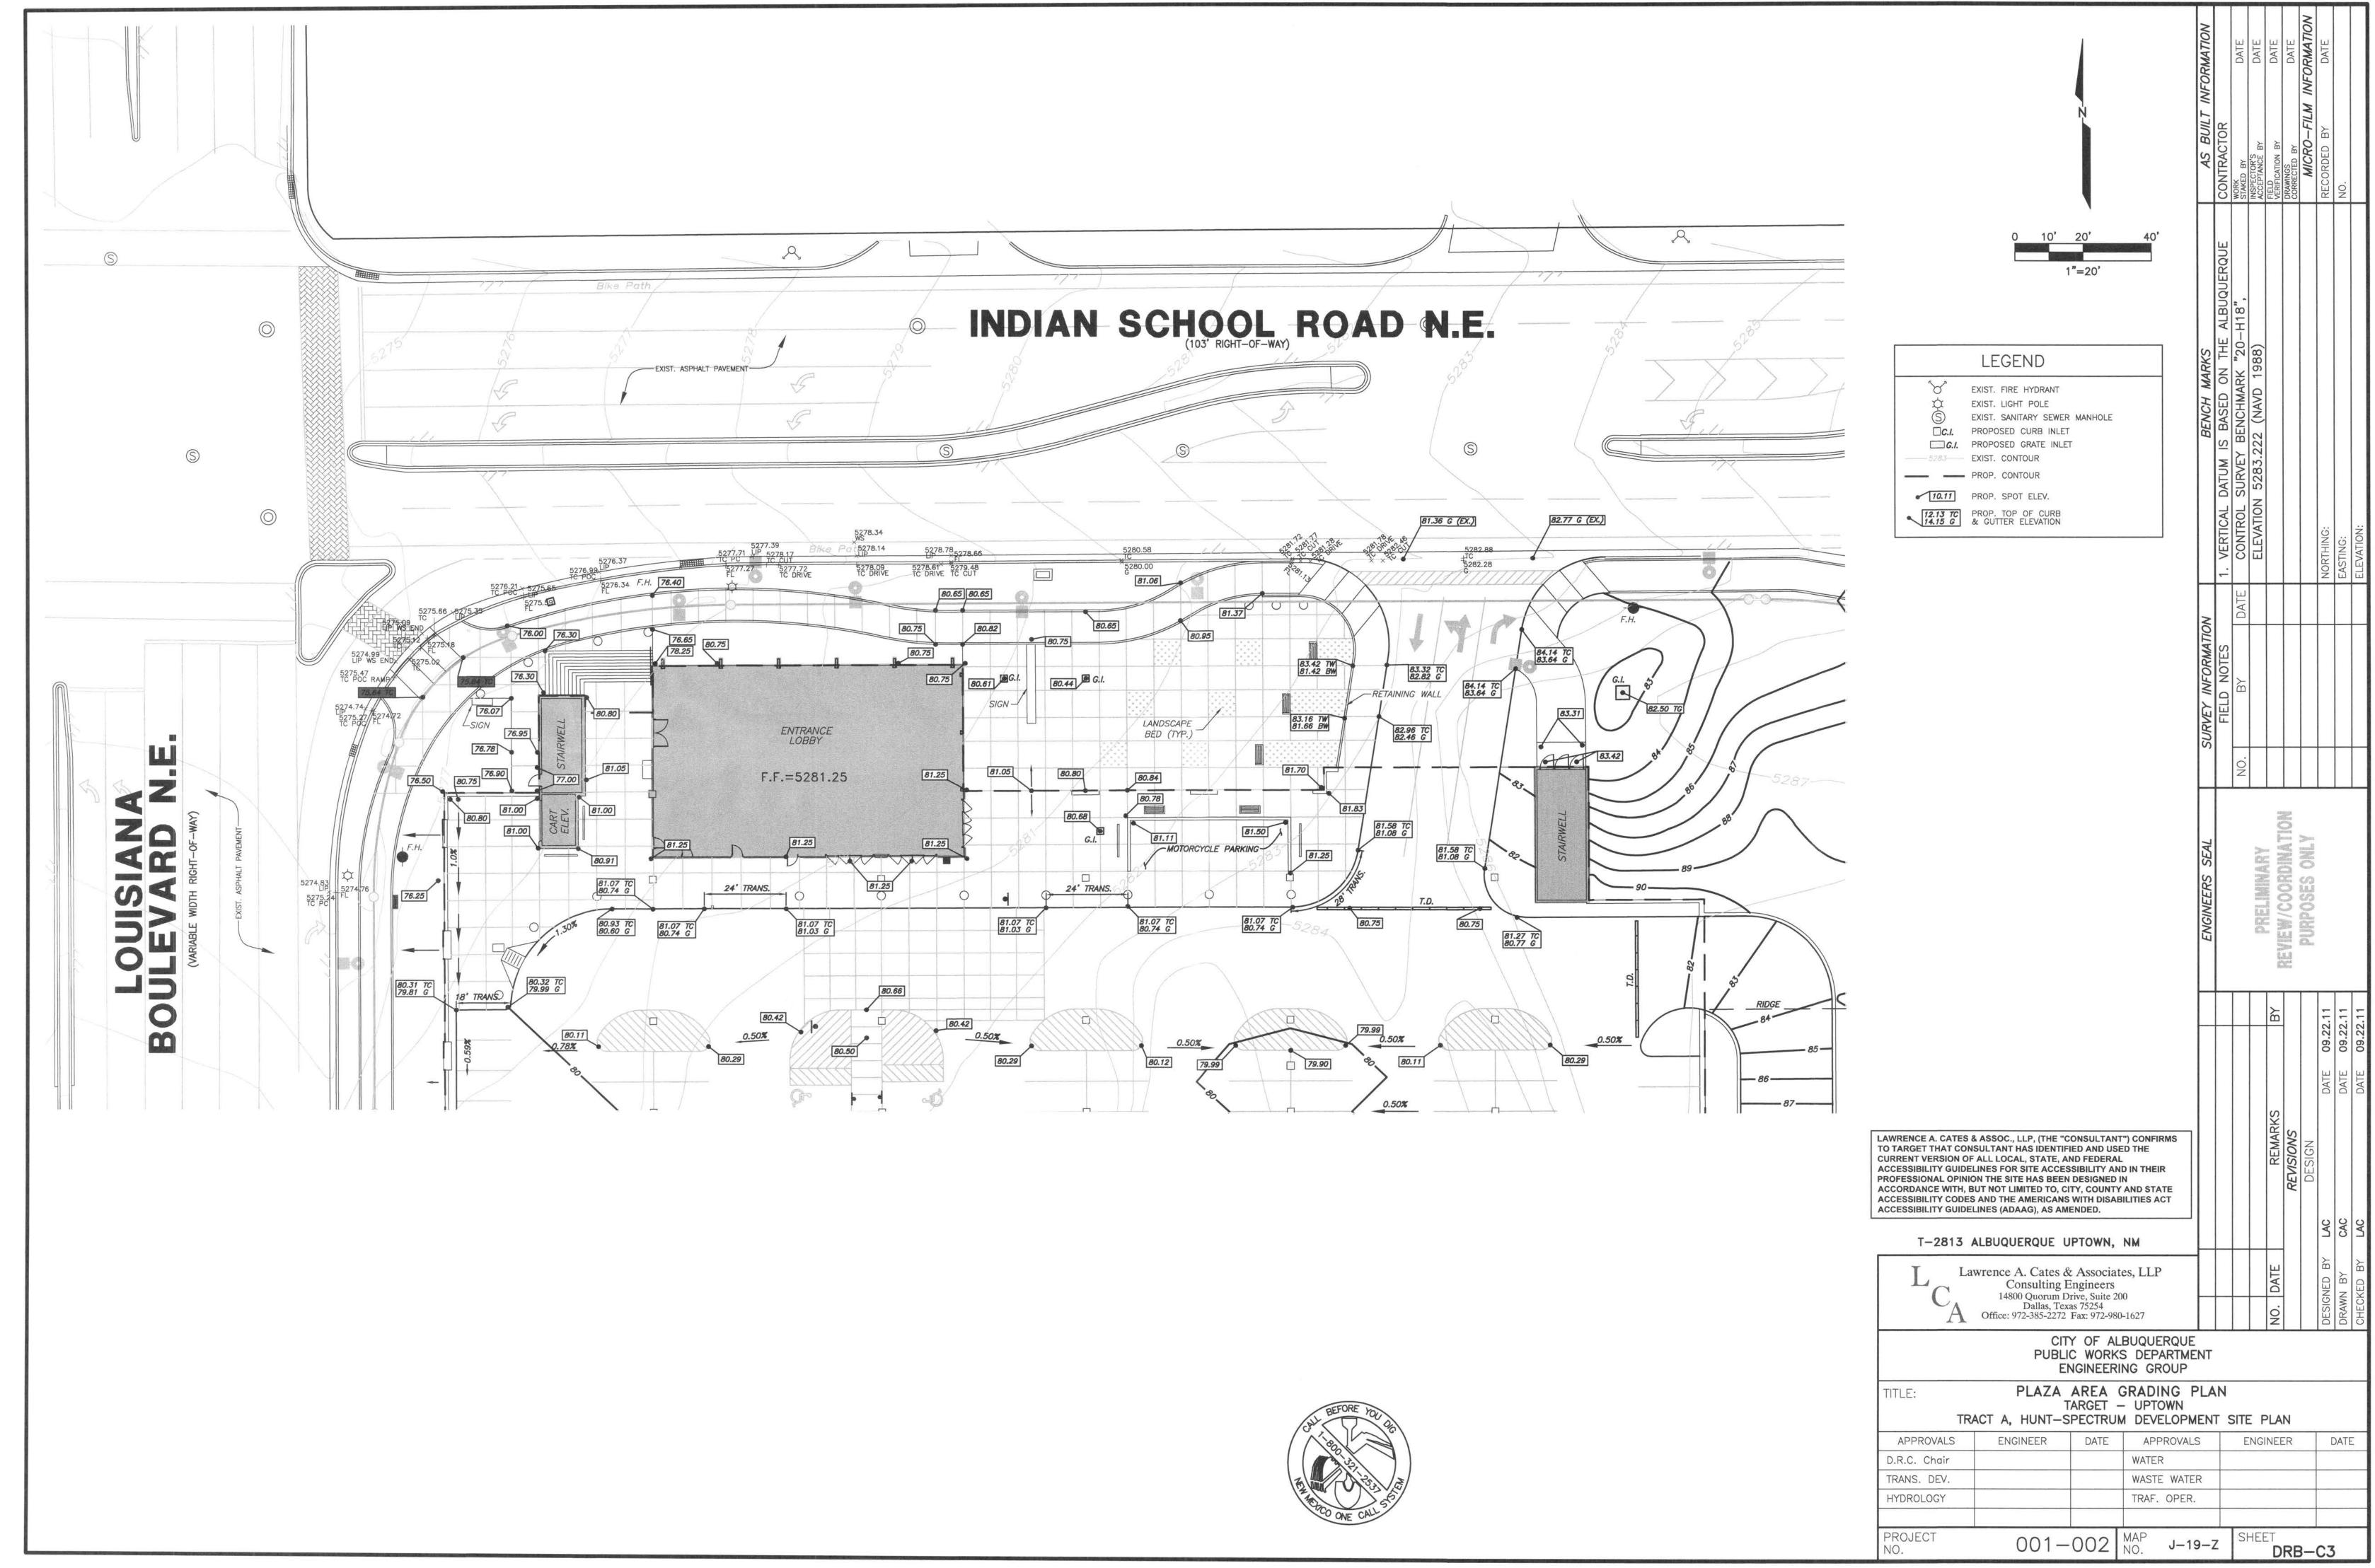


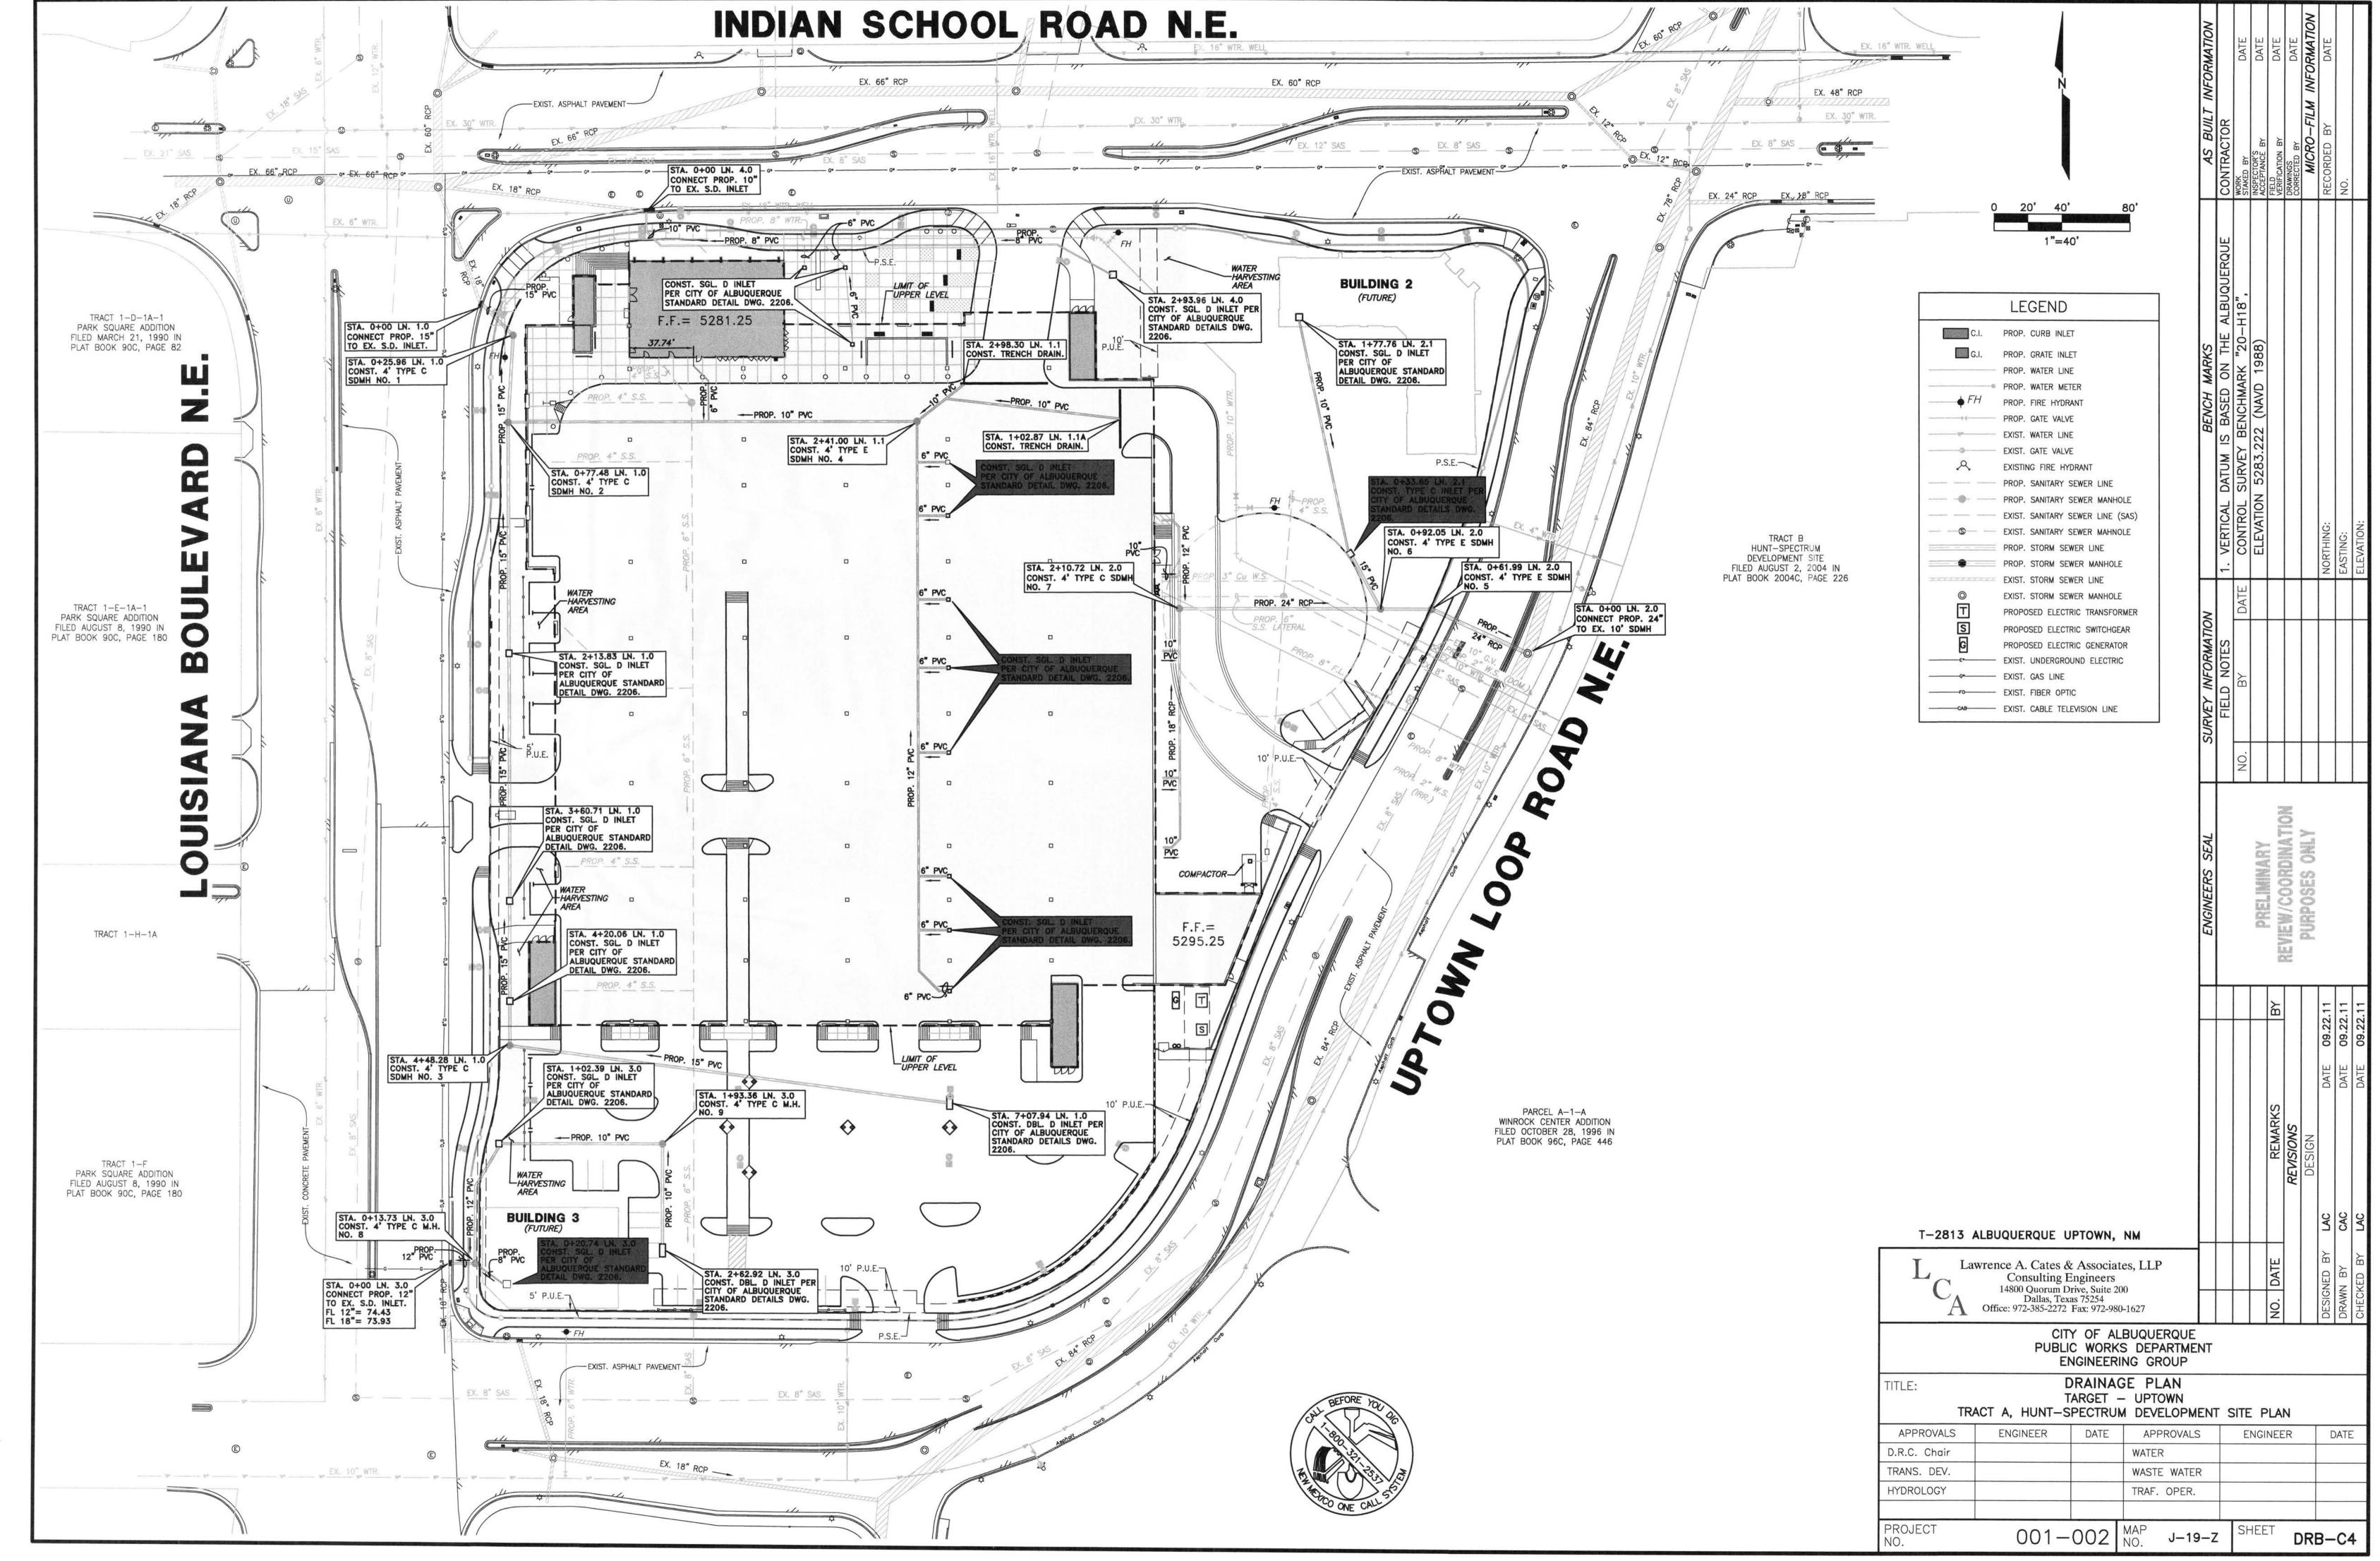

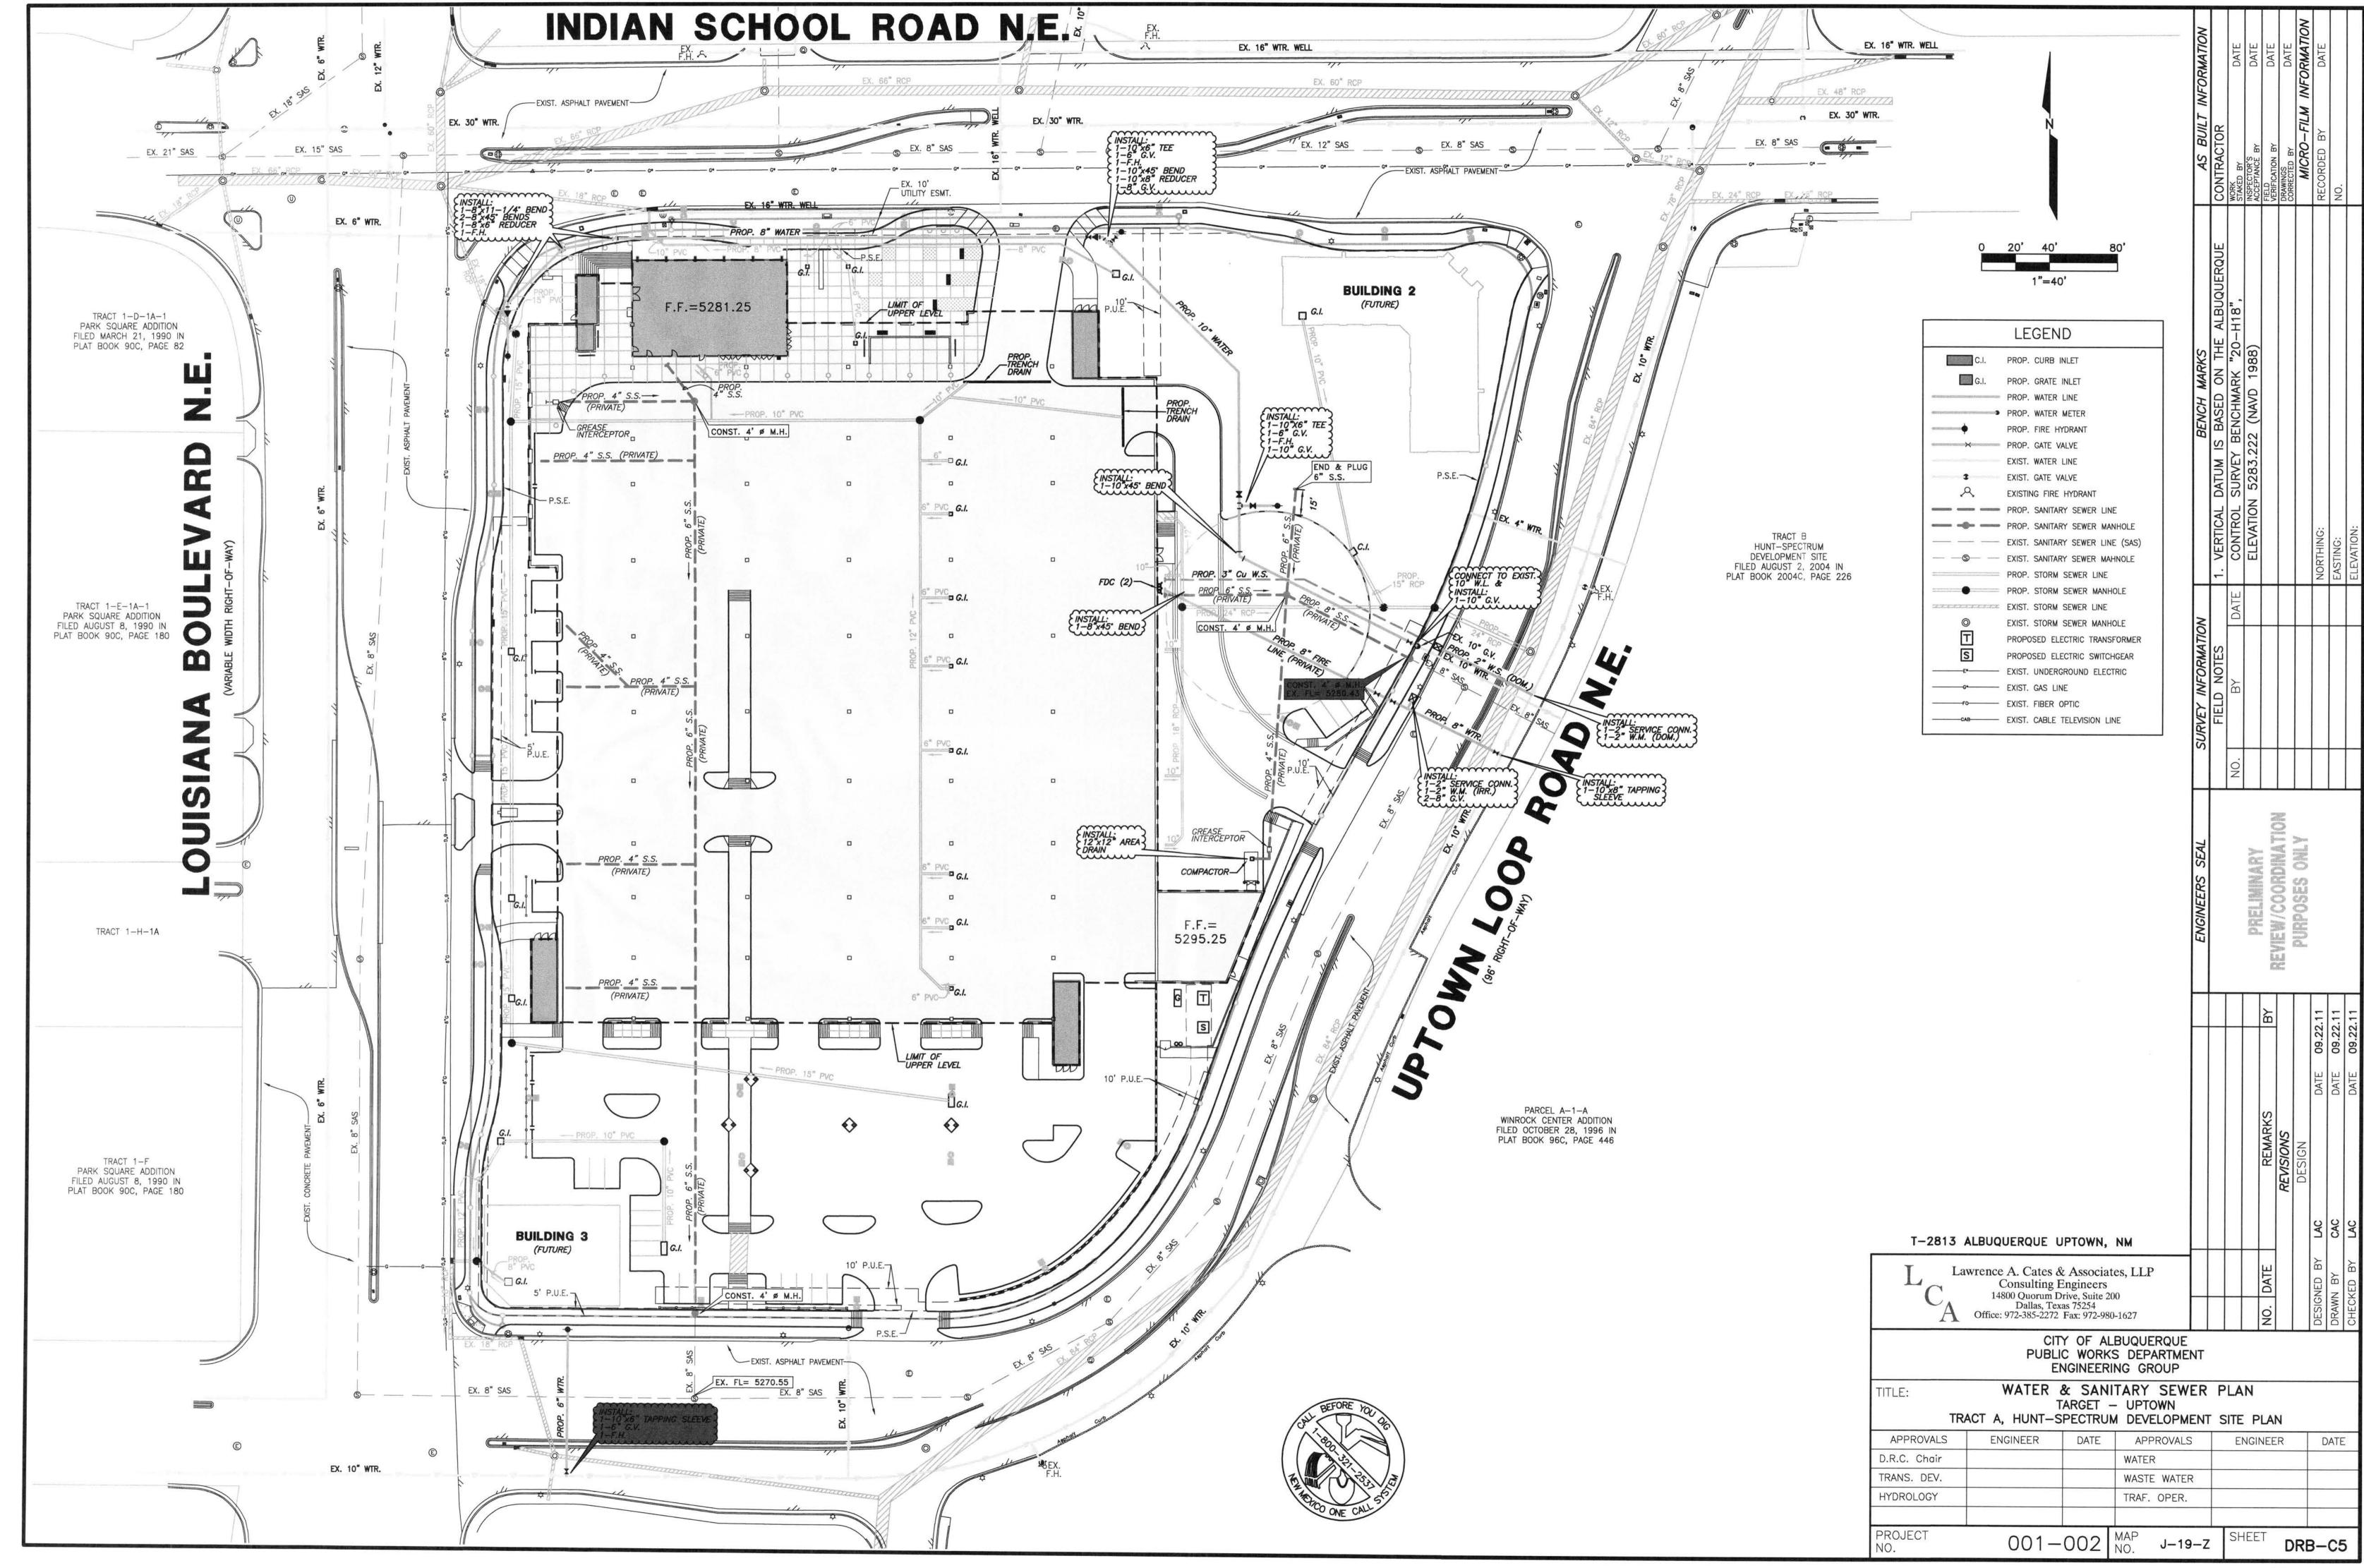

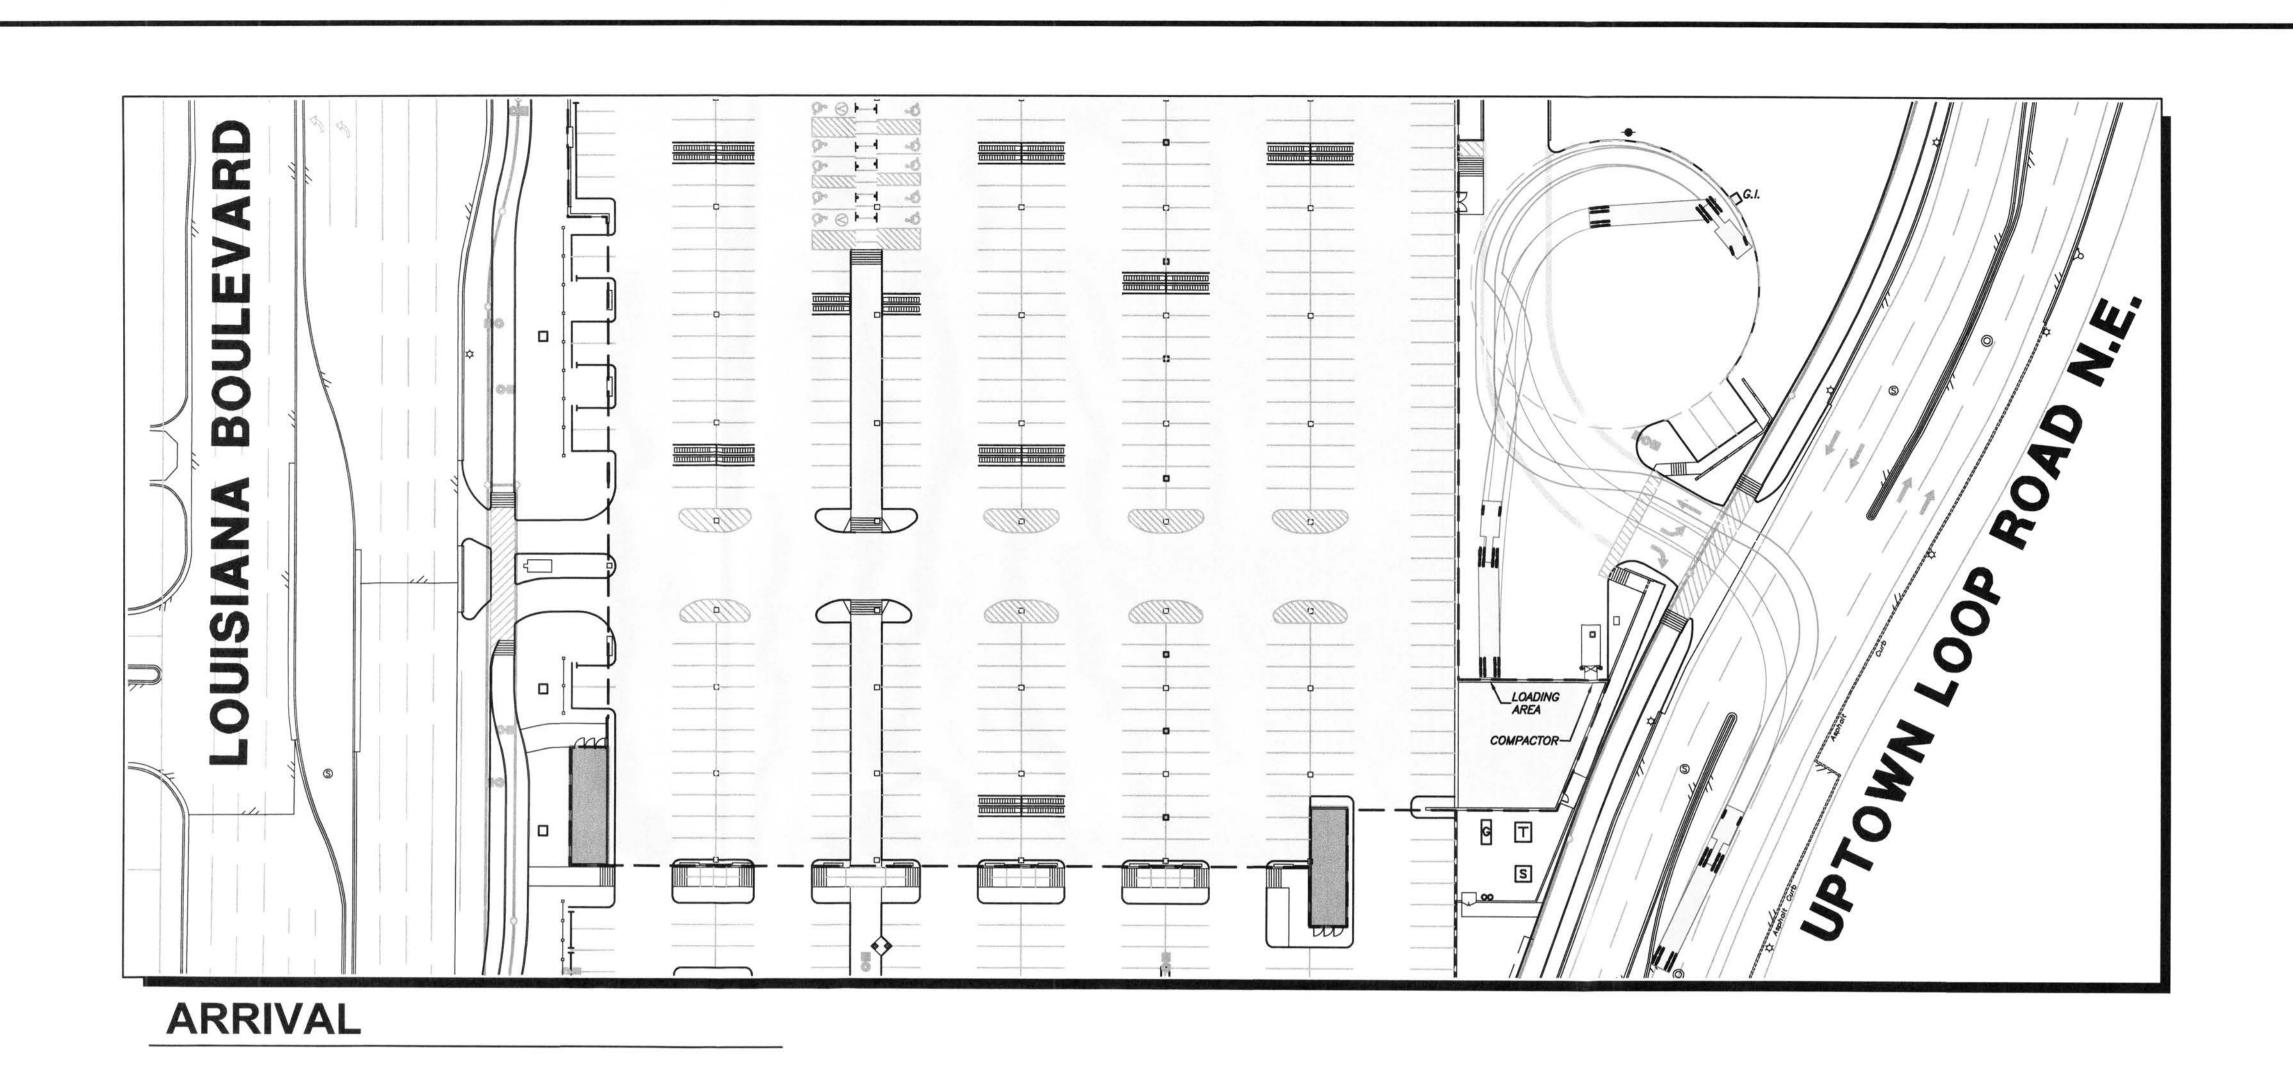


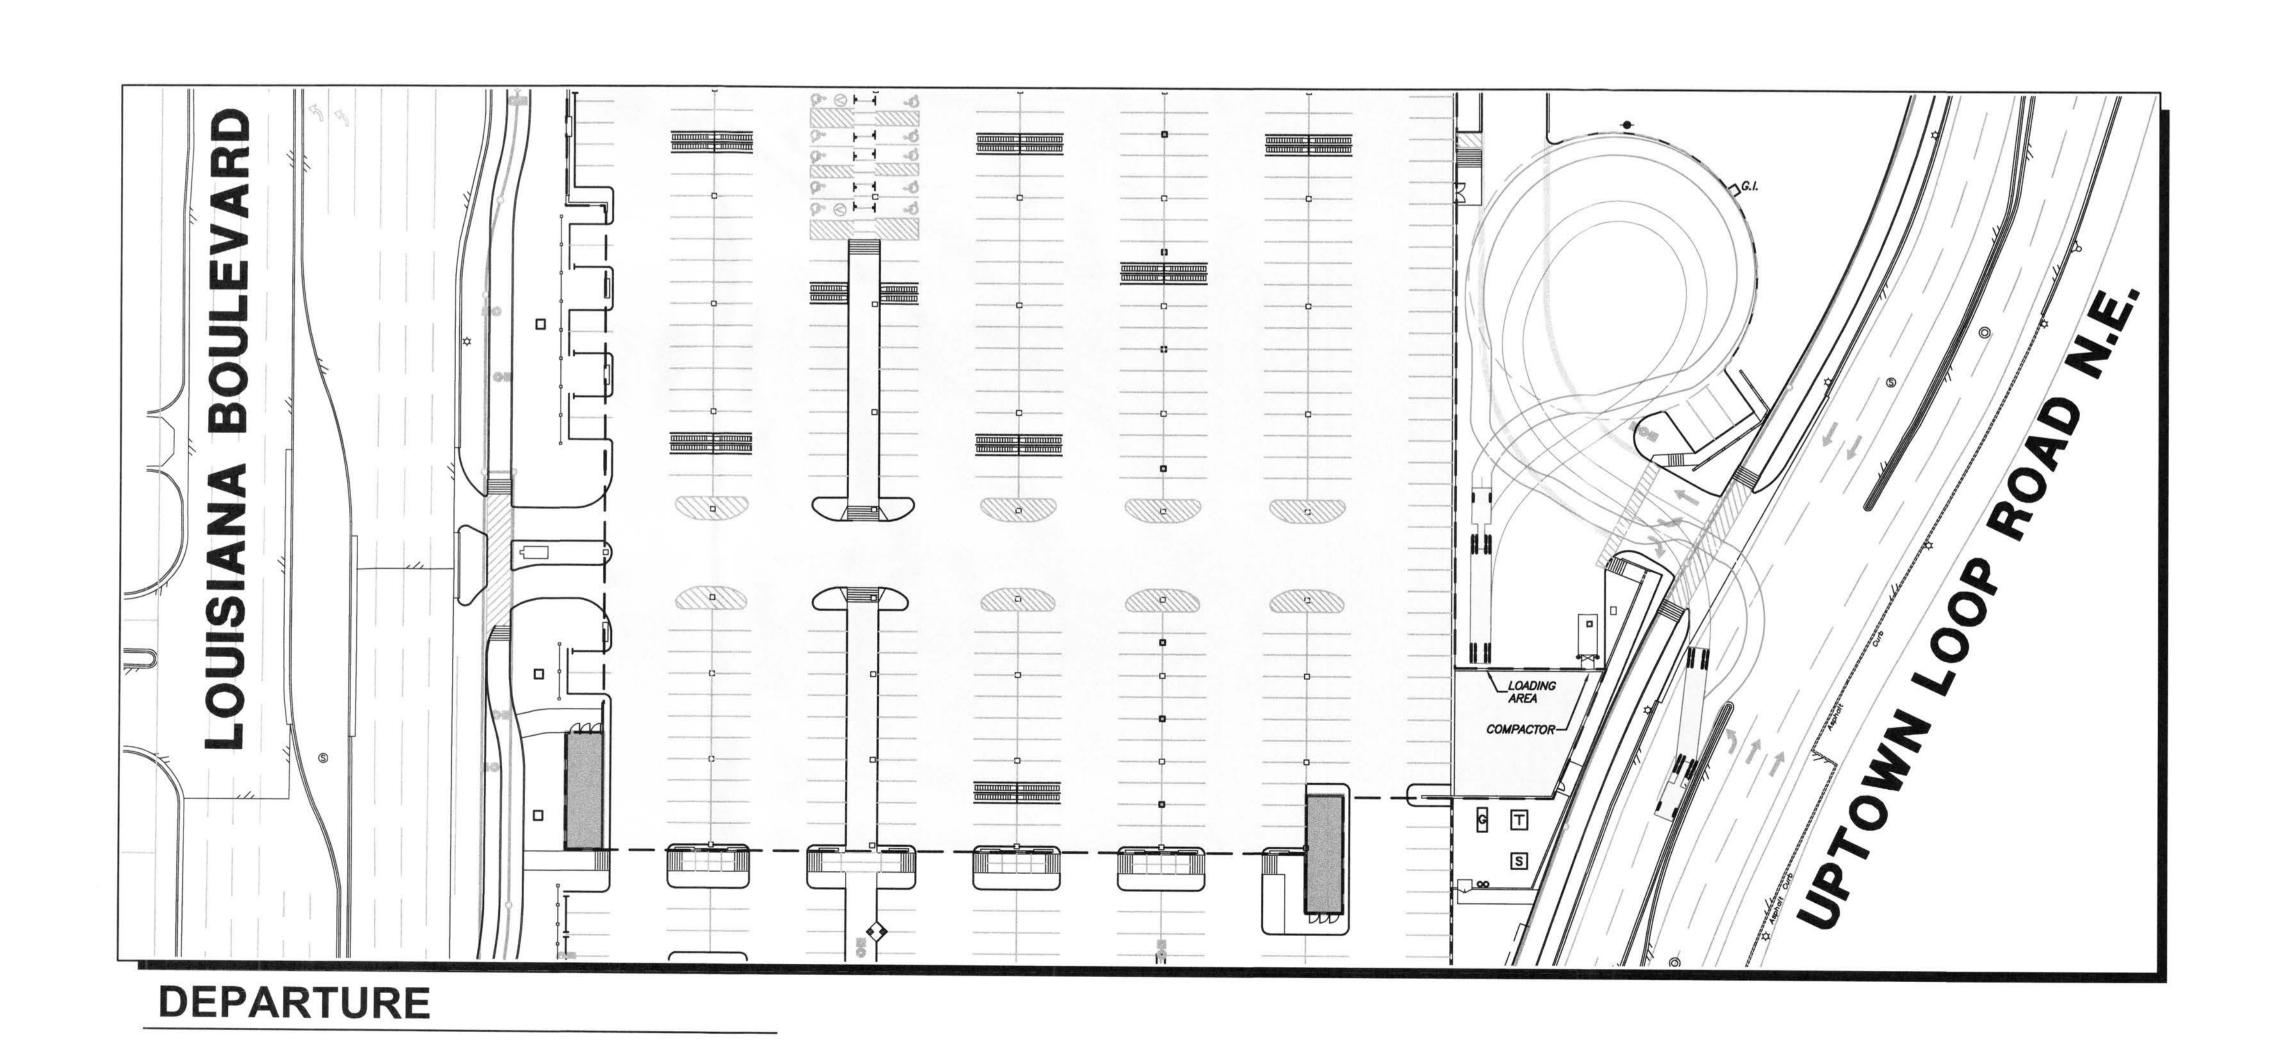

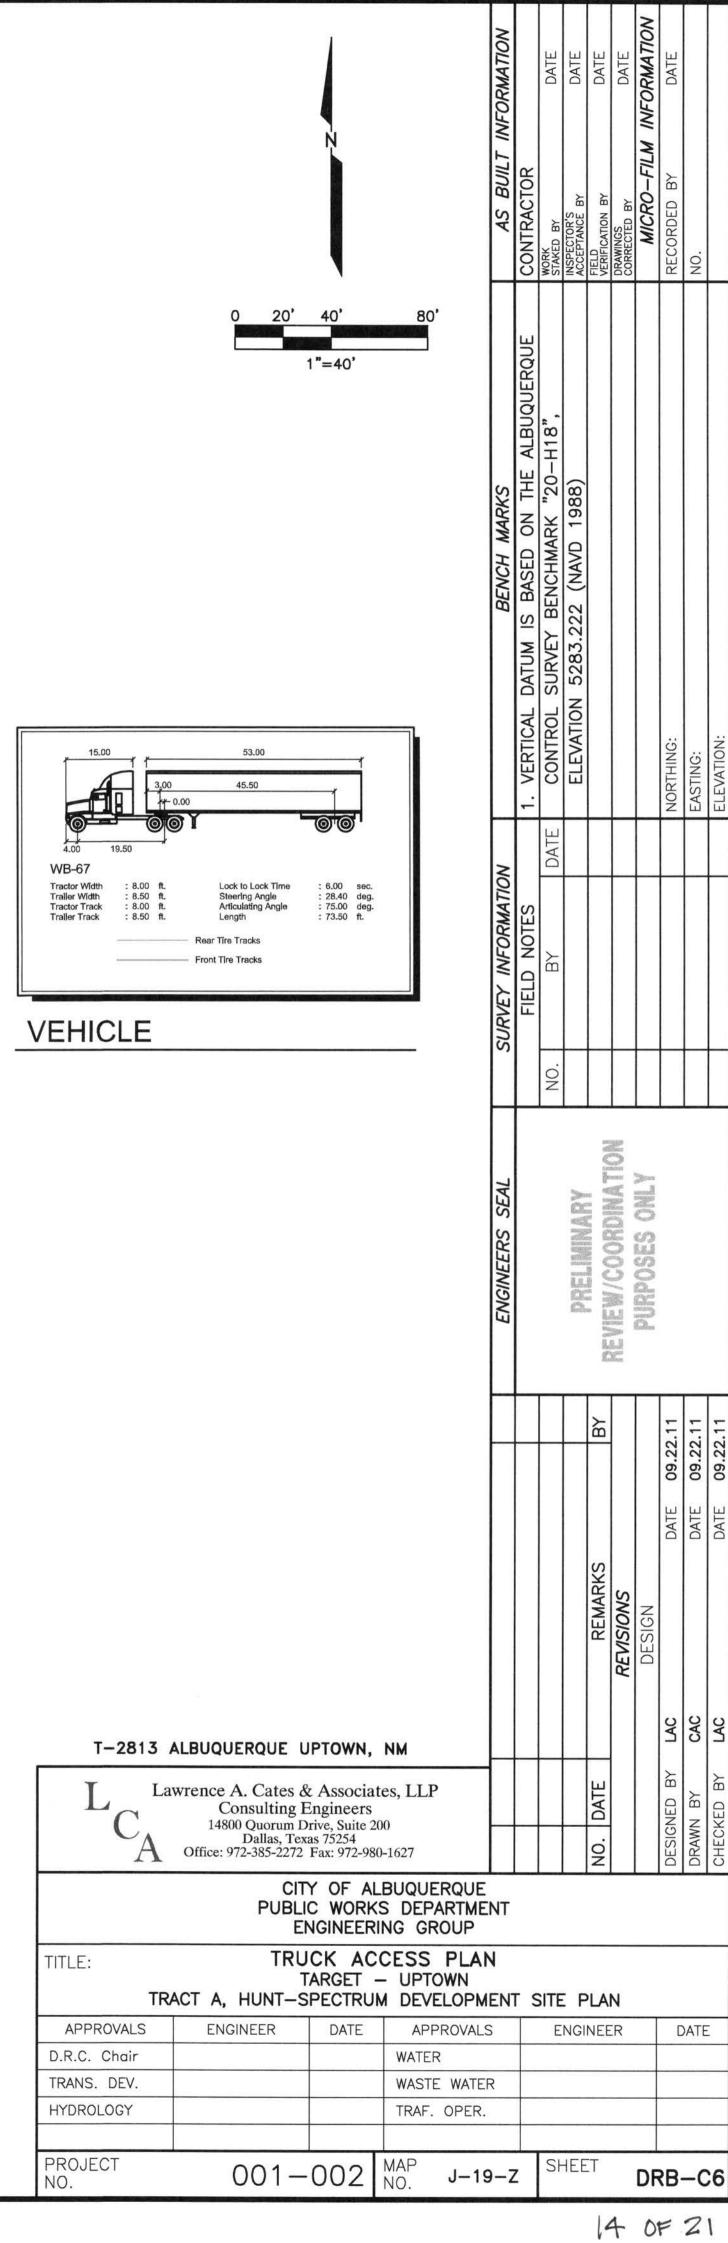



EAST ELEVATION SIMILAR OPPOSITE HAND

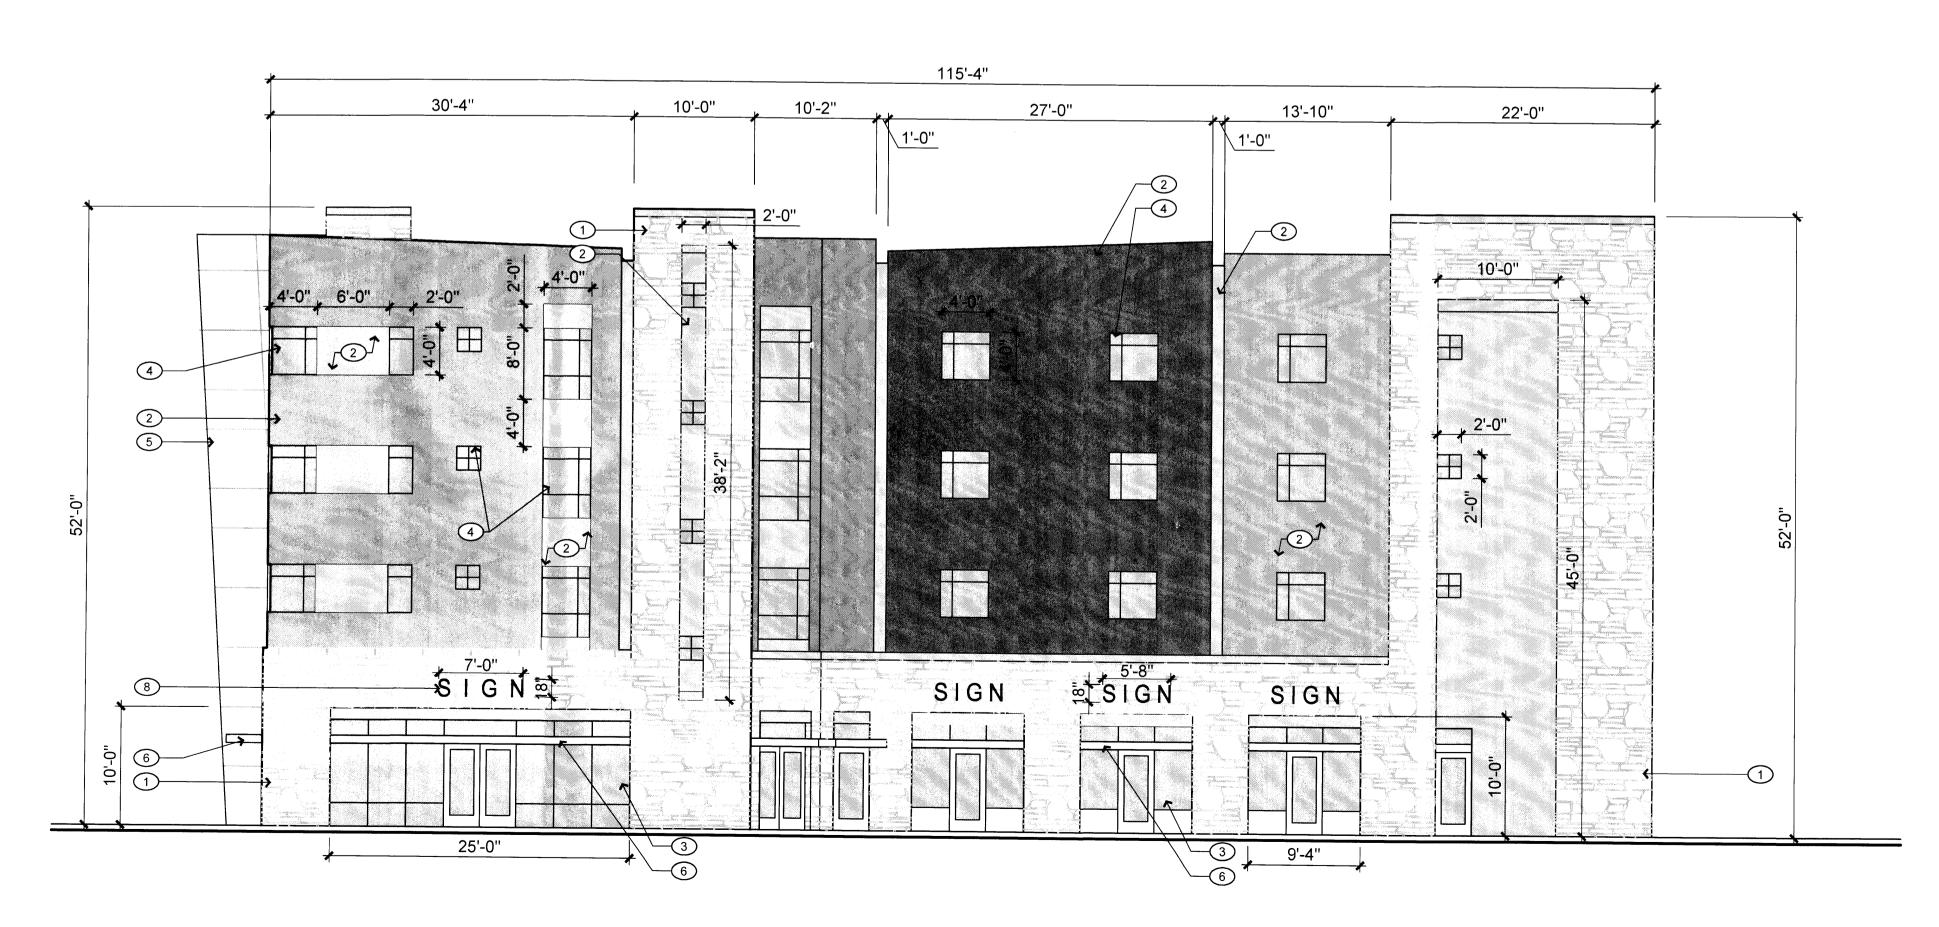

WEST ELEVATION

SOUTH ELEVATION SIMILAR OPPOSITE HAND 1/8" = 1'-0"



GENERAL NOTES

- A. ALL BUILDING FACADES SHALL BE COMPOSED OF THE DESIGN ELEMENTS SHOWN OR DESCRIBED IN THIS PLAN. DESIGN ELEMENTS INCLUDE, AS EXAMPLES, THE BUILDING COLORS, MASSING, WINDOWS, DOORS, TRELLIS AND PORTALS. THESE DESIGN ELEMENTS NEED NOT BE ARRANGED AS SHOWN ON THIS PLAN, BUT MAY BE FREELY INTERCHANGED TO ACCOMMODATE FUTURE TENANTS.
- B. ENTRY STOREFRONTS TO THE BUILDING MAY BE MODIFIED TO ACCOMMODATE SPECIFIC NEEDS OF FUTURE TENANTS. THESE STOREFRONTS ARE TO MAINTAIN THE OVERALL DESIGN INTENT OF THE BUILDINGS AS SHOWN AND MUST BE COMPATIBLE WITH THE BUILDING FACADES IN TERMS OF QUALITY OF MATERIALS AND SYSTEMS.
- C. SIGNAGE AS SHOWN IS FOR ILLUSTRATION PURPOSES AND MAY CHANGE TO MEET FUTURE TENANT REQUIREMENTS.

KEYED NOTES

- 1. CULTURED STONE
- 2. EXTERIOR INSULATION AND FINISH SYSTEM (STUCCO), SEE FINISH LEGEND FOR COLORS.
- 3. ALUMINUM STOREFRONT
- 4. OPERABLE ALUMINUM WINDOWS
- 5. METAL PANELS6. METAL AWNING
- 7. EIFS HEADER
- 8. SIGNAGE: INTERNALLY ILLUMINATED INDIVIDUAL LETTERS. BOX SIGNS NOT ALLOWED, EXCEPT FOR LOGOS. INDICATED SIZE IS APPROXIMATE.
- 9. BALCONY WITH METAL GUARD RAILING AND WOVEN WIRE MESH.
- 10. ALUMINUM OVERHEAD DOOR
- 11. STANDING SEAM METAL ROOF, GALVANIZED
- 12. HOLLOW METAL DOOR AND FRAME, PAINTED TO MATCH ADJACENT EIFS
- 13. STEEL TRELLIS PAINTED TO MATCH STUCCO 4
- 14. PAINTED STEEL SUPPORT RODS
- 15. PAINTED STEEL DECKING
- 16. PAINTED STEEL STRUCTURE

FINISH LEGEND

CULTURED STONE

STUCCO 1: LIGHT GREY

STUCCO 2: LIGHT BROWN

STUCCO 3: MEDIUM BROWN


STUCCO 4: DARK BROWN

GLAZING

ALUMINUM STOREFRONT AND METAL AWNINGS:

WHITE

METAL PANELS - CLEAR ANODIZED ALUMINUM

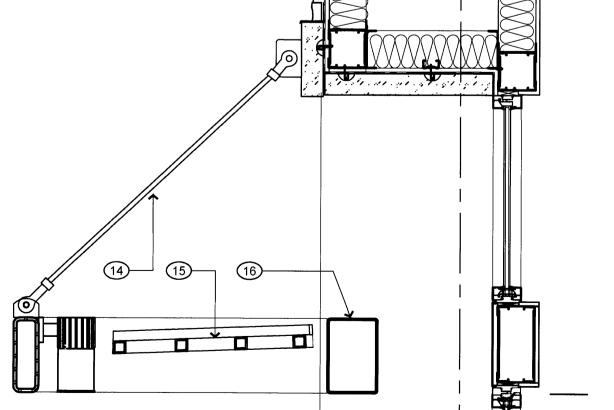

AWNING DETAIL

architecture interiors landscape planning

Dekker Perich Sabatini

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dps@dpsdesign.org

ARCHITECT

ENGINEER

PROJECT


FARGET @ ABQ Uptown Albuquerque, New Mexico

DRAWN BY CRG, TGB
REVIEWED BY CRG

DATE 11/10/2011
PROJECT NO. 10-0135

LOT 2 MIXED USE ELEVATIONS

DRAWING NAME

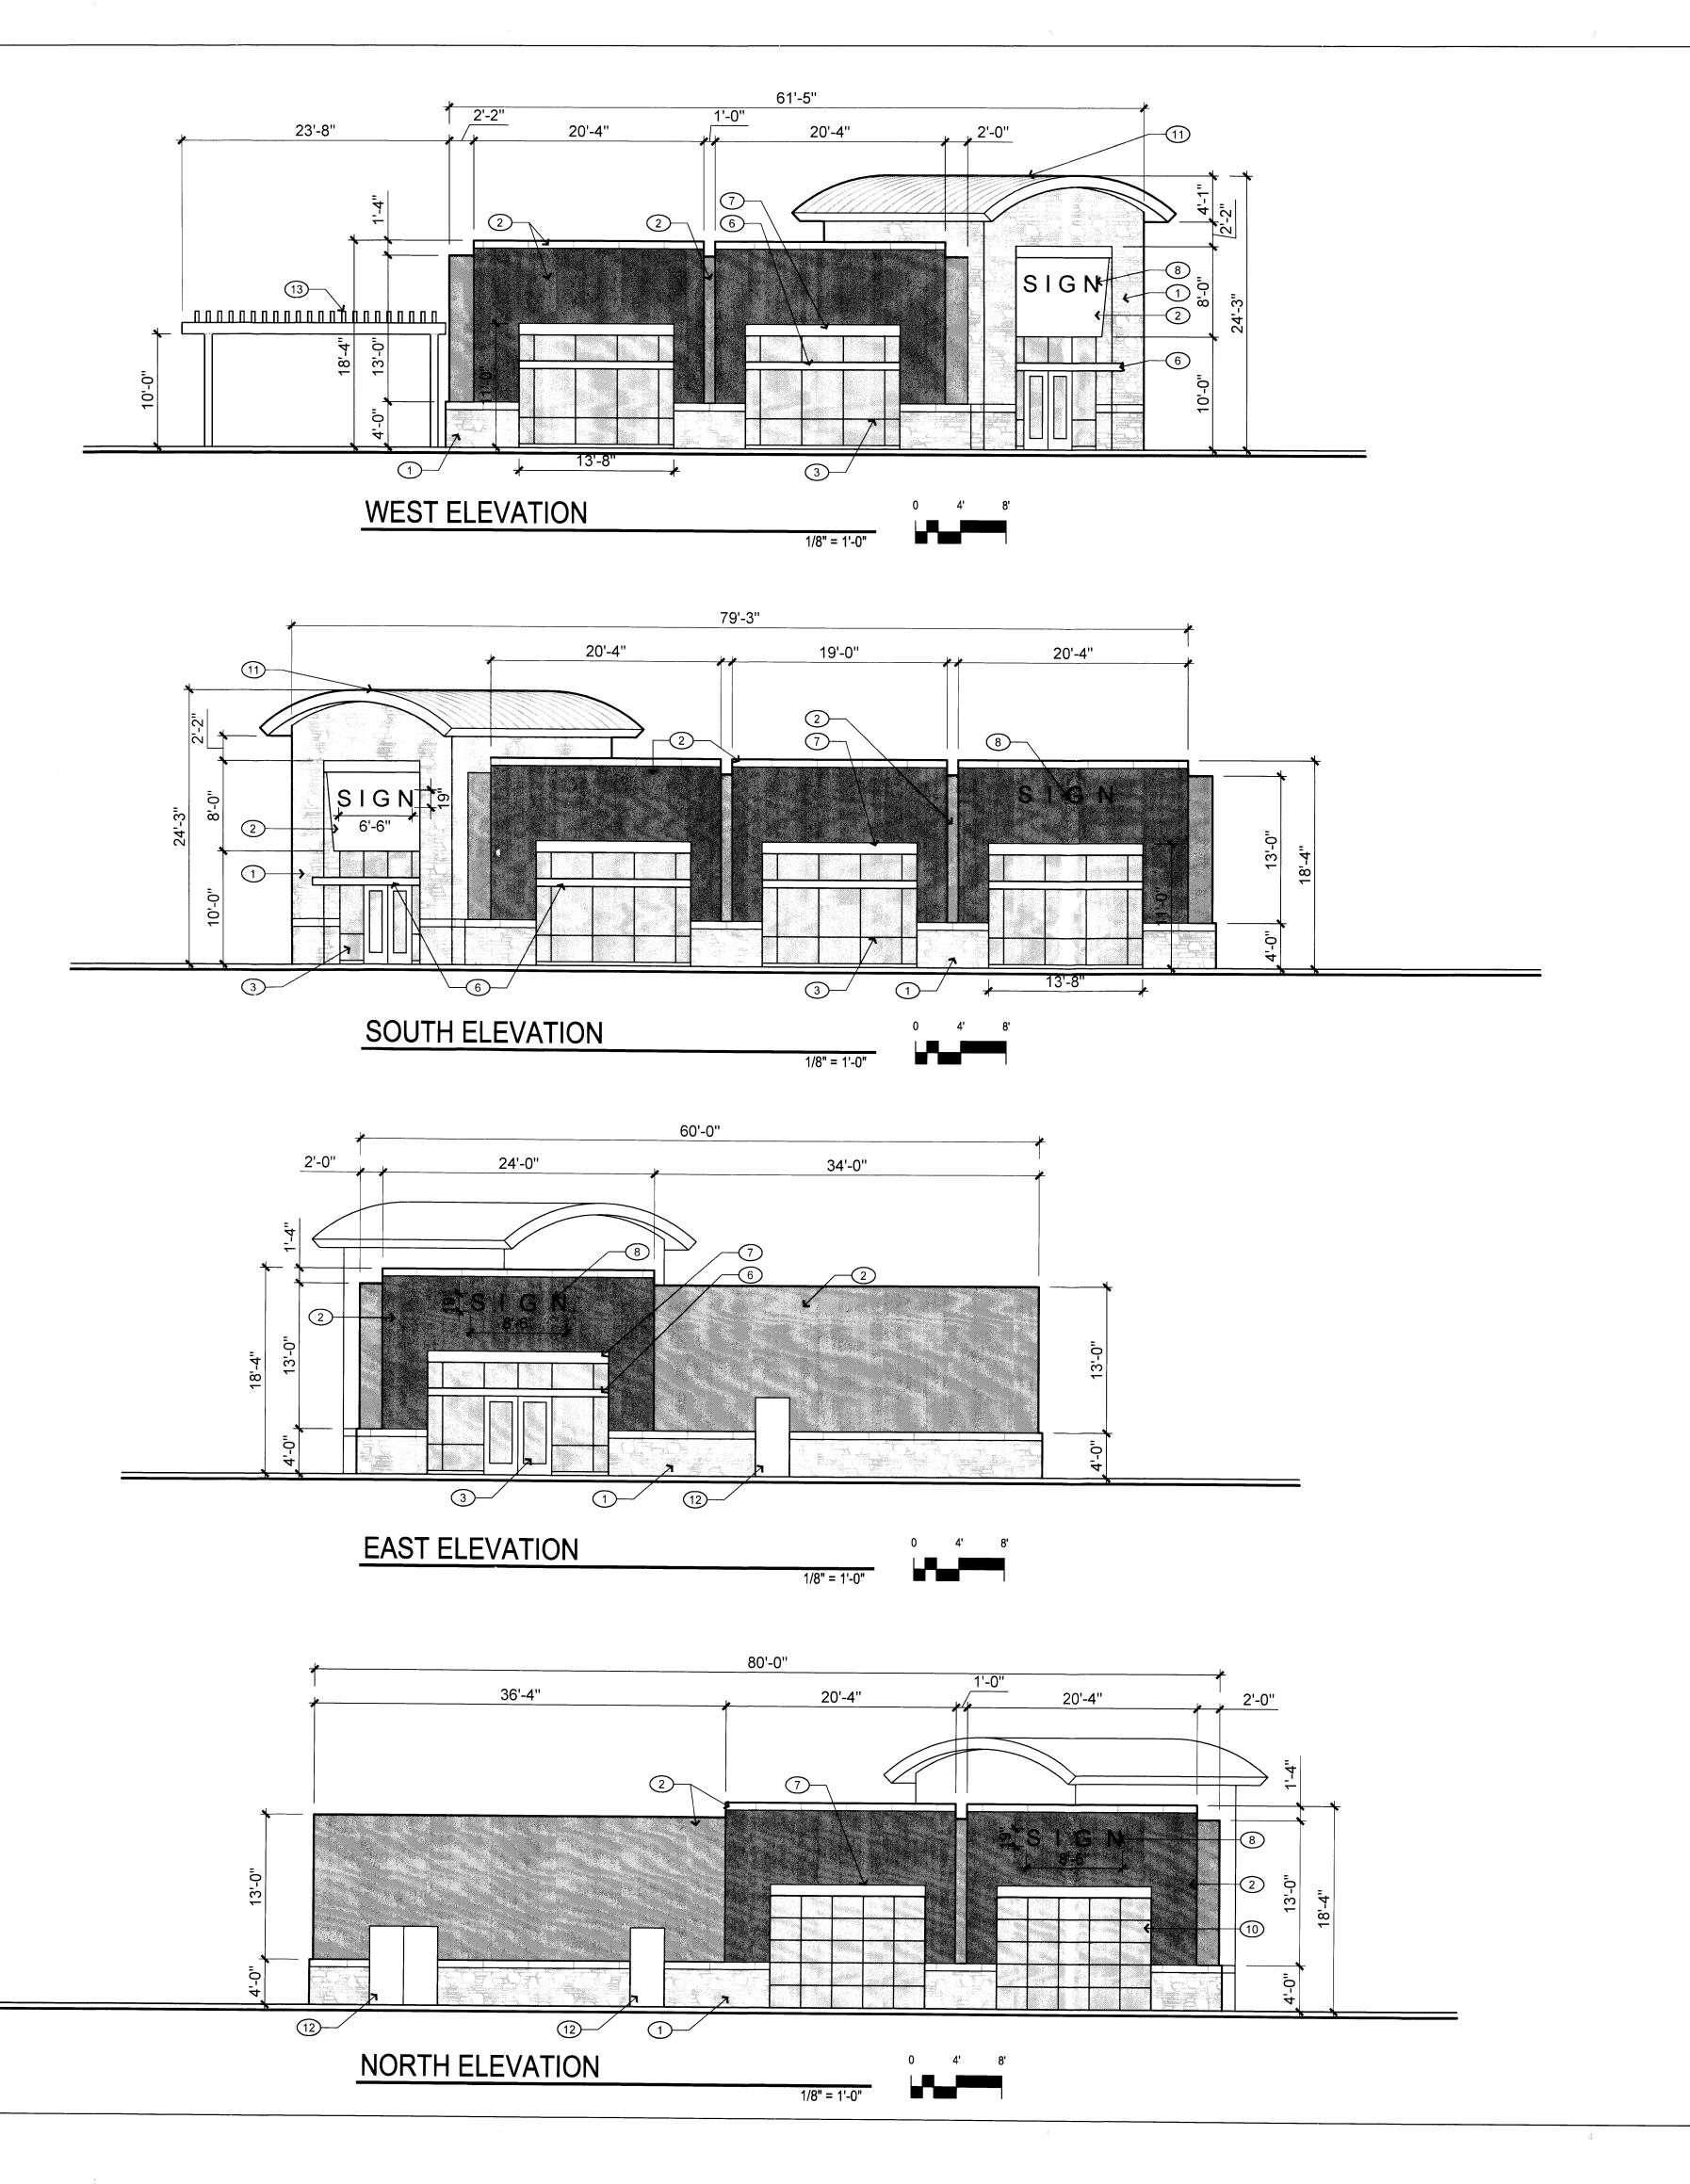

GENERAL NOTES

A. ALL BUILDING FACADES SHALL BE COMPOSED OF THE DESIGN ELEMENTS SHOWN OR DESCRIBED IN THIS PLAN. DESIGN ELEMENTS INCLUDE, AS EXAMPLES, THE BUILDING COLORS, MASSING, WINDOWS, DOORS, TRELLIS AND PORTALS. THESE DESIGN ELEMENTS NEED NOT BE ARRANGED AS SHOWN ON THIS PLAN, BUT MAY BE FREELY INTERCHANGED TO ACCOMMODATE FUTURE TENANTS.

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C. SIGNAGE AS SHOWN IS FOR ILLUSTRATION PURPOSES AND MAY CHANGE TO MEET FUTURE TENANT REQUIREMENTS.

KEYED NOTES

- 1. CULTURED STONE
- 2. EXTERIOR INSULATION AND FINISH SYSTEM (STUCCO), SEE FINISH LEGEND FOR COLORS.
- 3. ALUMINUM STOREFRONT
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- 13. STEEL TRELLIS PAINTED TO MATCH STUCCO 4
- 14. PAINTED STEEL SUPPORT RODS
- 15. PAINTED STEEL DECKING
- 16. PAINTED STEEL STRUCTURE

FINISH LEGEND

CULTURED STONE

STUCCO 1: LIGHT GREY

STUCCO 2: LIGHT BROWN

STUCCO 3: MEDIUM BROWN

STUCCO 4: DARK BROWN

GLAZING

ALUMINUM STOREFRONT AND METAL AWNINGS:

METAL PANELS - CLEAR ANODIZED ALUMINUM

a rchite ctu re interiors landscape planning engineering

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ARCHITECT

ENGINEER

PROJECT

Uptown Mexico BQ TARGET @/Albuquerque, DRB

SUBMITT

REVISIONS

CRG, TGB DRAWN BY REVIEWED BY CRG 11/10/2011 PROJECT NO. 10-0135 DRAWING NAME

LOT 3 PAD BUILDING ELEVATIONS

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Dekker Perich Sabatini

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REVISIONS

DRAWN BY

DRAWN BY TARGET
REVIEWED BY TARGET

DATE 11/10/2011
PROJECT NO. 10-0135

DRAWING NAME

TARGET ELEVATIONS





ALBUQUERQUE UPTOWN, NM

PERSPECTIVE VIEW

TARGET STORE DESIGN OCTOBER 28, 2011 architecture interiors landscape planning engineering

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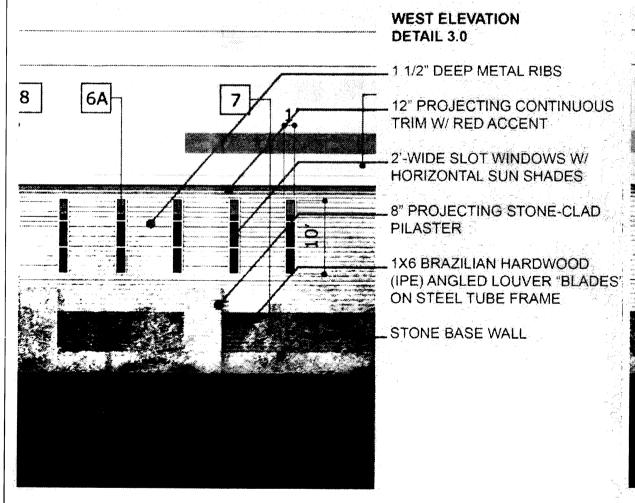
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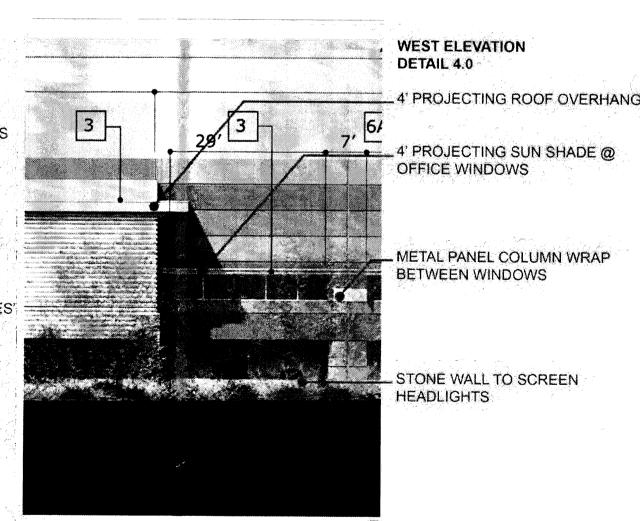
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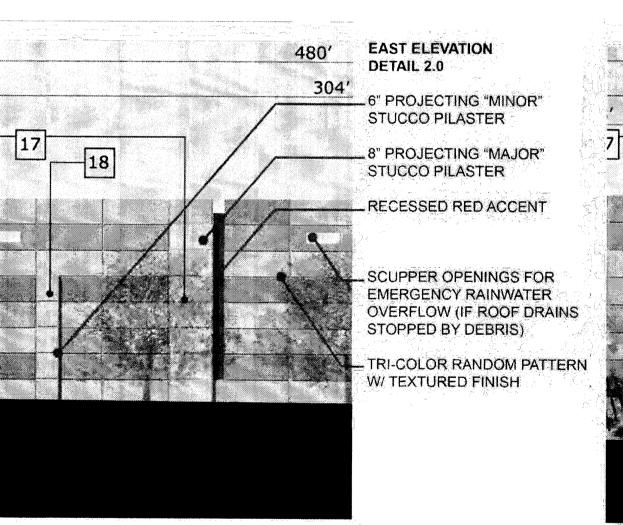
| DRAWN BY | TARGET |
|--------------|------------|
| REVIEWED BY | TARGET |
| DATE | 11/10/2011 |
| PROJECT NO. | 10-0135 |
| DRAWING NAME | |


TARGET PERSPECTIVES

FLOOR PLAN with ROOF OVERHANGS







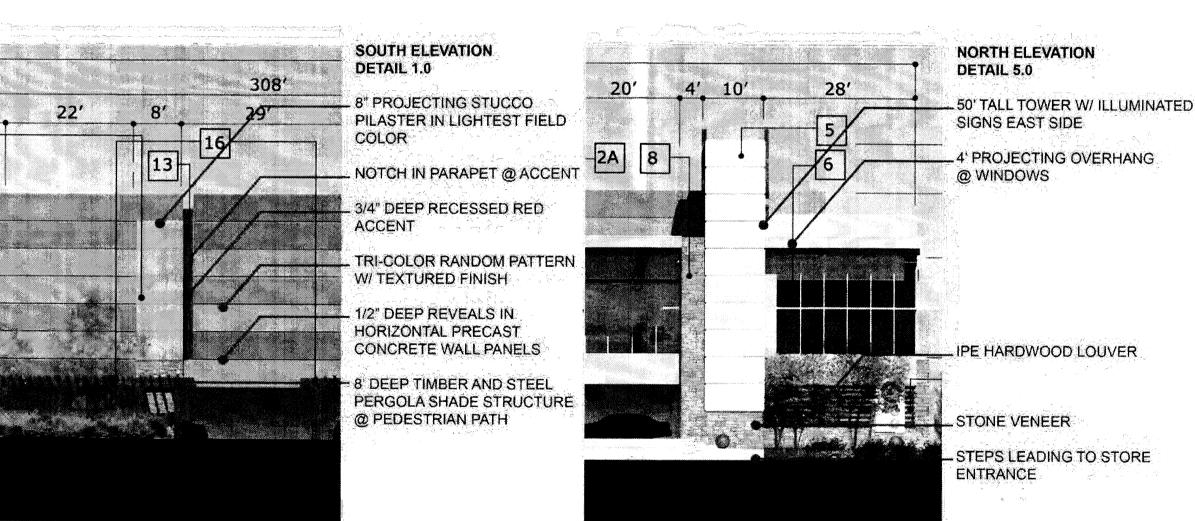

WEST ELEVATION DETAIL

WEST ELEVATION DETAIL

EAST ELEVATION DETAIL

SOUTH ELEVATION DETAIL

NORTH ELEVATION DETAIL

ALBUQUERQUE UPTOWN, NM

ELEVATION DETAILS

TARGET STORE DESIGN OCTOBER 4, 2011

architecture planning engineering

7601 Jefferson NE Suite 100 Albuquerque, NM 87109 505 761-9700 fax 761-4222

dps@dpsdesign.org ARCHITECT

ENGINEER


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SUBMIT

REVISIONS

DRAWN BY TARGET **REVIEWED BY TARGET** DATE 11/10/2011 PROJECT NO. 10-0135 DRAWING NAME

ARTICULATION COMPLIANCE

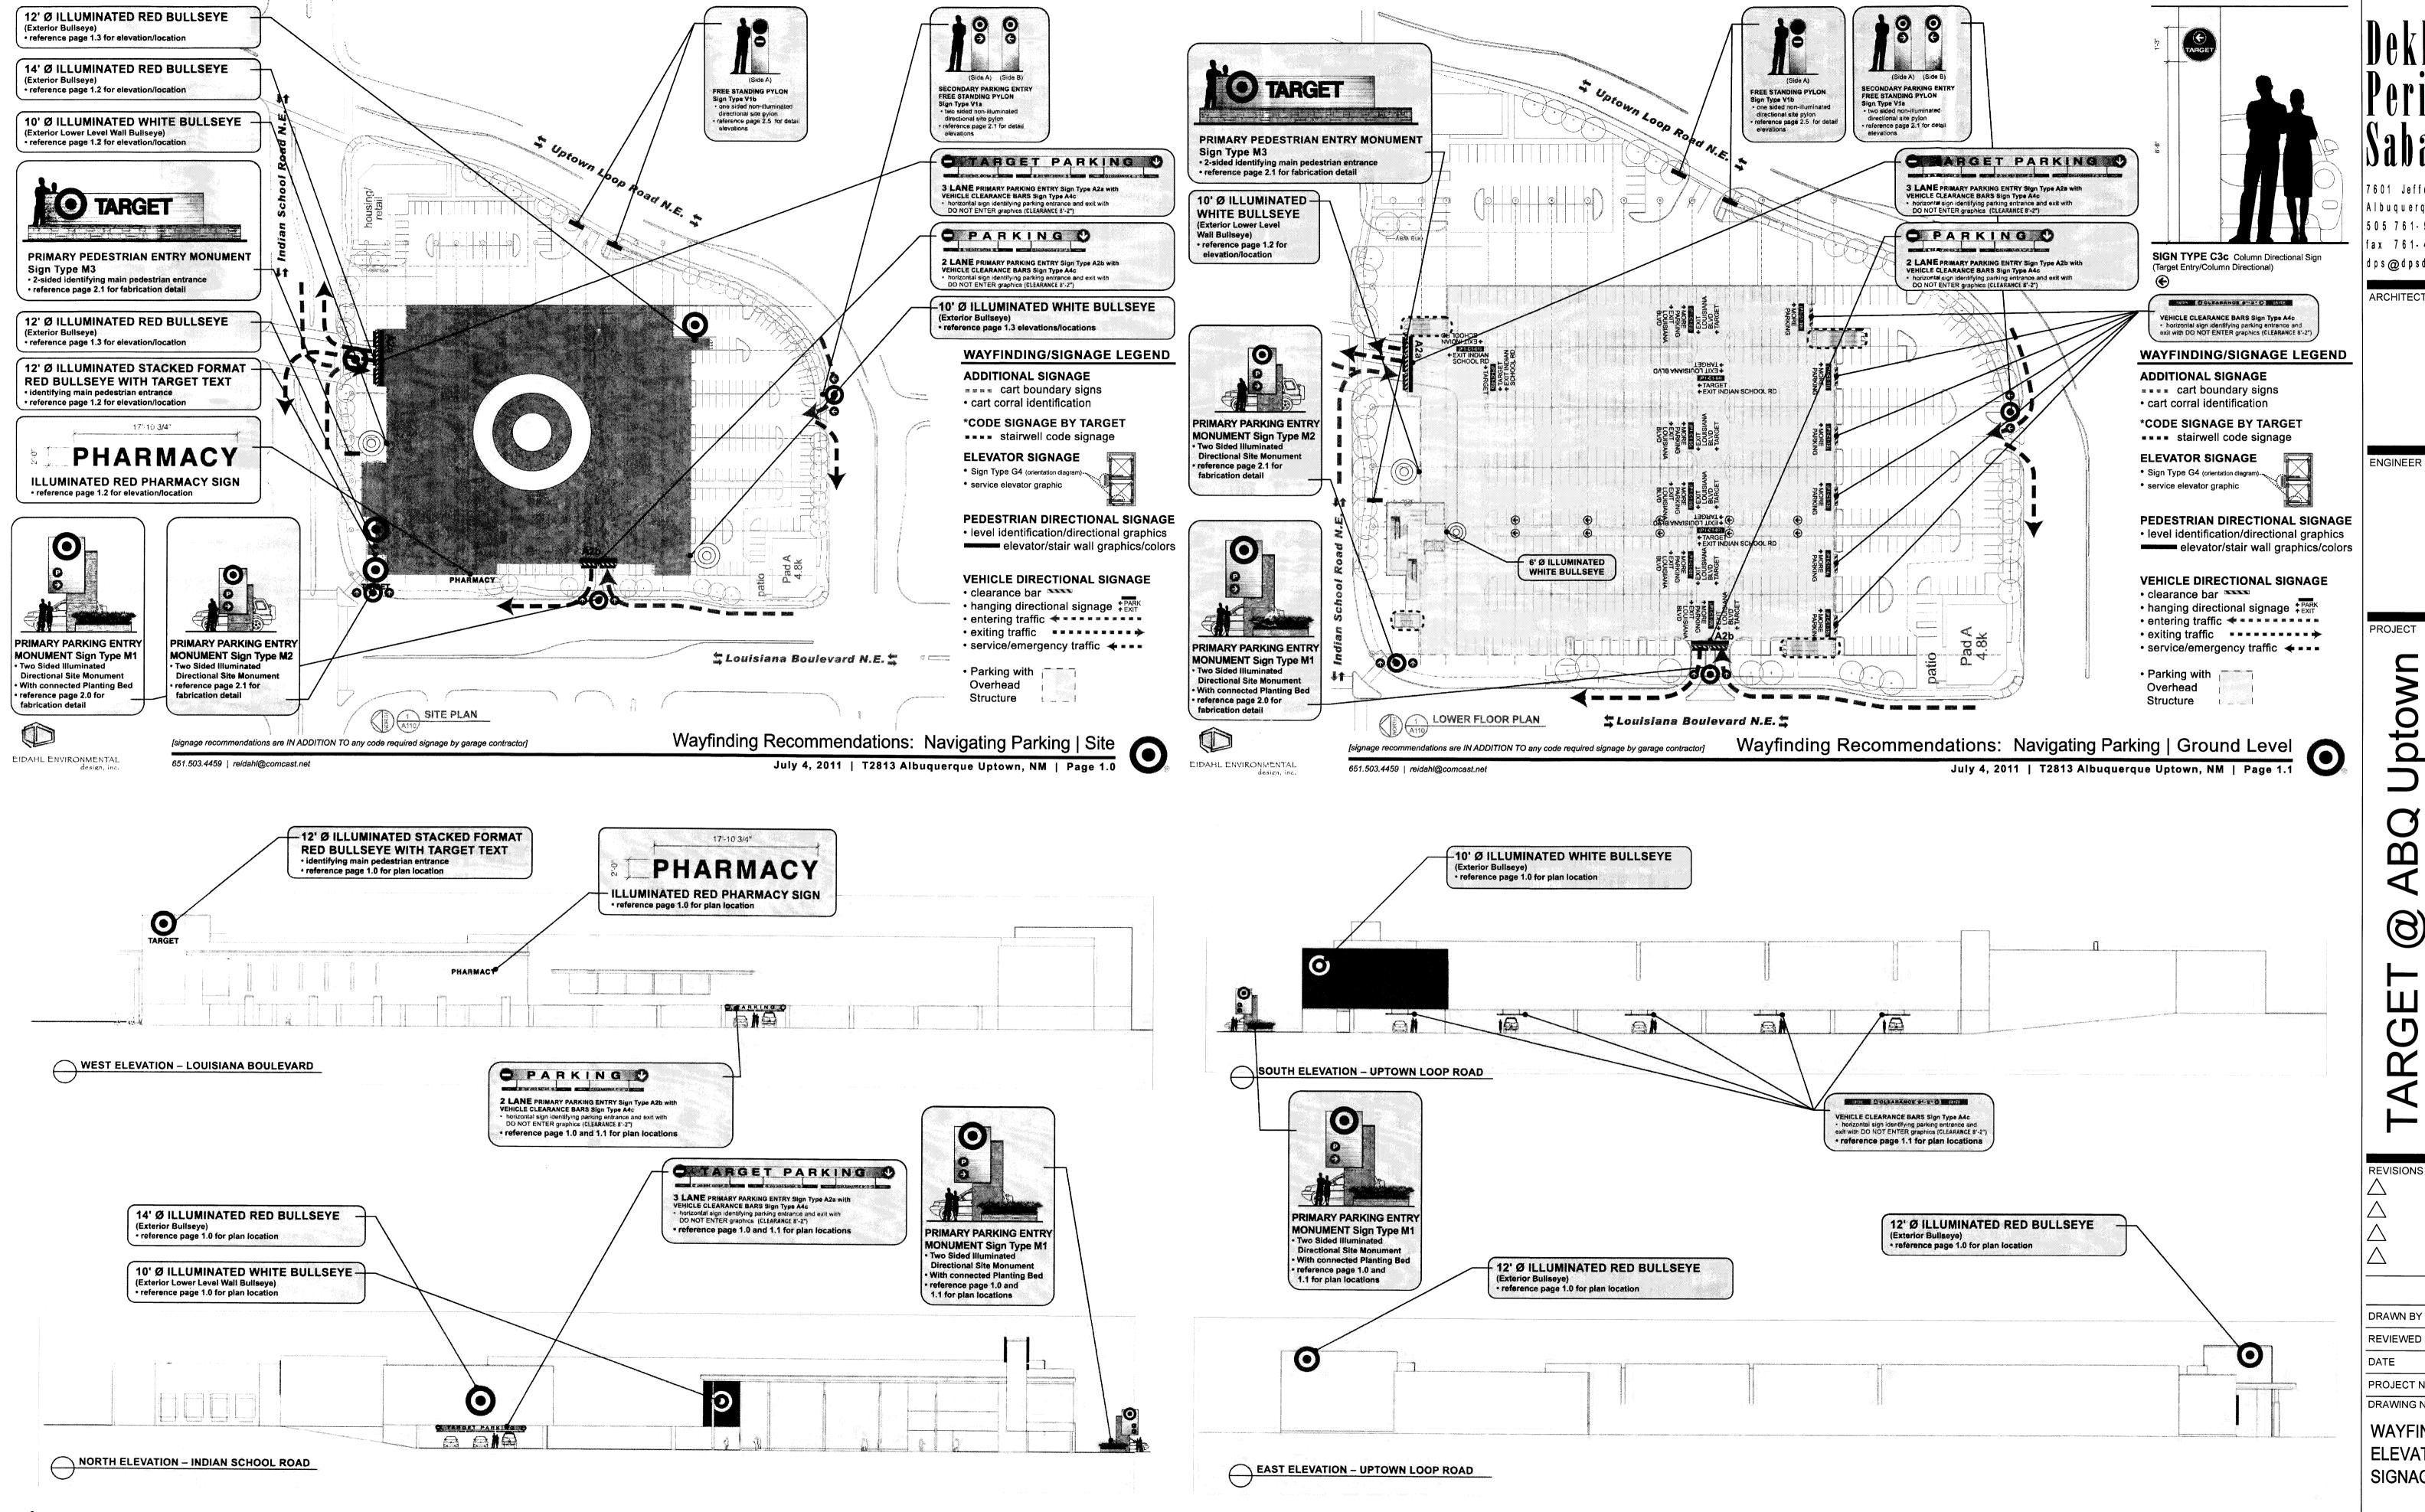

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DRB

REVISIONS

DRAWN BY EIDHAL **REVIEWED BY TARGET** DATE 11/10/2011 PROJECT NO. 10-0135 DRAWING NAME

WAYFINDING SITE, **ELEVATIONS, AND** SIGNAGE PLANS

EIDAHL ENVIRONMENTAL

[signage recommendations are IN ADDITION TO any code required signage by garage contractor]

651.503.4459 | reidahl@comcast.net

Wayfinding Recommendations: Target Signage | Building Elevations July 4, 2011 | T2813 Albuquerque Uptown, NM | Page 1.2





[signage recommendations are IN ADDITION TO any code required signage by garage contractor] 651.503.4459 | reidahl@comcast.net

Wayfinding Recommendations: Target Signage | Building Elevations

| Description | Page 1.3 | Page 1

Ø 1'-9" -internally lit

PRIMARY PARKING ENTRY MONUMENT Sign Type M1

Two Sided Illuminated Directional Site Monument

With connected Planting Bed

(SCALE: 3/8" = 1'-0")

EIDAHL ENVIRONMENTAL

← EQ − **∤** EQ −

651.503.4459 | reidahl@comcast.net

[signage recommendations are IN ADDITION TO any code required signage by garage contractor]

SIGN TYPE A2a NOTE: (3 Lanes)

and provide mounting solution

field verify for appropriate width of clearance bars

Field verify signage location/condition

Plan View metal signage cabinet (material to match on all Sign Type Ms) PRIMARY PEDESTRIAN ENTRY MONUMENT Sign Type M3 stone to match • Two Sided Illuminated Site Monument (SCALE: 3/8" = 1'-0")

Plan View

ENGINEER

a rchite ctu re

planning

engineering

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Albuquerque, NM 87109

dps@dpsdesign.org

505 761-9700

fax 761-4222

ARCHITECT

PROJECT

Uptown Mexico Albuq

SUBMIT

DRB

REVISIONS

MORE PARKING (P1-C1-11) two sided (blank back panel) (P1-C1-12) two sided (blank back panel)

DRAWN BY **EIDHAL** REVIEWED BY **TARGET** 11/10/2011 PROJECT NO. 10-0135

WAYFINDING SIGN TYPES AND **FABRICATION DETAILS**

DRAWING NAME

(P1-C1-15) two sided (blank back panel)

MORE PARKING (



SIGN TYPE C1 (Reference Target Fabrication Details further details)

SIGN TYPE C1 Vehicle Directional

↑ EXIT → TARGET

(SCALE: 1/2" = 1'-0")

TARGET


(P1-C1-02) two sided

EXIT INDIAN SCHOOL ROAD

EXIT INDIAN SCHOOL ROAD

(P1-C1-01) two sided

(P1-C1-05) two sided

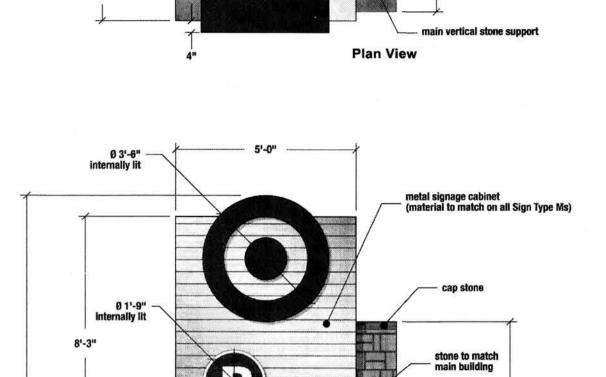

metal signage cabinet (material to match on all Sign Type Ms)

PRIMARY PARKING ENTRY MONUMENT Sign Type M2 (SCALE: 3/8" = 1'-0")

EIDAHL ENVIRONMENTAL

signage recommendations are IN ADDITION TO any code required signage by garage contractor]

Wayfinding Recommendations: Sign Types | Entry July 4, 2011 | Target T2813 Albuquerque Uptown, NM | Page 2.1

(P1-C1-03) two sided

(P1-C1-07) two sided (blank back panel) (P1-C1-08) two sided

8'-2"

field verify for appropriate

mounting height

TARGET

TARGET | EXIT INDIAN C

LOUISIANA BLVD TARGET

C LOUISIANA BLVD TARGET

MORE PARKING A

(P1-C1-10) two sided (blank back panel)

MORE PARKING A

MORE PARKING A

(P1-C1-13) two sided (blank back panel)

MORE PARKING (A)

(P1-C1-14) two sided (blank back panel)

(P1-C1-04) two sided

(P1-C1-09) two sided

metal signage cabinet (material to match on all Sign Type Ms)

Plan View

Wayfinding Recommendations: Sign Types | Entry

July 4, 2011 | Target T2813 Albuquerque Uptown, NM | Page 2.0

field verify for appropriate mounting height and noted height of clearance bars

651.503.4459 | reidahl@comcast.net

DELIVERY

VEHICLES

SIGN TYPE V1 One and Two Sided Non-Illuminated Directional Site Pylons (SCALE: 1/2" = 1'-0")

V1 Freestanding Pylon Sign scale may be adjusted depending on site requirements. Text and directional arrows are a combination of color and white reflective vinyl.

SIGN TYPE A2b NOTE: (2 Lanes) Field verify signage location/condition and provide mounting solution EXILET O DO NOT ENTER O EXILET CLEARANCE 81-2" C ENTER field verify for appropriate width of clearance bars field verify for appropriate mounting height and noted height of clearance bars

field verify for appropriate width of parking bar cabinet

field verify for appropriate width of parking bar cabinet

metal signage cabinet (material to match on all Sign Type Ms)

stone to match main building

14'-8"

PRIMARY PARKING ENTRY Sign Type A2 with VEHICLE CLEARANCE BARS Sign Type A4c • signs identifying parking entrance (circular "P" parking graphic) and exit (circular "DO NOT ENTER" graphic) SIGN TYPE A2 Illuminated Circular Garage Entry I.D. for Primary Ingress SIGN TYPE A4c Entry/Exit Vehicle Clearance Bars

Wayfinding Recommendations: Sign Types | Entry



[signage recommendations are IN ADDITION TO any code required signage by garage contractor]

Wayfinding Recommendations: Sign Types | Navigation July 4, 2011 | Target T2813 Albuquerque Uptown, NM | Page 2.3

Reference Target Property Development's Fabrication

Details pages 3.0 and 4.0 for further fabrication details.

EIDAHL ENVIRONMENTAL

[signage recommendations are IN ADDITION TO any code required signage by garage contractor]

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(SCALE: 1/4" = 1'-0")

October 4, 2011 | Target T2813 Albuquerque Uptown, NM | Page 2.2

651.503.4459 | reidahl@comcast.net



OFFICIAL NOTICE OF DECISION

CITY OF ALBUQUERQUE PLANNING DEPARTMENT DEVELOPMENT REVIEW BOARD November 16, 2011

Project# 1007316

11DRB-70284 SITE DEVELOPMENT PLAN FOR BUILDING PERMIT 11DRB-70303 MINOR - PRELIMINARY/ FINAL PLAT APPROVAL

DEKKER/PERICH/SABATINI and SURV-TEK INC, agent(s) for HUNT UPTOWN II, LLC request(s) the referenced/ above action(s) for all or a portion of Tract(s) A, HUNT-SPECTRUM DEVELOPMENT SITE zoned SU-3 MU-UPT, located on the south side of INDIAN SCHOOL RD NE between LOUISIANA BLVD NE and UPTOWN LOOP RD NE containing approximately 7.467 acre(s). (J-19)[Deferred from 10-19-11, 11/2/11]

The Site Development Plan for Building Permit was presented to the Development Review Board in compliance with the Uptown Sector Development Plan. Additionally, an Updated Traffic Impact Study was submitted and accepted by the City's Transportation Development Division.

With the signing of the infrastructure list dated November 16, 2011, the Site Development Plan for Building Permit was approved with final sign off delegated to City Engineer for recording of the Subdivision Improvement Agreement and to Planning to comply with the following conditions and expiration of the 15 day appeal period; the preliminary/final plat was approved with final sign off delegated to Planning:

- 1. The pedestrian linkage in the parking lot on the south of Building 1 shall have a flared/ split concrete connection to the public sidewalk on the Uptown Loop Road, to direct pedestrians west or east.
- 2. A contrasting color (and/ or material) shall be used as a major façade change over the new vehicular access on the east elevation.
- 3. An informational note shall be provided regarding care for delivery allocation to minimize semi-trailer conflicts with vehicular customer traffic.

Any person with standing who is aggrieved with any determination of the Development Review Board may file an appeal, but it must be within 15 days of the Development Review Board's decision. If you wish to appeal this decision you must do so by December 1, 2011, on the Planning Department appeal forms with the appropriate fee, to the Planning Department Front Counter. Appeal is to the Land Use Hearing Officer, who will make a recommendation to the City Council.

You will receive notice if any other person files an appeal. Successful applicants are reminded that other requirements of the City must be complied with, even after approval of the referenced application(s).

Jack Cloud, DRB Chair

Cc: Hunt Uptown II, LLC - 201 3rd St NW Ste 1150 - Albuquerque, NM 87102

Cc: Dekker/Perich/Sabatini - 7601 Jefferson St NE - Albuquerque, NM 87109

Cc: Gary Goodman - 100 Sun Ave NE St 100 - Albuquerque, NM 87109

Cc: John Salazar – P.O. Box 1888 – Albuquerque, NM 87103

Cc: Evelyn Feltner – 2014 Utah St NE – Albuquerque, NM 87110

Cc: Dave Harman – 2938 La Palomita Rd NE – Albuquerque, NM 87111

Cc: Dave Dekker - 2101 Mountain Rd NW - Albuquerque, NM 87104

Marilyn Maldonado

SCOPE OF WORK:

ALL SIGNS TO BE REPLACED/UPDATED, EXCEPT 'CVS PHARMACY' SIGN WHICH IS TO REMAIN. TWO (2) NEW SIGNS TO BE ADDED, ONE (1) ALONG SOUTH ELEVA-TION, ONE (1) ALONG WEST.

PROPOSED SIGN-AGE


A. WHITE BULLSEYE TO MATCH EXISTING SIZE AND LOCATION B. RED BULLSEYE TO MATCH EXISTING SIZE AND LOCATION C. WHITE BULLSEYE TO MATCH EXISTING SIZE AND LOCATION D. WHITE BULLSEYE TO MATCH EXISTING SIZE AND LOCATION E. WHITE BULLSEYE TO MATCH EXISTING SIZE AND LOCATION F. WHITE BULLSEYE (10') AND WHITE LETTER-STACK (2'6") G. WHITE BULLSEYE (12') & WHITE LETTER-STACK (3')

NOTES:

- 1. ALL PROPOSED FACADE COLOR CHANGES ARE WITHIN THE DESIGN SCHEME OF THE ORIGINAL SITE PLAN.
- 2. INTERIOR GARAGE TO BE REFURBISHED WITH EXISTING MATERIALS.
- 3. EXISTING SIGN SQUARE FOOTAGE TOTALS 762.9 SF, PROPOSED ADDS 331.6 SF.
- 4. MONUMENT SIGNS WILL BE UPDATED, COLORS TO INVERSE, NO STRUCTURAL CHANGES TO BE MADE.
- 5. ALL SIGNS TO REPLACE EXISTING, NO ADDITIONAL SIGNS TO BE ADDED.

PROPOSED EXTERIOR REMODEL - SIGN AGE AND FACADE T-2813 UPTOWN 2120 LOUISIANA BOULEVARD

ALBUQUERQUE, NM 87110

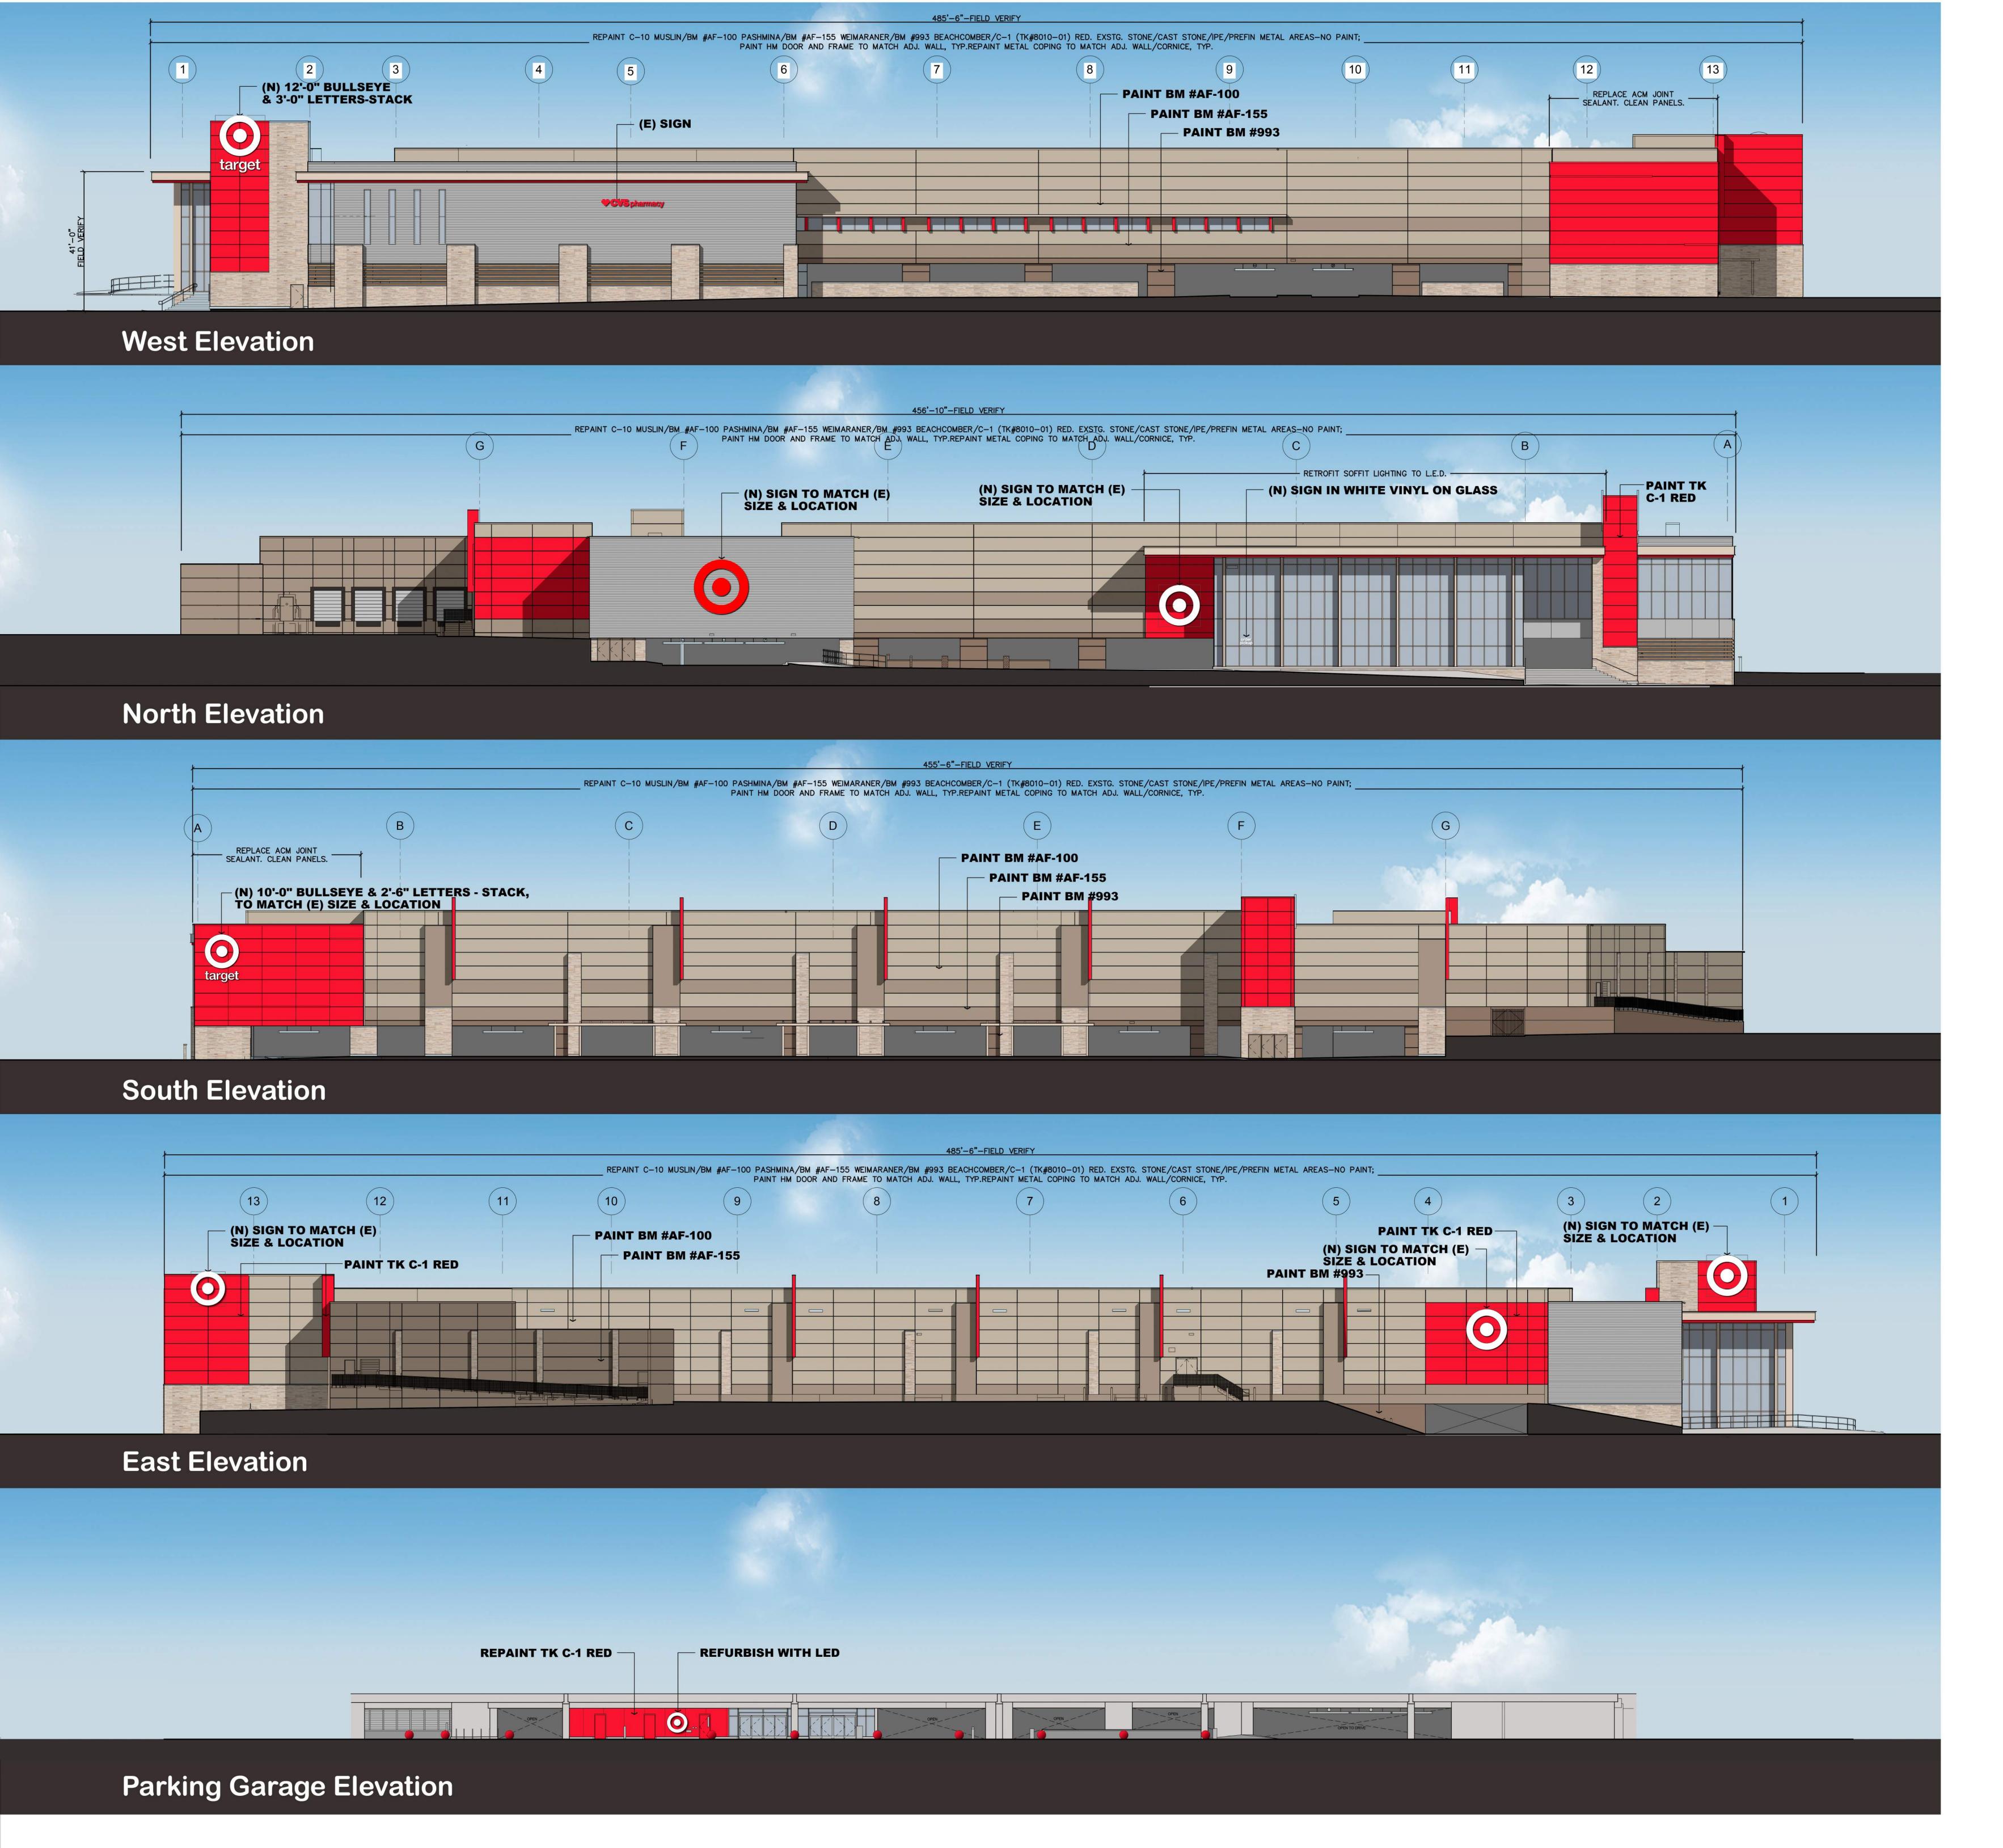

BM #AF-100 PASHMINA

BM #AF-155 WEIMARANER

BM #993 BEACHCOMBER

C-1....RED-#TK -8010-1

(E) SOFFIT PAINTC-1 RED


NOTE:


- * ALL COLORS ARE FOR REFERENCE ONLY.
- * EXISTING PREFINISHED METAL-NO PAINT, UNLESS NOTED OTHERWISE
- * EXISTING STONE, CAST STONE, IPE & PREFIN METAL AREAS-NO PAINT; PAINT HM DOOR AND FRAME TO MATCH ADJ. WALL, TYP.
- * RESEAL CAST STONE CAPS.
- *STORE EXTERIOR WALLS ARE PRIMARILY PRECAST CONCRETE & STONE VENEER
- *REPAINT BUS STOP C-1 RED-#TK8010-1
- *BEN-2: MODERN, COLOR......SILVER

GENERAL NOTE

- * AREA TO BE PAINTED STARTS AT TOP OF CURB OR REVEAL AND CONTINUES TO TOP OF PARAPET/FLASHING OR REVEAL. PAINT COLOR AND FINISH TRANSITIONS OCCUR AT EXISTING VERTICAL CONTROL JOINTS OR AT INSIDE BUILDING CORNERS, U.N.O.
- * ALL EXISTING WALL-MOUNTED ITEMS TO BE PAINTED TO MATCH ADJ. WALL SURFACE, U.N.O.
- * PATCH ALL VISIBLE HOLES FROM MOUNTING OF REMOVED SIGNS WITH LIKE MATERIALS. RESTORE WALL SURFACE TO 'LIKE NEW' APPEARANCE.

Proposed Elevations

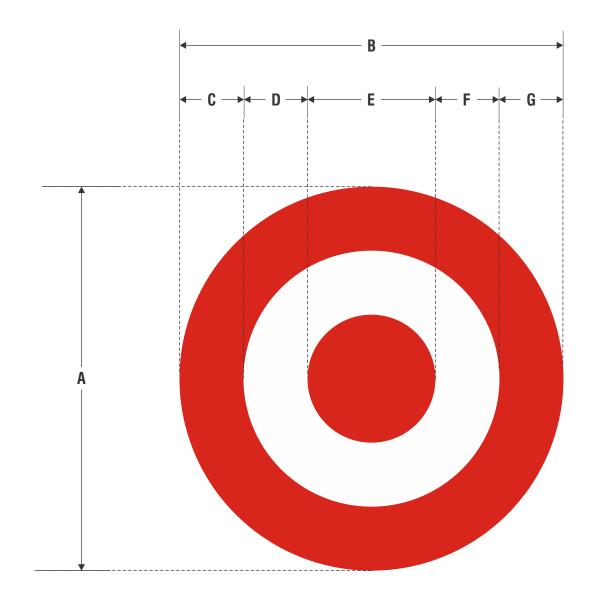

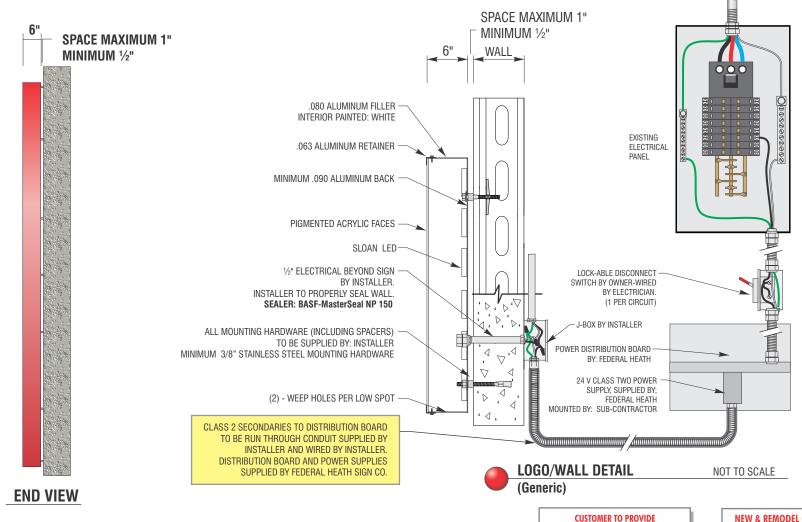

ACRYLIC FACED INTERNALLY ILLUMINATED "BULLSEYE"

MANUFACTURE AND INSTALL CHANNEL LOGO AS SHOWN AND NOTED

| SIGN TYPE | A | В | C | D | Ε | F | G | RETAINER | SQ.FT. | QTY |
|---------------|--------|--------|-------|-------|-------|-------|-------|----------|--------|-----|
| 96 BULLSEYE-R | 14'-0" | 14'-0" | 2'-4" | 2'-4" | 4'-8" | 2'-4" | 2'-4" | 1 1/2" | 153.9 | 1 |

ELECTRICAL REQUIREMENTS

Total: 0.0 Amps

(1) 120V 20A Circuit Required.

ALL BRANCH CIRCUITS SHALL BE DEDICATED TO SIGNS (INCLUDING GROUND AND NEUTRAL) AND SHALL NOT BE SHARED WITH OTHER LOADS.

DEDICATED BRANCH CIRCUITS FOR SIGNS ONLY PER NEC CODE 600.5

MATERIAL FINISH COLORS

Faces

Modified Acrylic (Altuglas or Equiv.)

Trimcap/Retainer

MP# 82074LVG (FULL GLOSS)

ALL BRANCH CIRCUITS SHALL BE DEDICATED TO SIGNS (INCLUDING GROUND AND NEUTRAL) AND INCLUDING GROUND AND NEUTRAL) AND PROPERLY SIZED GROUND WIRE THAT CAN BE TRACED BACK TO BREAKER PANEL IS REQUIRED.

INSTALLER REQUIREMENTS

ALL MOUNTING HARDWARE, SECONDARY WIRING AND CONDUITS ARE TO BE PROVIDED BY THE INSTALLATION CONTRACTOR. ALL PENETRATIONS IN THE WALL ARE TO BE SEALED WITH SILICONE AND TO BE WATERTIGHT.

ANY DEVIATION FROM FEDERAL HEATH REQUIREMENTS MAY RESULT IN DAMAGE TO OR IMPROPER OPERATION OF SIGNAGE, CAUSING DELAYS AND ADDITIONAL COSTS.

NEW & REMODEL CONSTRUCTION


ADEQUATE BEHIND THE WALL BACKING AND ACCESS IS REQUIRED FOR THE INSTALLATION OF NEW SIGNAGE. CUSTOMER TO FORWARD APPROVED SIGNAGE DRAWINGS TO THE ON SITE CONTACT TO INSURE THAT THE REQUIRED PROVISIONS ARE MADE DURING CONSTRUCTION, PRIOR TO THE SIGN INSTALLATION.

INSTALLER REQUIREMENTS FOR EIFS WALLS

IT IS THE RESPONSIBILITY OF THE INSTALLATION CONTRACTOR TO PROVIDE ANY WALL SPACERS REQUIRED TO KEEP EIFS WALL MATERIAL FROM BEING COMPACTED DURING INSTALLATION OF ANY MOUNTING BOLTS REQUIRED FOR SIGNAGE.

GENERAL NOTE


• INSTALLER SHALL VERIFY WALL CONDITION IN THE FIELD.
• TYPE, SIZE AND NUMBER OF FASTENERS TO BE DETERMINED.
• ALL BOLT HOLES TO BE DRILLED OR PUNCHED.
• ISOLATE ALL ALUMINUM FROM STEEL.

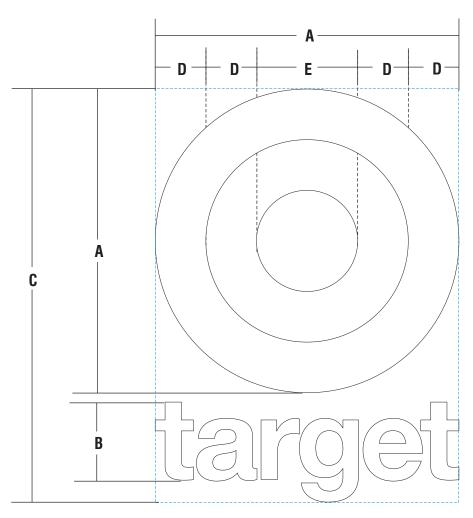


ACRYLIC FACED INT. ILLUM. "LOGO & LETTER SET" | LC-S W

SCOPE OF WORK:

MANUFACTURE AND INSTALL CHANNEL LOGO & LETTERS

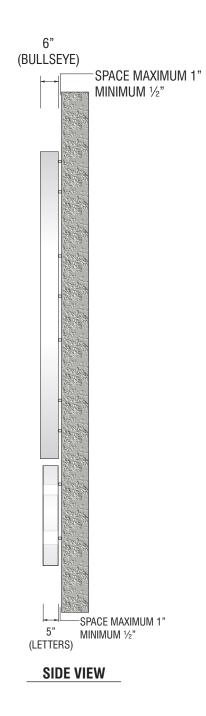

| SIGN TYPE | A | В | C | D | E | RETAINER | <u>amps</u> Circuits | SQ.FT. |
|-----------|--------|-----------|------------|-------|-------|----------|-------------------------|--------|
| | 10'-0" | 2'-6-7/8' | 13'-7-1/8' | 1'-8" | 3'-4" | 1" | | 135.9 |

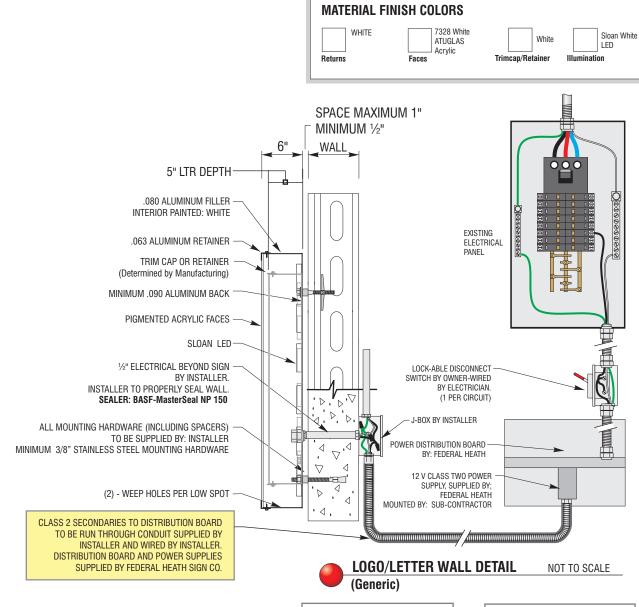

ELECTRICAL REQUIREMENTS

Total: 0.0 Amps

(1) 120V 20A Circuit Required

ALL BRANCH CIRCUITS SHALL BE DEDICATED TO SIGNS (INCLUDING GROUND AND NEUTRAL) AND SHALL NOT BE SHARED WITH OTHER LOADS.

CUSTOMER TO PROVIDE DEDICATED BRANCH CIRCUITS FOR SIGNS ONLY PER NEC CODE 600.5

ALL BRANCH CIRCUITS SHALL BE DEDICATED TO SIGNS (INCLUDING GROUND AND NEUTRAL) AND SHALL NOT BE SHARED WITH OTHER LOADS. PROPERLY SIZED GROUND WIRE THAT CAN BE TRACED BACK TO BREAKER PANEL IS REQUIRED

INSTALLER REQUIREMENTS

ALL MOUNTING HARDWARE, SECONDARY WIRING AND CONDUITS ARE TO BE PROVIDED BY THE INSTALLATION CONTRACTOR. ALL PENETRATIONS IN THE WALL ARE TO BE SEALED WITH SILICONE AND TO BE WATERTIGHT.

ANY DEVIATION FROM FEDERAL HEATH REQUIREMENTS MAY RESULT IN DAMAGE TO OR IMPROPER OPERATION OF SIGNAGE. CAUSING DELAYS AND ADDITIONAL COSTS

NEW & REMODEL CONSTRUCTION

ADEQUATE BEHIND THE WALL BACKING AND ACCESS IS REQUIRED FOR THE INSTALLATION OF NEW SIGNAGE. CUSTOMER TO FORWARD APPROVED SIGNAGE DRAWINGS TO THE ON SITE CONTACT TO INSURE THAT THE REQUIRED PROVISIONS ARE MADE DURING CONSTRUCTION. PRIOR TO THE SIGN INSTALLATION

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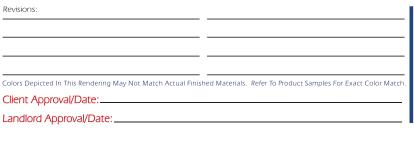
GENERAL NOTE

INSTALLER SHALL VERIFY WALL CONDITION IN THE FIELD. TYPE, SIZE AND NUMBER OF FASTENERS TO BE DETERMINED. • ALL BOLT HOLES TO BE DRILLED OR PUNCHED. • ISOLATE ALL ALUMINUM FROM STEEL.



Delaware, OH - Racine, WI Office Locations: **VISUAL COMMUNICATIONS** www.FederalHeath.com 12704 DuPont Circle Tampa, FL 33626 (813) 855-4415 (800) 284-3284 Fax (813) 854-3037 Building Quality Signage Since 1901 Landlord Approval/Date:

Manufacturing Facilities: Oceanside, CA - Euless, TX - Jacksonville, TX Oceanside, CA - Las Vegas, NV - Laughlin, AZ Idaho Falls, ID - Euless, TX - Jacksonville, TX - San Antonio, TX Houston, TX - Corpus Christi, TX - Indianapolis, IN Louisville, KY - Knoxville, TN - Grafton, WI - Delaware, OH Willowbrook, IL - Tunica, MS - Atlanta, GA Tampa, FL - Daytona Beach, FL - Orlando, FL



Boyd Hippenstiel Account Rep: Sandra Ramirez Project Manager Joe Knestrick Underwriters Laboratories Inc.

ALL ELECTRICAL SIGNS ARE TO COMPLY WITH U.L. 48 AND ARTICLE 600 OF THE N.E.C. STANDARDS, INCLUDING THE PROPER GROUNDING AND BONDING OF ALL SIGNS


Store: #T0000

Project / Location:

23-00000-10 Job Number: 27 February 2018 6 Of 18

Design Number: 23-0000-10


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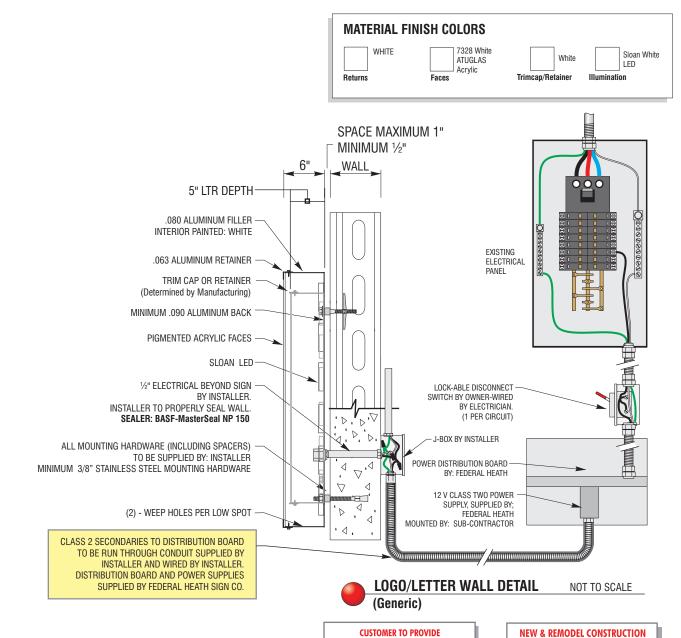
ACRYLIC FACED INT. ILLUM. "LOGO & LETTER SET" | LC-S W

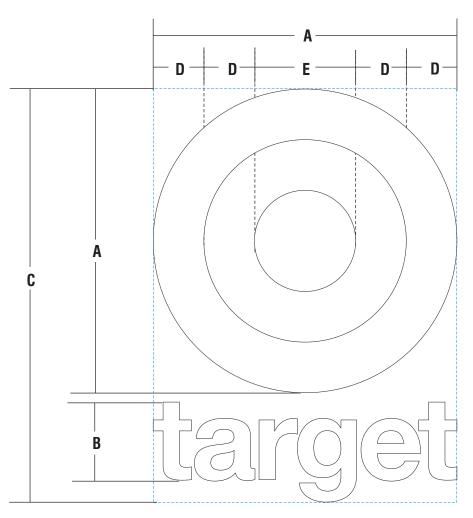SCOPE OF WORK:

MANUFACTURE AND INSTALL CHANNEL LOGO & LETTERS



| SIGN TYPE | A | В | C | D | E | RETAINER | <u>amps</u> Circuits | SQ.FT. |
|-----------|--------|-------|------------|-------|-------|----------|-------------------------|--------|
| | 12'-0' | 3'-1" | 16'-3 3/4" | 2'-0" | 4'-0" | 1 1/2" | | 195.7 |

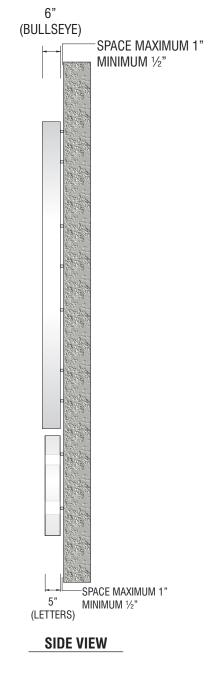

ELECTRICAL REQUIREMENTS

Total: 0.0 Amps

(1) 120V 20A Circuit Required

ALL BRANCH CIRCUITS SHALL BE DEDICATED TO SIGNS (INCLUDING GROUND AND NEUTRAL) AND SHALL NOT BE SHARED WITH OTHER LOADS.

CUSTOMER TO PROVIDE DEDICATED BRANCH CIRCUITS FOR SIGNS ONLY PER NEC CODE 600.5

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INSTALLER REQUIREMENTS

ALL MOUNTING HARDWARE, SECONDARY WIRING AND CONDUITS ARE TO BE PROVIDED BY THE INSTALLATION CONTRACTOR. ALL PENETRATIONS IN THE WALL ARE TO BE SEALED WITH SILICONE AND TO BE WATERTIGHT.

ANY DEVIATION FROM FEDERAL HEATH REQUIREMENTS MAY RESULT IN DAMAGE TO OR IMPROPER OPERATION OF SIGNAGE. CAUSING DELAYS AND ADDITIONAL COSTS

OF NEW SIGNAGE. CUSTOMER TO FORWARD APPROVED SIGNAGE DRAWINGS TO THE ON SITE CONTACT TO INSURE THAT THE REQUIRED PROVISIONS ARE MADE DURING CONSTRUCTION. PRIOR TO THE SIGN INSTALLATION

ADEQUATE BEHIND THE WALL BACKING AND

ACCESS IS REQUIRED FOR THE INSTALLATION

INSTALLER REQUIREMENTS FOR EIFS WALLS IT IS THE RESPONSIBILITY OF THE INSTALLATION CONTRACTOR TO PROVIDE ANY WALL SPACERS REQUIRED TO KEEP EIFS WALL MATERIAL FROM BEING COMPACTED DURING INSTALLATION OF

ANY MOUNTING BOLTS REQUIRED FOR SIGNAGE

GENERAL NOTE

INSTALLER SHALL VERIFY WALL CONDITION IN THE FIELD. TYPE, SIZE AND NUMBER OF FASTENERS TO BE DETERMINED. • ALL BOLT HOLES TO BE DRILLED OR PUNCHED. • ISOLATE ALL ALUMINUM FROM STEEL.



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Colors Depicted In This Rendering May Not Match Actual Finished Materials. Refer To Product Samples For Exact Color Mat Client Approval/Date:

Boyd Hippenstiel Account Rep: Sandra Ramirez Project Manager Joe Knestrick

Underwriters Laboratories Inc. ALL ELECTRICAL SIGNS ARE TO COMPLY WITH U.L. 48 AND ARTICLE 600 OF THE N.E.C. STANDARDS, INCLUDING THE PROPER GROUNDING AND BONDING OF ALL SIGNS


Project / Location: Store: #T0000

23-00000-10 Job Number: 27 February 2018 6 Of 18 Design Number: 23-0000-10

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FIELD SURVEY REQUIRED

VERIFY GLASS V.O. & MULLION/DIVIDER SIZING PRIOR TO FABRICATION

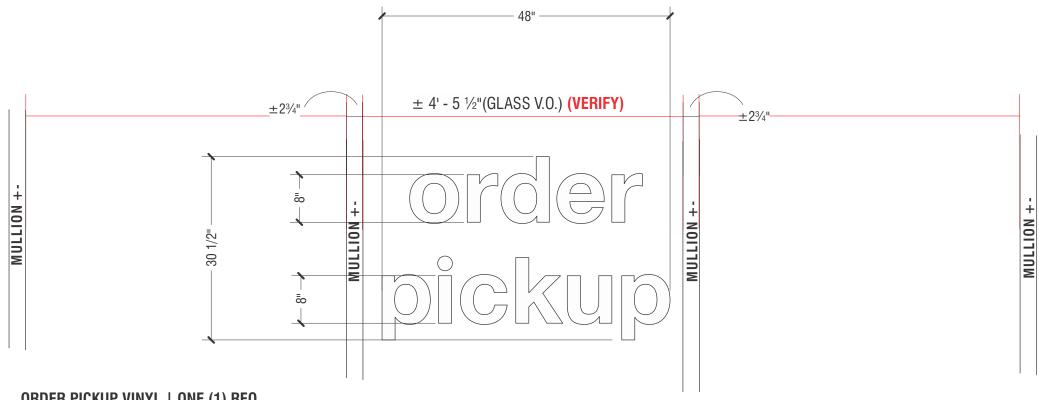


ORDER PICKUP VINYL | ONE (1) REQ.

SCALE: 3/4"=1'-0"

MANUFACTURE AND INSTALL FIRST SURFACE (*Verify IF; 1st or 2nd Surface Applied) OPAQUE WHITE VINYL LAYOUT


MATERIAL FINISH COLORS 3M 7725-10 WHITE OPAQUE

10.16 SQ FT

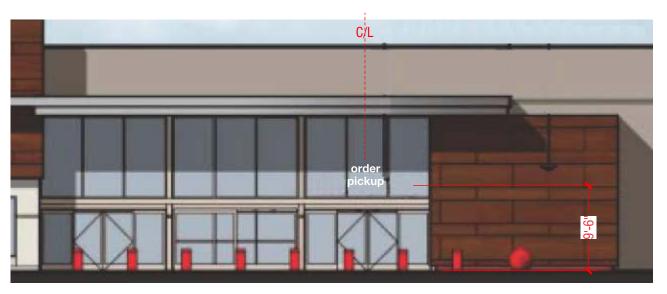

NORTH ELEVATION (Partial) STOREFRONT


scale 3/32"=1'-0"

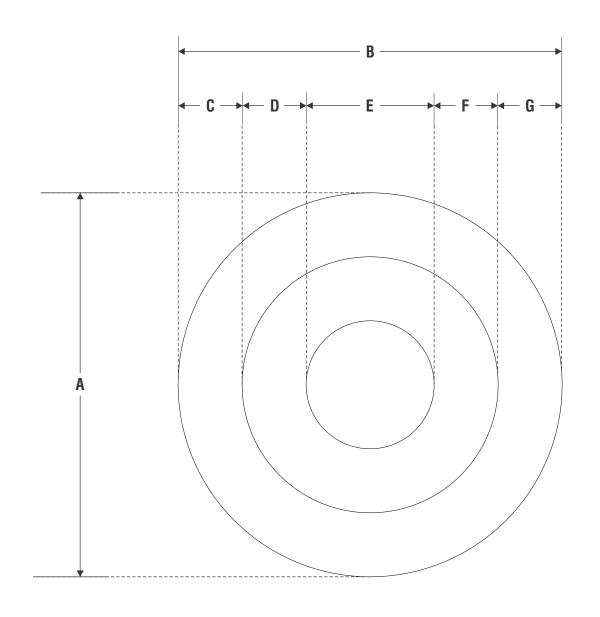


ACRYLIC FACED INTERNALLY ILLUMINATED "BULLSEYE"

MANUFACTURE AND INSTALL CHANNEL LOGO AS SHOWN AND NOTED

| SIGN TYPE | A | В | C | D | Ε | F | G | RETAINER | SQ.FT. | QTY |
|----------------|--------|--------|-------|-------|-------|-------|-------|----------|--------|-----|
| 156 BULLSEYE-W | 10'-0" | 10'-0" | 1'-8" | 1'-8" | 3'-4" | 1'-8" | 1'-8" | 1" | 78.5 | 1 |

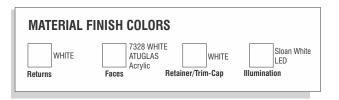

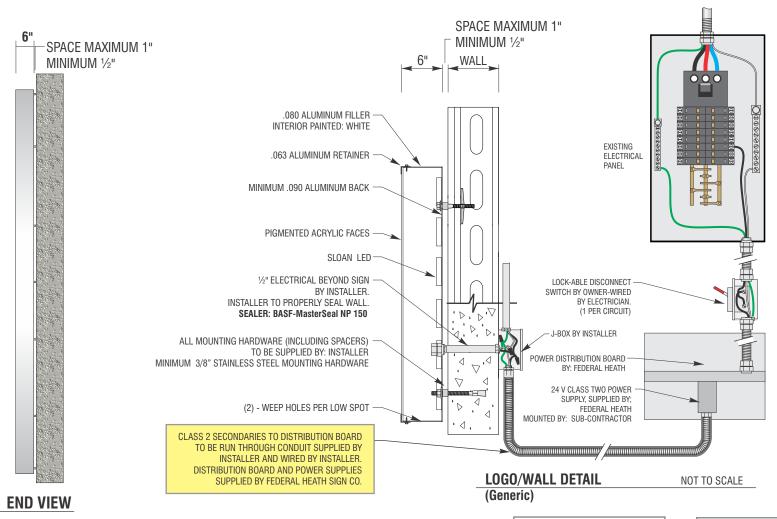

ELECTRICAL REQUIREMENTS

Total: 0.0 Amps

(1) 120V 20A Circuit Required.

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INSTALLER REQUIREMENTS

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NEW & REMODEL CONSTRUCTION


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GENERAL NOTE


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 TYPE, SIZE AND NUMBER OF FASTENERS TO BE DETERMINED.
 ALL BOLT HOLES TO BE DRILLED OR PUNCHED.
 ISOLATE ALL ALUMINUM FROM STEEL.




ACRYLIC FACED INTERNALLY ILLUMINATED "BULLSEYE"

MANUFACTURE AND INSTALL CHANNEL LOGO AS SHOWN AND NOTED
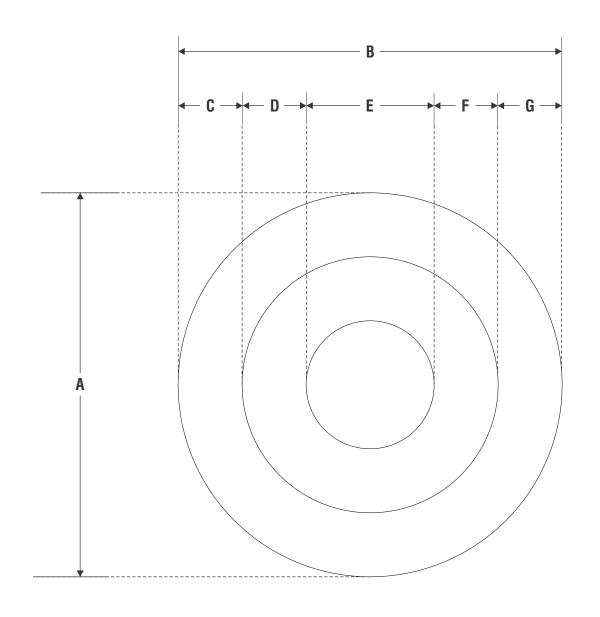
| SIGN TYPE | A | В | C | D | E | F | G | RETAINER | SQ.FT. | QTY |
|----------------|--------|--------|-------|-------|-------|-------|-------|----------|--------|-----|
| 156 BULLSEYE-W | 12'-0" | 12'-0" | 2'-0" | 2'-0" | 4'-0" | 2'-0" | 2'-0" | | 113.1 | 1 |

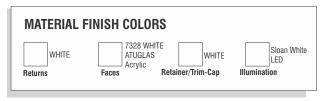

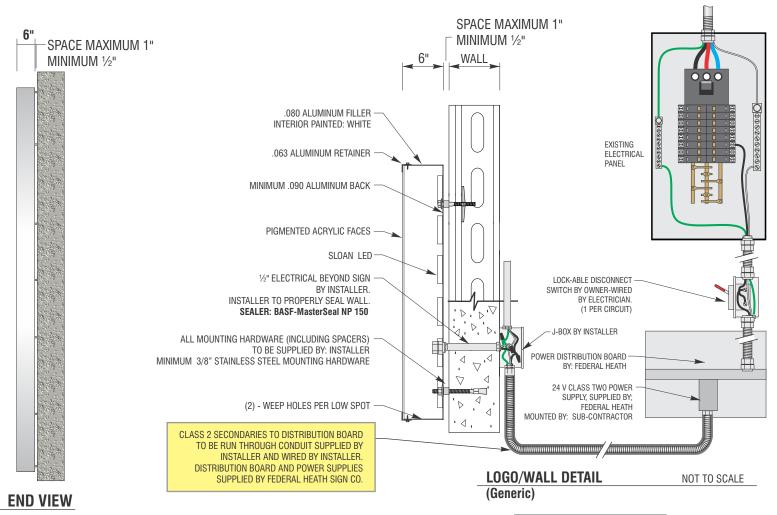

ELECTRICAL REQUIREMENTS

Total: 0.0 Amps

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