

DEKKER PERICH

SABATINI

ARCHITECTURE DESIGN INSPIRATION



PROJECT

ENGINEER

REVISIONS


DRAWN BY **REVIEWED BY** DATE 7/24/2020 PROJECT NO. 19-0007.001

DRAWING NAME OVERALL

SITE PLAN

SHEET NO.

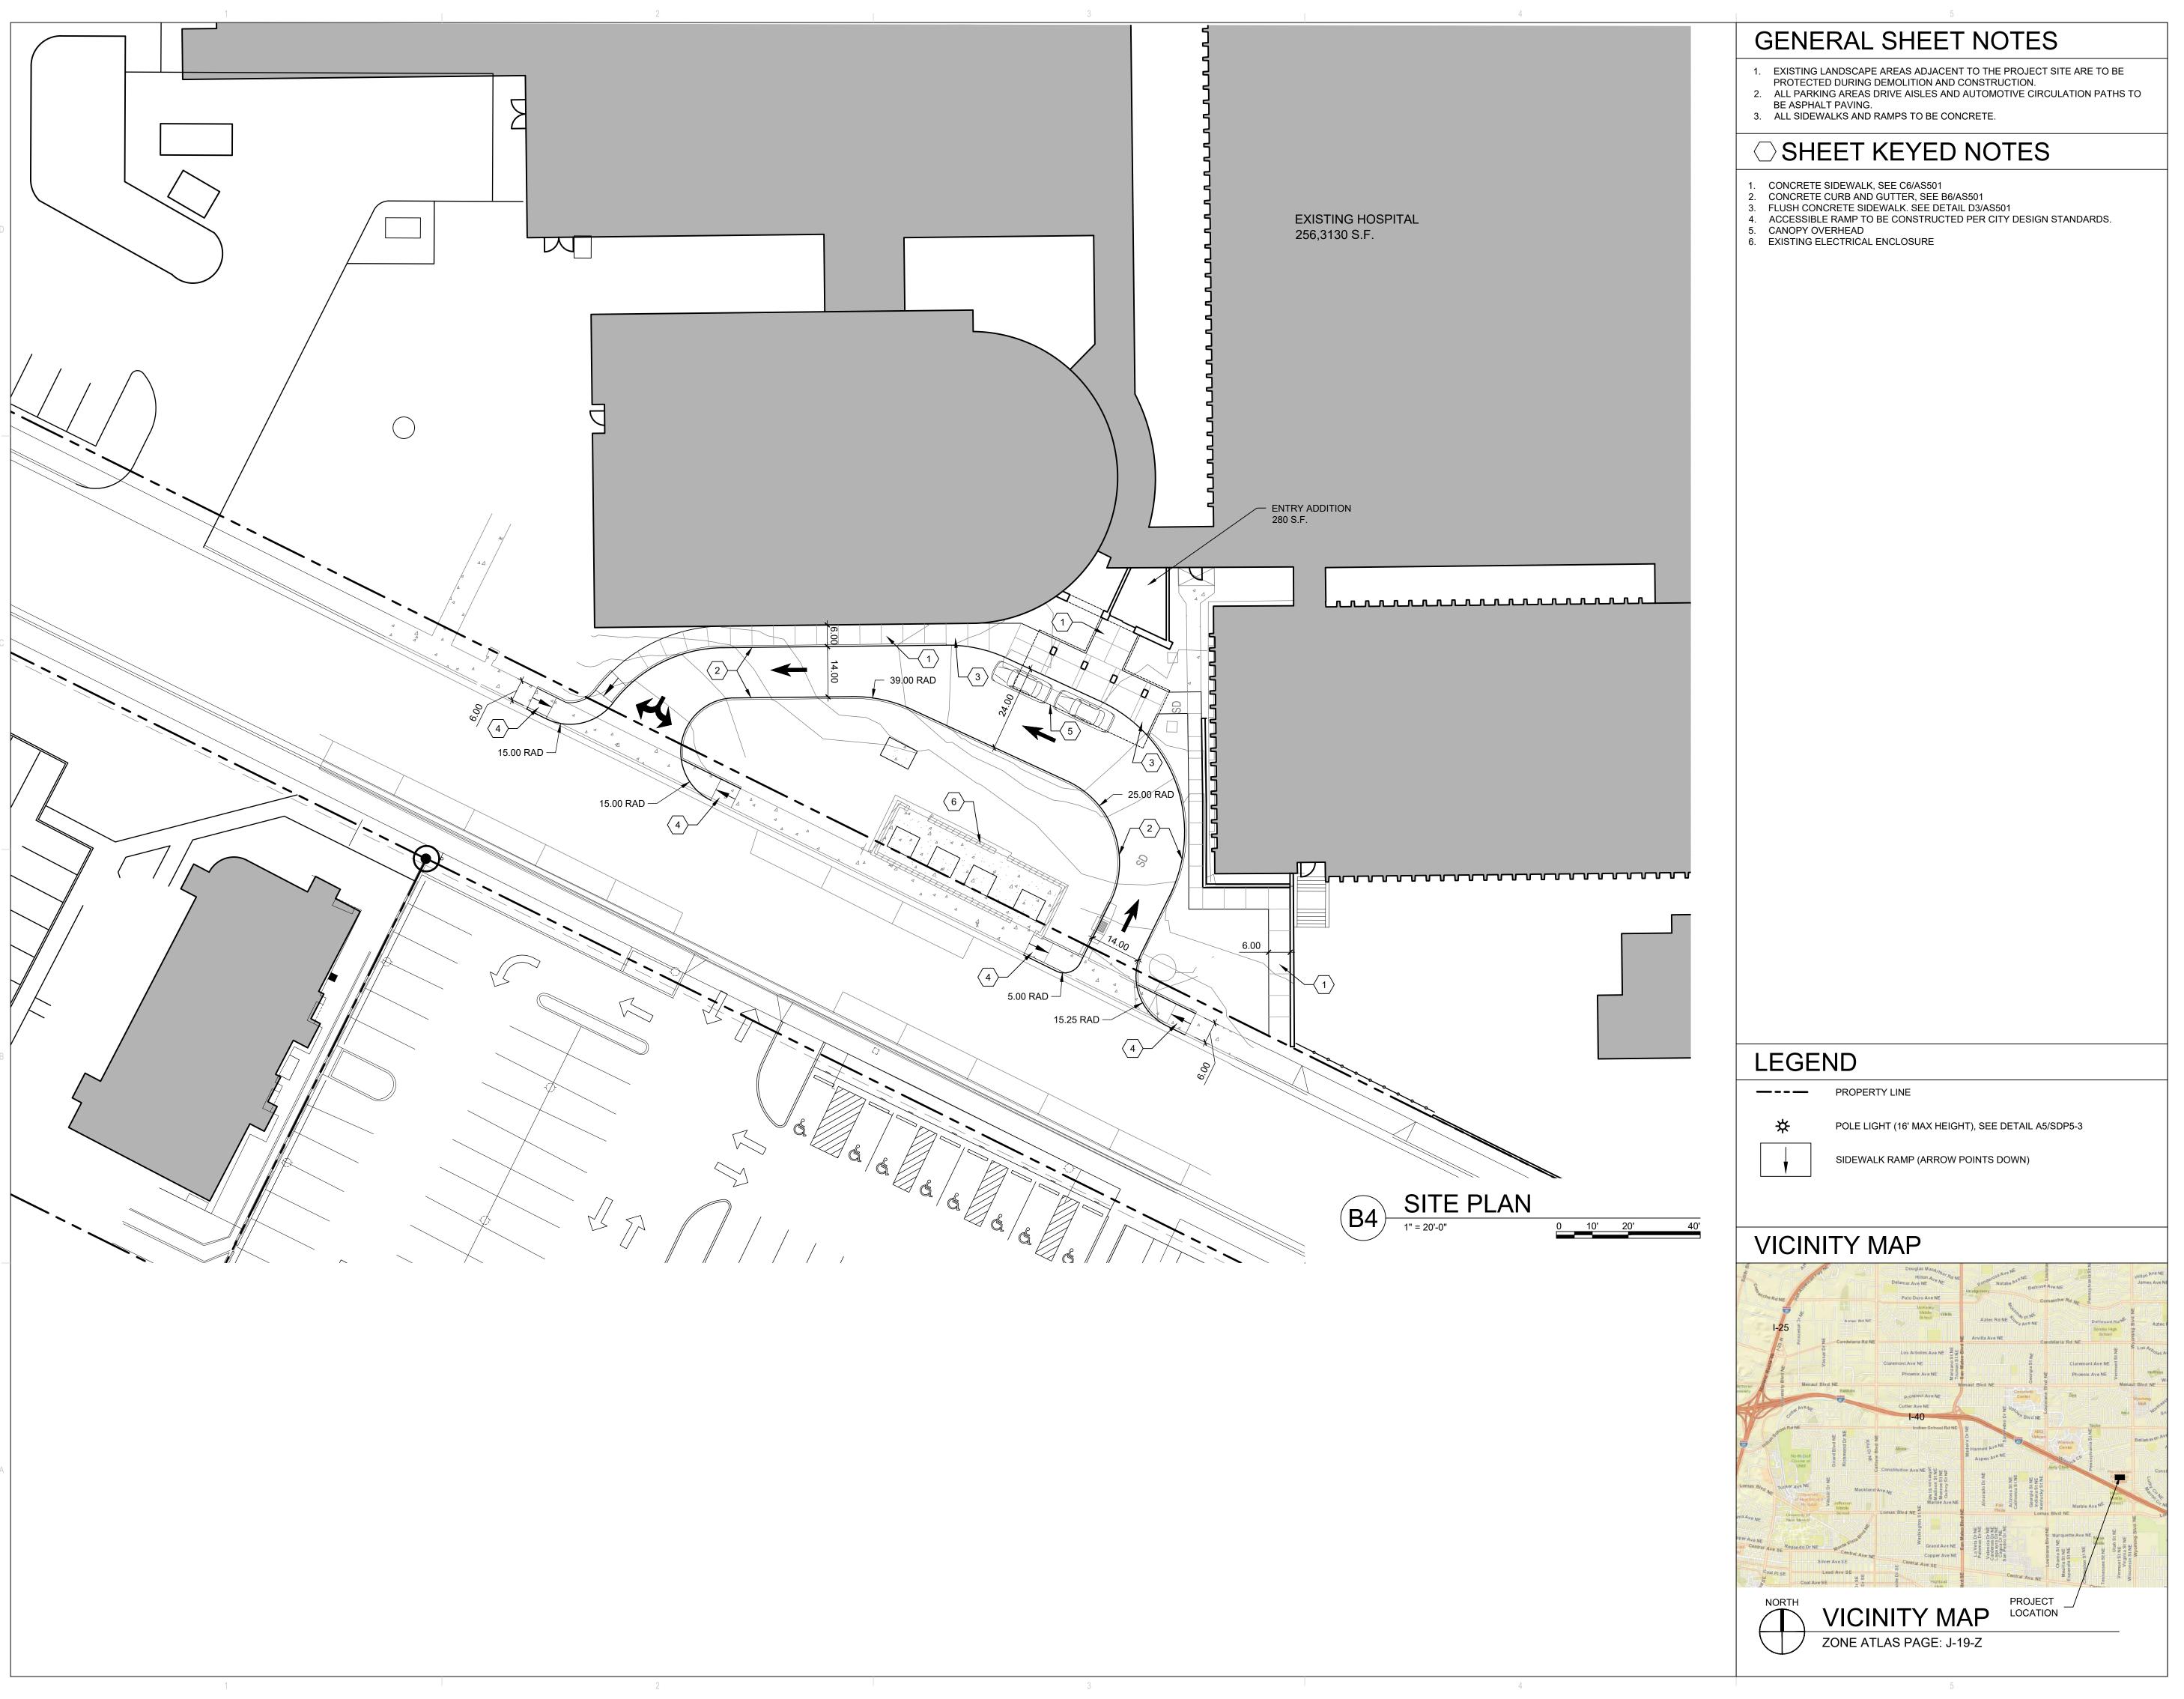AS100



ARCHITECTURE DESIGN INSPIRATION

ENGINEER

REVISIONS


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7/24/2020 19-0007.001 PROJECT NO. DRAWING NAME


ARCHITECTURAL SITE PLAN

AS101



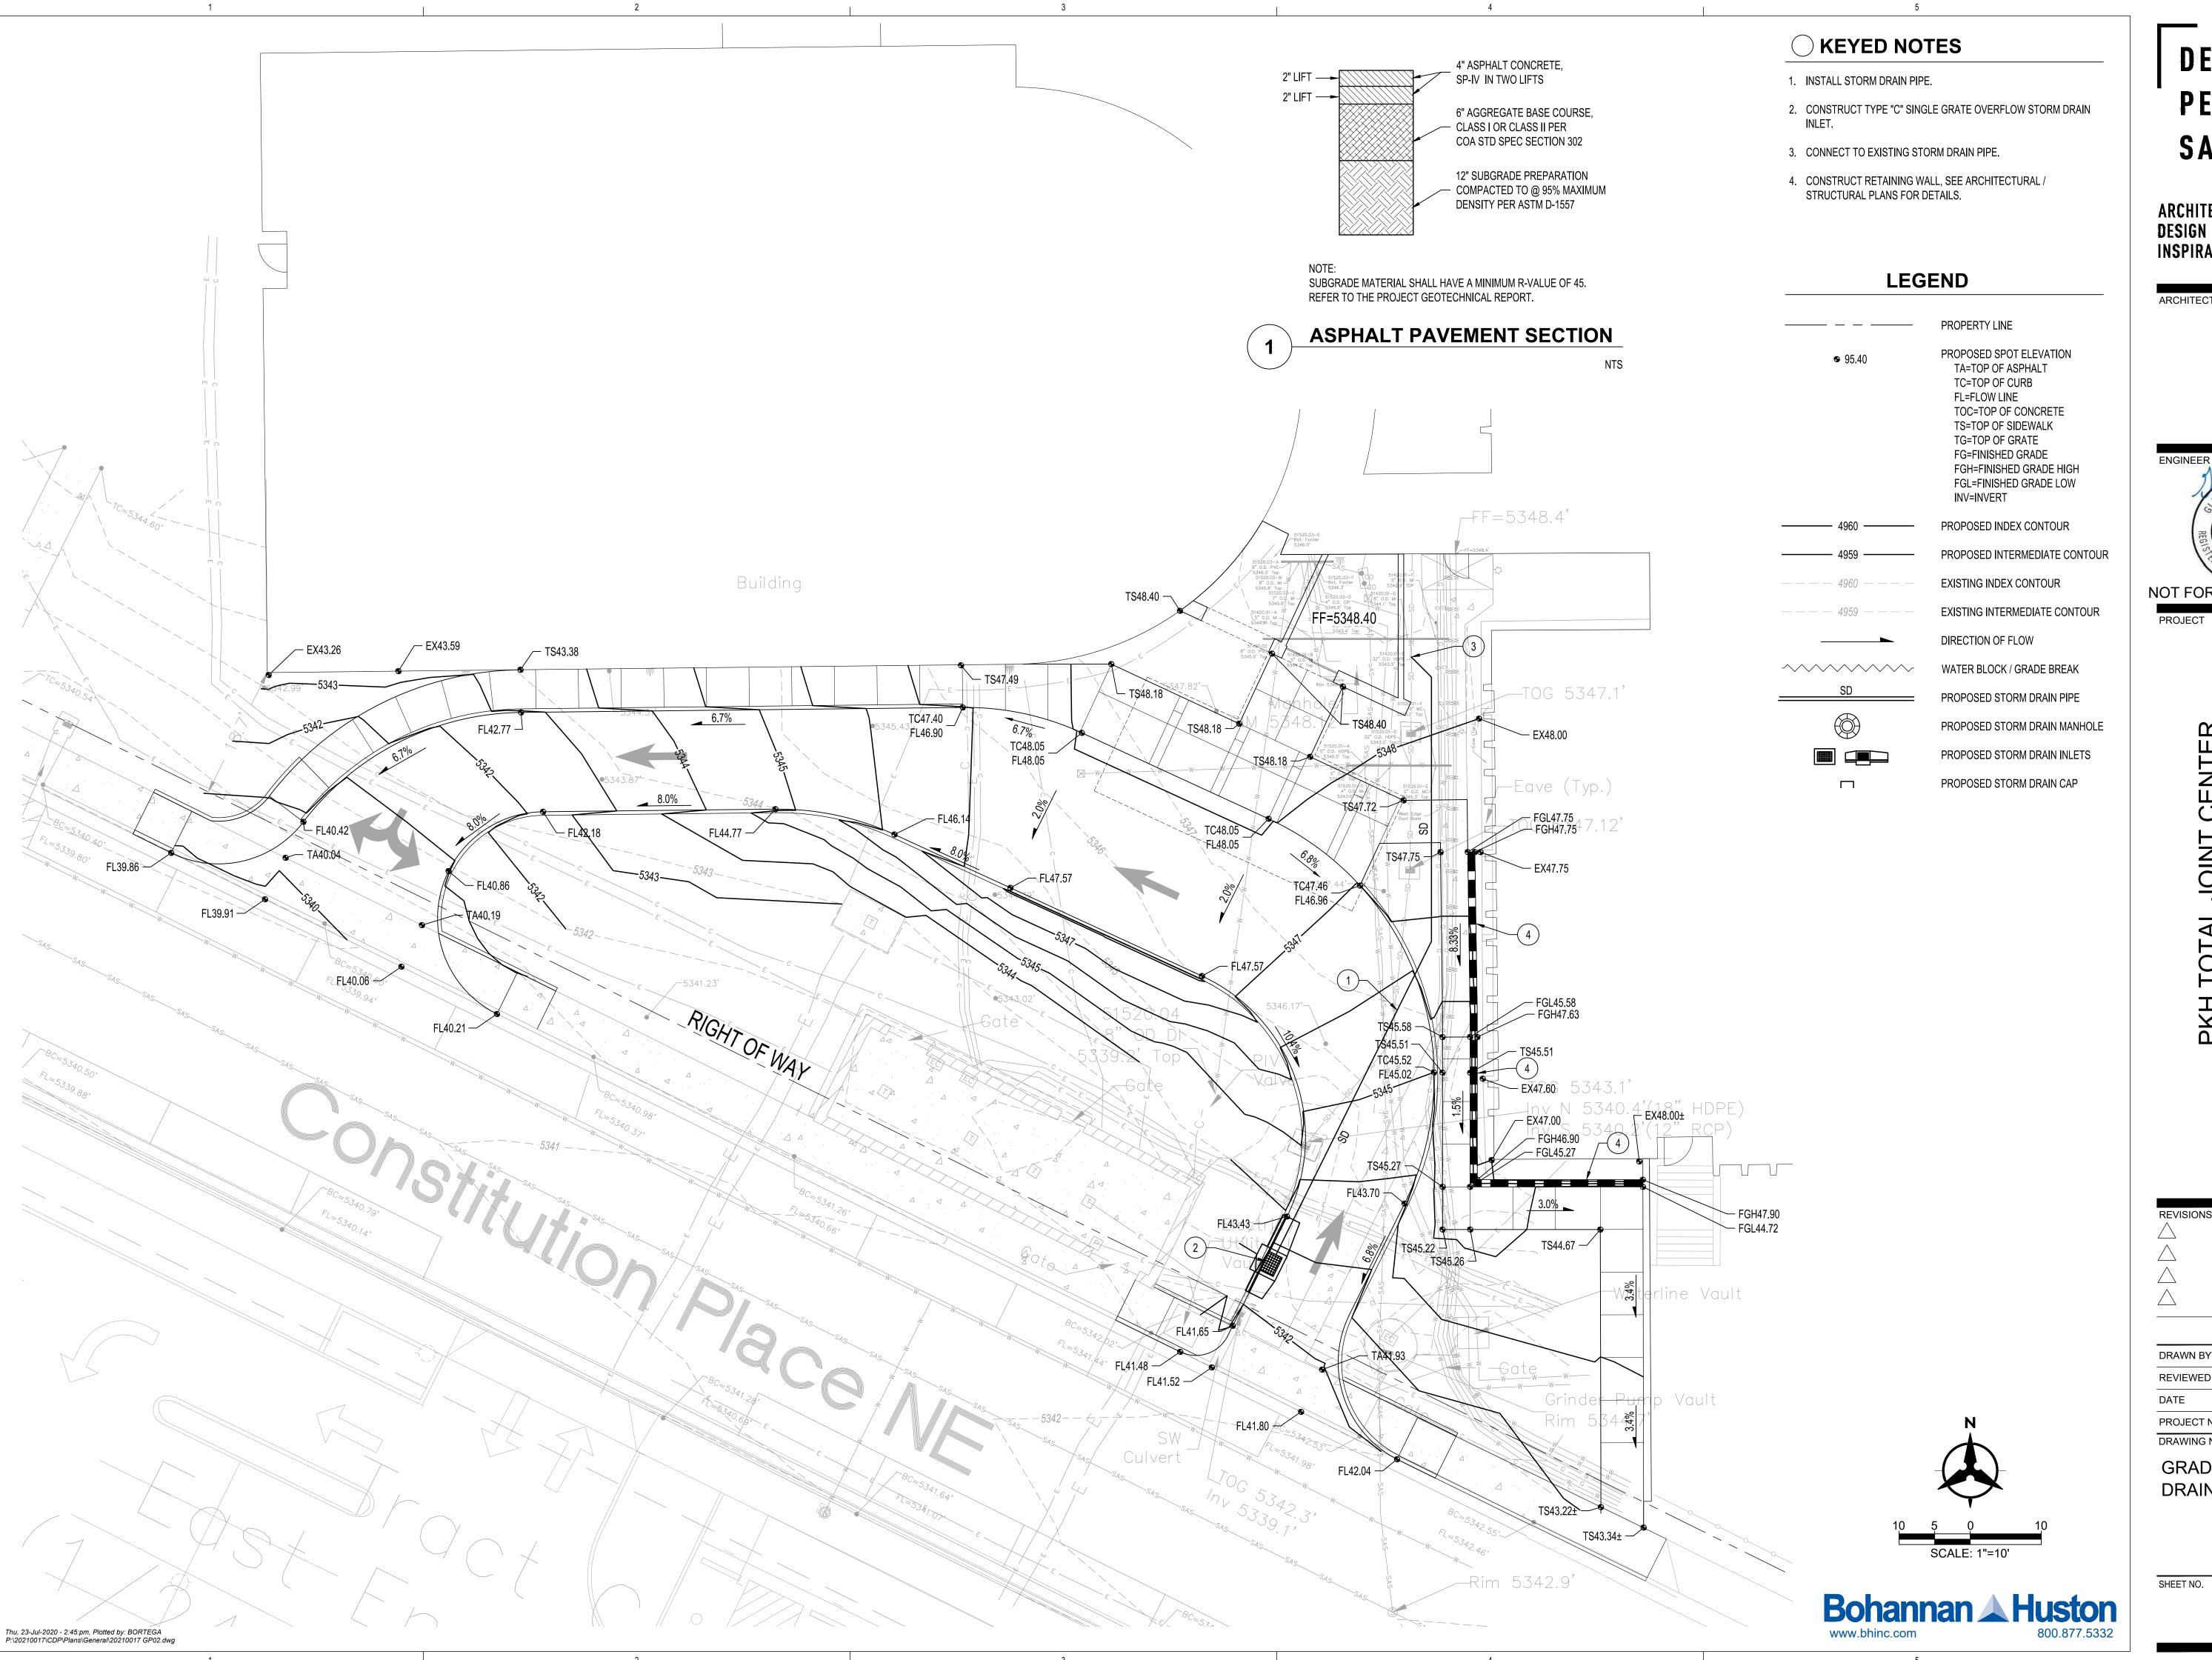ARCHITECTURE DESIGN INSPIRATION

ARCHITECT

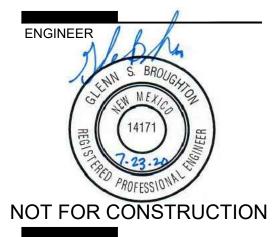


DRAWN BY REVIEWED BY 7/24/2020 PROJECT NO. 19-0007.001 DRAWING NAME

GRADING & DRAINAGE PLAN

SHEET NO.

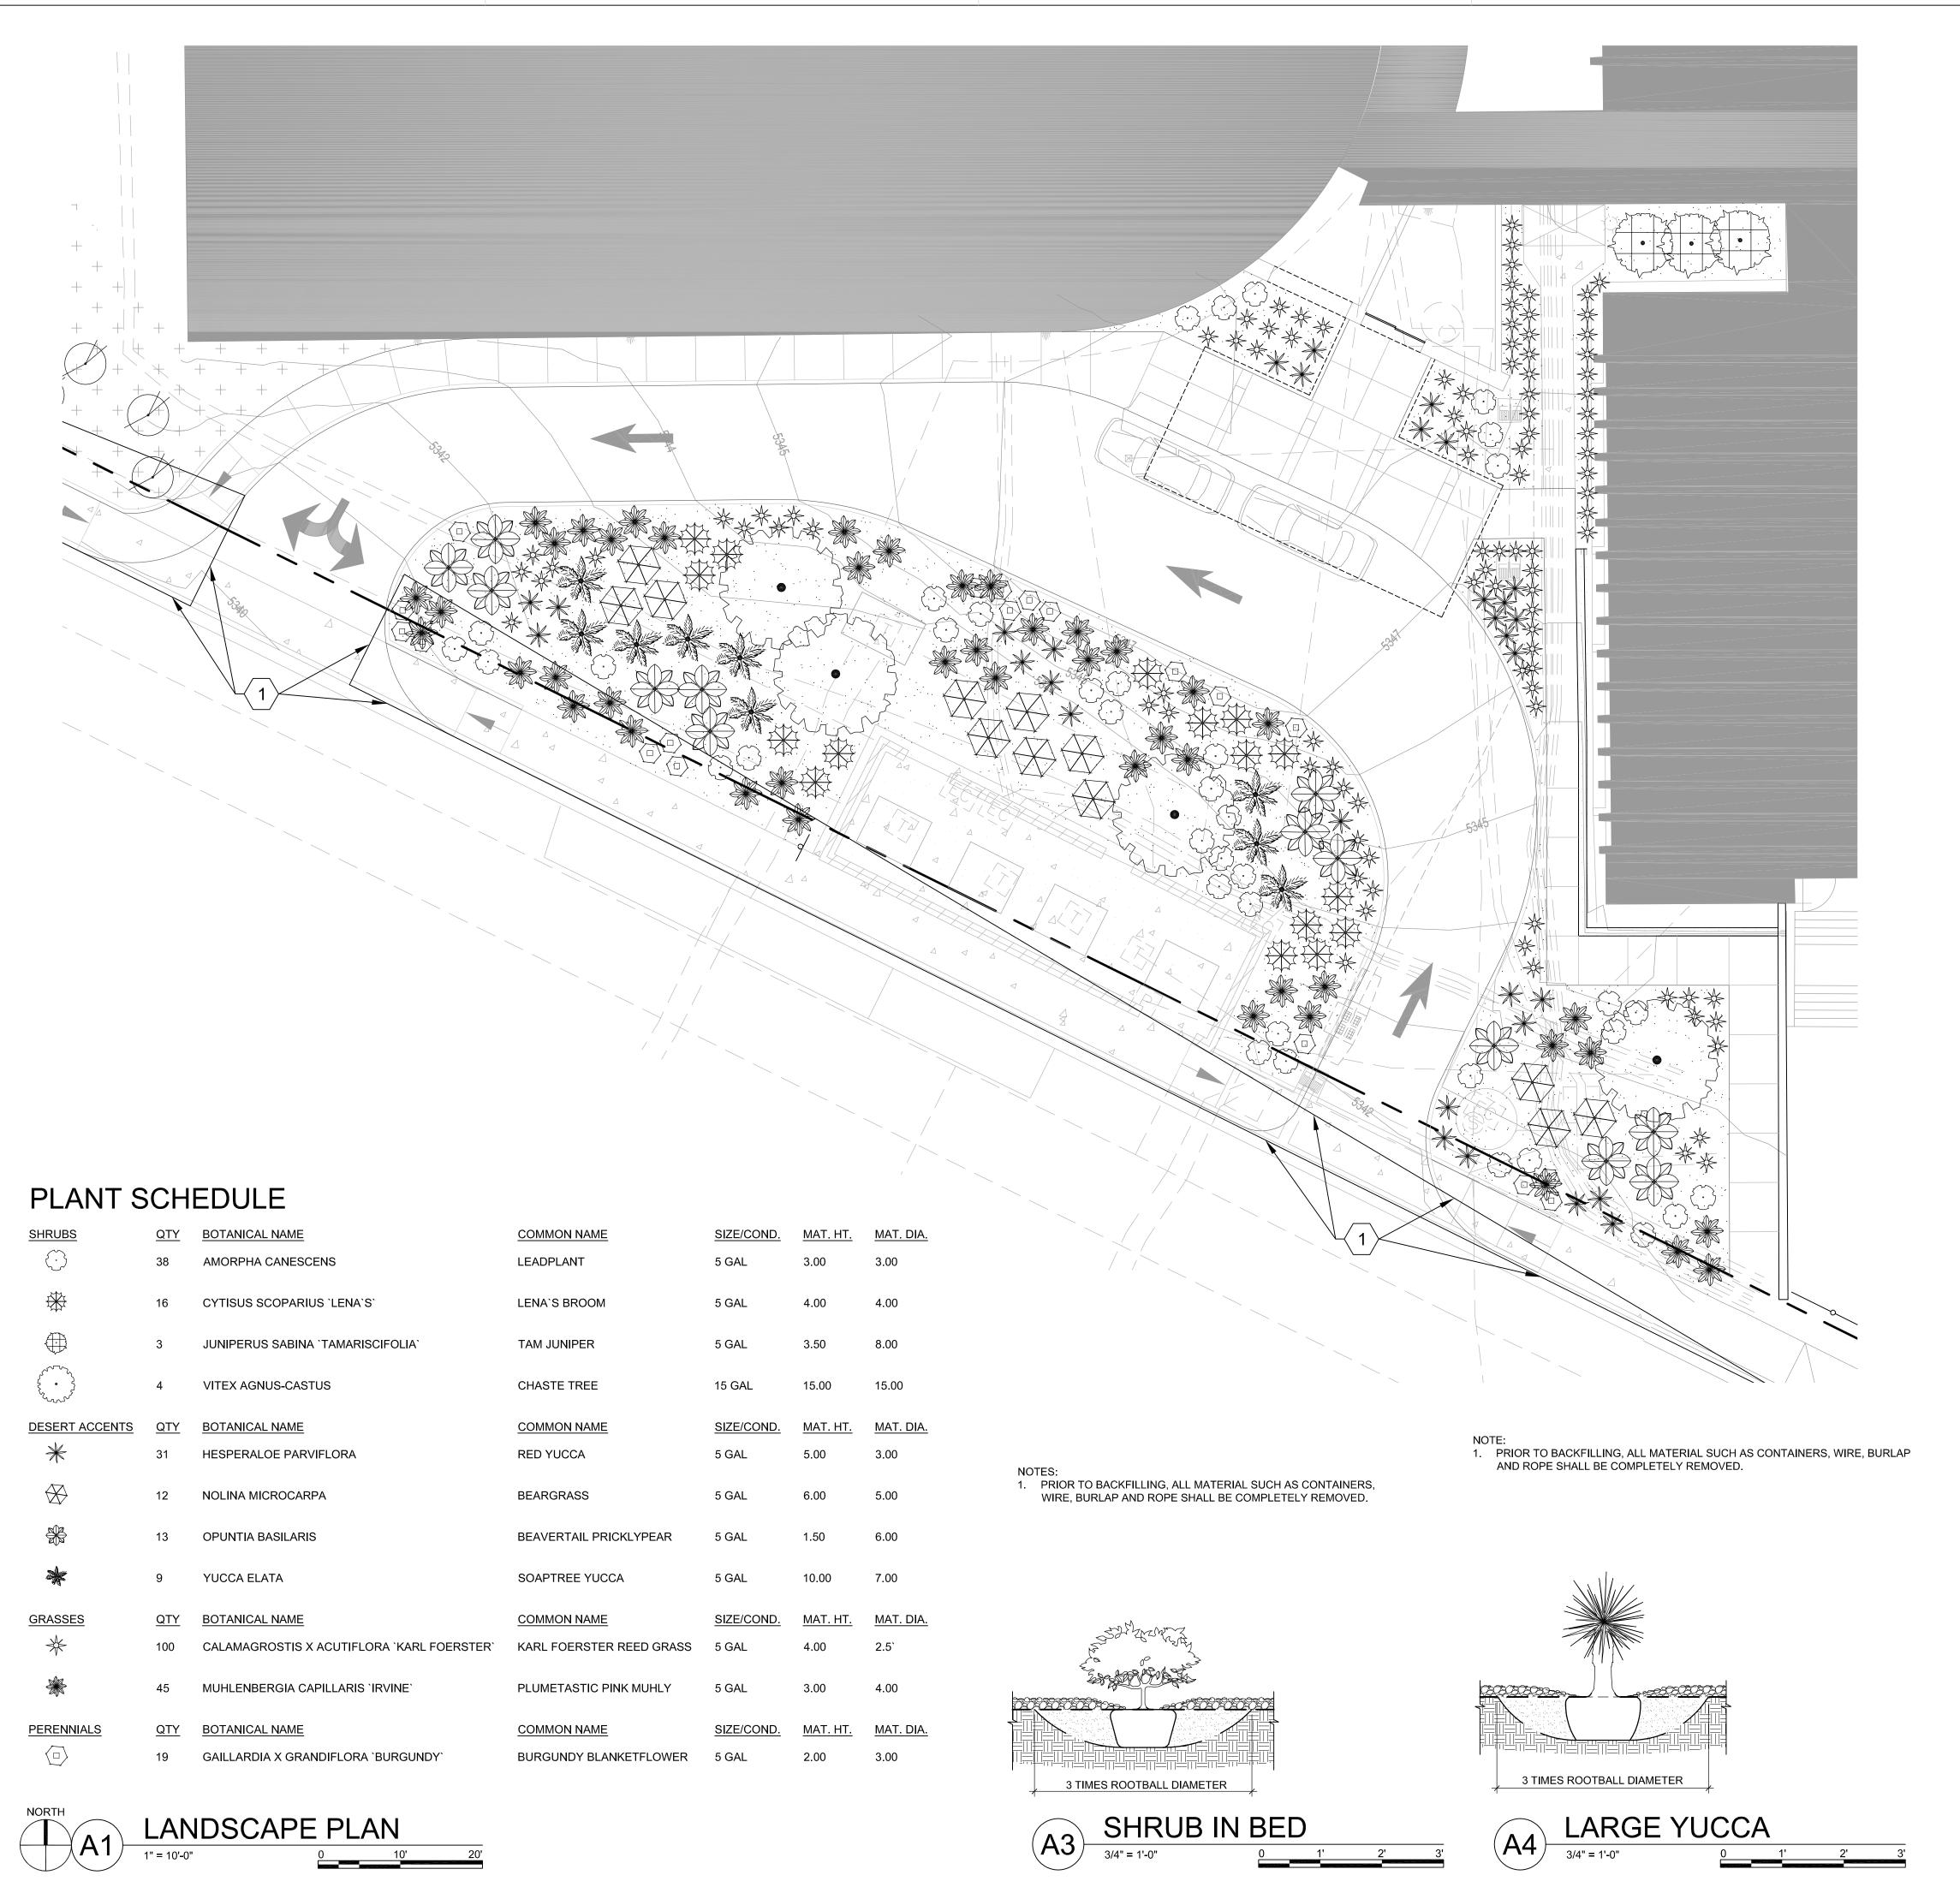C101



GENERAL SHEET NOTES

- A. RESPONSIBILITY FOR MAINTENANCE: THE CONTRACTOR WILL BE RESPONSIBLE FOR MAINTENANCE OF THE LANDSCAPE DURING CONSTRUCTION AND DURING A 90 DAY-MAINTENANCE PERIOD FOLLOWING SUBSTANTIAL COMPLETION. THE OWNER WILL BE RESPONSIBLE FOR MAINTENANCE FOLLOWING THE 90-DAY MAINTENANCE PERIOD.
- B. STATEMENT OF COMPLIANCE WITH CITY OF ALBUQUERQUE: THE LANDSCAPE DESIGN WILL COMPLY WITH THE CITY OF ALBUQUERQUE'S LANDSCAPING, BUFFERING, AND SCREENING REGULATIONS (14-16-5-6), WATER CONSERVATION ORDINANCE AND POLLEN ORDINANCE.
- WATER CONSERVATION ORDINANCE AND POLLEN ORDINANCE.
 C. TIMING OF LANDSCAPE INSTALLATION: INSTALLATION OF THE LANDSCAPING SHALL BE COMPLETE WITHIN 60 DAYS OF THE RELATED
- BUILDING'S OCCUPANCY.

 D. SURFACE TREATMENT: DISTURBED LANDSCAPE AREAS ARE OR SHALL BE COVERED WITH TURF, OR VEGETATION AND MULCH. ORGANIC MULCH IS REQUIRED AT EACH NEW TREE ROOTBALL AREA/DRIPLINE.
- E. LANDSCAPE AND SIGNAGE WILL NOT INTERFERE WITH CLEAR SIGHT REQUIREMENTS. THEREFORE SIGNS, WALLS, TREES AND SHRUBS BETWEEN 3 AND 7 FEET TALL (AS MEASURED FROM THE GUTTER PAN) WILL NOT BE PERMITTED IN THE CLEAR SIGHT TRIANGLE.
- F. MINIMUM PLANT SIZES ARE AS PER CITY OF ALBUQUERQUE STANDARDS PER TABLE 5-6-1 OF THE IDO.
- G. LANDSCAPE AREAS THAT AREA DISTURBED DURING CONSTRUCTION WILL BE REPAIRED TO THEIR ORIGINAL CONDITION.
- H. VEGETATIVE SCREENING SURROUNDING GROUND-MOUNTED TRANSFORMERS AND UTILITY PADS SHALL ALLOW 10' OF CLEARANCE MINIMUM IN FRONT OF THE EQUIPMENT DOOR AND 5' OF CLEARANCE MINIMUM ON THE REMAINING SIDES FOR SAFE OPERATION AND MAINTENANCE.
- EXISTING PLANT MATERIAL TO BE PRESERVED ON THE PROPERTY IS SHOWN AND QUANTIFIED IN THE LANDSCAPE CALCULATIONS.

J. SEE SITE PLAN FOR IMPERVIOUS AREAS AND EASEMENTS.

IRRIGATION NOTES

- A. THE IRRIGATION FOR NEW CONSTRUCTION AREAS IS CONNECTED TO THE SITE'S EXISTING IRRIGATION SYSTEM.
- B. THE IRRIGATION SYSTEM DESIGN IS BE BASED ON RECORD DRAWINGS AND OWNER'S REPRESENTATIVE'S INFORMATION TO SPECIFY EXISTING IRRIGATION EQUIPMENT AND DATA. RECORD DRAWINGS ARE AVAILABLE UPON REQUEST.
- C. THE IRRIGATION SYSTEM IS COMPRISED OF THE FOLLOWING:AN EXISTING POINT OF CONNECTION AND CONTROLLER ARE TBD. THE
- EXISTING CONTROLLER WILL OPERATE NEW AND EXISTING IRRIGATION.
 THE CURRENT VACUUM BREAKER, IF NOT IN COMPLIANCE, WILL BE REMOVED AND REPLACED WITH A NEW BACKFLOW PREVENTER THAT COMPLIES WITH THE CITY OF ALBUQUERQUE BACKFLOW PREVENTION DEVICE STANDARDS AND SPECIFICATIONS.
- THE IRRIGATION ZONES BEING CREATED OR MODIFIED WITH THIS PROJECT ARE COMPRISED OF THE FOLLOWING:
 NEW DRIP IRRIGATION ZONES.
- o RETROFIT ZONES THAT ARE IRRIGATING EXISTING PLANTS.

 D. THE NEW DRIP IRRIGATION ZONES ARE DESIGNED TO MINIMIZE THE USE
- E. THE NEW AND RETROFIT IRRIGATION ZONES WILL NOT IRRIGATE IMPERVIOUS SURFACES, INCLUDING SIDEWALKS, DRIVEWAYS, STREETS, PARKING, AND LOADING AREAS.
- F. THE NEW AND RETROFIT IRRIGATION ZONE'S RUN TIMES ARE BASE UPON PLANT SPECIES AND ESTABLISHMENT. THE CONTRACTOR SHALL ADJUST RUN TIMES ACCORDING TO PLANT MATURITY, SEASON, LOCATION, AND PLANT PERFORMANCE.
- PLANT PERFORMANCE.

 G. THE CONTRACTOR SHALL AUDIT THE EXISTING IRRIGATION SYSTEM TO DETERMINE ITS EXTENTS, PERFORMANCE, AND CONDITION. THE CONTRACTOR SHALL VERIFY THE EXISTING SYSTEM AND NOTE WATER METERS, SHUT-OFF VALVES, BACKFLOW PREVENTION ASSEMBLIES, PIPING, STATIONS AND OTHER COMPONENTS NECESSARY TO MANAGE
- DISTURBANCE, REPLACEMENT, AND OPERATION DURING CONSTRUCTION.
 THE CONTRACTOR SHALL PROTECT THE EXISTING IRRIGATION SYSTEM TO ENSURE THAT REMAINING PLANT MATERIAL RECEIVES IRRIGATION DURING CONSTRUCTION. THE CONTRACTOR MAY TEMPORARILY MODIFY THE EXISTING IRRIGATION SYSTEM TO ASSURE IRRIGATION TO THE REMAINING PLANT MATERIALS DURING CONSTRUCTION.
- THE CONTRACTOR SHALL OBTAIN NECESSARY PERMITS REQUIRED TO PERFORM THE WORK INDICATED HEREIN BEFORE BEGINNING WORK.

LEGEND

PROPERTY LINE

EXISTING SHRUB

EXISTING SHRUB TO REMAIN AND BE PROTECTED DURING CONSTRUCTION

7/8"Ø SANTA FE BROWN ROCK MULCH AT 3" DEPTH OVER WEED BARRIER FABRIC

EXISTING VEGETATION TO REMAIN

SHEET KEYED NOTES

SYMBOL DESCRIP

 $\langle 1 \rangle$

CLEAR SIGHT TRIANGLE, NO PLANT MATERIAL WITH A MATURE HEIGHT GREATER THAN 3'-0" TO BE WITHIN THIS AREA

LANDSCAPE CALCULATIONS

REQUIRED STREET TREES = 1 TREE PER 25' LINEAR FEET OF STREET FRONTAGE
STREET TREES =

CONSTITUTION PLACE FRONTAGE = 219 LNFT
REQUIRED STREET TREES = 9
PROVIDED STREET TREES = 0*
(*TREES NOT POSSIBLE DUE TO EXISTING UTILITIES)

GROUND COVER MATERIAL
TOTAL ROCK MULCH GROUN

MULCHED LANDSCAPE AREA)

TOTAL ROCK MULCH GROUND COVER = 5526 SF (100% OF MULCHED LANDSCAPE AREA)

REQUIRED VEGETATIVE COVERAGE
TOTAL VEGETATIVE COVER REQUIRED = 4,4145 SF (75% OF TOTAL MULCHED LANDSCAPE AREA)
TOTAL VEGETATIVE COVER PROVIDED = 4194 SF (75% OF TOTAL

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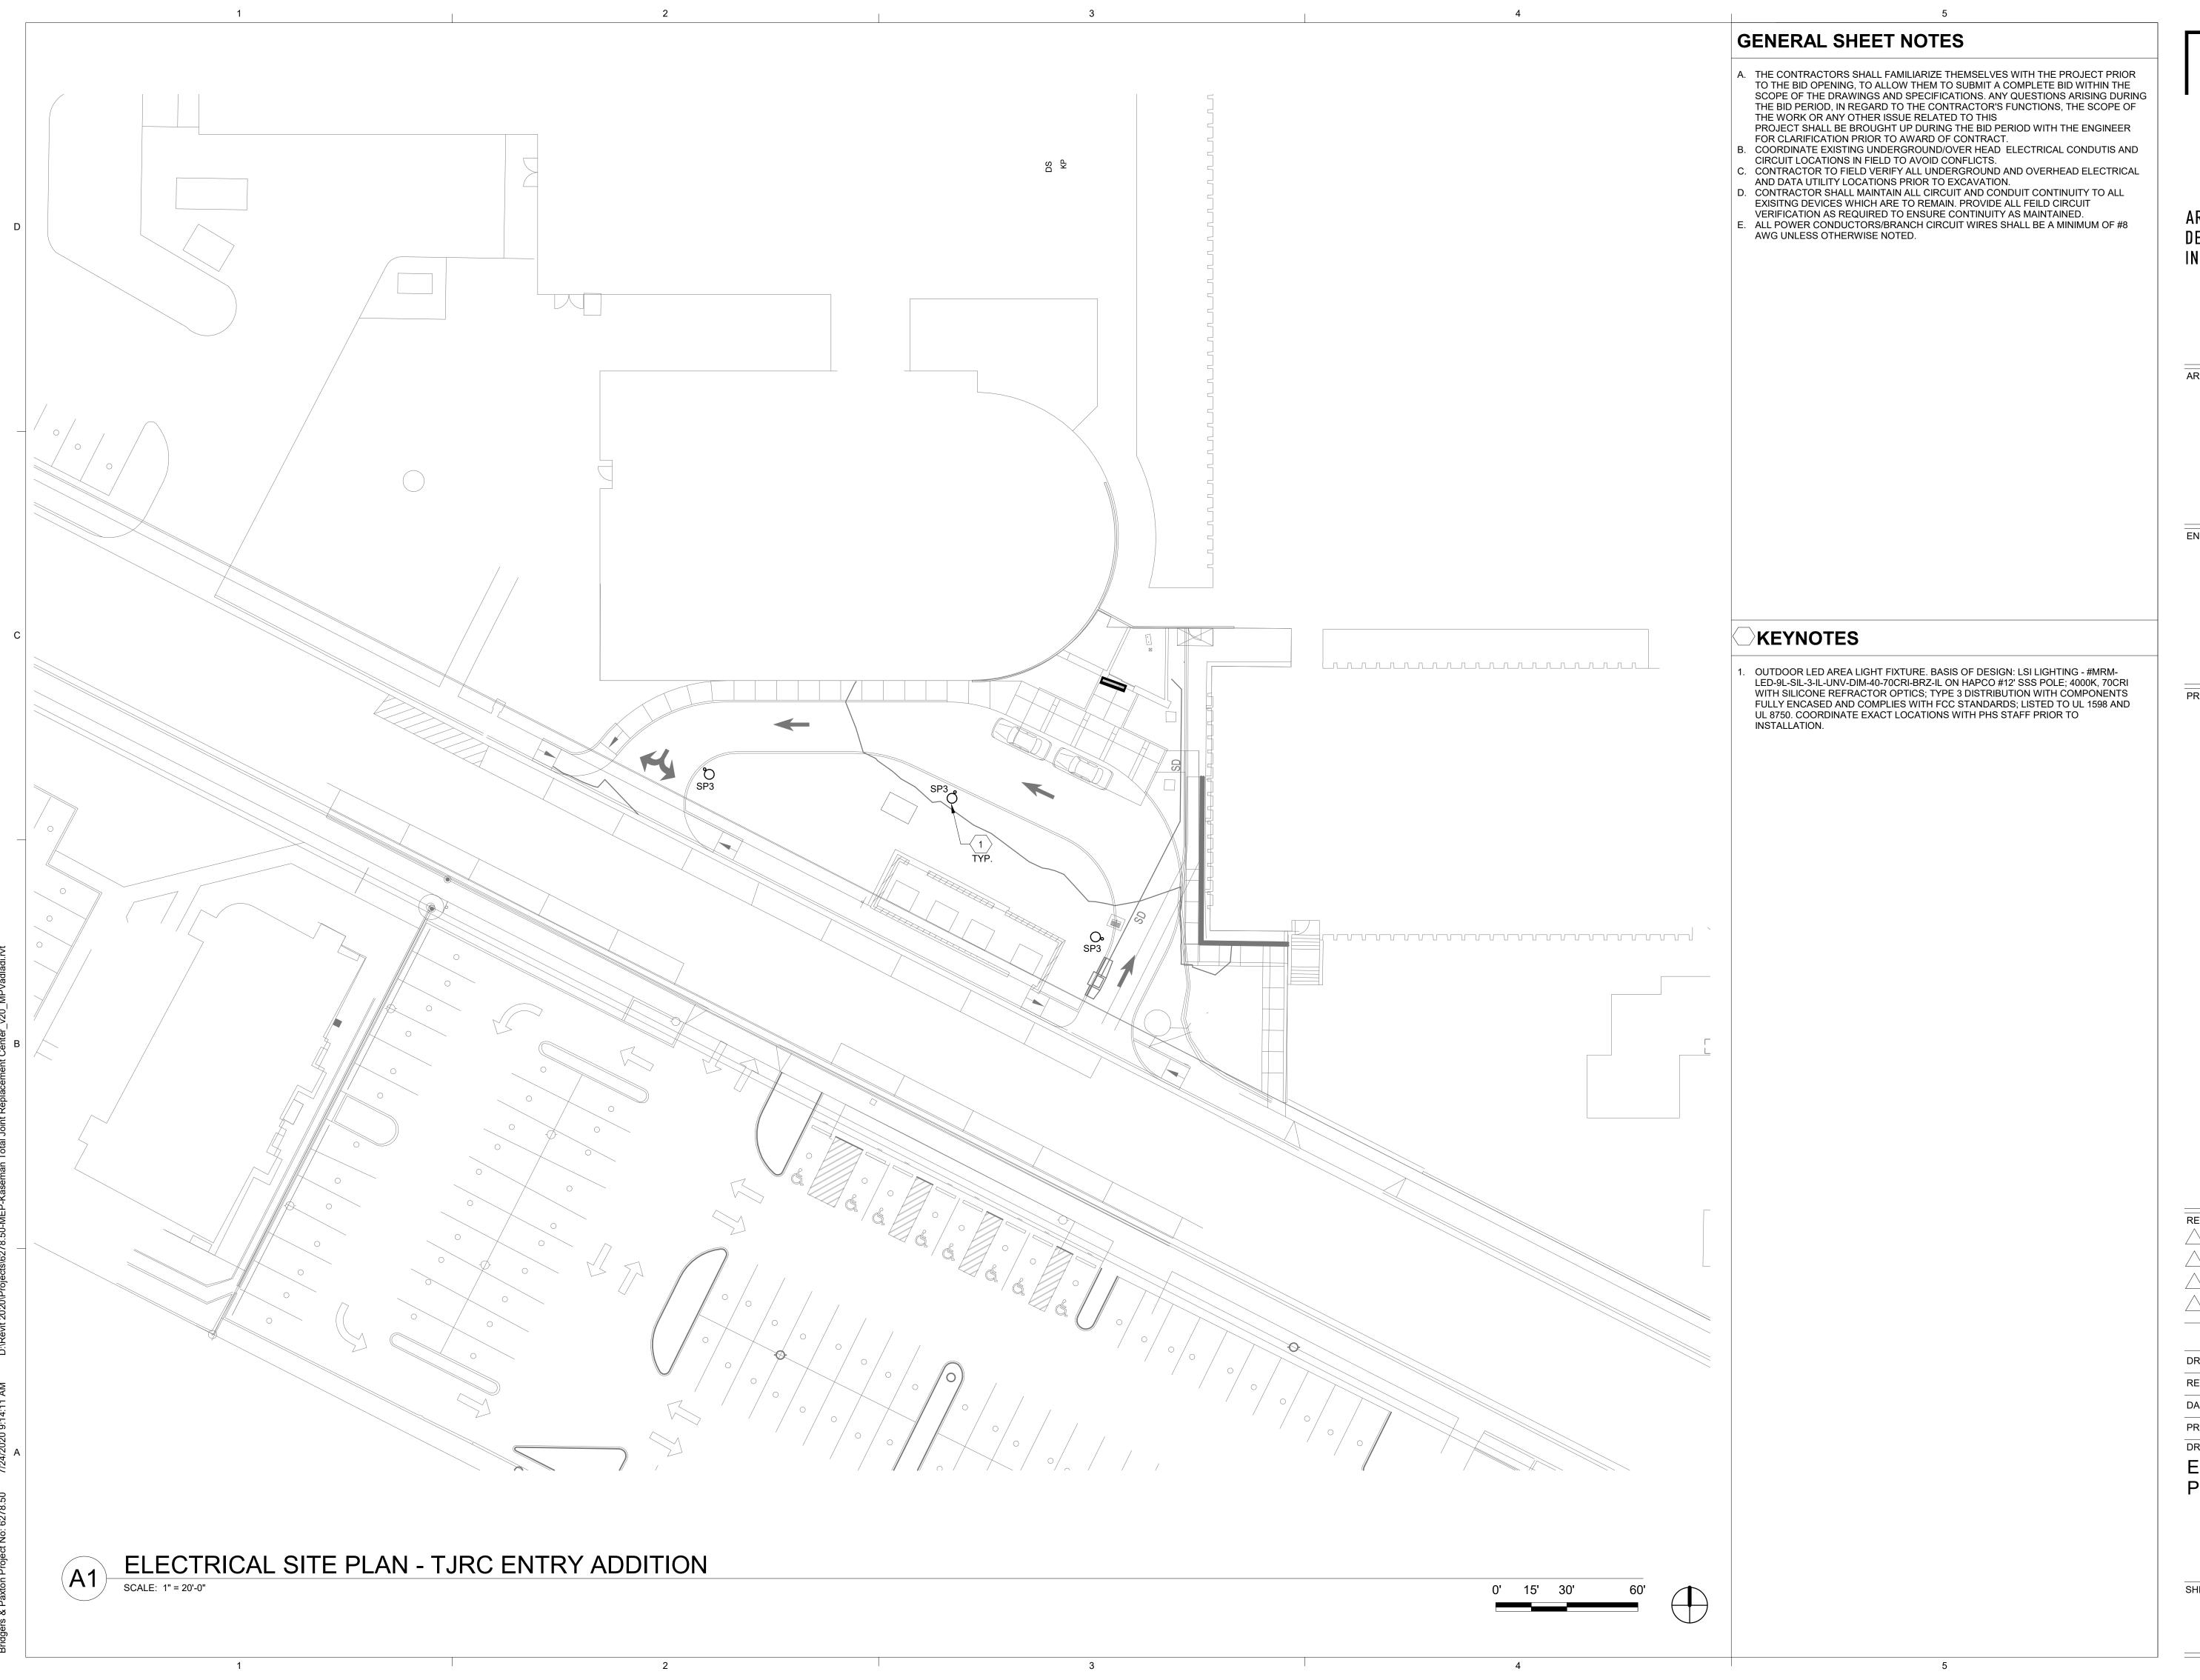
SITE DEVELOPMENT PLAN FOR BUILDING PERMIT
8300 CONSTITUTION AVE. NE

DRAWN BY CD
REVIEWED BY MB
DATE 7/24/2020
PROJECT NO. 19-0007.001
DRAWING NAME

LANDSCAPE PLAN

SHEET NO.

LP10′



ARCHITECTURE DESIGN INSPIRATION

BRIDGERS

BRIDGERS

4600 C Montgomery Blvd. NE
Albuquerque, NM 87109
505.883.4111 www.bpce.com

INNOVATIVE | DEPENDABLE | SOLUTIONS

ENGINEER

S L. CHALLES IN MEAN COMPANY OF THE PROPERTY O

PROJCET

PKH TOTAL JOINT CENTER
SITE DELEVOPMENT PLAN FOR BUILDING PERMI8300 CONSTITUTION AVE. NE
ALBUQUERQUE, NM 87110

REVISIONS

 DRAWN BY
 MF

 REVIEWED BY
 CL

 DATE
 7/24/202


 PROJECT NO.
 19-0007.00

DRAWING NAME
ELECTRIC

ELECTRICAL SITE PLAN

SHEET NO.

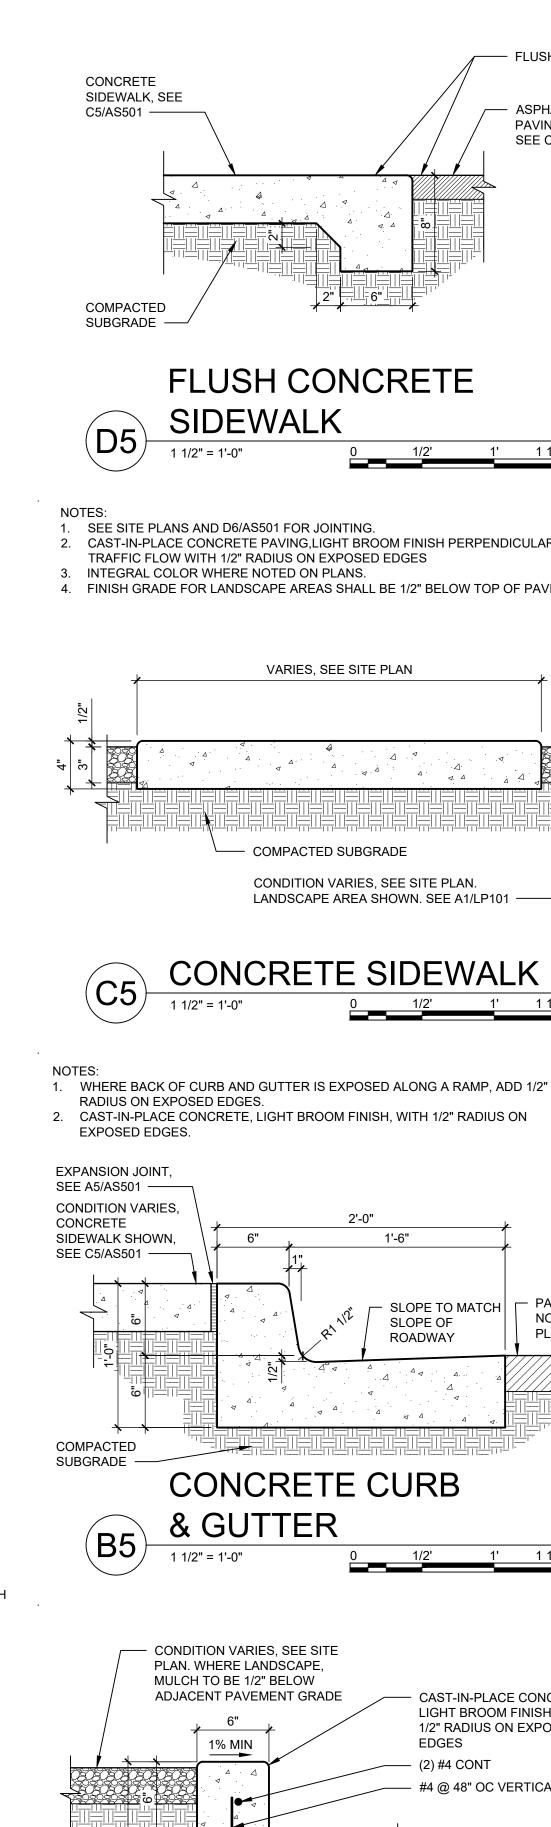ES102




1/4" WIDE DRY JOINT SAWCUT 3/16" WIDE x 1/3rd DEPTH OF SLAB, SEE SITE PLAN FOR LOCATIONS SAWCUT CONTROL JOINT 1/4" WIDE x 1" DEEP TOOLED CONCRETE JOINT WITH 1/4" RADIUS ON EDGES, SEE SITE PLAN FOR LOCATIONS CONCRETE JOINT - POURABLE FILLER (COLOR TO MATCH CONCRETE) ON BACKER ROD, 1/4" RADIUS ON EXPOSED EDGES

EXPANSION JOINT		EDGES			
ONTROL AND EXPANSION JOINT SPACING -UNLESS NOTED OTHERWISE ON PLANS					
PPROX WIDTH F CONCRETE	CURB & GUTTER, ROLL, HEADER, FLUSH CURBS	5' WALK	8' WALK & BLDG APRON	6'-12' WALK	
ONTROL JOINTS	4' OC	5' OC	8' OC	6' OC	
XPANSION JOINTS	16' OC	15' OC	24' OC	18' OC	


CONCRETE JOINTS

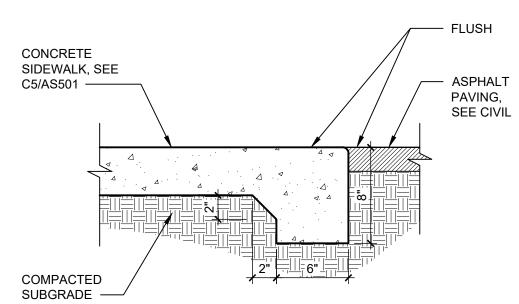& JOINT SPACING




FLUSH CONCRETE

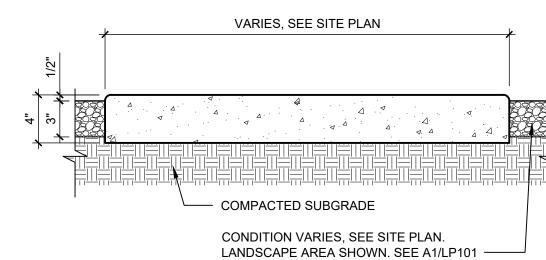- 2. CAST-IN-PLACE CONCRETE PAVING, LIGHT BROOM FINISH PERPENDICULAR TO TRAFFIC FLOW WITH 1/2" RADIUS ON EXPOSED EDGES
- 4. FINISH GRADE FOR LANDSCAPE AREAS SHALL BE 1/2" BELOW TOP OF PAVING.




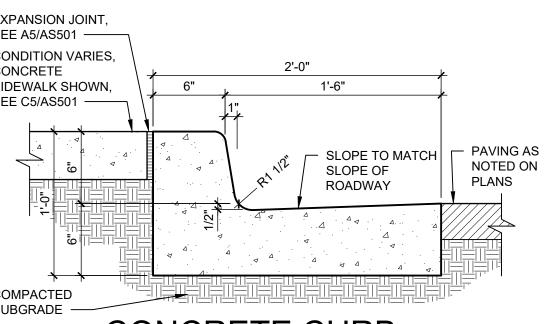RADIUS ON EXPOSED EDGES.
2. CAST-IN-PLACE CONCRETE, LIGHT BROOM FINISH, WITH 1/2" RADIUS ON



CONCRETE CURB



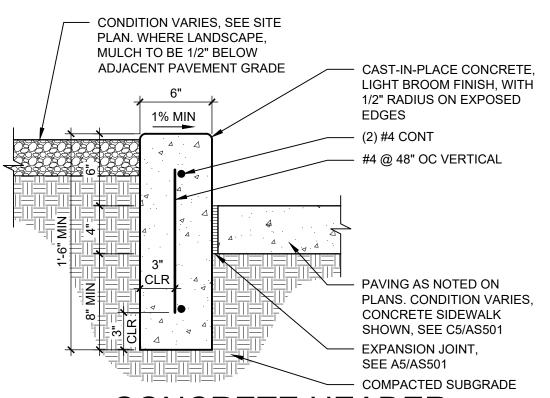

CONCRETE HEADER

CURB (A5) 1 1/2" = 1'-0"

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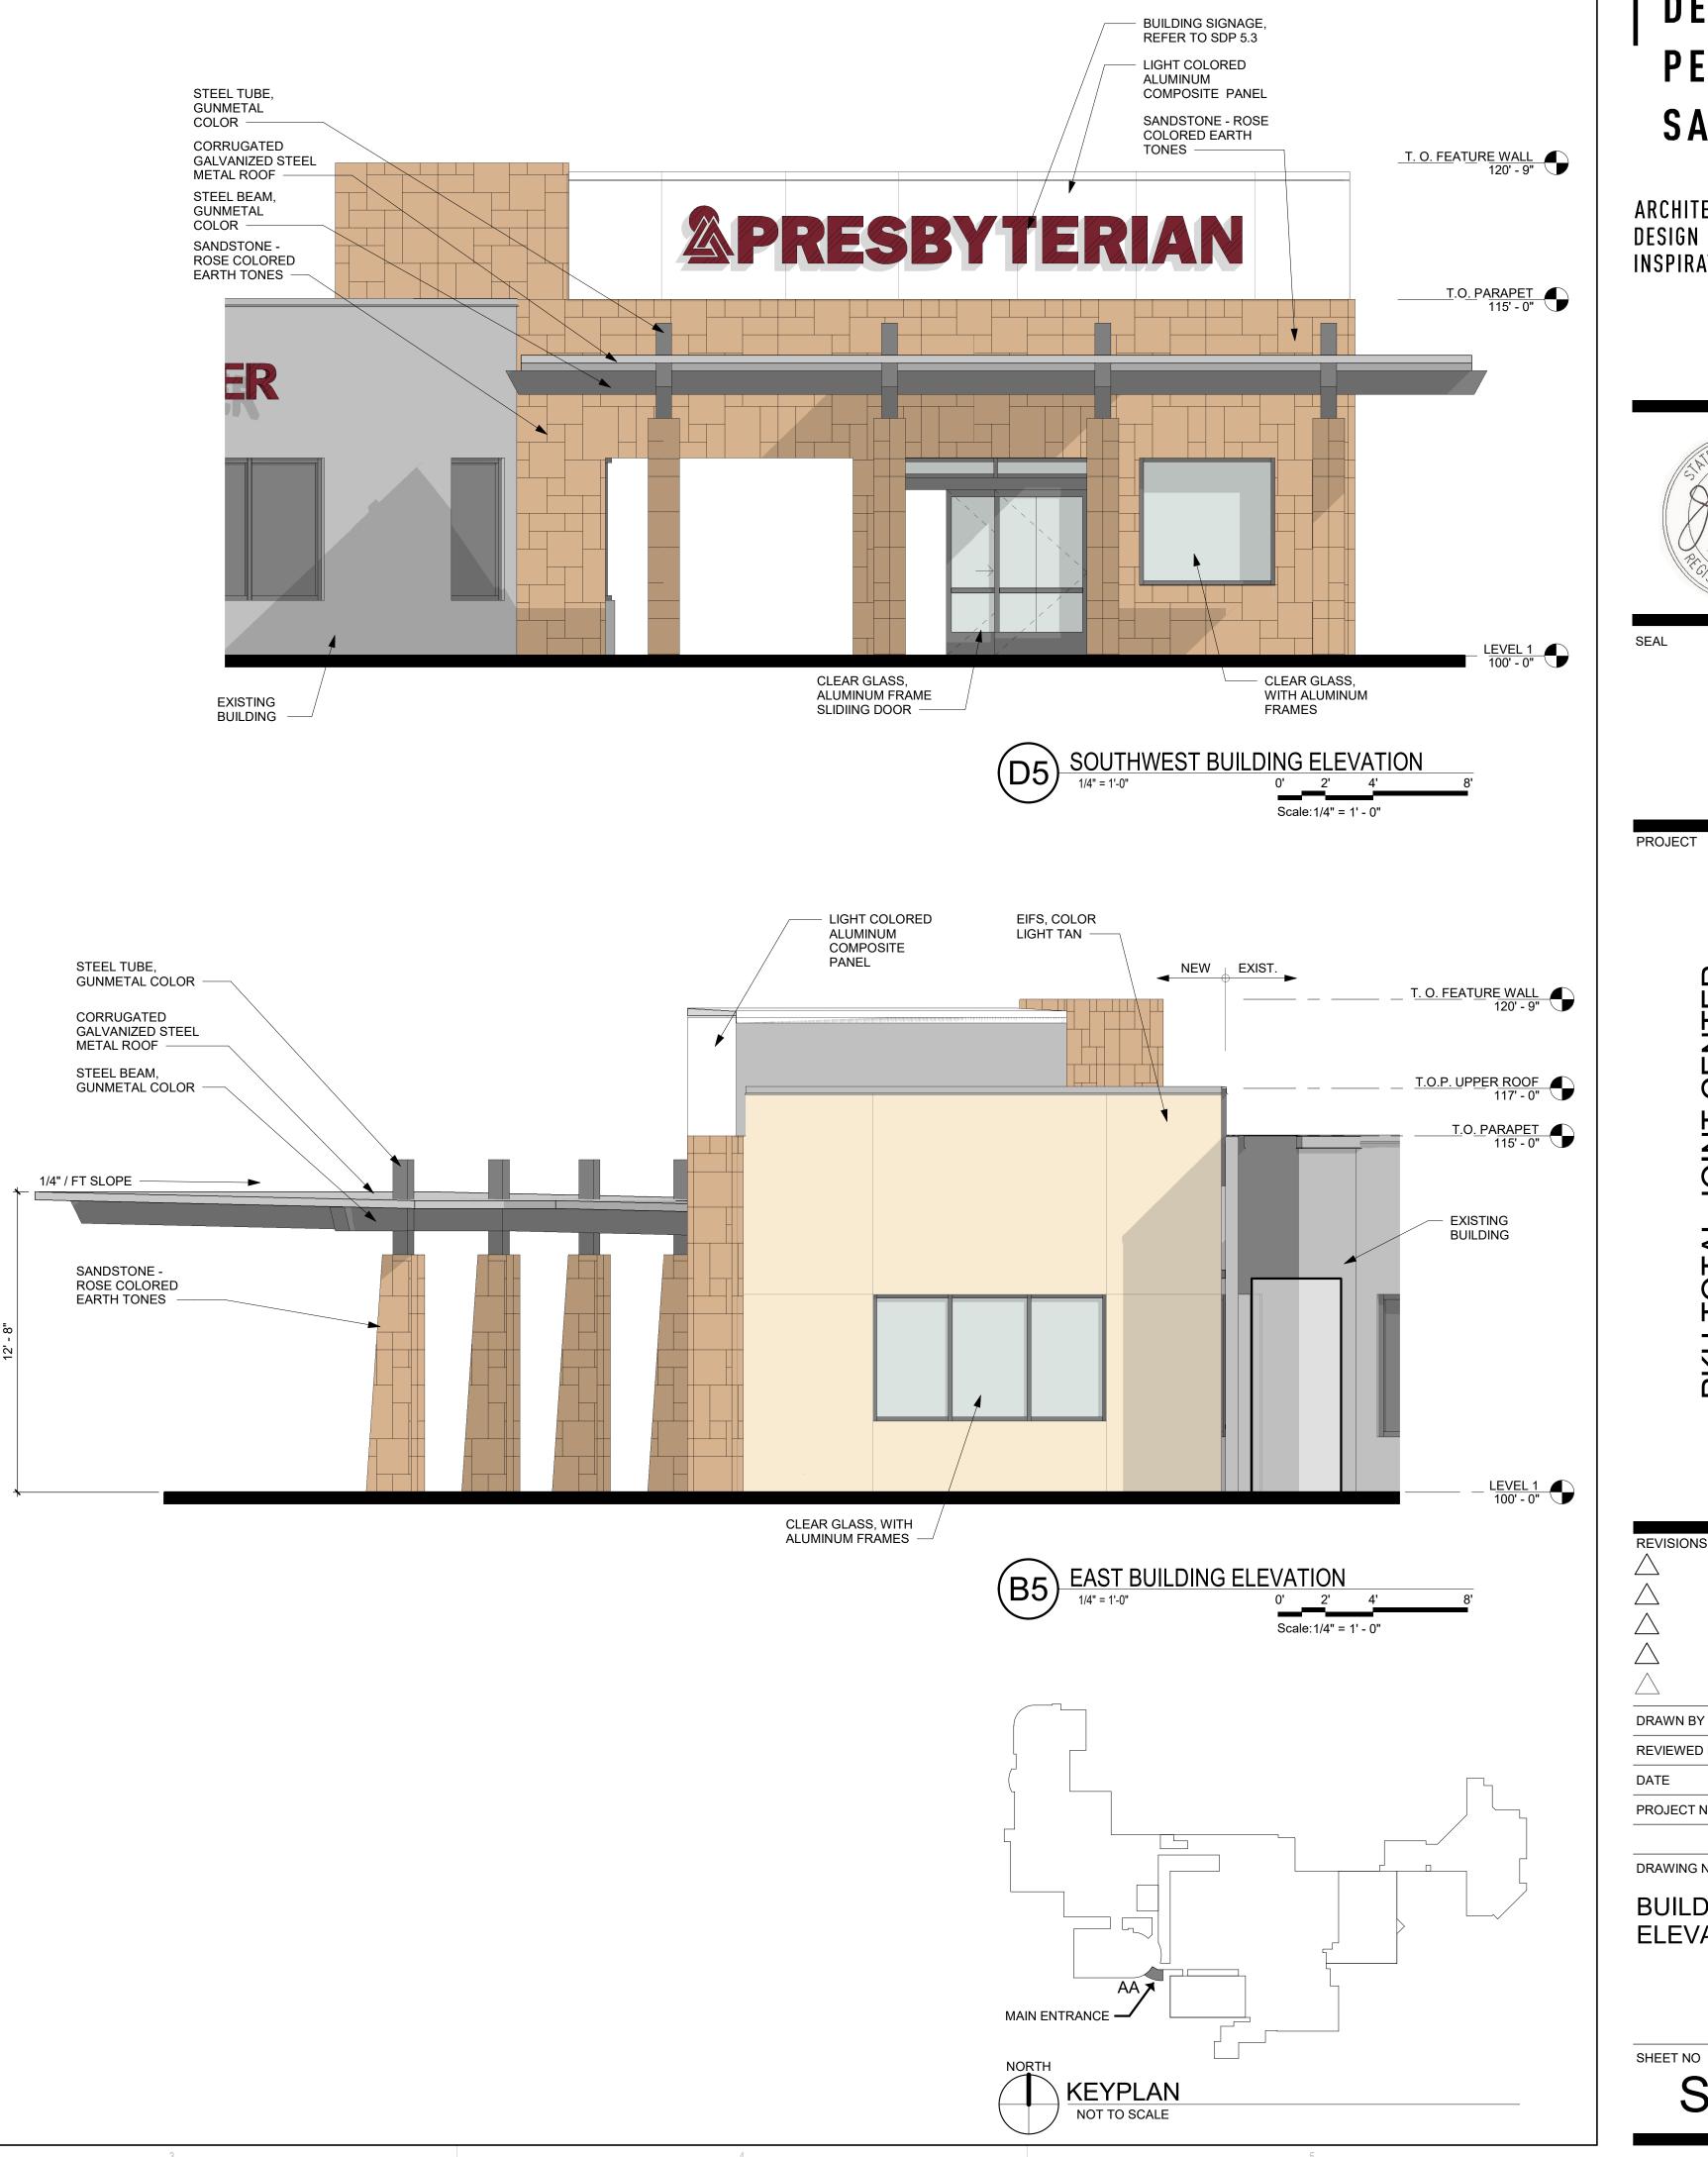
PKH TOTAL JOINT CENTER
EVELOPMENT PLAN FOR BUILDING P
8300 CONSTITUTION AVE. NE
ALBUQUERQUE, NM 87110

REVISIONS

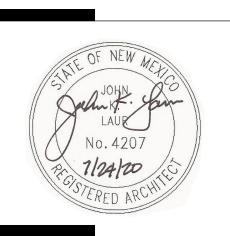
DRAWN BY REVIEWED BY 7/24/2020 DATE PROJECT NO. 19-0007.001 DRAWING NAME

SITE DETAILS

SHEET NO. AS501



ARCHITECTURE DESIGN INSPIRATION



CENTER BUILDING PE AVE. NE 1 87110

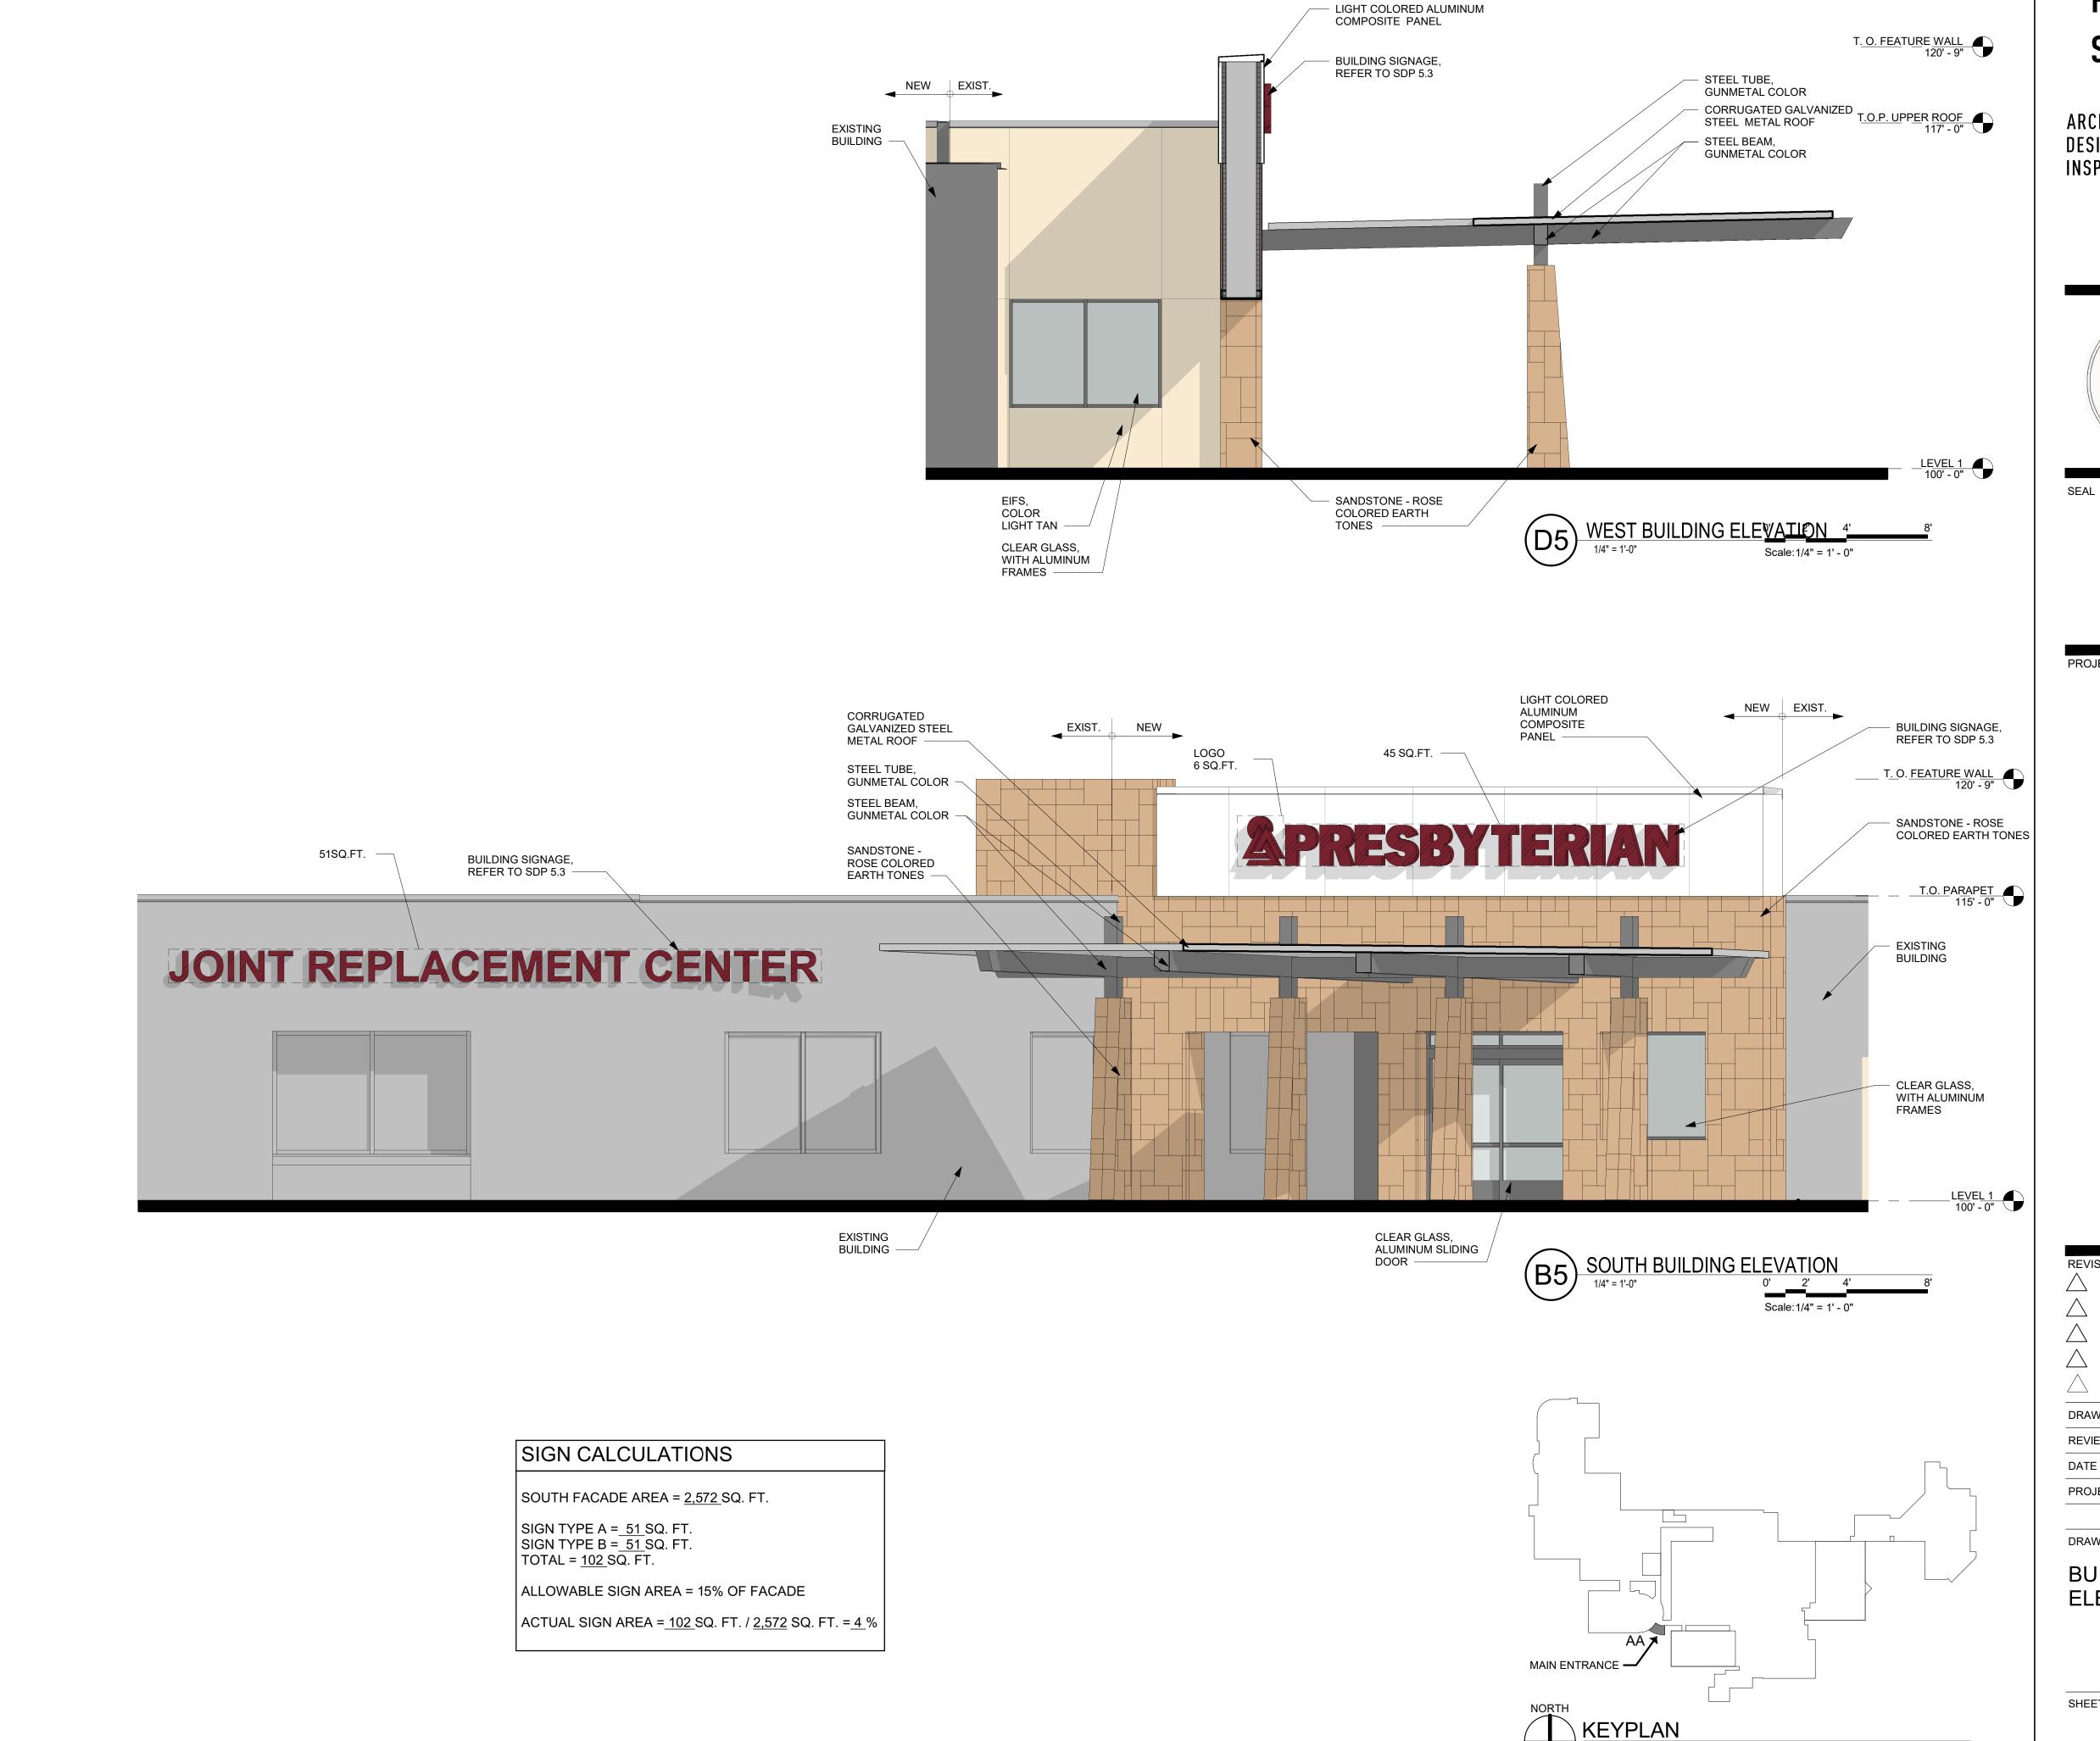
DRAWN BY **REVIEWED BY**

T. SANCHEZ J. MEDRANO DATE 7/24/2020 PROJECT NO: 19-0007.001

DRAWING NAME


BUILDING **ELEVATIONS**

SHEET NO SDP-5.1



PERICH SABATINI

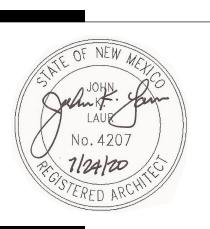ARCHITECTURE INSPIRATION



CENTER BUILDING PI AVE. NE PKH TOTAL JOINT C

E DEVELOPMENT PLAN FOR BI

8300 CONSTITUTION AN
ALBUQUERQUE, NM 8

REVISIONS

DRAWN BY	T. SANCHEZ		
REVIEWED BY	J. MEDRANO		
DATE	7/24/2020		
PROJECT NO:	19-0007.001		

DRAWING NAME

BUILDING **ELEVATIONS**

SHEET NO SDP-5.2

NOT TO SCALE



ARCHITECTURE DESIGN INSPIRATION



SEAL

PROJECT

PKH TOTAL JOINT CENTER

E DEVELOPMENT PLAN FOR BUILDING PERMI8300 CONSTITUTION AVE. NE
ALBUQUERQUE, NM 87110

DRAWN BY
T. SANCHEZ
REVIEWED BY
J. MEDRANO

 REVIEWED BY
 J. MEDRANO


 DATE
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 PROJECT NO:
 19-0007.001

DRAWING NAME

SIGN ELEVATIONS

SHEET NO SDP-5.3

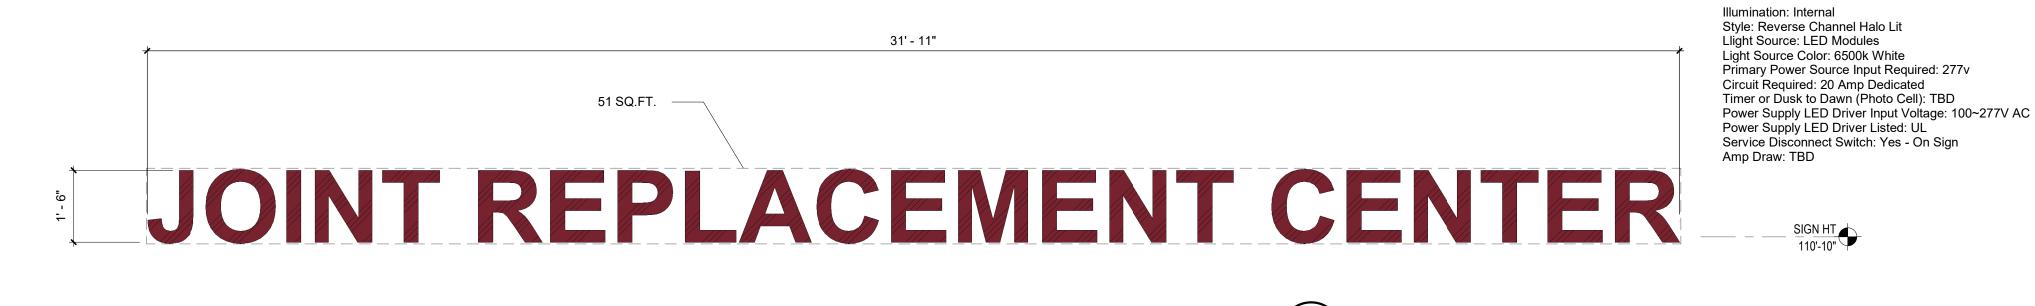

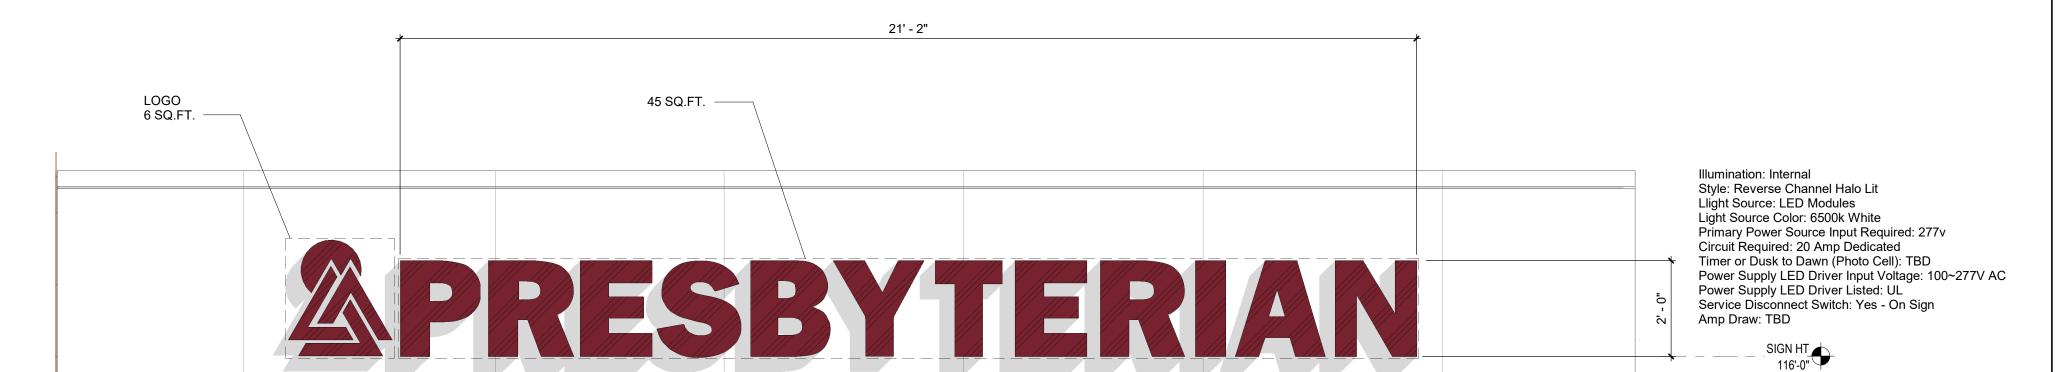


Table 5-12-2: On-premises Signs in Mixed-use and Non-residential Zone Districts

Zone District

Mixed-use Zone Districts,
NR-BP, NR-SU, NR-SU, NR-Sign Type
NR-C, NR-LM, NR-GM

Number, maximum
N/A
Size, maximum
Size, maximum
Shall not exceed the following percentages of façade area,
inclusive of door and window openings.
MX-T, MX-FB-ID: 5%
MX-L: 10%
MX-H, MX-FB-FX, MX-FB-AC, MX-FB-UD, NR-C: 15%
NR-LM, NR-GM: 25%

Location
Where there is no side setback between 2 establishment
frontages in the same or abutting buildings, no wall sign may

BUILDING MOUNTED SIGN - TYPE A

1/2" = 1'-0"

Scale: 1/2" = 1' - 0"