

# PR-2020-004098\_Site\_Plan\_Signature Sheet

Final Audit Report 2025-08-12

Created: 2025-07-23

By: Jacob Boylan (jboylan@cabq.gov)

Status: Signed

Transaction ID: CBJCHBCAABAAPqvgbmKtAE2R0mX24G3kfhFd6zeHnq\_e

# "PR-2020-004098\_Site\_Plan\_Signature Sheet" History


- Document created by Jacob Boylan (jboylan@cabq.gov) 2025-07-23 5:38:05 PM GMT
- Document emailed to Tiequan Chen (tchen@cabq.gov) for signature 2025-07-23 5:38:11 PM GMT
- Document emailed to Ernest Armijo (earmijo@cabq.gov) for signature
- Document emailed to David Gutierrez (dggutierrez@abcwua.org) for signature 2025-07-23 5:38:12 PM GMT
- Document emailed to Whitney Phelan (wphelan@cabq.gov) for signature 2025-07-23 5:38:12 PM GMT
- Document emailed to Jeff Palmer (jppalmer@cabq.gov) for signature 2025-07-23 5:38:12 PM GMT
- Document emailed to Jay Rodenbeck (jrodenbeck@cabq.gov) for signature 2025-07-23 5:38:12 PM GMT
- Email viewed by Emest Armijo (earmijo@cabq.gov)
- Document e-signed by Ernest Armijo (earmijo@cabq.gov)
  Signature Date: 2025-07-23 5:44:02 PM GMT Time Source: server
- Email viewed by Tiequan Chen (tchen@cabq.gov)
  2025-07-23 5:51:02 PM GMT
- Document e-signed by Tiequan Chen (tchen@cabq.gov)
  Signature Date: 2025-07-23 5:52:48 PM GMT Time Source: server


- Email viewed by Whitney Phelan (wphelan@cabq.gov) 2025-07-23 - 6:41:08 PM GMT
- Document e-signed by Whitney Phelan (wphelan@cabq.gov)
  Signature Date: 2025-07-23 6:42:02 PM GMT Time Source: server
- Email viewed by Jay Rodenbeck (jrodenbeck@cabq.gov) 2025-07-23 6:46:46 PM GMT
- Email viewed by Jeff Palmer (jppalmer@cabq.gov) 2025-07-23 7:42:59 PM GMT
- Email viewed by David Gutierrez (dggutierrez@abcwua.org) 2025-07-23 7:57:05 PM GMT
- Document e-signed by Jeff Palmer (jppalmer@cabq.gov)
  Signature Date: 2025-07-24 11:06:32 PM GMT Time Source: server
- Email viewed by David Gutierrez (dggutierrez@abcwua.org)
  2025-07-25 5:48:45 PM GMT
- Email viewed by Jay Rodenbeck (jrodenbeck@cabq.gov) 2025-07-25 - 5:49:37 PM GMT
- Email viewed by Jay Rodenbeck (jrodenbeck@cabq.gov) 2025-07-27 5:44:08 PM GMT
- Email viewed by David Gutierrez (dggutierrez@abcwua.org)
  2025-07-27 5:44:11 PM GMT
- Email viewed by Jay Rodenbeck (jrodenbeck@cabq.gov) 2025-07-29 10:23:39 PM GMT
- Email viewed by David Gutierrez (dggutierrez@abcwua.org)
  2025-07-29 10:23:58 PM GMT
- Email viewed by David Gutierrez (dggutierrez@abcwua.org)
  2025-07-31 10:00:27 PM GMT
- Email viewed by Jay Rodenbeck (jrodenbeck@cabq.gov) 2025-08-02 - 5:43:53 PM GMT
- Email viewed by David Gutierrez (dggutierrez@abcwua.org)
  2025-08-02 5:44:36 PM GMT
- Email viewed by David Gutierrez (dggutierrez@abcwua.org) 2025-08-04 9:14:25 PM GMT




- Email viewed by Jay Rodenbeck (jrodenbeck@cabq.gov) 2025-08-04 9:27:45 PM GMT
- Email viewed by David Gutierrez (dggutierrez@abcwua.org)
  2025-08-06 10:09:11 PM GMT
- Email viewed by Jay Rodenbeck (jrodenbeck@cabq.gov) 2025-08-06 10:26:13 PM GMT
- Email viewed by Jay Rodenbeck (jrodenbeck@cabq.gov) 2025-08-08 - 5:45:29 PM GMT
- Email viewed by David Gutierrez (dggutierrez@abcwua.org)
  2025-08-08 5:48:21 PM GMT
- Document e-signed by David Gutierrez (dggutierrez@abcwua.org)

  Signature Date: 2025-08-08 7:49:30 PM GMT Time Source: server
- Email viewed by Jay Rodenbeck (jrodenbeck@cabq.gov) 2025-08-10 - 5:44:15 PM GMT
- Email viewed by Jay Rodenbeck (jrodenbeck@cabq.gov) 2025-08-12 - 8:46:32 PM GMT
- Document e-signed by Jay Rodenbeck (jrodenbeck@cabq.gov)
  Signature Date: 2025-08-12 10:06:44 PM GMT Time Source: server
- Agreement completed. 2025-08-12 - 10:06:44 PM GMT

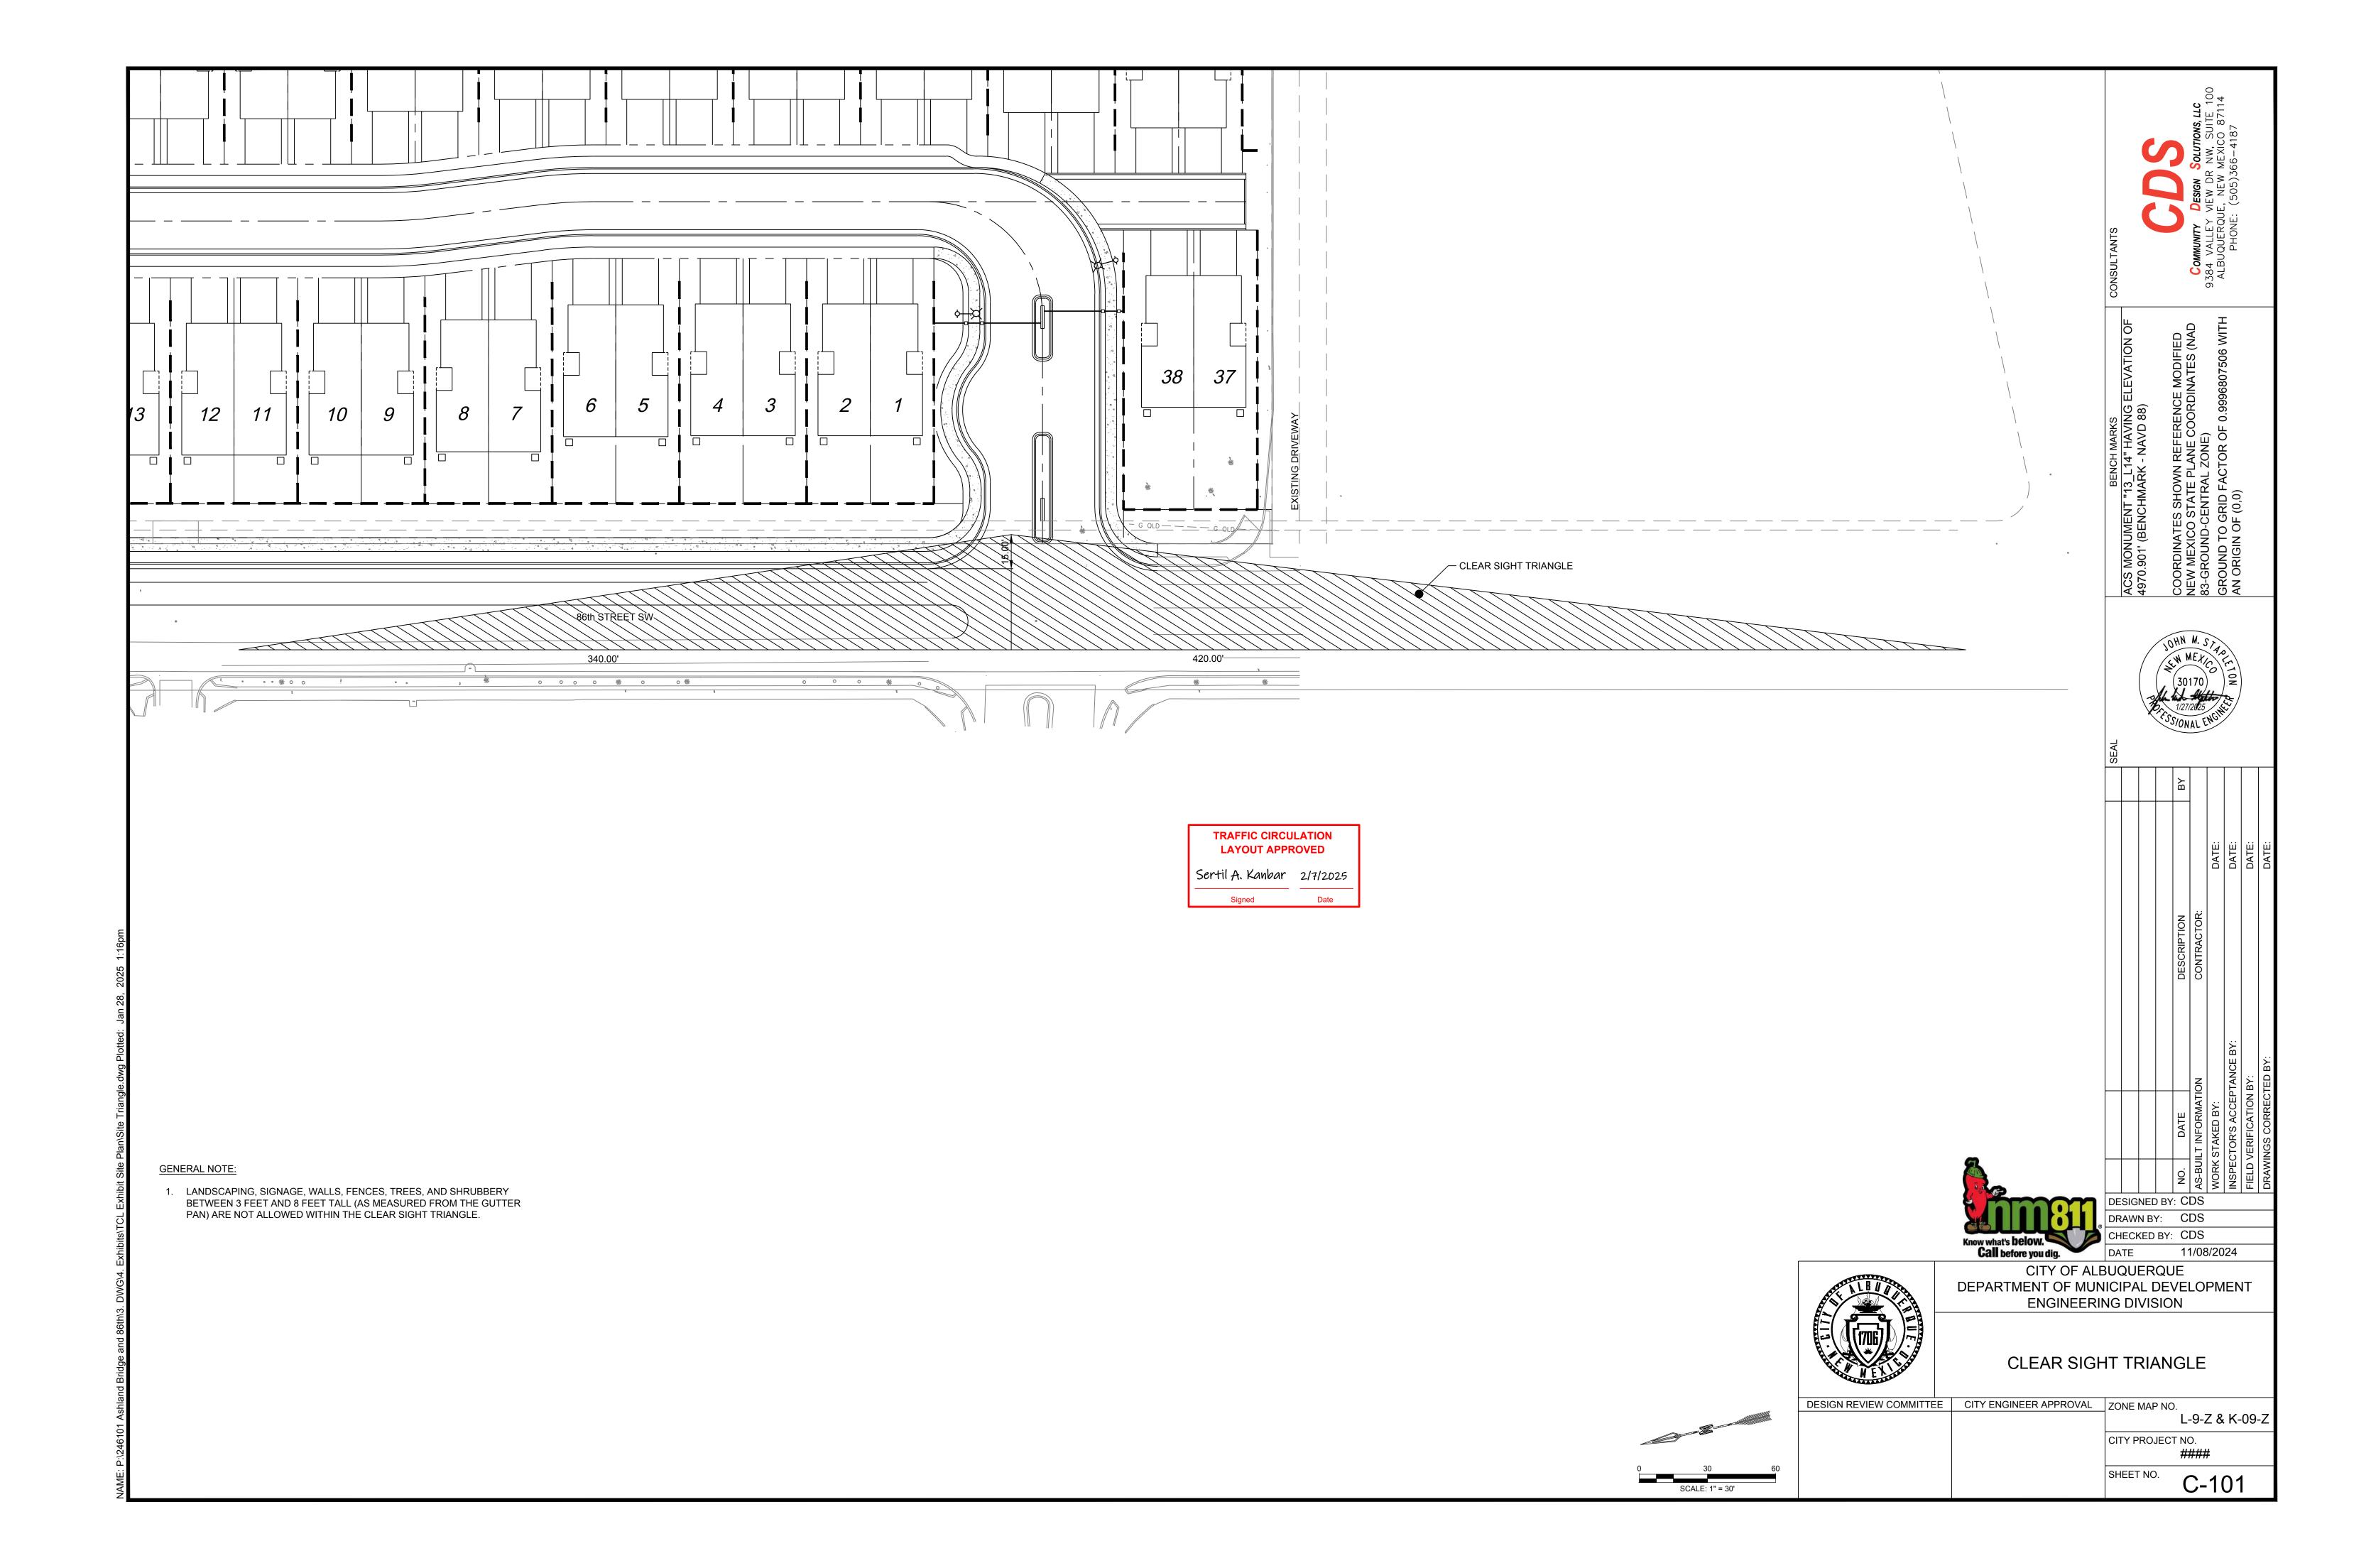

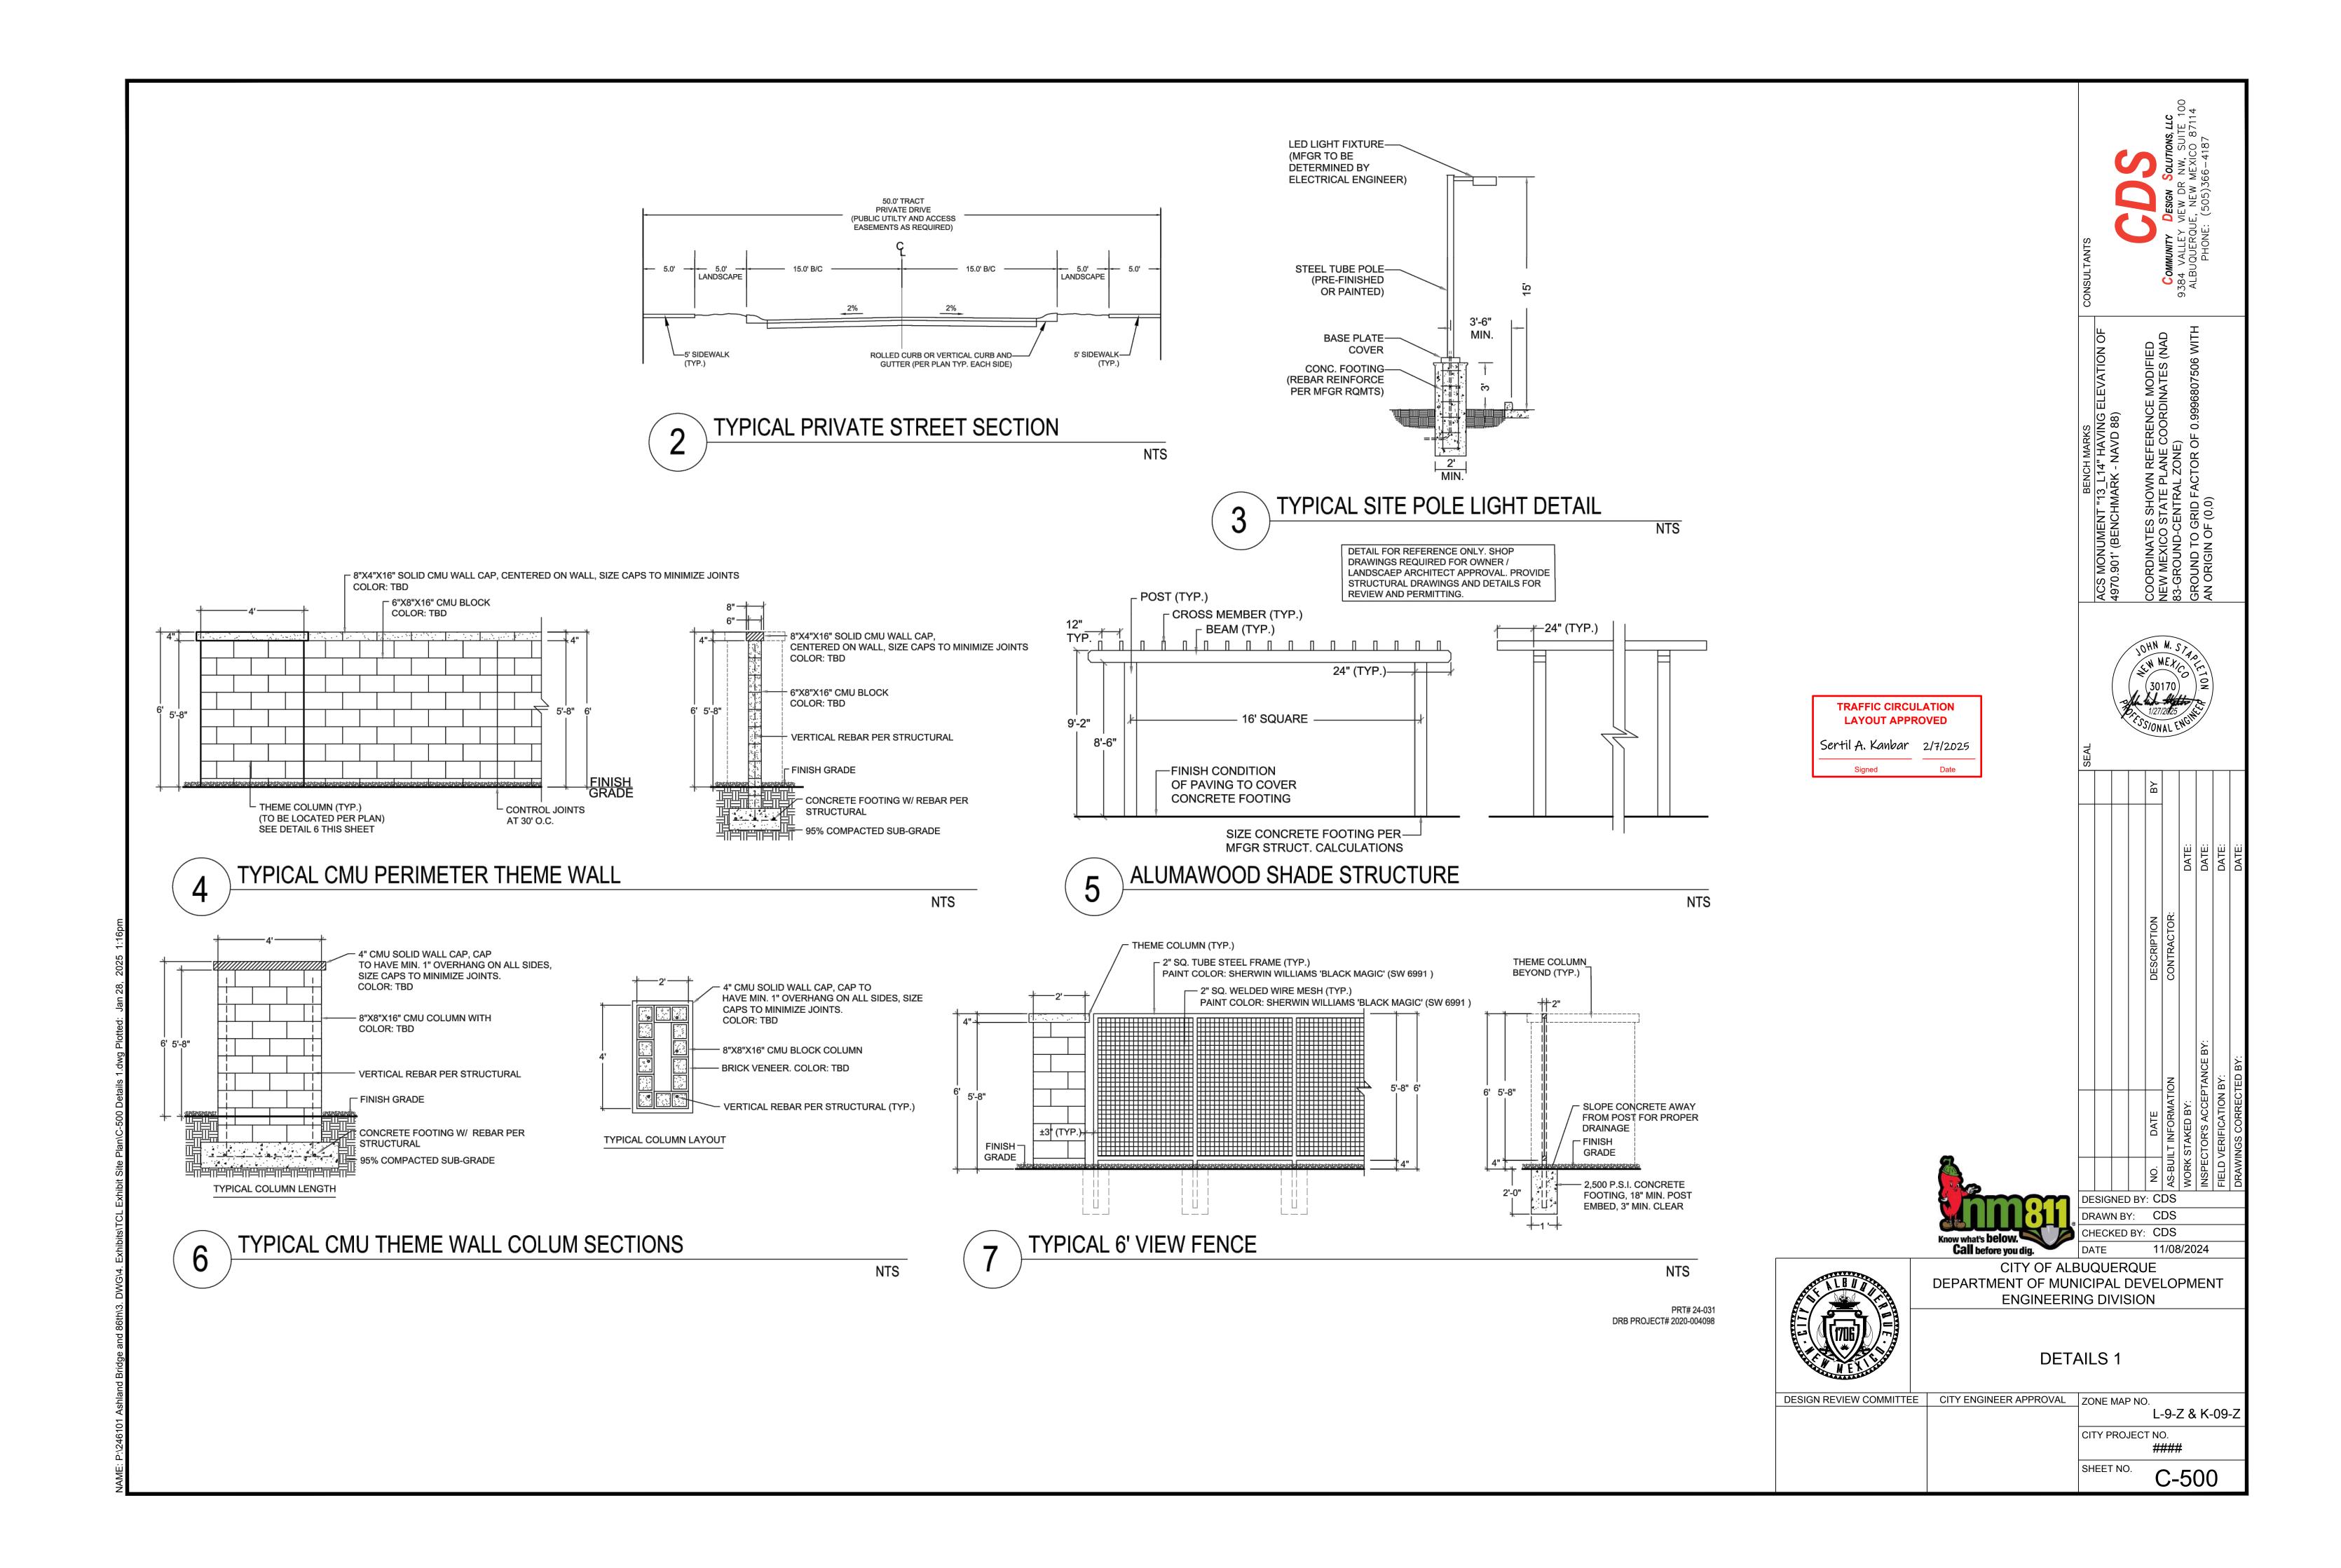

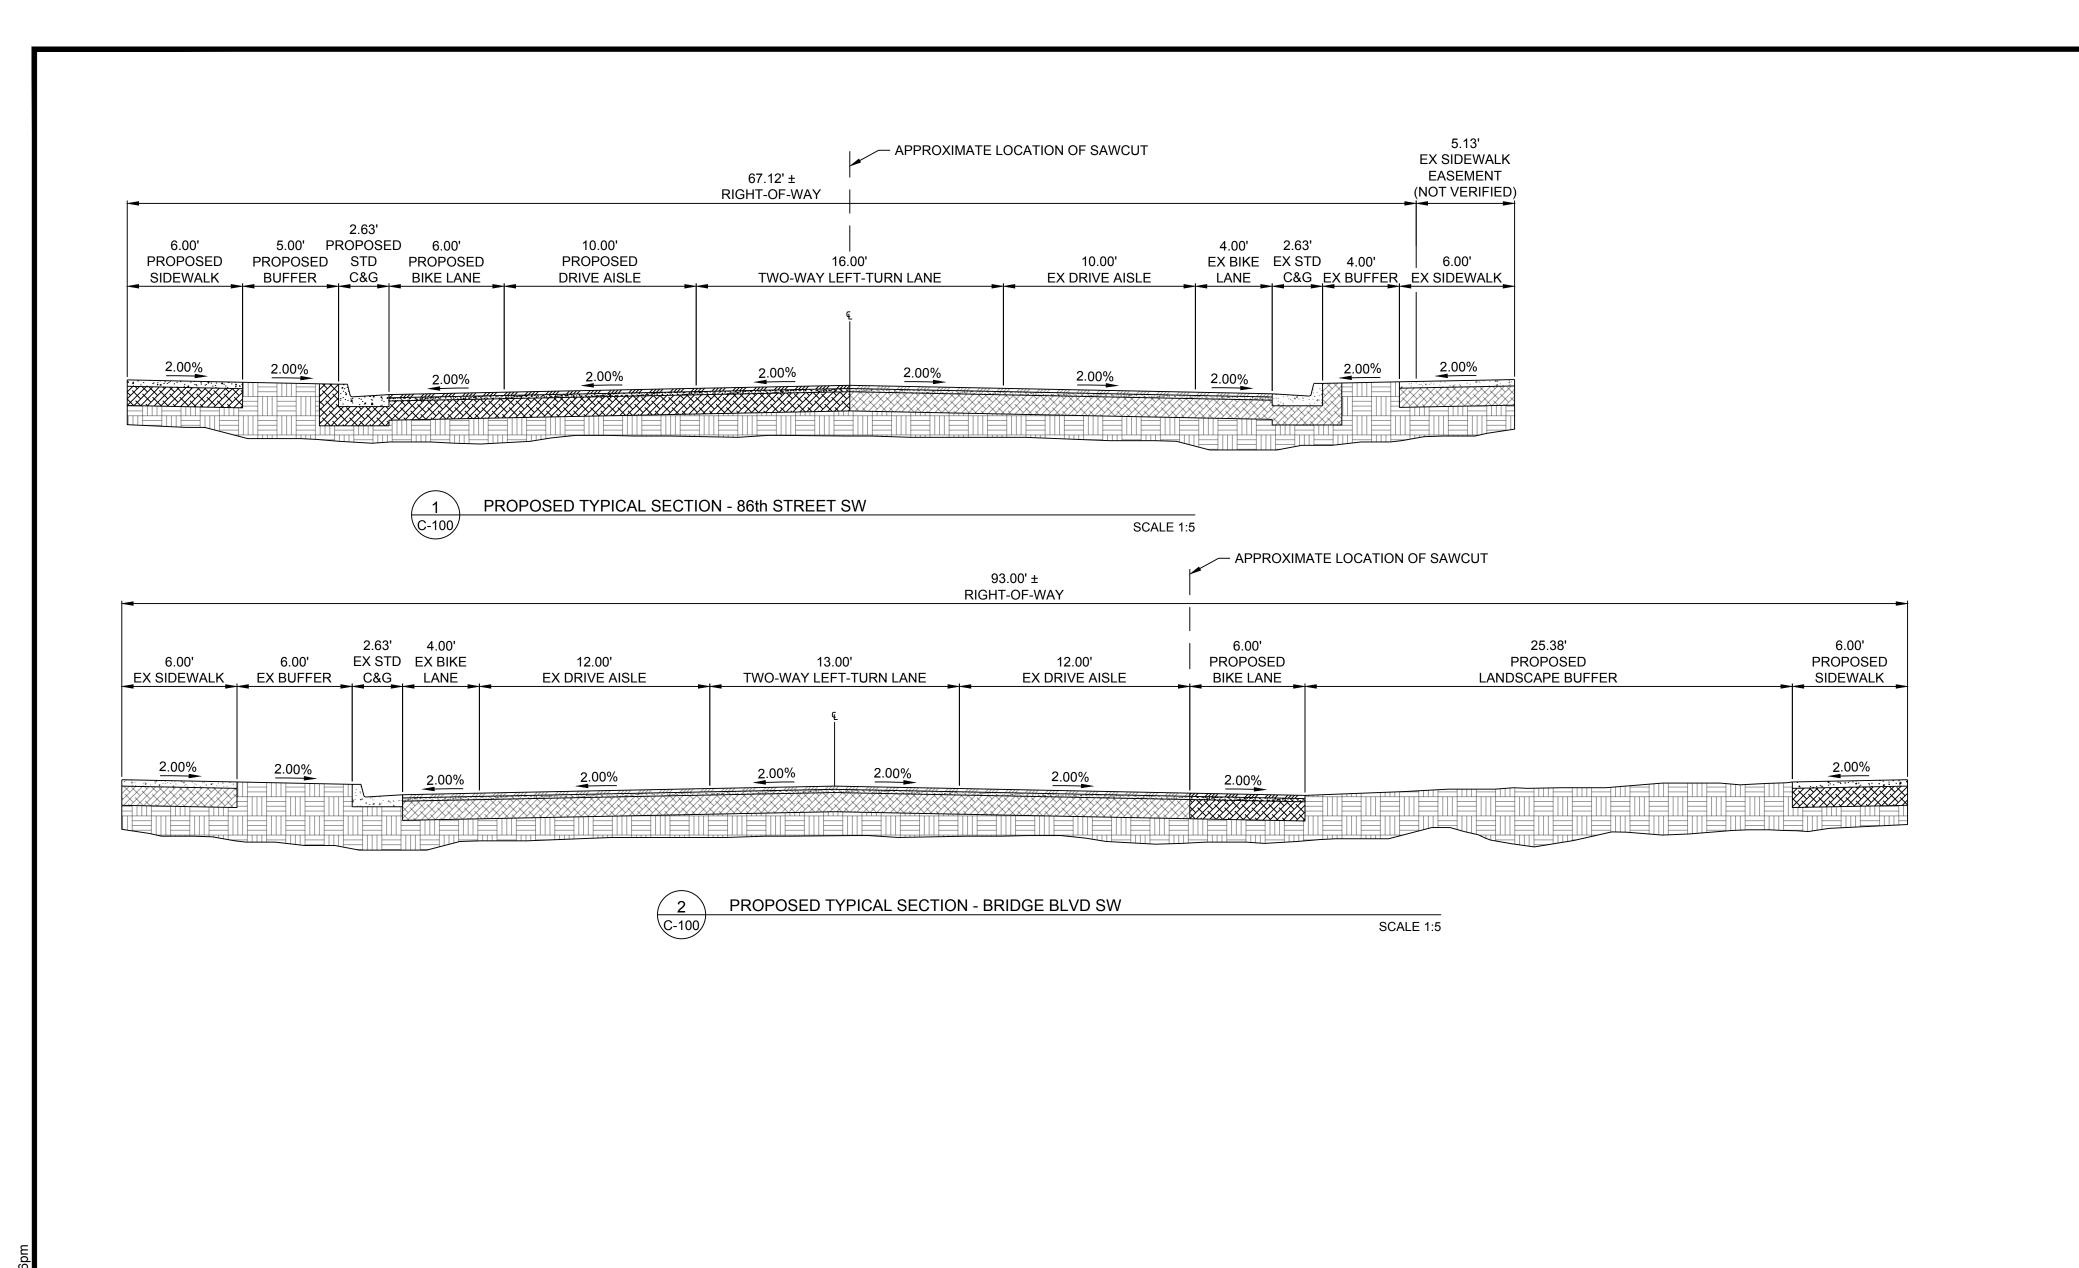

TRAFFIC CIRCULATION
LAYOUT APPROVED

Sertil A. Kanbar 2/7/2025

BENCH MARKS

ACS MONUMENT "13\_L14" HAVING ELEVATION OF
4970.901' (BENCHMARK - NAVD 88)

COORDINATES SHOWN REFERENCE MODIFIED
NEW MEXICO STATE PLANE COORDINATES (NAD
83-GROUND-CENTRAL ZONE)
GROUND TO GRID FACTOR OF 0.9996807506 WITI

30170 25 1/27/2025 1/27/2025

AS-BUILT INFORMATION

CONTRACTOR:

WORK STAKED BY:


INSPECTOR'S ACCEPTANCE BY:

DESCRIPTION

CONTRACTOR:

DATE:

D

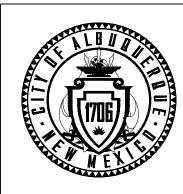

Call before you dig.

DATE 11/08/2024

CITY OF ALBUQUERQUE

DEPARTMENT OF MUNICIPAL DEVELOPMENT

ENGINEERING DIVISION

**DETAILS 2** 

DESIGN REVIEW COMMITTEE


CITY ENGINEER APPROVAL


L-9-Z & K-09-Z

CITY PROJECT NO.

#####

T NO. C-501

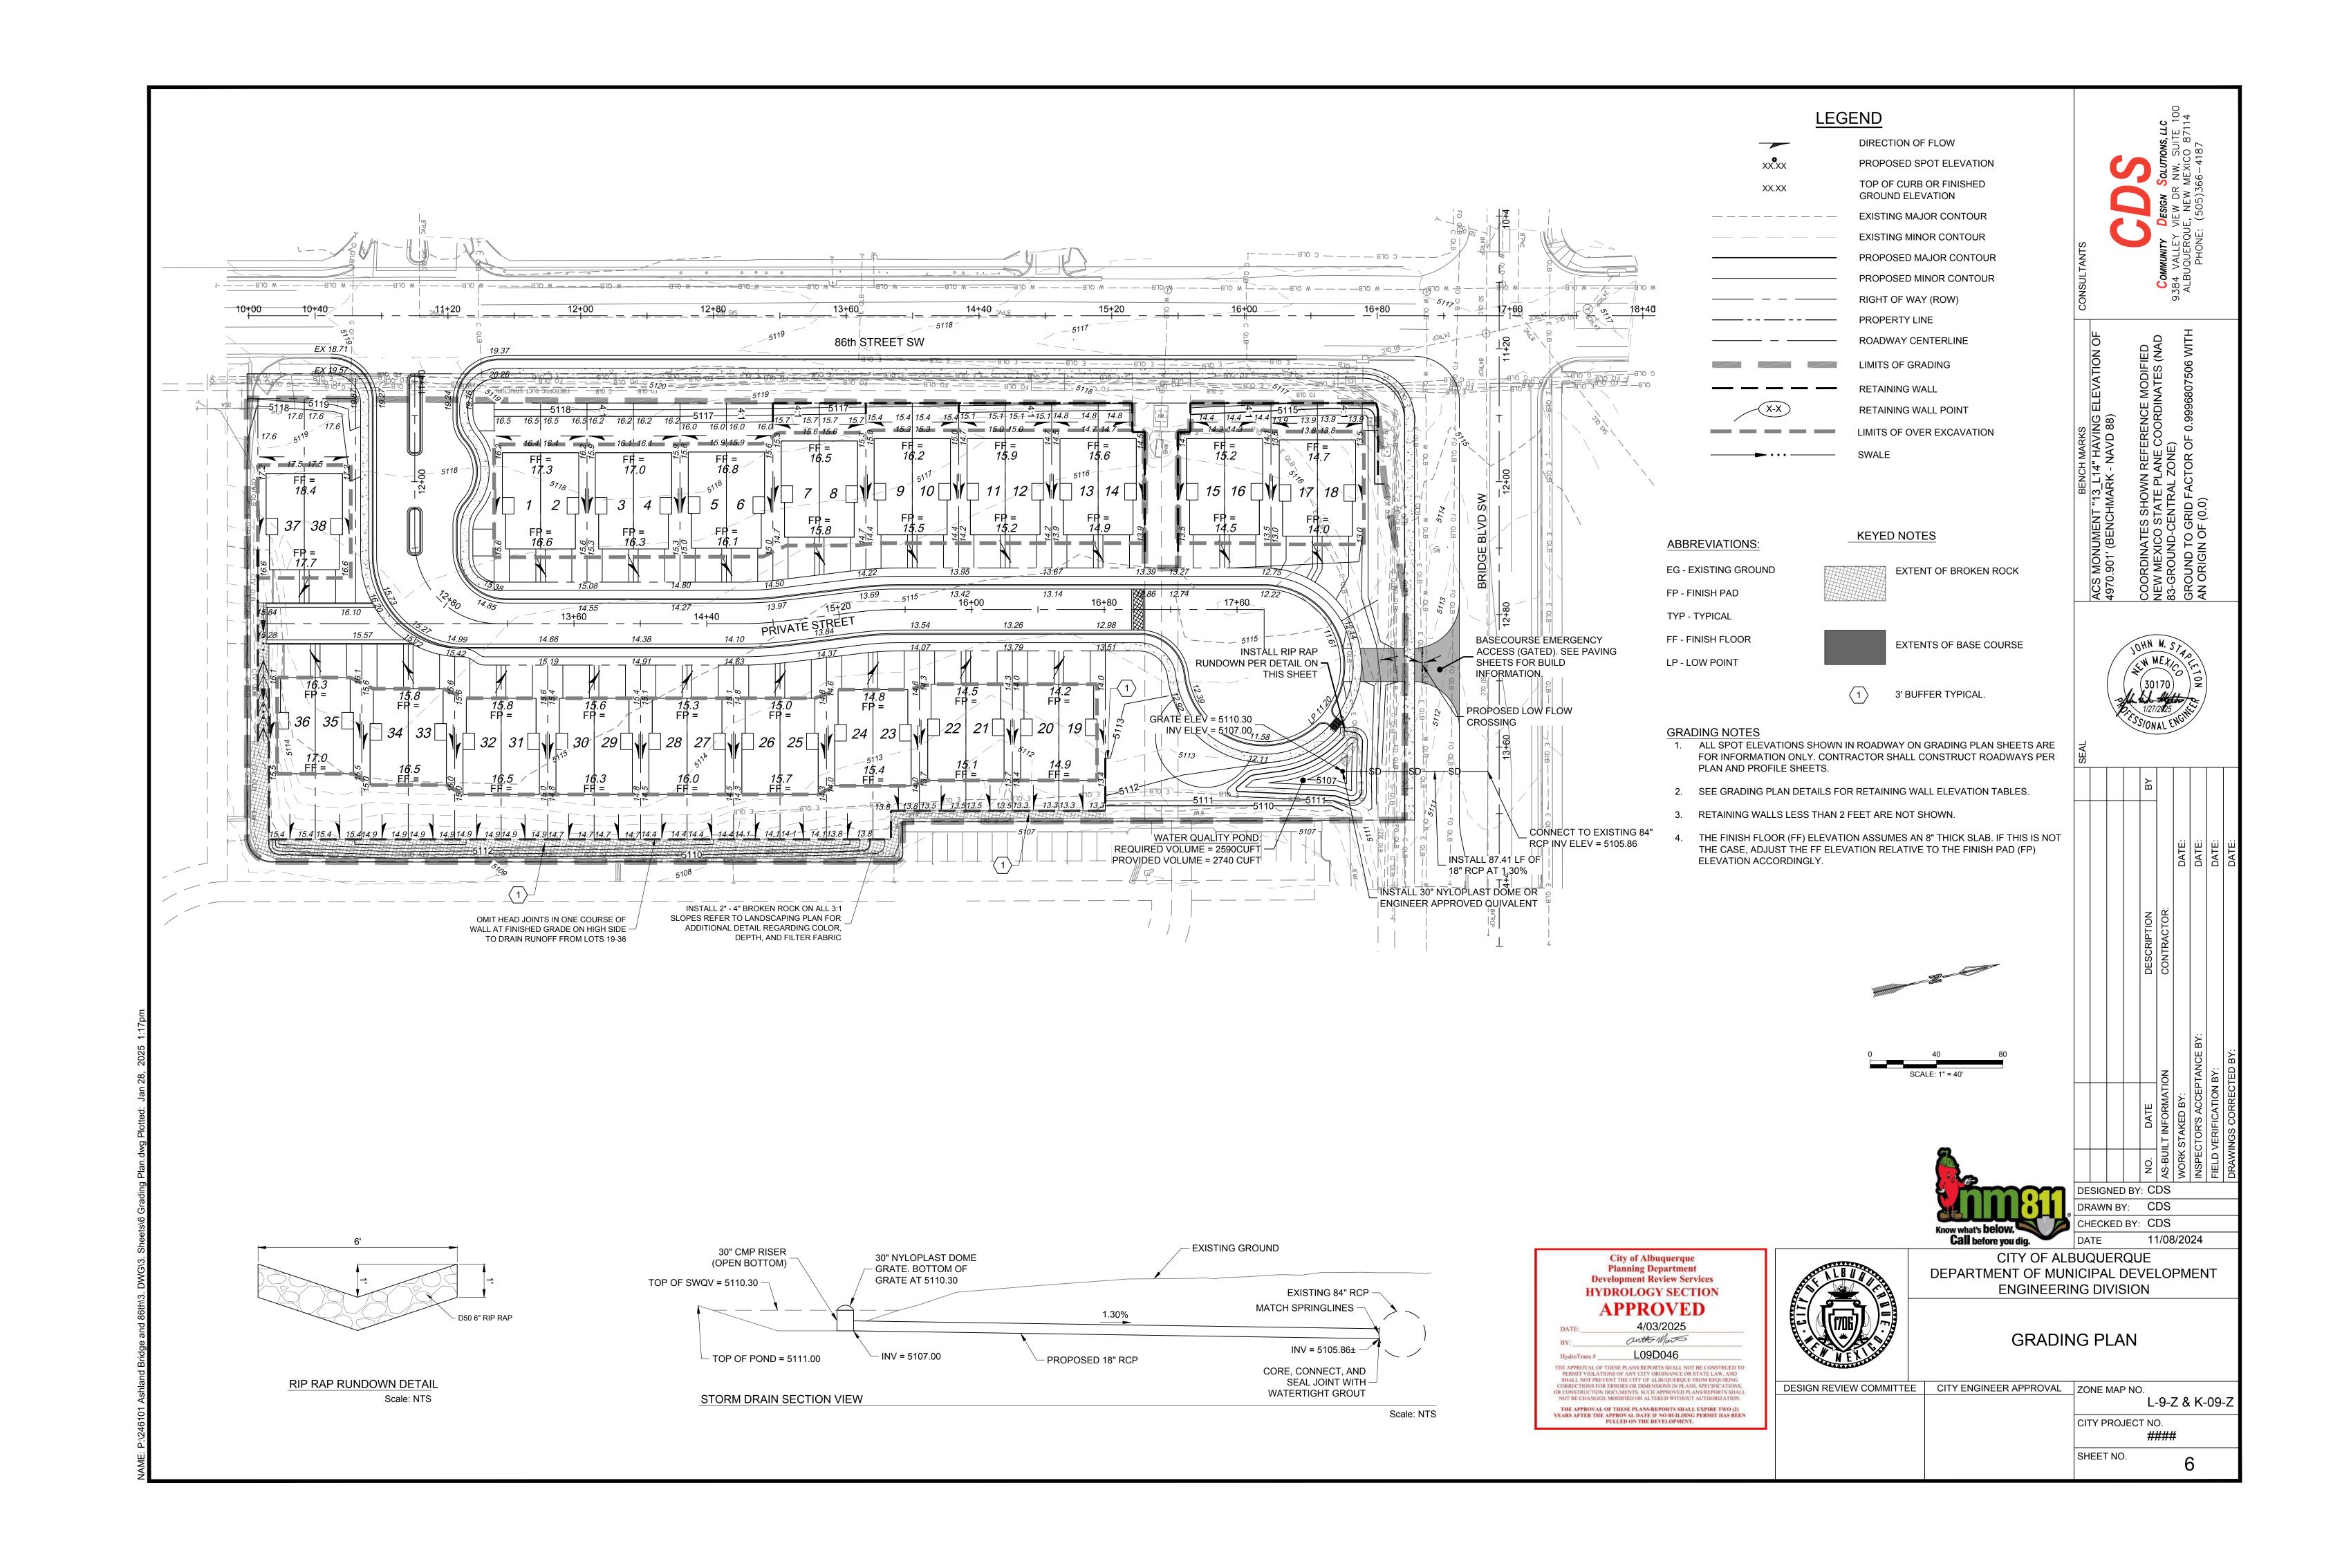

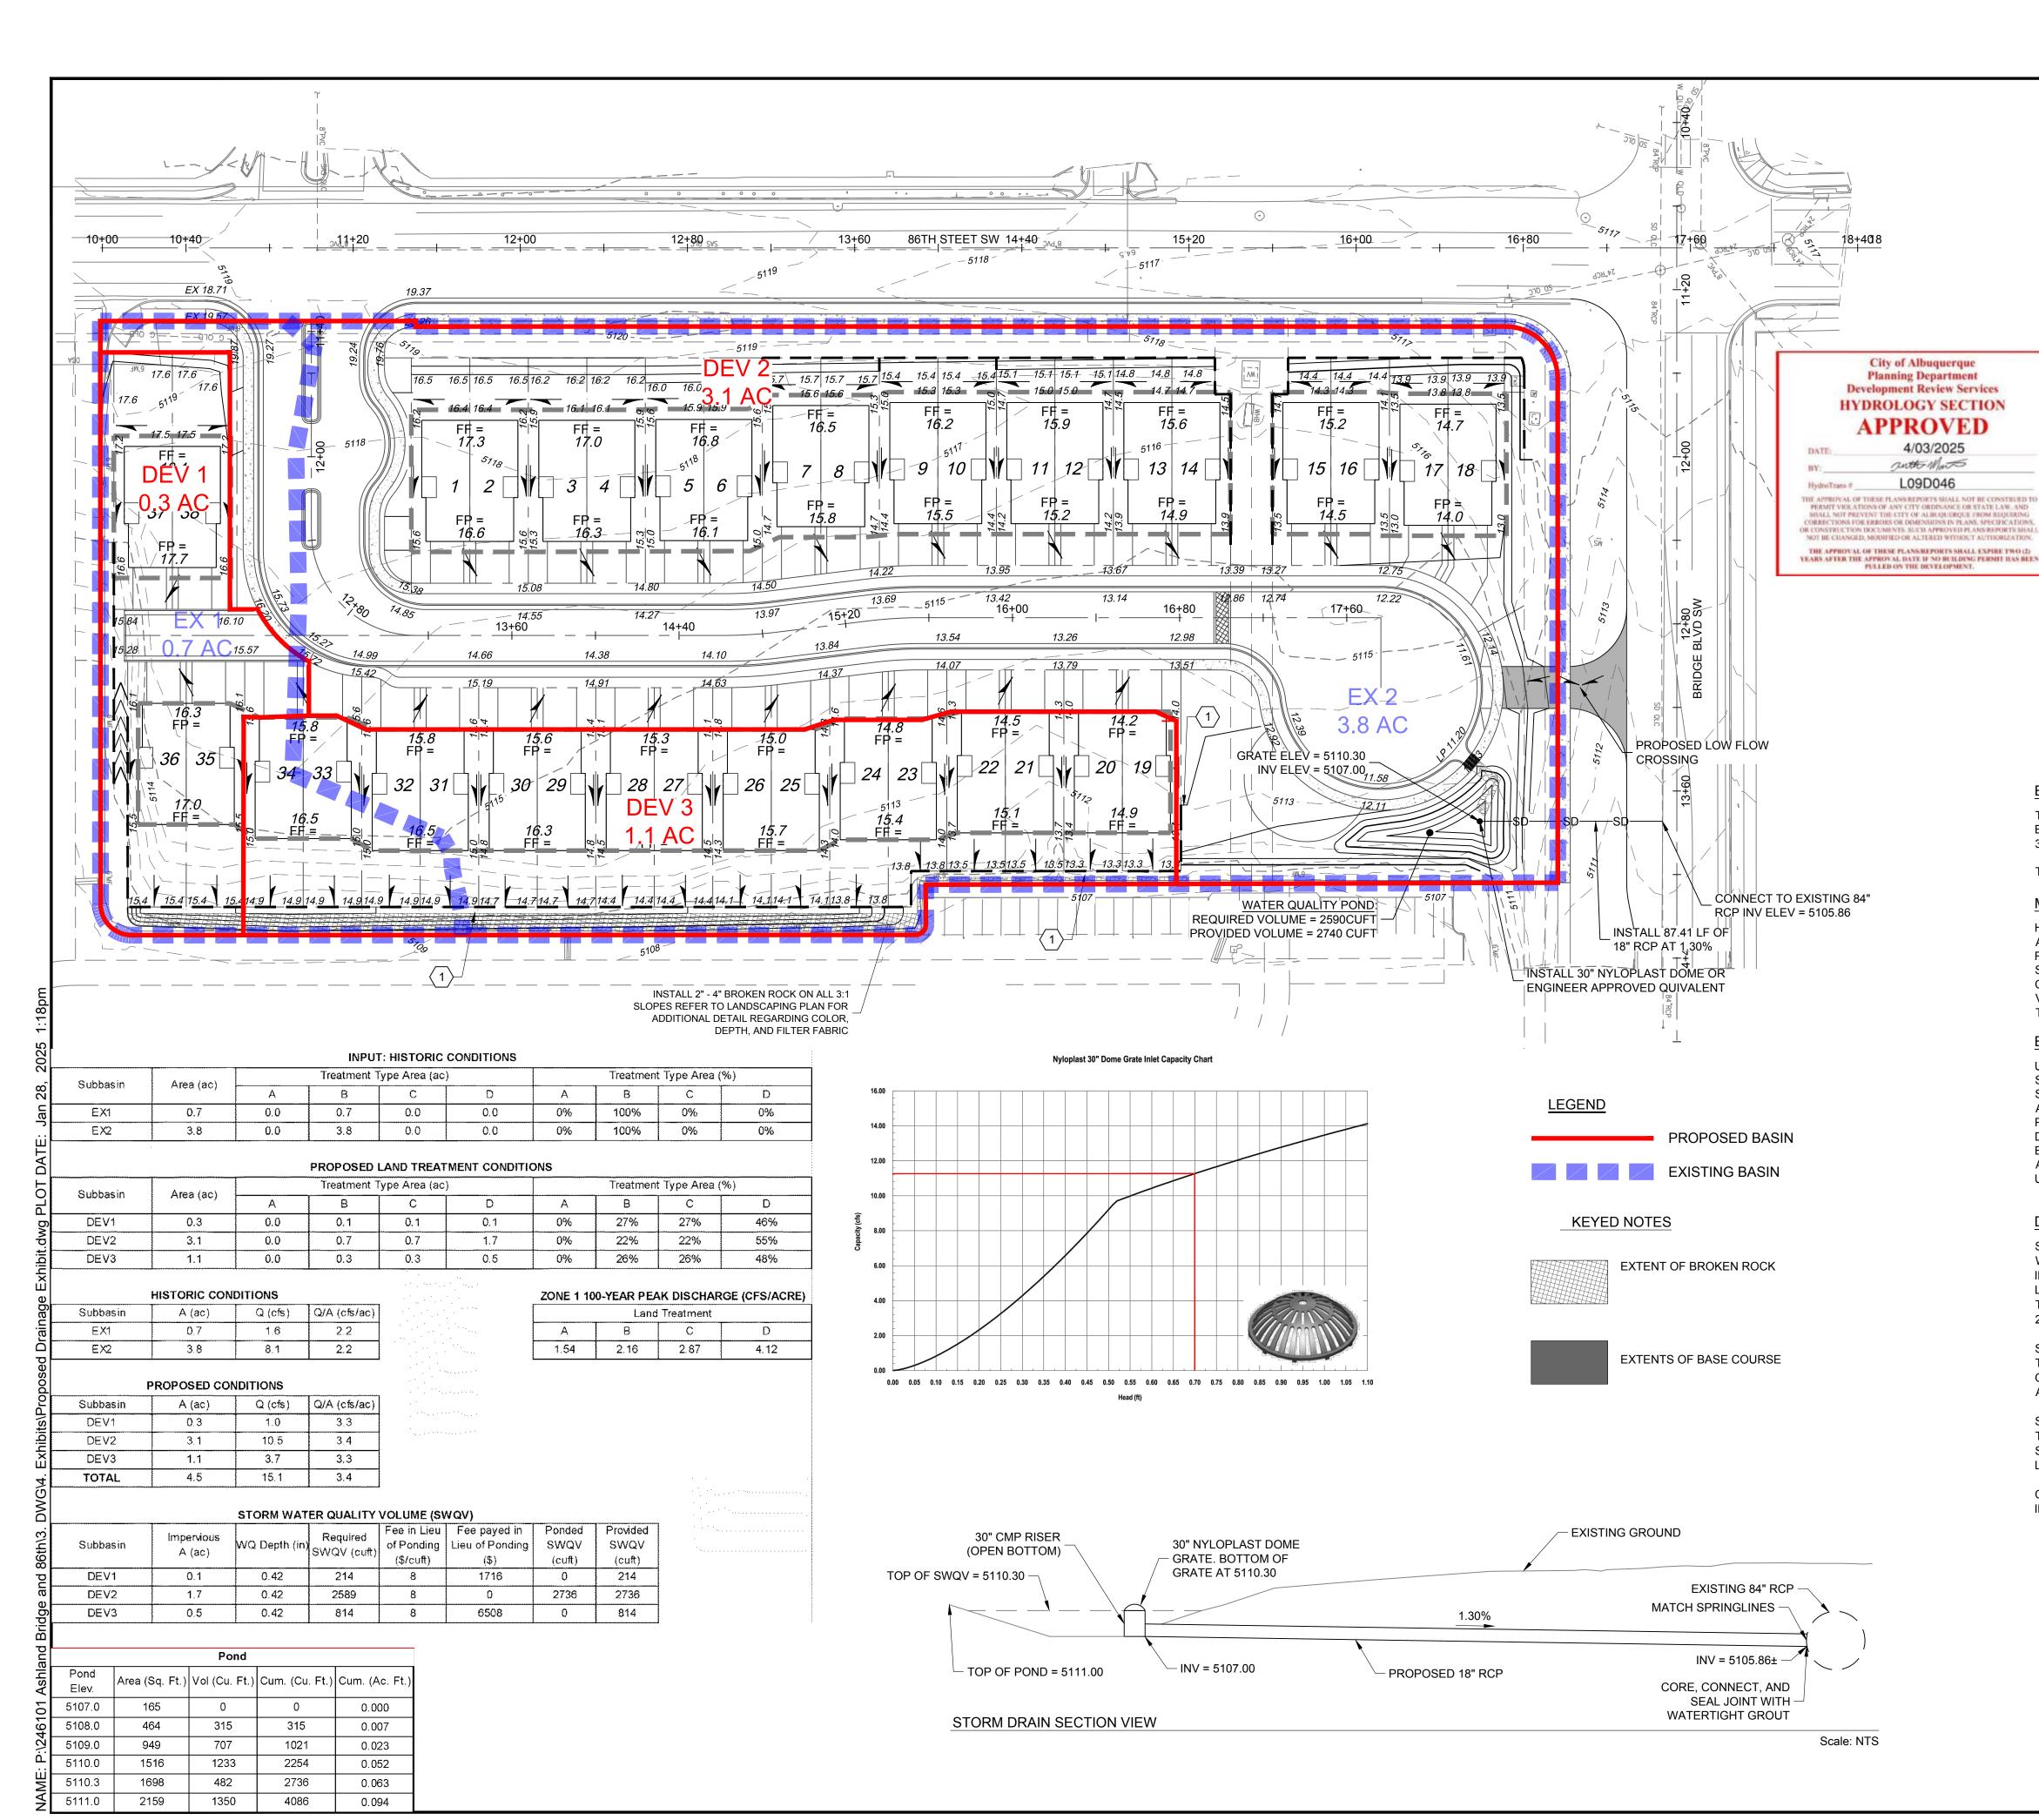

# PROPOSED & EXISTING DRAINAGE EXHIBIT

January 28, 2025



# MAP NUMBER 35001C0328J

### BACKGROUND

THE DEVELOPMENT IS LOCATED AT THE SOUTHEAST CORNER OF 86TH STREET SW AND BRIDGE BOULEVARD SW AND CONTAINS 4.5 ACRES. THE SITE WILL BE SUBDIVIDED INTO 38 LOTS

THE SITE IS GOVERNED BY THE 2013 AMOLE-HUBBELL DRAINAGE MASTER PLAN.

#### **METHODOLOGY**

HYDROLOGY CALCULATIONS FOR THE SITE ARE PERFORMED IN ACCORDANCE WITH THE ALBUQUERQUE DEVELOPMENT PROCESS MANUAL (DPM) ARTICLE 6.2 USING THE RATIONAL METHOD TO CALCULATE PEAK FLOW RATES TO ENSURE ALL FLOW PATHS ARE SUFFICIENT TO CARRY FLOWS. THE REQUIRED WATER QUALITY VOLUME WAS CALCULATED BY MULTIPLYING THE IMPERVIOUS AREA BY THE FIRST FLUSH RUNOFF VALUE OF 0.42". ALL HYDROLOGIC AND HYDRAULIC CALCULATIONS CAN BE FOUND ON THIS SHEET.

## **EXISTING CONDITIONS**

UNDER THE EXISTING CONDITIONS, THE MAJORITY OF THE SITE (EX 2) SLOPES FROM SOUTHWEST TO NORTHEAST. A SMALL PORTION OF THE SITE (EX 1) SLOPES TO THE SOUTH. STORMWATER RUNOFF FROM THE SITE IS CONVEYED VIA SURFACE FLOW ACROSS THE LOT AND FREELY DISCHARGES INTO THE PARKING LOT OF THE ADJACENT PROPERTY TO THE EAST. RUNOFF FROM THE EXISTING BASINS EACH ARE DIRECTED TO DIFFERENT PONDS WITHIN THE ADJACENT PROPERTY. HOWEVER, THE RUNOFF FROM BOTH EXISTING SUBBASINS IS ULTIMATELY CONVEYED ALONG WITH RUNOFF FROM THE ADJACENT PROPERTY INTO THE DRAINAGE CHANNEL AT THE SOUTHEAST CORNER OF UNSER BLVD AND BRIDGE BLVD.


## **DEVELOPED CONDITIONS**

SUBBASIN DEV2 CONTAINS 3.1 ACRES AND DRAINS VIA ROADWAY GUTTER FLOW TO A WATER QUALITY RETENTION POND BY THE CUL-DE-SAC. THE POND DISCHARGES VOLUME IN EXCESS OF THE WATER QUALITY TREATMENT VOLUME INTO AN EXISTING 84" RCP LOCATED IN BRIDGE BOULEVARD AT A RATE OF 11.2 CFS (3.61 CFS/AC) WHICH IS LESS THEN THE ALLOWABLE DISCHARGE RATE OF 12.5 CFS (4.0 CFS/AC) ACCORDING TO THE 2013 DRAINAGE MASTER PLAN BY AMOLE-HUBBELL.

SUBBASINS DEV1 AND DEV 3 CONTAIN A COMBINED TOTAL OF 1.4 ACRES AND DRAIN TO THE ADJACENT PROPERTY TO THE EAST VIA SHEET FLOW AT A RATE OF 4.7 CFS (3.4 CFS/AC) WHICH IS LESS THE ALLOWABLE DISCHARGE RATE OF 5.6 CFS (4.0 CFS/AC) ACCORDING TO THE 2013 AMOLE-HUBBELL DRAINAGE MASTER PLAN.

SUBBASINS DEV 1 AND DEV 3 DISCHARGE LESS RUNOFF TO THE AJACENT PROPERTY THAN IN THE EXISTING CONDITION (SUBBASINS EX1 AND EX2, RESPECTIVELY).
SUBBASINS DEV1 AND DEV3 MEET THEIR WATER QUALITY REQUIREMENTS VIA FEE IN

CALCULATIONS OF WATER QUALITY VOLUME AND THE FEE IN LIEU AMOUNT ARE SHOWN IN THE TABLES ON THIS SHEET.

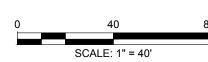





2013 Report



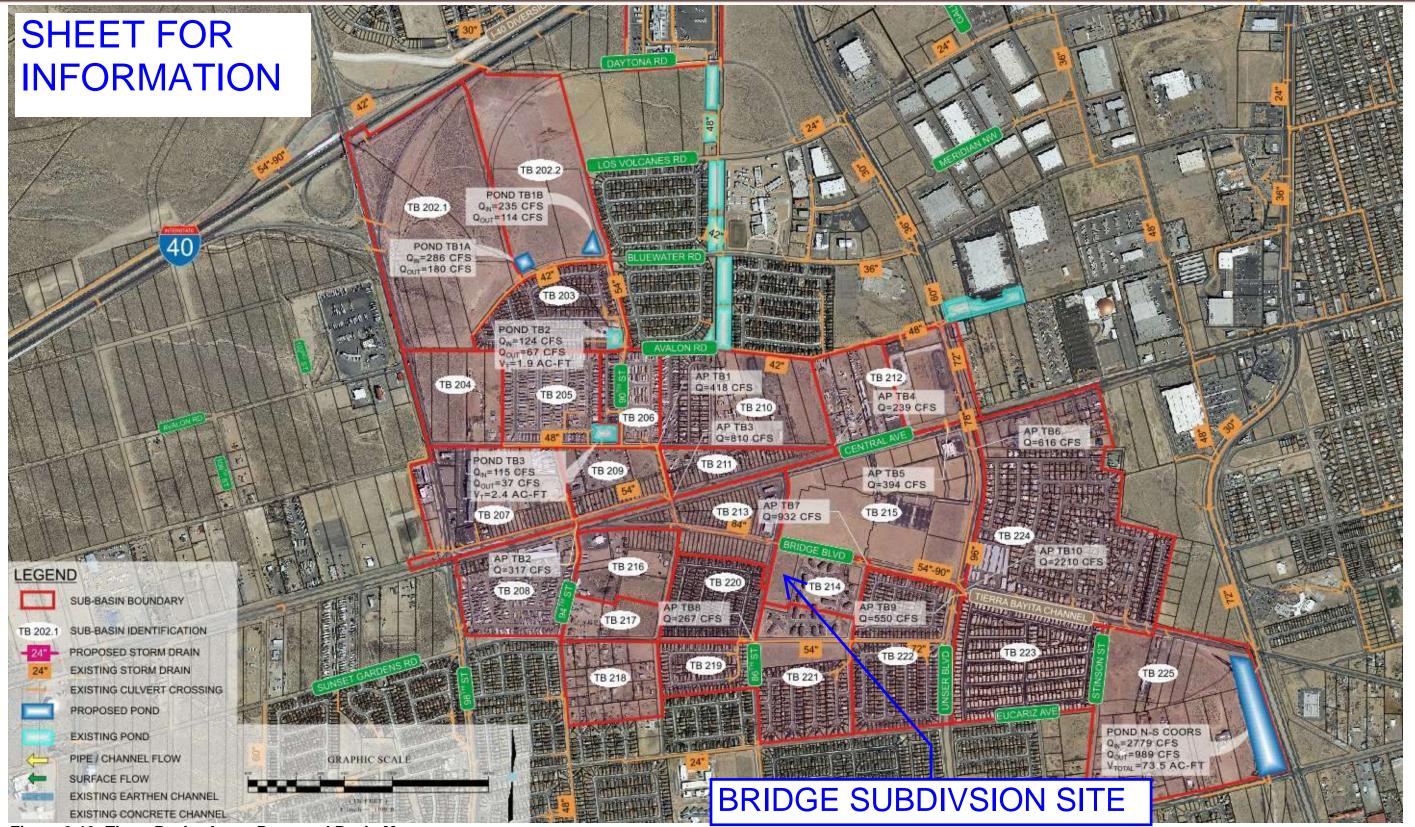


Figure 3-13: Tierra Bayita Area - Proposed Basin Map

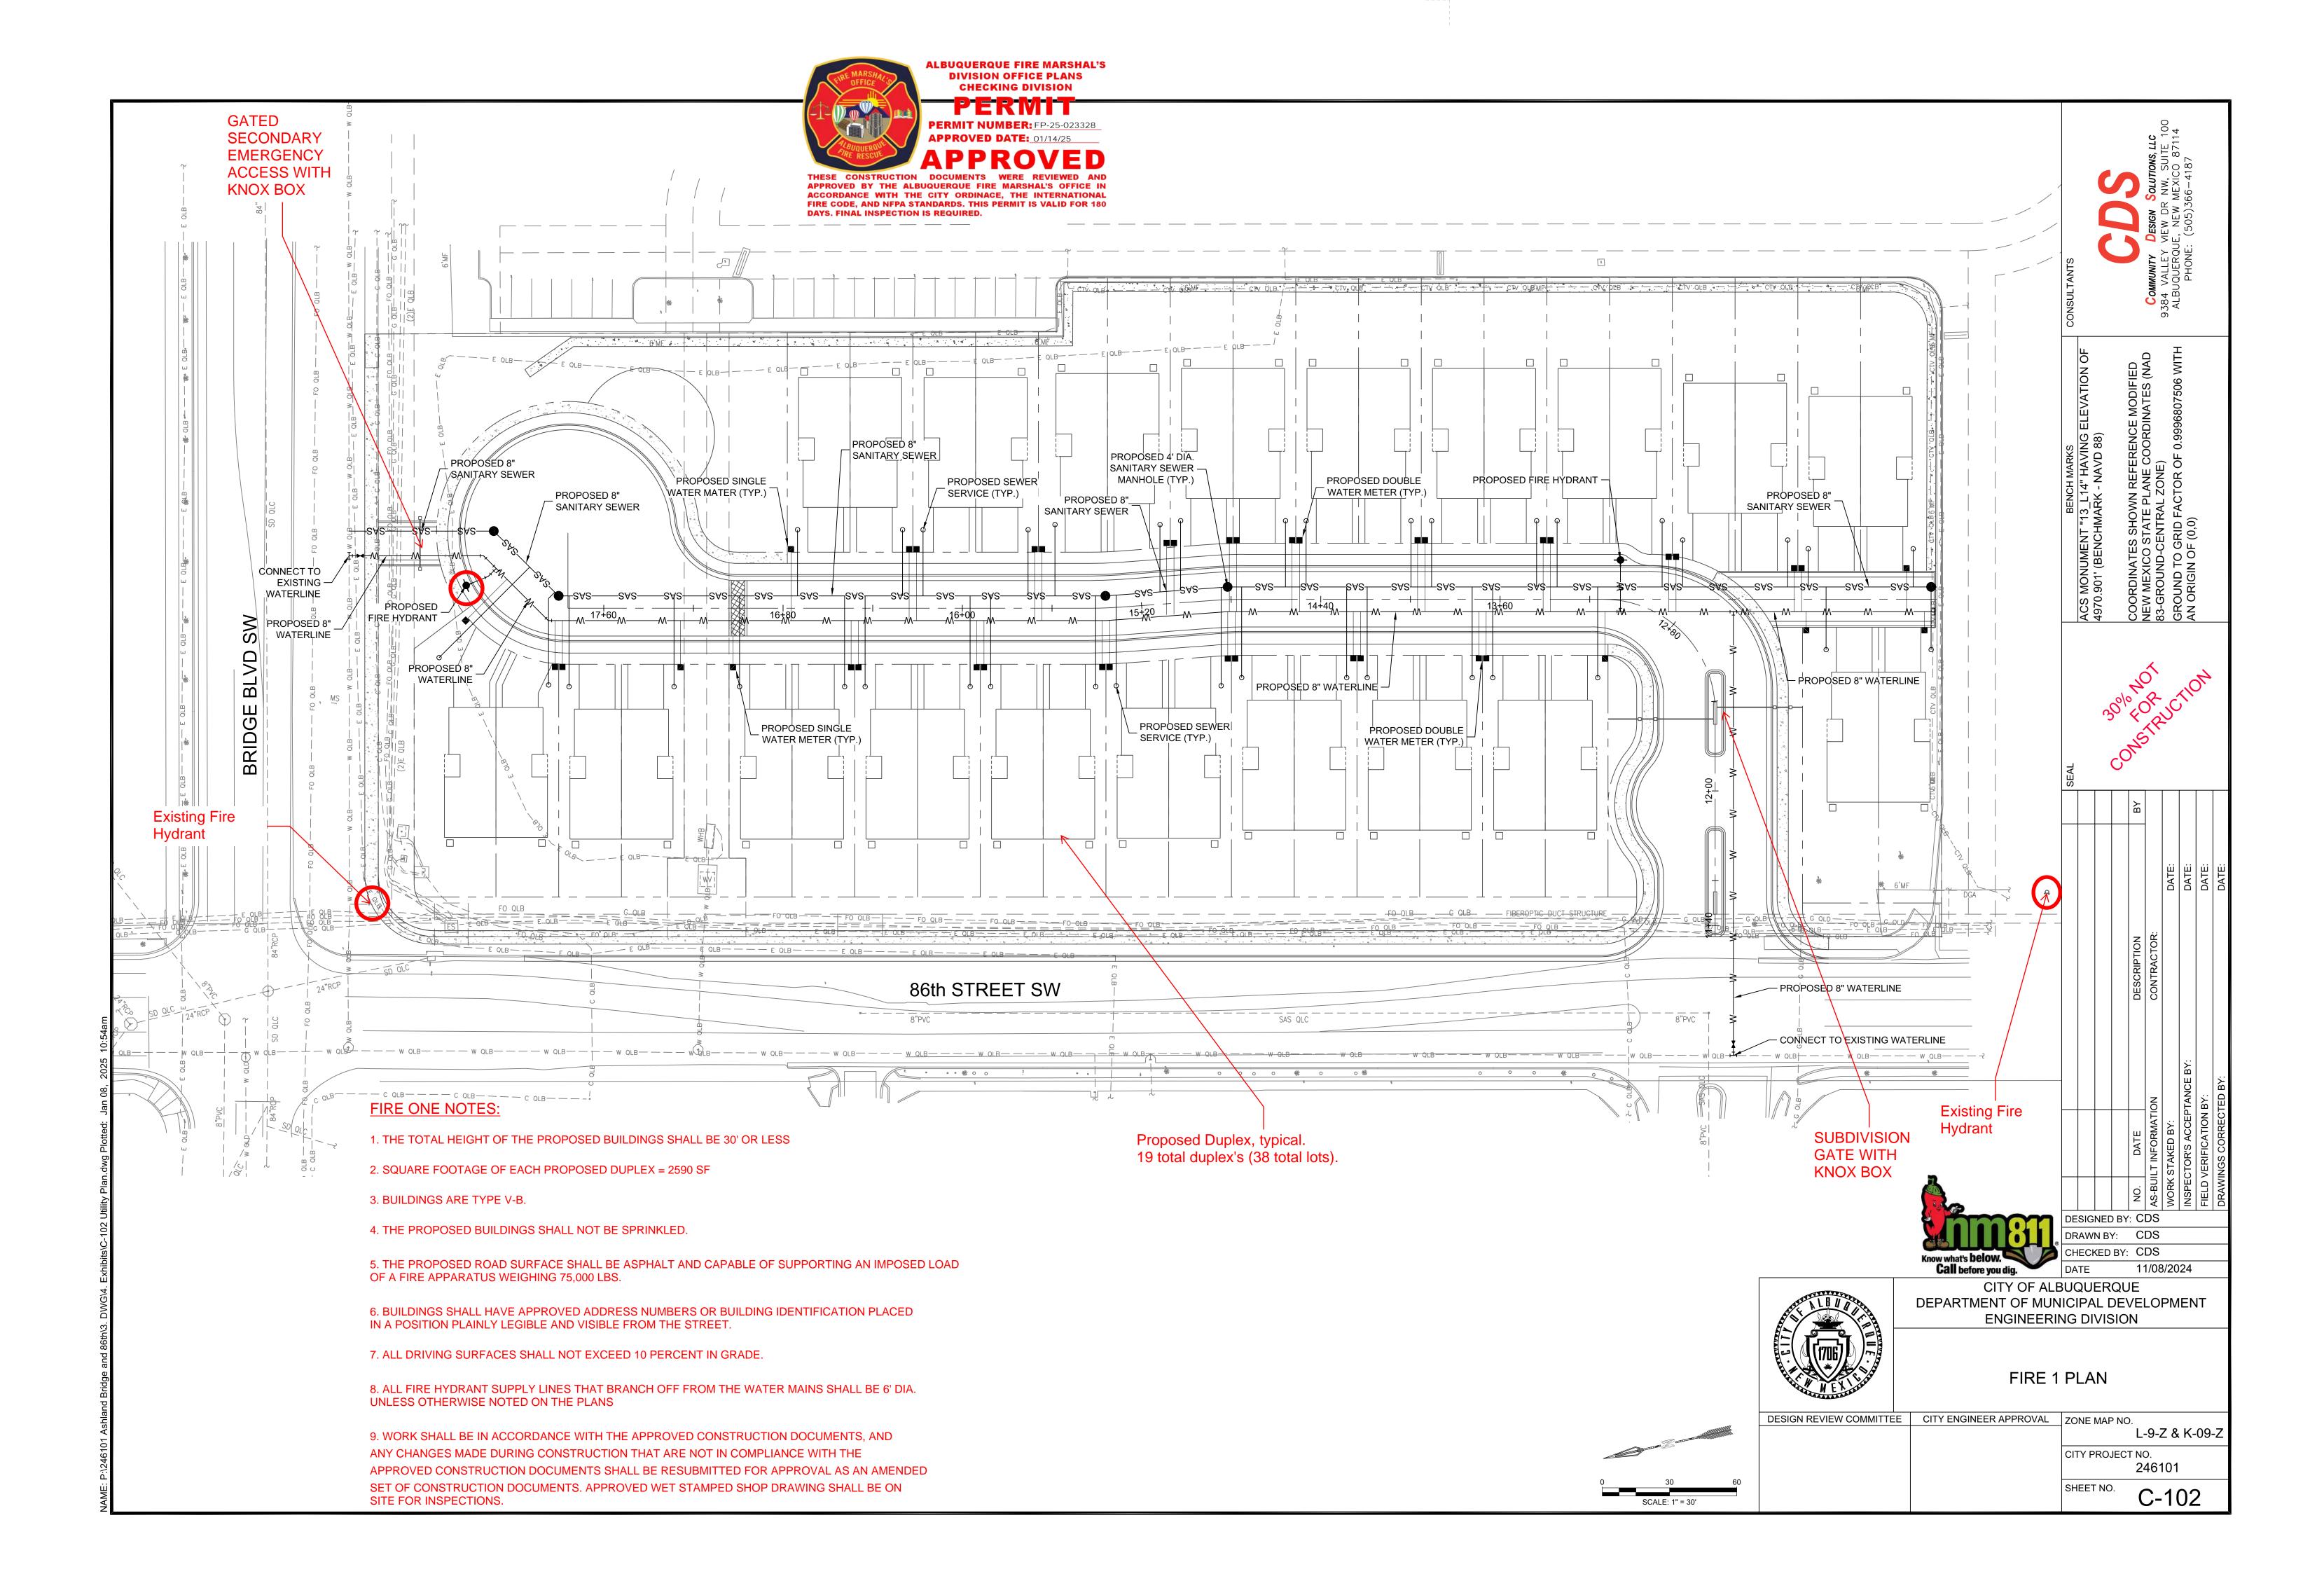

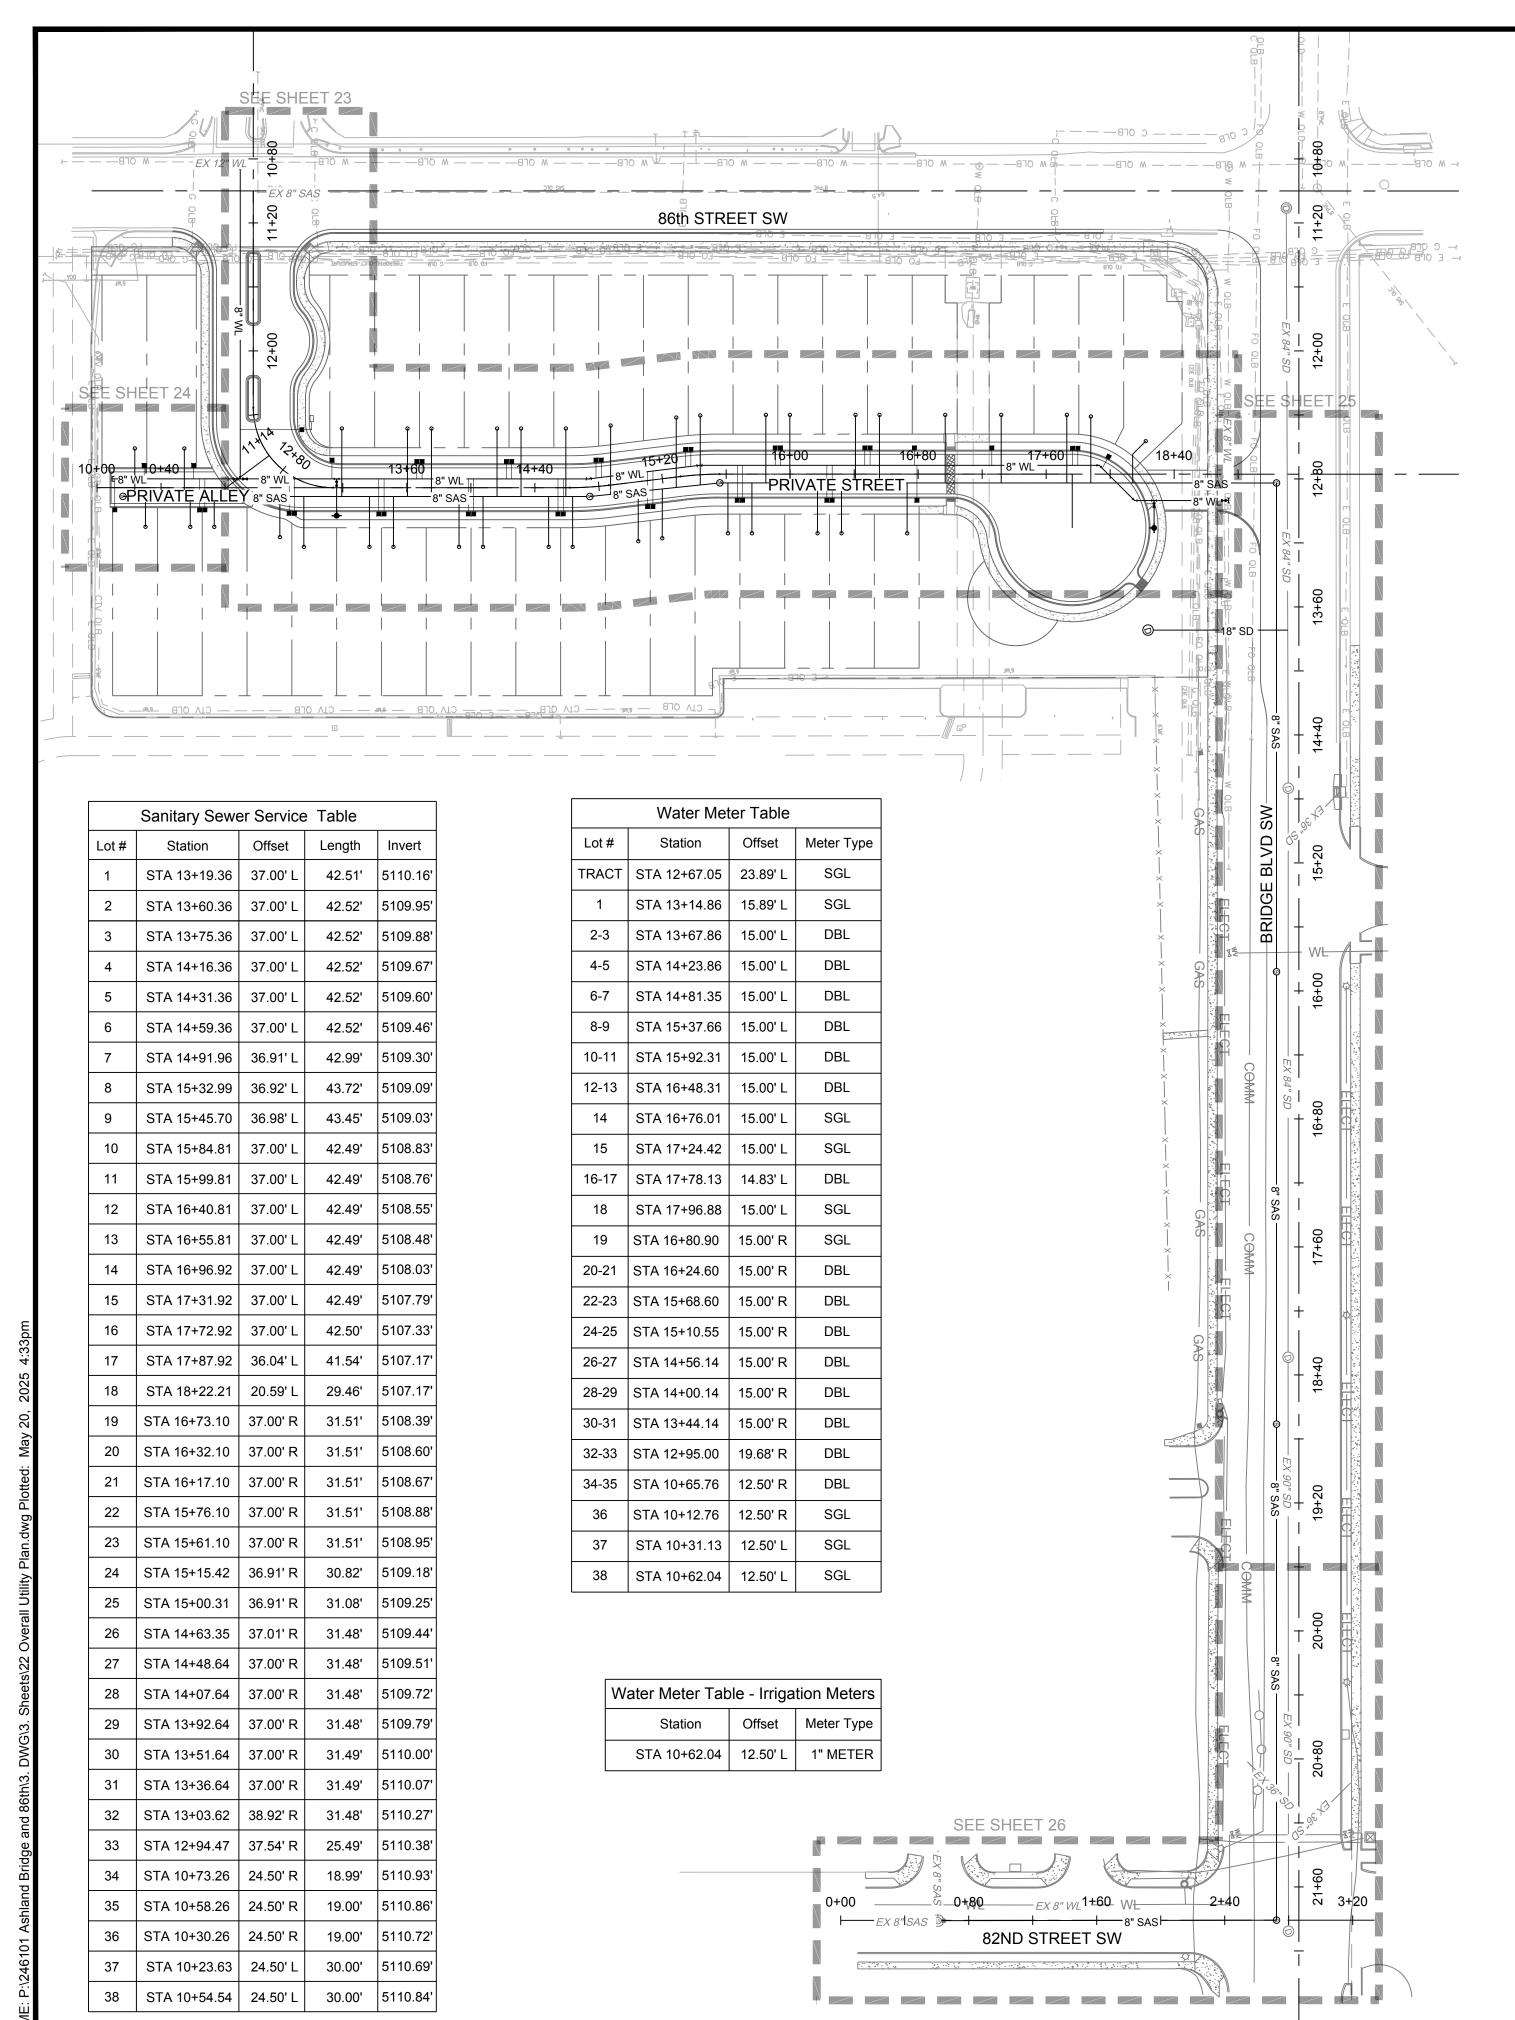

#### **UTILITY GENERAL NOTES:**

- 1. COORDINATION WITH THE WATER AUTHORITY CROSS CONNECTION SECTION WILL BE REQUIRED TO ENSURE PROPER BACKFLOW CONTAINMENT IS IN PLACE PRIOR TO RELEASE OF METER FOR THE SITE. CONTACT THE CROSS CONNECTION SECTION AT 505-289-3454.
- 2. COORDINATION WITH THE WATER AUTHORITY PRE-TREATMENT ENGINEER IS REQUIRED TO ENSURE THE SITE COMPLIES WITH WATER AUTHORITY SEWER USE ORDINANCE. CONTACT THE PRE-TREATMENT ENGINEER AT 505-289-3439.
- 3. PRIVATE SAS SERVICE LINES SHALL BE PVC DWV OR ANOTHER MATERIAL APPROVED BY THE NEW MEXICO PLUMBING CODE.
- 4. ALL PUBLIC WATERLINES SHALL BE PVC C900 DR18 UNLESS OTHERWISE NOTED.
- 5. ALL PUBLIC SEWER LINES SHALL BE PVC DR 35 UNLESS OTHERWISE NOTED.
- WHERE POSSIBLE, CONTRACTOR SHALL INSTALL FULL 20-FT JOINT OF PIPE ON EITHER SIDE OF ALL MECHANICAL JOINT VALVES, FITTINGS, AND APPURTENANCES. FOR ALL CIRCUMSTANCES WHERE A 20-FT JOINT CAN BE UTILIZED AND THE CONTRACTOR ELECTS TO USE A SHORTER PIPE JOINT, CONTRACTOR SHALL PROVIDE, AT CONTRACTOR'S SOLE EXPENSE, ALL NECESSARY JOINT RESTRAINTS REQUIRED BY TABLE ABOVE

#### THRUST RESTRAINT NOTE

ALL BURIED VALVES, FITTINGS, AND APPURTENANCES SHALL BE MECHANICAL JOINT-TYPE UTILIZING "MEGA-LUG"® STYLE MECHANICAL JOINT RESTRAINTS IN CONJUNCTION WITH "MEGA-LUG"® PIPE BELL-HARNESS RESTRAINTS WHEN ADEQUATE RESTRAINED LENGTH CAN BE OBTAINED. IN THE EVENT ADEQUATE RESTRAINED LENGTHS CANNOT BE OBTAINED, CONTRACTOR SHALL IMMEDIATELY CONTACT ENGINEER FOR DETERMINATION OF APPROPRIATE ACTION TO BE TAKEN. THE EBAA IRON "RESTRAINED LENGTH CALCULATION" PROGRAM (VERSION 4.0) HAS BEEN USED TO DETERMINE MINIMUM RESTRAINED LENGTHS SHOWN IN TABLE BELOW. THE FOLLOWING GENERAL ASSUMPTIONS APPLY TO ALL CALCULATIONS:

SOIL TYPE <u>SM (SILTY SANDS, SAND SILT MIXTURE)</u> SAFETY FACTOR <u>1.5 TO 1</u>

TYPICAL BURY DEPTH:
4" THROUGH 8" DIAMETER PIPE 3 FT

12" THROUGH 24" DIAMETER PIPE 4 FT

6 FT TO TOP OF LOWER BRANCH 12" THROUGH 24" DIAMETER PIPE 4 FT TO TOP OF UPPER BRANCH 7 FT TO TOP OF LOWER BRANCH

CONTRACTOR MAY SUBMIT SUBSTITUTE REDUCED RESTRAINED JOINT LENGTHS IF SOIL AND DEPTH OF BURY CONDITIONS WARRANT. CONTRACTOR SHALL PROVIDE SOIL TEST RESULTS AND APPROPRIATE CALCULATIONS TO SUPPORT THE LENGTH REDUCTION. SOIL TESTING AND CALCULATIONS SHALL BE PERFORMED AT CONTRACTOR'S SOLE EXPENSE

#### WATER SHUTOFF NOTES:

- THE CONTRACTOR SHALL COORDINATE WITH THE WATER AUTHORITY SEVEN (7) DAYS IN ADVANCE OF PERFORMING WORK THAT WILL AFFECT THE PUBLIC WATER OR SANITARY SEWER INFRASTRUCTURE. WORK REQUIRING SHUTOFF OF WELL COLLECTORS. TRANSMISSION LINES, OR FACILITIES DESIGNATED AS MASTER PLAN FACILITIES MUST BE COORDINATED WITH THE WATER AUTHORITY 14 DAYS IN ADVANCE OF PERFORMING SUCH WORK. ONLY WATER AUTHORITY CREWS ARE AUTHORIZED TO OPERATE PUBLIC VALVES. SHUTOFF REQUESTS MUST BE MADE ONLINE AT:
- http://www.abcwua.org/Water\_Shut\_off\_and\_Turn\_on\_Procedures.aspx

2. APPROXIMATE SHUT OFF TIME WILL BE 24 HOURS.

# TEST PRESSURE @ 150 PSI

LENGTHS OF PIPE TO BE RESTRAINED - ALL JOINTS WITHIN LENGTH(FEET) MUST BE

All proposed utility

infrastructure shown

is public unless noted

infrastructure shall be

otherwise. All public

installed with a City

work order.

	RESTRAINED (APPLIES TO PVC ONLY)						
		HORIZ	FIRE HYDRANT TEE				
PIPE SIZE	90° BEND	45° BEND	22 1/2° BEND	11 1/4° BEND	DEAD END OR VALVE	STD. 6-INCH BRANCH LINE	
4"	18'	8'	4'	2'	39'	FOR ALL PIPE MAIN LINE	
6"	25'	11'	5'	3'	55'	SIZES, ALL FITTINGS AND	
8"	33'	14'	7'	4'	72'	PIPE JOINTS FROM TEE TO	
10"	39'	16'	8'	4'	87'	FIRE HYDRANT FLANGE	
12"	45'	19'	9'	5'	102'	SHALL BE RESTRAINED	

	VERTICAL DOWNBEND						
	4:	5°	22	1/2°	11 1/4°		
PIPE SIZE	UPPER BEND RESTRAINT	LOWER BEND RESTRAINT	UPPER BEND RESTRAINT	LOWER BEND RESTRAINT	UPPER BEND RESTRAINT	LOWER BEND RESTRAINT	
4"	16'	4'	8'	2'	4'	1'	
6"	23'	5'	11'	3'	5'	1'	
8"	30'	7'	14'	3'	7'	2'	
10"	36'	8'	17'	4'	8'	2'	
12"	42'	10'	20'	5'	10'	2'	

TEES	LENGTH ALONG RUN (Lr)											
IEES	2'	4'	6'	8'	10'	12'	14'	16'	18'	20'	REDUCERS	
6x6x4	29	18	7	1	1	1	1	1	1	1		L. SIDE
6x6x6	48	41	33	26	18	11	4	1	1	1	6x4	28
8x8x4	25	11	1	1	1	1	1	1	1	1	8x4	52
8x8x6	46	36	26	16	6	1	1	1	1	1	8x6	30
8x8x8	65	57	50	43	35	28	20	13	5	1	10x4	70
0x10x4	21	3	1	1	1	1	1	1	1	1	10x6	53
0x10x6	43	30	18	5	1	1	1	1	1	1	10x8	29
0x10x8	63	53	44	34	25	15	6	1	1	1	12x4	88
0x10x10	79	72	64	56	49	41	34	26	18	11	12x6	74
2x12x4	17	1	1	1	1	1	1	1	1	1	12x8	54
2x12x6	40	25	10	1	1	1	1	1	1	1	12x10	50
2x12x8	61	49	38	26	15	3	1	1	1	1		
2x12x10	78	68	59	50	41	32	22	13	4	1	RESTRAINED	
2x12x12	95	87	79	72	64	56	49	41	33	26	ON LARGE S	IDE ONLY
RESTRAINED LENGTH ALONG BRANCH (Lb)						<u> </u>						




DESIGNED BY: RSM DRAWN BY: RSM

now what's below. CHECK DATE

5/20/2025 CITY OF ALBUQUERQUE DEPARTMENT OF MUNICIPAL DEVELOPMENT **ENGINEERING DIVISION** 


OVERALL UTILITY PLAN


DESIGN REVIEW COMMITTEE | CITY ENGINEER APPROVAL | ZONE MAP NO. L-9-Z & K-09-Z CITY PROJECT NO. ####

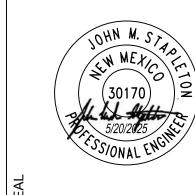



SHEET NO.


CHECKED BY: JMS

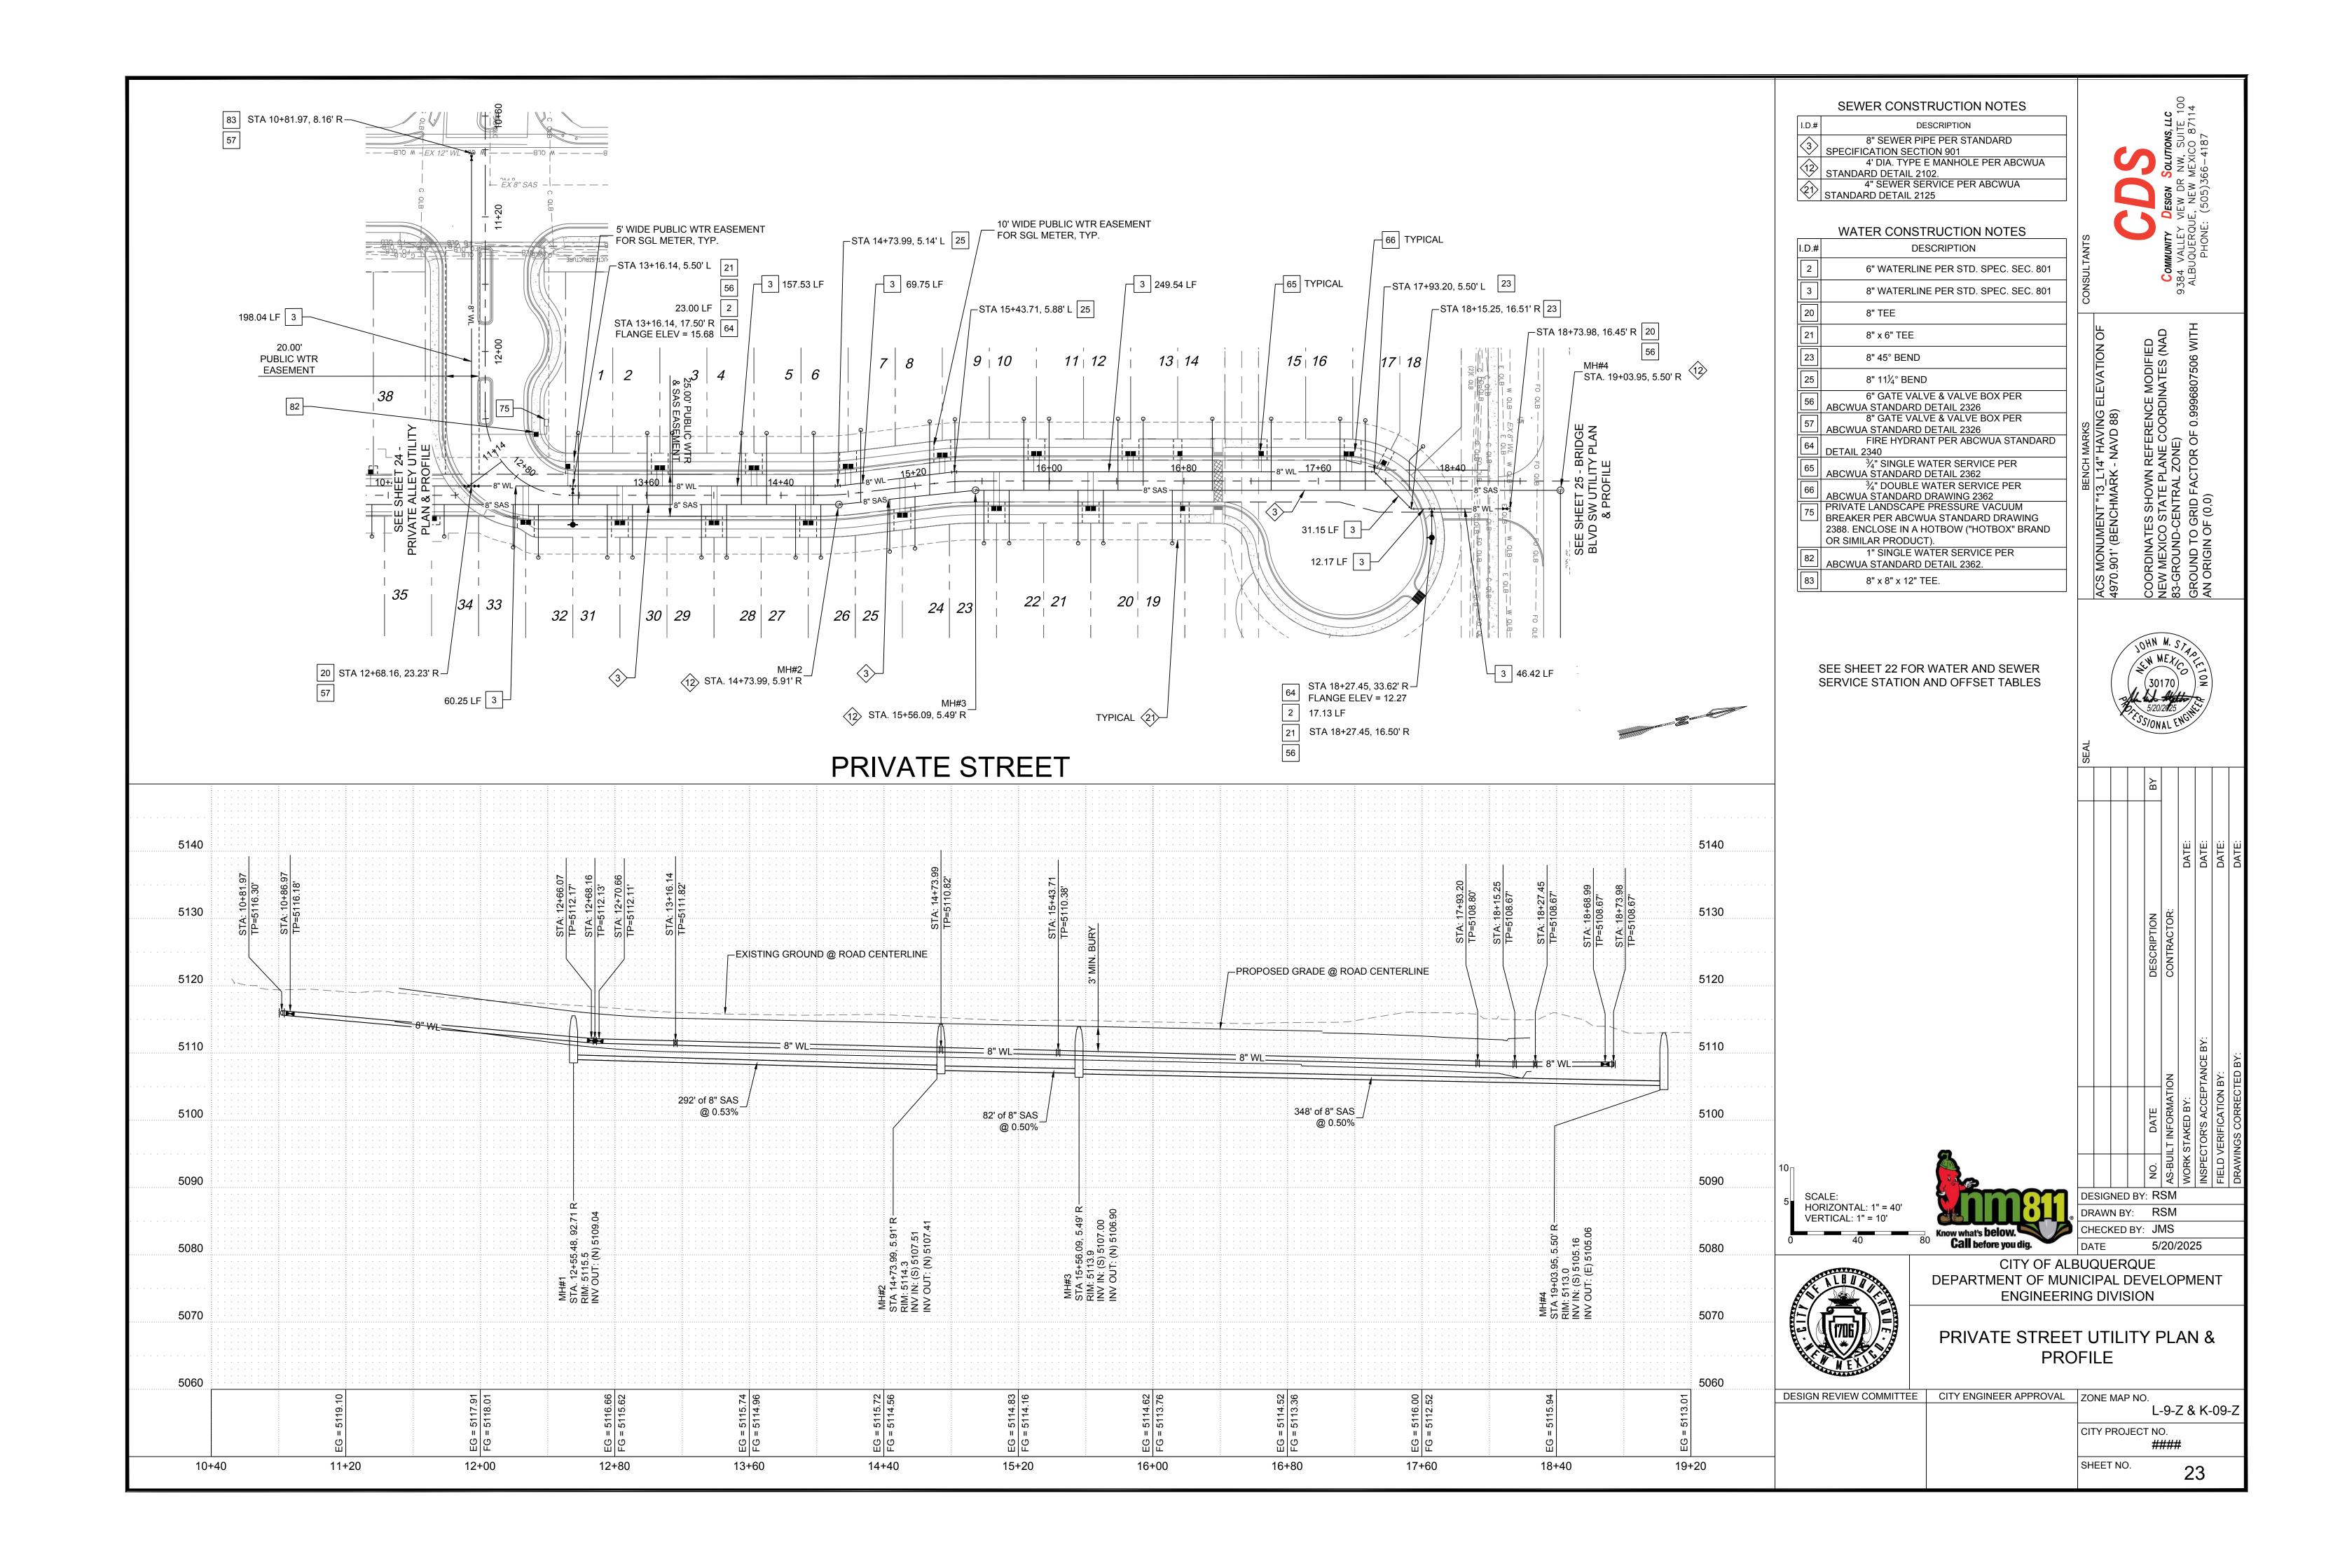

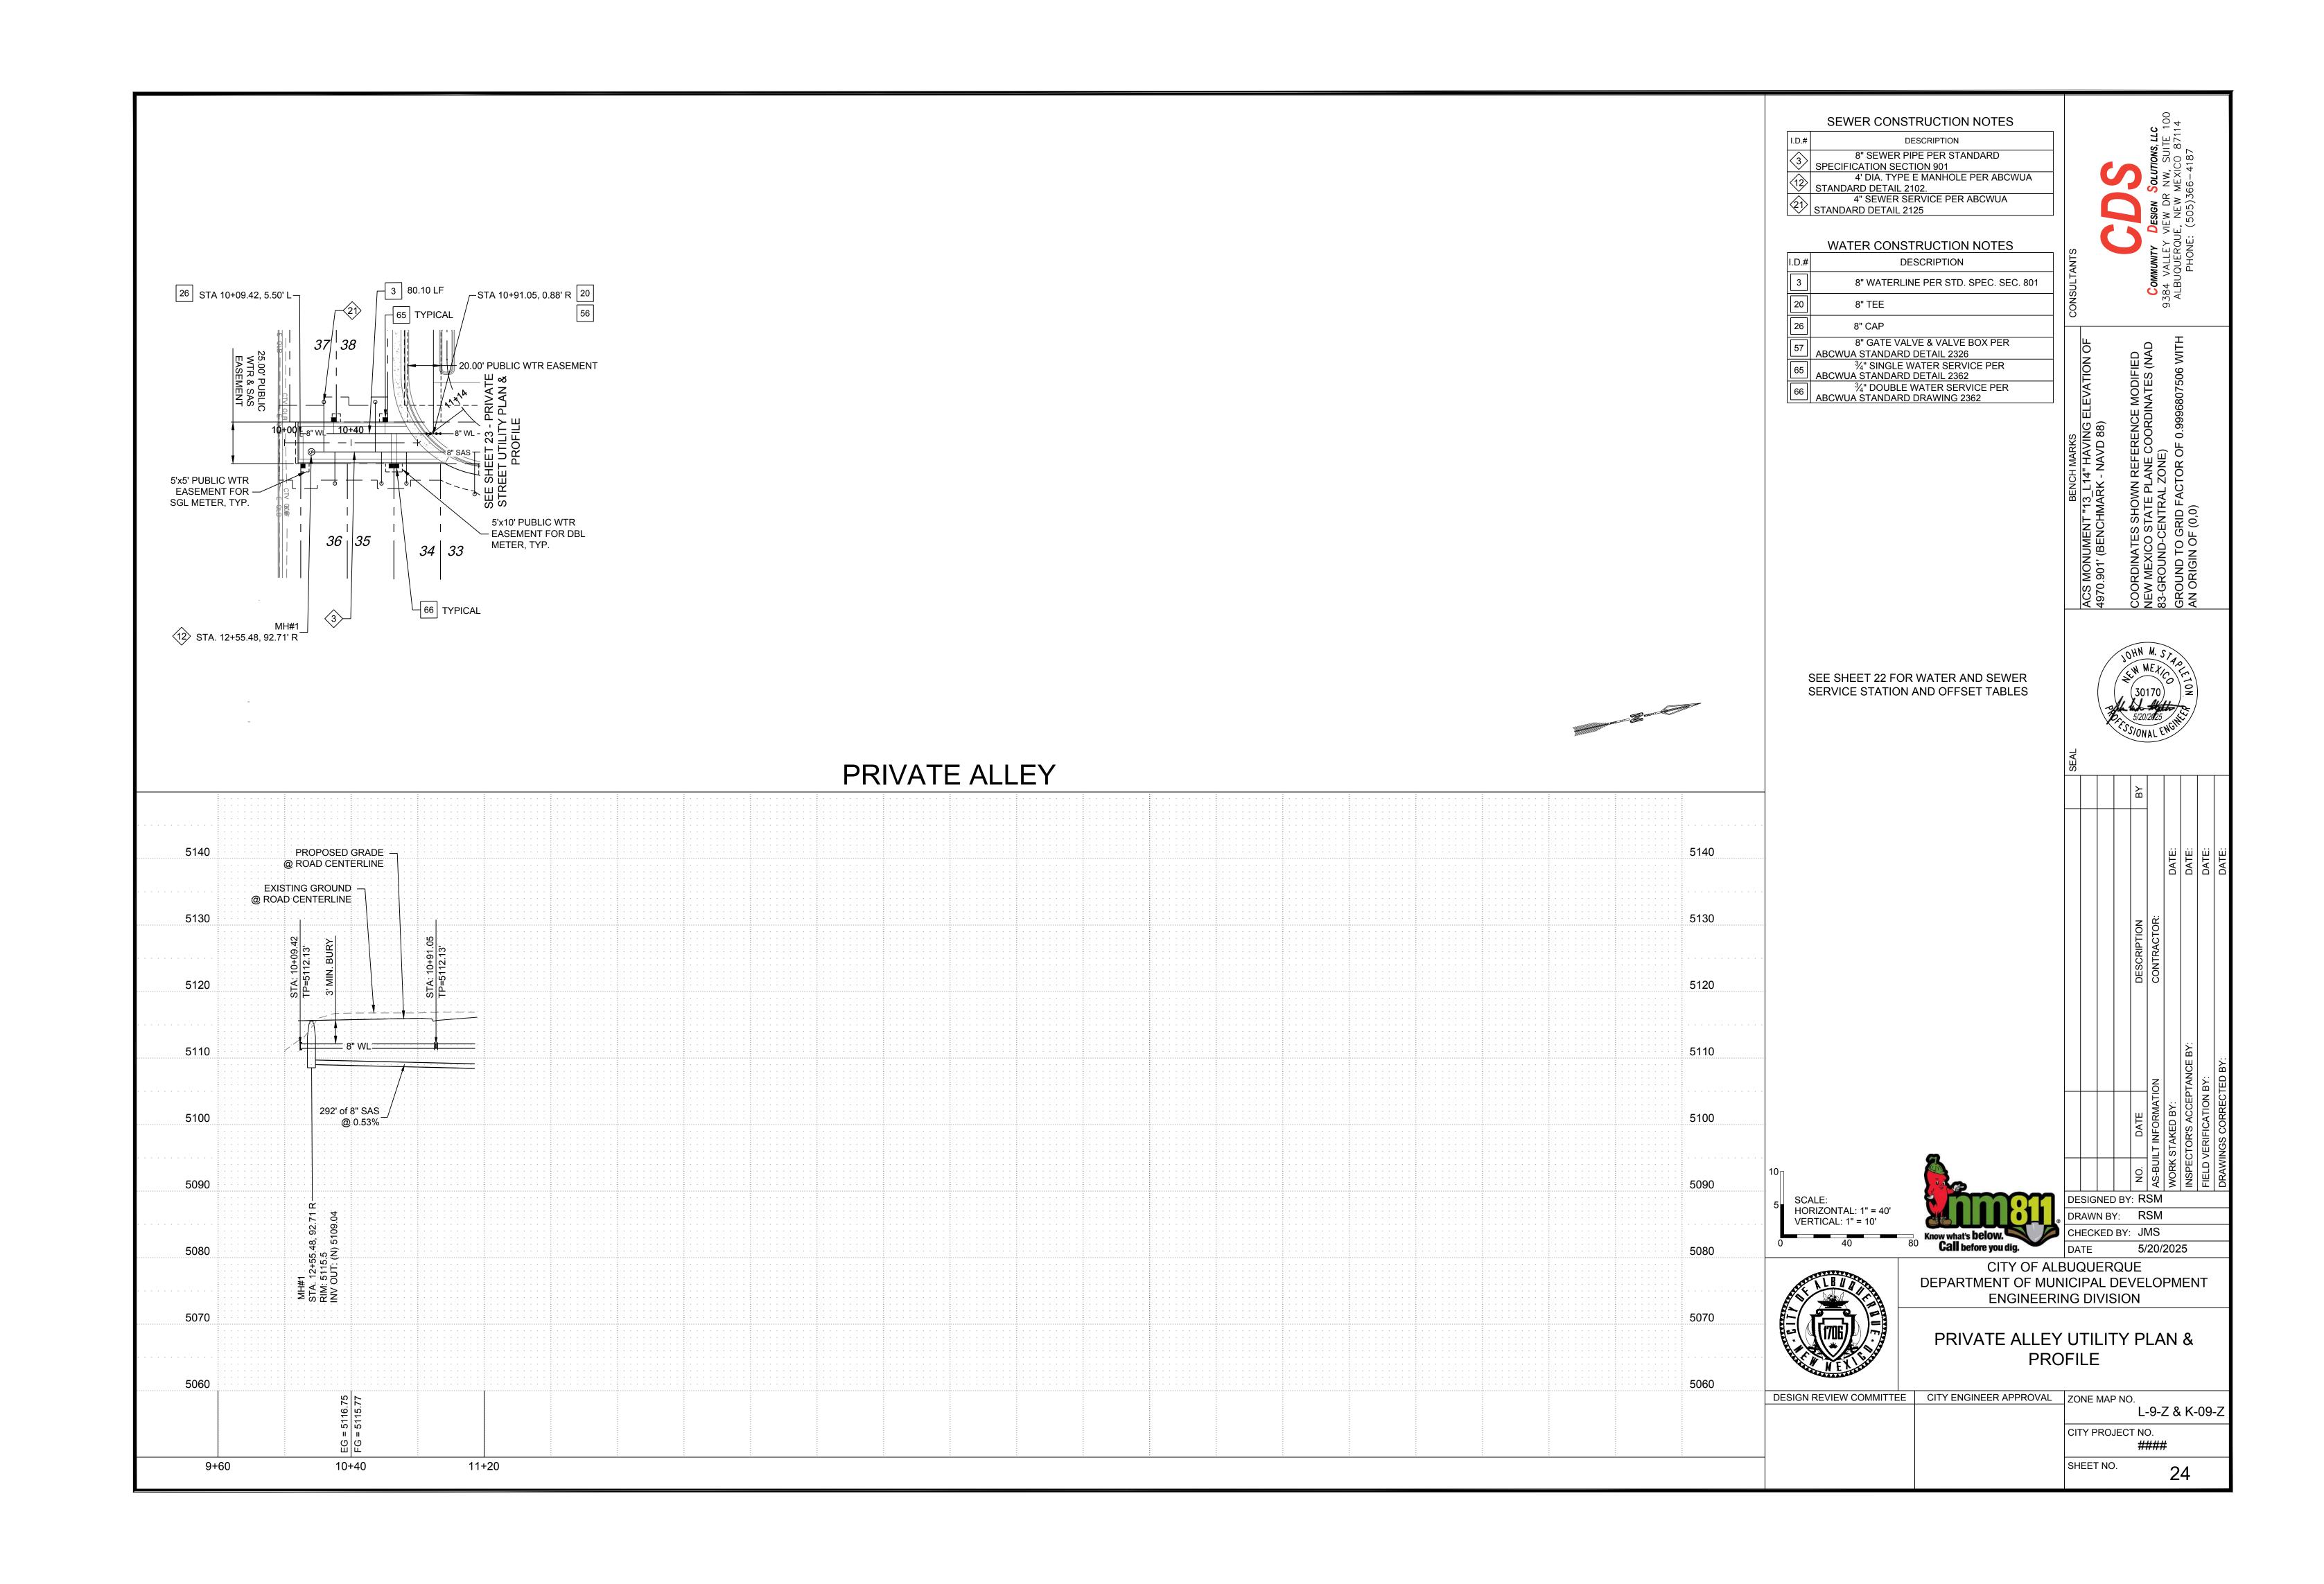

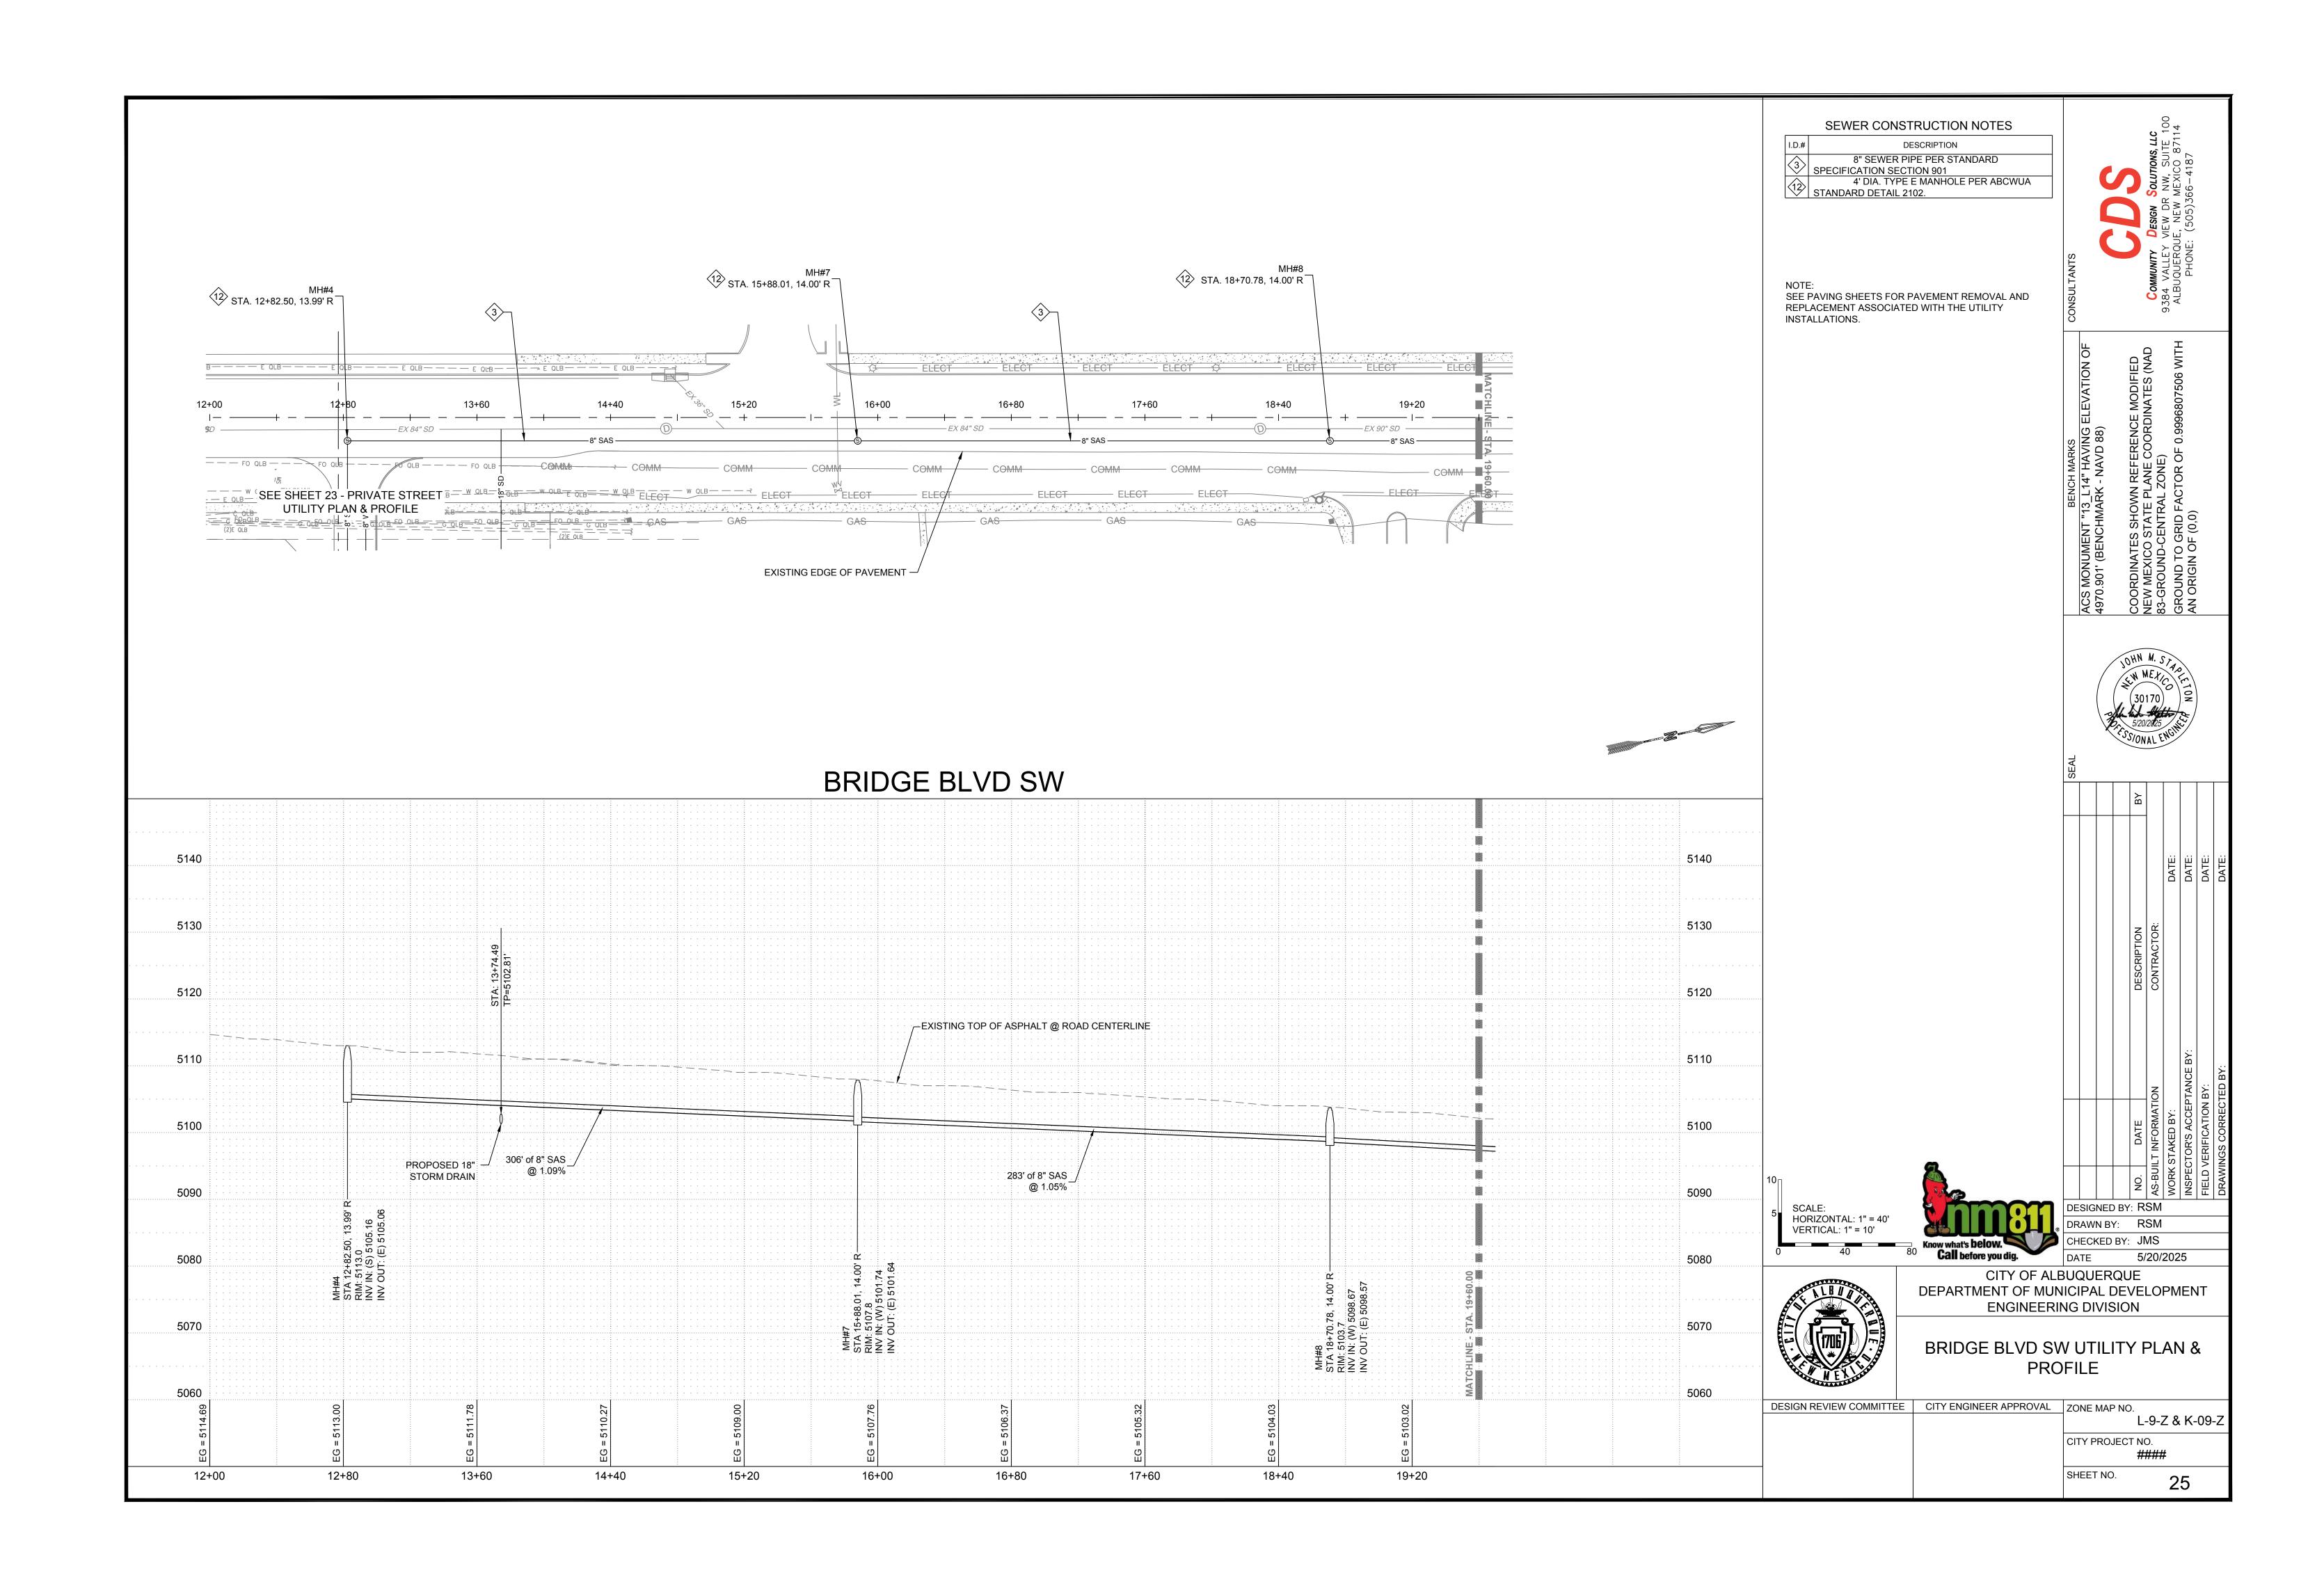

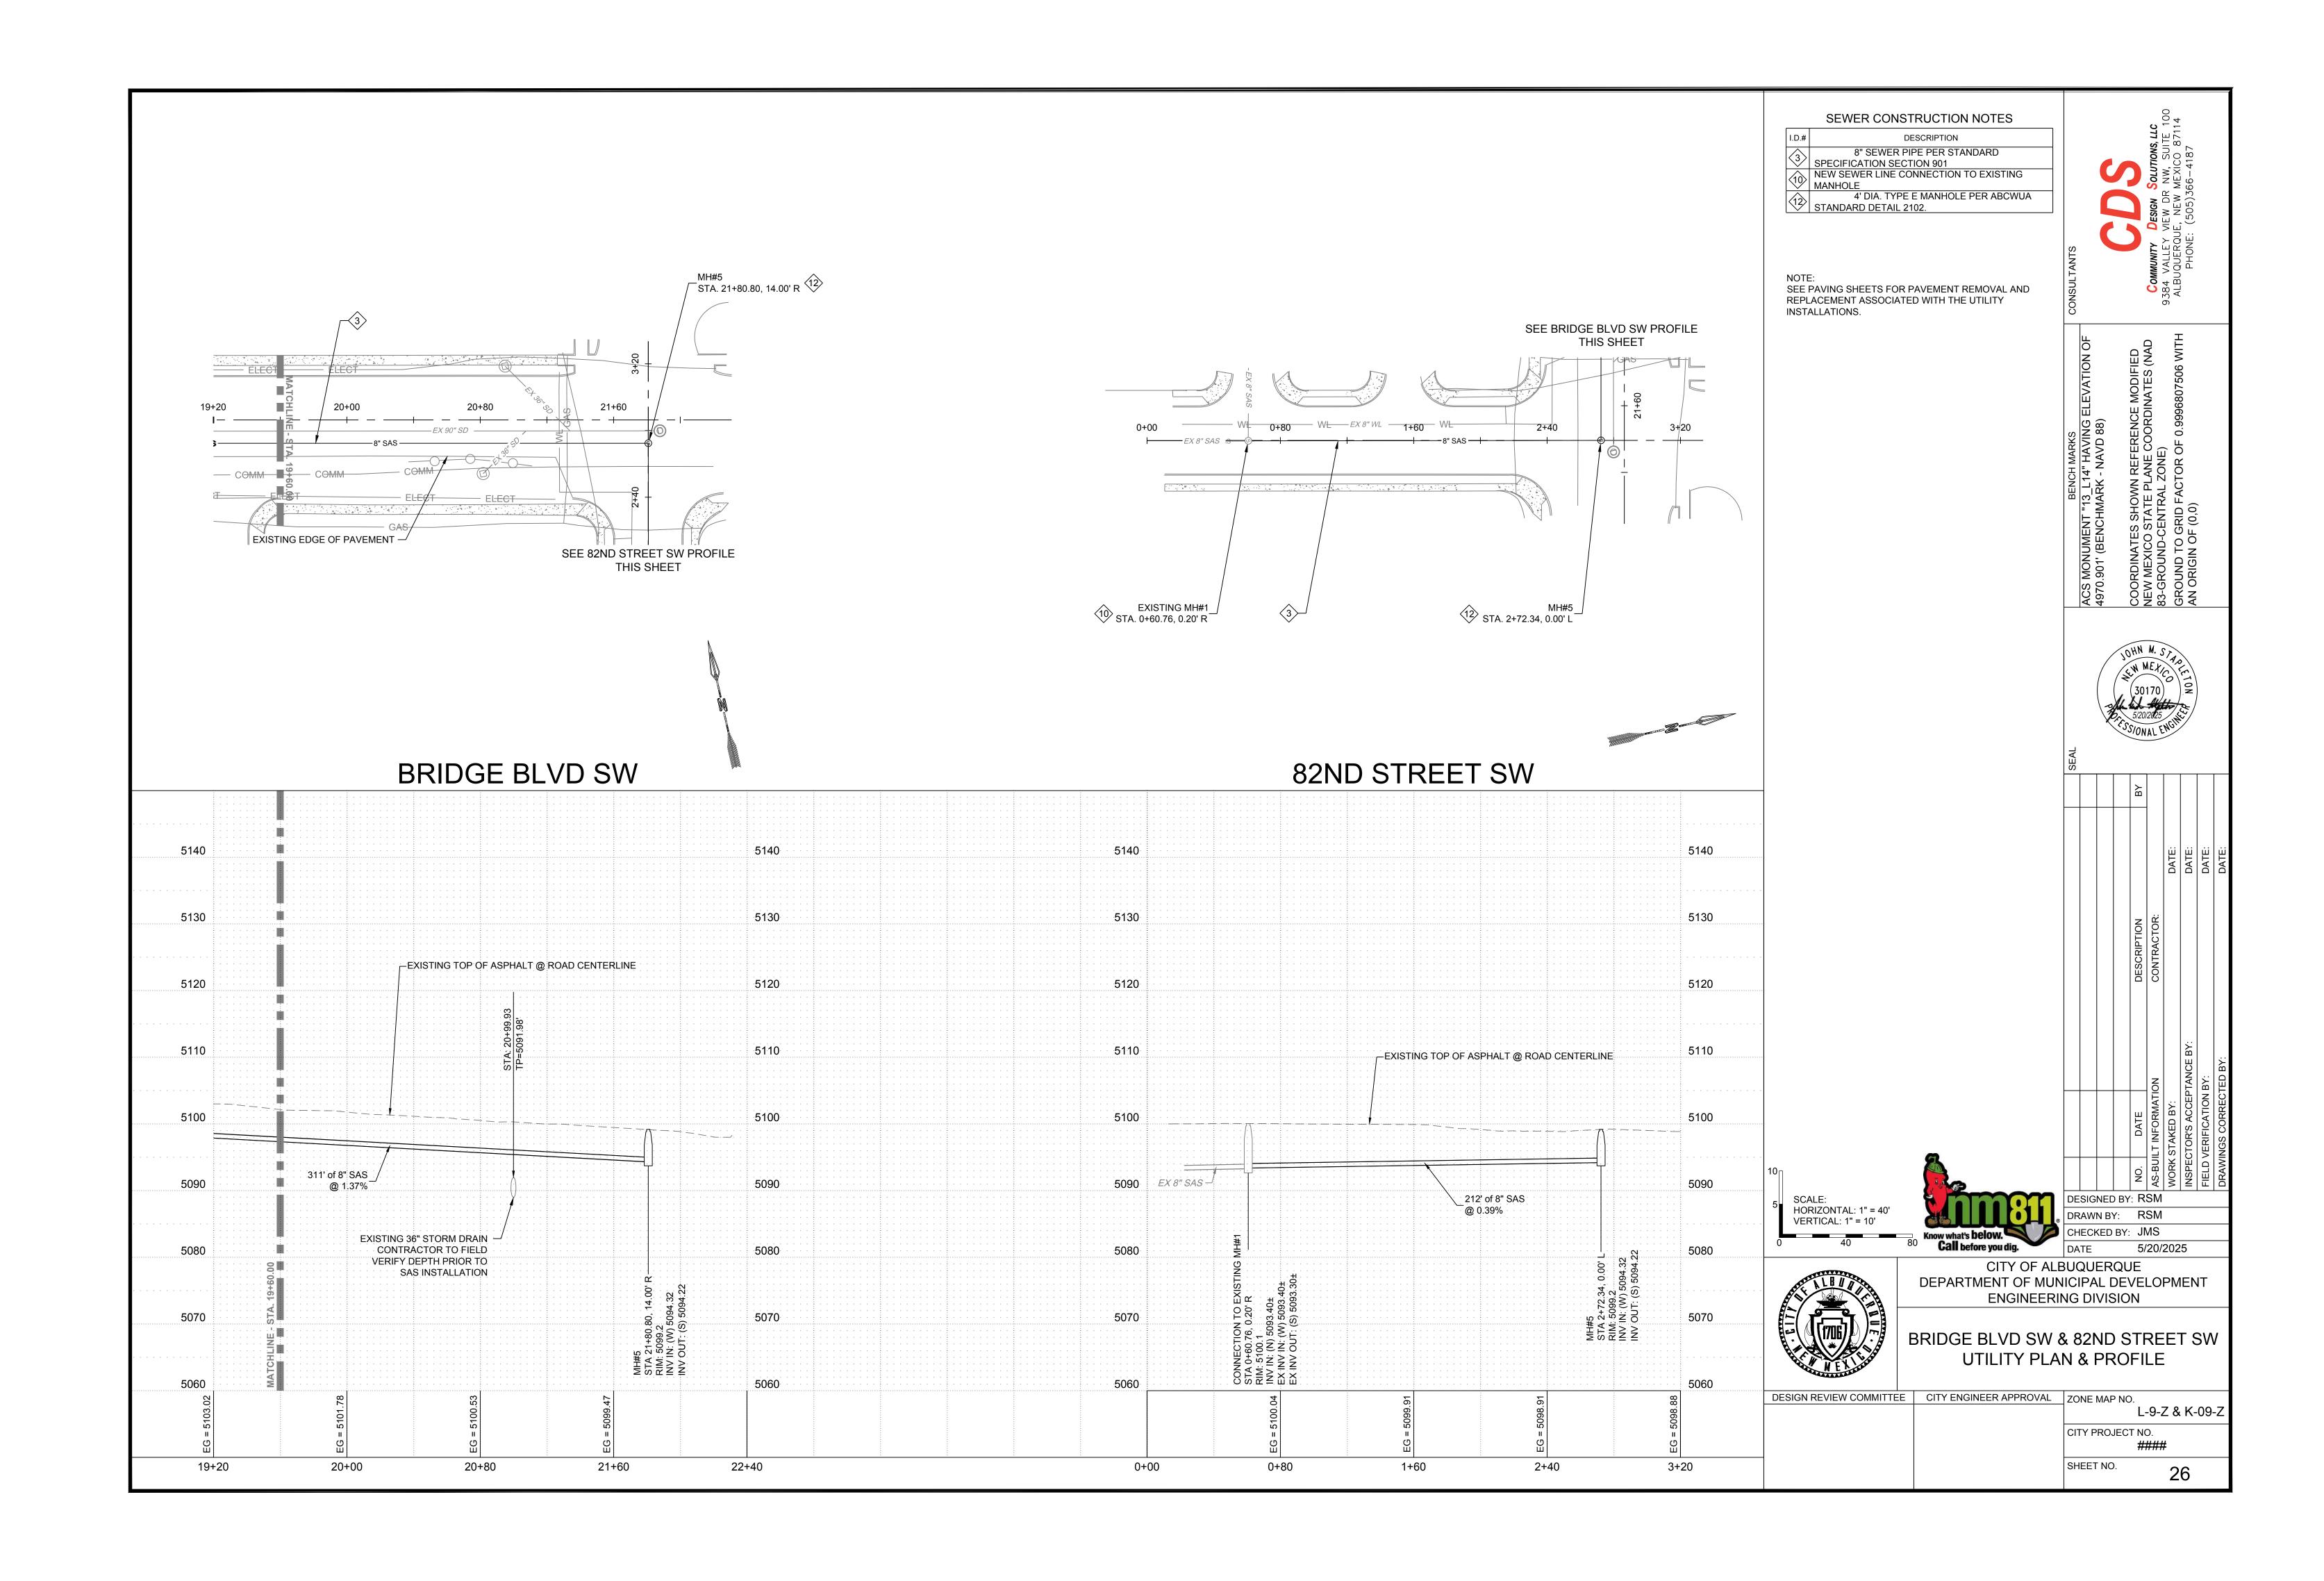

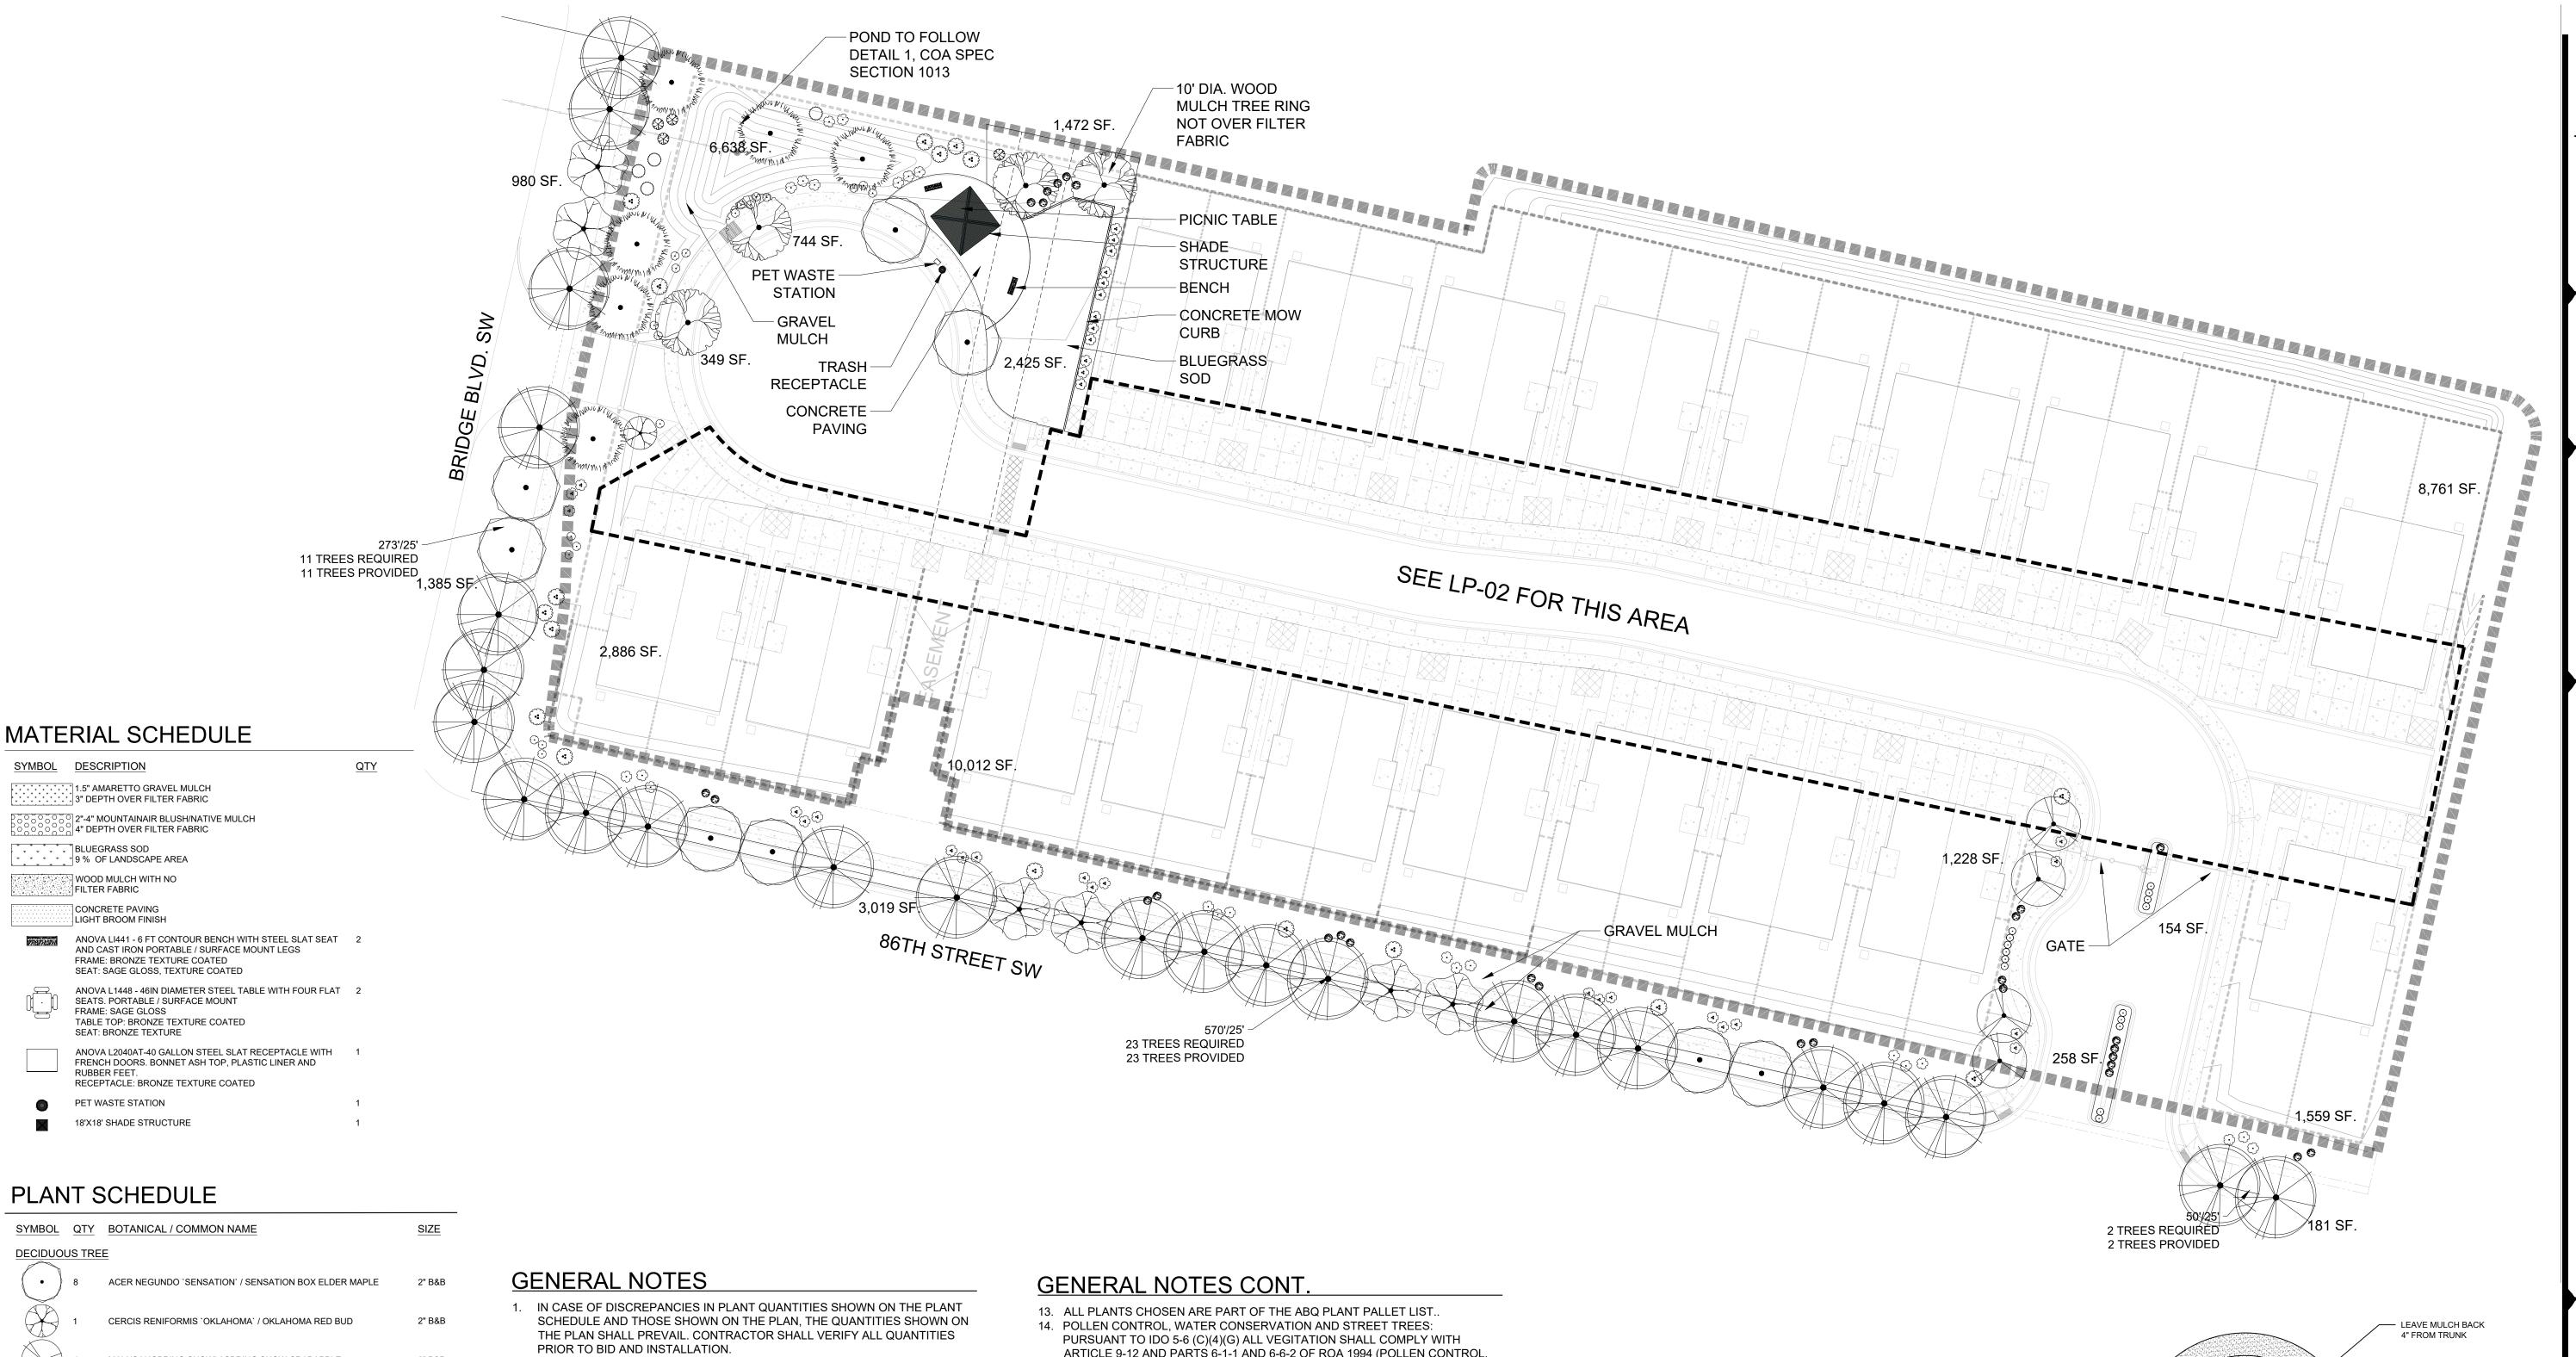

SYMBOL	QTY	BOTANICAL / COMMON NAME	SIZE
DECIDUOL	JS TRE	<u>E</u>	
	8	ACER NEGUNDO `SENSATION` / SENSATION BOX ELDER MAPLE	2" B&B
	1	CERCIS RENIFORMIS 'OKLAHOMA' / OKLAHOMA RED BUD	2" B&B
	4	MALUS X 'SPRING SNOW' / SPRING SNOW CRABAPPLE	2" B&B
	24	QUERCUS BUCKLEYI / BUCKLEY OAK	2" B&B
	4	ULMUS PARVIFOLIA `ALLEE` / ALLEE® LACEBARK ELM	2" B&B
	6	ULMUS PROPINQUA 'EMERALD SUNSHINE' / EMERALD SUNSHINE ELM	2" B&B
EVERGRE	EN TRE	<u>:E</u>	
William William Control of the Contr	6	PINUS ELDARICA / AFGHAN PINE	6`
DESERT A	CCENT		
<b>(.</b> )	34	HESPERALOE PARVIFLORA / RED YUCCA	5 GAL
\$ ** X	17	NOLINA MICROCARPA / BEARGRASS	5 GAL
DECIDUOL	JS SHR	RUBS	
$\left( \cdot \right)$	20	AMORPHA CANESCENS / LEADPLANT	5 GAL
	29	CARYOPTERIS X CLANDONENSIS `DARK KNIGHT` / BLUE MIST SPIREA	1 GAL
	4	LEUCOPHYLLUM FRUTESCENS / TEXAS SAGE	5 GAL
	4	PEROVSKIA ATRIPLICIFOLIA / RUSSIAN SAGE	5 GAL

SALVIA GREGGII / AUTUMN SAGE CHERRY

5 GAL

23 ARTEMISIA FILIFOLIA / SAND SAGEBRUSH

2. POSITIVE DRAINAGE AWAY FROM ALL STRUCTURES SHALL BE PROVIDED TO THE LANDSCAPE CONTRACTOR AND SHALL BE MAINTAINED BY THE LANDSCAPE CONTRACTOR THROUGHOUT THE DURATION OF THE PROJECT. 3. GRADING OF THE SITE PER THE GRADING PLAN IS NOT INCLUDED IN THE SCOPE OF WORK OF THE LANDSCAPE CONTRACTOR. GRADES PER THE

GRADING PLAN SHALL BE PROVIDED TO THE LANDSCAPE CONTRACTOR +/-

- 1/10TH OF A FOOT, BY OTHERS. 4. ALL MAINTENANCE OF THE LANDSCAPE AND IRRIGATION SYSTEMS SHALL BE PROVIDED BY OWNER. NO CONTRACTUAL MAINTENANCE SHALL BE INCLUDED UNLESS OTHERWISE SPECIFIED IN THE BIDDING DOCUMENTS. 5. WATER MANAGEMENT IS THE SOLE RESPONSIBILITY OF THE PROPERTY
- RESTRICTIONS OF IRRIGATION WATER USE BY ANY GOVERNING BODY. 6. PER 5-6(C)(9)(a), ALL PLANTING OF VEGETATED MATERIAL OR INSTALLATION OF ANY LANDSCAPING, BUFFERING, OR SCREENING MATERIAL IN THE PUBLIC RIGHT-OF-WAY SHALL REQUIRE THE PRIOR APPROVAL OF THE CITY. THE PROPERTY OWNER SHALL BE RESPONSIBLE FOR THE MAINTENANCE, REPAIRS, OR LIABILITY FOR ALL THE LANDSCAPING PLACED IN OR OVER

OWNER. THE LANDSCAPE ARCHITECT IS NOT RESPONSIBLE FOR ANY

- THE PUBLIC RIGHT-OF-WAY. 7. PER 5-6(C)(9)(b), ANY TREES THAT OVERHANG A PUBLIC SIDEWALK OR MAJOR PUBLIC OPEN SPACE SHALL BE TRIMMED TO MAINTAIN AN 8 FOOT CLEARANCE OVER THE SIDEWALK. ANY TREES THAT OVERHANG A PUBLIC STREET SHALL BE TRIMMED TO MAINTAIN A 9' CLEARANCE OVER THE
- STREET SURFACE. 8. PURSUANT TO 5-6(C)(5)(e), BARK MULCH AREAS CLEARLY DELINEATED ON
- PLANS FOR LANDSCAPE AREAS AND 5' RADIUS RINGS AROUND TREES. 9. PURSUANT TO 5-6(C)(7)(a), ALL VEGETATION HAS BEEN LOCATED A MINIMUM OF 3' IN ANY DIRECTION FROM FIRE HYDRANTS, VALVE VAULTS, HOSE BIBS,

MANHOLES, HYDRANTS AND FIRE DEPARTMENT CONNECTIONS.

- 10. PURSUANT TO 5-6(C)(10)(a), TREES AND SHRUBS SHALL NOT BE PLANTED IN UTILITY EASEMENTS UNLESS THERE IS NO OTHER PRACTICABLE LOCATION ON THE LOT WHERE THE LANDSCAPING WOULD ACHIEVE ITS INTENDED
- 11. PURSUANT TO 5-6(C)(10)(b), TREES SHALL NOT BE PLANTED WITHIN 10' IN ANY DIRECTION OF THE CENTERLINE OF A SEWER OR WATER LINE.
- 12. CLEAR SIGHT TRIANGLE NOTE: LANDSCAPING, SIGNAGE, WALLS, FENCES, TREES, AND SHRUBBERIES BETWEEN 3' AND 8' TALL ( AS MEASURED FROM


THE GUTTER PAN) ARE NOT ALLOWED WITHIN THE CLEAR SIGHT TRIANGLE.


ARTICLE 9-12 AND PARTS 6-1-1 AND 6-6-2 OF ROA 1994 (POLLEN CONTROL WATER CONSERVATION, LANDSCAPING AND WATER WASTE, AND STREET TREES) AND SECTION 4 OF THE ALBUQUERQUE BERNALILLO COUNTY WATER AUTHORITY (ABCWUA) LEGISLATION AND ORDINANCES (WATER

WATER WASTE REDUCTION ORDINANCE) AS APPLICABLE\*."


# **IRRIGATION NOTES**

- ALL PLANTS WITHIN PUBLIC RIGHT-OF-WAY SHALL BE IRRIGATED BY BUBBLER IRRIGATION SYSTEM PER COA SPEC. ALL PLANTS WITHIN THE PUBLIC RIGHT-OF-WAY SHALL BE ZONED SEPARATELY FROM THE PLANTS WITHIN THE PROPERTY LINE.
- 2. ALL PLANTS WITHIN THE SITE, NOT IN THE PUBLIC RIGHT-OF-WAY, SHALL BE IRRIGATED WITH A DRIP IRRIGATION SYSTEM CONSISTING OF A REDUCED PRESSURE BACKFLOW PREVENTION DEVICE, MASTER VALVE, CONTROL VALVES, LOW FLOW POINT-SOURCE DRIP EMITTERS ON 3/4" POLY DRIP TUBING WITH FLUSH CAPS.
- 3. ALL SOD AREAS TO BE IRRIGATED WITH CONTROL VALVES, PVC LATERAL LINE TO PRESSURE COMPENSATING HEADS.
- 4. ALL IRRIGATION SHALL BE PERMANENT AND SHALL BE CONTROLLED BY AN
- AUTOMATIC IRRIGATION CONTROLLER. 5. PER 5-6(C)(14)(a), IRRIGATION SYSTEMS SHALL COMPLY WITH SECTION 8 OF THE ABCWUA LEGISLATION AND ORDINANCES (CROSS CONNECTION PREVENTION AND CONTROL ORDINANCE)
- 6. PER 5-6(C)(14)(b), ALL IRRIGATION SYSTEMS SHALL BE DESIGNED TO MINIMIZE THE USE OF WATER.
- 7. PER 5-6(C)(14)(c), ALL NON-RESIDENTIAL LANDSCAPE IRRIGATION SHALL HAVE AUTOMATIC TIMERS AND/OR PROGRAMMABLE SETTINGS TO AVOID OVERWATERING.
- 8. PER 5-6(C)(14)(d), THE IRRIGATION SYSTEM SHALL NOT SPRAY OR IRRIGATE IMPERVIOUS SURFACES, INCLUDING SIDEWALKS, DRIVEWAYS, DRIVE AISLES, STREETS, AND PARKING AND LOADING AREAS.

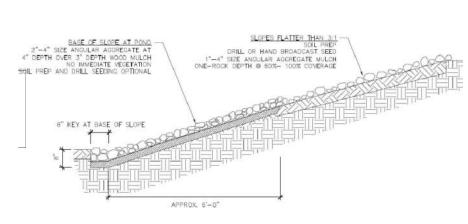


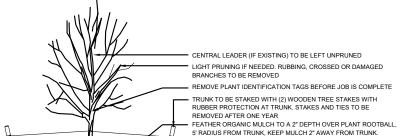


1 1013-SKL-1: POND SLOPES FLATTER THAN 3:1

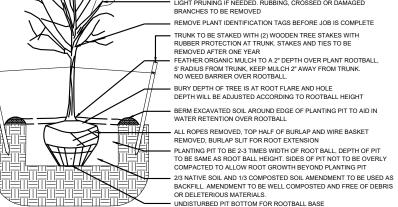

TREE PLANTING DETAIL

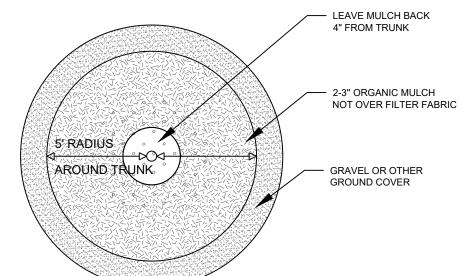

7 TREE DETAIL

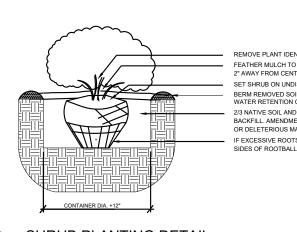


REMOVE PLANT IDENTIFICATION TAGS BEFORE JOB IS COMPLETE FEATHER MULCH TO A 2" DEPTH OVER PLANT ROOTBALL, KEEP MULCH 2" AWAY FROM CENTER OF SHRUB. NO WEED BARRIER OVER ROOTBALL SET SHRUB ON UNDISTURBED PIT BOTTOM PLUMB AND STRAIGHT BERM REMOVED SOIL AT EDGE OF PLANTING PIT TO AID IN WATER RETENTION OVER ROOTBALL 2/3 NATIVE SOIL AND 1/3 COMPOSTED SOIL AMENDMENT TO BE USED AS BACKFILL. AMENDMENT TO BE WELL COMPOSTED AND FREE OF DEBRIS OR DELETERIOUS MATERIALS. IF EXCESSIVE ROOTS ARE PRESENT ON ROOTBALL SCORE THE SIDES OF ROOTBALL TO DISCOURAGE ROOT CIRCLING

SHRUB PLANTING DETAIL

**YELLOWSTONE** 

www.yellowstonelandscape.com PO Box 10597 Albuquerque, NM 87184 505.898.9615 design@yellowstonelandscape.com

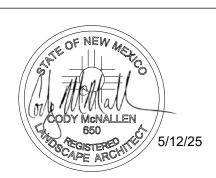


04/16//2025

05/12/2025

08/09/2024 Date: Revisions: 09/30/2024 02/11/2025

Drawn by: CC Reviewed by: CM

LL ∞  $\omega_{\infty}$ 

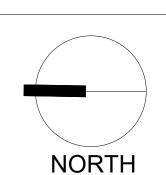


Albuquerq

Scale: 1" = 30'

**Sheet Title: Planting** Plan

**Sheet Number:** 

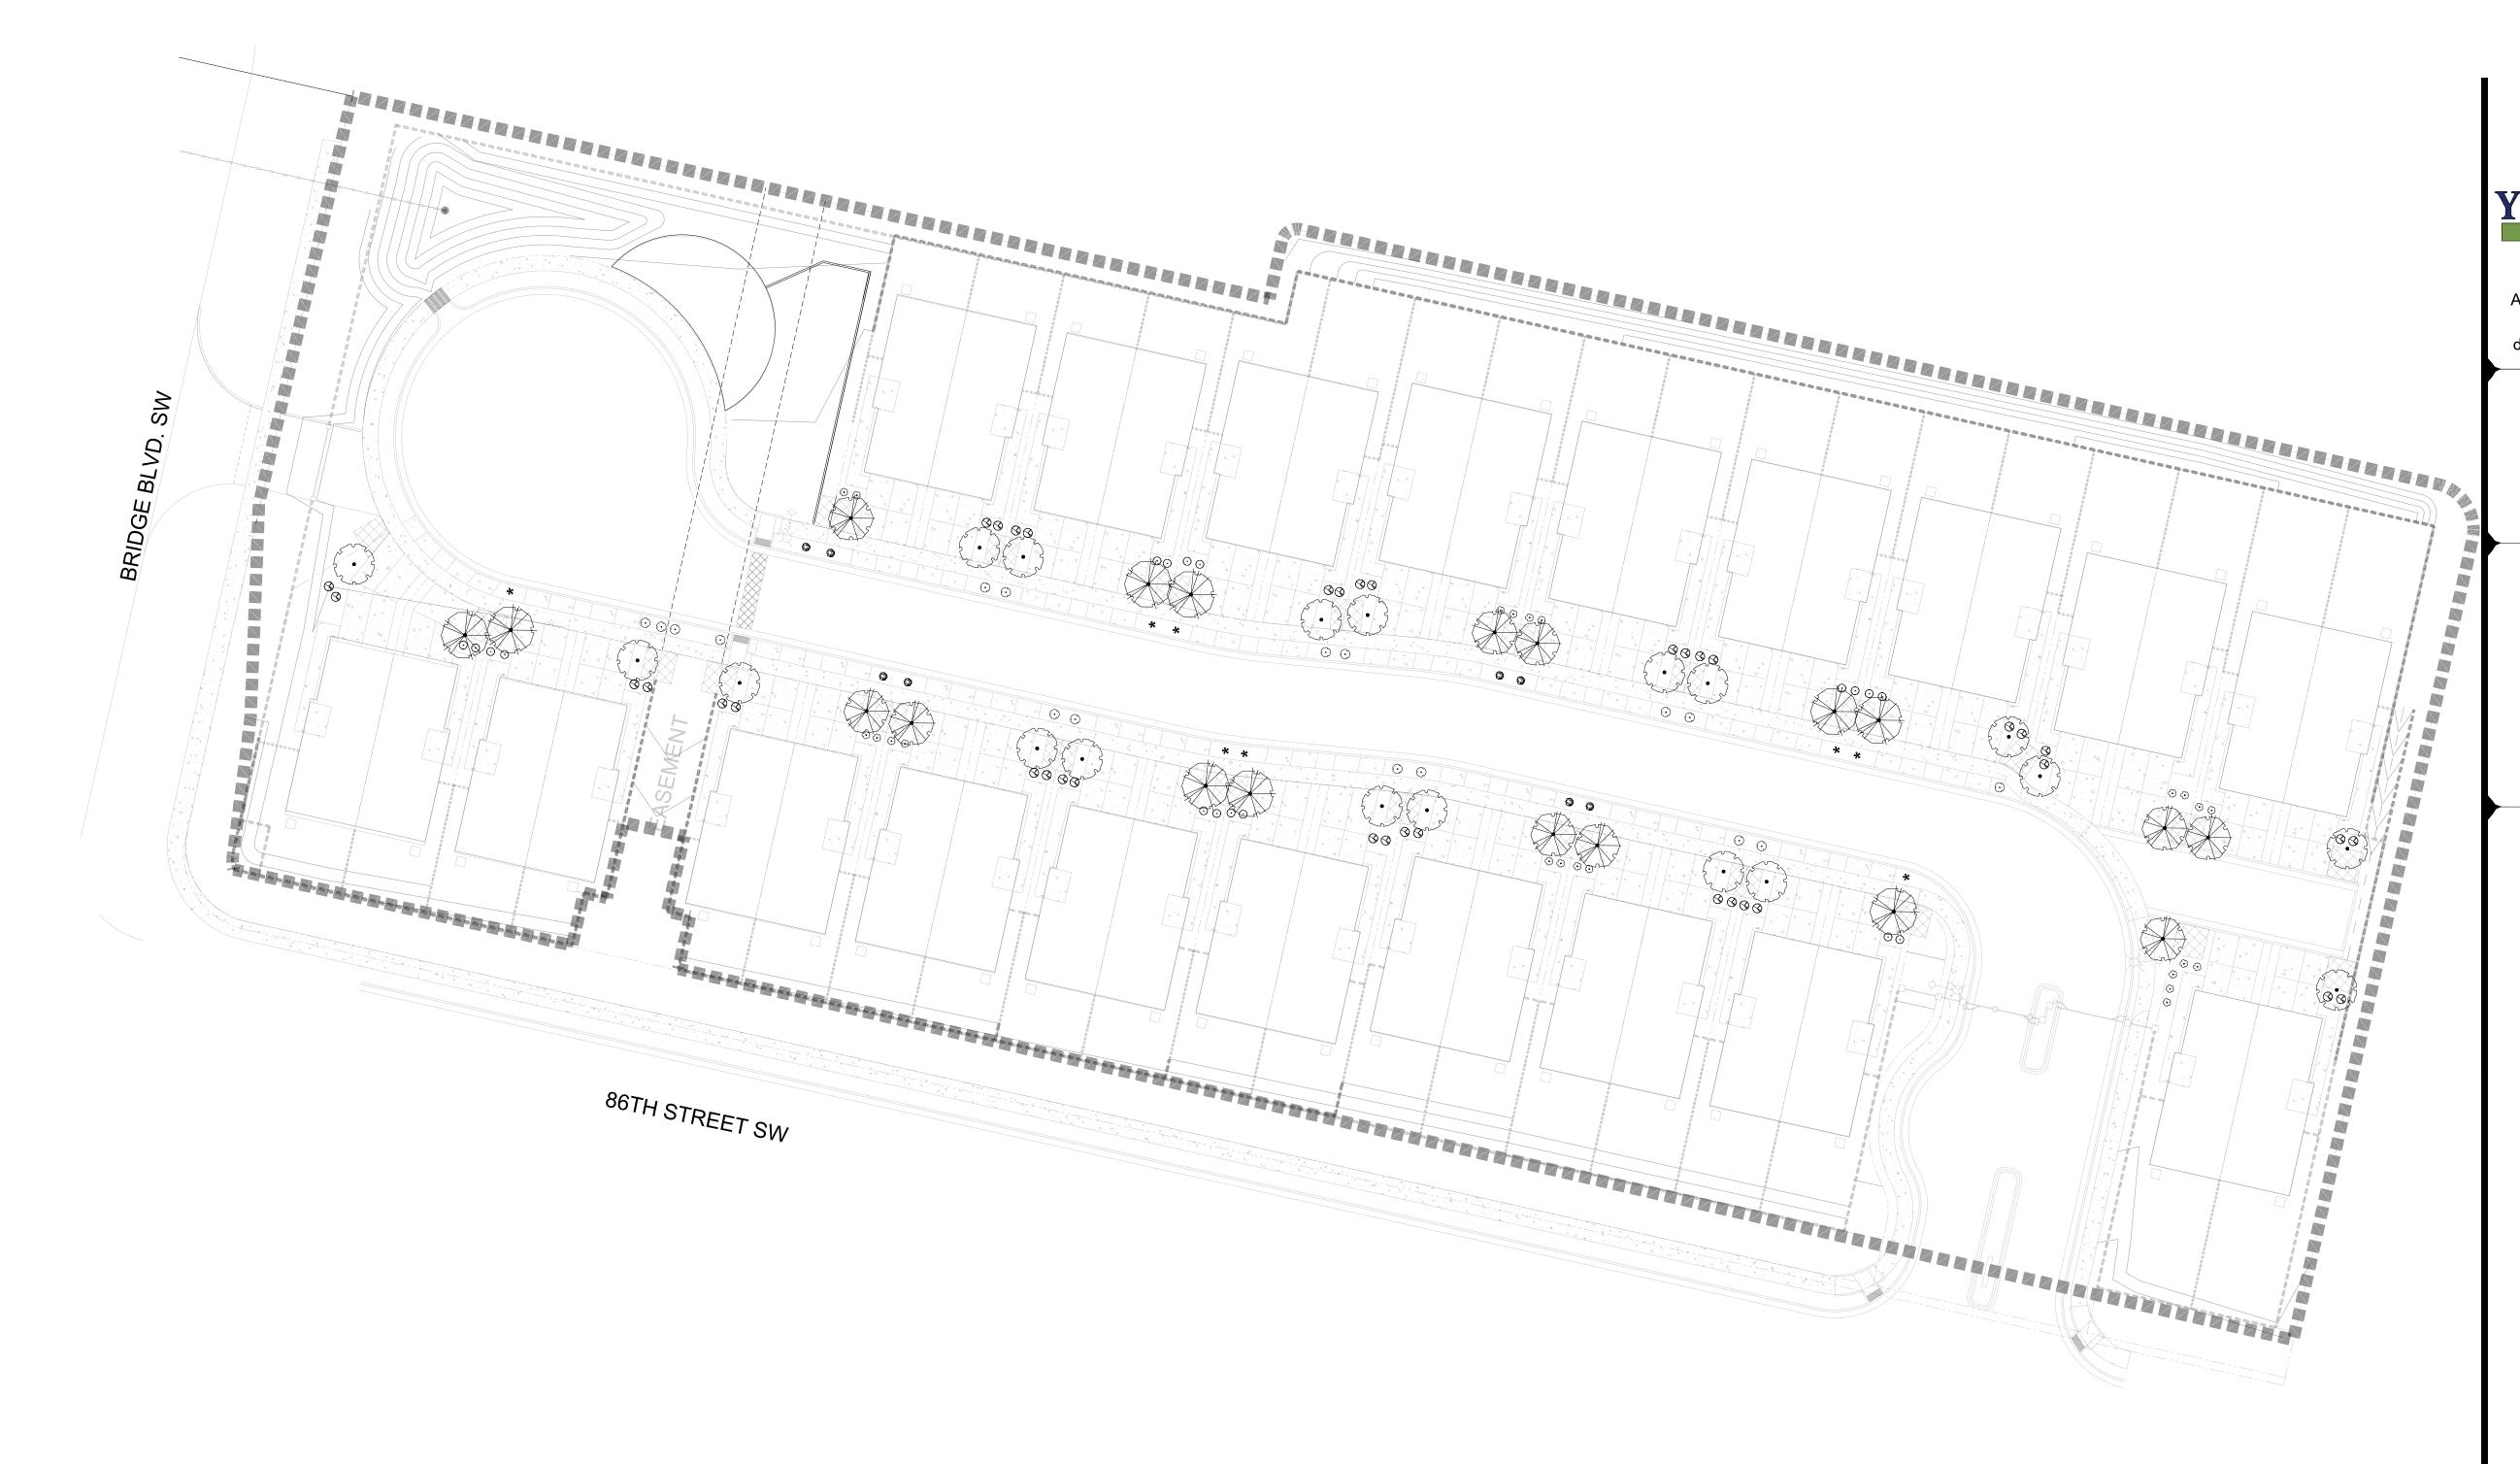

# PLANT SCHEDULE

SYMBOL	QTY	BOTANICAL / COMMON NAME	SIZE
DECIDUOL	JS TRE	<u>E</u>	
	10	CRATAEGUS CRUS-GALLI 'INERMIS' / THORNLESS HAWTHORN	2" B&B
	9	KOELREUTERIA PANICULATA / GOLDEN RAIN TREE	2" B&B
	19	PYRUS CALLERYANA 'CLEVELAND SELECT' / CLEVELAND SELECT PEAR	2" B&B
DECIDUOL	JS SHR	RUBS	
(·)	17	AMORPHA CANESCENS / LEADPLANT	5 GAL
	8	BERBERIS THUNBERGII 'CRIMSON PYGMY' / CRIMSON PYGMY BARBERRY	5 GAL
+	18	SALVIA GREGGII / AUTUMN SAGE CHERRY	1 GAL
	8	SALVIA GREGGII `ULTRAVIOLET` / ULTRAVIOLET AUTUMN SAGE	1 GAL
EVERGRE	EN SH	RUBS	
$\bigotimes$	38	RHAPHIOLEPIS INDICA / INDIAN HAWTHORN	5 GAL

SANTOLINA CHAMAECYPARISSUS / LAVENDER COTTON

# **GENERAL NOTES**

- 1. IN CASE OF DISCREPANCIES IN PLANT QUANTITIES SHOWN ON THE PLANT SCHEDULE AND THOSE SHOWN ON THE PLAN, THE QUANTITIES SHOWN ON THE PLAN SHALL PREVAIL. CONTRACTOR SHALL VERIFY ALL QUANTITIES PRIOR TO BID AND INSTALLATION.
- 2. POSITIVE DRAINAGE AWAY FROM ALL STRUCTURES SHALL BE PROVIDED TO THE LANDSCAPE CONTRACTOR AND SHALL BE MAINTAINED BY THE LANDSCAPE CONTRACTOR THROUGHOUT THE DURATION OF THE PROJECT.
- 3. GRADING OF THE SITE PER THE GRADING PLAN IS NOT INCLUDED IN THE SCOPE OF WORK OF THE LANDSCAPE CONTRACTOR. GRADES PER THE GRADING PLAN SHALL BE PROVIDED TO THE LANDSCAPE CONTRACTOR +/-1/10TH OF A FOOT, BY OTHERS.
- ALL MAINTENANCE OF THE LANDSCAPE AND IRRIGATION SYSTEMS SHALL BE PROVIDED BY OWNER. NO CONTRACTUAL MAINTENANCE SHALL BE INCLUDED UNLESS OTHERWISE SPECIFIED IN THE BIDDING DOCUMENTS.
   WATER MANAGEMENT IS THE SOLE RESPONSIBILITY OF THE PROPERTY OWNER. THE LANDSCAPE ARCHITECT IS NOT RESPONSIBLE FOR ANY
- RESTRICTIONS OF IRRIGATION WATER USE BY ANY GOVERNING BODY.

  6. PER 5-6(C)(9)(a), ALL PLANTING OF VEGETATED MATERIAL OR INSTALLATION OF ANY LANDSCAPING, BUFFERING, OR SCREENING MATERIAL IN THE PUBLIC RIGHT-OF-WAY SHALL REQUIRE THE PRIOR APPROVAL OF THE CITY. THE PROPERTY OWNER SHALL BE RESPONSIBLE FOR THE MAINTENANCE,
- REPAIRS, OR LIABILITY FOR ALL THE LANDSCAPING PLACED IN OR OVER THE PUBLIC RIGHT-OF-WAY.

  7. PER 5-6(C)(9)(b), ANY TREES THAT OVERHANG A PUBLIC SIDEWALK OR MAJOR PUBLIC OPEN SPACE SHALL BE TRIMMED TO MAINTAIN AN 8 FOOT CLEARANCE OVER THE SIDEWALK. ANY TREES THAT OVERHANG A PUBLIC STREET SHALL BE TRIMMED TO MAINTAIN A 9' CLEARANCE OVER THE
- STREET SURFACE.

  8. PURSUANT TO 5-6(C)(5)(e), BARK MULCH AREAS CLEARLY DELINEATED ON PLANS FOR LANDSCAPE AREAS AND 5' PADILIS RINGS AROUND TREES.
- PLANS FOR LANDSCAPE AREAS AND 5' RADIUS RINGS AROUND TREES.

  9. PURSUANT TO 5-6(C)(7)(a), ALL VEGETATION HAS BEEN LOCATED A MINIMUM OF 3' IN ANY DIRECTION FROM FIRE HYDRANTS, VALVE VAULTS, HOSE BIBS, MANHOLES, HYDRANTS AND FIRE DEPARTMENT CONNECTIONS.
- 10. PURSUANT TO 5-6(C)(10)(a), TREES AND SHRUBS SHALL NOT BE PLANTED IN UTILITY EASEMENTS UNLESS THERE IS NO OTHER PRACTICABLE LOCATION ON THE LOT WHERE THE LANDSCAPING WOULD ACHIEVE ITS INTENDED PURPOSE.
- 11. PURSUANT TO 5-6(C)(10)(b), TREES SHALL NOT BE PLANTED WITHIN 10' IN ANY DIRECTION OF THE CENTERLINE OF A SEWER OR WATER LINE.
- 12. CLEAR SIGHT TRIANGLE NOTE: LANDSCAPING, SIGNAGE, WALLS, FENCES, TREES, AND SHRUBBERIES BETWEEN 3' AND 8' TALL ( AS MEASURED FROM THE GUTTER PAN) ARE NOT ALLOWED WITHIN THE CLEAR SIGHT TRIANGLE.

# GENERAL NOTES CONT.


ALL PLANTS CHOSEN ARE PART OF THE ABQ PLANT PALLET LIST..
 POLLEN CONTROL, WATER CONSERVATION AND STREET TREES:
 PURSUANT TO IDO 5-6 (C)(4)(G) ALL VEGITATION SHALL COMPLY WITH
 ARTICLE 9-12 AND PARTS 6-1-1 AND 6-6-2 OF ROA 1994 (POLLEN CONTROL,
 WATER CONSERVATION, LANDSCAPING AND WATER WASTE, AND STREET
 TREES) AND SECTION 4 OF THE ALBUQUERQUE BERNALILLO COUNTY
 WATER AUTHORITY (ABCWUA) LEGISLATION AND ORDINANCES (WATER

WATER WASTE REDUCTION ORDINANCE) AS APPLICABLE\*."


# **IRRIGATION NOTES**

- ALL PLANTS WITHIN PUBLIC RIGHT-OF-WAY SHALL BE IRRIGATED BY BUBBLER IRRIGATION SYSTEM PER COA SPEC. ALL PLANTS WITHIN THE PUBLIC RIGHT-OF-WAY SHALL BE ZONED SEPARATELY FROM THE PLANTS WITHIN THE PROPERTY LINE.
- 2. ALL PLANTS WITHIN THE SITE, NOT IN THE PUBLIC RIGHT-OF-WAY, SHALL BE IRRIGATED WITH A DRIP IRRIGATION SYSTEM CONSISTING OF A REDUCED PRESSURE BACKFLOW PREVENTION DEVICE, MASTER VALVE, CONTROL VALVES, LOW FLOW POINT-SOURCE DRIP EMITTERS ON 3/4" POLY DRIP TUBING WITH FLUSH CAPS.
- 3. ALL SOD AREAS TO BE IRRIGATED WITH CONTROL VALVES, PVC LATERAL LINE TO PRESSURE COMPENSATING HEADS.
- 4. ALL IRRIGATION SHALL BE PERMANENT AND SHALL BE CONTROLLED BY AN
- AUTOMATIC IRRIGATION CONTROLLER.


  5. PER 5-6(C)(14)(a), IRRIGATION SYSTEMS SHALL COMPLY WITH SECTION 8 OF THE ABCWUA LEGISLATION AND ORDINANCES (CROSS CONNECTION PREVENTION AND CONTROL ORDINANCE)
- 6. PER 5-6(C)(14)(b), ALL IRRIGATION SYSTEMS SHALL BE DESIGNED TO MINIMIZE THE USE OF WATER.
- 7. PER 5-6(C)(14)(c), ALL NON-RESIDENTIAL LANDSCAPE IRRIGATION SHALL HAVE AUTOMATIC TIMERS AND/OR PROGRAMMABLE SETTINGS TO AVOID OVERWATERING.
- 8. PER 5-6(C)(14)(d), THE IRRIGATION SYSTEM SHALL NOT SPRAY OR IRRIGATE IMPERVIOUS SURFACES, INCLUDING SIDEWALKS, DRIVEWAYS, DRIVE AISLES, STREETS, AND PARKING AND LOADING AREAS.

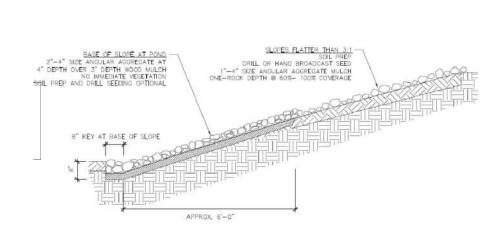




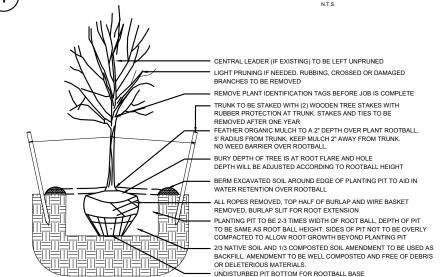

TREE PLANTING DETAIL

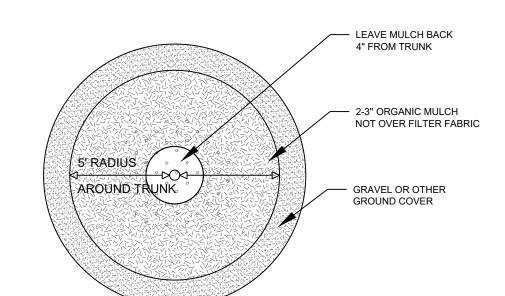

7 TREE DETAIL

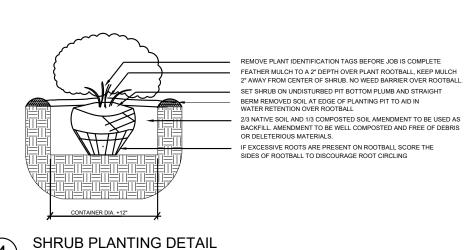

YELLOWSTONE

LANDSCAPE

www.yellowstonelandscape.com

POBox 10597

Albuquerque, NM 87184

505.898.9615

design@yellowstonelandscape.com




05/12/2025

New Mexico

Albuquerque

Drawn by: <u>CC</u> Reviewed by: <u>CM</u>

> allo Partners 86th & Bridge

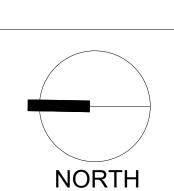


Scale: 1" = 30

7.5 0 15 30

Sheet Title:
Interior
Planting Plan

**Sheet Number:** 

LP-02

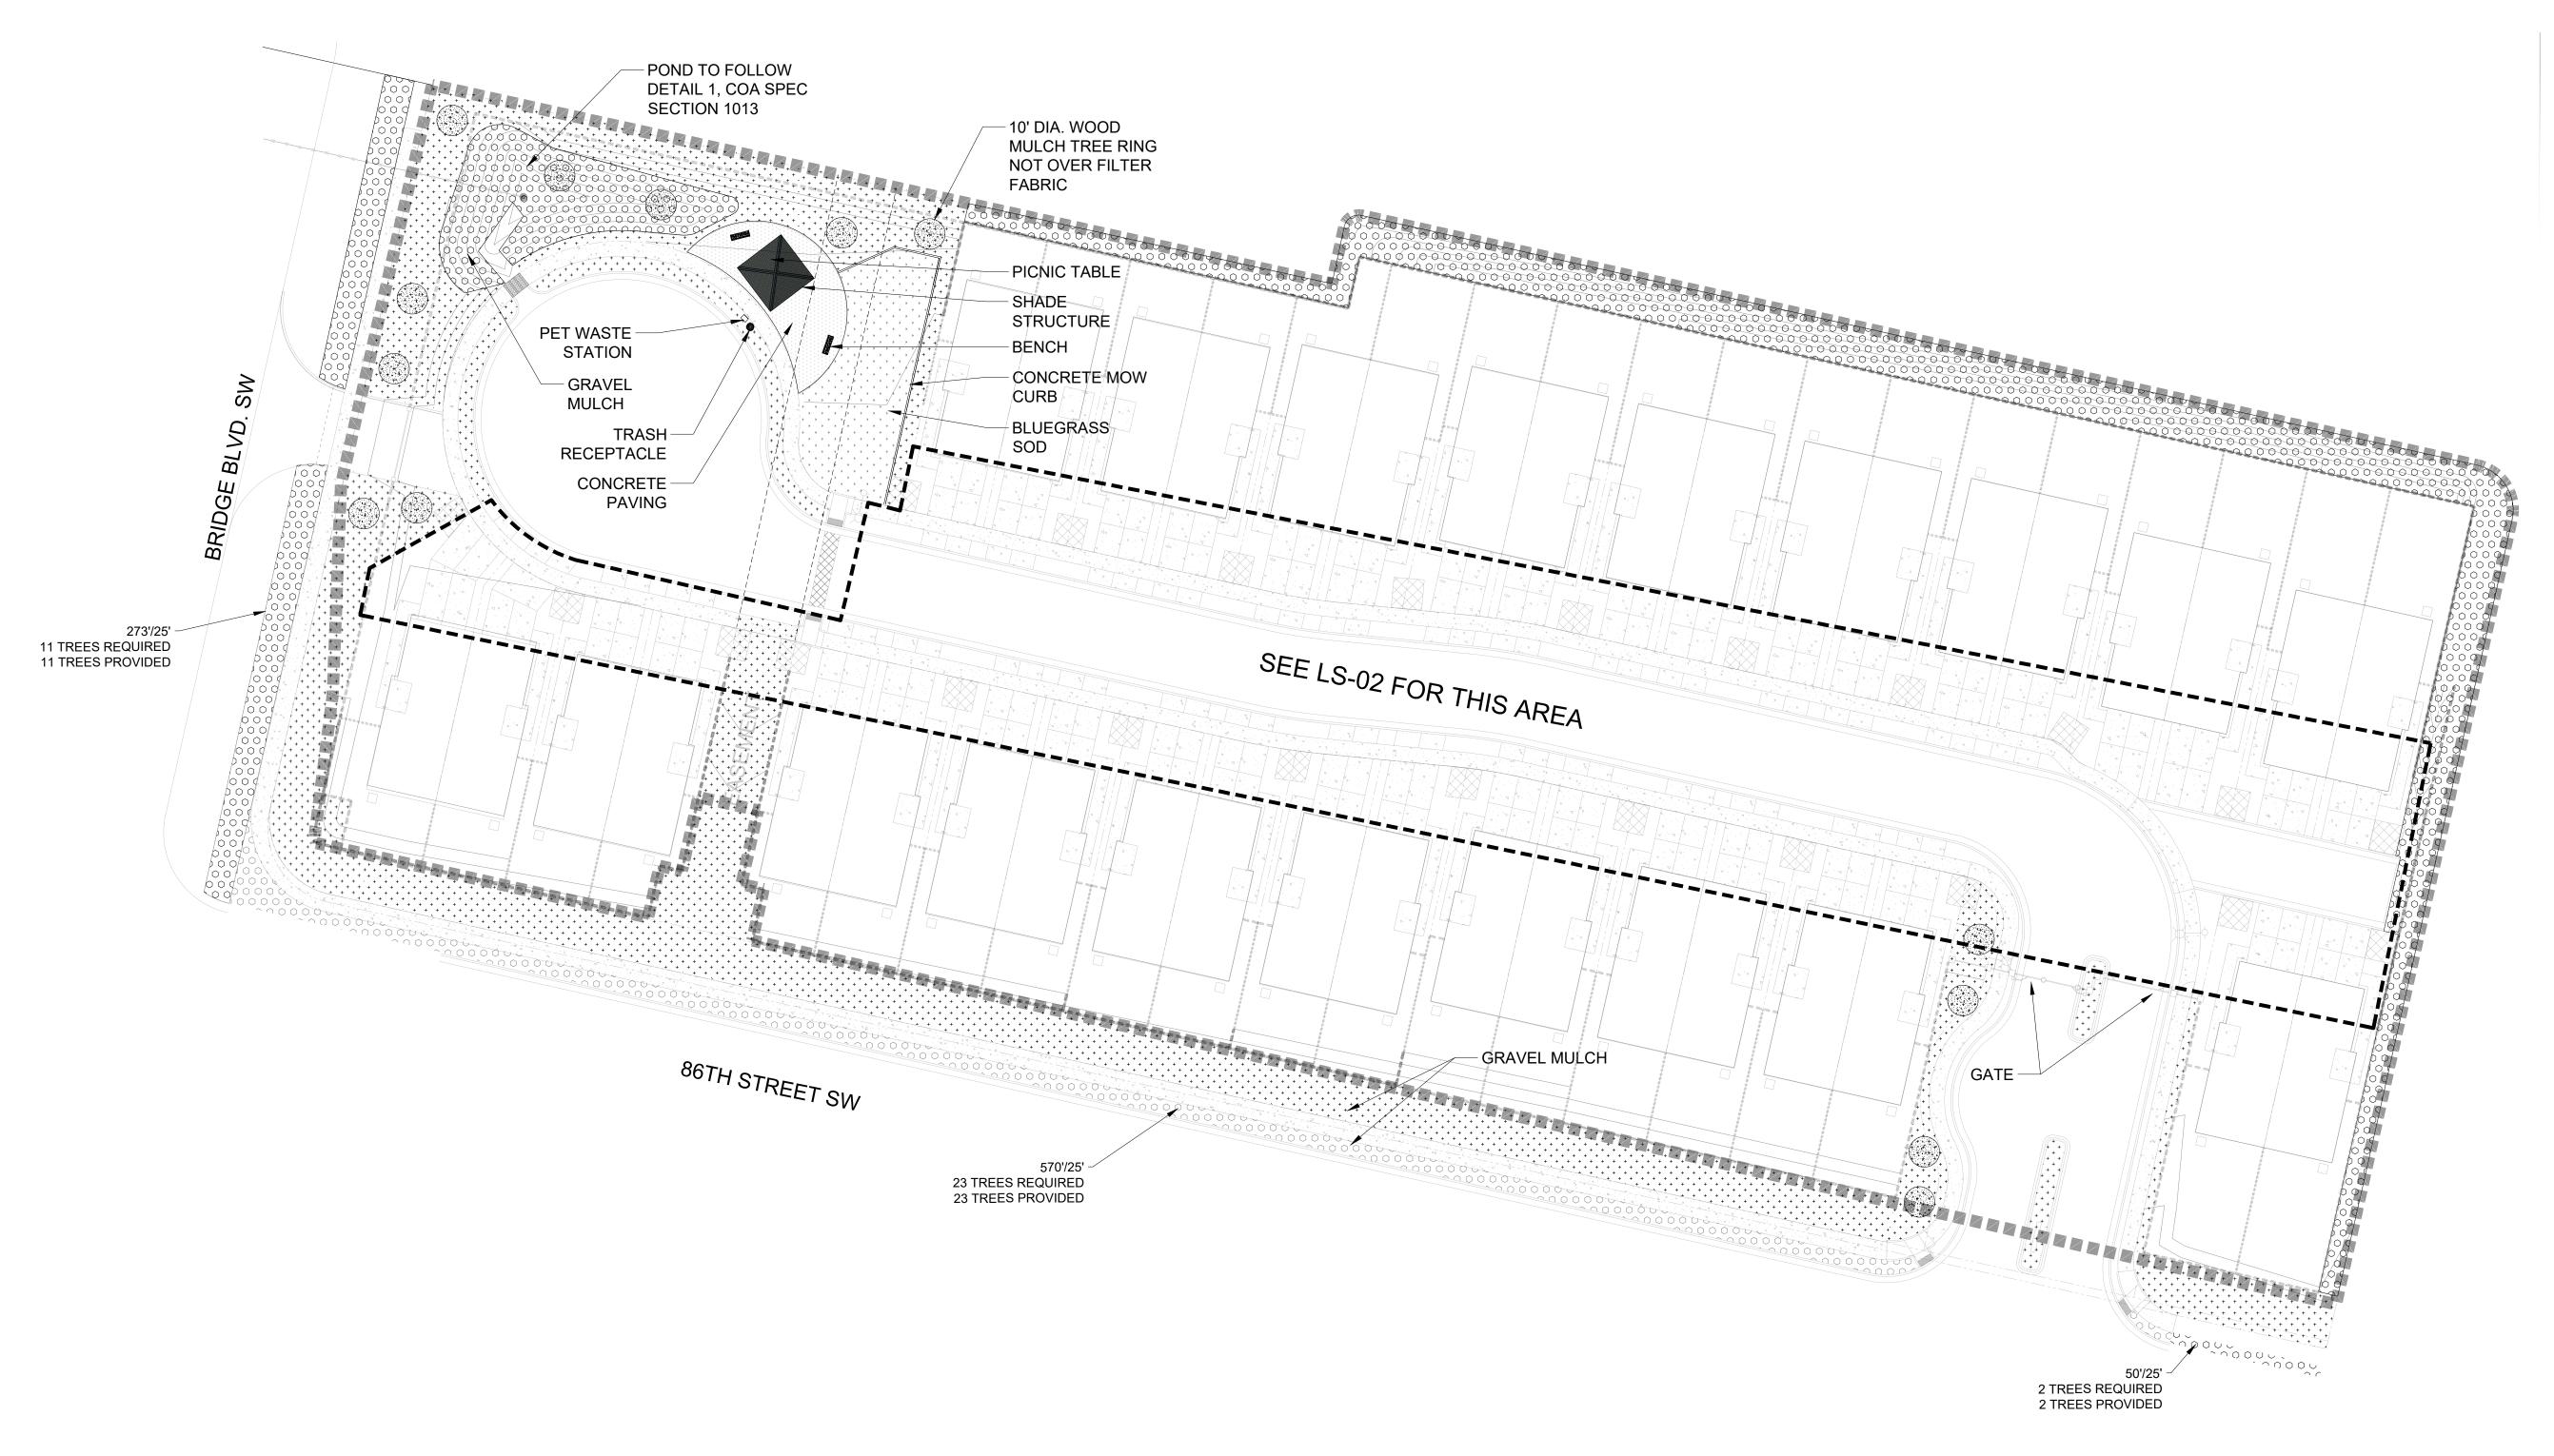

# MATERIAL SCHEDULE

SYMBOL	DESCRIPTION	
* * * * * * * * * * * * * * * * * * *	1.5" AMARETTO GRAVEL MULCH 3" DEPTH OVER FILTER FABRIC	
	2"-4" MOUNTAINAIR BLUSH/NATIVE MULCH 4" DEPTH OVER FILTER FABRIC	
,	BLUEGRASS SOD 9 % OF LANDSCAPE AREA	
	WOOD MULCH WITH NO FILTER FABRIC	
	CONCRETE PAVING LIGHT BROOM FINISH	
	ANOVA LI441 - 6 FT CONTOUR BENCH WITH STEEL SLAT SEAT AND CAST IRON PORTABLE / SURFACE MOUNT LEGS FRAME: BRONZE TEXTURE COATED SEAT: SAGE GLOSS, TEXTURE COATED	
	ANOVA L1448 - 46IN DIAMETER STEEL TABLE WITH FOUR FLAT SEATS. PORTABLE / SURFACE MOUNT FRAME: SAGE GLOSS TABLE TOP: BRONZE TEXTURE COATED SEAT: BRONZE TEXTURE	2
	ANOVA L2040AT-40 GALLON STEEL SLAT RECEPTACLE WITH FRENCH DOORS. BONNET ASH TOP, PLASTIC LINER AND RUBBER FEET. RECEPTACLE: BRONZE TEXTURE COATED	1
	PET WASTE STATION	1

18'X18' SHADE STRUCTURE

# **IRRIGATION NOTES**

- 1. ALL PLANTS WITHIN PUBLIC RIGHT-OF-WAY SHALL BE IRRIGATED BY BUBBLER IRRIGATION SYSTEM PER COA SPEC. ALL PLANTS WITHIN THE PUBLIC RIGHT-OF-WAY SHALL BE ZONED SEPARATELY FROM THE PLANTS
- WITHIN THE PROPERTY LINE. 2. ALL PLANTS WITHIN THE SITE, NOT IN THE PUBLIC RIGHT-OF-WAY, SHALL BE IRRIGATED WITH A DRIP IRRIGATION SYSTEM CONSISTING OF A REDUCED PRESSURE BACKFLOW PREVENTION DEVICE, MASTER VALVE, CONTROL VALVES, LOW FLOW POINT-SOURCE DRIP EMITTERS ON 3/4" POLY DRIP TUBING WITH FLUSH CAPS.
- 3. ALL SOD AREAS TO BE IRRIGATED WITH CONTROL VALVES, PVC LATERAL LINE TO PRESSURE COMPENSATING HEADS.
- 4. ALL IRRIGATION SHALL BE PERMANENT AND SHALL BE CONTROLLED BY AN AUTOMATIC IRRIGATION CONTROLLER.
- 5. PER 5-6(C)(14)(a), IRRIGATION SYSTEMS SHALL COMPLY WITH SECTION 8 OF THE ABCWUA LEGISLATION AND ORDINANCES (CROSS CONNECTION PREVENTION AND CONTROL ORDINANCE)
- 6. PER 5-6(C)(14)(b), ALL IRRIGATION SYSTEMS SHALL BE DESIGNED TO MINIMIZE THE USE OF WATER.
- 7. PER 5-6(C)(14)(c), ALL NON-RESIDENTIAL LANDSCAPE IRRIGATION SHALL HAVE AUTOMATIC TIMERS AND/OR PROGRAMMABLE SETTINGS TO AVOID OVERWATERING.
- 8. PER 5-6(C)(14)(d), THE IRRIGATION SYSTEM SHALL NOT SPRAY OR IRRIGATE IMPERVIOUS SURFACES, INCLUDING SIDEWALKS, DRIVEWAYS, DRIVE AISLES, STREETS, AND PARKING AND LOADING AREAS.

# **GENERAL NOTES**

- 1. IN CASE OF DISCREPANCIES IN PLANT QUANTITIES SHOWN ON THE PLANT SCHEDULE AND THOSE SHOWN ON THE PLAN, THE QUANTITIES SHOWN ON THE PLAN SHALL PREVAIL. CONTRACTOR SHALL VERIFY ALL QUANTITIES PRIOR TO BID AND INSTALLATION.
- 2. POSITIVE DRAINAGE AWAY FROM ALL STRUCTURES SHALL BE PROVIDED TO THE LANDSCAPE CONTRACTOR AND SHALL BE MAINTAINED BY THE LANDSCAPE CONTRACTOR THROUGHOUT THE DURATION OF THE PROJECT.
- 3. GRADING OF THE SITE PER THE GRADING PLAN IS NOT INCLUDED IN THE SCOPE OF WORK OF THE LANDSCAPE CONTRACTOR. GRADES PER THE GRADING PLAN SHALL BE PROVIDED TO THE LANDSCAPE CONTRACTOR +/-1/10TH OF A FOOT, BY OTHERS.
- 4. ALL MAINTENANCE OF THE LANDSCAPE AND IRRIGATION SYSTEMS SHALL BE PROVIDED BY OWNER. NO CONTRACTUAL MAINTENANCE SHALL BE
- INCLUDED UNLESS OTHERWISE SPECIFIED IN THE BIDDING DOCUMENTS WATER MANAGEMENT IS THE SOLE RESPONSIBILITY OF THE PROPERTY OWNER. THE LANDSCAPE ARCHITECT IS NOT RESPONSIBLE FOR ANY RESTRICTIONS OF IRRIGATION WATER USE BY ANY GOVERNING BODY.
- 6. PER 5-6(C)(9)(a), ALL PLANTING OF VEGETATED MATERIAL OR INSTALLATION OF ANY LANDSCAPING, BUFFERING, OR SCREENING MATERIAL IN THE PUBLIC RIGHT-OF-WAY SHALL REQUIRE THE PRIOR APPROVAL OF THE CITY. THE PROPERTY OWNER SHALL BE RESPONSIBLE FOR THE MAINTENANCE, REPAIRS, OR LIABILITY FOR ALL THE LANDSCAPING PLACED IN OR OVER
- THE PUBLIC RIGHT-OF-WAY. 7. PER 5-6(C)(9)(b), ANY TREES THAT OVERHANG A PUBLIC SIDEWALK OR MAJOR PUBLIC OPEN SPACE SHALL BE TRIMMED TO MAINTAIN AN 8 FOOT CLEARANCE OVER THE SIDEWALK. ANY TREES THAT OVERHANG A PUBLIC STREET SHALL BE TRIMMED TO MAINTAIN A 9' CLEARANCE OVER THE STREET SURFACE.
- 8. PURSUANT TO 5-6(C)(5)(e), BARK MULCH AREAS CLEARLY DELINEATED ON
- PLANS FOR LANDSCAPE AREAS AND 5' RADIUS RINGS AROUND TREES. 9. PURSUANT TO 5-6(C)(7)(a), ALL VEGETATION HAS BEEN LOCATED A MINIMUM OF 3' IN ANY DIRECTION FROM FIRE HYDRANTS, VALVE VAULTS, HOSE BIBS,
- MANHOLES, HYDRANTS AND FIRE DEPARTMENT CONNECTIONS. 10. PURSUANT TO 5-6(C)(10)(a), TREES AND SHRUBS SHALL NOT BE PLANTED IN UTILITY EASEMENTS UNLESS THERE IS NO OTHER PRACTICABLE LOCATION ON THE LOT WHERE THE LANDSCAPING WOULD ACHIEVE ITS INTENDED PURPOSE.
- 11. PURSUANT TO 5-6(C)(10)(b), TREES SHALL NOT BE PLANTED WITHIN 10' IN ANY DIRECTION OF THE CENTERLINE OF A SEWER OR WATER LINE. 12. CLEAR SIGHT TRIANGLE NOTE: LANDSCAPING, SIGNAGE, WALLS, FENCES,

TREES, AND SHRUBBERIES BETWEEN 3' AND 8' TALL ( AS MEASURED FROM THE GUTTER PAN) ARE NOT ALLOWED WITHIN THE CLEAR SIGHT TRIANGLE.

# **GENERAL NOTES CONT**


13. ALL PLANTS CHOSEN ARE PART OF THE ABQ PLANT PALLET LIST. 14. POLLEN CONTROL, WATER CONSERVATION AND STREET TREES:

WATER WASTE REDUCTION ORDINANCE) AS APPLICABLE\*."

PURSUANT TO IDO 5-6 (C)(4)(G) ALL VEGITATION SHALL COMPLY WITH ARTICLE 9-12 AND PARTS 6-1-1 AND 6-6-2 OF ROA 1994 (POLLEN CONTROL, WATER CONSERVATION, LANDSCAPING AND WATER WASTE, AND STREET TREES) AND SECTION 4 OF THE ALBUQUERQUE BERNALILLO COUNTY WATER AUTHORITY (ABCWUA) LEGISLATION AND ORDINANCES (WATER

# YELLOWSTONE www.yellowstonelandscape.com

PO Box 10597 Albuquerque, NM 87184 505.898.9615 design@yellowstonelandscape.com

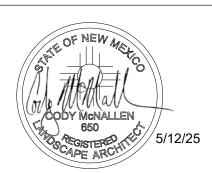


09/30/2024 Revisions: 04/18/2025 05/12/2025


Drawn by: CC

Reviewed by: CM

\∞

Albuquerque

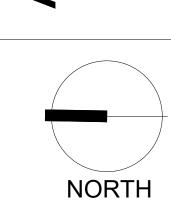


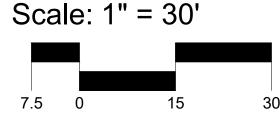

Sheet Title: Materials

Sheet Number:

Plan

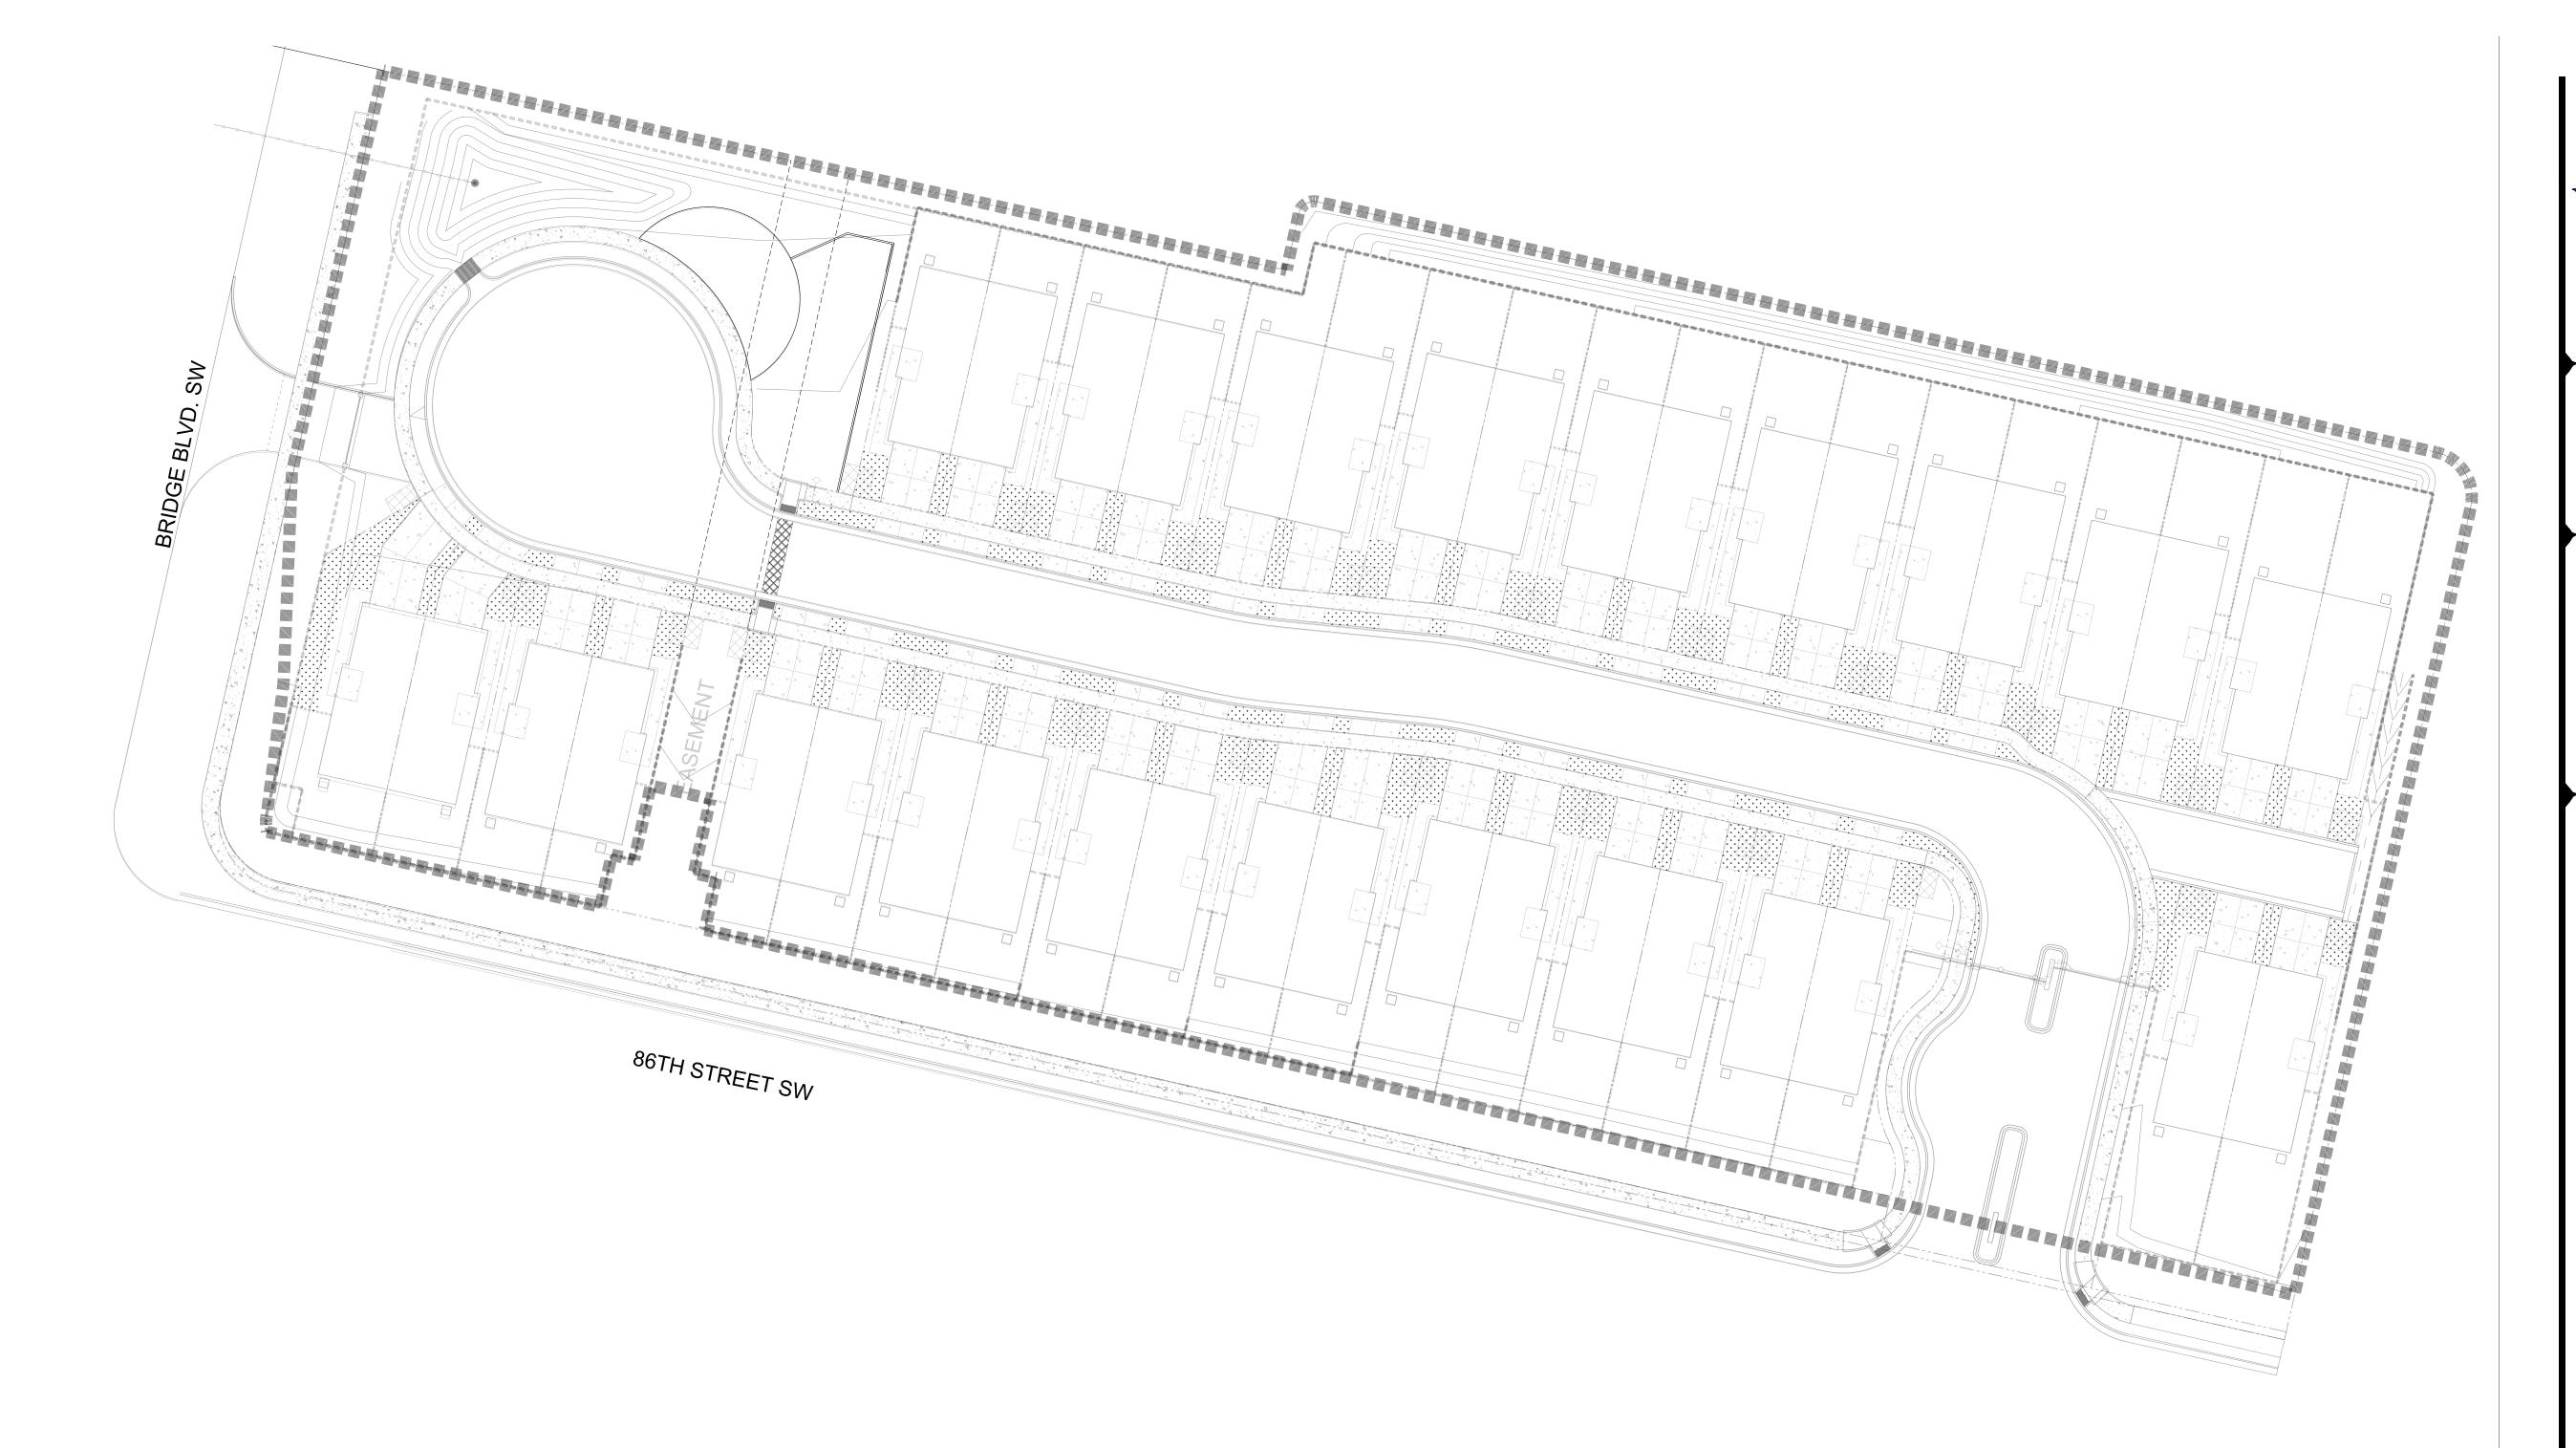

# **IRRIGATION NOTES**

- 1. ALL PLANTS WITHIN PUBLIC RIGHT-OF-WAY SHALL BE IRRIGATED BY BUBBLER IRRIGATION SYSTEM PER COA SPEC. ALL PLANTS WITHIN THE PUBLIC RIGHT-OF-WAY SHALL BE ZONED SEPARATELY FROM THE PLANTS WITHIN THE PROPERTY LINE.
- PRESSURE BACKFLOW PREVENTION DEVICE, MASTER VALVE, CONTROL VALVES, LOW FLOW POINT-SOURCE DRIP EMITTERS ON 3/4" POLY DRIP TUBING WITH FLUSH CAPS. 3. ALL SOD AREAS TO BE IRRIGATED WITH CONTROL VALVES, PVC LATERAL

2. ALL PLANTS WITHIN THE SITE, NOT IN THE PUBLIC RIGHT-OF-WAY, SHALL BE

IRRIGATED WITH A DRIP IRRIGATION SYSTEM CONSISTING OF A REDUCED

- LINE TO PRESSURE COMPENSATING HEADS.
- 4. ALL IRRIGATION SHALL BE PERMANENT AND SHALL BE CONTROLLED BY AN AUTOMATIC IRRIGATION CONTROLLER.

PREVENTION AND CONTROL ORDINANCE)

- 5. PER 5-6(C)(14)(a), IRRIGATION SYSTEMS SHALL COMPLY WITH SECTION 8 OF THE ABCWUA LEGISLATION AND ORDINANCES (CROSS CONNECTION
- 6. PER 5-6(C)(14)(b), ALL IRRIGATION SYSTEMS SHALL BE DESIGNED TO MINIMIZE THE USE OF WATER.
- 7. PER 5-6(C)(14)(c), ALL NON-RESIDENTIAL LANDSCAPE IRRIGATION SHALL HAVE AUTOMATIC TIMERS AND/OR PROGRAMMABLE SETTINGS TO AVOID OVERWATERING.
- 8. PER 5-6(C)(14)(d), THE IRRIGATION SYSTEM SHALL NOT SPRAY OR IRRIGATE IMPERVIOUS SURFACES, INCLUDING SIDEWALKS, DRIVEWAYS, DRIVE AISLES, STREETS, AND PARKING AND LOADING AREAS.

# **GENERAL NOTES**

- 1. IN CASE OF DISCREPANCIES IN PLANT QUANTITIES SHOWN ON THE PLANT SCHEDULE AND THOSE SHOWN ON THE PLAN, THE QUANTITIES SHOWN ON THE PLAN SHALL PREVAIL. CONTRACTOR SHALL VERIFY ALL QUANTITIES PRIOR TO BID AND INSTALLATION.
- 2. POSITIVE DRAINAGE AWAY FROM ALL STRUCTURES SHALL BE PROVIDED TO THE LANDSCAPE CONTRACTOR AND SHALL BE MAINTAINED BY THE LANDSCAPE CONTRACTOR THROUGHOUT THE DURATION OF THE PROJECT.
- 3. GRADING OF THE SITE PER THE GRADING PLAN IS NOT INCLUDED IN THE SCOPE OF WORK OF THE LANDSCAPE CONTRACTOR. GRADES PER THE GRADING PLAN SHALL BE PROVIDED TO THE LANDSCAPE CONTRACTOR +/-1/10TH OF A FOOT, BY OTHERS.
- 4. ALL MAINTENANCE OF THE LANDSCAPE AND IRRIGATION SYSTEMS SHALL BE PROVIDED BY OWNER. NO CONTRACTUAL MAINTENANCE SHALL BE
- INCLUDED UNLESS OTHERWISE SPECIFIED IN THE BIDDING DOCUMENTS 5. WATER MANAGEMENT IS THE SOLE RESPONSIBILITY OF THE PROPERTY OWNER. THE LANDSCAPE ARCHITECT IS NOT RESPONSIBLE FOR ANY RESTRICTIONS OF IRRIGATION WATER USE BY ANY GOVERNING BODY.
- 6. PER 5-6(C)(9)(a), ALL PLANTING OF VEGETATED MATERIAL OR INSTALLATION OF ANY LANDSCAPING, BUFFERING, OR SCREENING MATERIAL IN THE PUBLIC RIGHT-OF-WAY SHALL REQUIRE THE PRIOR APPROVAL OF THE CITY. THE PROPERTY OWNER SHALL BE RESPONSIBLE FOR THE MAINTENANCE, REPAIRS, OR LIABILITY FOR ALL THE LANDSCAPING PLACED IN OR OVER
- THE PUBLIC RIGHT-OF-WAY. 7. PER 5-6(C)(9)(b), ANY TREES THAT OVERHANG A PUBLIC SIDEWALK OR MAJOR PUBLIC OPEN SPACE SHALL BE TRIMMED TO MAINTAIN AN 8 FOOT CLEARANCE OVER THE SIDEWALK. ANY TREES THAT OVERHANG A PUBLIC STREET SHALL BE TRIMMED TO MAINTAIN A 9' CLEARANCE OVER THE STREET SURFACE.
- 8. PURSUANT TO 5-6(C)(5)(e), BARK MULCH AREAS CLEARLY DELINEATED ON
- PLANS FOR LANDSCAPE AREAS AND 5' RADIUS RINGS AROUND TREES. 9. PURSUANT TO 5-6(C)(7)(a), ALL VEGETATION HAS BEEN LOCATED A MINIMUM OF 3' IN ANY DIRECTION FROM FIRE HYDRANTS, VALVE VAULTS, HOSE BIBS,
- MANHOLES, HYDRANTS AND FIRE DEPARTMENT CONNECTIONS. 10. PURSUANT TO 5-6(C)(10)(a), TREES AND SHRUBS SHALL NOT BE PLANTED IN UTILITY EASEMENTS UNLESS THERE IS NO OTHER PRACTICABLE LOCATION ON THE LOT WHERE THE LANDSCAPING WOULD ACHIEVE ITS INTENDED PURPOSE.
- 11. PURSUANT TO 5-6(C)(10)(b), TREES SHALL NOT BE PLANTED WITHIN 10' IN ANY DIRECTION OF THE CENTERLINE OF A SEWER OR WATER LINE.
- 12. CLEAR SIGHT TRIANGLE NOTE: LANDSCAPING, SIGNAGE, WALLS, FENCES, TREES, AND SHRUBBERIES BETWEEN 3' AND 8' TALL ( AS MEASURED FROM THE GUTTER PAN) ARE NOT ALLOWED WITHIN THE CLEAR SIGHT TRIANGLE.

# **GENERAL NOTES CONT**


- 13. ALL PLANTS CHOSEN ARE PART OF THE ABQ PLANT PALLET LIST.
- 14. POLLEN CONTROL, WATER CONSERVATION AND STREET TREES: PURSUANT TO IDO 5-6 (C)(4)(G) ALL VEGITATION SHALL COMPLY WITH ARTICLE 9-12 AND PARTS 6-1-1 AND 6-6-2 OF ROA 1994 (POLLEN CONTROL, WATER CONSERVATION, LANDSCAPING AND WATER WASTE, AND STREET TREES) AND SECTION 4 OF THE ALBUQUERQUE BERNALILLO COUNTY WATER AUTHORITY (ABCWUA) LEGISLATION AND ORDINANCES (WATER WATER WASTE REDUCTION ORDINANCE) AS APPLICABLE\*."

# MATERIAL SCHEDULE

1.5" AMARETTO GRAVEL MULCH



505.898.9615 design@yellowstonelandscape.com

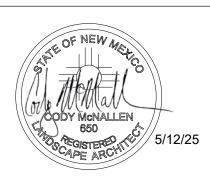


Date: <u>09/30/2024</u> Revisions: 05/12/2025


Drawn by: CC

Reviewed by: CM

me \∞

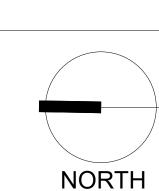

**Albuquerq** 

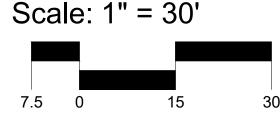

Sheet Title:


Interior Materials Plan

Sheet Number:

-		
SYMBOL	MANUFACTURER/MODEL/DESCRIPTION	<u>QTY</u>
2000	HUNTER MP2000 - TURF ROTATOR PROS-04-PRS40-CV, 4IN. POP-UP WITH FACTORY INSTALLED CHECK VALVE, PRESSURE REGULATED TO 40 PSI, MP ROTATOR NOZZLE ON PRS40 BODY.	13
3000	HUNTER MP3000 - TURF ROTATOR PROS-04-PRS40-CV, 4IN. POP-UP WITH FACTORY INSTALLED CHECK VALVE, PRESSURE REGULATED TO 40 PSI, MP ROTATOR NOZZLE ON PRS40 BODY.	1
→         →         →            40           402          404	RAIN BIRD 1800-1400 FLOOD FIXED FLOW RATE 0.25 GPM - 2.0 GPM, FULL CIRCLE BUBBLER, 1/2IN. FIPT.	108
SYMBOL	MANUFACTURER/MODEL/DESCRIPTION	QTY
M	DRIP CONTROL VALVE - SHRUB RAIN BIRD XCZ-100-PRF, MEDIUM FLOW DRIP CONTROL KIT, 1IN. DV VALVE, 1IN. PRESSURE REGULATING FILTER, 40PSI PRESSURE REGULATOR. 5 GPM-20 GPM.	2
	DRIP CONTROL VALVE - TREE RAIN BIRD XCZ-100-PRF. MEDIUM FLOW DRIP CONTROL KIT, 1IN. DV VALVE, 1IN. PRESSURE REGULATING FILTER, 40PSI PRESSURE REGULATOR. 3 GPM-15 GPM.	1
⟨ <b>F</b> ⟩	FLUSH CAP NDS CEP900	12
	DRIP EMITTER - SHRUB (2) NDS TAE 20 DRIP EMITTERS	146
٥	DRIP EMITTER - TREE (6) NDS TAE 20 DRIP EMITTERS	17
SYMBOL	MANUFACTURER/MODEL/DESCRIPTION	QTY
•	CONTROL VALVE RAIN BIRD PEB. 1IN., 1-1/2IN., 2IN. PLASTIC INDUSTRIAL VALVES. LOW FLOW OPERATING CAPABILITY, GLOBE CONFIGURATION.	3
×	ISOLATION VALVE SPEARS STANDARD BALL VALVE	1
	MASTER VALVE 1" RAIN BIRD PEB. 1IN., 1-1/2IN., 2IN. PLASTIC INDUSTRIAL MASTER VALVES. LOW FLOW OPERATING CAPABILITY, GLOBE CONFIGURATION.	1
BF	REDUCED PRESSURE BACKFLOW PREVENTER 1" FEBCO 825Y	1
C	CONTROLLER - RAIN BIRD ESPLXME2-LXMMPED 12-48 STATION TRADITIONALLY-WIRED, COMMERCIAL CONTROLLER. INCLUDES METAL CABINET AND PEDESTAL FOR CONTROLLER.	1
M	WATER METER 1"	1
	IRRIGATION LATERAL LINE: PVC SCHEDULE 40	
	IRRIGATION LATERAL LINE: A940 DRIP POLYLINE	
	IRRIGATION LATERAL LINE: A940RDS DRIP POLYLINE	
	IRRIGATION MAINLINE: PVC SCHEDULE 40	
	PIPE SLEEVE: PVC CLASS 200 SDR 21	
\	/alve Callout	
# # # •	——Valve Number ——Valve Flow	


# **IRRIGATION NOTES**

- 1. ALL PLANTS WITHIN PUBLIC RIGHT-OF-WAY SHALL BE IRRIGATED BY BUBBLER IRRIGATION SYSTEM PER COA SPEC. ALL PLANTS WITHIN THE PUBLIC RIGHT-OF-WAY SHALL BE ZONED SEPARATELY FROM THE PLANTS WITHIN THE PROPERTY LINE.
- 2. ALL PLANTS WITHIN THE SITE, NOT IN THE PUBLIC RIGHT-OF-WAY, SHALL BE IRRIGATED WITH A DRIP IRRIGATION SYSTEM CONSISTING OF A REDUCED PRESSURE BACKFLOW PREVENTION DEVICE, MASTER VALVE, CONTROL VALVES, LOW FLOW POINT-SOURCE DRIP EMITTERS ON 3/4" POLY DRIP TUBING WITH FLUSH CAPS.
- 3. ALL SOD AREAS TO BE IRRIGATED WITH CONTROL VALVES, PVC LATERAL LINE TO PRESSURE COMPENSATING HEADS.
- 4. ALL IRRIGATION SHALL BE PERMANENT AND SHALL BE CONTROLLED BY AN
- AUTOMATIC IRRIGATION CONTROLLER.
- 5. PER 5-6(C)(14)(a), IRRIGATION SYSTEMS SHALL COMPLY WITH SECTION 8 OF THE ABCWUA LEGISLATION AND ORDINANCES (CROSS CONNECTION PREVENTION AND CONTROL ORDINANCE)
- 6. PER 5-6(C)(14)(b), ALL IRRIGATION SYSTEMS SHALL BE DESIGNED TO MINIMIZE THE USE OF WATER.
- 7. PER 5-6(C)(14)(c), ALL NON-RESIDENTIAL LANDSCAPE IRRIGATION SHALL HAVE AUTOMATIC TIMERS AND/OR PROGRAMMABLE SETTINGS TO AVOID
- OVERWATERING. 8. PER 5-6(C)(14)(d), THE IRRIGATION SYSTEM SHALL NOT SPRAY OR IRRIGATE IMPERVIOUS SURFACES, INCLUDING SIDEWALKS, DRIVEWAYS, DRIVE AISLES, STREETS, AND PARKING AND LOADING AREAS.

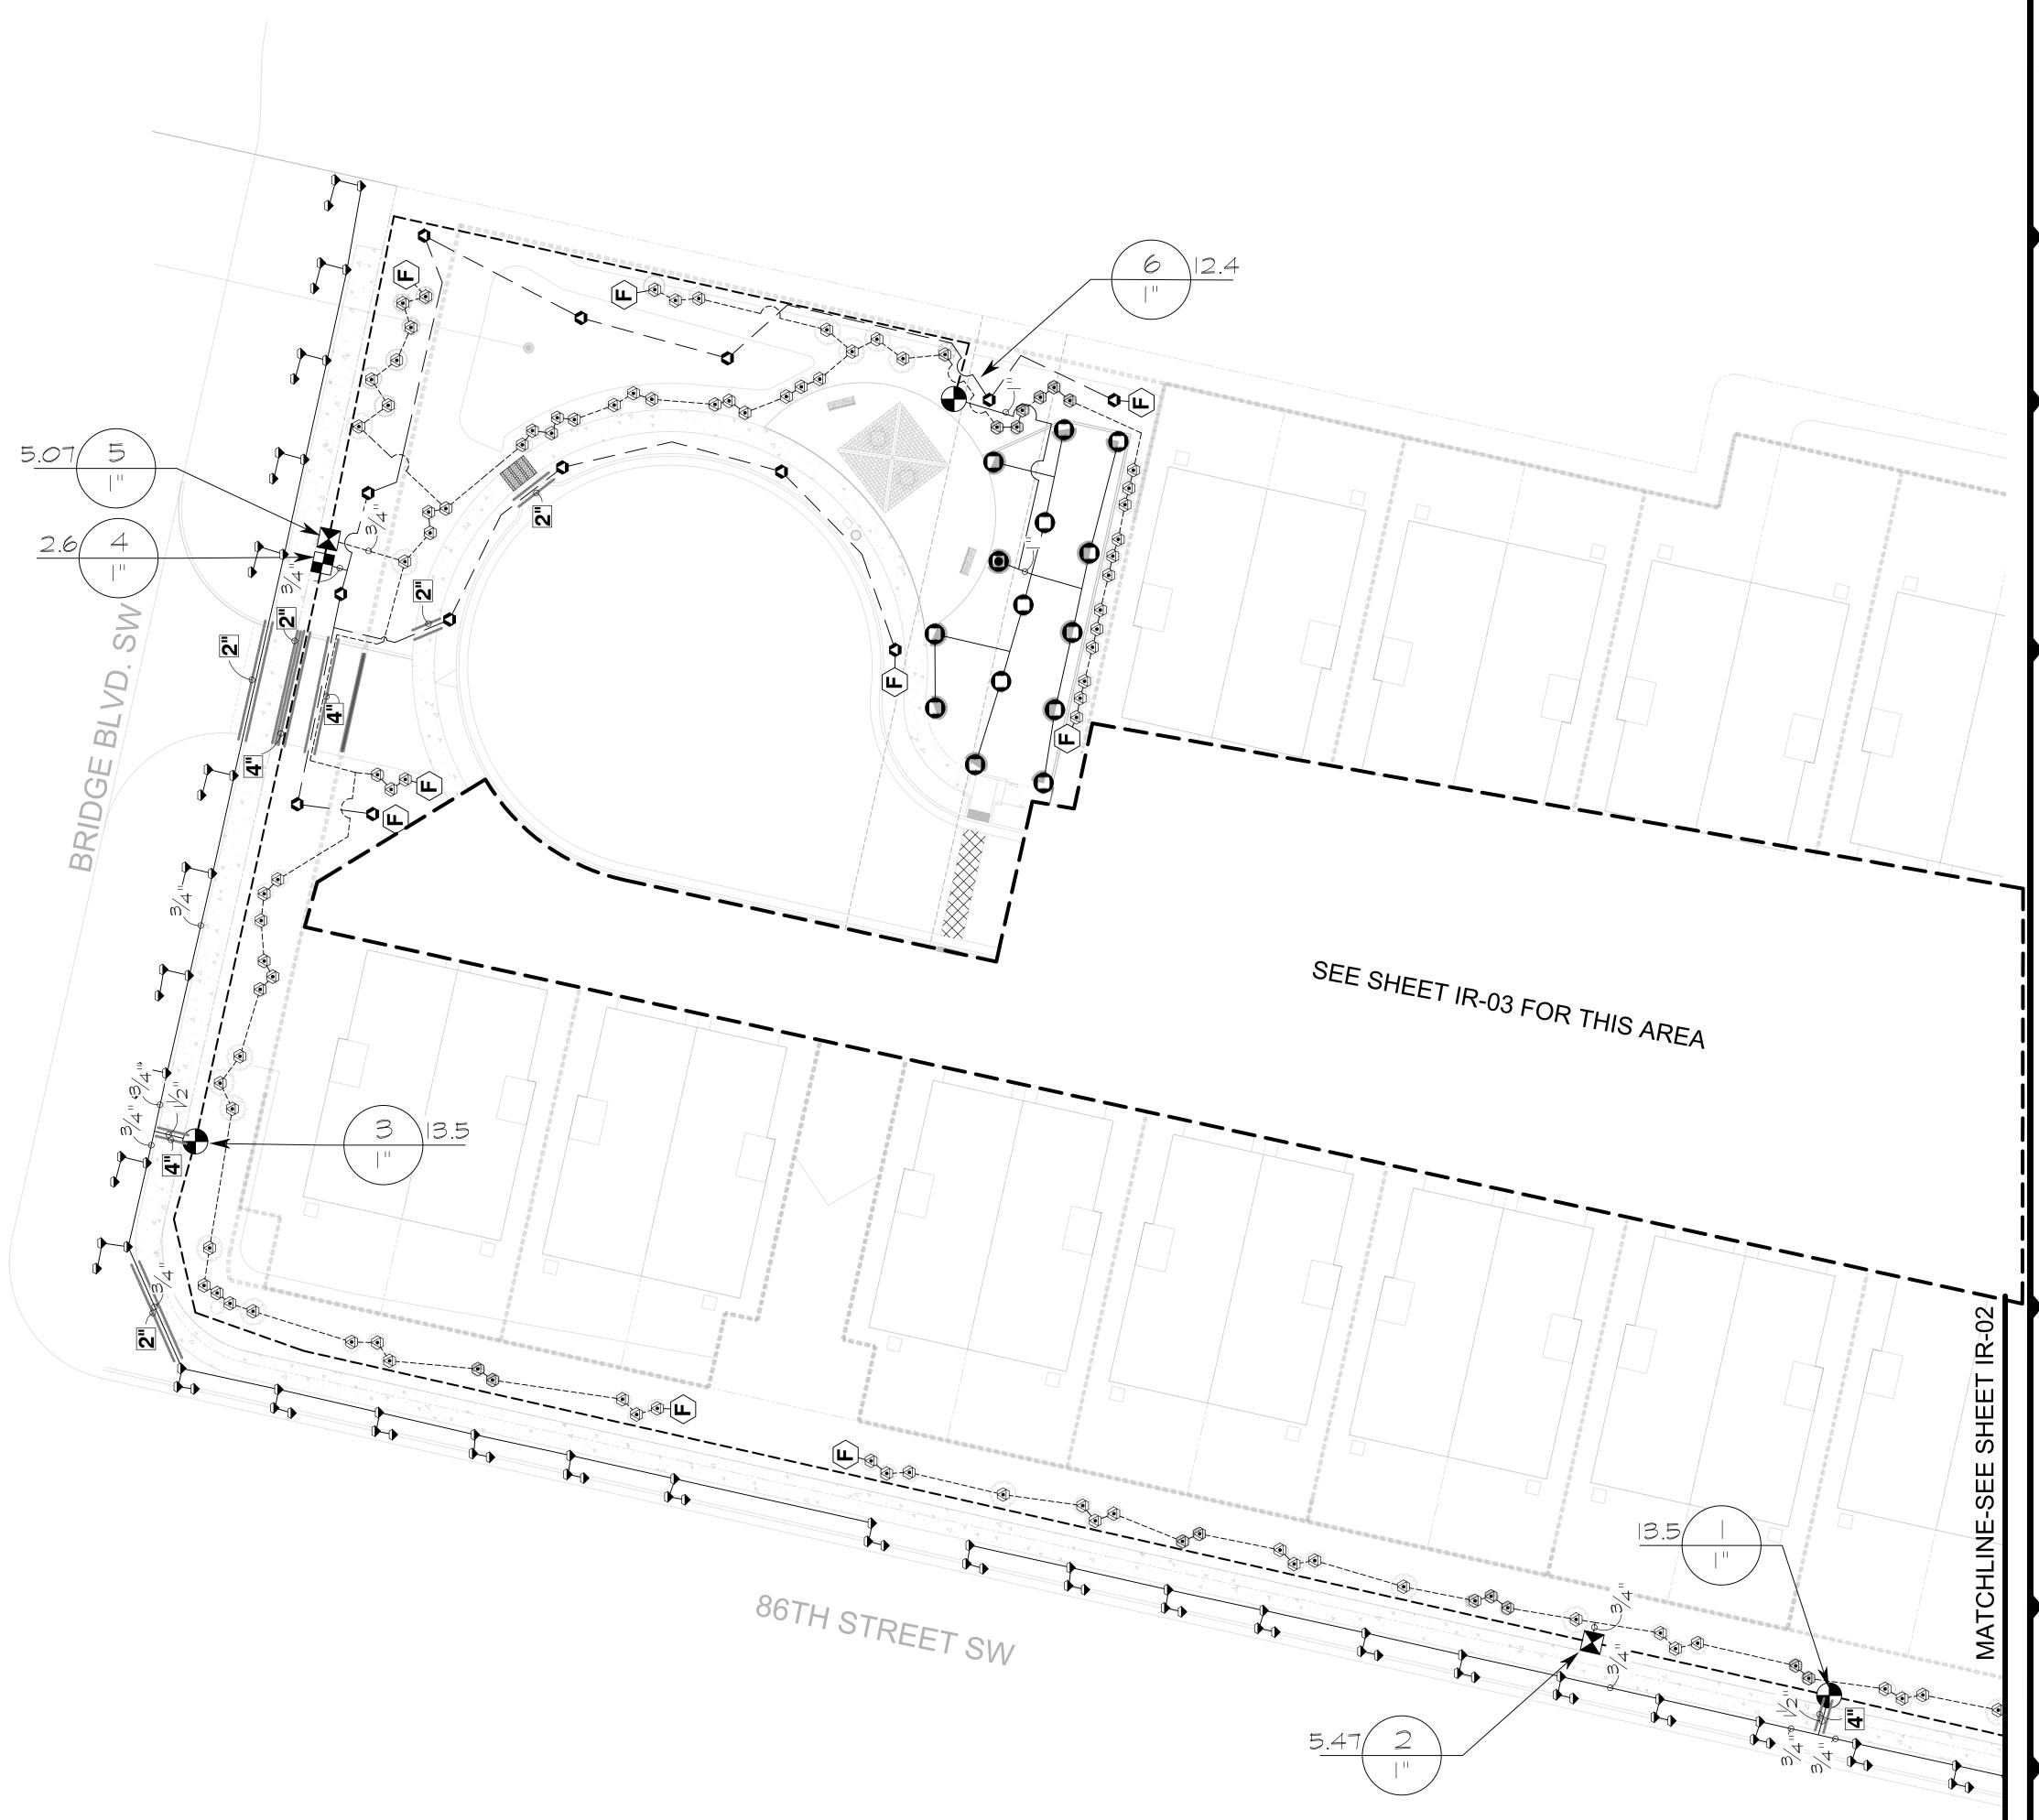




www.yellowstonelandscape.com PO Box 10597 Albuquerque, NM 87184 505.898.9615 design@yellowstonelandscape. com

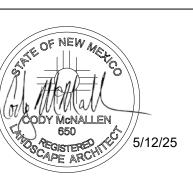


Date: 05/12/2025 Revisions:

Drawn by: CC Reviewed by: CM

> $\mathbb{D}^{\infty}$ **allo** 86th

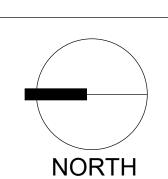

Scale: 1" = 20'

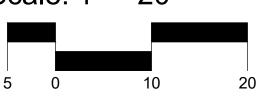

Sheet Title: Irrigation Plan


Sheet Number:

IRRIGATION	SCHEDULE	
SYMBOL	MANUFACTURER/MODEL/DESCRIPTION	QTY
2000	HUNTER MP2000 - TURF ROTATOR PROS-04-PRS40-CV, 4IN. POP-UP WITH FACTORY INSTALLED CHECK VALVE, PRESSURE REGULATED TO 40 PSI, MP ROTATOR NOZZLE ON PRS40 BODY.	13
3000	HUNTER MP3000 - TURF ROTATOR PROS-04-PRS40-CV, 4IN. POP-UP WITH FACTORY INSTALLED CHECK VALVE, PRESSURE REGULATED TO 40 PSI, MP ROTATOR NOZZLE ON PRS40 BODY.	1
→         →         →            40           402          404	RAIN BIRD 1800-1400 FLOOD FIXED FLOW RATE 0.25 GPM - 2.0 GPM, FULL CIRCLE BUBBLER, 1/2IN. FIPT.	108
SYMBOL	MANUFACTURER/MODEL/DESCRIPTION	QTY
×	DRIP CONTROL VALVE - SHRUB RAIN BIRD XCZ-100-PRF, MEDIUM FLOW DRIP CONTROL KIT, 1IN. DV VALVE, 1IN. PRESSURE REGULATING FILTER, 40PSI PRESSURE REGULATOR. 5 GPM-20 GPM.	2
	DRIP CONTROL VALVE - TREE RAIN BIRD XCZ-100-PRF. MEDIUM FLOW DRIP CONTROL KIT, 1IN. DV VALVE, 1IN. PRESSURE REGULATING FILTER, 40PSI PRESSURE REGULATOR. 3 GPM-15 GPM.	1
<b>⟨F</b> ⟩	FLUSH CAP NDS CEP900	12
<b>②</b>	DRIP EMITTER - SHRUB (2) NDS TAE 20 DRIP EMITTERS	146
٥	DRIP EMITTER - TREE (6) NDS TAE 20 DRIP EMITTERS	17
SYMBOL	MANUFACTURER/MODEL/DESCRIPTION	QTY
•	CONTROL VALVE RAIN BIRD PEB. 1IN., 1-1/2IN., 2IN. PLASTIC INDUSTRIAL VALVES. LOW FLOW OPERATING CAPABILITY, GLOBE CONFIGURATION.	3
×	ISOLATION VALVE SPEARS STANDARD BALL VALVE	1
	MASTER VALVE 1" RAIN BIRD PEB. 1IN., 1-1/2IN., 2IN. PLASTIC INDUSTRIAL MASTER VALVES. LOW FLOW OPERATING CAPABILITY, GLOBE CONFIGURATION.	1
BF	REDUCED PRESSURE BACKFLOW PREVENTER 1" FEBCO 825Y	1
C	CONTROLLER - RAIN BIRD ESPLXME2-LXMMPED 12-48 STATION TRADITIONALLY-WIRED, COMMERCIAL CONTROLLER. INCLUDES METAL CABINET AND PEDESTAL FOR CONTROLLER.	1
M	WATER METER 1"	1
	IRRIGATION LATERAL LINE: PVC SCHEDULE 40	
	IRRIGATION LATERAL LINE: A940 DRIP POLYLINE	
	IRRIGATION LATERAL LINE: A940RDS DRIP POLYLINE	
	IRRIGATION MAINLINE: PVC SCHEDULE 40	
	PIPE SLEEVE: PVC CLASS 200 SDR 21	
\	/alve Callout ——— Valve Number	
# • # •	—— Valve Flow	
#"•	—— Valve Size	

# IRRIGATION NOTES


- 1. ALL PLANTS WITHIN PUBLIC RIGHT-OF-WAY SHALL BE IRRIGATED BY BUBBLER IRRIGATION SYSTEM PER COA SPEC. ALL PLANTS WITHIN THE PUBLIC RIGHT-OF-WAY SHALL BE ZONED SEPARATELY FROM THE PLANTS WITHIN THE PROPERTY LINE.
- 2. ALL PLANTS WITHIN THE SITE, NOT IN THE PUBLIC RIGHT-OF-WAY, SHALL BE IRRIGATED WITH A DRIP IRRIGATION SYSTEM CONSISTING OF A REDUCED PRESSURE BACKFLOW PREVENTION DEVICE, MASTER VALVE, CONTROL VALVES, LOW FLOW POINT-SOURCE DRIP EMITTERS ON 3/4" POLY DRIP TUBING WITH FLUSH CAPS.
- 3. ALL SOD AREAS TO BE IRRIGATED WITH CONTROL VALVES, PVC LATERAL LINE TO PRESSURE COMPENSATING HEADS.
- 4. ALL IRRIGATION SHALL BE PERMANENT AND SHALL BE CONTROLLED BY AN
- AUTOMATIC IRRIGATION CONTROLLER.

  5. PER 5-6(C)(14)(a), IRRIGATION SYSTEMS SHALL COMPLY WITH SECTION 8 OF THE ABCWUA LEGISLATION AND ORDINANCES (CROSS CONNECTION PREVENTION AND CONTROL ORDINANCE)
- 6. PER 5-6(C)(14)(b), ALL IRRIGATION SYSTEMS SHALL BE DESIGNED TO MINIMIZE THE USE OF WATER.
- PER 5-6(C)(14)(c), ALL NON-RESIDENTIAL LANDSCAPE IRRIGATION SHALL HAVE AUTOMATIC TIMERS AND/OR PROGRAMMABLE SETTINGS TO AVOID OVERWATERING.
- 8. PER 5-6(C)(14)(d), THE IRRIGATION SYSTEM SHALL NOT SPRAY OR IRRIGATE IMPERVIOUS SURFACES, INCLUDING SIDEWALKS, DRIVEWAYS, DRIVE AISLES, STREETS, AND PARKING AND LOADING AREAS.

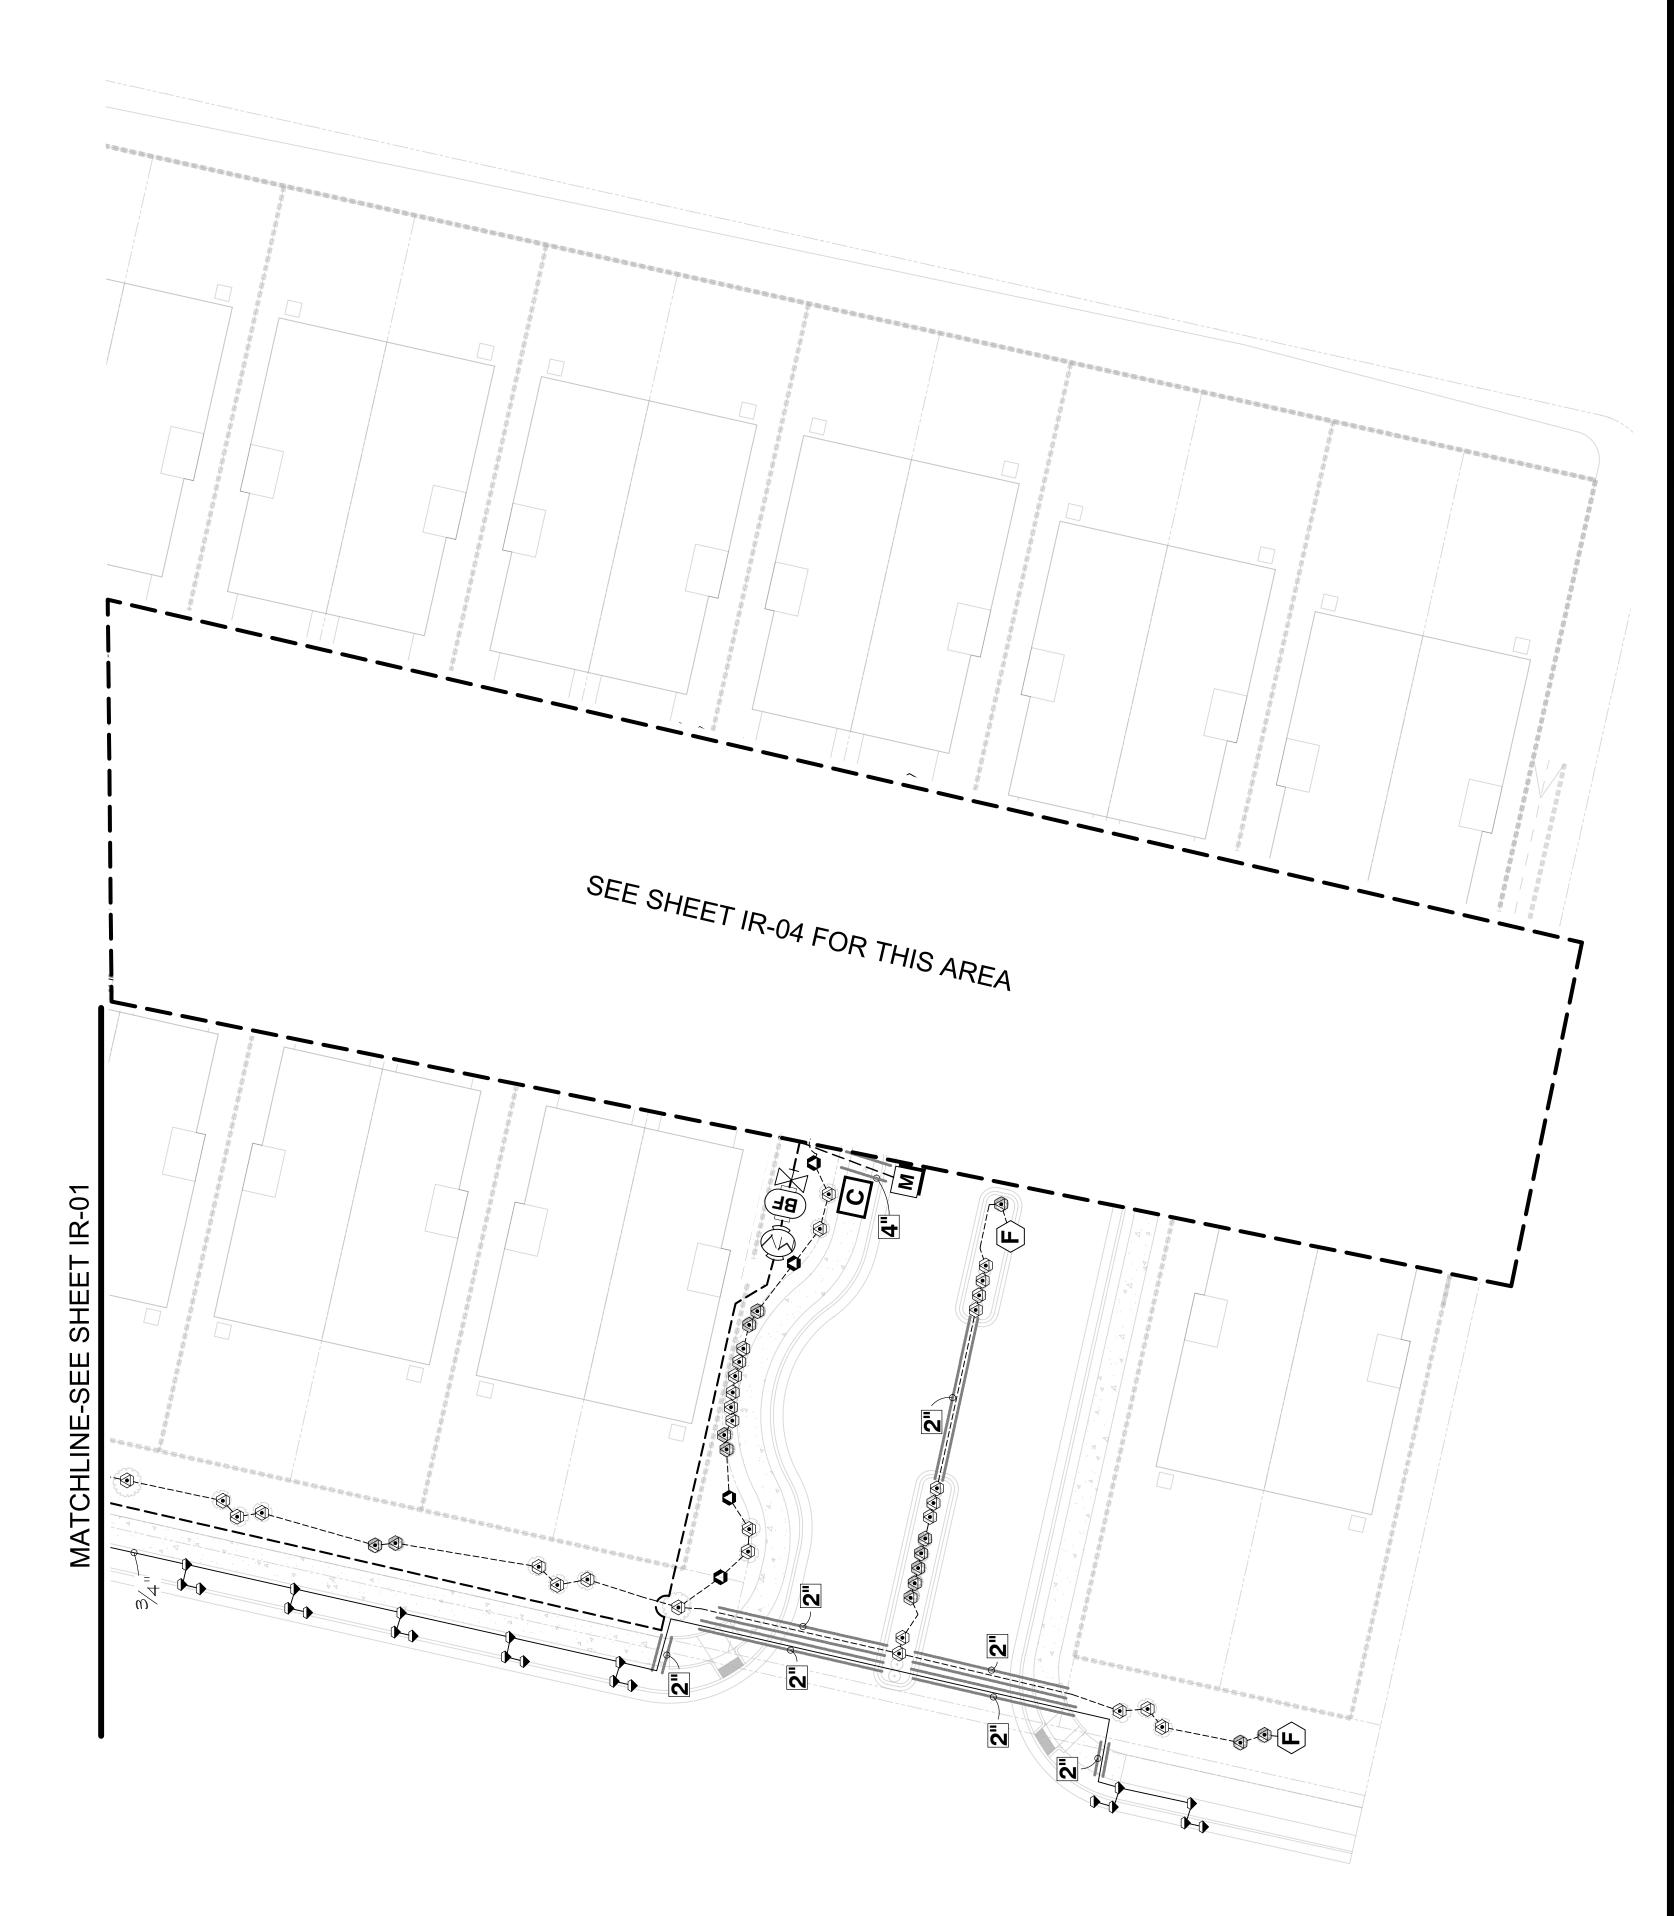




www.yellowstonelandscape.com
POBox10597
Albuquerque, NM87184
505.898.9615
design@yellowstonelandscape.com

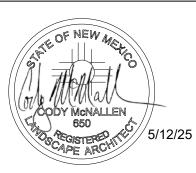


Date:_	05/12/2025
Revisio	ns:
$\triangle$ _	
$\triangle$ _	
$\triangle$ _	
Drawn	bv: CC

Reviewed by: <u>CM</u>

Gallo Partners 86th & Bridge

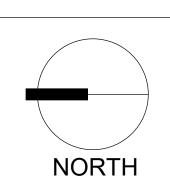

Scale: 1" = 20'

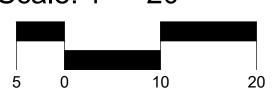

Sheet Title:

Irrigation
Plan

Sheet Number:

SYMBOL	MANUFACTURER/MODEL/DESCRIPTION	QTY
×	DRIP CONTROL VALVE - SHRUB RAIN BIRD XCZ-100-PRF, MEDIUM FLOW DRIP CONTROL KIT, 1IN. DV VALVE, 1IN. PRESSURE REGULATING FILTER, 40PSI PRESSURE REGULATOR. 5 GPM-20 GPM.	1
•	DRIP CONTROL VALVE - TREE RAIN BIRD XCZ-100-PRF. MEDIUM FLOW DRIP CONTROL KIT, 1IN. DV VALVE, 1IN. PRESSURE REGULATING FILTER, 40PSI PRESSURE REGULATOR. 3 GPM-15 GPM.	1
<b>②</b>	TRANSITION FITTING PIPE TRANSITION POINT FROM PVC LATERAL TO DRIP TUBING WITH RISER IN 6IN. DRIP BOX.	46
F	FLUSH CAP NDS CEP900	47
<b>&amp;</b>	DRIP EMITTER - SHRUB (2) NDS TAE 20 DRIP EMITTERS	111
٥	DRIP EMITTER - TREE (6) NDS TAE 20 DRIP EMITTERS	38
SYMBOL	MANUFACTURER/MODEL/DESCRIPTION	
	IRRIGATION LATERAL LINE: PVC SCHEDULE 40	
	IRRIGATION LATERAL LINE: A940 DRIP POLYLINE	
	IRRIGATION LATERAL LINE: A940RDS DRIP POLYLINE	
	IRRIGATION MAINLINE: PVC SCHEDULE 40	
	PIPE SLEEVE: PVC CLASS 200 SDR 21	
# # # # #	Valve Callout  Valve Number  Valve Flow  Valve Size	

# **IRRIGATION NOTES**


- 1. ALL PLANTS WITHIN PUBLIC RIGHT-OF-WAY SHALL BE IRRIGATED BY BUBBLER IRRIGATION SYSTEM PER COA SPEC. ALL PLANTS WITHIN THE PUBLIC RIGHT-OF-WAY SHALL BE ZONED SEPARATELY FROM THE PLANTS WITHIN THE PROPERTY LINE.
- 2. ALL PLANTS WITHIN THE SITE, NOT IN THE PUBLIC RIGHT-OF-WAY, SHALL BE IRRIGATED WITH A DRIP IRRIGATION SYSTEM CONSISTING OF A REDUCED PRESSURE BACKFLOW PREVENTION DEVICE, MASTER VALVE, CONTROL VALVES, LOW FLOW POINT-SOURCE DRIP EMITTERS ON 3/4" POLY DRIP TUBING WITH FLUSH CAPS.
- ALL SOD AREAS TO BE IRRIGATED WITH CONTROL VALVES, PVC LATERAL LINE TO PRESSURE COMPENSATING HEADS.
   ALL IRRIGATION SHALL BE PERMANENT AND SHALL BE CONTROLLED BY AN AUTOMATIC IRRIGATION CONTROLLER.

- 5. PER 5-6(C)(14)(a), IRRIGATION SYSTEMS SHALL COMPLY WITH SECTION 8 OF THE ABCWUA LEGISLATION AND ORDINANCES (CROSS CONNECTION PREVENTION AND CONTROL ORDINANCE)
- 6. PER 5-6(C)(14)(b), ALL IRRIGATION SYSTEMS SHALL BE DESIGNED TO MINIMIZE THE USE OF WATER.
- 7. PER 5-6(C)(14)(c), ALL NON-RESIDENTIAL LANDSCAPE IRRIGATION SHALL HAVE AUTOMATIC TIMERS AND/OR PROGRAMMABLE SETTINGS TO AVOID
- 8. PER 5-6(C)(14)(d), THE IRRIGATION SYSTEM SHALL NOT SPRAY OR IRRIGATE IMPERVIOUS SURFACES, INCLUDING SIDEWALKS, DRIVEWAYS, DRIVE AISLES, STREETS, AND PARKING AND LOADING AREAS.






PO Box 10597 Albuquerque, NM 87184 505.898.9615 design@yellowstonelandscape.com

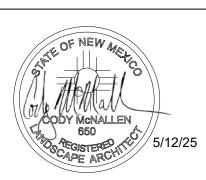

Date: 05/12/2025 Revisions:

Drawn by: CC Reviewed by: CM

 $\Box \infty$ Gallo 86th

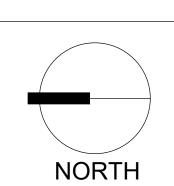

Scale: 1" = 20'




Sheet Title: Interior Irrigation Plan

Sheet Number:

SYMBOL	MANUFACTURER/MODEL/DESCRIPTION	QTY
×	DRIP CONTROL VALVE - SHRUB RAIN BIRD XCZ-100-PRF, MEDIUM FLOW DRIP CONTROL KIT, 1IN. DV VALVE, 1IN. PRESSURE REGULATING FILTER, 40PSI PRESSURE REGULATOR. 5 GPM-20 GPM.	1
5	DRIP CONTROL VALVE - TREE RAIN BIRD XCZ-100-PRF. MEDIUM FLOW DRIP CONTROL KIT, 1IN. DV VALVE, 1IN. PRESSURE REGULATING FILTER, 40PSI PRESSURE REGULATOR. 3 GPM-15 GPM.	1
<b>②</b>	TRANSITION FITTING PIPE TRANSITION POINT FROM PVC LATERAL TO DRIP TUBING WITH RISER IN 6IN. DRIP BOX.	46
F	FLUSH CAP NDS CEP900	47
<b>⊕</b>	DRIP EMITTER - SHRUB (2) NDS TAE 20 DRIP EMITTERS	111
•	DRIP EMITTER - TREE (6) NDS TAE 20 DRIP EMITTERS	38
SYMBOL	MANUFACTURER/MODEL/DESCRIPTION	
	IRRIGATION LATERAL LINE: PVC SCHEDULE 40	
	IRRIGATION LATERAL LINE: A940 DRIP POLYLINE	
	IRRIGATION LATERAL LINE: A940RDS DRIP POLYLINE	
	IRRIGATION MAINLINE: PVC SCHEDULE 40	
	PIPE SLEEVE: PVC CLASS 200 SDR 21	
	/aive Callout  Valve Number	
# # # # #	Valve Flow	
#"•	Valve Size	

# **IRRIGATION NOTES**

- 1. ALL PLANTS WITHIN PUBLIC RIGHT-OF-WAY SHALL BE IRRIGATED BY BUBBLER IRRIGATION SYSTEM PER COA SPEC. ALL PLANTS WITHIN THE PUBLIC RIGHT-OF-WAY SHALL BE ZONED SEPARATELY FROM THE PLANTS WITHIN THE PROPERTY LINE.
- 2. ALL PLANTS WITHIN THE SITE, NOT IN THE PUBLIC RIGHT-OF-WAY, SHALL BE IRRIGATED WITH A DRIP IRRIGATION SYSTEM CONSISTING OF A REDUCED PRESSURE BACKFLOW PREVENTION DEVICE, MASTER VALVE, CONTROL VALVES, LOW FLOW POINT-SOURCE DRIP EMITTERS ON 3/4" POLY DRIP TUBING WITH FLUSH CAPS.
- ALL SOD AREAS TO BE IRRIGATED WITH CONTROL VALVES, PVC LATERAL LINE TO PRESSURE COMPENSATING HEADS.
- ALL IRRIGATION SHALL BE PERMANENT AND SHALL BE CONTROLLED BY AN AUTOMATIC IRRIGATION CONTROLLER.
- PER 5-6(C)(14)(a), IRRIGATION SYSTEMS SHALL COMPLY WITH SECTION 8 OF THE ABCWUA LEGISLATION AND ORDINANCES (CROSS CONNECTION PREVENTION AND CONTROL ORDINANCE)
- 6. PER 5-6(C)(14)(b), ALL IRRIGATION SYSTEMS SHALL BE DESIGNED TO MINIMIZE THE USE OF WATER.
- PER 5-6(C)(14)(c), ALL NON-RESIDENTIAL LANDSCAPE IRRIGATION SHALL HAVE AUTOMATIC TIMERS AND/OR PROGRAMMABLE SETTINGS TO AVOID OVERWATERING.
- 8. PER 5-6(C)(14)(d), THE IRRIGATION SYSTEM SHALL NOT SPRAY OR IRRIGATE IMPERVIOUS SURFACES, INCLUDING SIDEWALKS, DRIVEWAYS, DRIVE AISLES, STREETS, AND PARKING AND LOADING AREAS.

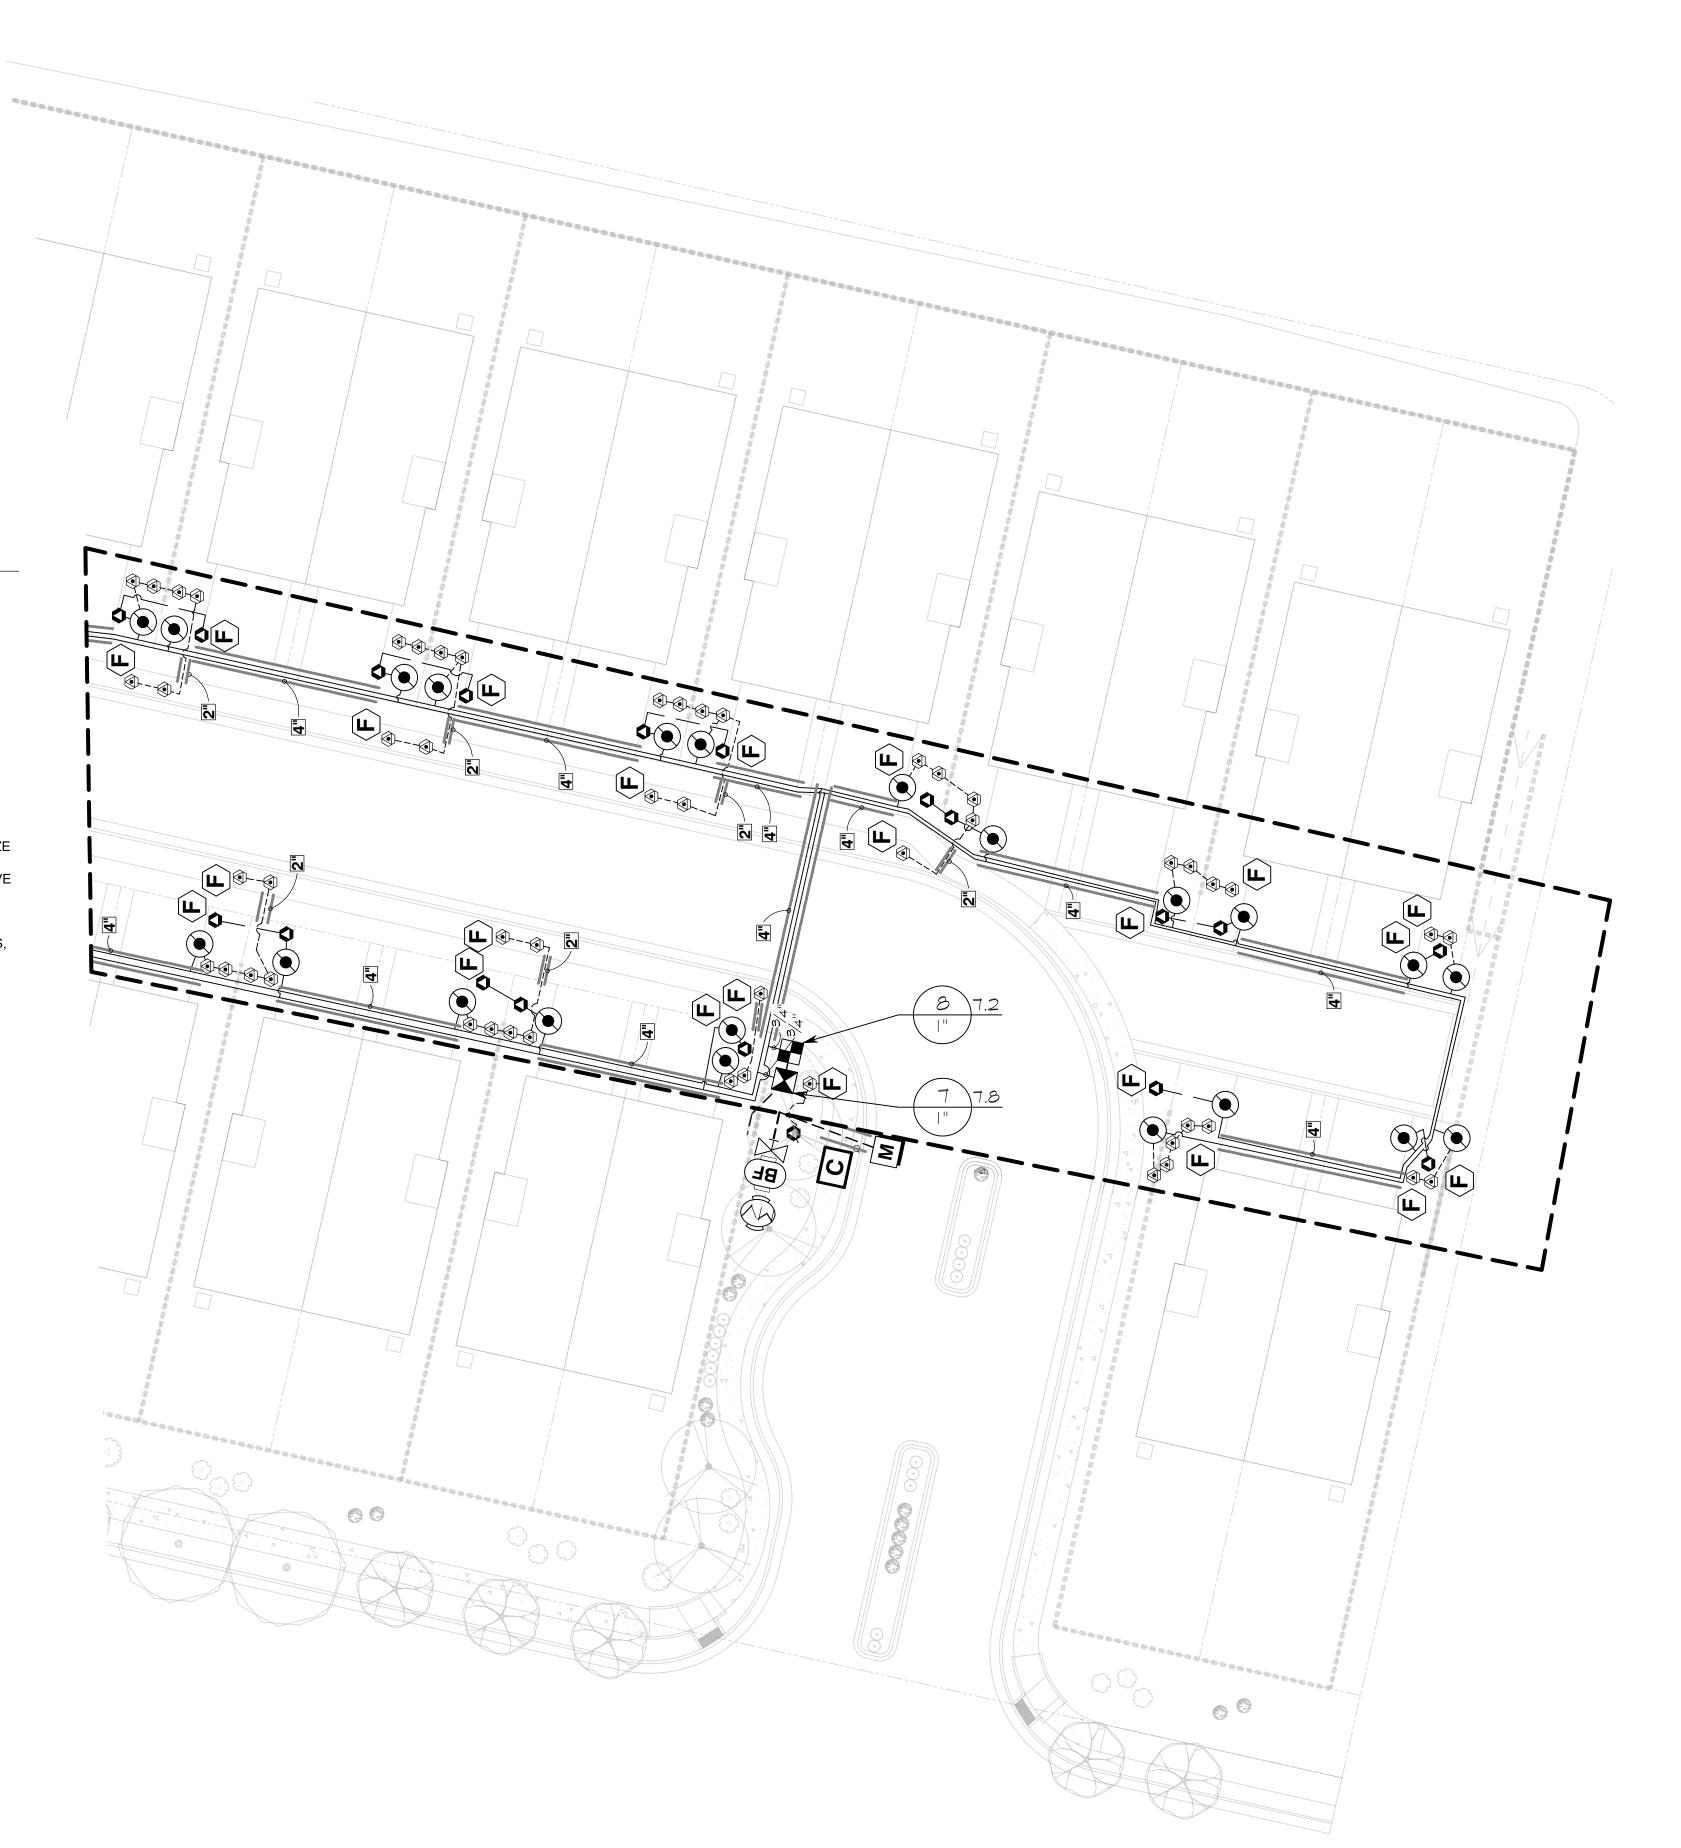




Albuquerque, NM 87184 505.898.9615



	05/12/2025
Revisio	ns:
$\triangle$ _	
Drawn	by: CC
Review	red by: <u>CM</u>

Gallo Partners 86th & Bridge

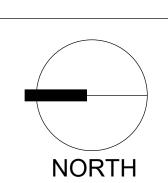

Scale: 1" = 20'



Sheet Title:
Interior
Irrigation Plan

Sheet Number:

- IRRIGATION SUPPLY LINE
- SCH. 80 UTILITY BALL VALVE APPLIED ENGINEERING PRODUCTS 910 ROUND VALVE BOX WITH EXTENSIONS AS NEEDED
- FINISH GRADE SCH. 80 NIPPLE
- GAL. 90°
- GAL. 30" NIPPLE 4" THICK CONCRETE PAD (6" WIDER THAN ASSEMBLY ON ALL SIDES)
- OUTLET FOR HEAT TAPE PROVIDED BY OTHERS HOT BOX (HEATED ENCLOSURE)
- REDUCED PRESSURE BACKFLOW PREVENTER GAL. STREET 90°

N.T.S.


- M. GAL. NIPPLE (TYP.)
- GAL. UNION (TYP.) PVC SLEEVE THROUGH CONCRETE (TYP.)
- SCH. 80 UTILITY BALL VALVE MASTER VALVE

SCH. 80 NIPPLE

SLIP X THREAD MALE ADAPTER SCH. 40 PVC MASTERLINE APPLIED ENGINEERING PRODUCTS 1015

VALVE BOX WITH EXTENSIONS AS NEEDED

NOTE: INSTALL BACKFLOW PREVENTER AS REQUIRED BY LOCAL CODES AND HEALTH DEPARTMENT. VERIFY LOCAL REQUIREMENTS PRIOR TO INSTALLATION.

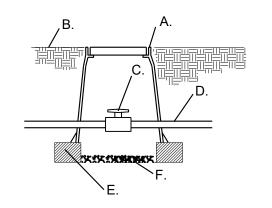

- APPLIED ENGINEERING PRODUCTS 910 ROUND VALVE BOX WITH EXTENSIONS AS NEEDED
- FINISH GRADE SCH. 80 UTILITY BALL VALVE MAINLINE/24" BURY 8" X 8" X 16" CMU CONCRETE BLOCK F. 4" LAYER OF 3/4" GRAVEL
- A. APPLIED ENGINEERING PRODUCTS 1320 VALVE BOX WITH EXTENSIONS AS
- NEEDED B. FINISH GRADE 24" WIRE LOOP
- AUTOMATIC VALVE, SEE IRRIGATION LEGEND
- DRY SPLICE CONNECTOR OR EQUAL
- LATERAL LINE/24" BURY 8" X 8" X 16" CMU CONCRETE BLOCK
- MASTERLINE/24" BURY
- 4" LAYER OF 3/4" GRAVEL
- SCH. 80 UTILITY BALL VALVE SCH. 40 PVC LATERAL LINE SCH. 80 UNION

RP BACKFLOW/MASTER VALVE DETAIL




N.T.S.






N.T.S.

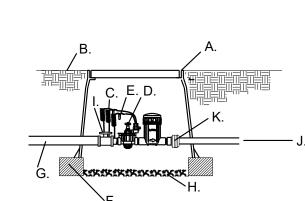

A. APPLIED ENGINEERING PRODUCTS 1320 VALVE BOX WITH EXTENSIONS AS NEEDED FINISH GRADE

C. 24" WIRE LOOP D. RAIN BIRD XCZ CONTROL ZONE KIT WITH BASKET FILTER, SEE LEGEND DRY SPLICE CONNECTOR OR EQUAL F. 8" X 8" X 16" CMU CONCRETE BLOCK


G. MASTERLINE/24" BURY H. 4" LAYER OF 3/4" GRAVEL SCH. 80 TRUE UNION BALL VALVE J. LATERAL LINE. SEE PLAN. K. SCH. 80 UNION

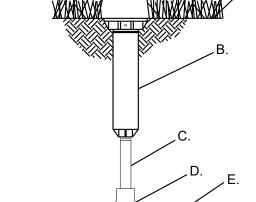

FINISH GRADE POP-UP SPRAY SPRINKLER: HUNTER PROS-04-PRS40-CV

NOZZLE PER SCHEDULE **HUNTER SJ-512 SWING JOINT** 


PVC SCH.40 TEE/ELL E. PVC LATERAL LINE

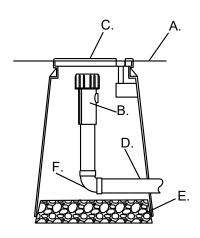

FINISH GRADE END FLUSH CAP

6" ROUND BOX WITH LID 3/4" POLY DRIP PIPE

2" DEPTH OF GRAVEL 90° FITTING

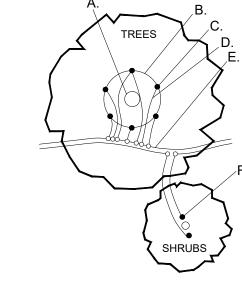

TREE TRUNK/ ROOT CROWN 24" CIRCLE FROM TRUNK

**EMITTERS** 

1/4" DISTRIBUTION LINE 3/4" POLYETHYLENE DRIPLINE

EMITTER PLACED AT THE EDGE OF THE ROOT BALL

NOTE: INSTALL EMITTERS ABOVE THE ROOT BALL IF PLANT IS INSTALLED ON A SLOPE.

DRIP VALVE WITH FILTER & PRESSURE REGULATOR FOR TRADITIONAL WIRE IRRIGATION

ROTATARY SPRAY HEAD

**END FLUSH CAP** 

**EMITTER PLACEMENT DETAIL** 

N.T.S.

BUBBLER PLACEMENT DETAIL

TREE TRUNK/ ROOT CROWN 36" DIA AROUND TREE 12-18" DIA AROUND SHRUB PVC LATERAL PIPE (SIZE VARIES)

BUBBLERS -TREE: (3)1.0 GPM -VERTICAL SHRUB: (2) 0.5 GPM -SHRUB: (1) 0.5 GPM -YUCCA AND OTHER VERY LOW WATER-USE SHRUBS: (1) 0.25 GPM

N.T.S.

NOTE: INSTALL BUBBLER(S) ABOVE THE ROOT BALL IF PLANT IS INSTALLED ON A SLOPE.

PEDESTAL MOUNTED AUTOMATIC CONTROLLER

N.T.S.

 $\mathbb{L}^{\infty}$ 

Albuquerque

YELLOWSTONE

www.yellowstonelandscape.com

Albuquerque, NM 87184

design@yellowstonelandscape.com

PO Box 10597

505.898.9615

Date: 05/01/2025

Revisions:

Drawn by: CC

Reviewed by: CM

Sheet Title: Irrigation Details

Sheet Number:

