


ADMINISTRATIVE AMENDMENT

FILE # _____ PROJECT # _____

APPROVED BY

DATE

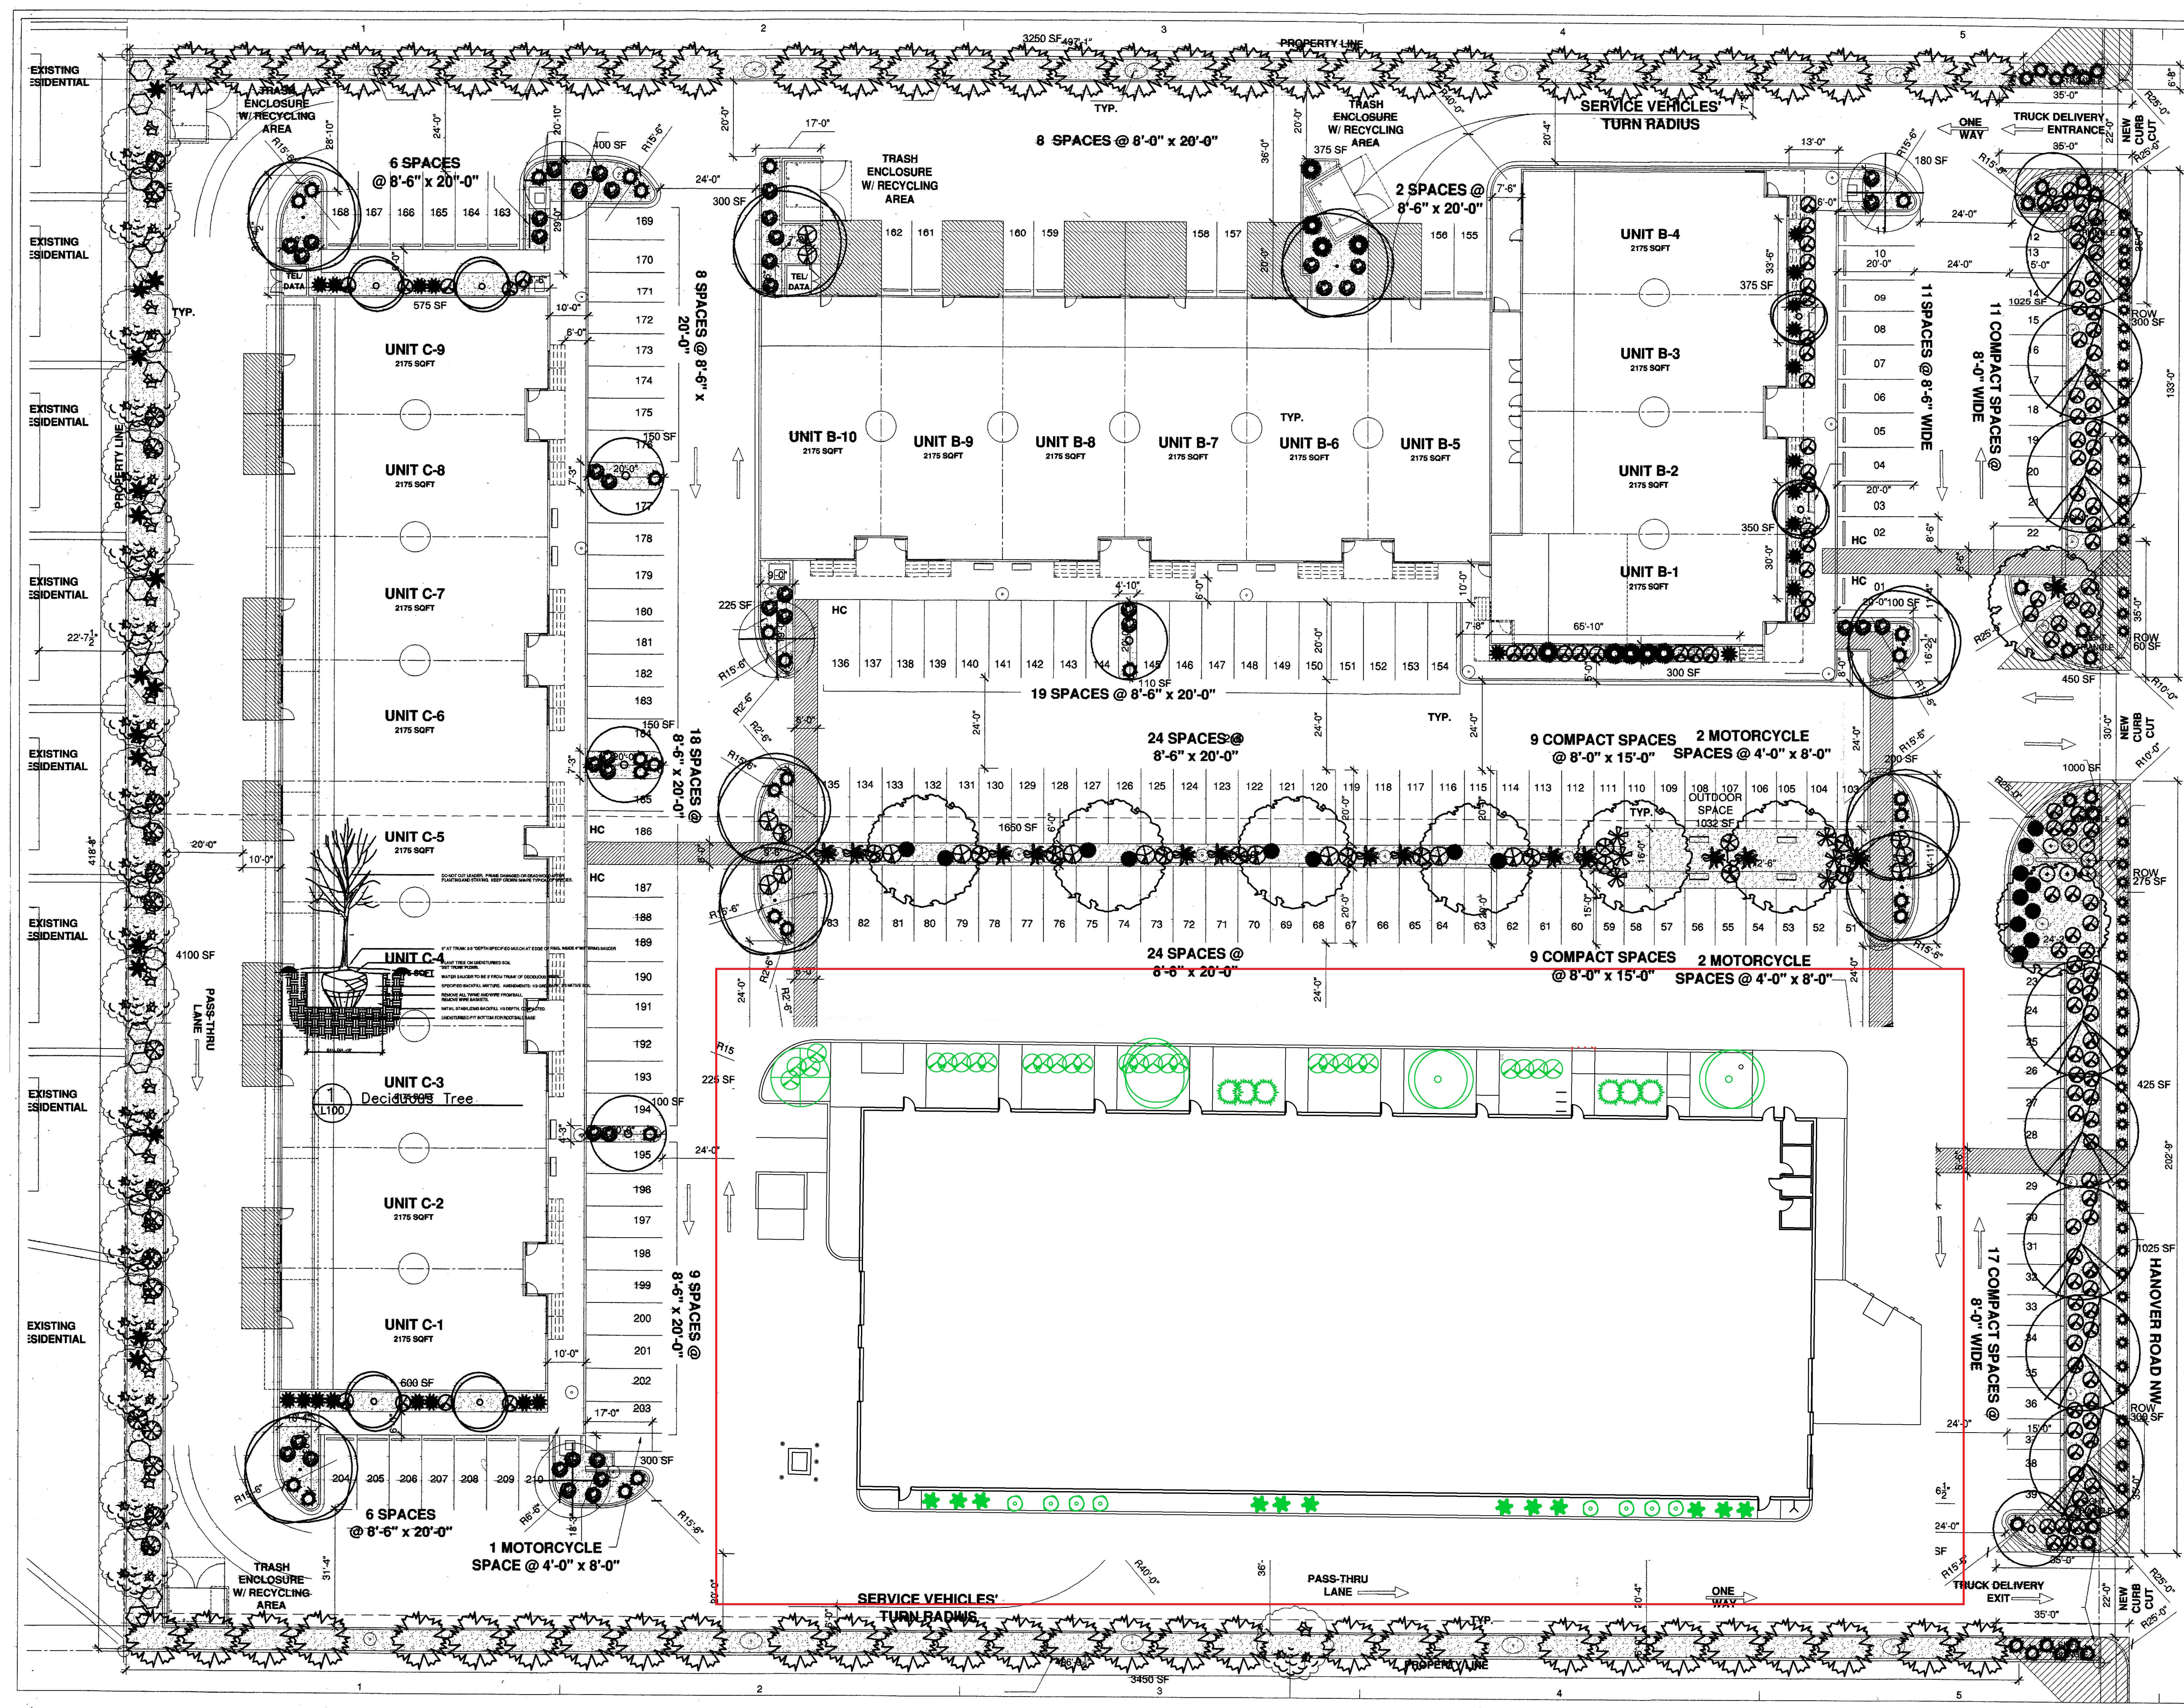

PLANT LEGEND

Qty	Symbol	Scientific Name Common Name	Size	Water Use
6	⊕	Cercis Western Redbud	15-Gal	Medium+
8	⊕	Fraxinus velutina 'Modesto' Modesto Ash	2" B&B	Medium +
10	⊕	Gleditsia triacanthos Honeylocust	2" B&B	Medium
8	⊕	Pistacia chinensis Chinese Pistache	2" B&B	Medium +
8	⊕	Prunus californiana Aristocrat Pear	15-Gal	Medium +
20	⊕	Chitalpa Chitalpa	15-Gal	Medium +
61	⊕	Juniperus chinensis Spartan Juniper	5-Gal	Medium +
Shrub/Conifers				
14	⊕	Ericameria laetifolia 'Aguilae' Turpentine Bush	5-Gal	Low+
8	⊕	Ericameria nauseosus Chamise	1-Gal	Low
20	⊕	Fallugia paradoxa Apache Plume	1-Gal	Low
6	⊕	Hesperaloe parviflora Red Yucca	5-Gal	Low+
1	⊕	Juniperus horizontalis Blue Chip Juniper	5-Gal	Low +
36	⊕	Nandina domestica Nandina	5-Gal	Medium+
18	⊕	Parrya atriplicifolia Russian Sage	1-Gal	Medium
58	⊕	Potentilla fruticosa Shrubby Cinqufoil	5-Gal	Medium+
19	⊕	Prunus besseyi Western Sand Cherry	5-Gal	Medium
156	⊕	Rhaphiophelis indica India Hawthorn	5-Gal	Medium
14	⊕	Rosa rugosa Rosemary	5-Gal	Low +
7	⊕	Sakha greggii Cherry Sage	1-Gal	Medium
55	⊕	Artemisia ludoviciana Prairie Sage	1-Gal	Low +
Ornamental Grasses				
14	⊕	Miscanthus sinensis 'Gracillimus' Maiden Grass	5-Gal	Medium
17	⊕	Muhlenbergia capillaris 'Regal Mist' Regal Mist	1-Gal	Medium
16	⊕	Nolina microcarpa Bear Grass	5-Gal	Low +

SITE DATA

GROSS LOT AREA	217,788 SF
LESS BUILDING(S)	62,640 SF
NET LOT AREA	155,148 SF
REQUIRED LANDSCAPE	15% OF NET LOT AREA
PROPOSED LANDSCAPE	23,282 SF (including ROW)
PERCENT OF NET LOT AREA	15%
REQUIRED STREET TREES	12
PROVIDED AT 30' O.C. SPACING ALONG STREET	12
REQUIRED PARKING LOT TREES	22
PROVIDED AT 1 PER 10 SPACES (217 SPACES/10)	22

PLANTING RESTRICTIONS APPROACH

A MINIMUM OF 80% OF THE PLANTINGS TO BE LOW OR MEDIUM WATER USE PLANTS

NOTE

MAINTENANCE OF LANDSCAPE AND IRRIGATION PROVIDED BY OWNER

PLANTINGS TO BE WATERED BY AUTO. DRIP IRRIGATION SYSTEM WITH REDUCED PRESSURE BACKFLOW PREVENTER (WILKINS MODEL 975) PER CITY OF ALBUQUERQUE

WATER MANAGEMENT IS THE SOLE RESPONSIBILITY OF THE PROPERTY OWNER

THIS PLAN IS TO COMPLY WITH C.O.A. LANDSCAPE AND WATER WASTE ORDINANCE

PLANTING RESTRICTIONS APPROACH


IT IS THE INTENT OF THIS PLAN TO PROVIDE MIN. 80% LIVE GROUND COVER OF LANDSCAPE AREAS AT MATURITY

LANDSCAPE AREAS TO BE MULCHED WITH 3" SANTA ANA TAN GRAVEL AT 2" DEPTH OVER FILTER FABRIC

APPROVAL OF THE LANDSCAPE PLAN DOES NOT CONSTITUTE OR IMPLY COMPLIANCE WITH OR EXEMPTION FROM THE C.O.A. LANDSCAPE AND WATER WASTE ORDINANCE

TREES ARE NOT TO BE PLACED IN PUBLIC UTILITY EASEMENTS


NO PARKING SPACE SHALL BE MORE THAN 10' FROM A TREE.

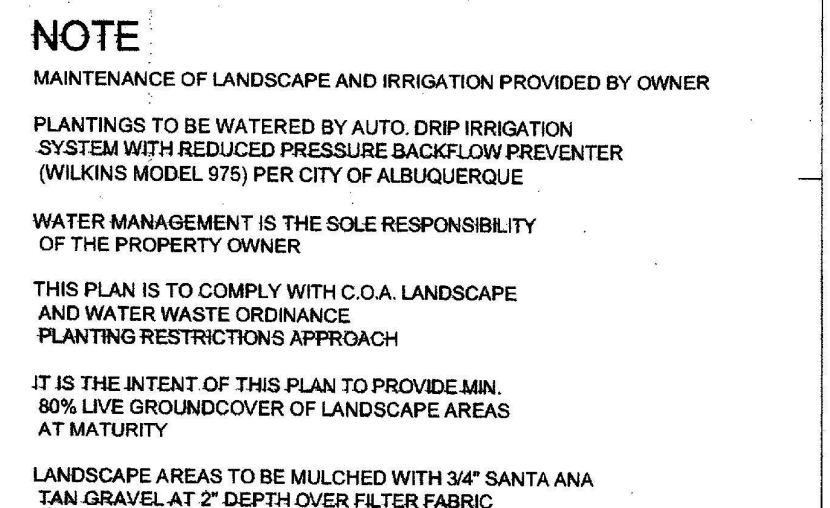

REVISIONS


REV	DATE
R1	04.16.07
R2	06.1.07
R3	06.18.07

PROJECT NO:
CAD DWG FILE:
DRAWN BY: KM
CHECKED BY:
COPYRIGHT:
DESIGN PLUS, LLC
SHEET TITLE

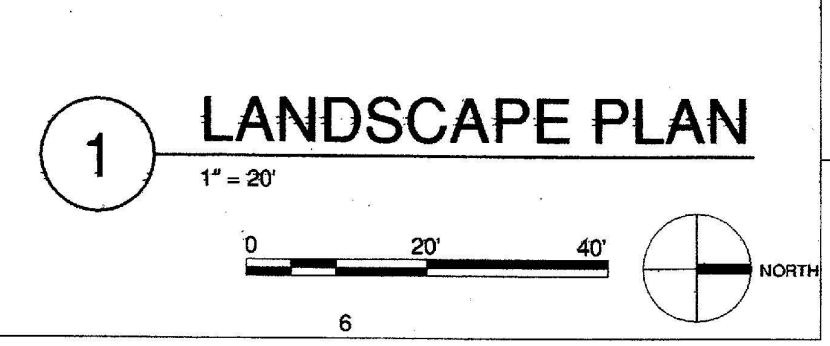

2415 PRINCETON DR. NE SUITE G-2
ALBUQUERQUE, NM 87107
505.843.7587 505.843.6775 (F)
www.designplusllc.com

DESIGN PLUS LLC

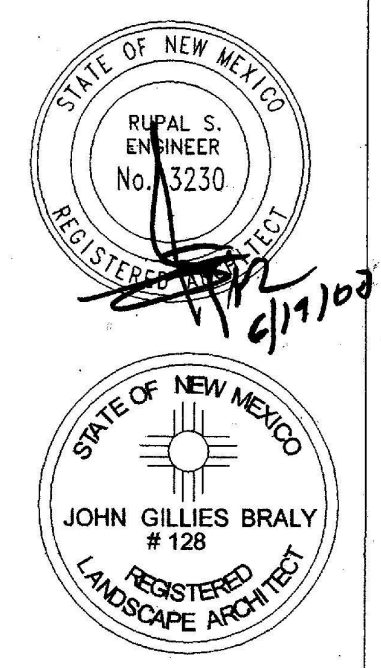


HANOVER BUSINESS CENTER

DATE: JUN. 15, 2007

PROJECT NO:
CAD DWG FILE:
DRAWN BY: KM
CHECKED BY:
COPYRIGHT:
DESIGN PLUS, LLC
SHEET TITLE

L100

SHEET ___ OF ___

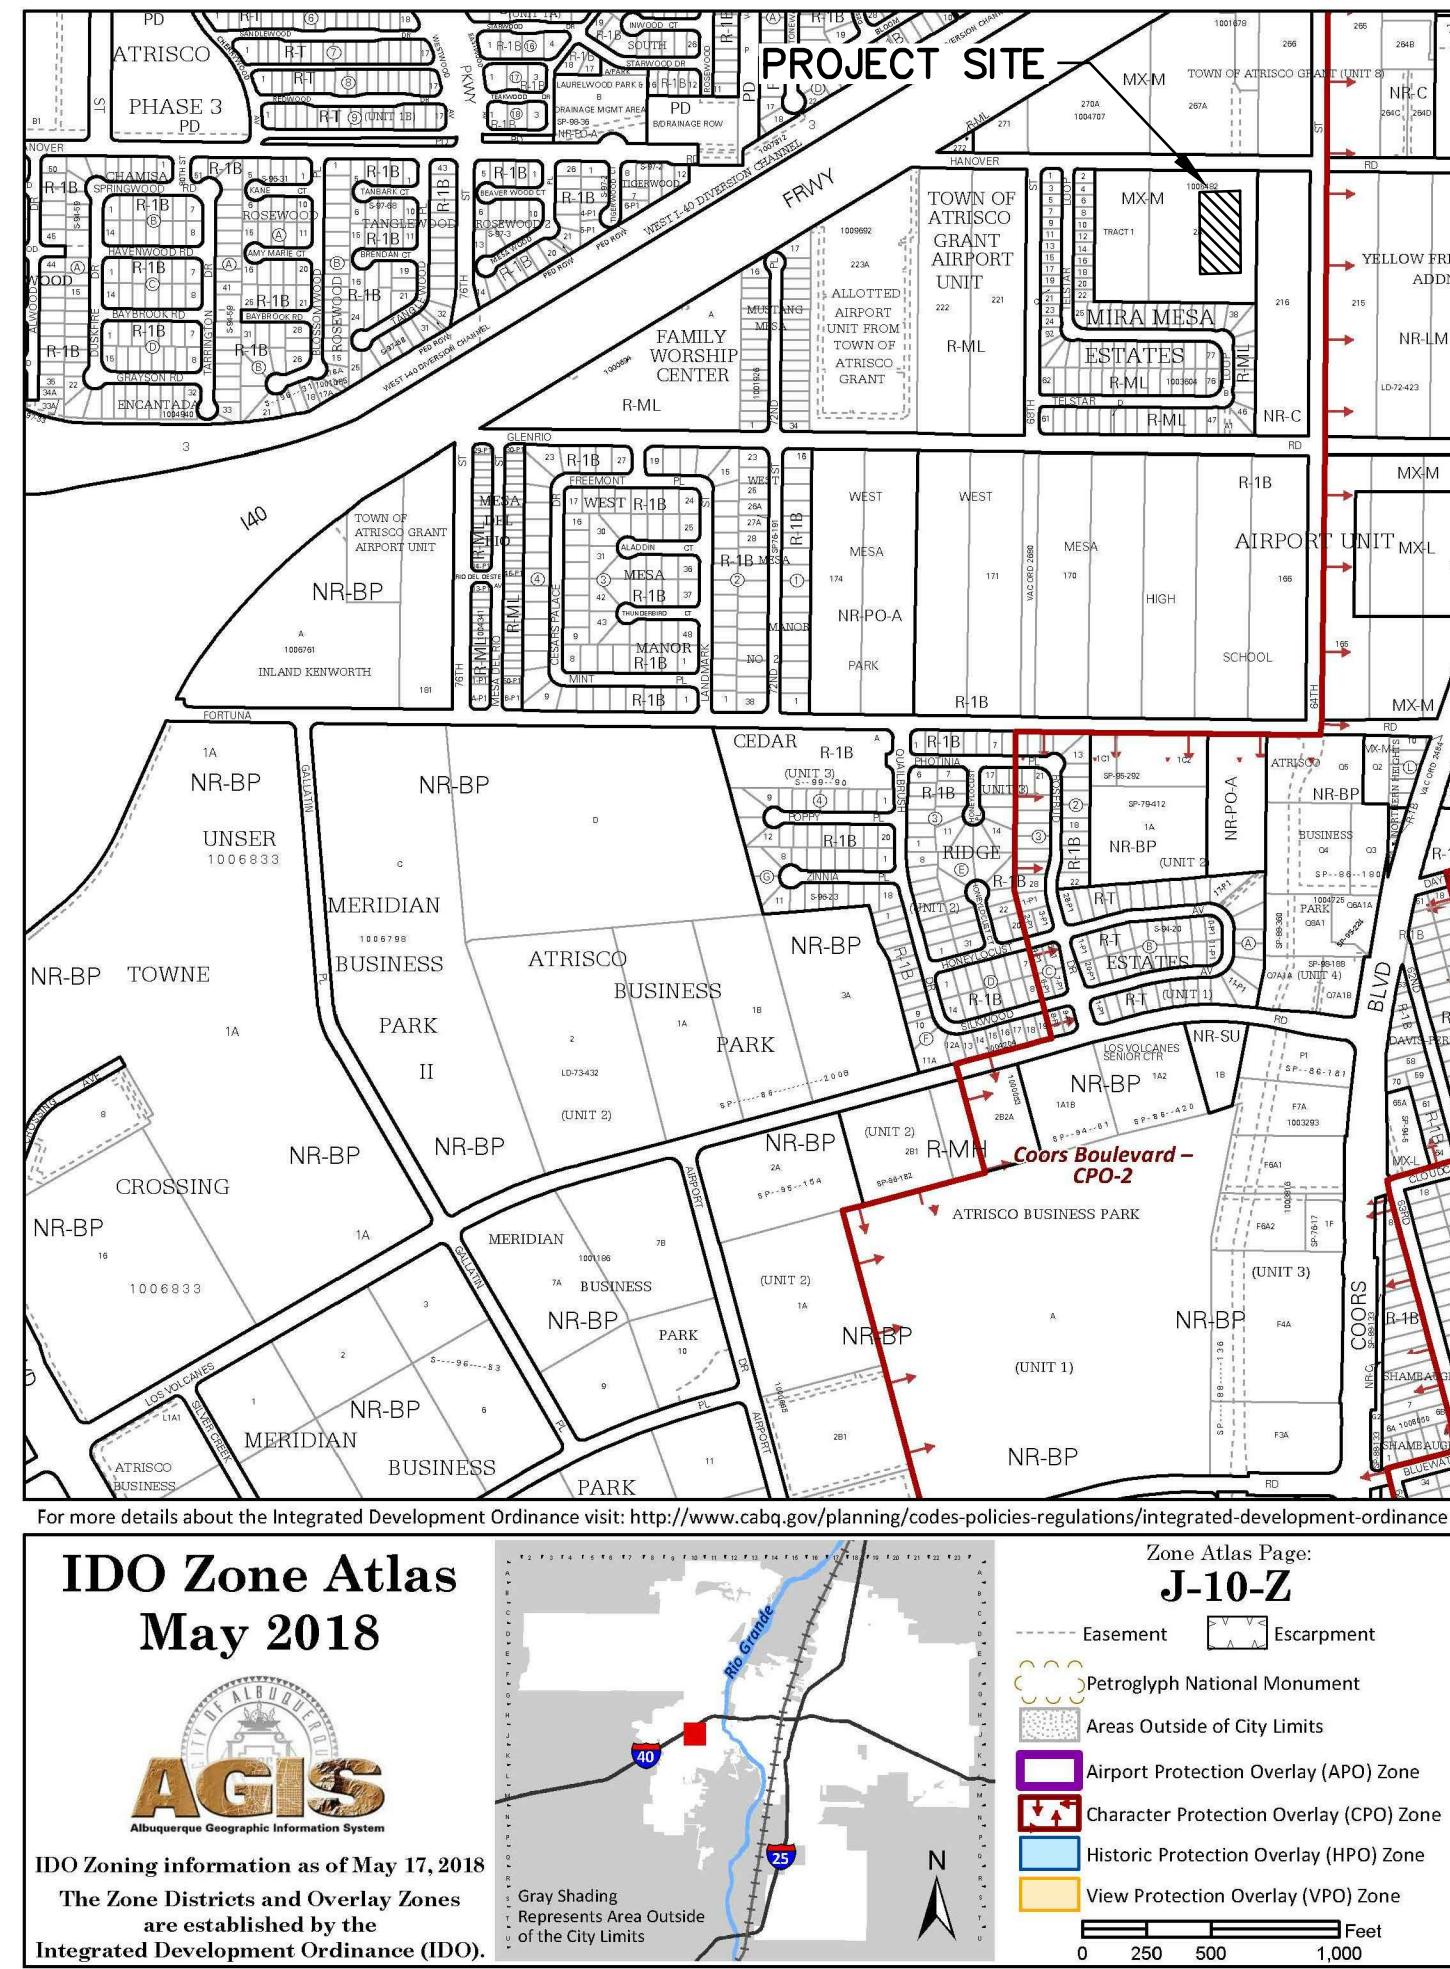

SITE LOCATION

The proposed site is an approximate 0.95-acre site located on Hanover Road NW. The site is bound on the south by Telstar Loop NW., on the west side by Telstar Loop NW., and the east side by an 64th Street.

EXISTING CONDITIONS

The existing site is estimated at 0.95 acres and is currently partially developed with a pad ready site and surrounding asphalt-paved parking lots. The site does not lie within a 100-year FEMA floodplain and is not impacted by offsite flows.

PROPOSED CONDITIONS

The proposed project would consist of a new commercial building to be placed within the pad ready envelope on the site. The finish floor of the new building will be set so that the existing overhead doors on the south side of the building can be accommodated with a 1% minimum grade. The site will also have new concrete sidewalks around the building for connectivity to the parking lot areas. Other areas around the building will be having with new asphalt paving as indicated on the G & D plan.

The site will experience additional runoff as outlined in the hydrology table on this sheet. The client has chosen to pay a fee in lieu of first flush ponding since there are no areas available on the existing site for a first flush pond.


CONCLUSIONS

When developed as indicated on the grading and drainage plan, the increased runoff from the site is estimated at 1.27 cfs, and 4,443 cf during the 100-year event. The first flush pond volume required for the project estimated at 1049 cf. The owner has chosen to pay a fee in lieu of first flush ponding.

GENERAL NOTES:

- EXISTING TOPOGRAPHIC DATA SHOWN ON THESE PLANS WAS PROVIDED BY SANDIA LAND SURVEYING LLC. MILLER ENGINEERING CONSULTANTS HAS UNDERTAKEN NO FIELD VERIFICATION OF THIS INFORMATION.
- ACS STA 6-G15 THE STATION IS LOCATED 2.2 MILES NORTH OF DOWNTOWN ALBUQUERQUE AT THE INTERSECTION OF CANDELARIA ROAD AND THE BNSF RAILROAD TRACKS. TO REACH THE STATION FROM THE INTERSECTION OF CANDELARIA ROAD AND I-25 NE, TRAVEL WEST ON CANDELARIA ROAD 0.8 MILES TO THE EAST SIDE OF THE BNSF RAILROAD TRACKS AND THE STATION ON THE RIGHT. THE STATION MARK IS A CITY OF ALBUQUERQUE SURVEY CONTROL 3" BRASS DISC STAMPED "6-G15 1979" SET IN A TRAFFIC SIGNAL BOX 0.6 FEET BELOW THE SURFACE OF THE GROUND ELEV. 4975.35 (NAVD 1988)
- THE CONTRACTOR IS RESPONSIBLE FOR ALL TEMPORARY SEDIMENT AND EROSION CONTROL DEVICES DURING THE CONSTRUCTION PHASE.
- CONTRACTOR SHALL OBTAIN A GRADING PERMIT FROM THE CITY OF ALBUQUERQUE, PRIOR TO ANY GRADING OR CONSTRUCTION.
- TWO WORKING DAYS PRIOR TO ANY EXCAVATION CONTRACTOR MUST CONTACT LINE LOCATING SERVICE 260-1990 FOR LOCATION OF EXISTING UTILITIES.
- ALL EMBANKMENTS SHALL BE PLACED AND COMPACTED IN LIFTS OF MAXIMUM OF 8". THE EMBANKMENTS SHALL BE WETTED AND COMPACTED TO 95% OPTIMUM DENSITY PER ASTM D1557 AND 95% UNDER ALL STRUCTURES INCLUDING DRIVEWAYS AND PARKING LOTS.
- MAINTENANCE OF THESE FACILITIES SHALL BE THE RESPONSIBILITY OF THE OWNER(S) OF THE PROPERTY SERVED.
- THE CONTRACTOR SHALL FIELD VERIFY LOCATION AND SIZE OF ALL UTILITIES PRIOR TO CONSTRUCTION.
- THE SUBJECT PROPERTY IS LOCATED WITHIN ZONE X (500 YEAR) DESIGNATING AREAS DETERMINED TO BE OUTSIDE THE 100-YEAR FLOOD PLANE ACCORDING TO THE FLOOD INSURANCE RATE MAP, ALBUQUERQUE, NEW MEXICO AND UNINCORPORATED AREAS PER MAP NO 35001C 0332G.
- ALL WORK PERFORMED SHALL COMPLY WITH THE REQUIREMENTS OF THE CITY OF ALBUQUERQUE STORM DRAINAGE REGULATIONS. ALL WORK PERFORMED SHALL COMPLY WITH THE REQUIREMENTS OF THE CITY OF ALBUQUERQUE "GRADING AND DRAINAGE DESIGN REQUIREMENTS AND POLICIES FOR LAND DEVELOPMENT."
- THE OWNER, CONTRACTOR AND/OR BUILDER SHALL COMPLY WITH ALL APPROPRIATE LOCAL, STATE AND FEDERAL REGULATIONS AND REQUIREMENTS.
- THE CONTRACTOR SHALL TAKE ALL APPROPRIATE AND REASONABLE MEASURES TO PREVENT SEDIMENT OR POLLUTANT LADEN STORM WATER FROM EXITING THE SITE DURING CONSTRUCTION. STORMWATER MAY BE DISCHARGED IN A MANNER, WHICH COMPLIES WITH THE APPROVED GRADING AND DRAINAGE PLAN.
- THE CONTRACTOR SHALL TAKE ALL APPROPRIATE MEASURES TO PREVENT THE MOVEMENT OF CONSTRUCTION RELATED SEDIMENT, DUST, MUD, POLLUTANTS, DEBRIS, WASTE, ETC FROM THE SITE BY WIND, STORM FLOW OR ANY OTHER METHOD EXCLUDING THE INTENTIONAL, LEGAL TRANSPORTATION OF SAME IN A MANNER ACCEPTABLE BY THE CITY.
- THE CONTRACTOR SHALL NOT DISTURB AREAS OUTSIDE THE AREAS SHOWN AS "SLOPE LIMITS" ON THE GRADING AND DRAINAGE PLAN.
- SEE ARCHITECTURAL DRAWINGS FOR SIDEWALK AND HANDICAPPED RAMPS, DETAILS AROUND THE BUILDING.
- THE CONTRACTOR SHALL CONTACT THE PROJECT ENGINEER FOR CLARIFICATION IF THERE ARE ANY SPOT ELEVATIONS ON THE GRADING AND DRAINAGE PLAN WHICH APPEAR TO BE AMBIGUOUS OR DO NOT MEET THE INTENT OF THE GRADING AND DRAINAGE PLAN.
- THE CONTRACTOR SHALL CONTACT THE PROJECT ENGINEER FOR CLARIFICATION IF THERE ARE SIDEWALKS OR CONCRETE FLATWORK WHICH DOES NOT MEET ADA ACCESSIBILITY REQUIREMENTS. ALL SIDEWALKS SHALL HAVE A MAXIMUM CROSS SLOPE OF 2.0%, ALL SIDEWALKS SHALL HAVE A MAXIMUM LONGITUDINAL SLOPE OF 5.0%, AND ALL RAMPS SHALL HAVE A MAXIMUM LONGITUDINAL SLOPE OF 15:1.
- ALL SIDEWALKS AND CONCRETE FLATWORK SHALL HAVE A MINIMUM OF 0.5% SLOPE. CONTRACTOR SHALL CONTACT PROJECT ENGINEER IF THERE ARE SIDEWALKS OR CONCRETE FLATWORK WHICH DO NOT MEET THIS REQUIREMENT.
- THE CONTRACTOR SHALL SUBMIT MATERIAL SUBMITTALS, CUT SHEETS AND SHOP DRAWINGS FOR ALL CIVIL RELATED ITEMS FOR REVIEW PRIOR TO CONSTRUCTION.
- THIS PROJECT SHALL BE CONSTRUCTED IN ACCORDANCE WITH THE CITY OF ALBUQUERQUE STANDARD SPECIFICATIONS (UPDATE 8, AMENDMENT 1)
- ALL EXISTING MANHOLES, VALVES AND METERS SHALL BE ADJUSTED TO NEW FINISH GRADE.

B1 VICINITY MAP
SCALE: NOT TO SCALE

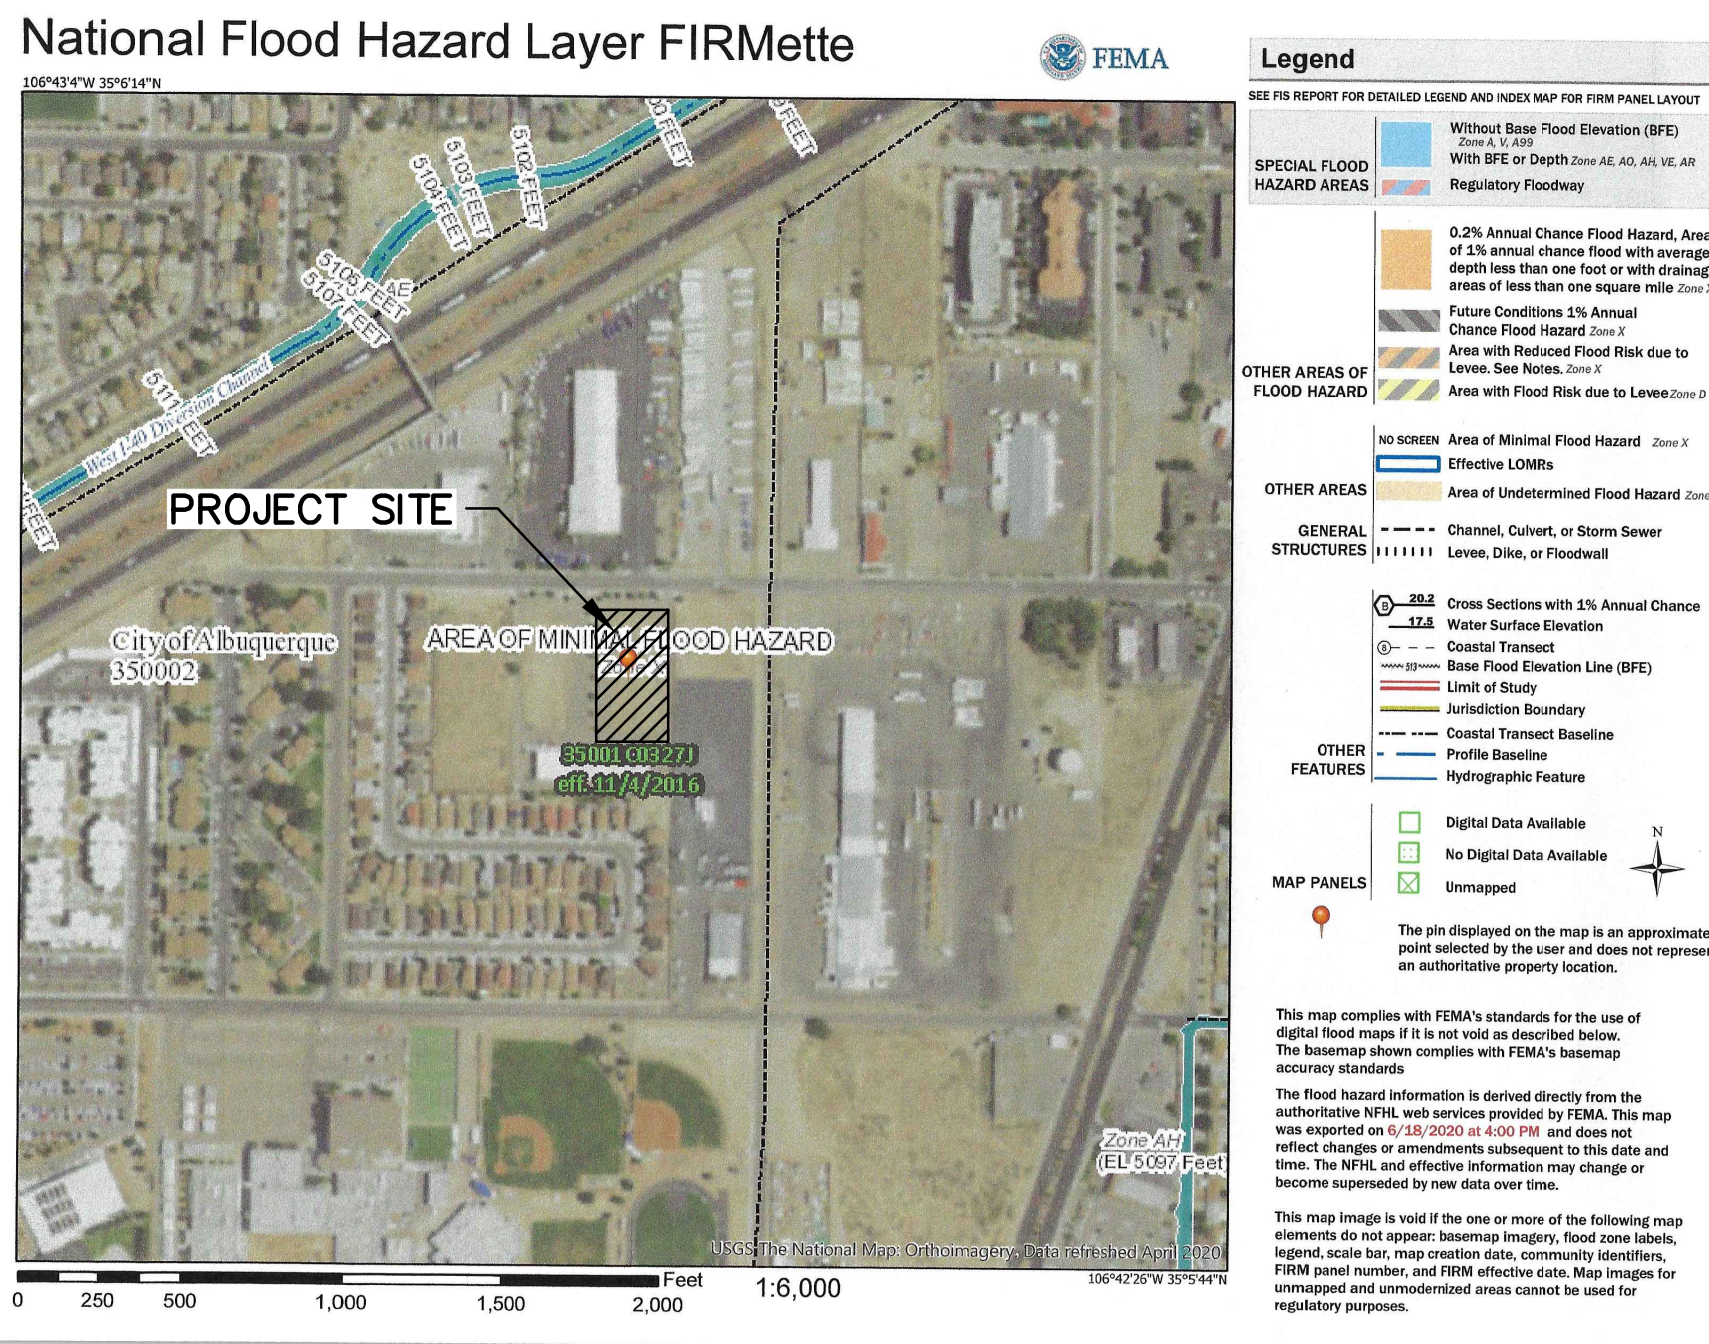

A1 FLOOD ZONE MAP
FLOOD ZONE MAP: 35001C0327J

HYDROLOGY

Precipitation Zone 1 - 100-year Storm P(360) = 2.20 in P(1440) = 2.66 in

Basin	Basin Area (Ac)	Land Treatment Factors				Ew (in)	V(100-6) (af)	V(100-24) (af)	Q(100) (cfs)
		A	B	C	D				
Existing Conditions									
A	0.95	0.00	0.00	0.95	0.00	0.99	0.078	0.078	2.73
Total	0.95								2.73
Proposed Conditions									
A	0.95	0.00	0.00	0.10	0.85	1.87	0.148	0.180	4.00
Total	0.95								4.00


FIRST FLUSH CALCULATIONS


FIRST FLUSH = (0.34" * 34,0265 SF) / 12 = 1049 CF

CIVIL DRAWING INDEX

SHEET No.	SHEET TITLE
C-100	HYDROLOGY PLAN AND DRAWING INDEX
C-101	GRADING AND DRAINAGE PLAN
C-501	MISCELLANEOUS DETAILS


No	Revision	Item	Date
SCOTT C. ANDERSON & ASSOCIATES ARCHITECTS 4419 4th St NW STE B ALBUQUERQUE, NM 87107 505.401.7175			
WAREHOUSE BUILDING 6500 HANOVER RD NW ALBUQUERQUE, NM 87121			
DRAWING TITLE: HDROLOGY PLAN			
DESIGNED	MEC	PROJECT NO.	
DRAWN	MEC	SCALE	NOTED
CHECKED	VAM	DRAWING NO.	
REVIEWED			
DATE	7/09/20		
		C-100 OF	

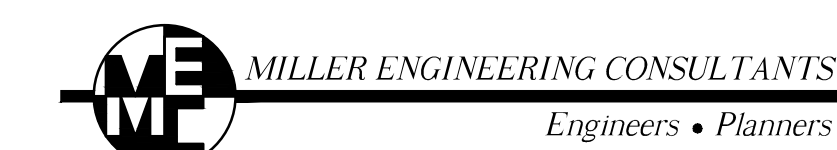

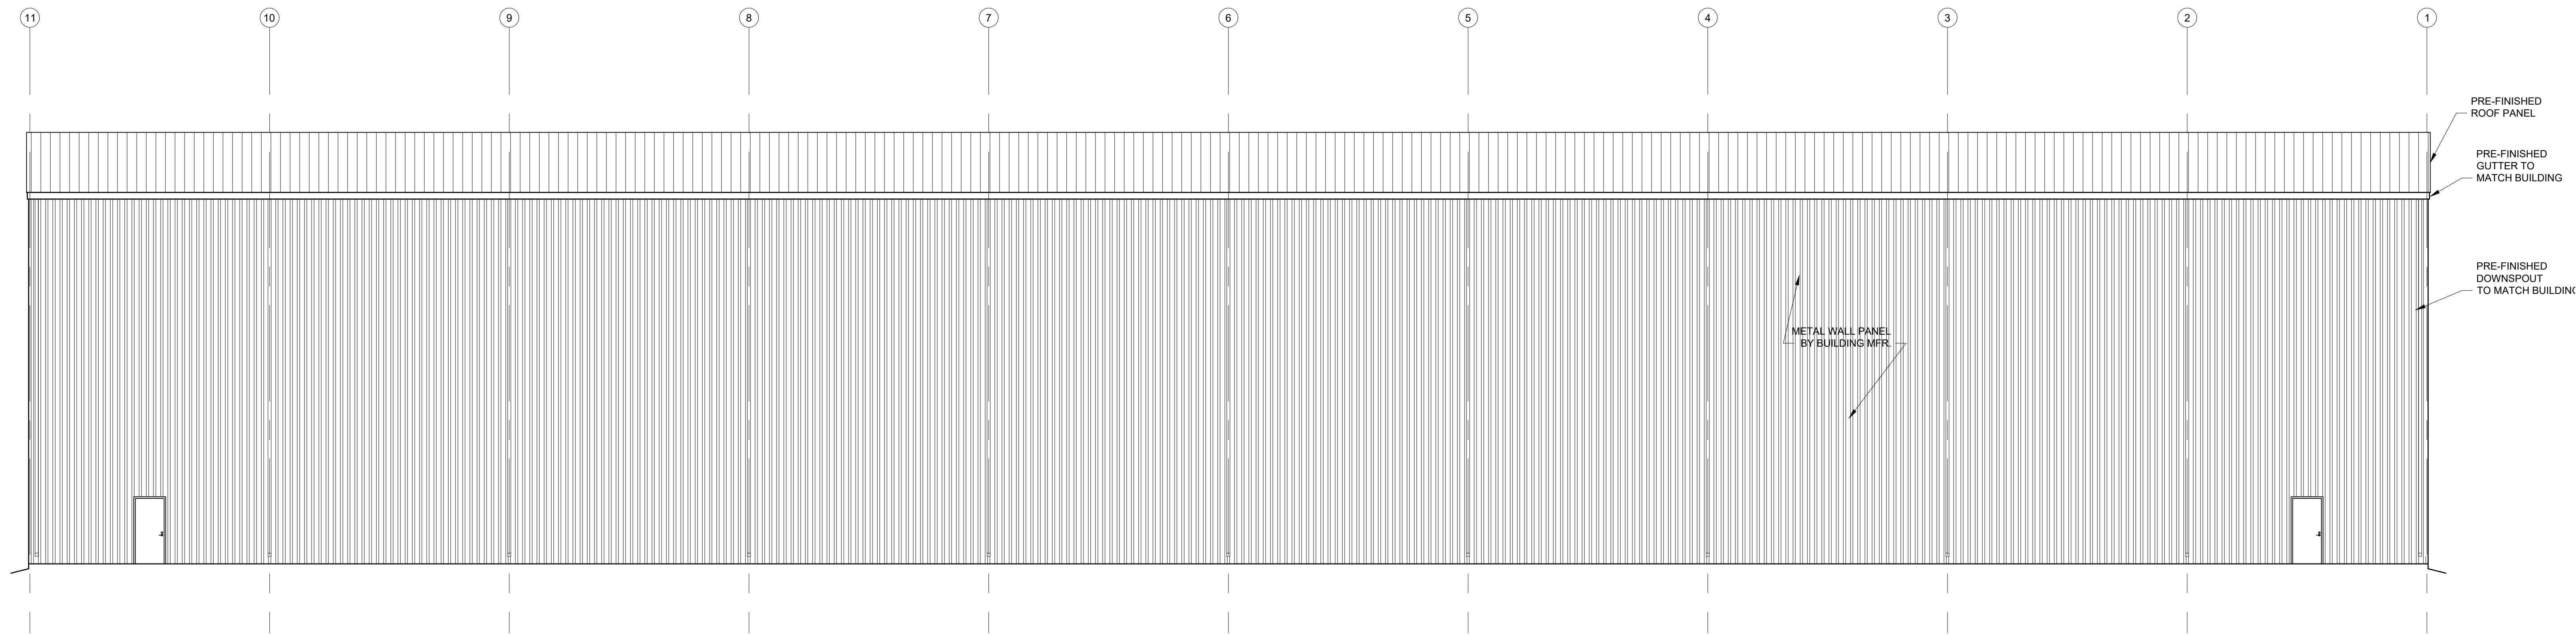

WEST ELEVATION

SCALE: 1/8" = 1'-0"

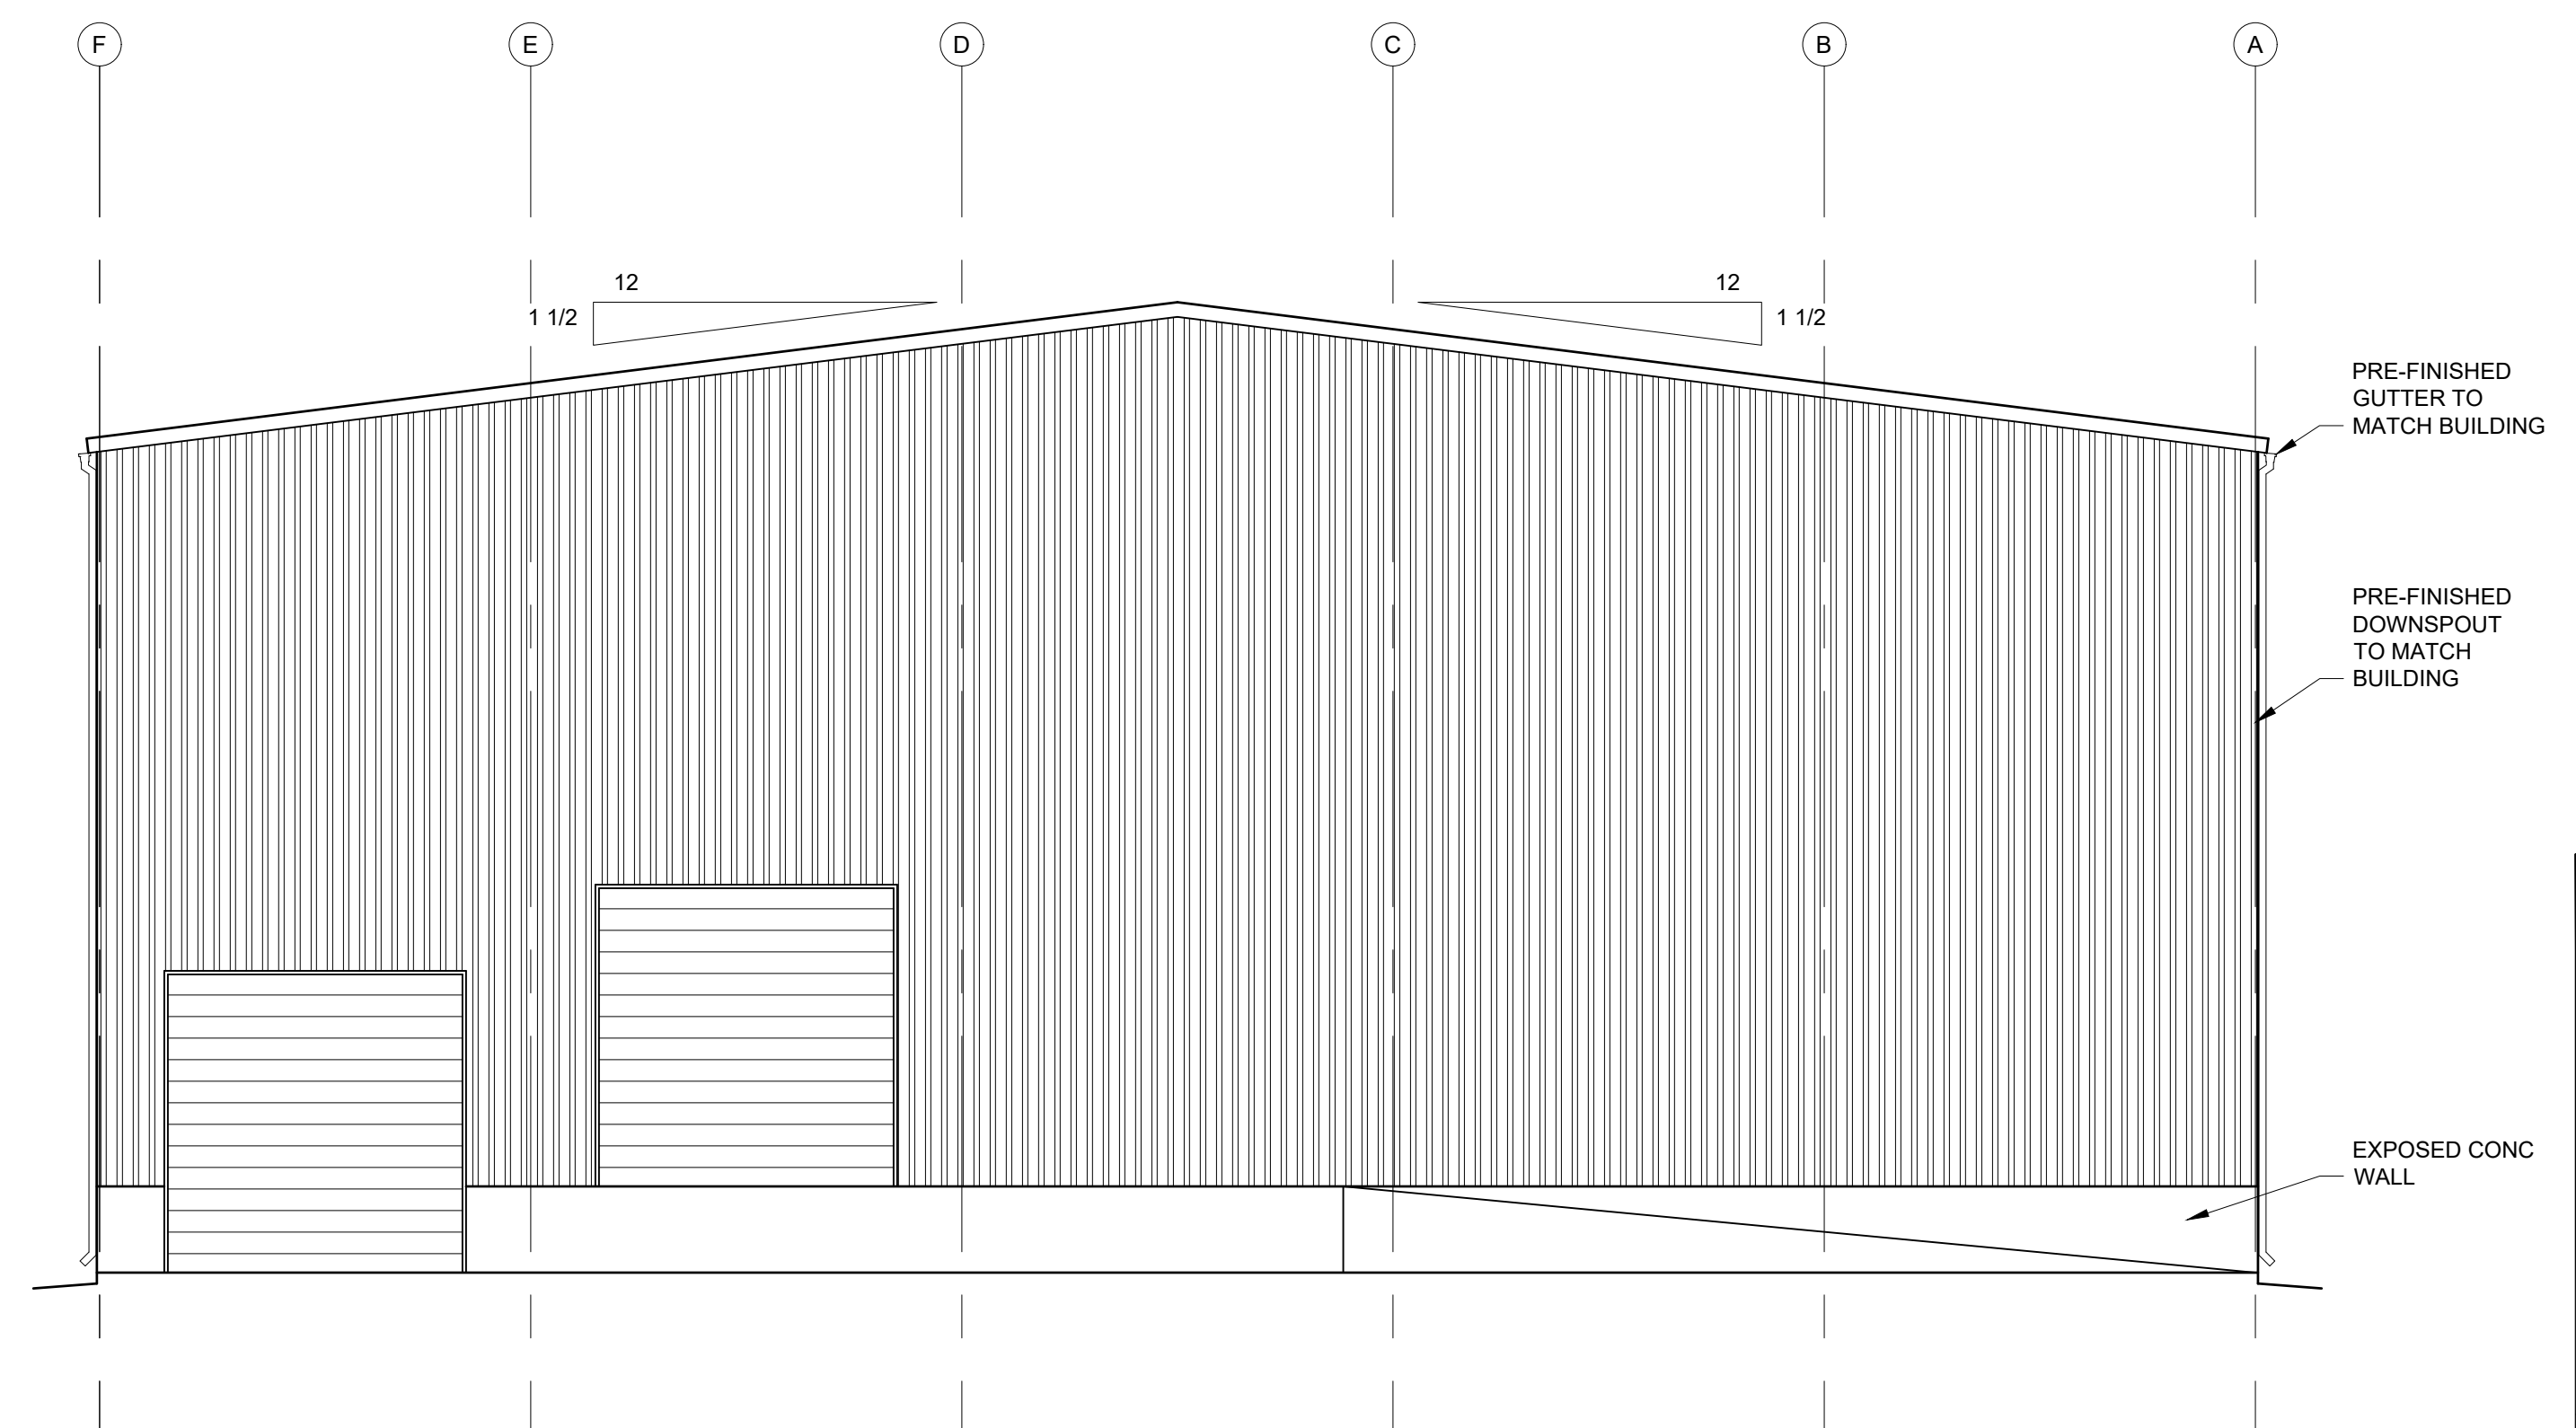

NORTH ELEVATION

SCALE: 1/8" = 1'-0"


No	Revision	Item	Date

SCOTT C. ANDERSON & ASSOCIATES ARCHITECTS
 4419 4th St. NW Ste. B
 ALBUQUERQUE, NM 87107
 scott@scottanderson.com 505.461.7575

WAREHOUSE BUILDING
 6500 HANOVER RD NW
 ALBUQUERQUE, NM 87121


DRAWING TITLE: **BUILDING ELEVATIONS**

SEAL STATE OF NEW MEXICO SCOTT C. ANDERSON No. 4342 3/5/2020 REGISTERED ARCHITECT	DESIGNED	PROJECT NO
	DRAWN	SCALE
	CHECKED	DRAWING NO
	REVIEWED	A-201
	DATE 6/11/2020	OF

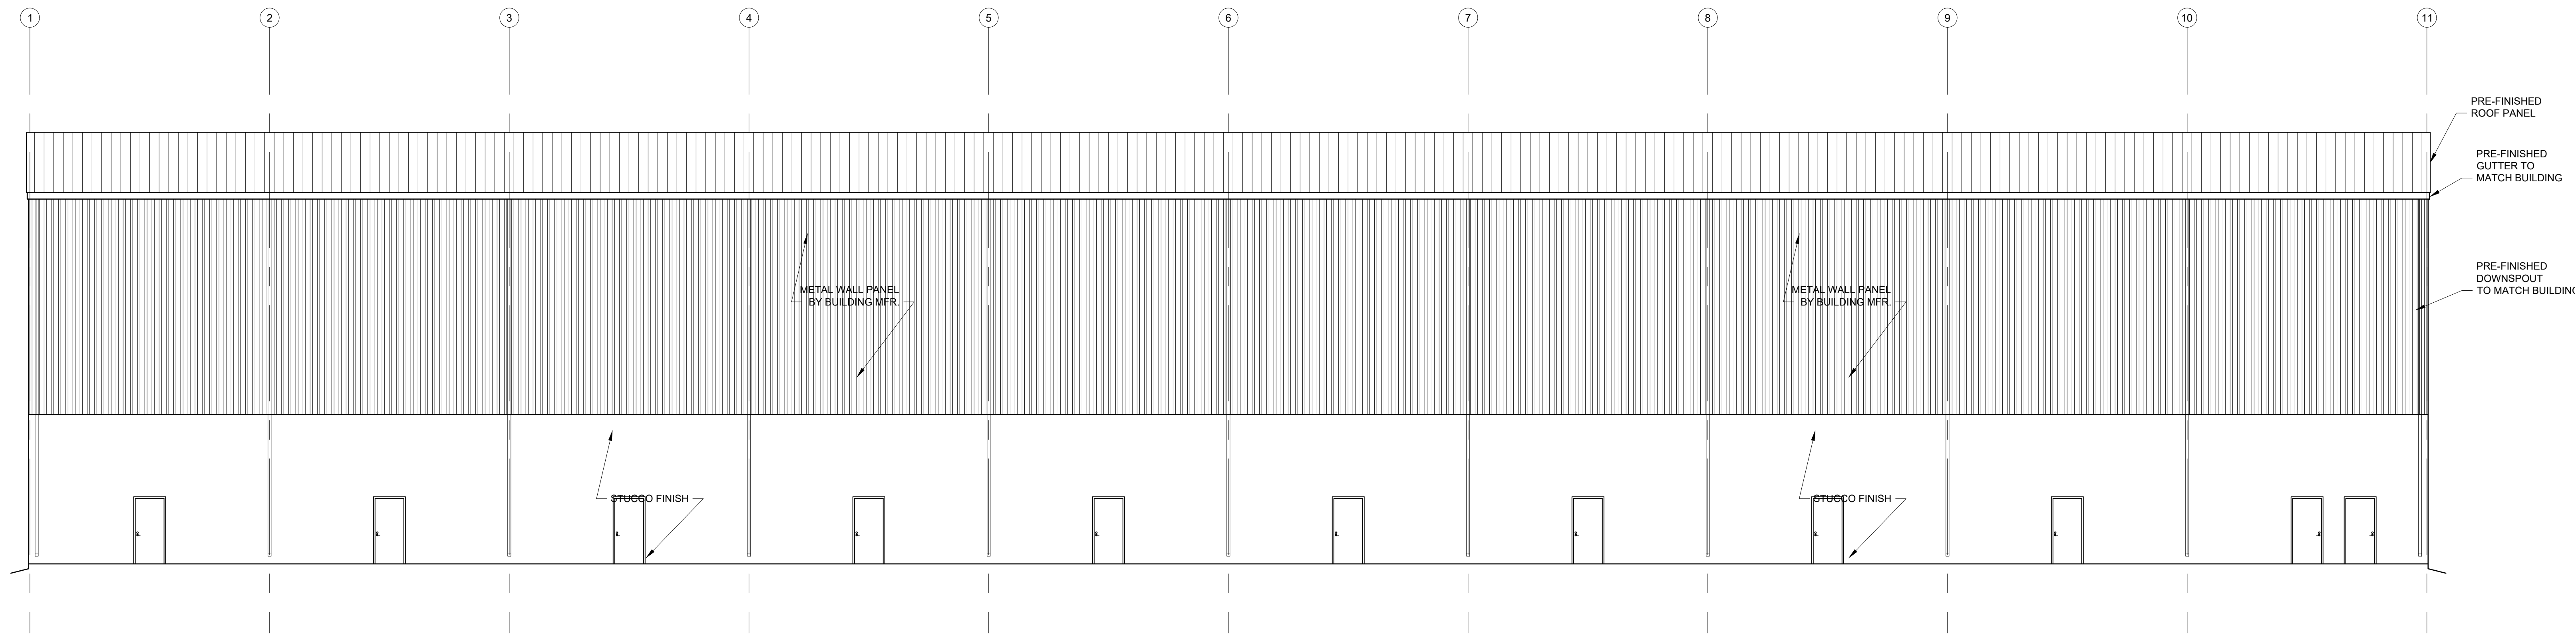

EAST ELEVATION

SCALE: 1/8" = 1'-0"

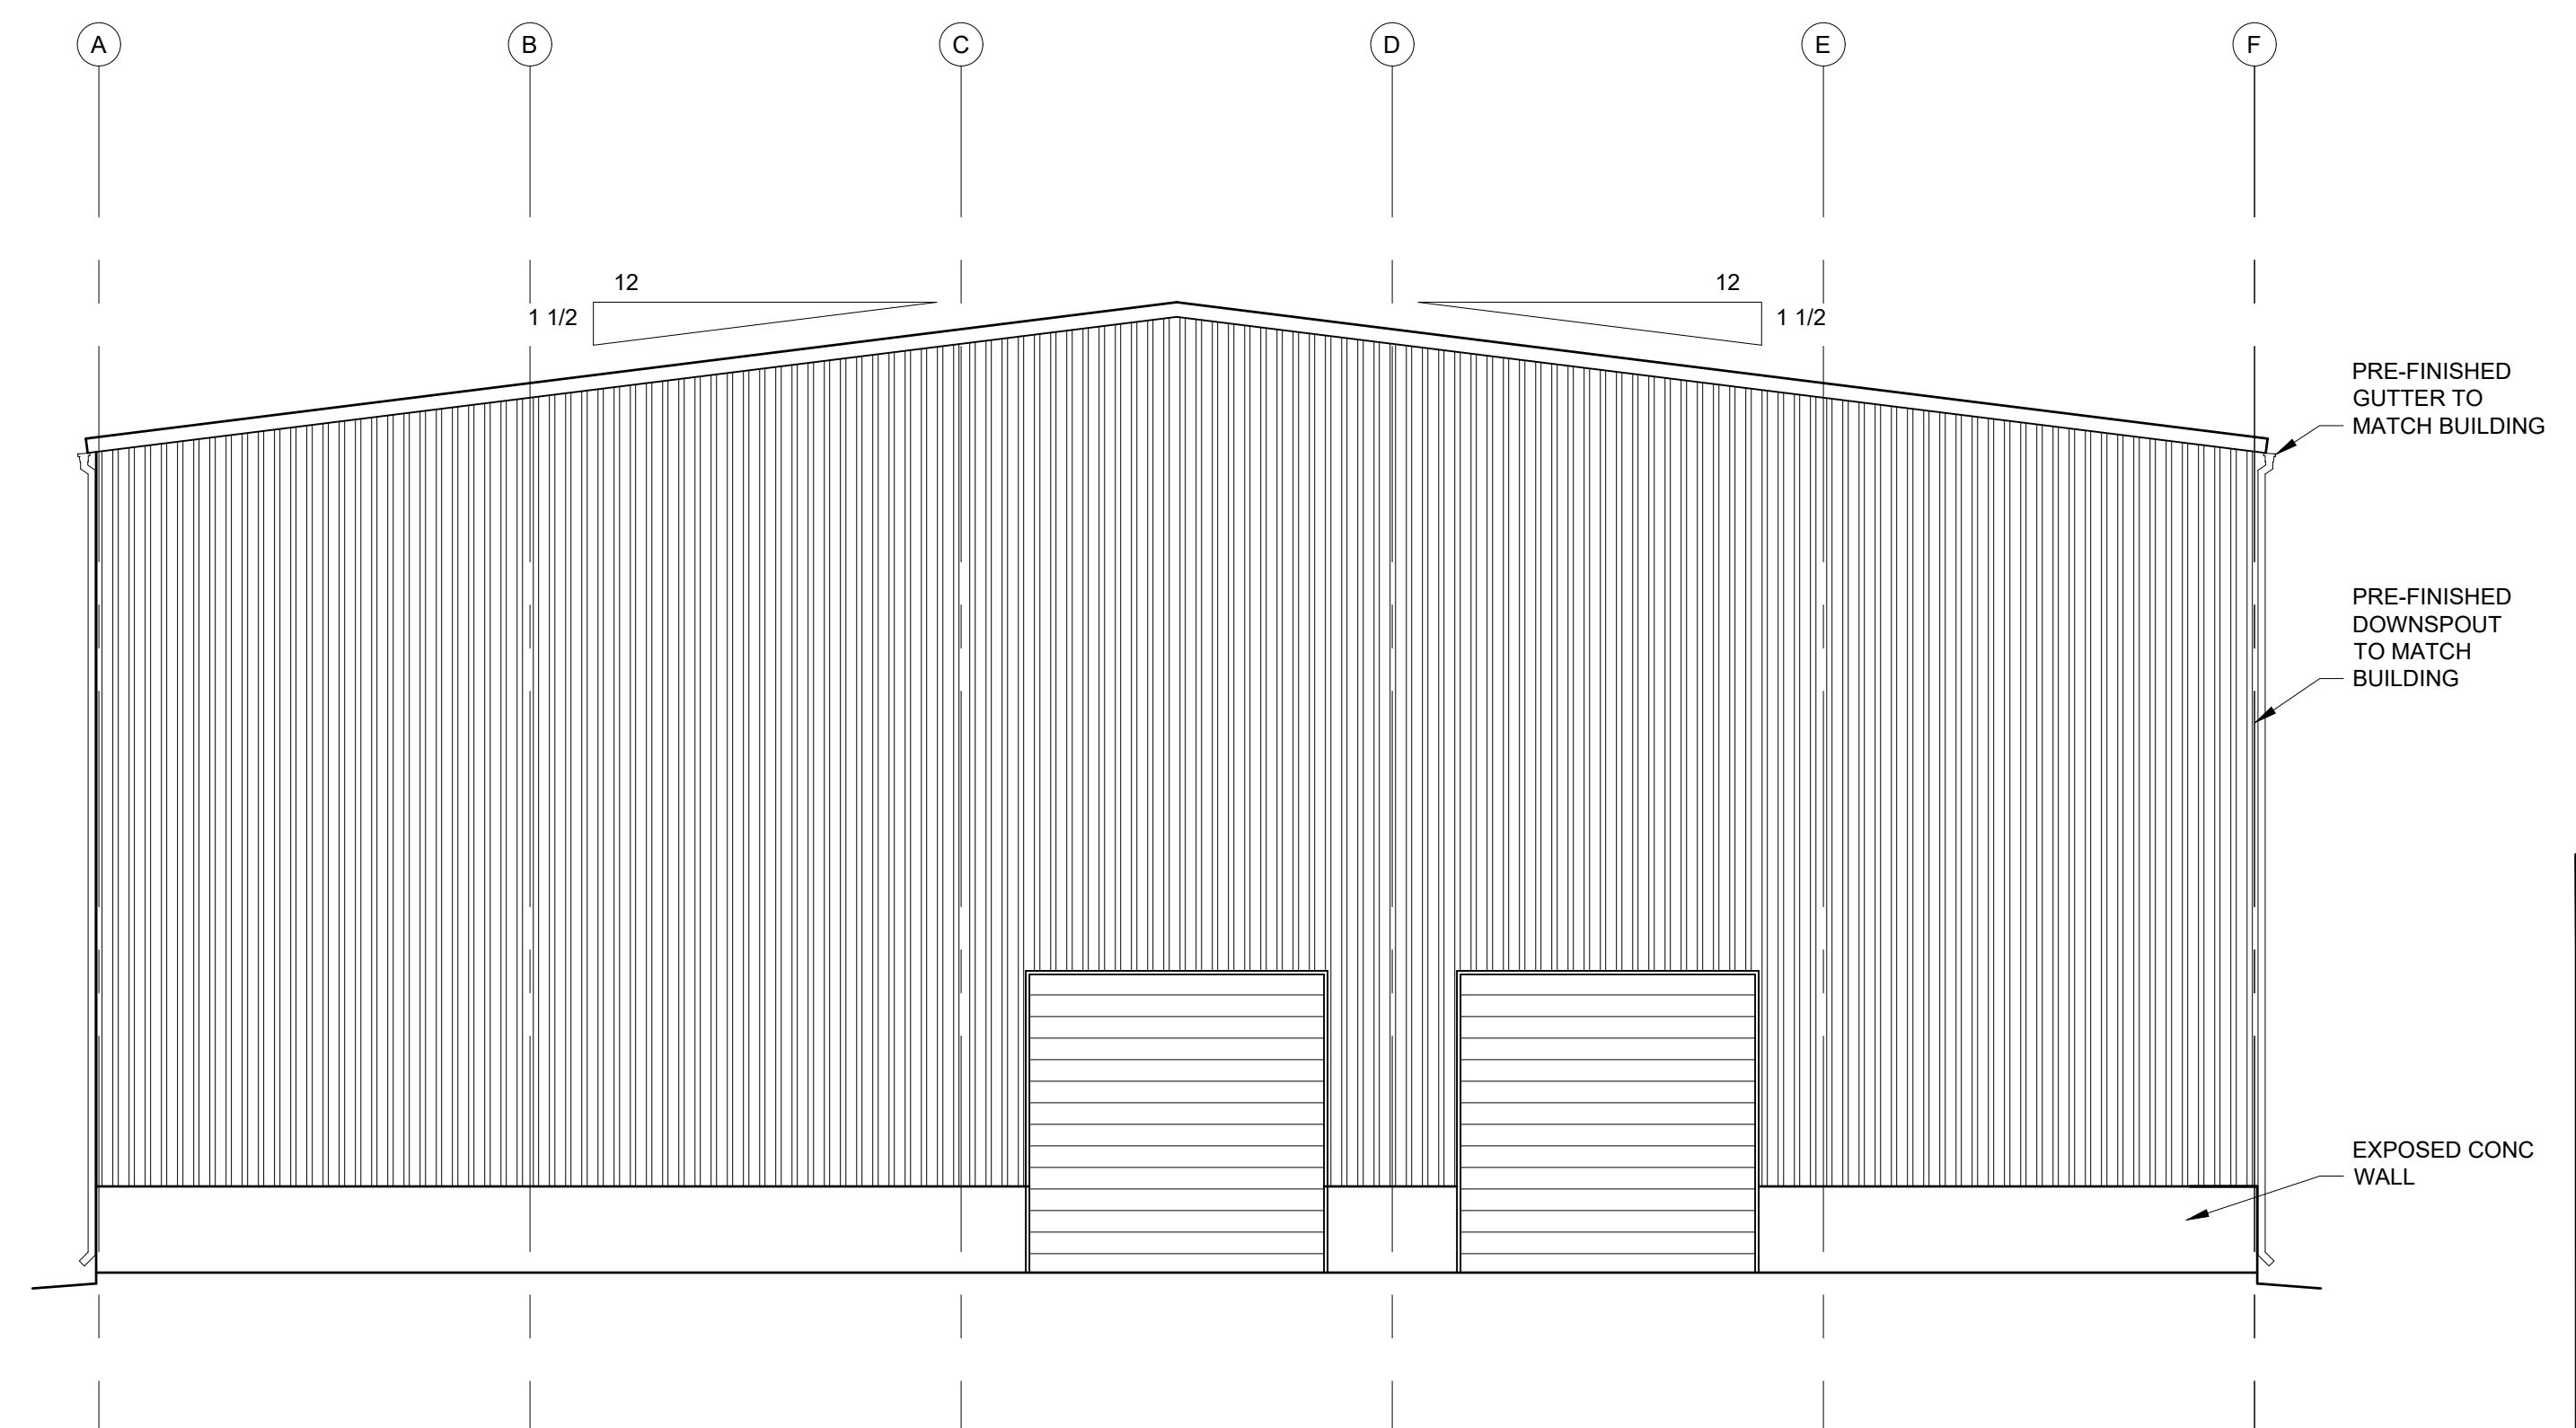


SOUTH ELEVATION

SCALE: 1/8" = 1'-0"

No	Revision	Item	Date

<p>SCOTT C. ANDERSON & associates architects 4419 4th St. NW Ste. B Albuquerque, NM 87107 scott@scottcanderson.com 505.461.7575</p>	<p>WAREHOUSE BUILDING 6500 HANOVER RD NW ALBUQUERQUE, NM 87121</p>	
	<p>DRAWING TITLE BUILDING ELEVATIONS</p>	
<p>SEAL STATE OF NEW MEXICO SCOTT C. ANDERSON No. 4342 3/5/2020 REGISTERED ARCHITECT</p>	<p>DESIGNED DRAWN CHECKED REVIEWED DATE 6/11/2020</p>	<p>PROJECT NO SCALE DRAWING NO A-202 OF</p>

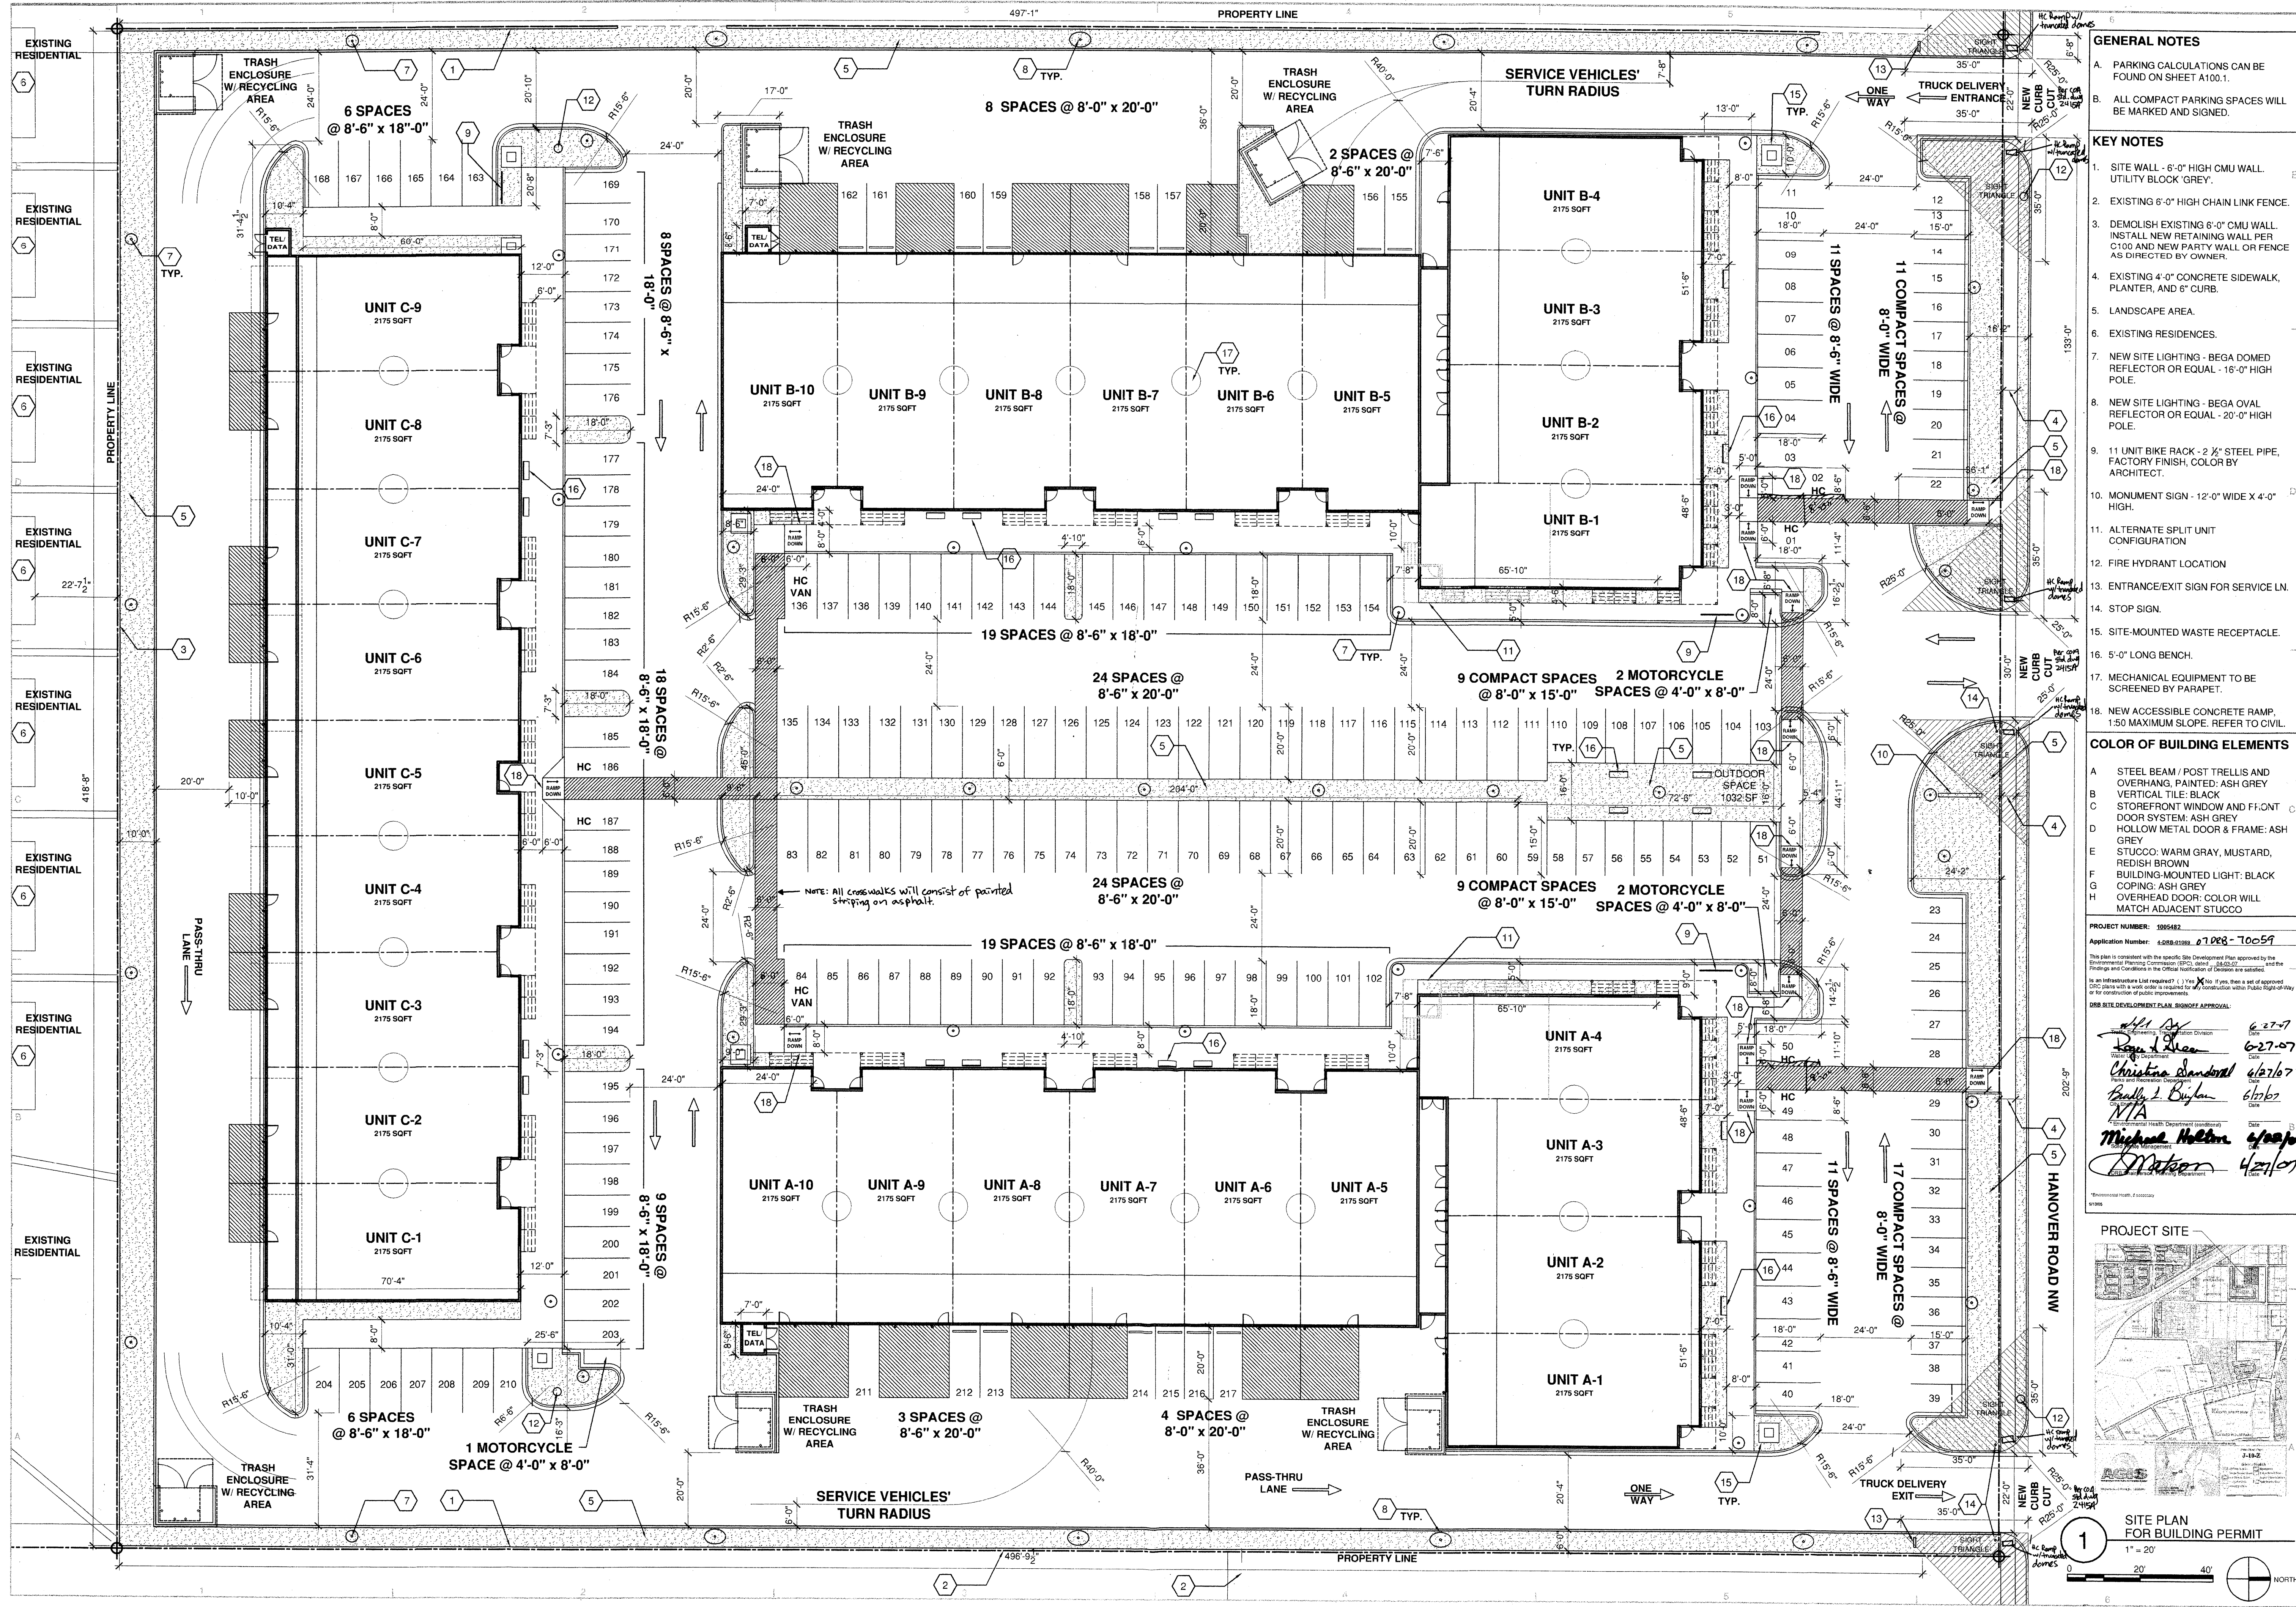

GENERAL NOTES

- PARKING CALCULATIONS CAN BE FOUND ON SHEET A100.1.
- ALL COMPACT PARKING SPACES WILL BE MARKED AND SIGNED.


KEY NOTES

- SITE WALL - 6'-0" HIGH CMU WALL. UTILITY BLOCK 'GREY'.
- EXISTING 6'-0" HIGH CHAIN LINK FENCE.
- DEMOLISH EXISTING 6'-0" CMU WALL. INSTALL NEW RETAINING WALL PER C100 AND NEW PARTY WALL OR FENCE AS DIRECTED BY OWNER.
- EXISTING 4'-0" CONCRETE SIDEWALK, PLANTER, AND 6" CURB.
- LANDSCAPE AREA.
- EXISTING RESIDENCES.
- NEW SITE LIGHTING - BEGA DOMED REFLECTOR OR EQUAL - 18'-0" HIGH POLE.
- NEW SITE LIGHTING - BEGA OVAL REFLECTOR OR EQUAL - 20'-0" HIGH POLE.
- 11 UNIT BIKE RACK - 2 1/2" STEEL PIPE, FACTORY FINISH, COLOR BY ARCHITECT.
- MONUMENT SIGN - 12'-0" WIDE X 4'-0" HIGH.
- ALTERNATE SPLIT UNIT CONFIGURATION.
- FIRE HYDRANT LOCATION.
- ENTRANCE/EXIT SIGN FOR SERVICE LN.
- STOP SIGN.
- SITE-MOUNTED WASTE RECEPTACLE.
- 5'-0" LONG BENCH.
- MECHANICAL EQUIPMENT TO BE SCREENED BY PARAPET.
- NEW ACCESSIBLE CONCRETE RAMP. 1:50 MAXIMUM SLOPE. REFER TO CIVIL.

COLOR OF BUILDING ELEMENTS


A	STEEL BEAM / POST TRELIS AND OVERHANG. PAINTED: ASH GREY
B	STOREFRONT WINDOW AND FRONT DOOR SYSTEM: ASH GREY
C	FOLLOW METAL DOOR & FRAME: ASH GREY
D	STUCCO: WARM GRAY, MUSTARD, REDISH BROWN
E	BUILDING-MOUNTED LIGHT: BLACK
F	COPING: ASH GREY
G	OVERHEAD DOOR: COLOR WILL MATCH ADJACENT STUCCO

PROJECT NUMBER: 1005482
 Application Number: 62090000_01208-70059
 This plan is submitted with the Special Site Development Plan approved by the Environmental Planning Commission (EPC) on 6/27/07.
 As an Infrastructure List requirement, I, J, K, L, M, N, O, P, Q, R, S, T, U, V, W, X, Y, Z, AA, AB, AC, AD, AE, AF, AG, AH, AI, AJ, AK, AL, AM, AN, AO, AP, AQ, AR, AS, AT, AU, AV, AW, AX, AY, AZ, BA, BB, BC, BD, BE, BF, BG, BH, BI, BJ, BK, BL, BM, BN, BO, BP, BQ, BR, BS, BT, BU, BV, BW, BX, BY, BZ, CA, CB, CC, CD, CE, CF, CG, CH, CI, CJ, CK, CL, CM, CN, CO, CP, CQ, CR, CS, CT, CU, CV, CW, CX, CY, CZ, DA, DB, DC, DD, DE, DF, DG, DH, DI, DJ, DK, DL, DM, DN, DO, DP, DQ, DR, DS, DT, DU, DV, DW, DX, DY, DZ, EA, EB, EC, ED, EE, EF, EG, EH, EI, EJ, EK, EL, EM, EN, EO, EP, EQ, ER, ES, ET, EU, EV, EW, EX, EY, EZ, FA, FB, FC, FD, FE, FF, FG, FH, FI, FJ, FK, FL, FM, FN, FO, FP, FQ, FR, FS, FT, FU, FV, FW, FX, FY, FZ, GA, GB, GC, GD, GE, GF, GG, GH, GI, GJ, GK, GL, GM, GN, GO, GP, GQ, GR, GS, GT, GU, GV, GW, GX, GY, GZ, HA, HB, HC, HD, HE, HF, HG, HH, HI, HJ, HK, HL, HM, HN, HO, HP, HQ, HR, HS, HT, HU, HV, HW, HX, HY, HZ, IA, IB, IC, ID, IE, IF, IG, IH, II, IJ, IK, IL, IM, IN, IO, IP, IQ, IR, IS, IT, IU, IV, IW, IX, IY, IZ, JA, JB, JC, JD, JE, JF, JG, JH, JI, JJ, JK, JL, JM, JN, JO, JP, JQ, JR, JS, JT, JU, JV, JW, JX, JY, JZ, KA, KB, KC, KD, KE, KF, KG, KH, KI, KJ, KK, KL, KM, KN, KO, KP, KQ, KR, KS, KT, KU, KV, KW, KX, KY, KZ, LA, LB, LC, LD, LE, LF, LG, LH, LI, LJ, LK, LL, LM, LN, LO, LP, LQ, LR, LS, LT, LU, LV, LW, LX, LY, LZ, MA, MB, MC, MD, ME, MF, MG, MH, MI, MJ, MK, ML, MM, MN, MO, MP, MQ, MR, MS, MT, MU, MV, MW, MX, MY, MZ, NA, NB, NC, ND, NE, NF, NG, NH, NI, NJ, NK, NL, NM, NN, NO, NP, NQ, NR, NS, NT, NU, NV, NW, NX, NY, NZ, OA, OB, OC, OD, OE, OF, OG, OH, OI, OJ, OK, OL, OM, ON, OO, OP, OQ, OR, OS, OT, OU, OV, OW, OX, OY, OZ, PA, PB, PC, PD, PE, PF, PG, PH, PI, PJ, PK, PL, PM, PN, PO, PP, PQ, PR, PS, PT, PU, PV, PW, PX, PY, PZ, QA, QB, QC, QD, QE, QF, QG, QH, QI, QJ, QK, QL, QM, QN, QO, QP, QQ, QR, QS, QT, QU, QV, QW, QX, QY, QZ, RA, RB, RC, RD, RE, RF, RG, RH, RI, RJ, RK, RL, RM, RN, RO, RP, RQ, RR, RS, RT, RU, RV, RW, RX, RY, RZ, SA, SB, SC, SD, SE, SF, SG, SH, SI, SJ, SK, SL, SM, SN, SO, SP, SQ, SR, SS, ST, SU, SV, SW, SX, SY, SZ, TA, TB, TC, TD, TE, TF, TG, TH, TI, TJ, TK, TL, TM, TN, TO, TP, TQ, TR, TS, TT, TU, TV, TW, TX, TY, TZ, UA, UB, UC, UD, UE, UF, UG, UH, UI, UJ, UK, UL, UM, UN, UO, UP, UQ, UR, US, UT, UY, UZ, VA, VB, VC, VD, VE, VF, VG, VH, VI, VJ, VK, VL, VM, VN, VO, VP, VQ, VR, VS, VT, VU, VV, VW, VX, VY, VZ, WA, WB, WC, WD, WE, WF, WG, WH, WI, WJ, WK, WL, WM, WN, WO, WP, WQ, WR, WS, WT, WU, WV, WW, WX, WY, WZ, XA, XB, XC, XD, XE, XF, XG, XH, XI, XJ, XK, XL, XM, XN, XO, XP, XQ, XR, XS, XT, XU, XV, XW, XX, XY, XZ, YA, YB, YC, YD, YE, YF, YG, YH, YI, YJ, YK, YL, YM, YN, YO, YP, YQ, YR, YS, YT, YU, YV, YW, YX, YY, YZ, ZA, ZB, ZC, ZD, ZE, ZF, ZG, ZH, ZI, ZJ, ZK, ZL, ZM, ZN, ZO, ZP, ZQ, ZR, ZS, ZT, ZU, ZV, ZW, ZX, ZY, ZZ.

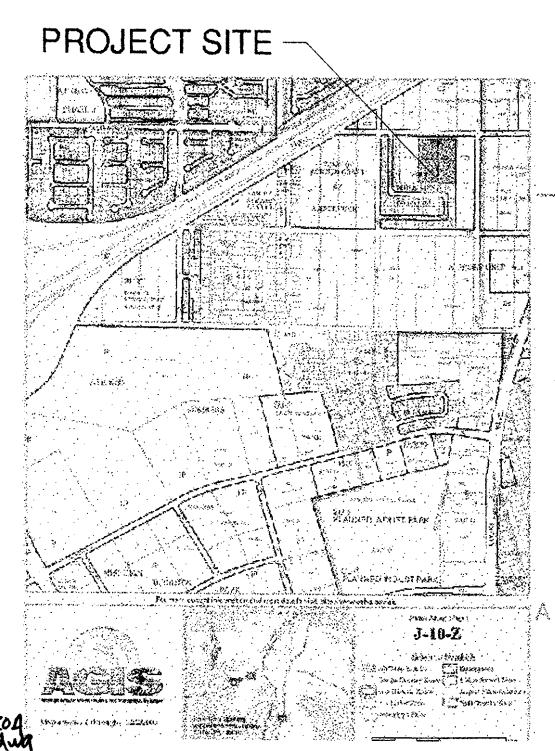

SITE PLAN FOR BUILDING PERMIT
 1" = 20'
 NORTH

2415 PRINCETON DR. NE, SUITE G-2
 ALBUQUERQUE, NM 87107
 505.843.7587, 505.843.6773 (F)
 www.designplusllc.com

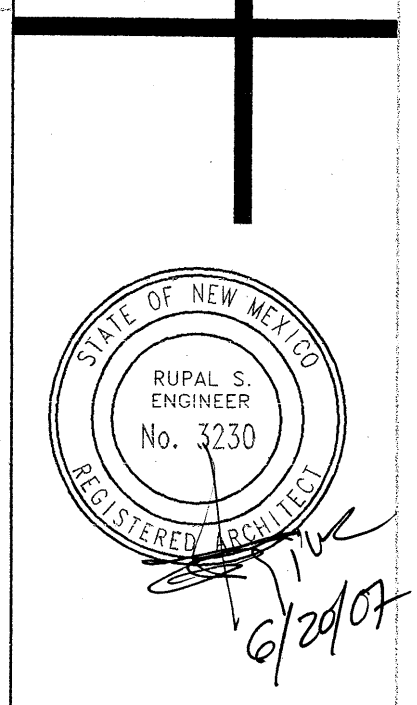

DATE: JUN. 20, 2007

REVISIONS

R1	04.16.07
R2	05.30.07

PROJECT NO:
 CAD DWG FILE:
 DRAWN BY: KM, JA
 CHECKED BY: RE, MJ
 COPYRIGHT:
 DESIGN PLUS, LLC
 SHEET TITLE

A-100

DESIGN PLUS LLC

HANOVER BUSINESS PARK

1005482