


PLANT SCHED	DULE			
SYMBOL	BOTANICAL / COMMON NAME	HT. & SPD.	CAL.	QTY
TREES				
	CELTIS LAEVIGATA RETICULATA NETLEAF HACKBERRY	25` X 25`	2" CAL.	6
	CHILOPSIS LINEARIS DESERT WILLOW	20` X 20`	2" CAL.	12
	JUNIPERUS SCOPULORUM ROCKY MOUNTAIN JUNIPER	30, X 50,	6` - 8` HT. B&B	7
	SAPINDUS DRUMMONDII WESTERN SOAPBERRY	25` X 30`	2" CAL.	5
	VITEX AGNUS-CASTUS CHASTE TREE	15` X 15`	2" CAL.	5

SYMBOL	BOTANICAL / COMMON NAME	HT. & SPR.	SIZE	QTY
SHRUBS				
~~~~~~~~~~~~~~~~~~~~~~~~~~~~~~~~~~~~~~	ARTEMISIA FILIFOLIA SAND SAGEBRUSH	3` X 4`	5 GAL.	57
$\odot$	CERCOCARPUS LEDIFOLIUS CURL-LEAF MOUNTAIN MAHOGANY	12` X 10`	5 GAL.	22
$\bigcirc$	CHAMAEBATIARIA MILLEFOLIUM FERNBUSH	5` X 5`	5 GAL.	1
-signa-	FALLOPIA AUBERTII SILVER LACE VINE	5 LBS		2
•	PENSTEMON PINIFOLIUS PINELEAF PENSTEMON POTENTILLA FRUTICOSA	1` X 2`	1 GAL.	25
O	'GOLDFINGER' GOLDFINGER BUSH CINQUEFOIL	3, X 3,	1 GAL.	44
	SALVIA DORRII DESERT SAGE	2` X 3`	1 GAL.	33
Φ	TEUCRIUM CHAMAEDRYS GERMANDER	1` X 2`	1 GAL.	35
GRASSES				
<b>©</b>	BOUTELOUA CURTIPENDULA SIDE OATS GRAMA	3` X 2`	1 GAL.	121
$\oplus$	MUHLENBERGIA RIGENS DEER GRASS	4` X 4`	1 GAL.	65
₹ <b>.</b> }	NOLINA MICROCARPA SACAHUISTA	6` X 4`	1 GAL.	12
*	NOLINA TEXANA TEXAS SACAHUISTA	2` X 2`	1 GAL.	1

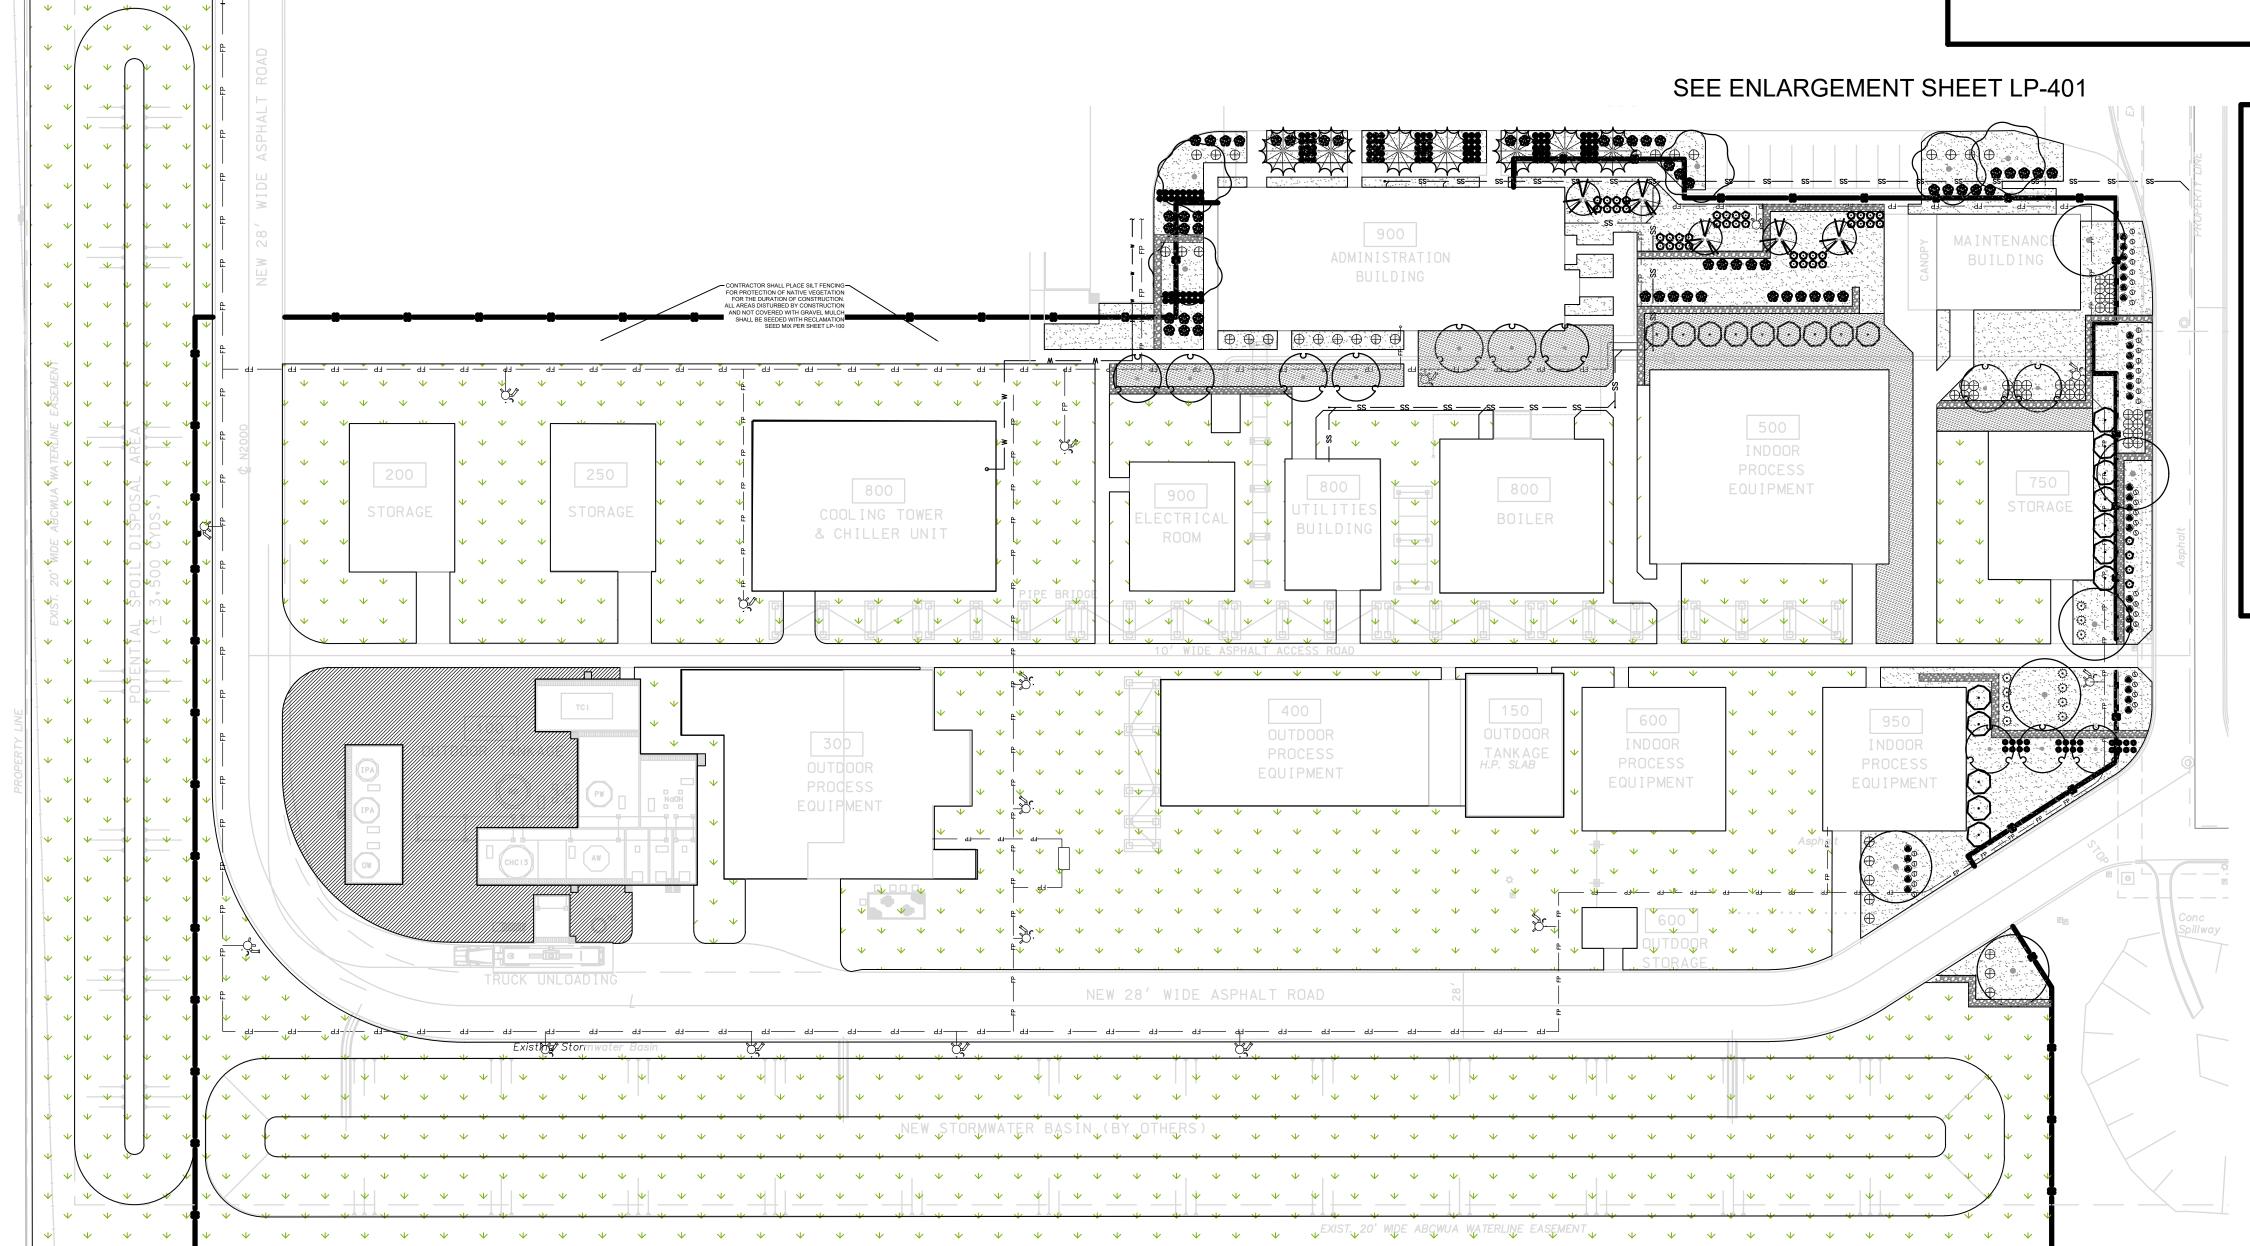

## SEEDING SCHEDULE

RECLAMATION SEED MIX (per Section 1013 City of Abq. Seed Mix - a. Gravelly Uplands & Slopes) #PLS/ AC Common Name Botanical Blue Grama Bouteloua Bouteloua gracilis 'Hachita' 7.0 Side oats Grama Bouteloua curtipen dula 'Niner' 5.0 Stipa neomexicana Needle & Thread Grass 2.0 Indian Rice Grass Oryzopsis hymenoides 2.0 1.0 Koeleria macrantha June Grass Aristida purpurea Pleuraphis jamesii 'Viva' 1.0 Galleta 0.25 Purple Prairie Clover Dalea purpurea var purpurea 0.25 Ratibida columnifera pulcherrima Mexican Hat 0.25 Gaillardia aristata Blanket Flower 0.25 Sphaeralcea parvifolia Nelson Globemallow Oenothera pallida White Evening Primrose 0.25 Baileya multiradiata Desert Marigold 0.25 0.25 Berlandiera lyrata Chocolate Flower 0.25 Abronia fragrans or villosa Sand Verbena

Greenbox

502 SEVENTH STREET, SUITE 203
OREGON CITY, OREGON \$7045

SITES

PROJECT NO.: 8000-22


DRAWN BY:

DATE: SEPTEMBER 1, 2024

LANDSCAPE PLANTING PLAN

A1 LANDSCAPE PLANTING PLAN

20' 40' 80' ALE: 1" = 40'

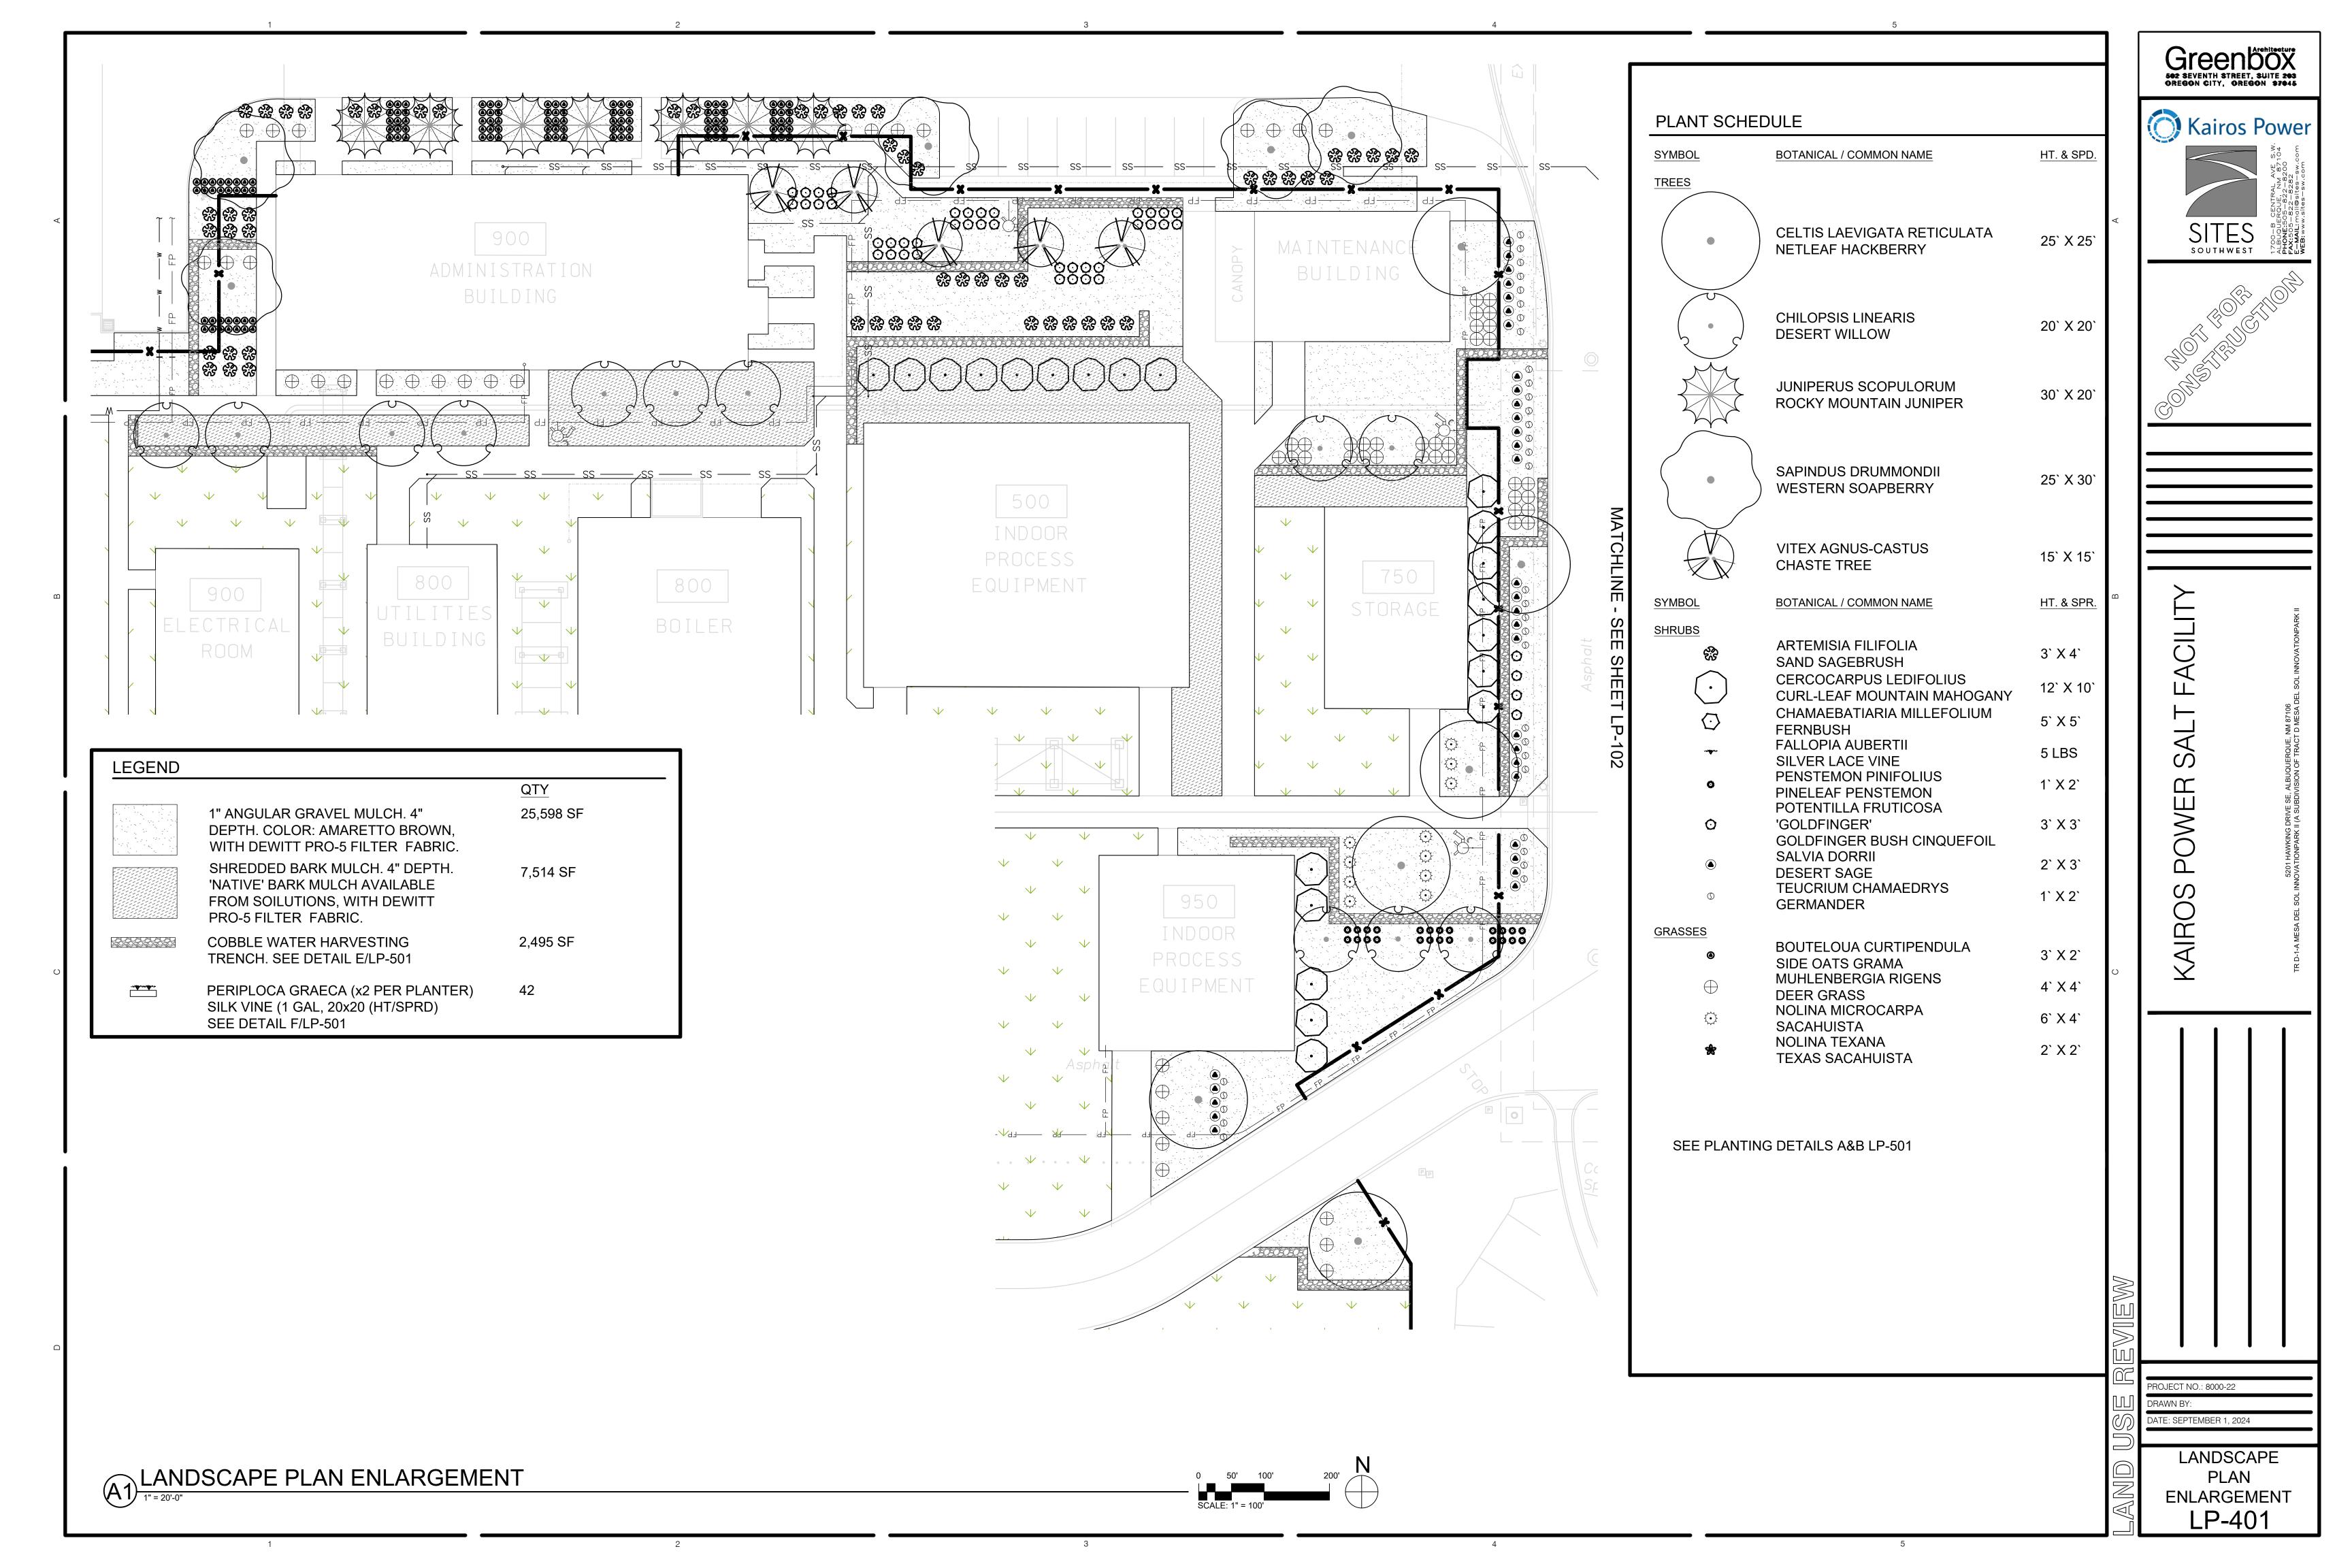

# KAIROS POWER EMPLOYEE PATIO

5201 Hawking Dr SE ALBUQUERQUE, NM 87106

JULY 12, 2024 100% CONSTRUCTION DOCUMENTS

#### **DESIGN TEAM:**

LANDSCAPE ARCHITECT

PLAND COLLABORATIVE 600 1ST ST NW, STE 100 ALBUQUERQUE, NM 87102 505-268-2266 PH 505-265-9637 FX ATTN: LANA IDRISS, PLA, ASLA LIDRISS@PLANDCOLLAB.COM

## OWNER:

KAIROS POWER

5201 HAWKING DR SE, ALBUQUERQUE, NM 87106 505-431-1255 PH ATTN: RHONDA REYNOLDS REYNOLDS@KAIROSPOWER.COM

PROJECT AREA









## KAIROS POWER **EMPLOYEE PATIO**

5201 HAWKING DR **ALBUQUERQUE NM 87106** 

JULY 12, 2024 SUBMITTAL

**CONSTRUCTION DOCUMENTS** 

NO.	DATE	DESCRIPTION	

MRWM PROJECT NO 24025 DESIGNED BY LI CHECKED BY AZ DRAWN BY CE-FB

SHEET TITLE

COVER SHEET

SHEET NUMBER

G001

**COVER SHEET** 

SITE PLAN

SITE DETAILS

**DEMOLITION PLAN** 


DIMENSION PLAN

PLANTING DETAILS


**IRRIGATION DETAILS** 

IRRIGATION PLAN

PLANTING PLAN

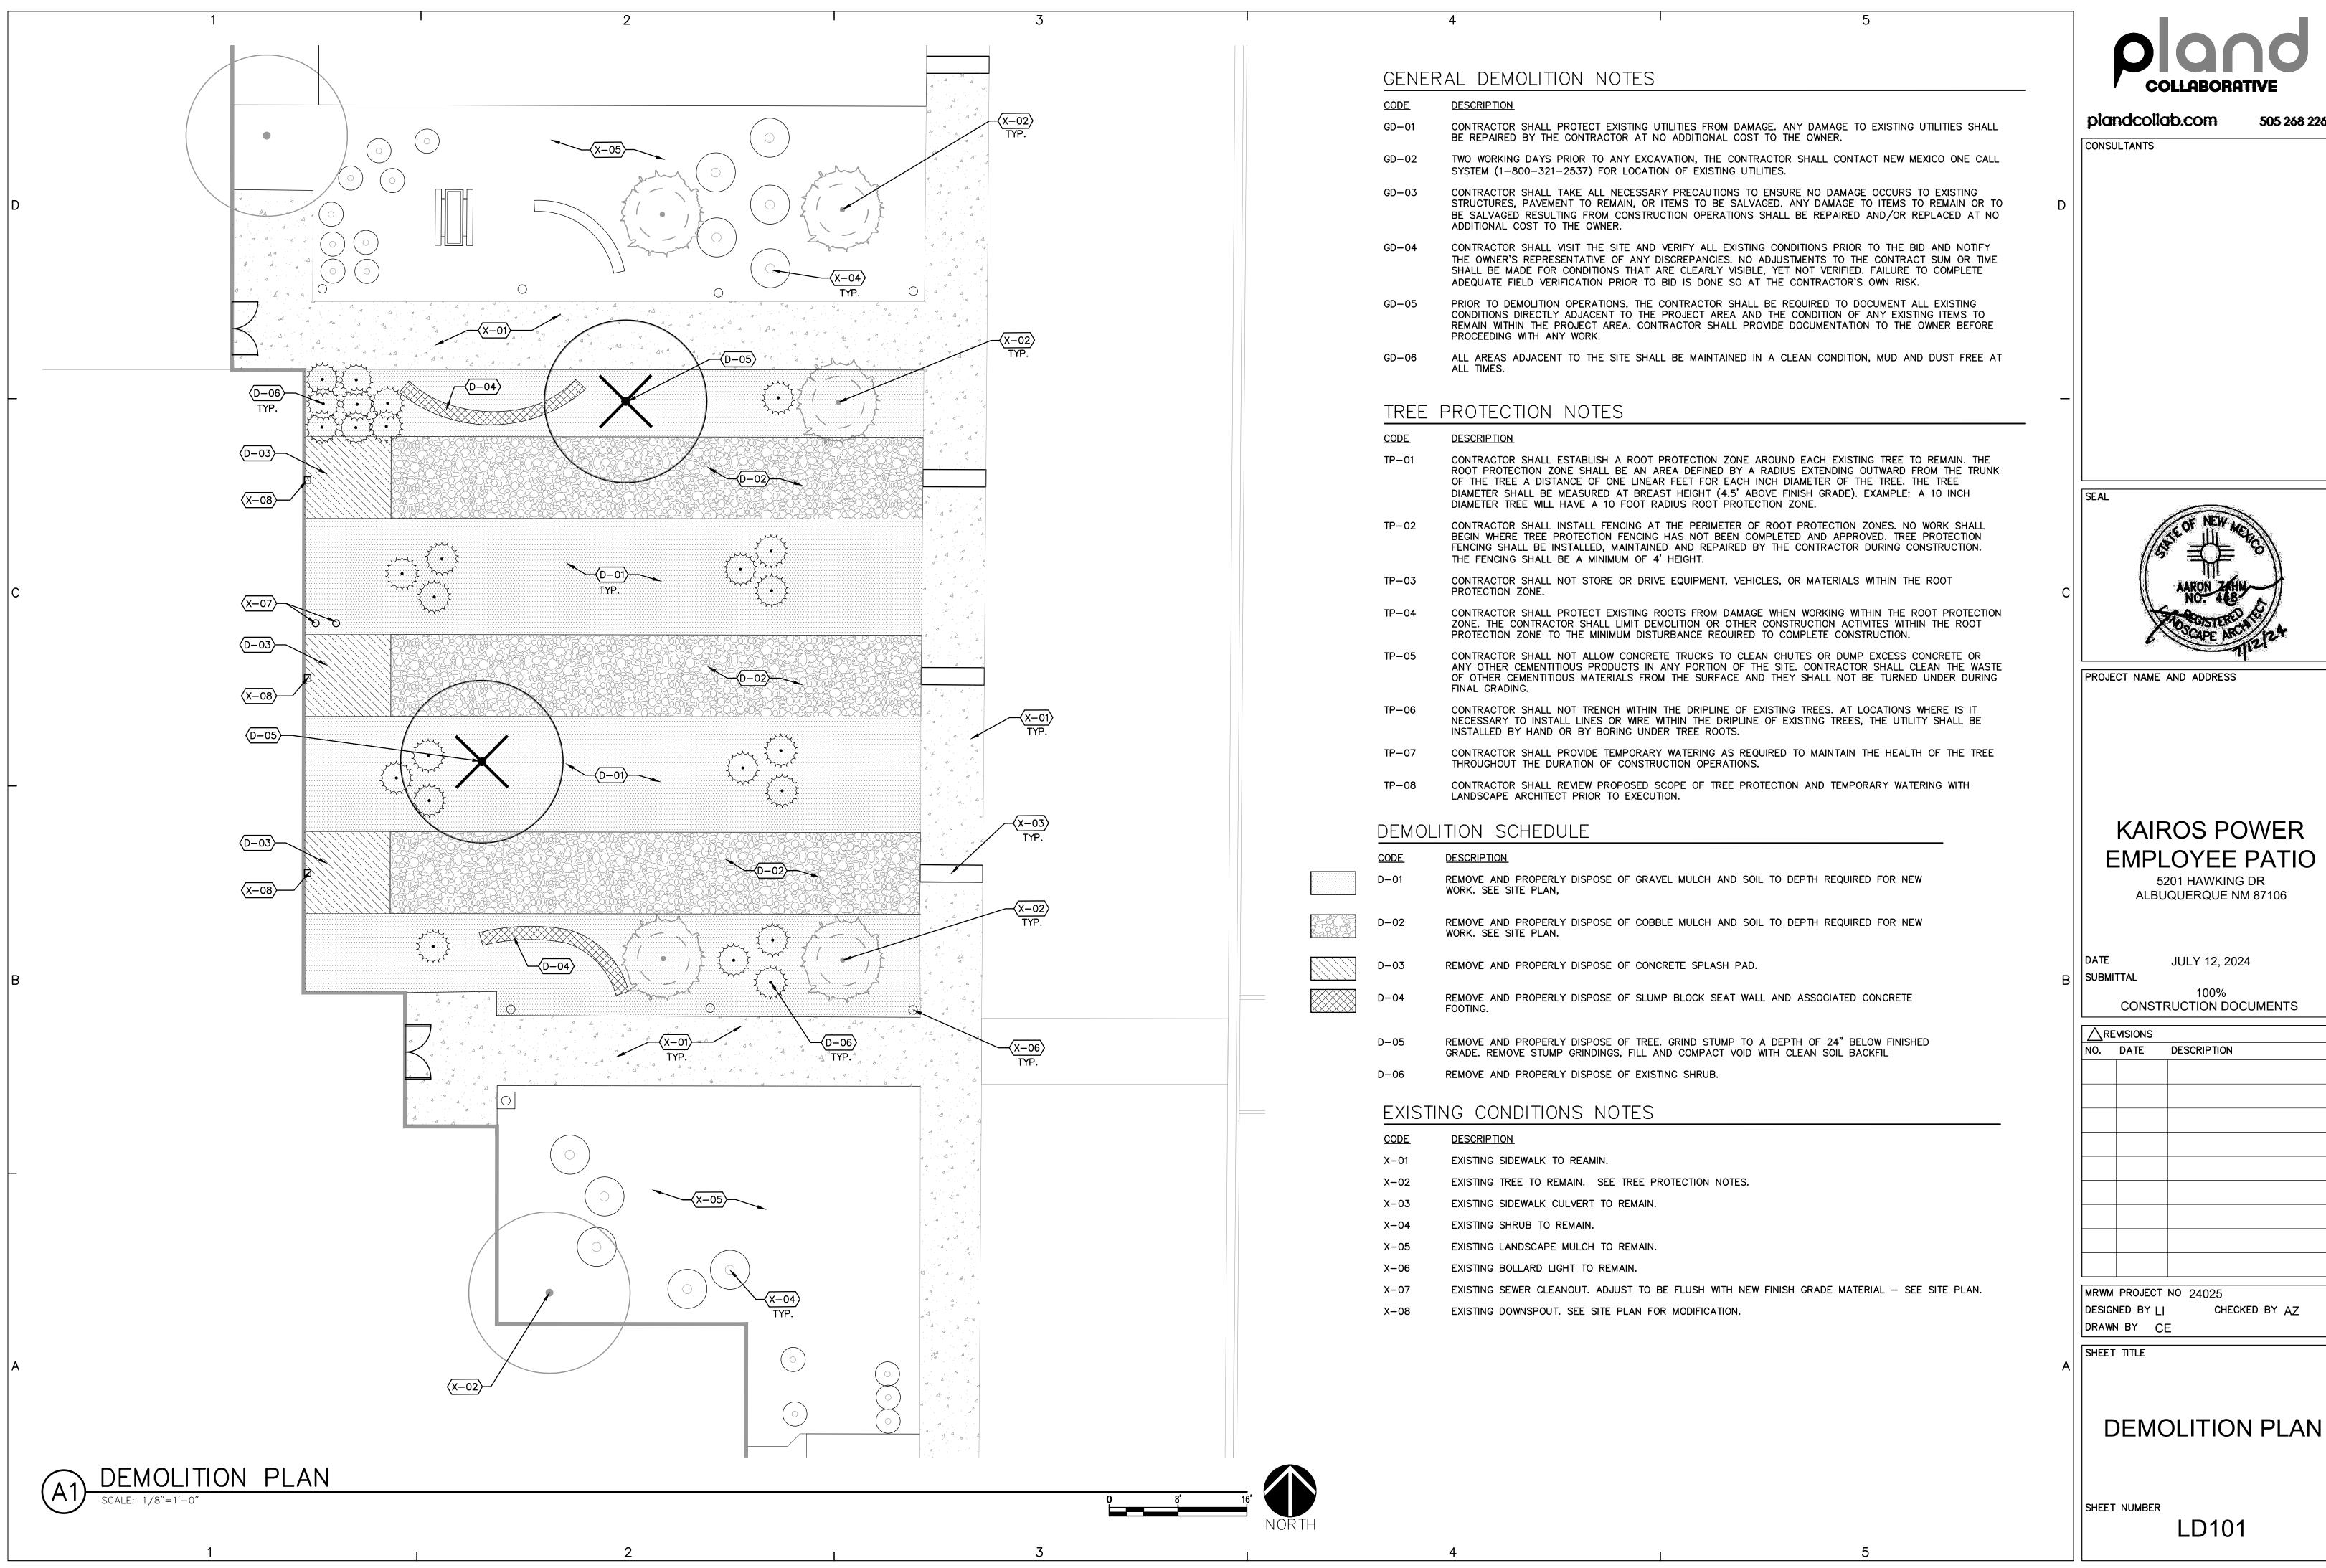


505 268 2266

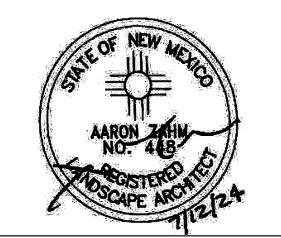


# KAIROS POWER

∠RI	EVISIONS	
NO.	DATE	DESCRIPTION

CHECKED BY AZ

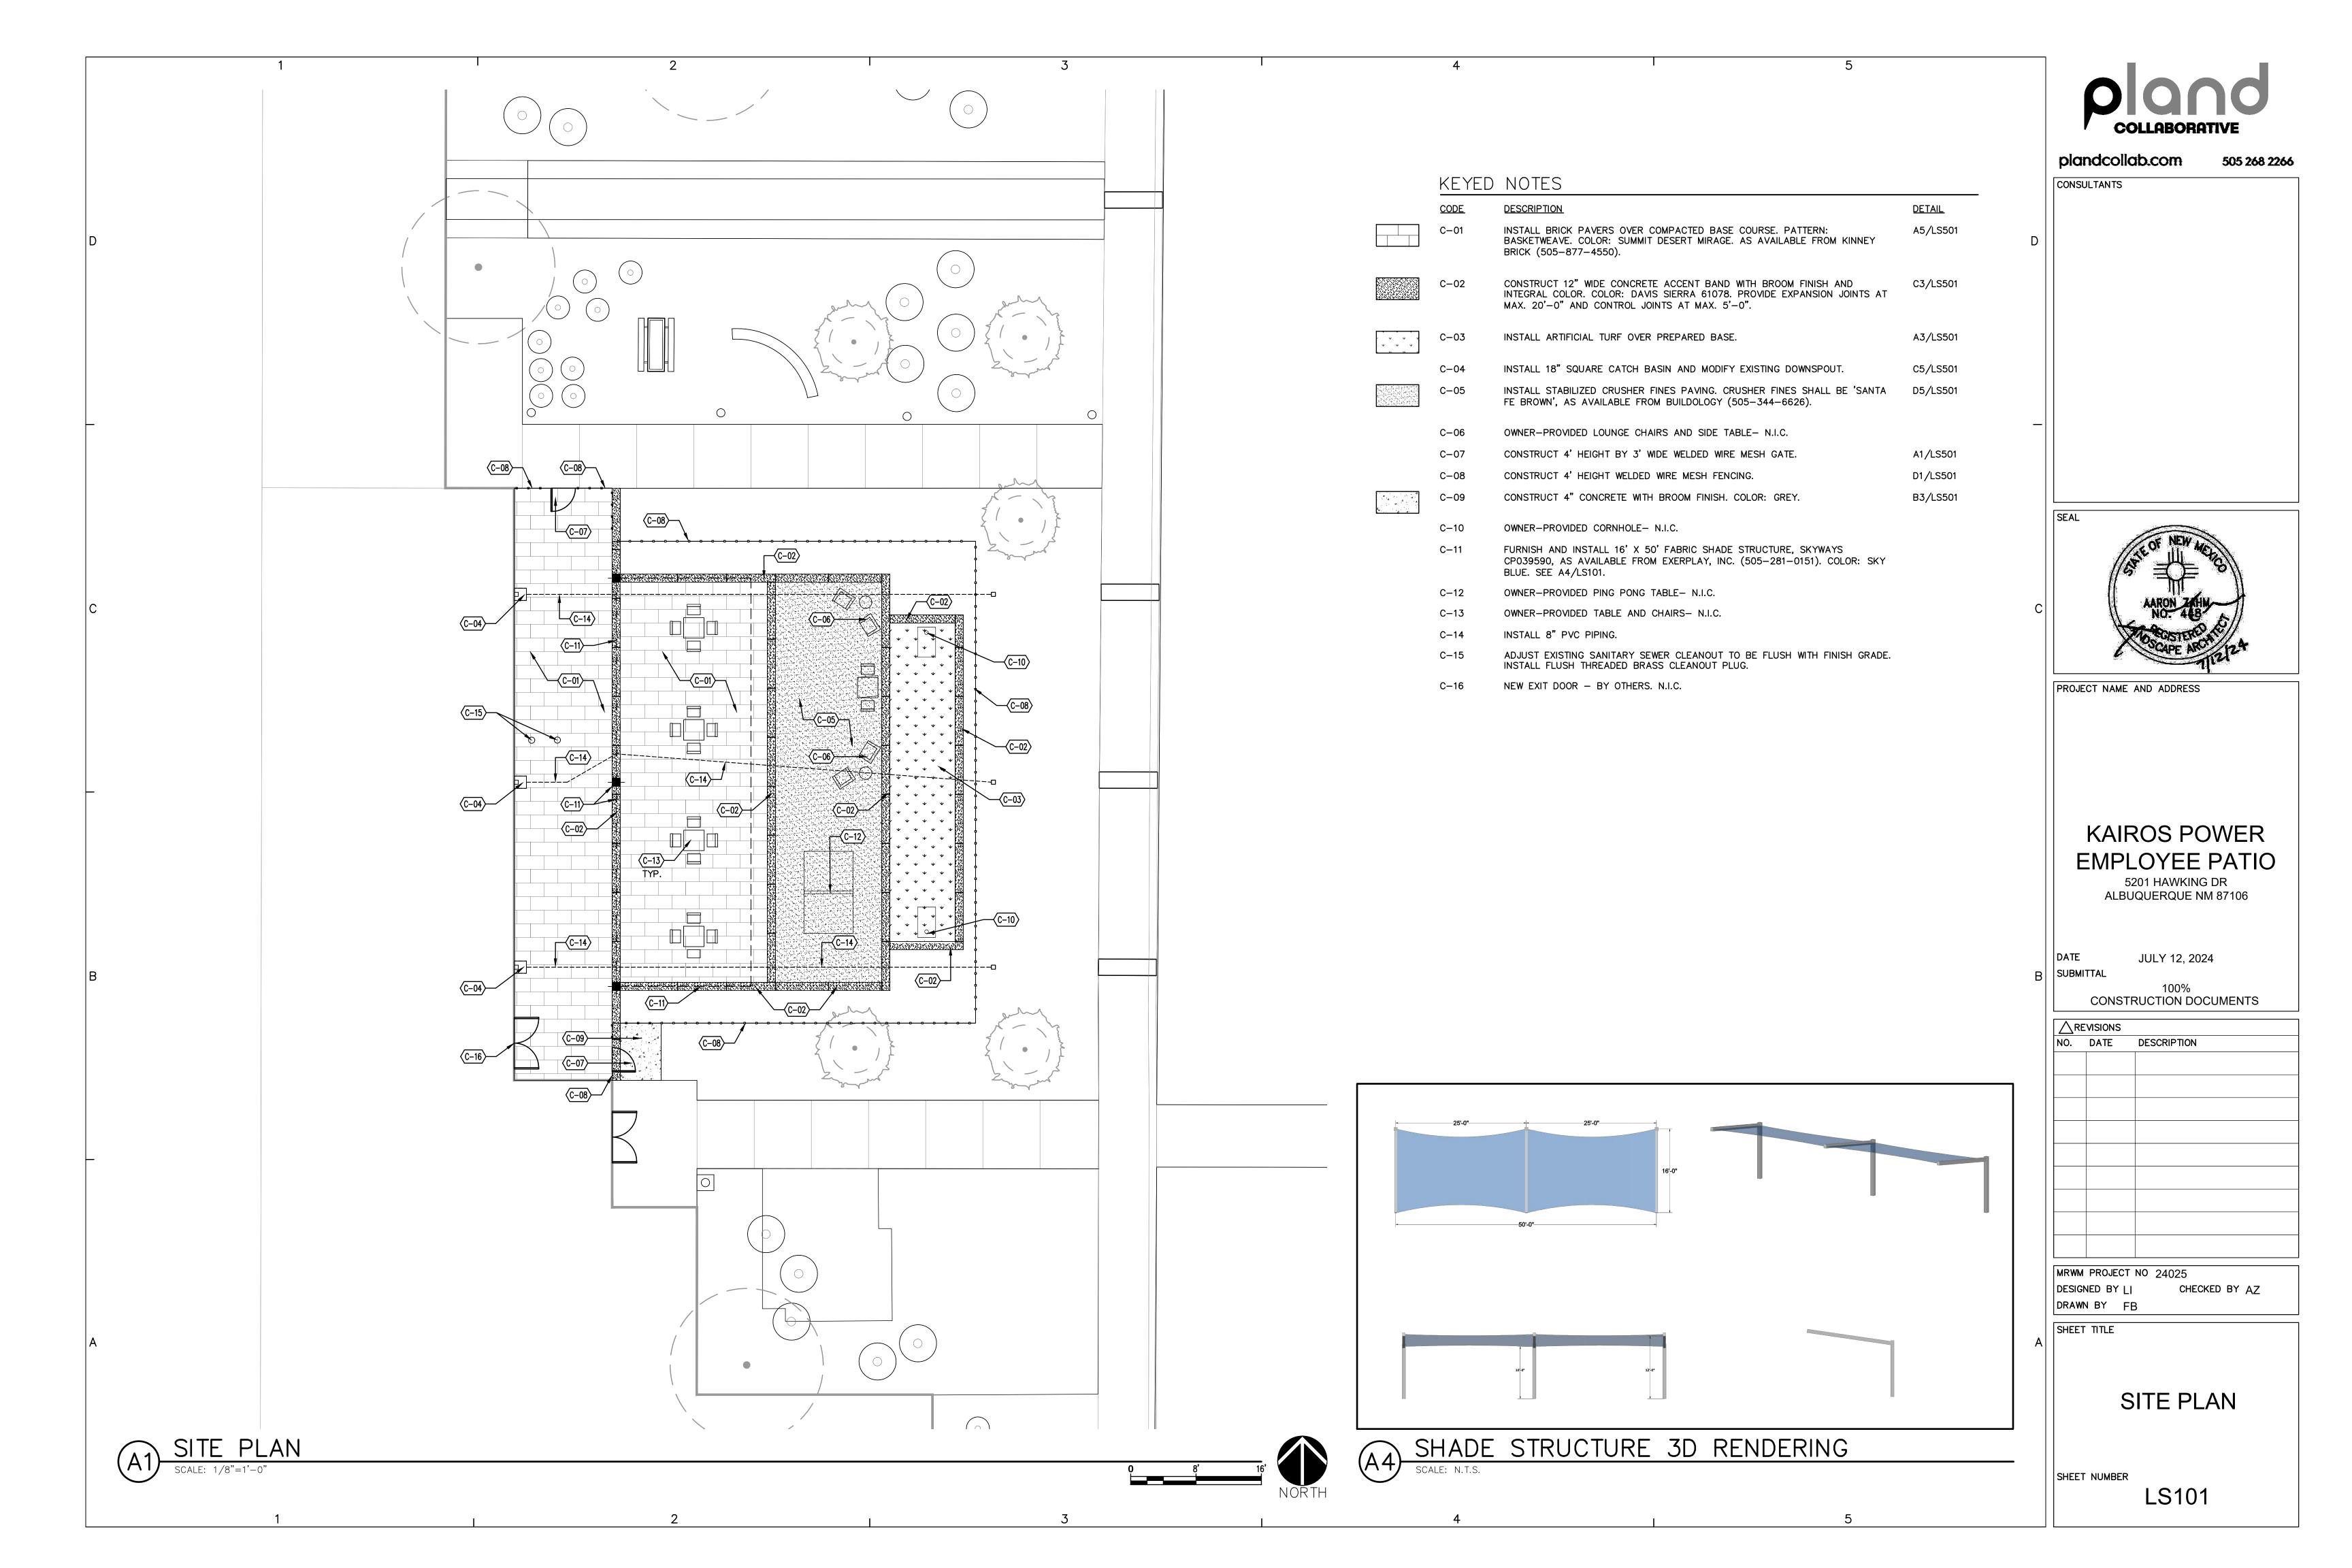

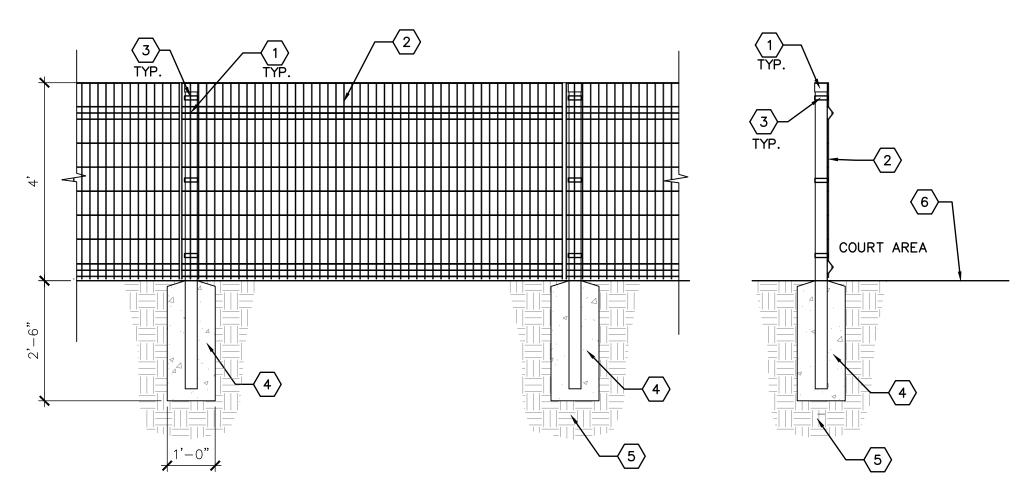


#### 

- 1. 3" X 3" X 11 GAUGE STEEL POST, SPACED AT 8'-0" O.C. TOPS OF POSTS SHALL HAVE POST CAPS.
- . 4' HIGH VERTICAL DESIGNMASTER CLASSIC FENCE PANEL AS AVAILABLE FROM VALLEY FENCE (505-877-1155) OR APPROVED EQUAL. . STANDARD BRACKET. FENCE PANELS SHALL BE ATTACHED TO POSTS WITH STANDARD BRACKETS. SEE GENERAL NOTE B.
- 4. 3000 PSI CONCRETE FOOTING. 5. SUBGRADE COMPACTED TO 95%.
- 6. FINISH GRADE, MATERIAL VARIES SEE CONSTRUCTION PLAN.

## GENERAL NOTES

- A. THE DESIGNMASTER FENCE SHALL BE INSTALLED PER THE MANUFACTURER'S SPECIFICATIONS. B. THE STANDARD BRACKET SHALL BE INSTALLED SO THE BOLT SIDE IS ON THE OUTSIDE OF THE PATIO.
- C. POSTS AT GATES SHALL BE 3" X 3" X 11 GAUGE STEEL POSTS. SEE DETAIL A1/LS501. D. POSTS, RAILS, AND FENCE PANEL POWDER COATING COLOR SHALL BROWN 7006.

## HT. DESIGNMASTER CLASSIC FENCE

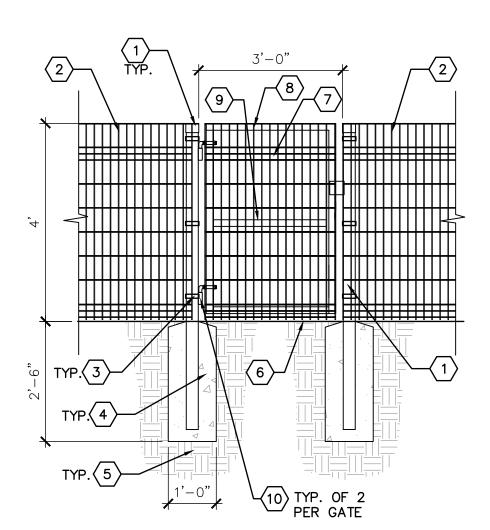

#### 


- 1. 3" X 3" X 11 GAUGE STEEL GATE POST. TOPS OF POSTS SHALL HAVE POST CAPS.
- 2. 4' HIGH DESIGNMASTER CLASSIC FENCE SEE DETAIL D1/LS501.
- 3. STANDARD 3" X 3" BRACKET FOR 3" GATE POST. FENCE PANELS SHALL BE ATTACHED TO GATE POSTS WITH STANDARD 3" BRACKETS. SEE GENERAL NOTE B.
- 4. 3000 PSI CONCRETE FOOTING. 5. SUBGRADE COMPACTED TO 95%.
- 6. FINISH GRADE SEE PLAN.
- 7. 4' HT. DESIGNMASTER CLASSIC PANEL. THE PANEL SHALL BE CUT TO LENGTH AND WELDED TO GATE FRAME. SEE GENERAL NOTE A.
- 8. 2" X 2" X 3 GAUGE (1/4" WALL) SQUARE STEEL TUBE, FOR GATE FRAME. INSTALL
- CAPS OR WELD OPEN ENDS. SEE GENERAL NOTES E & F. 9. 2" X 2" X 3 GAUGE (1/4" WALL) SQUARE STEEL TUBE CENTER RAIL FOR GATE. SEE
- GENERAL NOTES E & F. 10. 3/4" STEEL J-BOLT ADJUSTABLE BARREL HINGE TO ALLOW THE GATE TO OPEN IN BOTH DIRECTIONS.

## GENERAL NOTES

- A. TOUCH UP PAINT ON PANEL PER THE MANUFACTURER'S SPECIFICATIONS. B. THE STANDARD BRACKET SHALL BE INSTALLED SO THE BOLT SIDE IS ON THE OUTSIDE OF THE COURT AREA.
- C. POSTS AT GATES SHALL BE 3" X 3" X 11 GAUGE STEEL POSTS. D. POSTS, GATE, & FENCE PANELS POWDER COATING COLOR SHALL BE BROWN 7006.
- E. ALL WELDS SHALL BE GROUND SMOOTH. F. GATE SHALL BE CONSTRUCTED WITH ALL JOINTS WELDED. THE GATE SHALL ALSO BE CONSTRUCTED TO OPEN 180 DEGREES IN BOTH DIRECTIONS AND LATCH TO

## WIDE SINGLE GATE



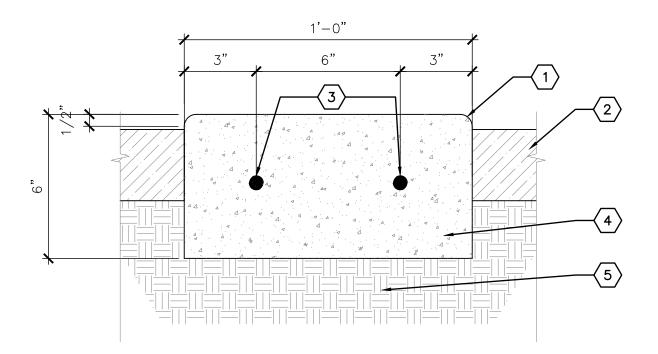


#### 

- 1. 1/2" RADIUS TOOLED EDGE.
- L'ANDSCAPE AREA, MATERIAL VARIES. 3. #4 REBAR, HORIZ. AND CONT.
- 4. 3000 PSI CONCRETE.
- 5. SUBGRADE COMPACTED TO 95%.

#### GENERAL NOTES

- A. PLACE EXPANSION JOINTS @ 20'-0" O.C. MAXIMUM WITH CONTROL JOINTS @ 5'-0" O.C.
- B. TOP SURFACE OF EDGER SHALL HAVE A MEDIUM BROOM FINISH.

# 12" CONCRETE ACCENT BAND

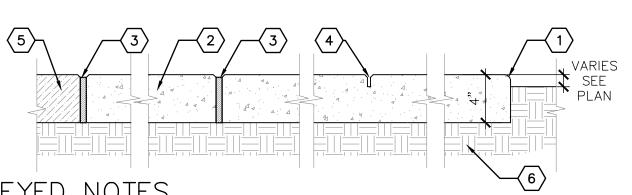


#### 


- TOOLED EDGE, 1/2" RADIUS 2. 3000 PSI CONCRETE
- 3. 1/2" WIDE EXPANSION JOINT WITH FELT EXPANSION MATERIAL
- 4. 1/8" X 1" CONTROL JOINT
- 5. ADJACENT CONCRETE 6. SUBGRADE COMPACTED TO 95%

#### GENERAL NOTES

- A. CONTROL JOINTS SHALL BE AT MAXIMUM EVERY 10' OR AS SHOWN ON PLAN. B. EXPANSION JOINTS SHALL BE AT MAXIMUM EVERY 30' OR AS SHOWN ON PLAN AND WHERE PAVING ABUTS
- EXISTING BUILDINGS, CURBS, SEATING WALLS, WALKS AND OTHER HARD CONSTRUCTION.
- C. FELT EXPANSION MATERIAL SHALL BE RECESSED 1/2" AND SET WITH PLASTIC EXPANSION JOINT CAP. TOP OF CAP SHALL BE FLUSH WITH TOP OF CONCRETE. OPPOSING CONCRETE EDGES OF JOINT SHALL HAVE 1/4" RADIUS TOOLED EDGE.
- D. CONTROL JOINTS SHALL BE TOOLED OR SAW CUT TO INDICATED DEPTH. SAW CUT JOINTS SHALL BE CUT AFTER FINISHING OF CONCRETE USING AN EARLY ENTRY TYPE DRY CUT SAW. SPALLING OF CONCRETE
- FINISH AT EDGE OF CUT IS NOT ACCEPTABLE. E. PROVIDE MEDIUM BROOM FINISH UNLESS OTHERWISE NOTED ON THE PLANS.

# THICK CONCRETE PAVING

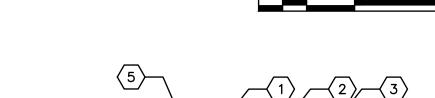

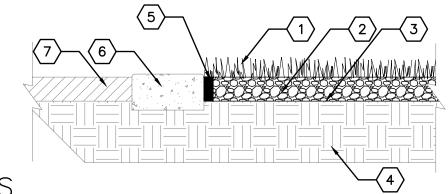



#### 

- 1. SYNTHETIC TURF SYSTEM WITH FILL MATERIAL 'SYNBLUE 745' AS AVAILABLE FROM SYNLAWN (505-890-8889), OR APPROVED EQUAL.
- 2. 4" MINIMUM DEPTH OF BASE COURSE MATERIAL NMDOT TYPE 1.
- 3. MIRAFI 180N HEAVY WEIGHT NONWOVEN GEOTEXTILE FABRIC OR APPROVED EQUAL.
- 4. SUBGRADE COMPACTED TO 95% PROCTOR. SLOPE OF SUBGRADE SHALL BE PER GRADING PLAN. 5. 2" x 4" PRESSURE TREATED PINE OR RECYCLED PLASTIC NAILER BOARD, SEE GENERAL NOTE #1.
- NAILER BOARD SHALL BE SET 2" BELOW TOP OF CONCRETE.
- 6. CONCRETE ACCENT BAND SEE PLAN 7. LANDSCAPE AREA, MATERIAL VARIES

## GENERAL NOTES

1. NAILER BOARD AT ALL CORNERS AND CHANGES IN DIRECTIONS SHALL BE CONNECTED TOGETHER WITH (3) STAINLESS STEEL SCREWS TO CREATE A CONTINUOUS FRAME. CONTRACTOR SHALL PROVIDE SUBMITTAL FOR HARDWARE USED TO FASTEN NAILER BOARD TO CONCRETE SURFACES.

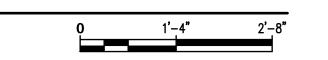


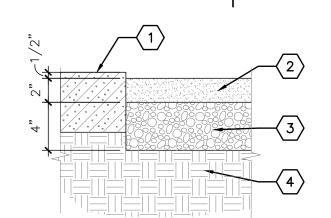

#### 

- 1. HARDENED EDGE ADJACENT CONDITION (CONCRETE CUB, PAVING, ETC.) SEE PLAN.
- 2. CRUSHER FINES SEE PLAN.
- 3. BASE COURSE COMPACTED TO 95%. 4. SUBGRADE COMPACTED TO 95%.
- GENERAL NOTES
- A. CRUSHER FINES SHALL BE STABILIZED WITH 'STABILIZER' NATURAL BINDER, OR APPROVED EQUAL.
- INSTALL PER MANUFACTURER'S SPECIFICATIONS.
- B. NATURAL BINDER SHALL BE APPLIED AT A RATE OF 15 LBS. PER TON OF CRUSHER FINES.


## STABILIZED CRUSHER FINES PAVING

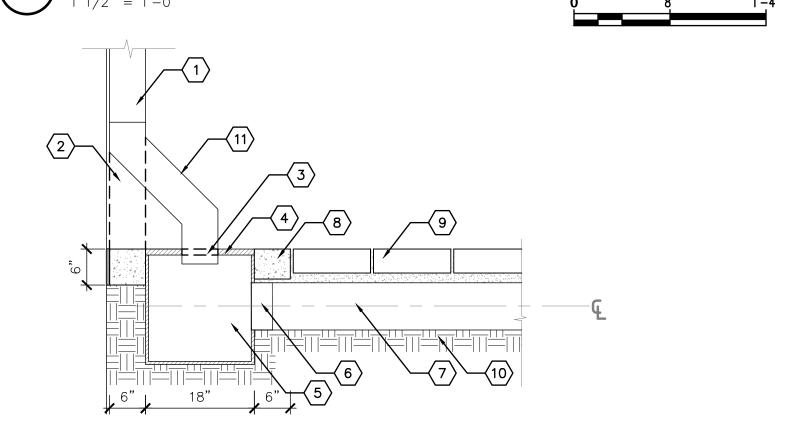

## 

- EXISTING DOWNSPOUT
- REMOVE PORTION OF EXISTING DOWNSPOUT
- CUT GRATE TO ACCOMMODATE DOWNSPOUT
- 18" SQUARE STRUCTURAL FOAM POLYOLEFIN GRATE WITH UV INHIBITOR, GRAY, NDS, PART NO. 1810
- 5. 18" X 18" EXPANDABLE CATCH BASIN, NDS, PART NO. 1800 6. 8" UNIVERSAL OUTLET, NDS, PART NO.1888
- 7. 8" DIAMETER PVC PIPING
- 8. 6" CONCRETE COLLAR
- 9. PAVERS, SEE PLAN 10. SUBGRADE COMPACTED TO 95%
- 11. FABRICATE REMOVABLE PORTION OF DOWNSPOUT, MATCHING COLOR AND PROFILE. FASTEN SECURELY TO EXISTING DOWNSPOUT USING APPROPRIATE HARDWARE.



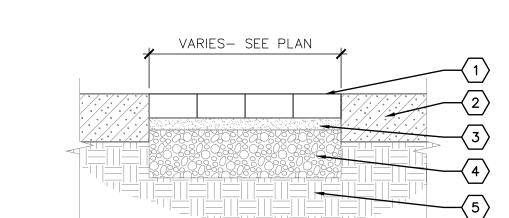

#### 


- 1. PAVERS SEE PLANS.
- 2. ADJACENT CONDITION VARIES SEE PLAN.
- 3. 1" DEPTH CONCRETE SAND LEVELING COURSE.
- 4. 4" DEPTH COMPACTED BASE COURSE (U.T.B.C. 1). 5. SUBGRADE COMPACTED TO 95%.

### GENERAL NOTES

- A. REFERENCE PLAN FOR PAVER TYPE, COLOR, AND INSTALLATION PATTERN.
- B. WHERE PAVERS ABUT HARD CONSTRUCTION, PAVERS SHALL BE CLEANLY SAWCUT AS REQUIRED TO FIT. C. TOP OF PAVERS SHALL BE INSTALLED FLUSH WITH TOP OF ADJACENT PAVEMENT.
- D. AFTER PLACING PAVERS ON SAND LEVELING COURSE CONTRACTOR SHALL SWEEP DRY CONCRETE SAND INTO PAVER JOINTS AND VIBRATE WITH A PLATE COMPACTOR TO VIBRATE SAND INTO JOINTS. THESE STEPS SHALL BE REPEATED UNTIL ALL PAVER JOINTS ARE FILLED WITH CONCRETE SAND. UPON COMPLETION THE CONTRACTOR SHALL SWEEP OFF EXCESS SAND.
- E. ALL JOINT LINES SHALL NOT DEVIATE MORE THAN 1/2" OVER 50' FROM STRING LINES.
- F. PROVIDE JOINTS BETWEEN PAVERS 1/16" AND 3/16" WIDE. NO MORE THAN 5% OF THE JOINTS SHALL EXCEED 1/4" WIDE TO ACHIEVE STRAIGHT BOND LINES.
- 10' STRAIGHT EDGE. H. ALL PAVERS SHALL HAVE NO GREATER THAN 1/8" DIFFERENCE IN HEIGHT BETWEEN ADJACENT PAVERS.

G. FINAL SURFACE TOLERANCE FROM GRADE ELEVATIONS SHALL NOT DEVIATE MORE THAN 1/4" UNDER A

- I. ALL PAVER JOINT LINES SHALL BE TRUE PARALLEL AND PERPENDICULAR TO EDGE OF ADJACENT HARD CONSTRUCTION.
- J. REFERENCE MANUFACTURER'S GUIDELINES FOR ADDITIONAL INSTALLATION REQUIREMENTS.
- K. TOP OF UTILITY BOXES SHALL BE FLUSH WITH TOP OF PAVERS. IRRIGATION BOXES, LIGHTING PULL BOXES, AND OTHER SURFACE APPURTENANCES SHALL BE SET PARALLEL TO THE RUN OF PRICK PAVERS.

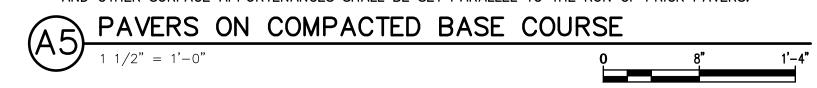



plandcollab.com 505 268 2266

PROJECT NAME AND ADDRESS

## KAIROS POWER **EMPLOYEE PATIO**

5201 HAWKING DR **ALBUQUERQUE NM 87106** 

JULY 12, 2024 SUBMITTAL

1'-4"

**CONSTRUCTION DOCUMENTS** 

110	D 4 TE	DECODIDATION	
NO.	DAIL	DESCRIPTION	


MRWM PROJECT NO 24025 DESIGNED BY LI CHECKED BY AZ


DRAWN BY CE

SHEET TITLE

SITE DETIALS

SHEET NUMBER LS501

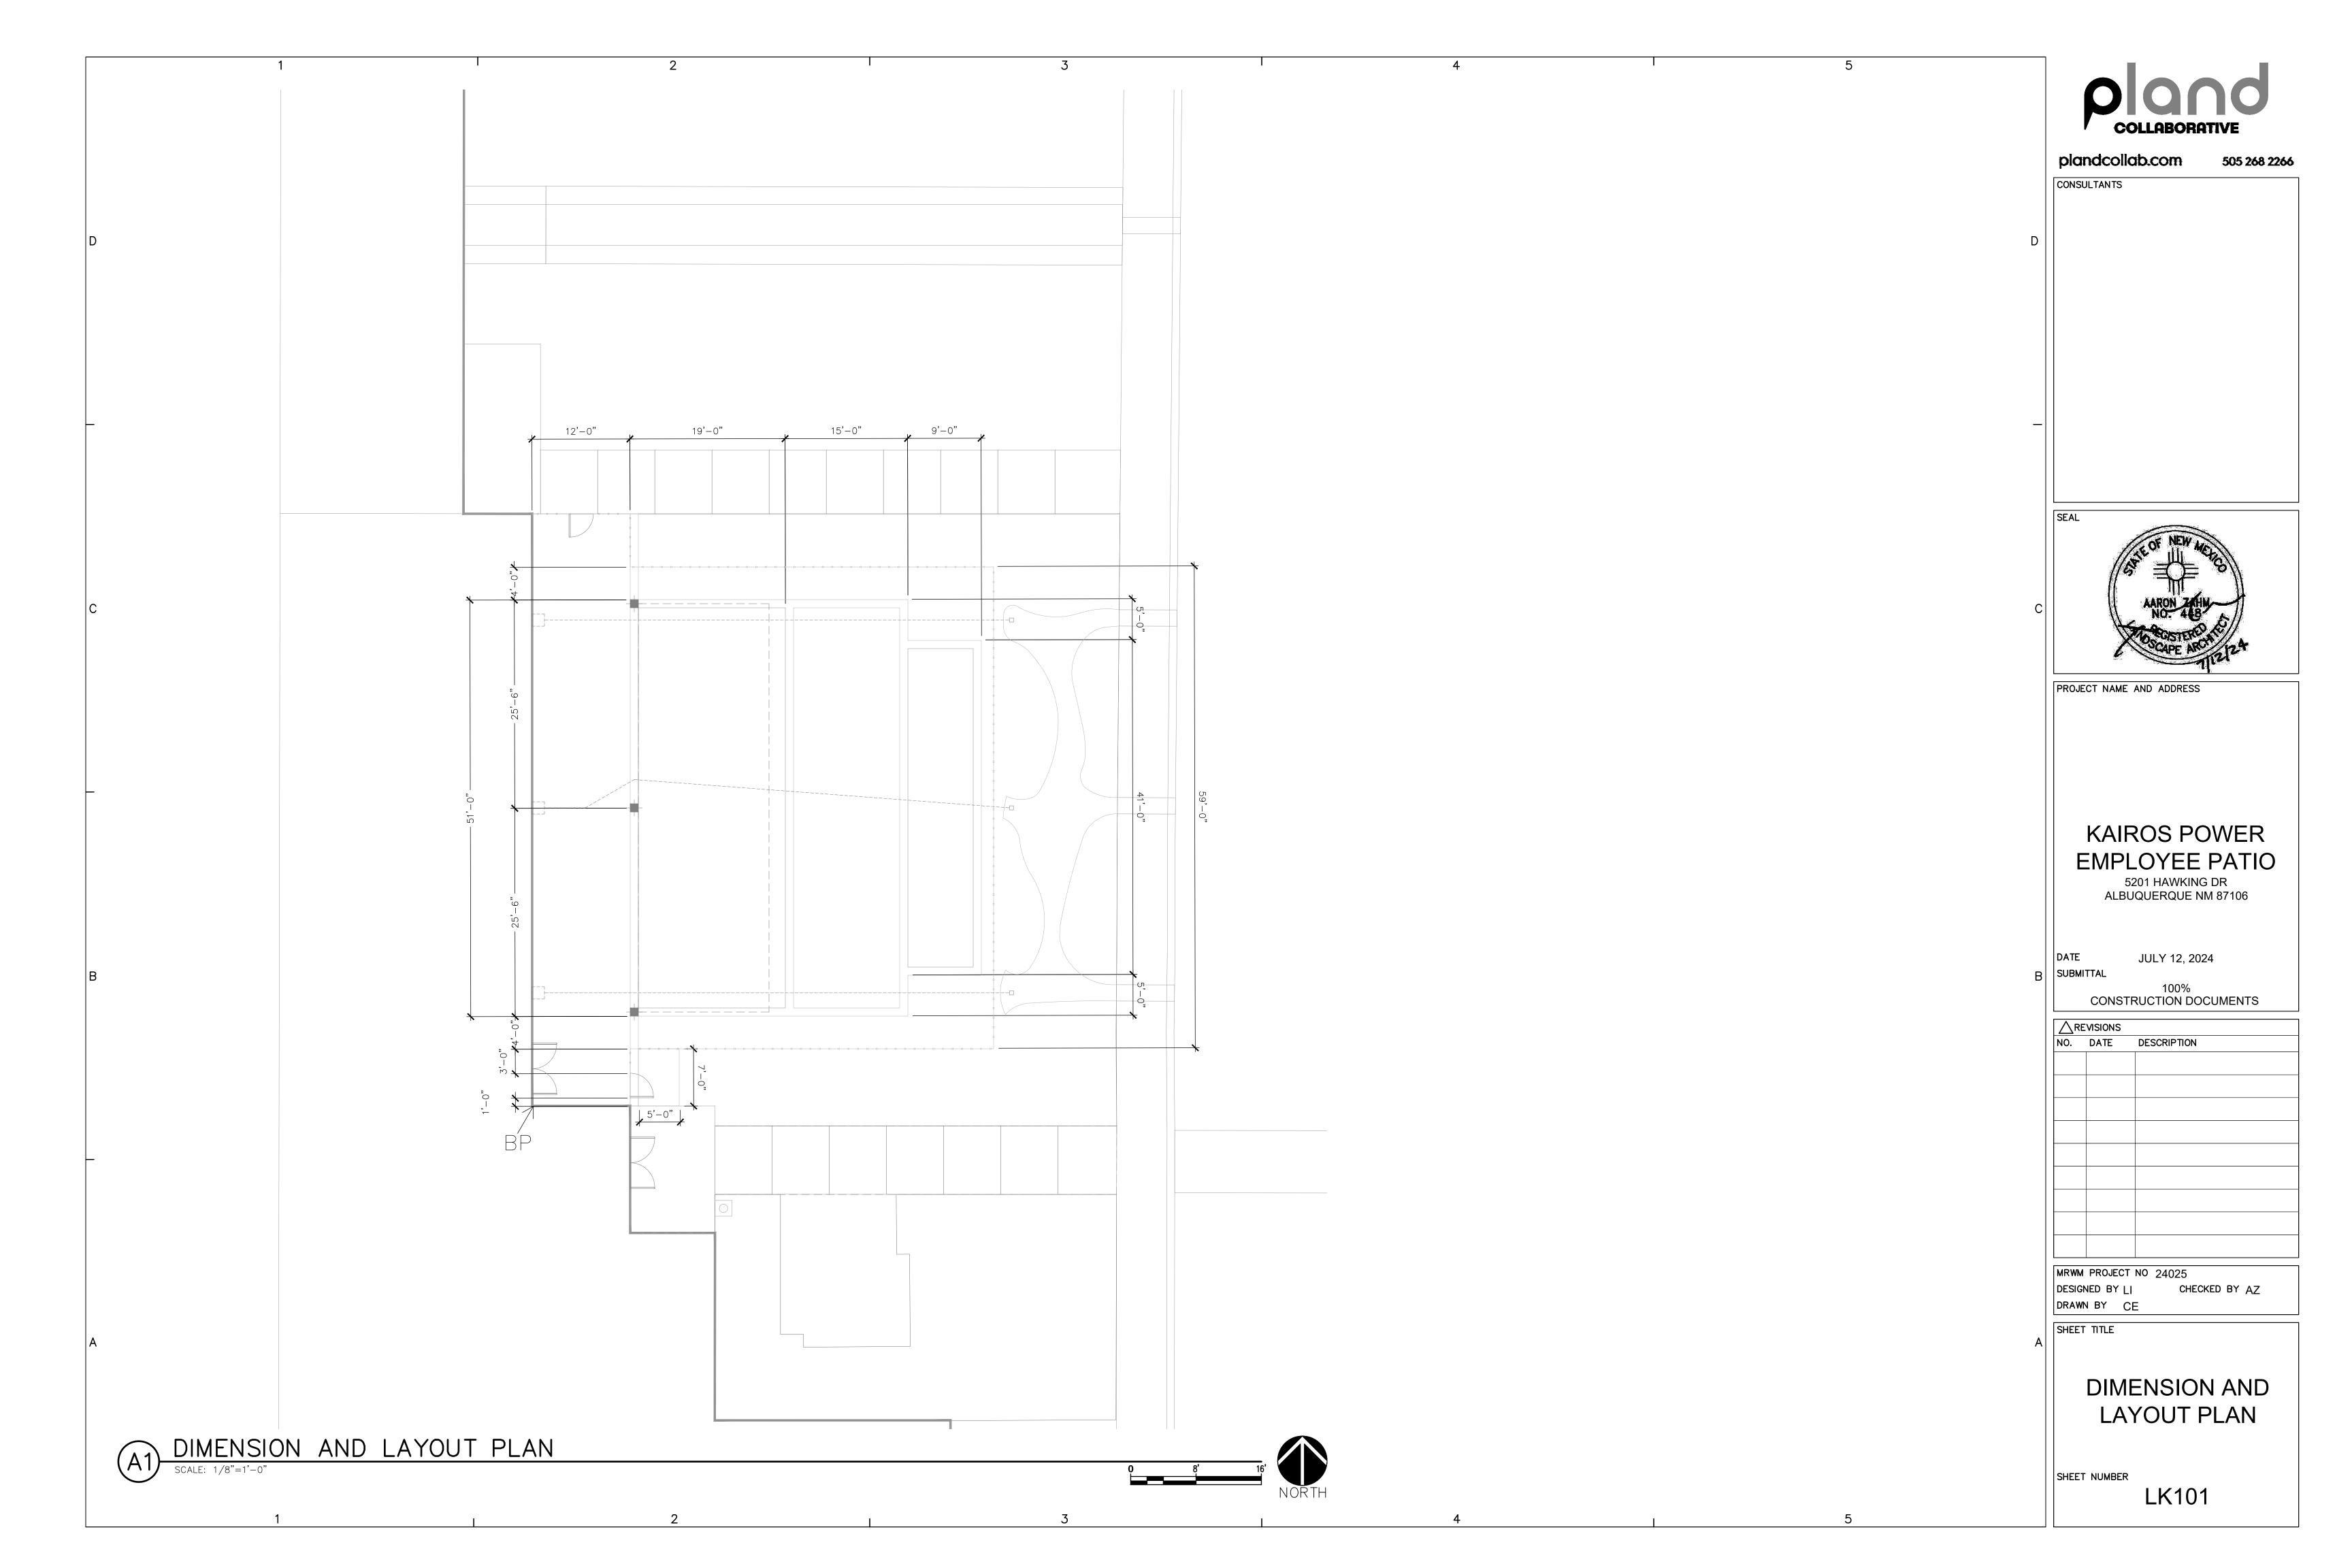

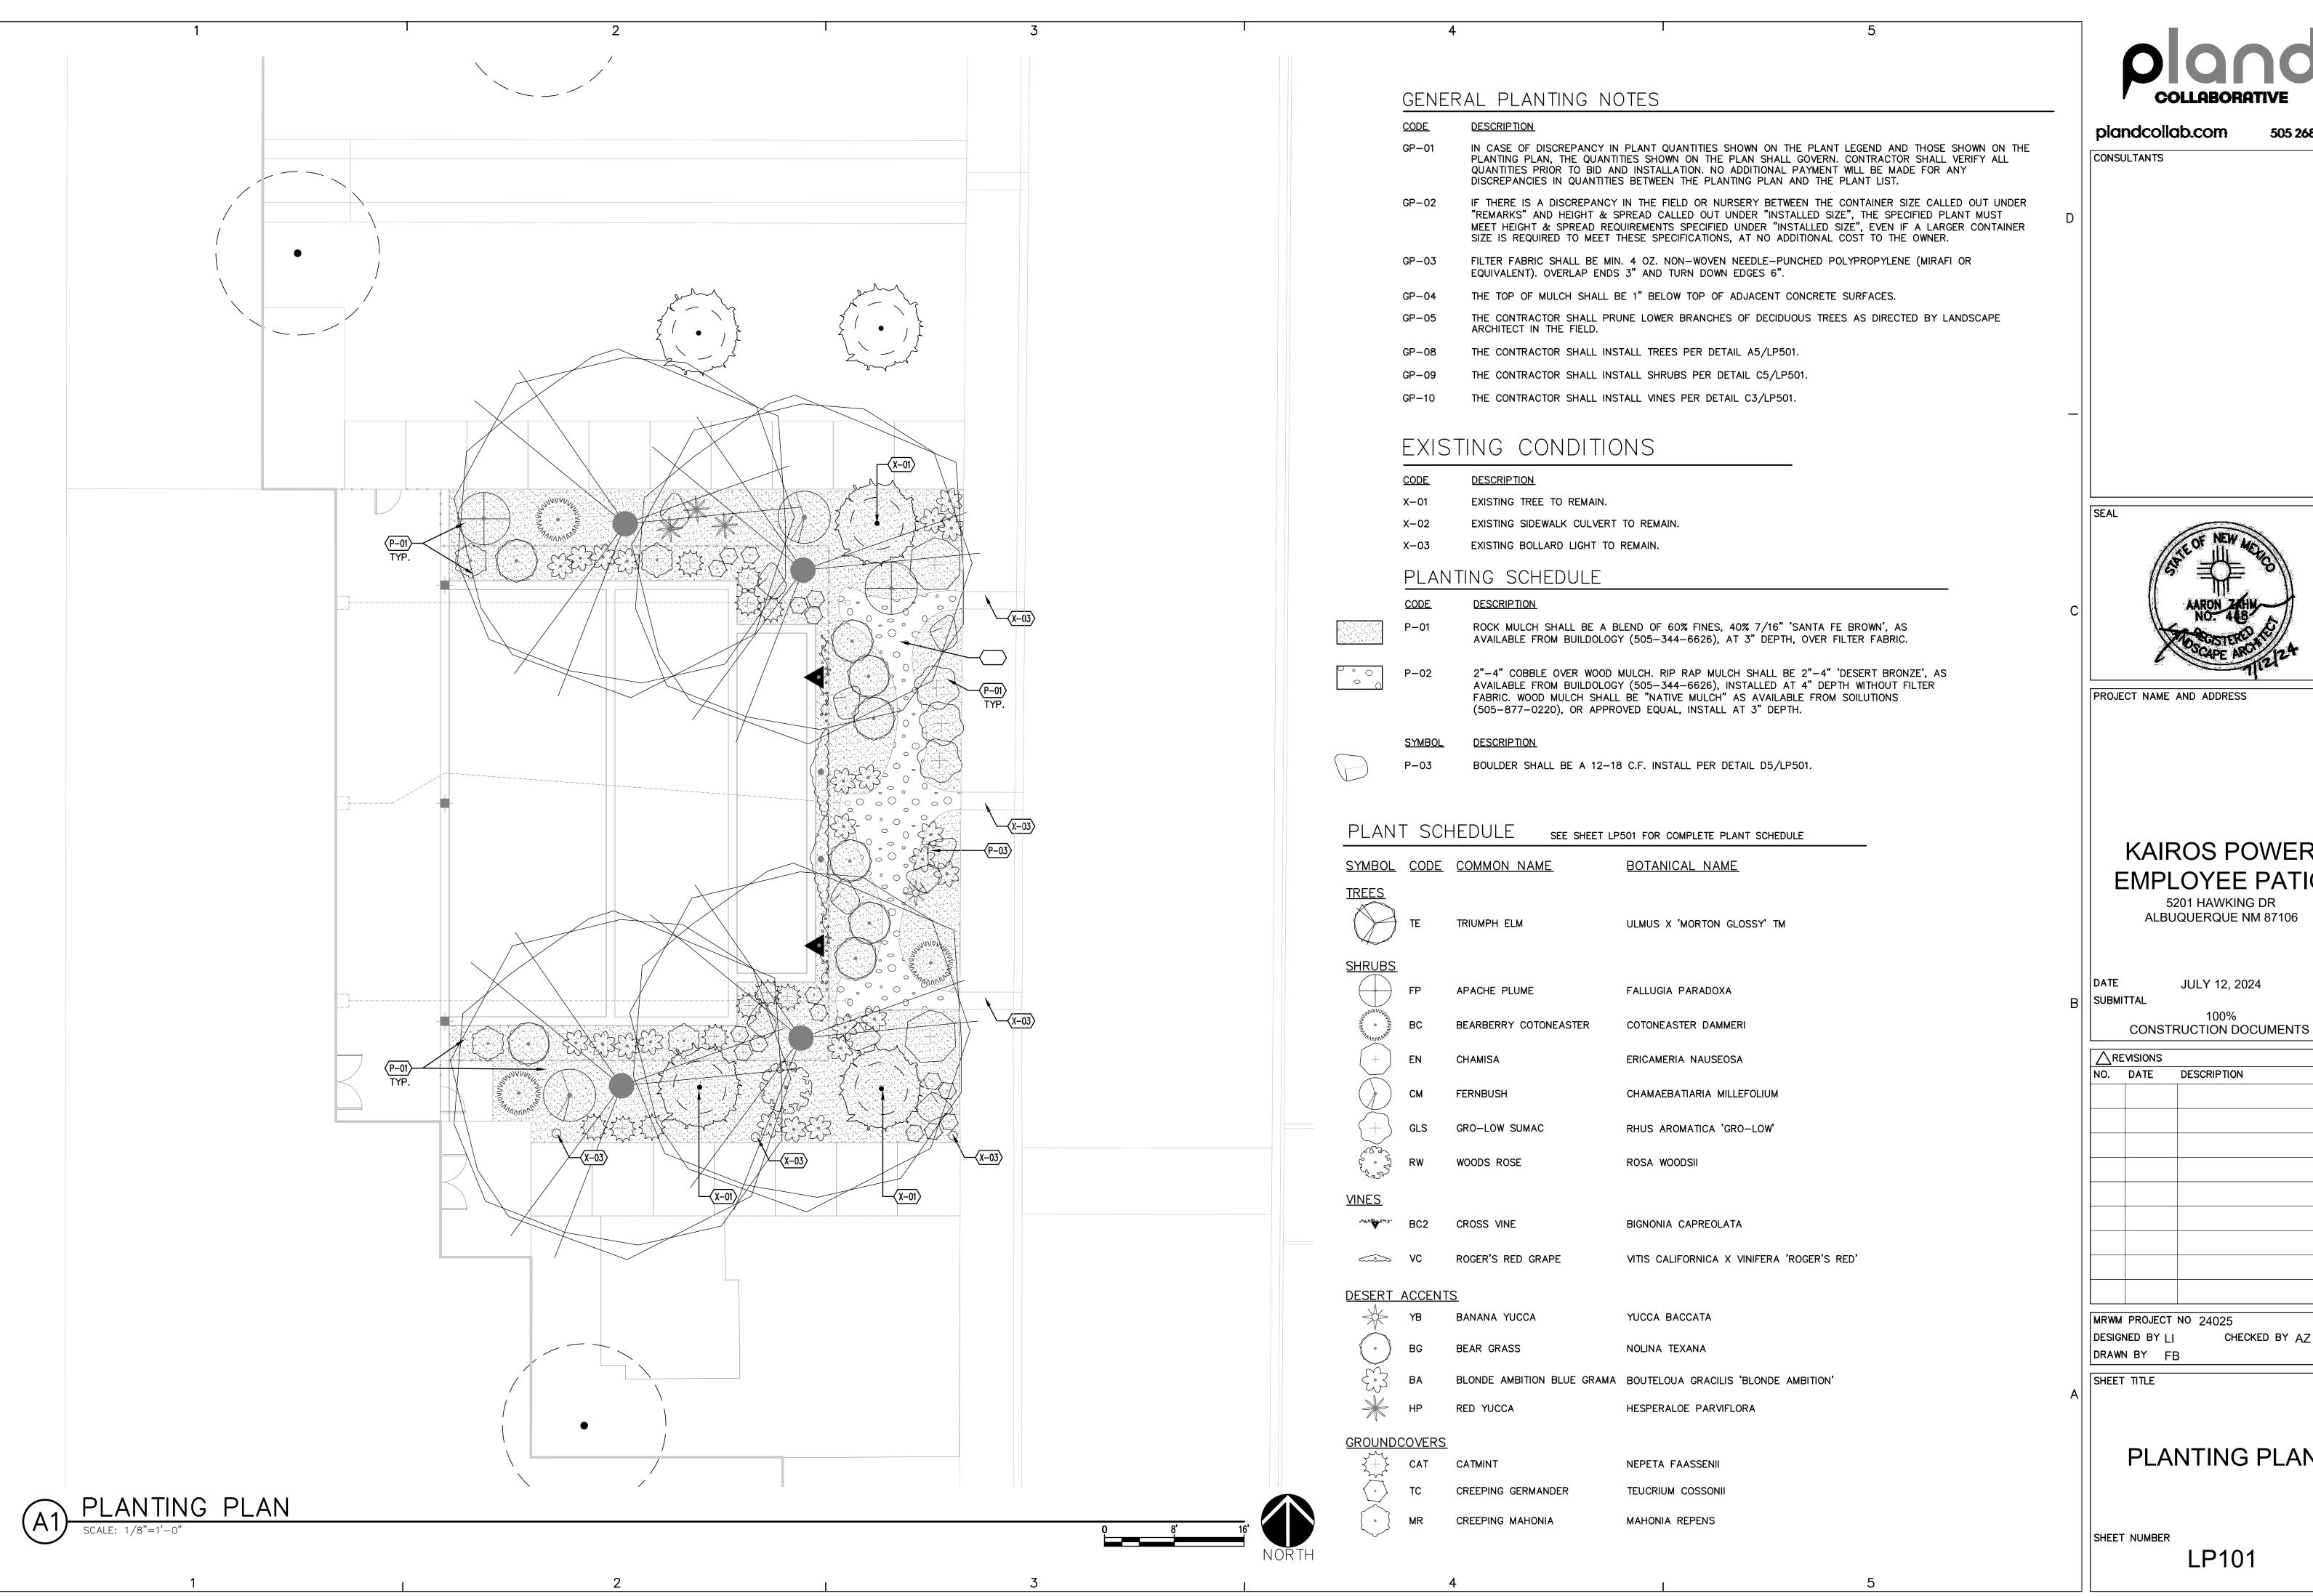



505 268 2266



KAIROS POWER **EMPLOYEE PATIO** 5201 HAWKING DR

ALBUQUERQUE NM 87106

JULY 12, 2024

CHECKED BY AZ

PLANTING PLAN

LP101


## 

- VINE SEE PLAN FOR SPECIES AND LOCATION.
   VERTICAL STRUCTURE SEE PLAN.
   PLANT AT SAME DEPTH AS MAINTAINED AT
- NURSERY. 4. MULCH - SEE PLAN. HOLD BACK 2" FROM VINE
- STEMS. 5. EARTHEN BERM, 6" HEIGHT
- 6. BACKFILL AND SOIL AMENDMENTS SEE SPECIFICATIONS. MIX THOROUGHLY PRIOR TO INSTALLATION.
- 7. SCARIFY EDGE OF PLANTING HOLE, CONTINUOUS
- ALL SIDES.
  8. UNDISTURBED SUBGRADE




## PLANT SCHEDULE

SYMBOL	CODE	QTY	COMMON NAME	BOTANICAL NAME	<u>REMARKS</u>	HT.	SPD.	INSTALLED SIZE
TREES								
	TE	4	TRIUMPH ELM	ULMUS X 'MORTON GLOSSY' TM	B&B	50'	40'	2" CAL., 10'-12' HT.
CHRIBC								
<u>SHRUBS</u>	FP	2	APACHE PLUME	FALLUGIA PARADOXA	5 GAL.	<b>6</b> '	6'	MIN. 18" SPD.
MANANA	rr	2	APACHE PLUME	FALLUGIA PARADUXA	5 GAL.	О	О	MIN. 18 SPD.
NANNANANANANANANANANANANANANANANANANAN	BC	3	BEARBERRY COTONEASTER	COTONEASTER DAMMERI	5 GAL.	1'	5'	MIN. 12" SPD.
+	EN	2	CHAMISA	ERICAMERIA NAUSEOSA	5 GAL.	5'	6'	MIN. 8" HT.
	СМ	2	FERNBUSH	CHAMAEBATIARIA MILLEFOLIUM	5 GAL.	4-6'	4-6'	MIN. 8" HT
+	GLS	3	GRO-LOW SUMAC	RHUS AROMATICA 'GRO-LOW'	5 GAL.	3'	5'	MIN. 18" SPD.
	RW	1	WOODS ROSE	ROSA WOODSII	5 GAL.	6'	6'	MIN. 18" SPD.
<u>VINES</u>								
Actions.	BC2	2	CROSS VINE	BIGNONIA CAPREOLATA	5 GAL.	20'	20'	MIN. 18" HT.
	VC	2	ROGER'S RED GRAPE	VITIS CALIFORNICA X VINIFERA 'ROGER'S RED'	5 GAL.	20'	20'	MIN. 18" HT.
DESERT A	ACCENT	S						
	YB	1	BANANA YUCCA	YUCCA BACCATA	5 GAL.	3'	3'	MIN. 12" HT.
	BG	8	BEAR GRASS	NOLINA TEXANA	5 GAL.	4'	5'	MIN. 12" HT.
£3	ВА	23	BLONDE AMBITION BLUE GRAMA	BOUTELOUA GRACILIS 'BLONDE AMBITION'	3 GAL.	2'	3'	MIN. 8" HT.
	HP	3	RED YUCCA	HESPERALOE PARVIFLORA	5 GAL.	3'	3'	MIN. 12" HT.
GROUNDO	OVERS							
	CAT	11	CATMINT	NEPETA FAASSENII	1 GAL.	1'	3'	MIN. 6" SPD.
	TC	16	CREEPING GERMANDER	TEUCRIUM COSSONII	1 GAL.	6 <b>"</b>	1'-6"	MIN. 6" SPD.
	MR	4	CREEPING MAHONIA	MAHONIA REPENS	5 GAL.	1'	3'	MIN. 18" SPD.

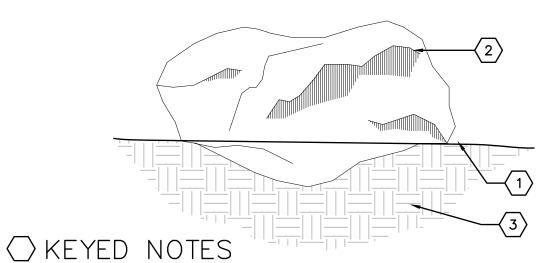


FINISH GRADE (MATERIAL VARIES) - BOULDER SHALL BE BURIED TO MIN 8" DEPTH BELOW FINISH GRADE.
 BOULDER, MOSSROCK OR APPROVED ALTERNATE MATERIAL AS LOCALLY AVAILABLE.
 SUBGRADE COMPACTED TO 95%.



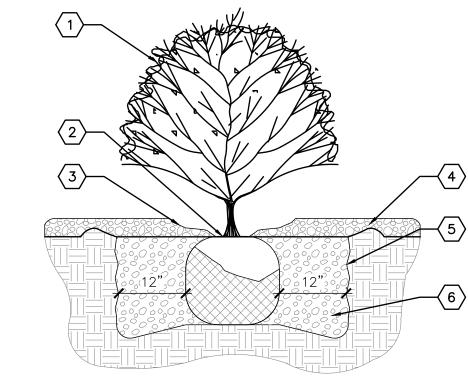

## 

- SHRUB SEE PLAN FOR SPECIES AND LOCATIONS.
   PLANT AT SAME DEPTH MAINTAINED AT NURSERY.
- 3. FEATHER MULCH TO A 2" DEPTH ON TOP OF ROOT BALL AND HOLD BACK 2" FROM SHRUB STEM(S).
- 4. GRAVEL MULCH
  5. SCARIFY EDGE OF PLANTING HOLE, CONTINUOUS ALL SIDES.
  6. BACKFILL AND SOIL AMENDMENTS SEE SPECIFICATIONS.
- SHRUB PLANTING

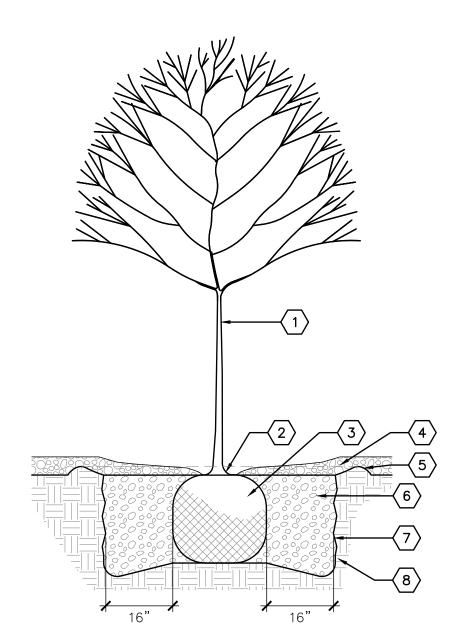

## 


- TREE SEE PLAN FOR SPECIES AND LOCATIONS.
   ROOT FLARE SHALL BE 2"-3" ABOVE GRADE. REMOVE EXISTING SOIL FROM NURSERY TO EXPOSE ROOT FLARE.
   PLACE TREE IN HOLE VERTICALLY. REMOVE WIRE BASKET, WOOD BOX, PLASTIC, TWINE AND/OR ROPE, AND BURLAP PRIOR TO BACKFILLING.
- 4. MULCH SEE PLAN. AVOID MULCH INSTALLATION 4"-6" OF DISTANCE FROM
- TREE TRUNK.
- 5. EARTHEN BERM, 6" HEIGHT
  6. THOROUGHLY MIX BACKFILL AND SOIL AMENDMENTS PRIOR TO INSTALLATION

   SEE SPECIFICATIONS.
  7. SCARIFY EDGE OF PLANTING HOLE, CONTINUOUS ALL SIDES.
  8. UNDISTURBED SUBGRADE



plandcollab.com 505 268 2266

CONSULTANTS

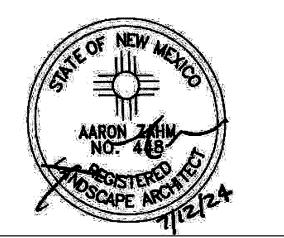

PROJECT NAME AND ADDRESS

## KAIROS POWER EMPLOYEE PATIO

5201 HAWKING DR ALBUQUERQUE NM 87106

JULY 12, 2024 SUBMITTAL

CONSTRUCTION DOCUMENTS

<u></u> RE	VISIONS	
NO.	DATE	DESCRIPTION

MRWM PROJECT NO 24025 CHECKED BY AZ DESIGNED BY LI


SHEET TITLE

DRAWN BY FB

PLANTING DETAILS

SHEET NUMBER

LP501

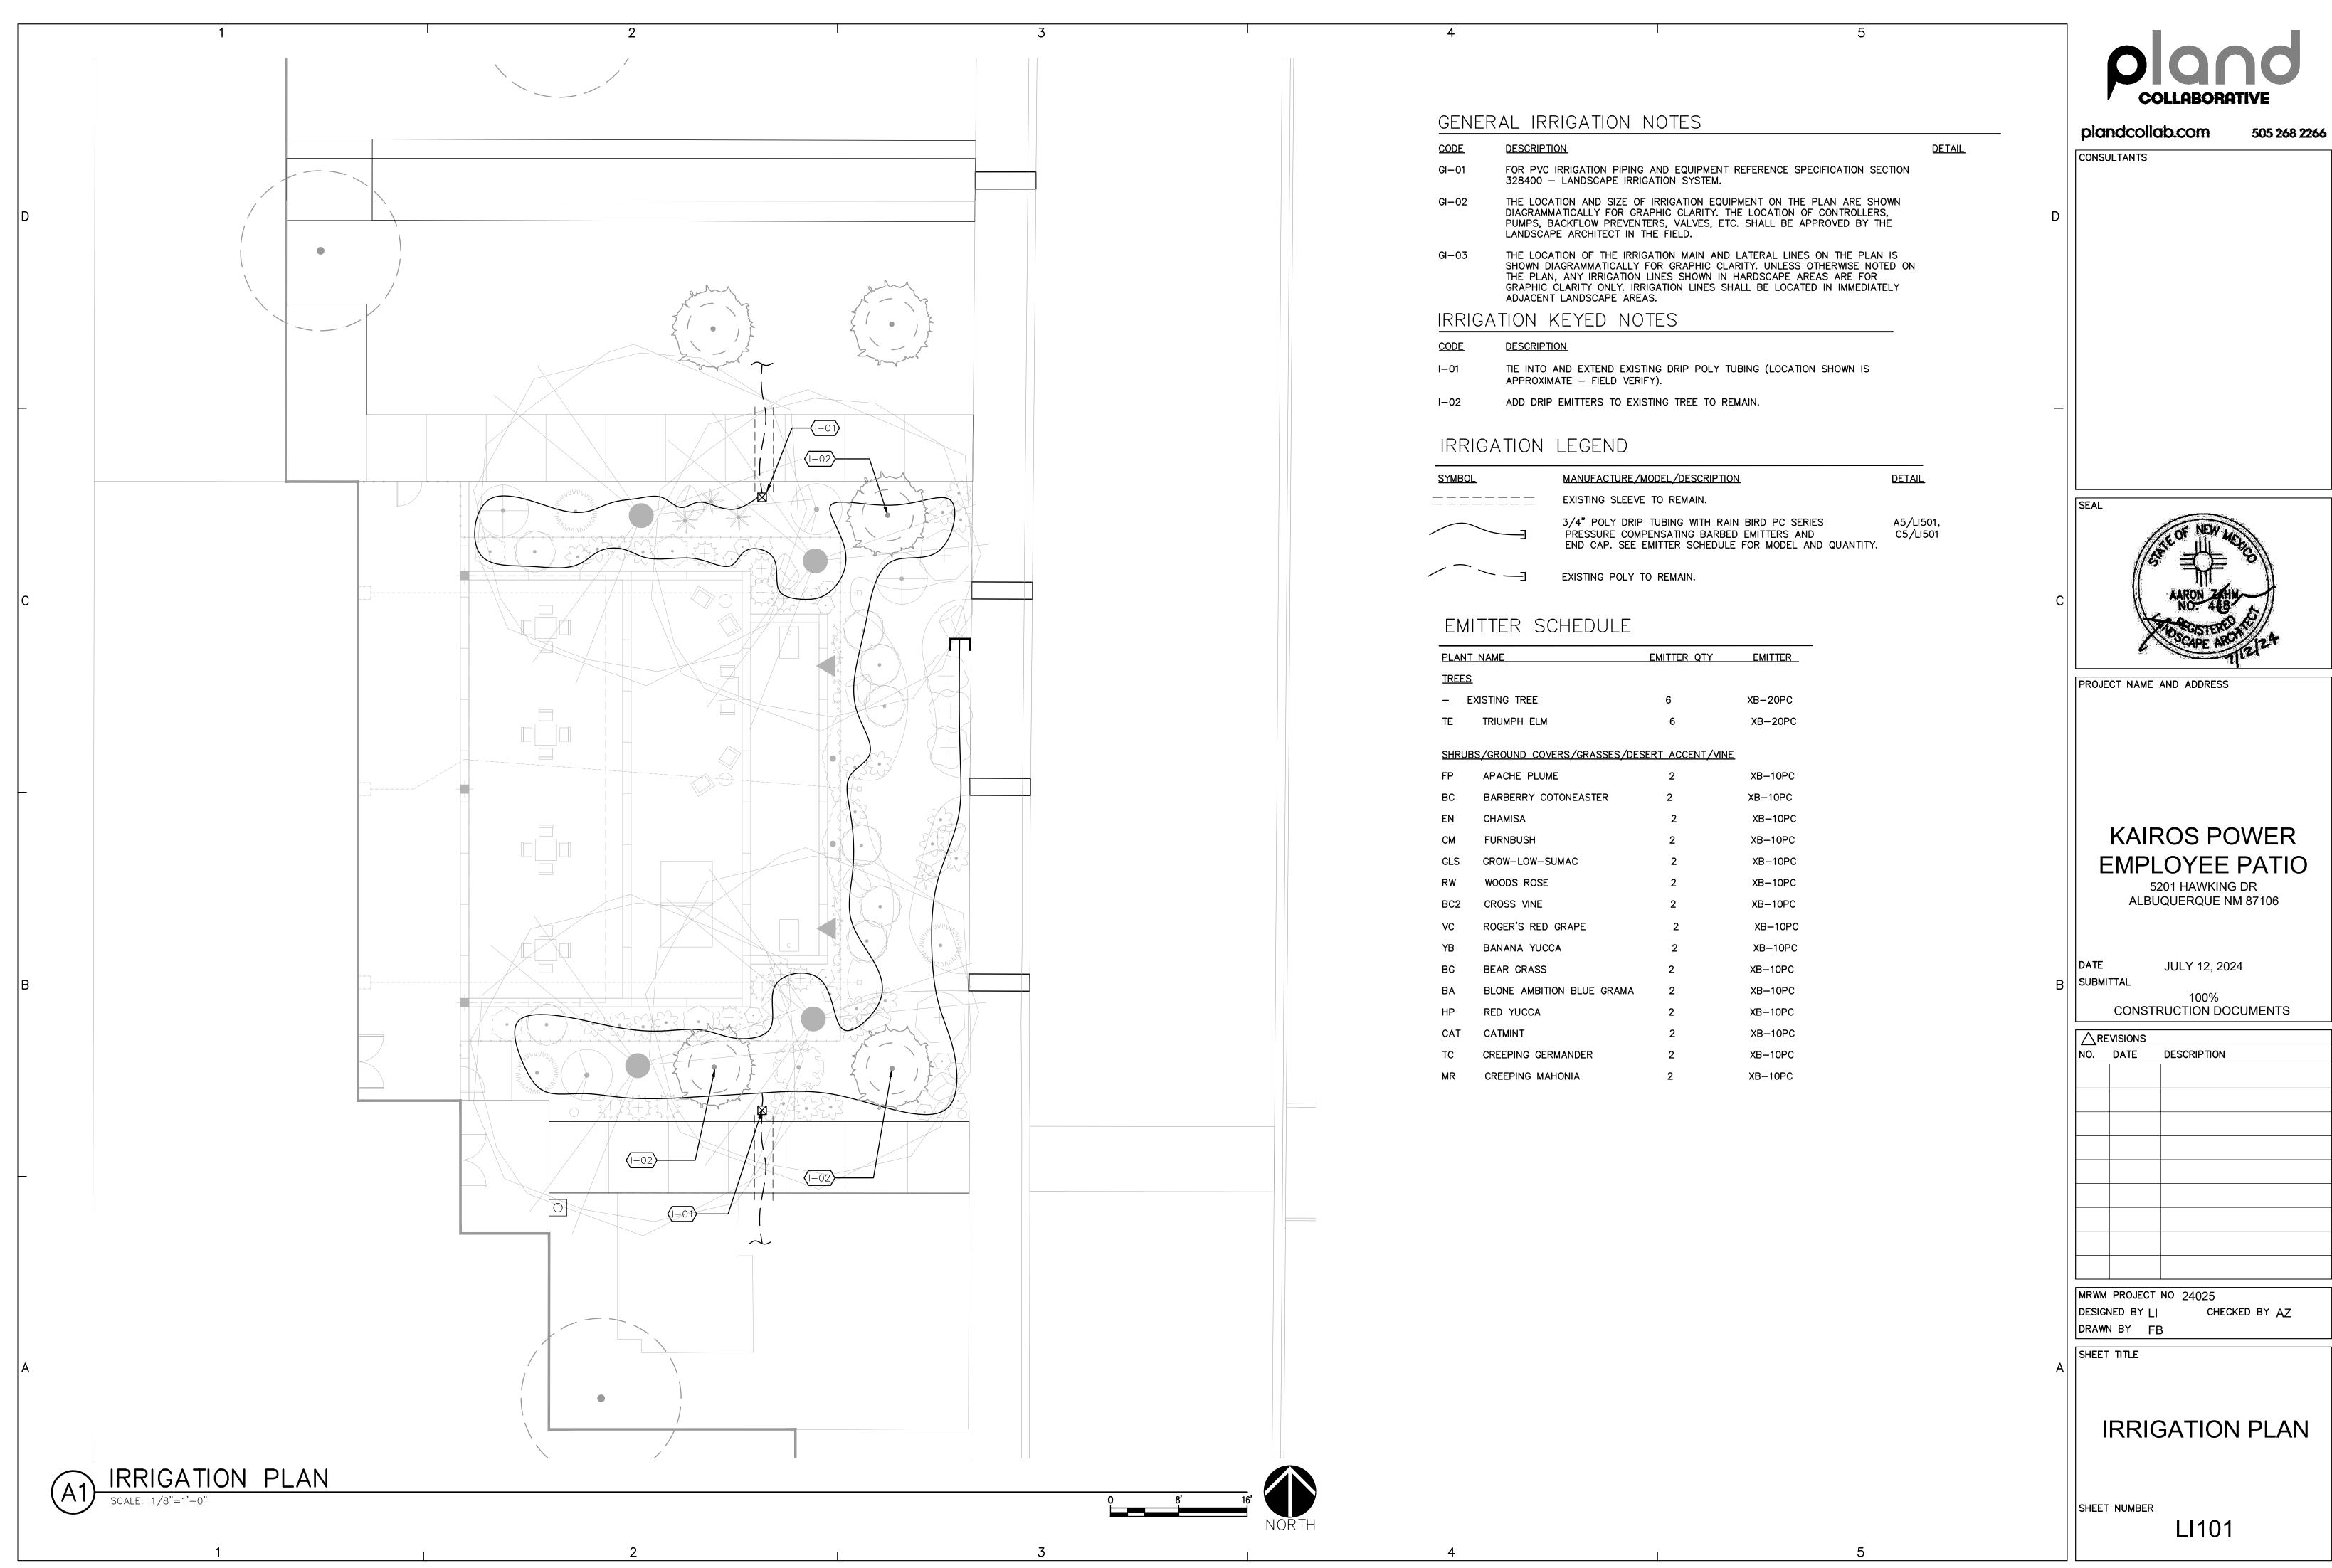

NO.	DATE	DESCRIPTION

plandcollab.com CONSULTANTS 1. FINISH GRADE. 2. APPLIED ENGINEERING SERIES 610, 6" ROUND VALVE BOX. (COLOR: TAN)
3. 1/2" POLYETHYLENE DRIP TUBING. 4. 1/2" RAIN BIRD EASY FIT COMPRESSION COUPLER WITH REMOVABLE FLUSH CAP. 5. 3/4" TO 1" DIAMETER CRUSHED GRAVEL, 6" DEPTH. GRAVEL SHALL BE FREE OF DÍRT AND FINES. 6. SOLID CMU BLOCK (2 EACH). DRIP LINE FLUSH CAP

NOT TO SCALE PROJECT NAME AND ADDRESS <u>PLAN</u> SUBMITTAL CONSTRUCTION DOCUMENTS <u>SECTION</u> MRWM PROJECT NO 24025 TRANSFER BARB.
 1/2" POLYETHYLENE DRIP TUBING.
 FINISH GRADE.
 PLANT ROOTBALL. TREE OR SHRUB PLANTING.
 DRIP EMITTER (SEE LEGEND).
 1/4" DRIPLINE. DESIGNED BY LI DRAWN BY CE SHEET TITLE GENERAL NOTES A. INSTALL EMITTERS ON OPPOSING SIDES D. IF PLANTING ON A 4:1 SLOPE OR STEEPER, INSTALL ALL EMITTERS ON UPHILL SIDE OF ROOTBALL.

CLEAR TOP OF FINISH GRADE BY A MINIMUM OF 1" AND A MAXIMUM OF 2".

C. FLUSH ALL LINES THOROUGHLY, INCLUDING 1/4" TUBING, PRIOR TO EMITTER INSTALLATION. DRIP EMITTER PLACEMENT

NOT TO SCALE SHEET NUMBER



505 268 2266



## KAIROS POWER **EMPLOYEE PATIO**

5201 HAWKING DR ALBUQUERQUE NM 87106

JULY 12, 2024

NO.	DATE	DESCRIPTION

CHECKED BY AZ

IRRIGATION DETAILS

LI501