

PROJECT NO. PR-2020-004538 APPLICATION NO. SI-2022-02197- SITE PLAN

THIS PLAN IS CONSISTENT WITH THE SPECIFIC SITE DEVELOPMENT PLAN APPROVED BY THE EPC, DATED _____ AND THE FINDINGS AND CONDITIONS IN THE OFFICIAL NOTIFICATION OF DECISION ARE SATISFIED.

IS AN INFRASTRUCTURE LIST REQUIRED? () YES () NO IF YES, THEN A SET OF APPROVED DRC PLANS WITH A WORK ORDER IS REQUIRED FOR ANY CONSTRUCTION WITHIN PUBLIC RIGHT-OF-WAY OR FOR CONSTRUCTION OF PUBLIC IMPROVEMENTS. DRB SITE DEVELOPMENT PLAN FOR BUILDING PERMIT;

Mar 13, 2023 Mar 24, 2023 Mar 13, 2023 Mar 13, 2023 Albert Mar 13, 2023 08:20 MDT) Mar 13, 2023

*ENVIRONMENTAL HEALTH DEPARTMENT (CONDITIONAL)

Mar 27, 2023 BRB CHAIRPERSON, ALBUQUERQUE PLANNING DEPARTMENT *ENVIRONMENTAL HEALTH, IF NECESSARY

PROJECT INFORMATION NEW OFFICE/WAREHOUSE 7500 FORTUNA, NW ALBUQUERQUE, NEW MEXICO ENGINEER SEAL

OWNER: BRUNACINI BUILDERS 1 OPPORTUNITY LAND, LLC TATE FISHBURN ARCHITECT **LEGAL DESCRIPTION:** LOT D-1 MERIDIAN BUSINESS PARK II

333,752 SF 7.66 ACRES

OFFICE 30,600 GSF WAREHOUSE 71,400 GSF

OFF-STREET PARKING 30,600 GSF 3.5:1000 = 108 SPACES 71,400 GSF NO REQUIREMENT REQUIRED 108 SPACES

TOTAL SPACES PROVIDED 143 SPACES HANDICAP PARKING (101-300 PRVD) = REQUIRED 8 SPACES TOTAL (2 VAN) PROVIDED 8 SPACES TOTAL (2 VAN)

REQUIRED 4 SPACES PROVIDED 4 SPACES BICYCLE PARKING (10% RQD PARKING SPACES) = PROVIDED 12 SPACES

1. ALL SITE LIGHTING SHALL COMPLY WITH IDO SECTION 14-16-5-8. OUTDOOR AND SITE LIGHTING.

2. PLACEMENT OF FIXTURES & STANDARDS SHALL CONFORM TO STATE & LOCAL SAFETY & ILLUMINATION REQUIREMENTS.

ALL LIGHT FIXTURES SHALL BE FULLY SHIELDED HORIZONTAL LAMPS WITH NO LIGHT, LENS OR BULB PROTRUDING BELOW THE BOTTOM OF THE CUT-OFF FIXTURE IN ORDER THAT NO FUGITIVE LIGHT SHALL ESCAPE BEYOND THE PROPERTY LINE AND NO SITE LIGHTING LIGHT SOURCE SHALL BE VISIBLE FRO THE SITE

ROOF TOP AND GROUND MOUNTED EQUIPMENT SHALL BE SCREENED FROM THE PUBLIC VIEW BY MATERIALS OF THE SAME NATURE AS THE BUILDINGS BASIC MATERIALS. THE TOP OF ALL ROOFTOP EQUIPMENT SHALL BE BELOW THE TOP OF THE PARAPET OR SCREENED FROM VIEW FROM PUBLIC RIGHTS-OF-WAY AND THE SITE ACCESS EASEMENT,

6. ALL ADA CURB RAMPS WITHIN THE PUBLIC ROW SHALL BE UPDATED TO CURRENT STANDARDS AND HAVE TRUNCATED DOMES INSTALLED.

7. ALL BROKEN OR CRACKED SIDEWALK MUST BE REPLACED WITH SIDEWALK AND CURB & GUTTER.

REVISIONS

---- EASEMENT LINE

HANDICAP PARKING PAVEMENT MARKING FIRE HYDRANT

SITE DISTANCE AND SITE TRIANGLE BASED ON COA DPM 7-5(1)(5)(iii) and 7-5(i)(5)(iv), LANDSCAPING AND SIGNAGE WILL NOT INTERFERE WITH CLEAR SIGHT REQUIREMENTS, THEREFORE SIGNS, WALLS, TREES, AND SHRUBBERY BETWEEN 3 AND 8 FEET TALL (AS MEASURED FROM THE GUTTER PAN) WILL NOT BE ACCEPTABLE IN THE CLEAR SITE TRIANGLE

DATE OCTOBER 13, 2022 1"=50'-0"

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ARCHITECT SEA

NR-BP

102,000 GSF

PROJECT

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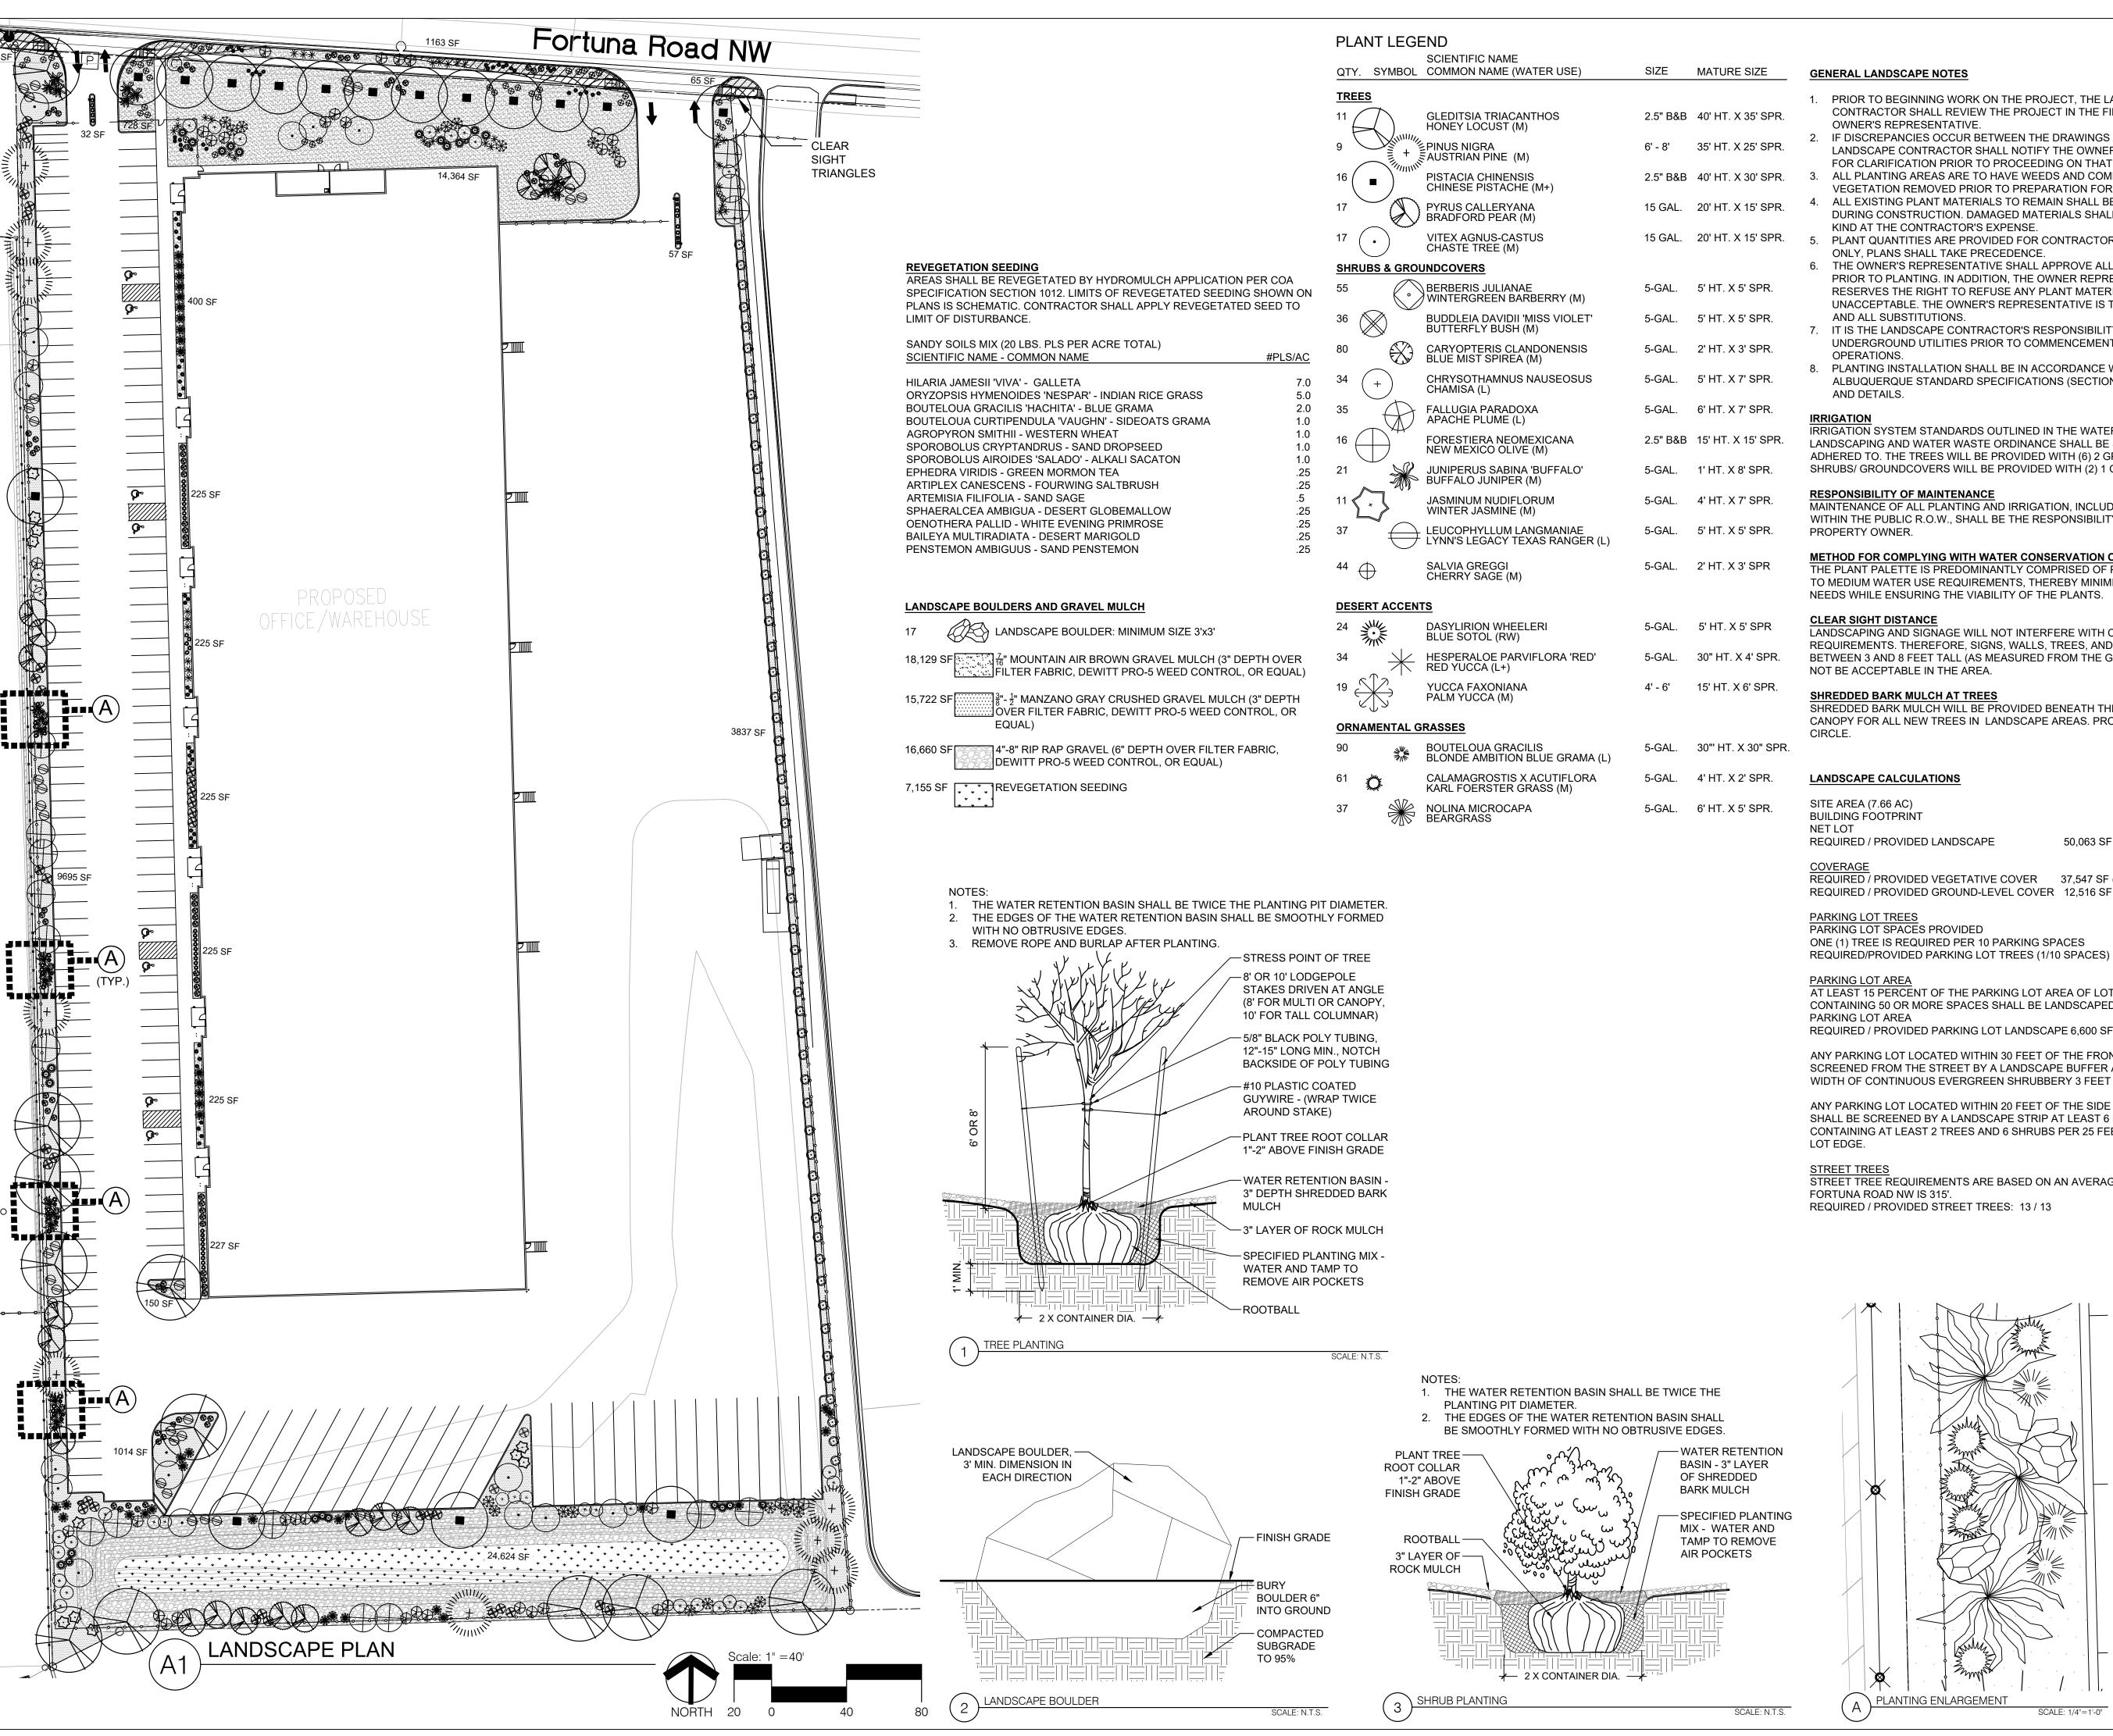
TATE FISHBURN

DRAWING NAME SITE DEVELOPMENT

PLAN

OR AS NOTED

SHEETNUMBER



- 1. PRIOR TO BEGINNING WORK ON THE PROJECT, THE LANDSCAPE CONTRACTOR SHALL REVIEW THE PROJECT IN THE FIELD WITH THE OWNER'S REPRESENTATIVE.
- 2. IF DISCREPANCIES OCCUR BETWEEN THE DRAWINGS AND THE SITE, THE LANDSCAPE CONTRACTOR SHALL NOTIFY THE OWNER'S REPRESENTATIVE
- FOR CLARIFICATION PRIOR TO PROCEEDING ON THAT PORTION OF WORK. ALL PLANTING AREAS ARE TO HAVE WEEDS AND COMPETITIVE
- VEGETATION REMOVED PRIOR TO PREPARATION FOR PLANTING. ALL EXISTING PLANT MATERIALS TO REMAIN SHALL BE PROTECTED DURING CONSTRUCTION. DAMAGED MATERIALS SHALL BE REPLACED IN
- KIND AT THE CONTRACTOR'S EXPENSE PLANT QUANTITIES ARE PROVIDED FOR CONTRACTOR'S CONVENIENCE
- THE OWNER'S REPRESENTATIVE SHALL APPROVE ALL PLANT MATERIAL PRIOR TO PLANTING. IN ADDITION, THE OWNER REPRESENTATIVE RESERVES THE RIGHT TO REFUSE ANY PLANT MATERIAL DEEMED UNACCEPTABLE. THE OWNER'S REPRESENTATIVE IS TO APPROVE ANY
- 7. IT IS THE LANDSCAPE CONTRACTOR'S RESPONSIBILITY TO LOCATE ALL UNDERGROUND UTILITIES PRIOR TO COMMENCEMENT OF PLANTING
- 8. PLANTING INSTALLATION SHALL BE IN ACCORDANCE WITH ALL CITY OF ALBUQUERQUE STANDARD SPECIFICATIONS (SECTION 1005 - PLANTING)

IRRIGATION SYSTEM STANDARDS OUTLINED IN THE WATER CONSERVATION LANDSCAPING AND WATER WASTE ORDINANCE SHALL BE STRICTLY ADHERED TO. THE TREES WILL BE PROVIDED WITH (6) 2 GPH EMITTERS AND SHRUBS/ GROUNDCOVERS WILL BE PROVIDED WITH (2) 1 GPH EMITTERS.

RESPONSIBILITY OF MAINTENANCE

MAINTENANCE OF ALL PLANTING AND IRRIGATION, INCLUDING THOSE WITHIN THE PUBLIC R.O.W., SHALL BE THE RESPONSIBILITY OF THE

METHOD FOR COMPLYING WITH WATER CONSERVATION ORDINANCE
THE PLANT PALETTE IS PREDOMINANTLY COMPRISED OF PLANTS WITH LOW TO MEDIUM WATER USE REQUIREMENTS, THEREBY MINIMIZING IRRIGATION NEEDS WHILE ENSURING THE VIABILITY OF THE PLANTS.

LANDSCAPING AND SIGNAGE WILL NOT INTERFERE WITH CLEAR SIGHT REQUIREMENTS. THEREFORE, SIGNS, WALLS, TREES, AND SHRUBBERY BETWEEN 3 AND 8 FEET TALL (AS MEASURED FROM THE GUTTER PAN) WILL NOT BE ACCEPTABLE IN THE AREA.

SHREDDED BARK MULCH WILL BE PROVIDED BENEATH THE ENTIRE TREE CANOPY FOR ALL NEW TREES IN LANDSCAPE AREAS. PROVIDE 3' DIAMETER

333,752 SF - 102,000 SF 231,752 SF 50,063 SF (15%) / 57,666 SF (17%)

REQUIRED / PROVIDED VEGETATIVE COVER 37,547 SF (75%) / 45,547 SF (91%) REQUIRED / PROVIDED GROUND-LEVEL COVER 12,516 SF (25%) / 12,997 SF (26%)

PARKING LOT SPACES PROVIDED 143 ONE (1) TREE IS REQUIRED PER 10 PARKING SPACES 14 / 15

PARKING LOT AREA
AT LEAST 15 PERCENT OF THE PARKING LOT AREA OF LOTS CONTAINING 50 OR MORE SPACES SHALL BE LANDSCAPED.


44,000 SF REQUIRED / PROVIDED PARKING LOT LANDSCAPE 6,600 SF (15%) / 11,950 SF (27%)

ANY PARKING LOT LOCATED WITHIN 30 FEET OF THE FRONT LOT LINE SHALL BE SCREENED FROM THE STREET BY A LANDSCAPE BUFFER AT LEAST 10 FEET IN WIDTH OF CONTINUOUS EVERGREEN SHRUBBERY 3 FEET IN HEIGHT.

ANY PARKING LOT LOCATED WITHIN 20 FEET OF THE SIDE OR REAR LOT LINE SHALL BE SCREENED BY A LANDSCAPE STRIP AT LEAST 6 FEET WIDE CONTAINING AT LEAST 2 TREES AND 6 SHRUBS PER 25 FEET OF THE PARKING

STREET TREE REQUIREMENTS ARE BASED ON AN AVERAGE SPACING OF 25' O. FORTUNA ROAD NW IS 315'.

REQUIRED / PROVIDED STREET TREES: 13 / 13

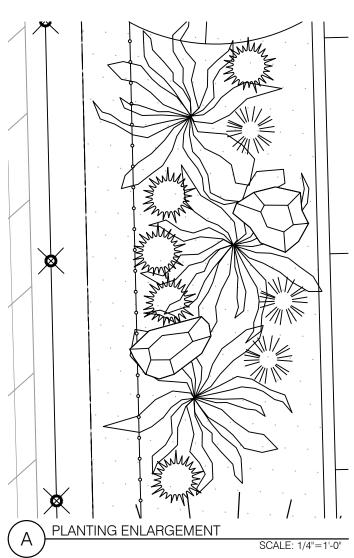



Planning / Landscape Architecture 302 Eighth Street NW Albuquerque, NM 87102

(505) 764-9801 Fax 842-5495

e-mail:cp@consensusplanning.com

DESCRIPTION



PHONE: 505-348-4000 FAX: 505-348-4055

TATE FISHBURN A R C H I T E C 1 BOX2941 CORRALES NEW MEXICO 87048 505 899 9338 FAX899 9328





NEW OFFICE / WAREHOUSE FOR **BRUNACINI DEVELOPMENT**

ALBUQUERQUE, NM

7500 FORTUNA NW

OCTOBER 26, 2022

Not for Construction

SUBMITTAL: 10/26/22												
	REVISIONS											
C.	NO.	DATE	DESCRIP	TION								
	PROJECT NO: 1083-09 CAD DWG FILE: DESIGNED BY: ISH DATE:10/26/2											
	DRAV	NN BY: I	SH	DATE:10/26/22								

LANDSCAPE PLAN

CHECKED BY: KR / JS DATE:10/26/22

DRAWING SHEET

SHEET TITLE

LP-101

EXTERIOR FINISHES

TILT-UP CONC. PANELS- FIELD COLOR - DARK GRAY TILT-UP CONC. PANELS- ACCENT COLOR - MEDIUM GRAY

METAL SIDING-COLOR- LIGHT GRAY

METAL ACCENT COLOR— WHITE

ALUMINUM WINDOW FRAMES- CLEAR ANODIZED WINDOW GLAZING- 1" TINTED INSULATED

TINT COLOR- SOLAR GRAY OVERHEAD & HM DOORS- MEDIUM GRAY

ALL BUILDING MOUNTED LIGHT FIXTURES SHALL BE FULLY SHIELDED HORIZONTAL LAMPS WITH NO LIGHT, LENS OR BULB PROTRUDING BELOW THE BOTTOM OF THE CUT-OFF FIXTURE IN ORDER THAT NO FUGITIVE LIGHT SHALL ESCAPE BEYOND THE PROPERTY LINE AND NO SITE LIGHTING LIGHT SOURCE SHALL BE VISIBLE FRO THE SITE PERIMETER.

ALL BUILDING MOUNTED SIGNAGE TO BE LIGHTED EITHER INTERNALLY OR EXTERNALLY. ANY LIGHTING FOR SIGNAGE SHALL CONFORM TO NIGHT SKIES ACT. SIGNAGE MATERIAL TO BE EITHER RAISED METAL LETTERING OR TRANSLUCENT LEXAN PANELS OF ANY COLOR, NO BOX SIGNAGE ALLOWED. INDIVIDUAL RAISED LETTERS ONLY,


NOTE: SIGNAGE MAY BE AMENDED PROVIDED IT COMPLIES WITH THE ATRISCO BUSINESS PARK MASTERPLAN REGULATIONS.


BUILDING SIGNAGE CALCS:

EAST ELEVATION— BLDG. AREA.-20,583 S.F. SIGNAGE— 600 S.F. 600 / 20,583 = 3%

NORTH ELEVATION- BLDG, AREA.-7,340 S.F. SIGNAGE- 200 S.F. 200 / 7,340 = 2.7%

GRAPHIC SCALE

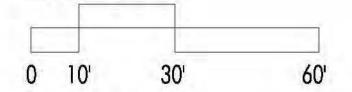

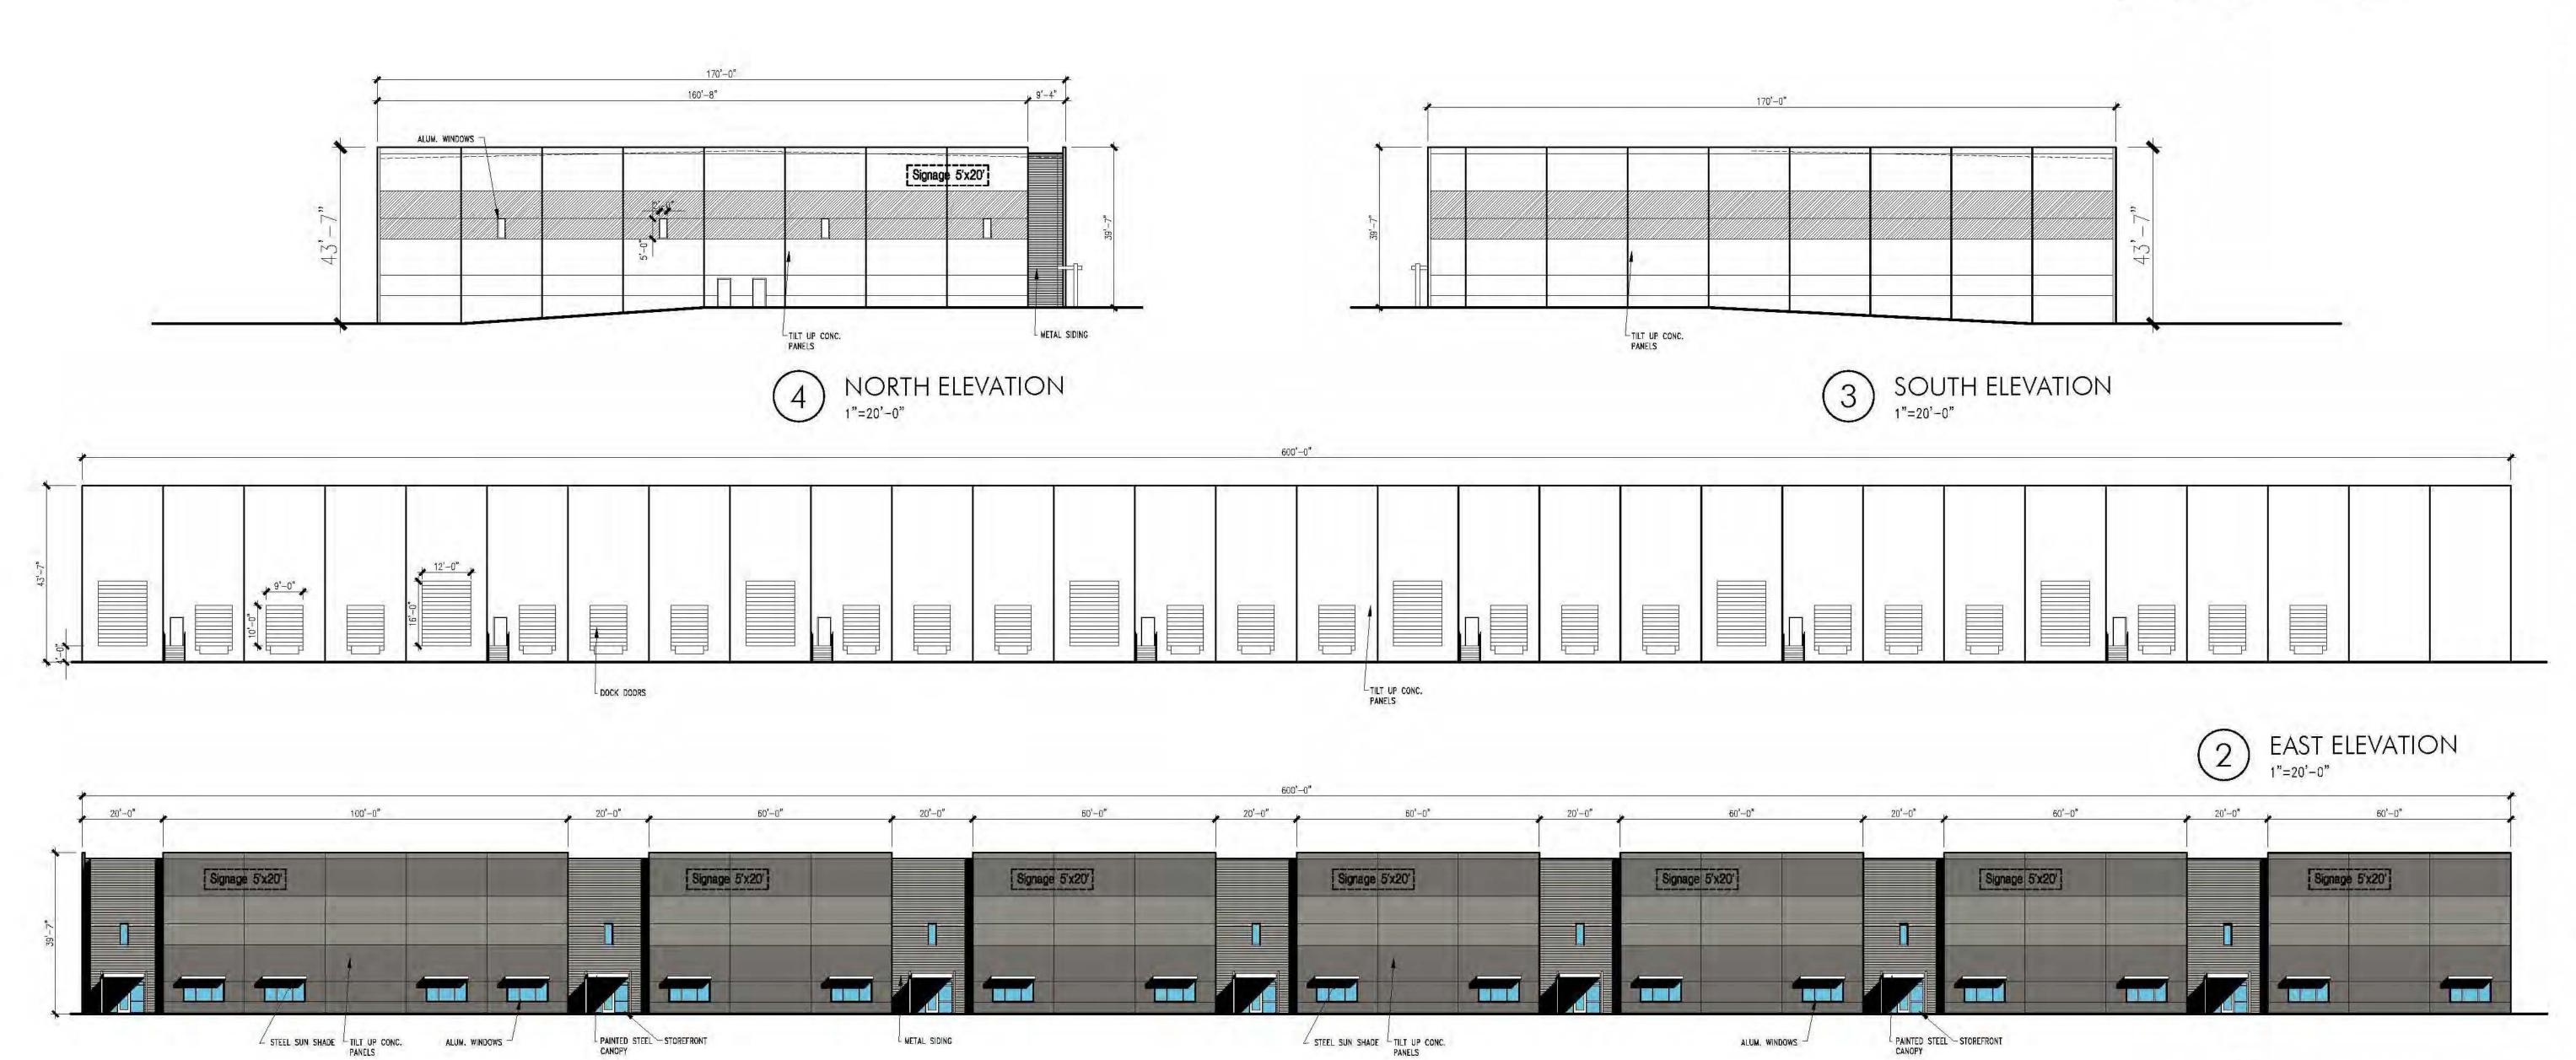


ALUM, WINDOWS

PAINTED STEEL STOREFRONT CANOPY

ALUM. WINDOWS

METAL SIDING

WEST ELEVATION
1"=20'-0"

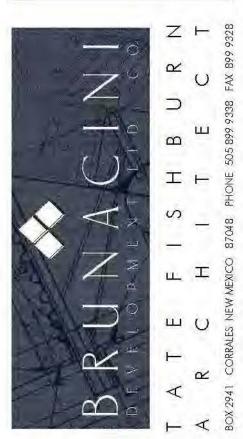



PROJECT

HOUSE NEW OFFICE/WAREH FOR BRUNACINI DEVELC 7500 FORTUNA, N ALBUQUERQUE, NEW I

REVISIONS


OCTOBER 13, 2022

1"=20'-0" OR AS NOTED

DRAWINGNAME

BUILDING ELEVATIONS

SHEET NUMBER

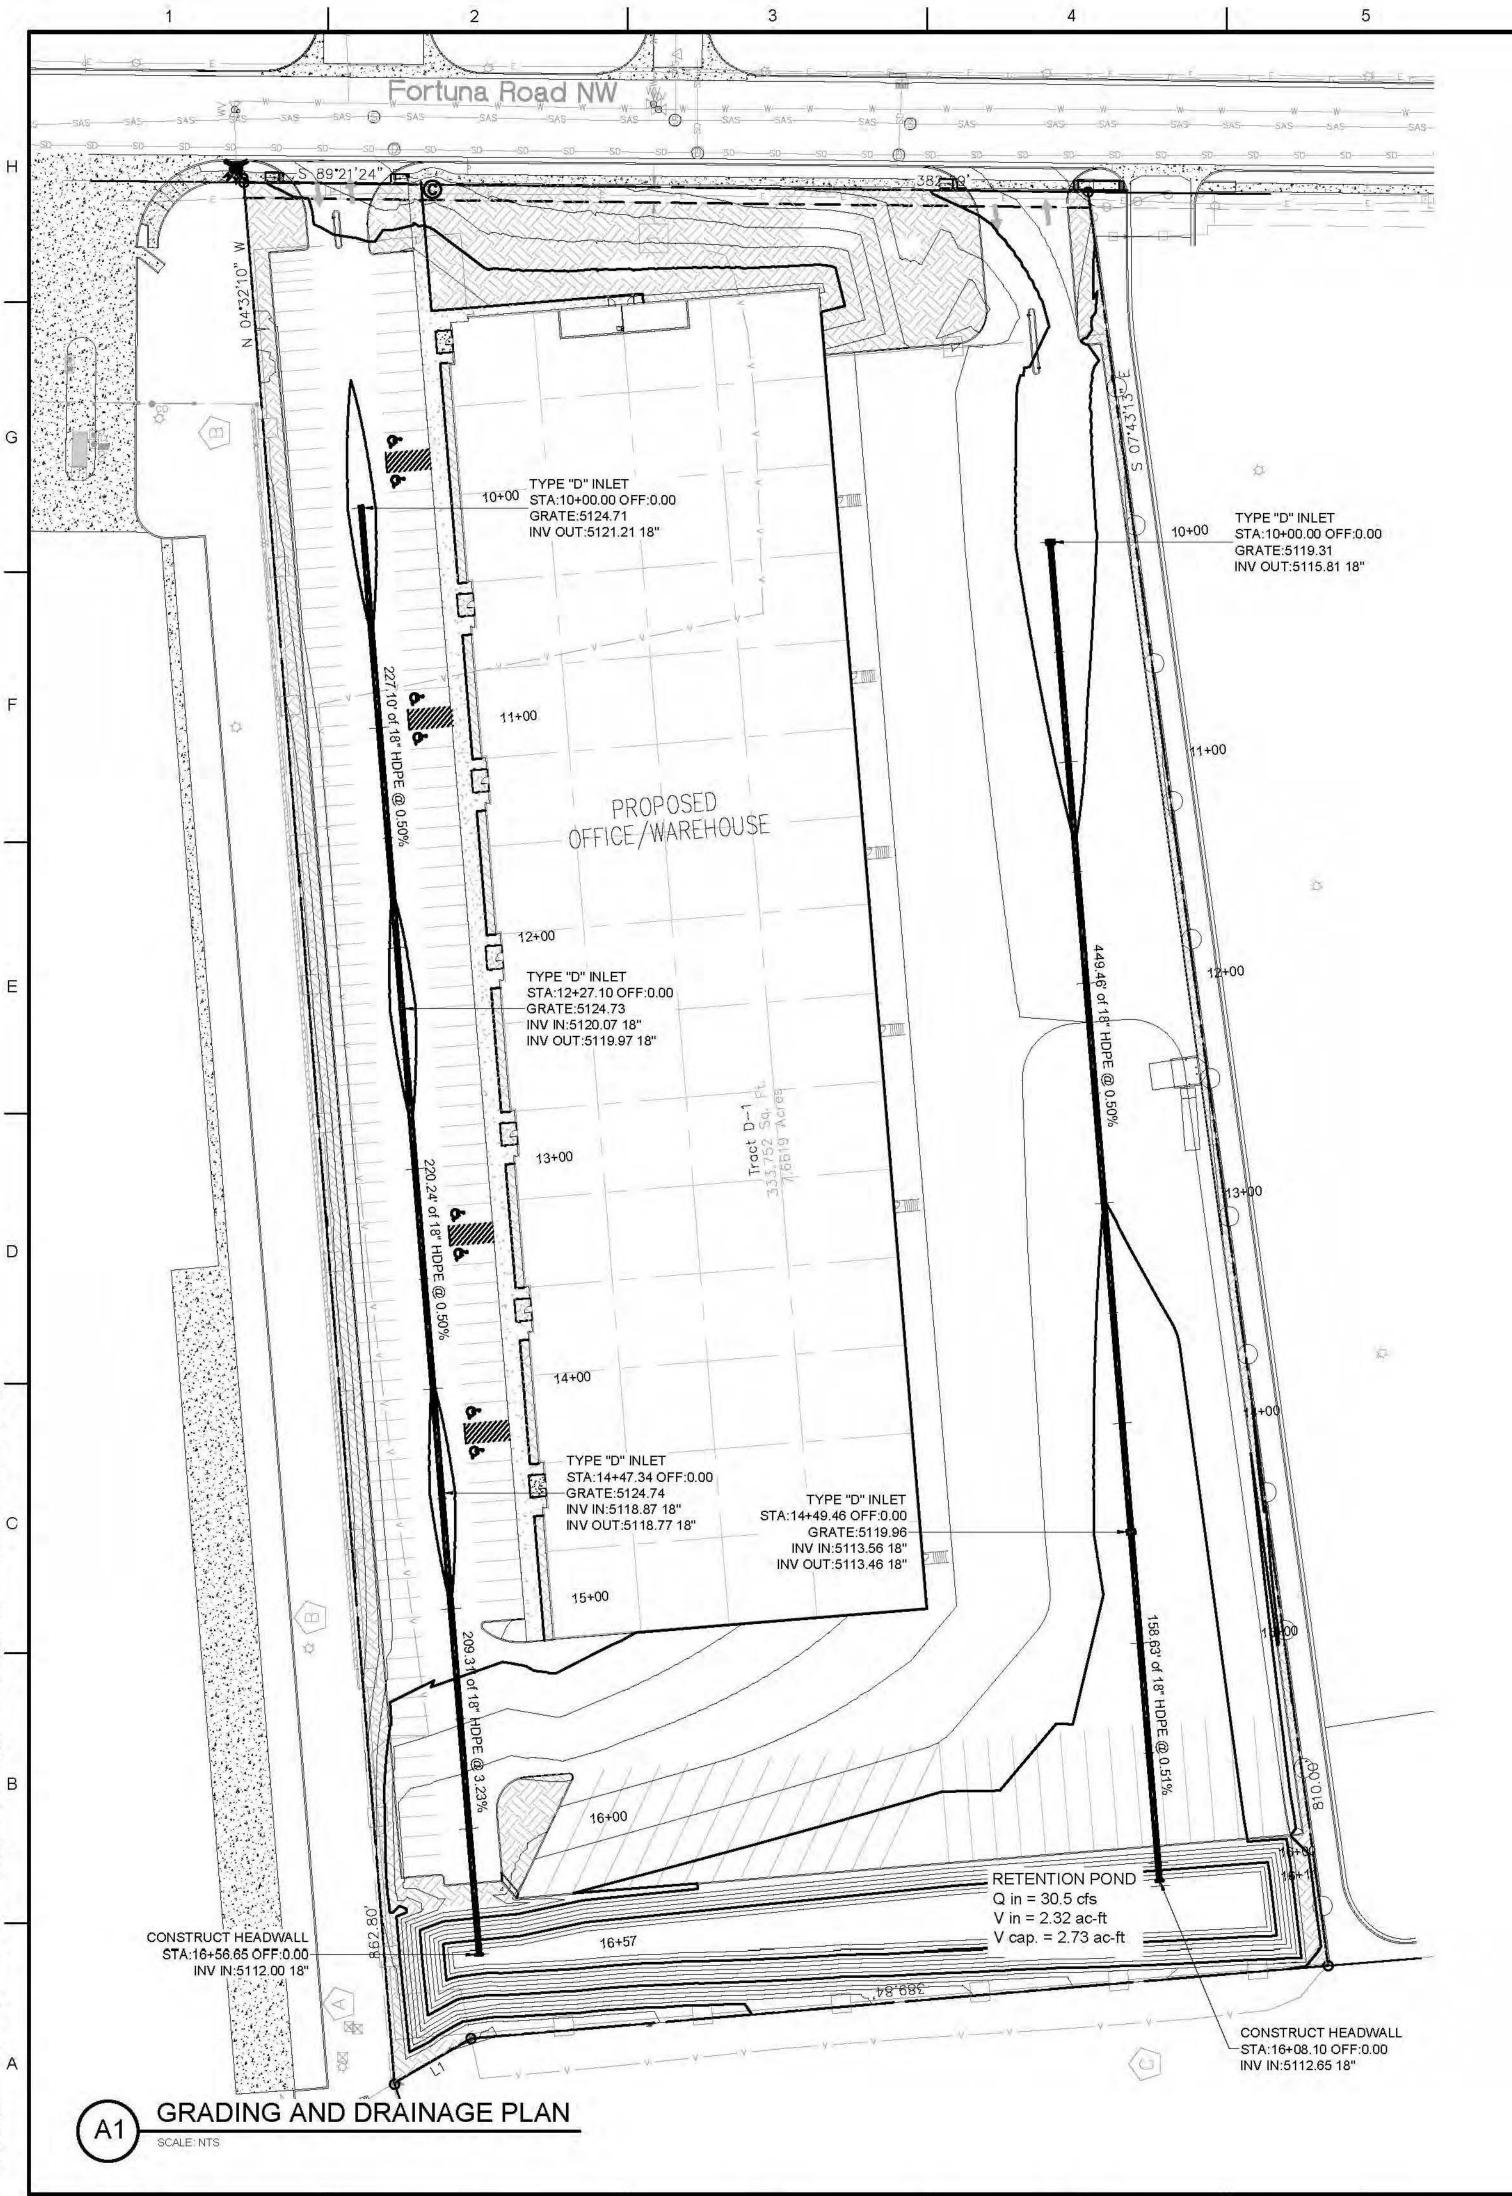

Drainage Narrative

Introduction

The project site is located at 7500 Fortuna Rd. NW. The site is bounded by Fortuna Road NW to the north, Gallatin Place NW to the west, and Los Volcanes Road NW to the south. The existing site and proposed improvements are contained within Tract D-1 of Meridian Business Park II. The site is labeled as an area of minimal flood hazard (Zone X) in the FEMA flood plain map service center, see firm maps 35001C0326J and 35001C0328J.

Existing Conditions

The existing site topography in Tract D-1 generally drains from west to east by review of survey topography and site visit. Across the southern edge of the property, there is approximately 6 feet of elevation difference from the southwestern corner to the southeastern corner. The site was recently used as a temporary stockpile and borrow site for neighboring development, and a large portion of the site was left compacted and barren. The temporary ponding area for the stockpile has since been filled according to topographic data and site inspection, allowing flow to continue draining east toward the neighboring property. There is an existing retention pond on the northwestern corner of the site. No drainage infrastructure was observed to outfall to the pond, and it likely only receives flow from the

In its current condition, the on-site basin is generating a peak discharge of 22.1 cfs for the 100-year 24-hour event. The site is generating a runoff volume of 0.6818 ac-ft for the 100-year 24-hour event, and a volume of 0.7664 ac-ft for the 100-year 10-day event. **Proposed Conditions**

A 102,000 square-foot tenant space is to be constructed, with entrances, sidewalk, and parking for the new office space on the western side of the building. The eastern face of the building will have a loading bay with a 4-foot vertical drop from the finished floor elevation. A trash enclosure is to be constructed along the eastern edge of the site. The enclosure will be raised to reduce the amount of surface runoff that drains through this location. The proposed site will direct surface runoff towards the western and eastern edges of the site, where a series of Type D sag inlets will be constructed to capture the flow. There will be 3 inlets in the western parking area, and 2 inlets on the eastern side of the building.

A proposed retention pond is to be constructed on the southernmost edge of the site. Tie in slopes at the western edge of the pond require that a 2:1 side slope be used. To protect the slopes, gravel mulch will be laid. To retain the 100-year 10-day storm without altering the pond boundary, water will be allowed to pond in the site up to the 5121 contour, with the site boundary bermed as needed to prevent flow from spilling into the neighboring lots. At this elevation, the pond will spill to the north toward Fortuna Rd. in the event that this pond overtops. A dry well will be installed in the pond to increase the pond's permeability and reduce the amount of time that water sits in the pond. The storm drain lines on each side of the site will discharge to the proposed pond. The western and eastern lines will be 18" HDPE. These lines will discharge at the bottom of pond. A concrete rundown will be constructed along the southern edge of the trailer parking to allow surface runoff from the vicinity to enter the pond. The southwestern corner of the lot will have a concrete passage running west to east through a median feature to permit flow from the area to travel to the rundown.

In the proposed condition, the on-site basin is generating a peak discharge of 30.5 cfs for the 100-year 24-hour event. The site is generating a runoff volume of 1.5212 ac-ft for the 100-year 24-hour event, and a volume of 2.3221 ac-ft for the 100-year 10-day event. Conclusion

In summary, Type D inlets and 18" HDPE storm drain will be installed to capture on-site flows and deliver the water to the proposed retention pond. The pond will be graded to accommodate the 100-year 10-day excess runoff volume, with some portion of the impervious site area used as storage for the event. A dry well will also be constructed to aid in percolation of the pond and water quality.

Fortuna Pond - Proposed Staging

Stage	Area	Storage	Cumulative Storage	Cumulative Storage			
Elev. (ft)	Ft ²	Ft ³	Ft ³	Ac-ft			
5114	8013	0.000	0				
5115	9603	8807.985	8808				
5116	11223	10412.745	19221				
5117	12876	12049.165	31270				
5118	14561	13718.130	44988				
5119	16280	15420.100	60408				
5120	37672	26975.820	87384				
5121	25225	31448.690	118833	2.7280			

MS4 Calculations

Basin	Area	Volume	Volume
	Ft ²	ft^3	Ac-ft
101	333752.0669	11681.32	0.27
		Total	0.27

P TOWNE CROSSING

MAPS

LOCATION MAP



FLOOD INSURANCEMAP REFERENCE: PANEL NO. 35001C0326J AND 35001C0328J



SOILS MAP REFERENCE: NRCS SOILS DATA


Evieting Conditions

existing	Condition	15															
	Total	Total		Α	E	3		3)	Peak	Excess Precip.	Volume Volum	Volume	Volume		
Basin	Basin	Area (sq ft)	Area (sq ft)	Area (Ac)	%	Ac	%	Ac	%	Ac	%	Ac	Discharge, Q	(Weighted)	(6 _{hr} , acre-ft)	(24 _{hr} , acre-ft)	(10 _{day} , acre-ft)
101	333752.07	7.662	0	0	15.3	1.17	75.3	5.77	9.4	0.72	22.1	1.04	0.6626	0.6818	0.7664		

Proposed Conditions

Basin	Total	Total		A		3		C)	Peak	Excess Precip.	Volume	Volume	Volume
	Area (sq ft)	Area	%	Ac	%	Ac	%	Ac	%	Ac	Discharge, Q	(Weighted)	(6 _{hr} , acre-ft)	(24 _{hr} , acre-ft)	(10 _{day} , acre-ft)
101	333752.07	7.662	0	0.00	0	0.00	11%	0.85	89%	6.82	30.5	2.10	1.3394	1.5212	2.3221



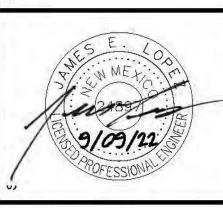

VAREHOUSE DEVELOPMENT NA RD, NW NEW OFFIC FOR BRUNAC 7500 FOR ALBUQUEF

PROJECT NO: 22-600-285-0 DESIGNED BY:


DRAWN BY: CHECKED BY: SEPTEMBER 2022


SHEET TITLE


OVERALL GRADING & DRAINAGE PLAN

SHEET NO:

C-102

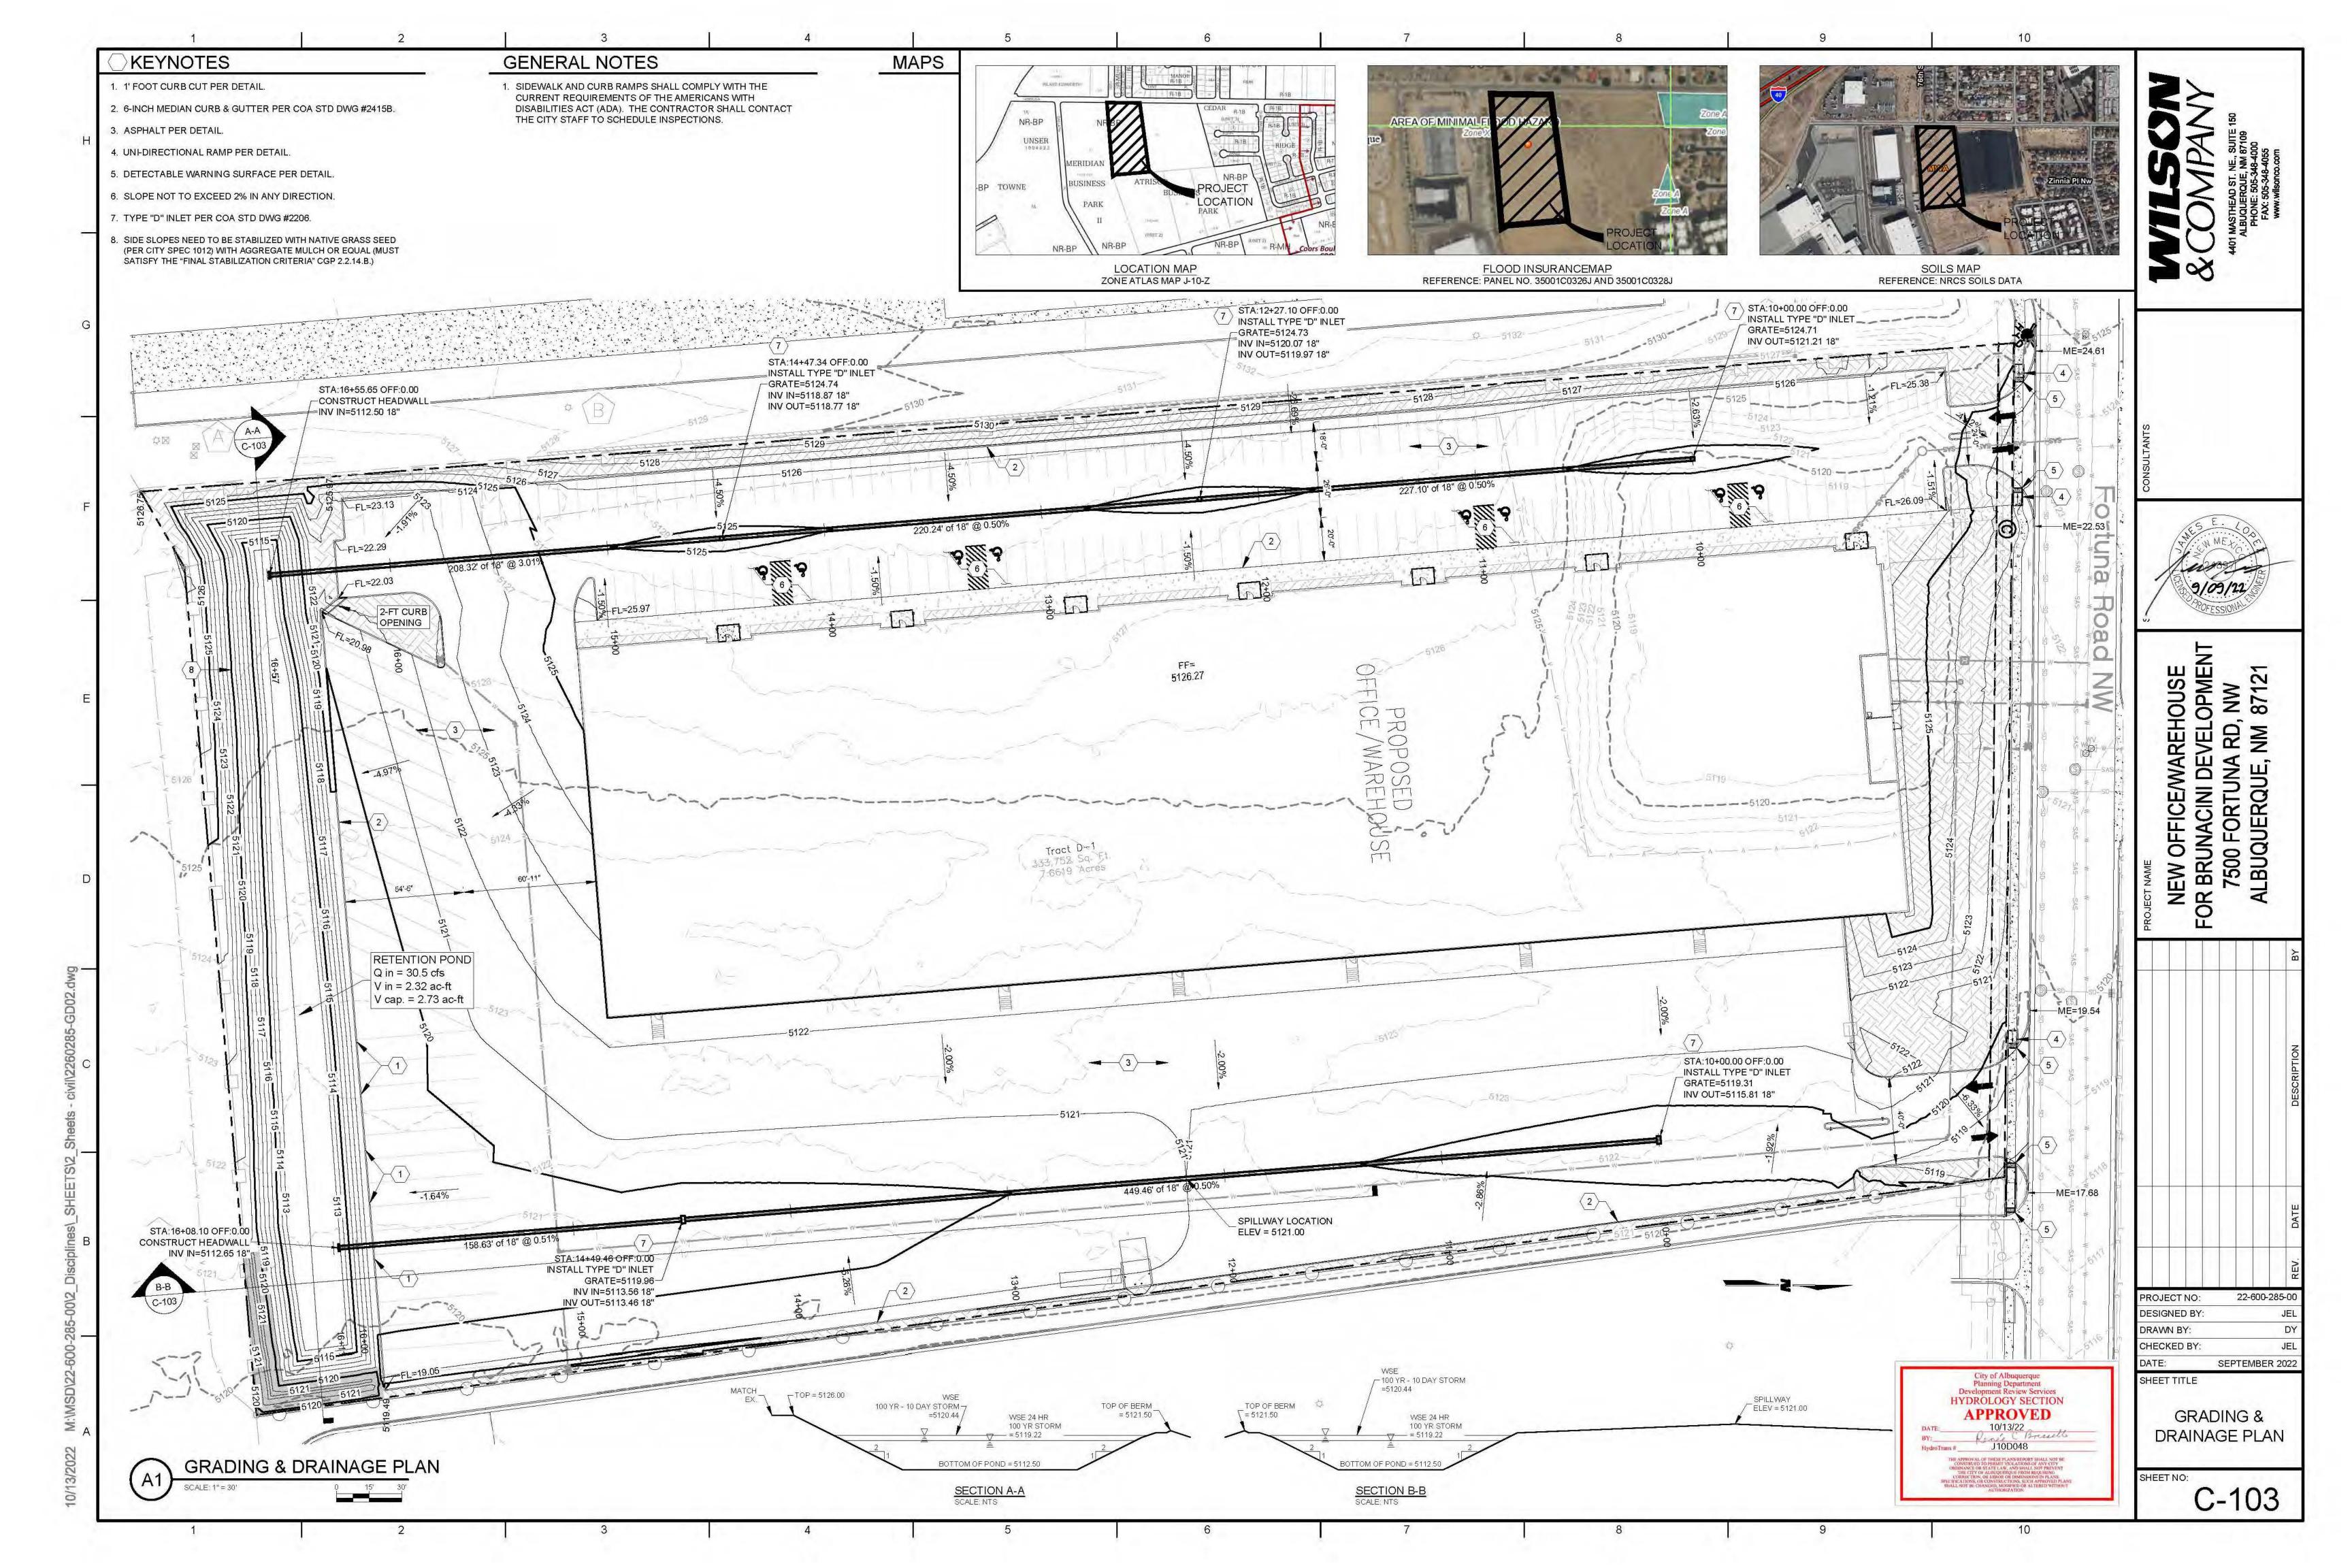

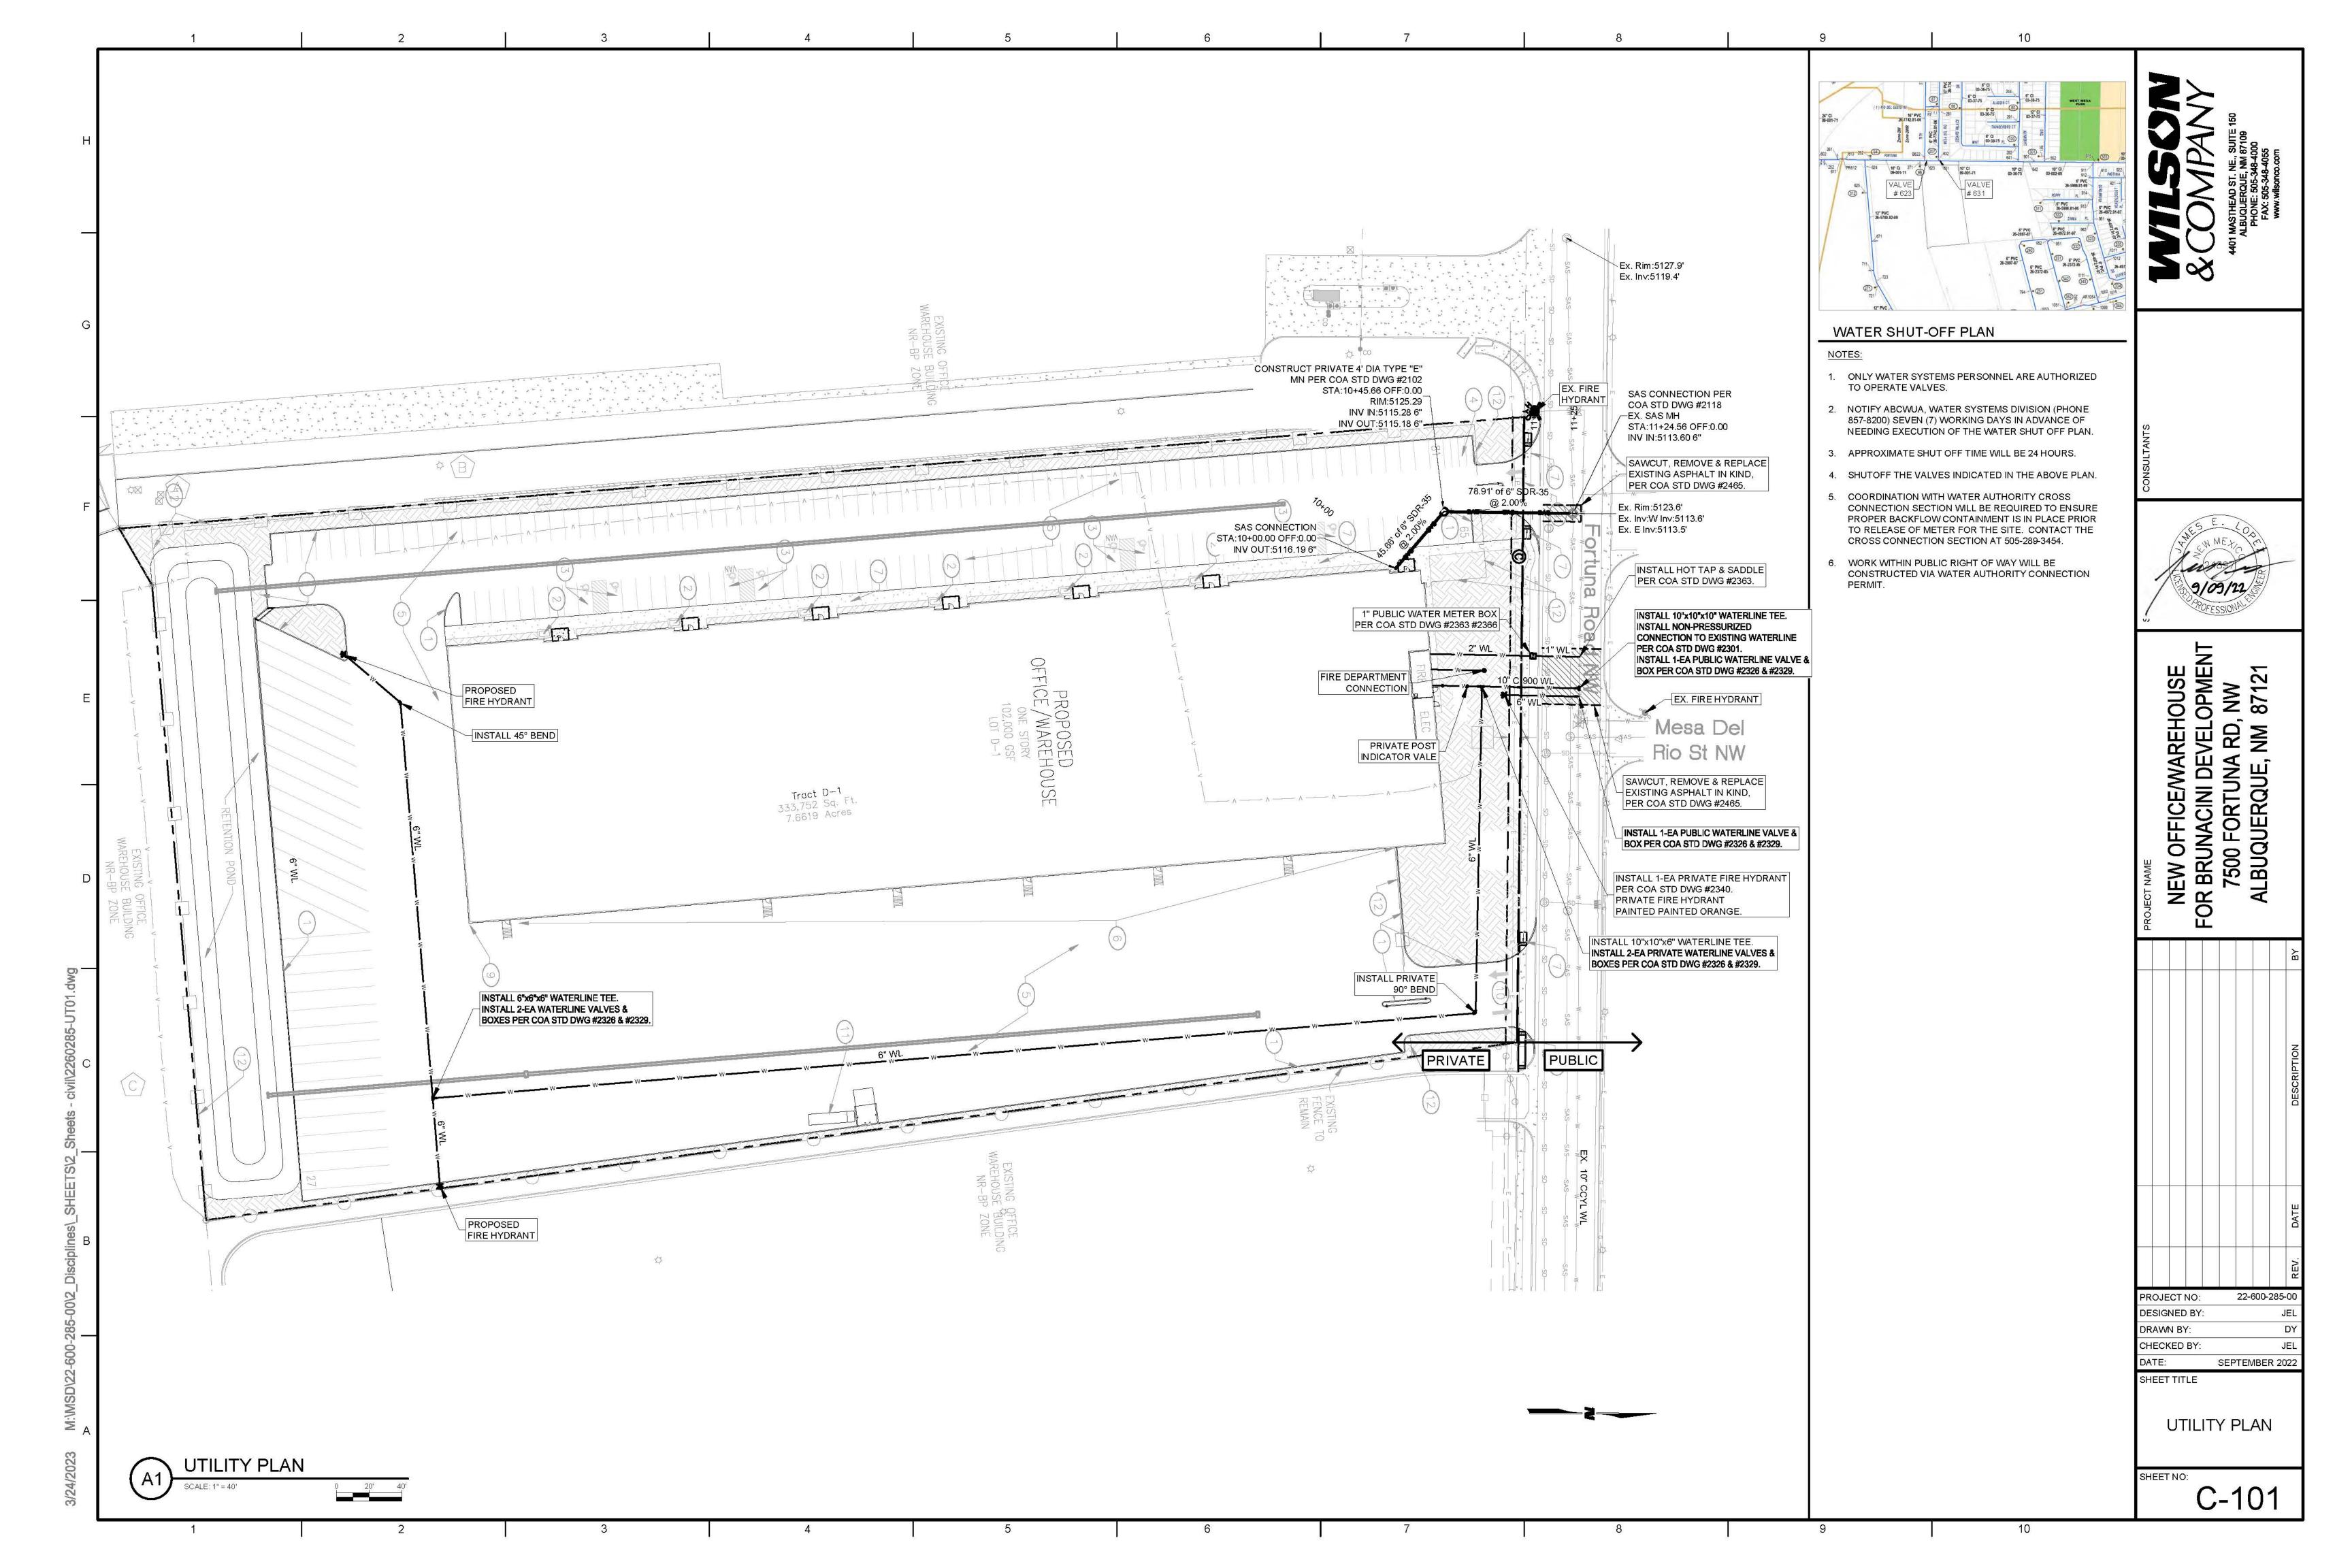

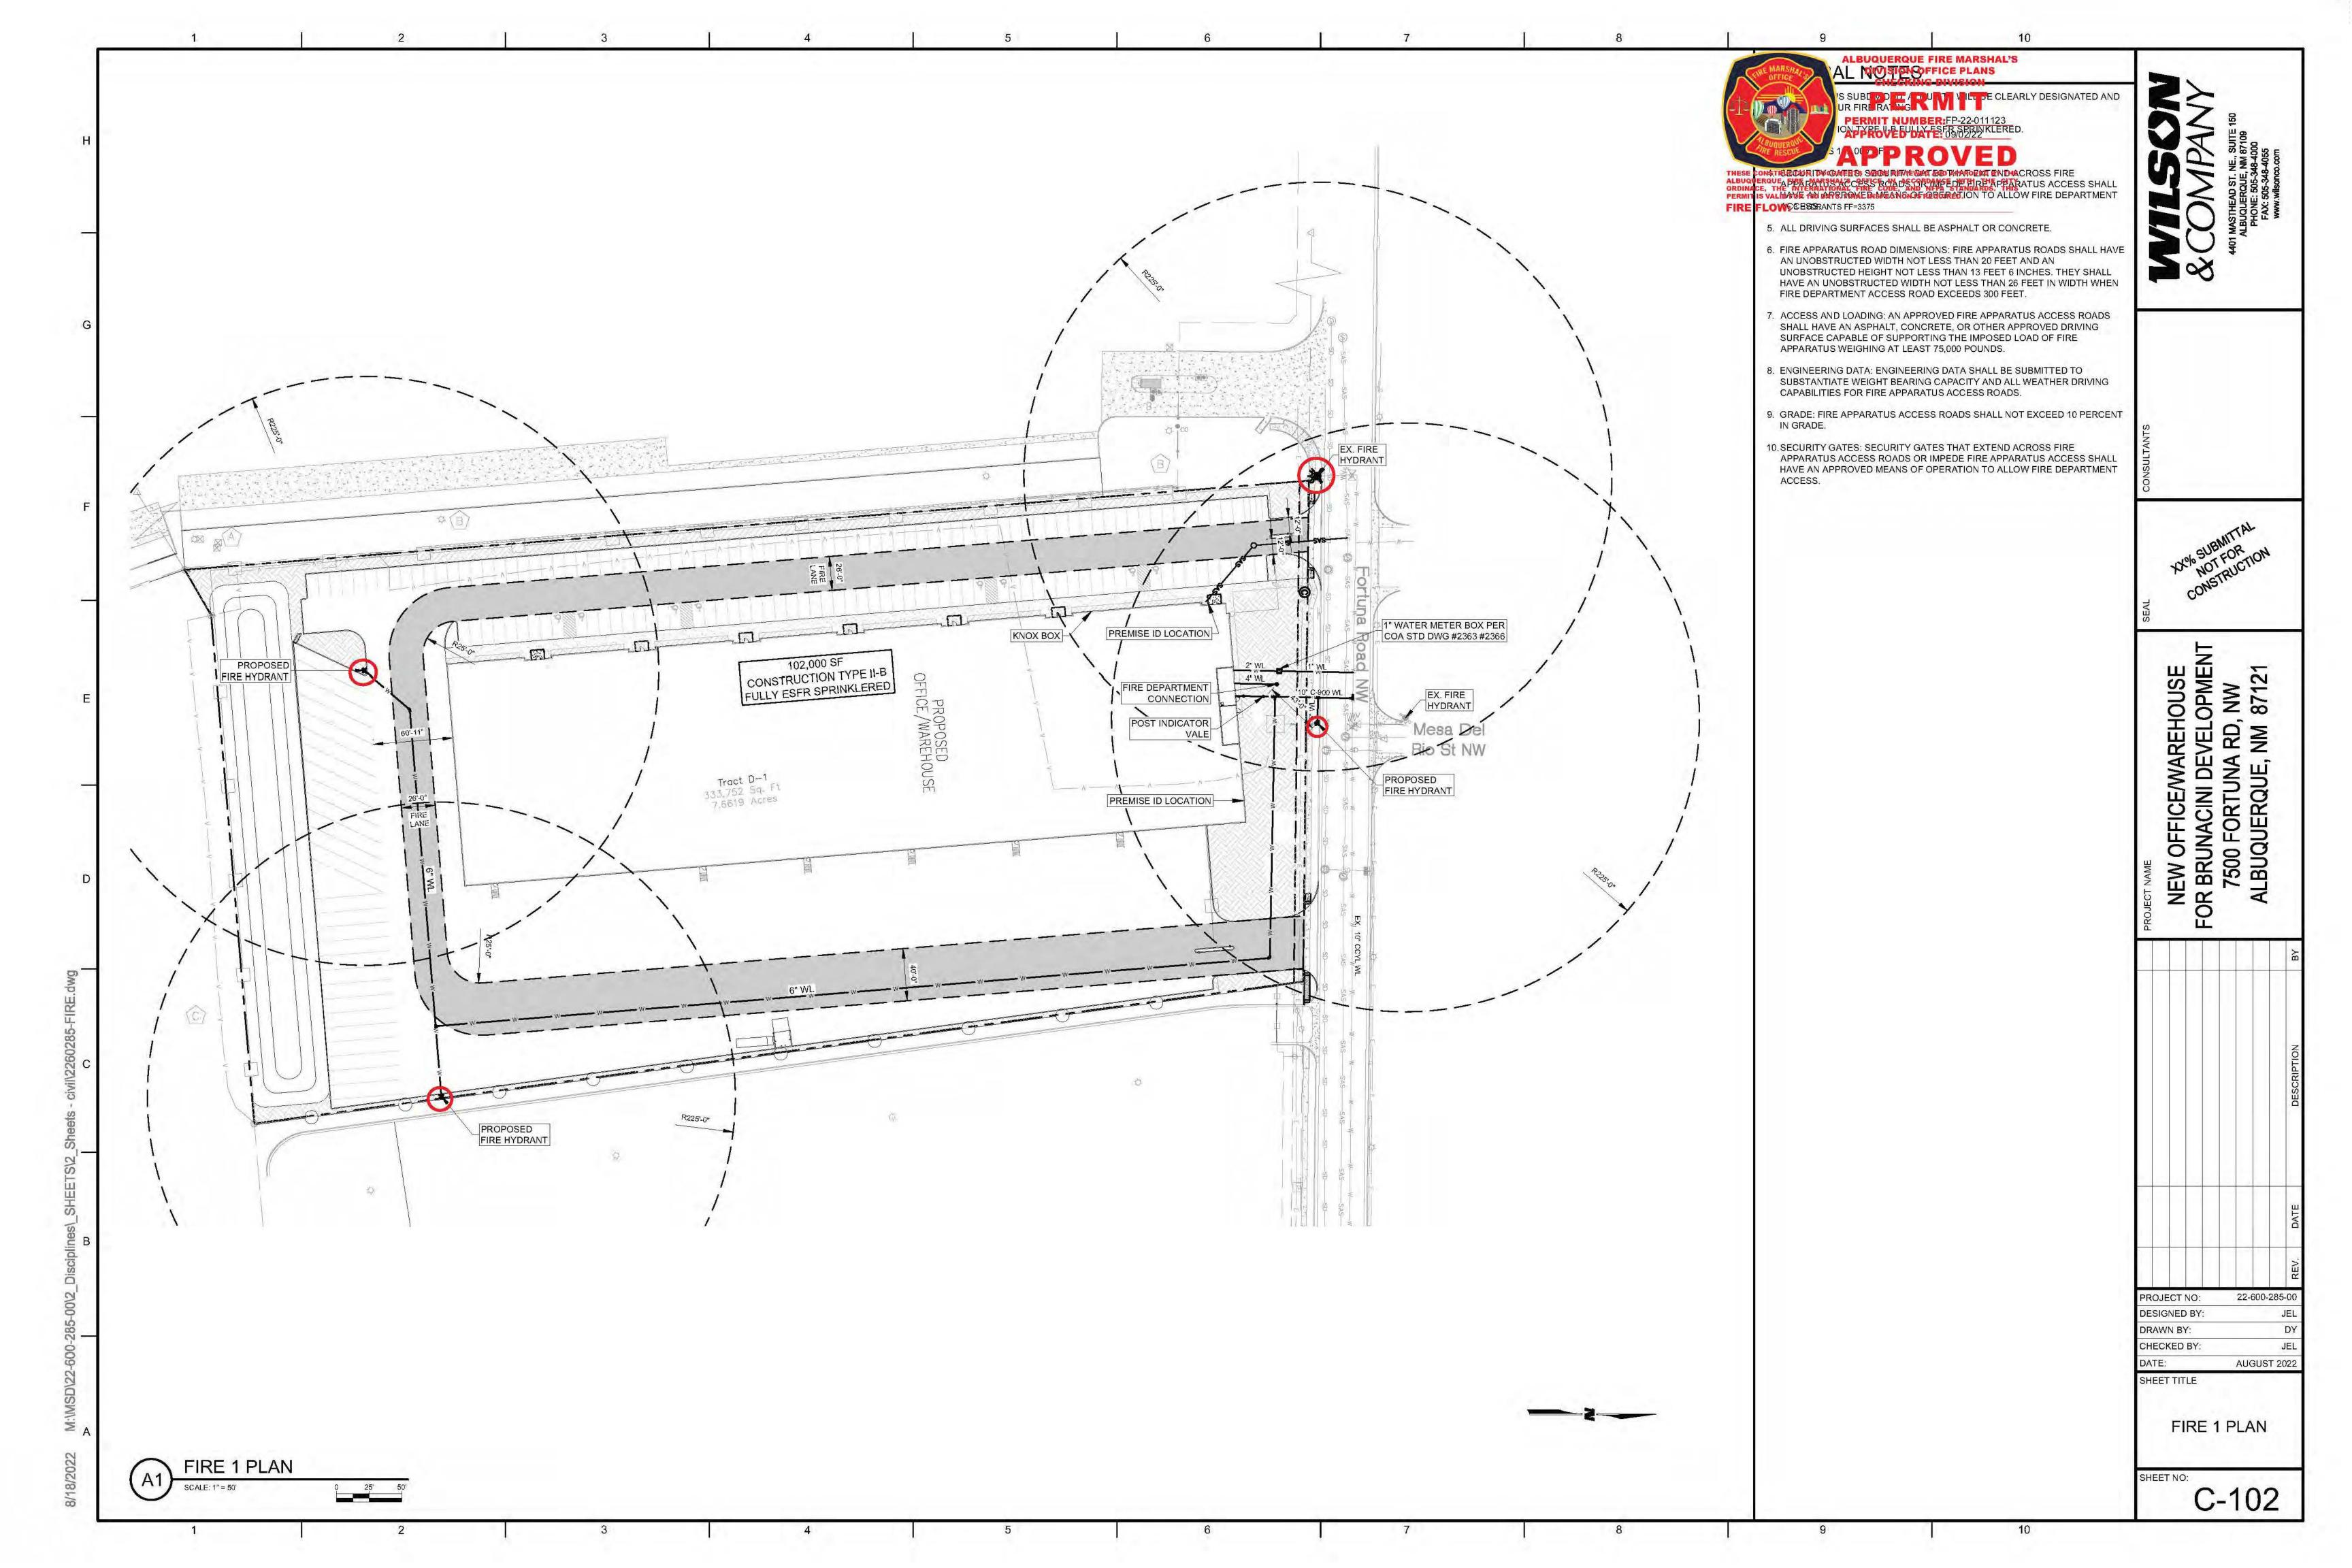

PR-2020-004538_SI-2022-02197_Site_Plan_Ap proved_12-14-22

Interim Agreement Report

2023-03-25

Created: 2023-03-13

By: Jay Rodenbeck (jrodenbeck@cabq.gov)

Status: Out for Signature

Transaction ID: ĈBJČHBČAABAApUneam5B5NtkCyoLUzBsom_g4el0T_QF

Agreement History

Agreement history is the list of the events that have impacted the status of the agreement prior to the final signature, A final audit report will be generated when the agreement is complete.

"PR-2020-004538_SI-2022-02197_Site_Plan_Approved_12-14-2 2" History

- Document created by Jay Rodenbeck (jrodenbeck@cabq.gov)
 2023-03-13 1:30:12 PM GMT-IP address: 73.242,135,213
- Document emailed to Jolene Wolfley (jwolfley@cabq.gov) for signature 2023-03-13 1:35:27 PM GMT
- Document emailed to Ernest Armijo (earmijo@cabq.gov) for signature 2023-03-13 1:35:27 PM GMT
- Document emailed to Tiequan Chen (tchen@cabq.gov) for signature 2023-03-13 1;35:28 PM GMT
- Document emailed to David Gutierrez (dggutierrez@abcwua.org) for signature 2023-03-13 1:35:28 PM GMT
- Document emailed to Jeff Palmer (jppalmer@cabq.gov) for signature 2023-03-13 1:35:28 PM GMT
- Document emailed to Cheryl Somerfeldt (csomerfeldt@cabq.gov) for signature 2023-03-13 1:35:28 PM GMT
- Email viewed by Ernest Armijo (earmijo@cabq.gov)
 2023-03-13 1:41:43 PM GMT-IP address: 143.120.132.81

Signature Date: 2023-03-13 - 1:42:07 PM GMT - Time Source: server- IP address: 143.120.132.81

Email viewed by Tiequan Chen (tchen@cabq.gov)

2023-03-13 - 1:51:51 PM GMT-IP address: 143.120.132.88

Language Document e-signed by Tiequan Chen (tchen@cabq.gov)

Signature Date: 2023-03-13 - 1:52:07 PM GMT - Time Source: server- IP address: 143.120.132.88

Email viewed by Jeff Palmer (jppalmer@cabq.gov)

2023-03-13 - 2:20:06 PM GMT-IP address: 143,120,136,68

Document e-signed by Jeff Palmer (jppalmer@cabq.gov)

Signature Date; 2023-03-13 - 2:20:35 PM GMT - Time Source; server- IP address: 143.120.136.68

Email viewed by Cheryl Somerfeldt (csomerfeldt@cabq.gov)

2023-03-13 - 10:17:59 PM GMT- IP address: 143.120.170,57

Document e-signed by Cheryl Somerfeldt (csomerfeldt@cabq.gov)

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Email viewed by David Gutierrez (dggutierrez@abcwua.org)

2023-03-15 - 2:21:01 PM GMT - IP address: 142,202,67.2

Email viewed by David Gutierrez (dggutierrez@abcwua.org)

2023-03-16 - 3:20:06 PM GMT-IP address: 142.202.67.2

mail viewed by Jolene Wolfley (jwolfley@cabq.gov)

2023-03-22 - 2:01:41 PM GMT-IP address: 143.120.133.169

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🛝 Document e-signed by David Gutierrez (dggutierrez@abcwua.org)

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PR-2020-004538_SI-2022-02197_Site_Plan_Approved_12-14-22

Final Audit Report 2023-03-27

Created: 2023-03-25

By: Jay Rodenbeck (jrodenbeck@cabq.gov)

Status: Signed

Transaction ID: CBJCHBCAABAAa1vzdQYg9tikxC12x38zLPD8pziU3UmT

"PR-2020-004538_SI-2022-02197_Site_Plan_Approved_12-14-2 2" History

Document created by Jay Rodenbeck (jrodenbeck@cabq.gov)

2023-03-25 - 1:58:58 AM GMT-IP address: 73.242.135.213

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2023-03-25 - 2:00:46 AM GMT

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2023-03-27 - 2:50:59 PM GMT-IP address: 75.161.225.16

Document e-signed by Jolene Wolfley (jwolfley@cabq.gov)

Signature Date: 2023-03-27 - 11:06:27 PM GMT - Time Source: server- IP address: 75.161.225.16

Agreement completed.

2023-03-27 - 11:06:27 PM GMT

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