SOLID WASTE NOTES:

TRASH ENCLOSURE.

THE DEVELOPMENT HAS NO GATES

THE SLOPE LEADING TO THE TRASH ENCLOSURE/DUMPSTER SHALL BE NO GREATER THAN 1/8" PER FOOT ON THE APPROACH.

THERE IS FOOD SERVICE FOR THIS PROJECT. ALL REFUSE ENCLOSURES SHALL

RECYCLING CONTAINERS LOCATED ADJACENT TO THE REFUSE ENCLOSURE, SEE


KEYED NOTE. THE REFUSE DRIVER SHALL HAVE ACCESS TO TRASH ENCLOSURE/DUMPSTER BY

THERE ARE NO OVERHANGING WIRES LEADING TO AND EXITING FROM THE


THIS PROJECT WILL NOT ALTER EXISTING TRASH SERVICE FOR THE SURROUNDING BUSINESSES DURING CONSTRUCTION.

OWNER SHALL PURCHASE 8 CY REFUSE CONTAINER.

HAVE GREASE DRAINS AND GREASE INTERCEPTORS

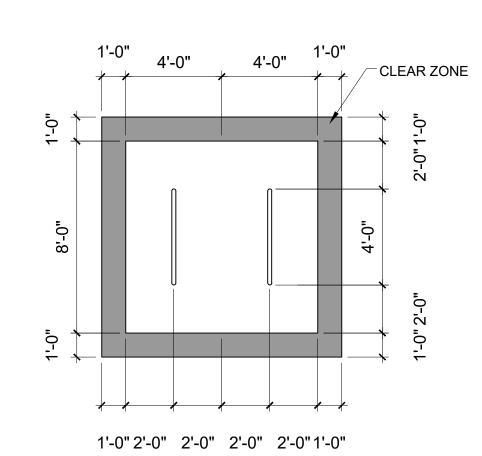

BIKE PARKING

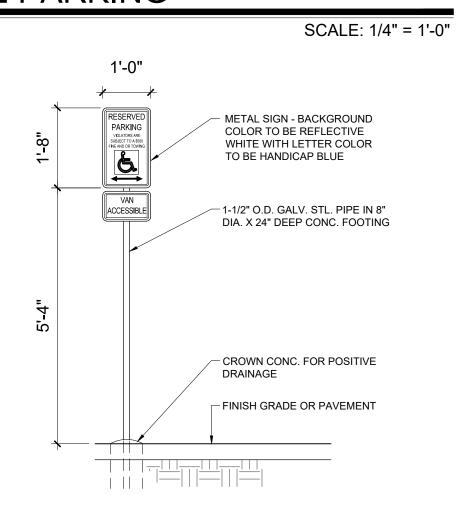

HC SIGN

1'-2" METAL SIGN - BACKGROUND COLOR TO BE REFLECTIVE WHITE WITH LETTER COLOR TO BE RED QUO 1-1/2" O.D. GALV. STL. PIPE IN 8" CROWN CONC. FOR POSITIVE FINISH GRADE OR PAVEMENT

MOTORCYCLE SIGN

SCALE: 1/2" = 1'-0"

SCALE: NTS

UPC: 101006305745520820 LEGAL: LOT 001 BLOCK 8 VOLCANO CLIFFS SUBDIVISION ZONING: MX-L ZONE ATLAS PAGE: D-10

GROSS LOT AREA = 6.5656 AC = 285,999.06 SF

BUILDING FOOTPRINT = 31,561 SF NET LOT AREA = 30 SF

REQUIRED LANDSCAPE AREA @ 15% = 29,023 SF; 74,520 SF PROVIDED

PARKING:

BUILDING 1: 10,000 SF X 3.5 SPACES = 35 SPACES BUILDING 2: 11,680 X 3.5 SPACE = 41 SPACES

TOTAL SPACES REQUIRED = 76 SPACES TOTAL SPACES PROVIDED = 107 SPACES

HC REQUIRED: 4 STANDARD, 3 VAN MOTORCYCLE PARKING 151-300 SPACES: 5 SPACES REQUIRED / 6 PROVIDED

BIKE PARKING 10% OF 246: 25 REQUIRED, 32 SPACES PROVIDED

ALL IMPROVEMENTS LOCATED IN THE RIGHT OF WAY MUST BE INCLUDED IN ON A PUBLIC WORK ORDER.

LANDSCAPING, FENCING AND SIGNING WILL NOT INTERFERE WITH CLEAR SIGHT REQUIREMENTS. THEREFORE, SIGNS, WALLS, TREES AND SHRUBBERY BETWEEN 3 AND 8 FEET TALL (AS MEASURED FROM THE GUTTER PAN) WILL NOT BE ACCEPTABLE IN THE CLEAR SIGHT TRIANGLE.

ALL PAVING SHALL BE SHALL BE ASPHALT UNLESS NOTED OTHERWISE, REF. DETAIL THIS SHEET.

ALL MECHANICAL EQUIPMENT SHALL BE SCREENED IN ACCORDANCE WITH IDO SECTION 5-5 (G).

ALL OUTDOOR LIGHT FIXTURES SHALL BE LED. FIXTURES 70 WATTS OR GREATER SHALL BE SHIELDED USING FULL CUTOFF LIGHT FIXTURES.


BUILDING MOUNTED SIGNS SHALL BE EXTERNALLY ILLUMINATED AND SHALL NOT EXTEND MORE THAN 2 FEET ABOVE THE EXTERIOR WALLS OF THE BUILDING.

WORK WITHIN THE PUBLIC RIGHT OF WAY REQUIRES A WORK ORDER.

MC" SHALL BE PAINTED ON THE PAVEMENT OF EACH MOTORCYCLE PARKING SPACE


DRIVE THROUGH USES SHALL BE LIMITED TO THOSE PERMISSIBLE IN THE IDO

ALL DRIVE-THROUGHS SHALL CONFORM WITH THE IDO STANDARDS & REQUIREMENTS.

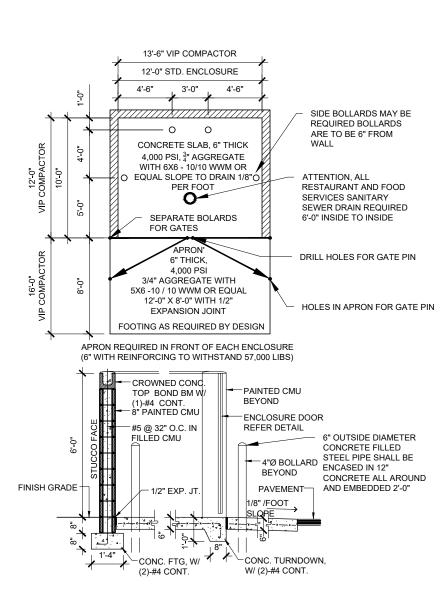

REFUSE ENCLOSURE

SCALE: 1/8" = 1'-0"

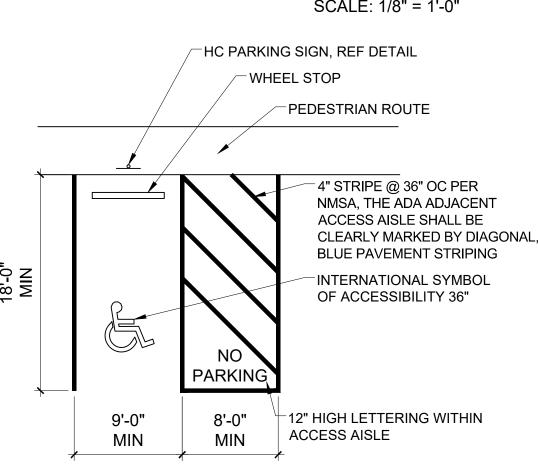

ADA PARKING

SCALE: $\frac{1}{8}$ " = 1'-0"

DO NOT ENTER SIGN SCALE: 1/2" = 1'-0"

P. Patoungar Car

36.89'

SITE PLAN

METAL SIGN

-1 ½" O.D. GALV.

FOOTING

POSITIVE

DRAINAGE

PAVEMENT

STEEL PIPE IN 8" Ø

CROWN CONC. FOR

FINISH GRADE OR

X 24" DEEP CONC.

51.86'

Š

N

S S S

#3 REBAR @ 18" OCBW IN CENTER OF SLAB USE 3 1 CHAIRS @ 48" OCBW - 6" AGGREGATE BASE COURSE - 6" FLEX BASE, COMPACTED TO 95% PER TEX 113-E, IF SOILS REPORT HAS PVR OF GREATER THAN 3 INCHES

3,000 PSI CONCRETE W/

499.91'

499.15'

ROSA PARKS RD NW

ROSA PARKS RD. NW 19

64' ROW (29)

BUILDING 1

48.87'

27.96'

10,275 SF

217.04'

BUILDING 2

11,680 SF

259.46'

PAVING SECTION

SCALE: NTS

PROJECT NUMBER: PR-2020-004596

Application Number: SI-2024-00390 Is an Infrastructure List required? () Yes () No If yes, then a set of approved DRC plans with a work order is required for any construction within Public Right-of-Way or for construction of public

28.49' 16.41'11.32'

Planning Department

DFT SITE DEVELOPMENT PLAN APPROVAL:	
Ernest armyo	08/05/24
Traffic Engineering, Transportation Division	Date
Die Guil	08/22/24
ABCWUA	Date
Whitney Phelan	08/05/24
Parks and Recreation Department	Date
Tiegre Cha	08/05/24
Hydrology	Date
Jeff Palace	08/05/24
Code Enforcement	Date
Environmental Health Department (conditional)	Date
Date Solid Waste Management	 Date

08/26/24

Date

KEYED NOTES

LEGEND

BUILDING

: [✓] CONCRETE

ASPHALT PAVING

CLEAR SIGHT TRIANGLE

LANDSCAPE

- 1. 8 SPACE BIKE RACK, REF DETAIL THIS SHEET
- MOTORCYCLE PARKING SIGN REF DETAIL THIS SHEET H.C. PARKING SIGN, REF DETAIL ON THIS SHEET
- 4. NEW FIRE HYDRANT
- IRRIGATION BOX NEW 6' SIDEWALK, 2% MAX CROSS SLOPE, 1.5% PREFERRED CROSS SLOPE,
- REFERENCE CITY OF ALBUQUERQUE STANDARD DETAIL 2430 GREASE CONTAINER ENCLOSURE SIM TO DETAIL THIS SHEET
- PARALLEL CURB RAMP, REF DETAIL A, COA STANDARD DETAIL 2443 9. PERPENDICULAR CURB RAMP, REF DETAIL COA STANDARD DETAIL 2447 10. PROPERTY LINE
- 11. EXISTING POWER POLE 12. MONUMENT SIGN
- 13. CLEAR SIGHT TRIANGLE. LANDSCAPING, FENCING AND SIGNING WILL NOT INTERFERE WITH CLEAR SIGHT REQUIREMENTS. THEREFORE, SIGNS, WALLS, TREES AND SHRUBBERY BETWEEN 3 AND 8 FT TALL (AS MEASURED FROM THE GUTTER PAN) WILL NOT BE ACCEPTABLE IN THE CLEAR SIGHT TRIANGLE
- 14. CORNER ACCESS RAMP, REF COA STANDARD DETAIL 2441
- 15. 6' WROUGHT IRON FENCE
- 16. REFUSE CONTAINER, REF DETAIL THIS SHEET 17. RECYCLING CONTAINER, REF DETAIL THIS SHEET
- 18. FIRE DEPARTMENT CONNECTION
- 19. PARALLEL RAMP AT DRIVE REF. COA STANDARD DETAIL 2426 20. CURB AND GUTTER REF. COA STANDARD DETAIL 2415B

29. VEGETATIVE DRIVE THROUGH SCREENING, REF LANDSCAPE SHEET


- 21. EXISTING POWER POLE 22. GREASE WASTE ENCLOSURE
- 23. 10' PUBLIC UTILITY EASEMENT

- 24. DO NOT ENTER SIGN, REF DETAIL THIS SHEET
- 25. "ONE WAY" SIGN
- 27. MENU BOARD

28. ORDER WINDOW

26. PREVIEW BOARD

ALL IMPROVEMENTS LOCATED IN THE RIGHT OF WALL

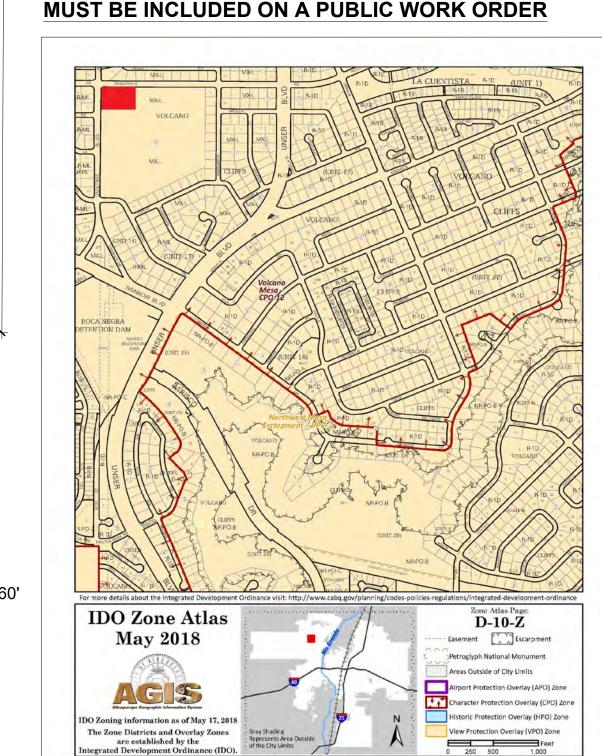

AREA MAP



UNIVERSE VIEW STRIP CENTER

UNIVERSE BLVD NW ALBUQUERQUE, NM 87114


DRAWING TITLE

SITE PLAN

NO. 4341 6/6/2024


A-100 6/6/2024

SCALE:NTS

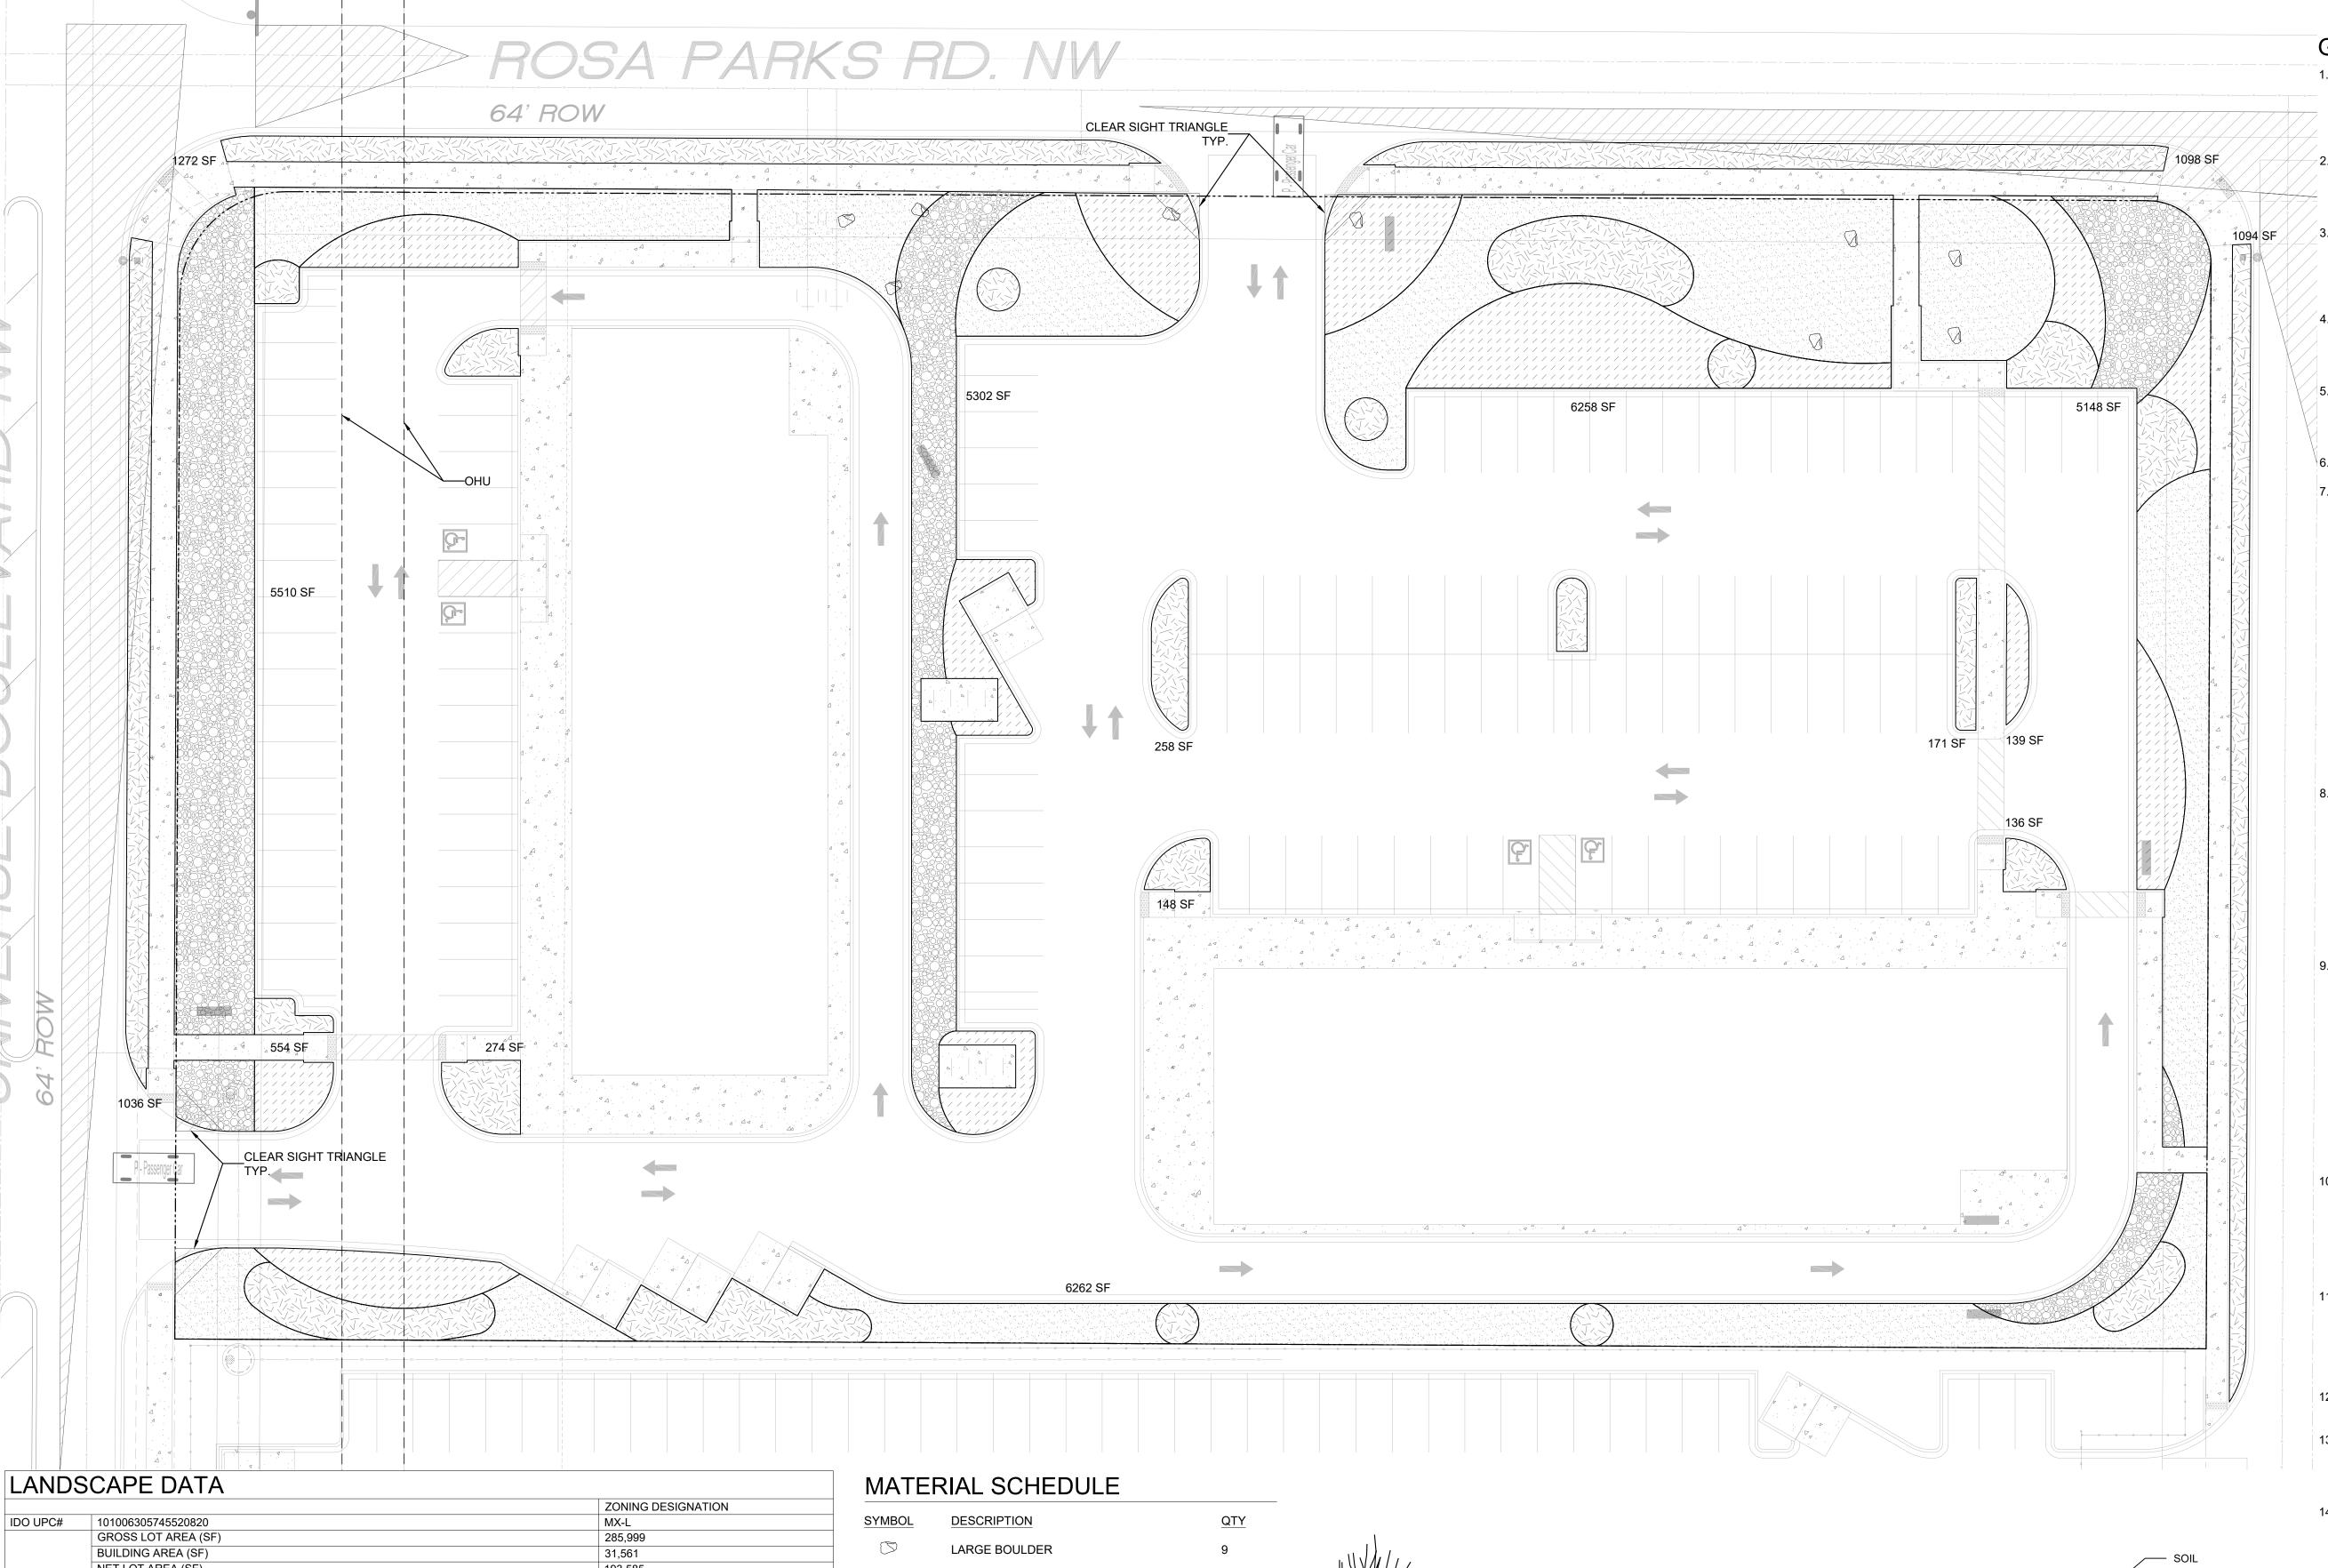

NET LOT AREA (SF) 193,585 MINIMUM LANDSCAPE REQUIRED PROVIDED AREA (SF) - MINIMUM 15 % OF NET LOT AREA* 29,038 35,454 18% TOTAL VEGETATIVE COVERAGE (SF) @ PLANT MATURITY (75% OF LANDSCAPE AREA) 21,778 30,840 106% VEGETATIVE COVERAGE (SF) OF GROUND-LEVEL PLANTS (25% OF TOTAL, MINIMUM) 5,445 5,625 26% * PER IDO 14-16-5-6(C)(2)(b). IN DT-UC-MS-PT AREAS. MINIMUM IS 10% OF NET LOT AREA * FOR MULTI-FAMILY DWELLING, MINIMUM IS 25% OF NET LOT AREA. SEE 14-16-4-3(B)(8) FOR DETAILS PLANTING AREA MULCH REQUIRED PROVIDED GRAVEL OR CRUSHER FINES (SF) 26,548 MAX. 75% 75% * PER IDO 14-15-5-6(C)(5) The use of gravel or crusher fines as ground cover is limited to a maximum 50 percent in DT-UC-MS areas. **PROVIDED** STREET TREES - 1 PER 25 LF REQUIRED STREET FRONTAGE (LF) 885 * PER IDO 14-15-5-6(D)(1)(a) TREES THAT ARE PLANTED WITHIN 20 FEET OF THE BACK OF CURB OF THE ABUTTING STREET MAY FULFILL THIS REQUIREMENT PARKING LOT INTERIOR REQUIRED **PROVIDED** PARKING STALLS PARKING LOT AREA (SF) 38,049 LANDSCAPED AREA (10% OF PARKING LOT AREA)* 28,753 TREES (1 PER 10 PARKING SPACES) PER IDO 14-16-5-6(F)(2), FOR PARKING LOTS CONTAINING 50 OR FEWER SPACES, MINIMUM IS 10% OF PARKING LOT AREA. **TOTALS** REQUIRED PROVIDED ** PER IDO 14-16-5-6(C)(3)(a), IF AREAS REQUIRED TO BE LANDSCAPED BY 2 OR MORE PROVISIONS OF THIS SECTION 14-16-5-6 OVERLAP EACH OTHER, THE PROVISION REQUIRING THE GREATER AMOUNT OF LANDSCAPING SHALL APPLY, AND LANDSCAPING PROVIDED THAT MEETS THE GREATER REQUIREMENT SHALL COUNT TOWARD FULFILLING THE OVERLAPPING REQUIREMENTS.

YMBOL	DESCRIPTION	<u>C</u>
	LARGE BOULDER	ç
YMBOL	DESCRIPTION	
	MOUNTAINAIR SUNRISE GOLD 1" GRAVEL 3" DEPTH OVER FILTER FABRIC	
	MOUNTAINAIR BLUSH 1" GRAVEL 3" DEPTH OVER FILTER FABRIC	
	NATIVE MULCH SHREDDED WOOD MULCH 3" DEPTH NOT OVER FILTER FABRIC	
	BLUE SAIS 2-4" ANGULAR COBBLE 4" DEPTH OVER FILTER FABRIC	

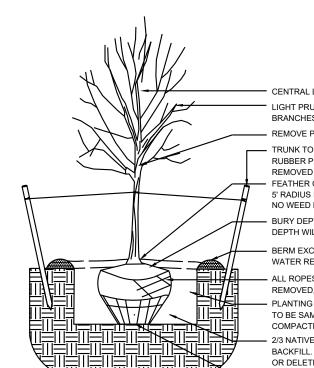

 CENTRAL LEADER (IF EXISTING) TO BE LEFT UNPRUNED LIGHT PRUNING IF NEEDED. RUBBING, CROSSED OR DAMAGED REMOVE PLANT IDENTIFICATION TAGS BEFORE JOB IS COMPLETE - TRUNK TO BE STAKED WITH (2) WOODEN TREE STAKES WITH RUBBER PROTECTION AT TRUNK. STAKES AND TIES TO BE REMOVED AFTER ONE YEAR FEATHER ORGANIC MULCH TO A 2" DEPTH OVER PLANT ROOTBALL, 5' RADIUS FROM TRUNK, KEEP MULCH 2" AWAY FROM TRUNK. NO WEED BARRIER OVER ROOTBALL - BURY DEPTH OF TREE IS AT ROOT FLARE AND HOLE DEPTH WILL BE ADJUSTED ACCORDING TO ROOTBALL HEIGHT BERM EXCAVATED SOIL AROUND EDGE OF PLANTING PIT TO AID IN WATER RETENTION OVER ROOTBALL ALL ROPES REMOVED, TOP HALF OF BURLAP AND WIRE BASKET REMOVED, BURLAP SLIT FOR ROOT EXTENSION - PLANTING PIT TO BE 2-3 TIMES WIDTH OF ROOT BALL, DEPTH OF PIT TO BE SAME AS ROOT BALL HEIGHT. SIDES OF PIT NOT TO BE OVERLY COMPACTED TO ALLOW ROOT GROWTH BEYOND PLANTING PIT 2/3 NATIVE SOIL AND 1/3 COMPOSTED SOIL AMENDMENT TO BE USED AS BACKFILL, AMENDMENT TO BE WELL COMPOSTED AND FREE OF DEBRIS

OR DELETERIOUS MATERIALS. UNDISTURBED PIT BOTTOM FOR ROOTBALL BASE

TREE PLANTING DETAIL



5' RADIUS

AROUND TRUNK

GENERAL NOTES

- 1. IN CASE OF DISCREPANCIES IN PLANT QUANTITIES SHOWN ON THE PLANT SCHEDULE AND THOSE SHOWN ON THE PLAN. THE QUANTITIES SHOWN ON THE PLAN SHALL PREVAIL. CONTRACTOR SHALL VERIFY ALL QUANTITIES PRIOR TO BID AND
- INSTALLATION. 2. POSITIVE DRAINAGE AWAY FROM ALL STRUCTUF SHALL BE PROVIDED TO THE LANDSCAPE CONTRACTOR AND SHALL BE MAINTAINED BY THE LANDSCAPE CONTRACTOR THROUGHOUT THE
- DURATION OF THE PROJECT. GRADING OF THE SITE PER THE GRADING PLAN IS NOT INCLUDED IN THE SCOPE OF WORK OF THE LANDSCAPE CONTRACTOR. GRADES PER THE GRADING PLAN SHALL BE PROVIDED TO THE LANDSCAPE CONTRACTOR +/- 1/10TH OF A FOOT, B
- 4. ALL MAINTENANCE OF THE LANDSCAPE AND IRRIGATION SYSTEMS SHALL BE PROVIDED BY OWNER. NO CONTRACTUAL MAINTENANCE SHALL BE INCLUDED UNLESS OTHERWISE SPECIFIED IN THE BIDDING DOCUMENTS. 5. WATER MANAGEMENT IS THE SOLE RESPONSIBILIT
- OF THE PROPERTY OWNER. THE LANDSCAPE ARCHITECT IS NOT RESPONSIBLE FOR ANY RESTRICTIONS OF IRRIGATION WATER USE BY ANY GOVERNING BODY.
- 6. PER 5-6(C)(4)(a) A MINIMUM OF 5 SPECIES MUST BE USED IN THE LANDSCAPED AREA.
- 7. PER 5-6(C)(4)(b) ONLY TREES AND SHRUBS SELECTED FROM THE OFFICIAL ALBUQUERQUE PLANT PALETTE OF LOW WATER USE, DROUGHT TOLERANT, OR XERIC SPECIES AND SHOWN ON A LANDSCAPE PLAN CAN COUNT TOWARD THE REQUIREMENTS OF THIS SUBSECTION 14-16-5-6(C) (GENERAL LANDSCAPING STANDARDS), EXCEPT THAT, UPON PRESENTATION OF EVIDENCE, THE RELEVANT DECISION-MAKING BODY MAY AUTHORIZE ALTERNATIVE SPECIES OR CULTIVARS THAT MEET ALL OF THE FOLLOWING REQUIREMENTS:

1.MEET THE INTENDED PURPOSE OF THAT TYPE OF LANDSCAPING. 2.ARE NOT HAZARDOUS 3.ARE NOT IDENTIFIED AS INVASIVE ON A CITY OR

STATE PLANT LIST. 4.ARE NOT LISTED IN THE CITY'S WEED IDENTIFICATION HANDBOOK. 5.ARE EQUALLY HARDY TO THE NEW MEXICO CLIMATE.

PEDESTRIAN WALKWAYS ARE REQUIRED PURSUANT TO SUBSECTION 14-16-5-6(C)(4)(i) (REQUIRED PLANT MATERIALS AND SITE AMENITIES). 5-6(C)(4)(i) SHADE TREES PLANTED APPROXIMATELY 25 FEET ON-CENTER ARE REQUIRED ALONG ALL REQUIRED PEDESTRIAN WALKWAYS. IF THE WALKWAY IS LESS THAN FEET LONG, AT LEAST ONE TREE IS REQUIRED, OR, WHERE THERE IS INSUFFICIENT SPACE FOR A TREE, A TRELLIS OF AT LEAST 8 FEET

SHALL BE PROVIDED. 9. PER 5-6(F)(1)(i) 1 OF THE IDO, ANY PARKING LOT LOCATED WITHIN 30 FEET OF THE FRONT LOT LINE SHALL BE SCREENED FROM THE STREET EITHER BY A MASONRY WALL CONSTRUCTED OF A MATERIA SIMILAR IN TEXTURE, APPEARANCE, AND COLOR T THE STREET-FACING FAÇADE OF THE PRIMARY BUILDING (BUT EXCLUDING EXPOSED CMU BLOCK) AT LEAST 3 BUT NOT MORE THAN 4 FEET IN HEIGHT OR BY A LANDSCAPE BUFFER AT LEAST 10 FEET IN WIDTH WITH A CONTINUOUS LINE OF EVERGREEN SHRUBBERY 3 FEET IN HEIGHT, OR BY OTHER MEANS THAT THE PLANNING DIRECTOR DETERMINES PROVIDES EQUAL OR BETTER SCREENING OF THE HEADLIGHTS OF PARKED

10. PER 5-6(C)(9)(a), ALL PLANTING OF VEGETATED MATERIAL OR INSTALLATION OF ANY LANDSCAPING BUFFERING, OR SCREENING MATERIAL IN THE PUBLIC RIGHT-OF-WAY SHALL REQUIRE THE PRIOR APPROVAL OF THE CITY. THE PROPERTY OWNER SHALL BE RESPONSIBLE FOR THE MAINTENANCE, REPAIRS, OR LIABILITY FOR ALL THE LANDSCAPING PLACED IN OR OVER THE PUBLIC RIGHT-OF-WAY. PUBLIC SIDEWALK OR MAJOR PUBLIC OPEN SPACE SHALL BE TRIMMED TO MAINTAIN AN 8 FOOT CLEARANCE OVER THE SIDEWALK. ANY TREES THA OVERHANG A PUBLIC STREET SHALL BE TRIMMED TO MAINTAIN A 9' CLEARANCE OVER THE STREET

CLEARLY DELINEATED ON PLANS FOR LANDSCAPE

13. PURSUANT TO 5-6(C)(7)(a), ALL VEGETATION HAS BEEN LOCATED A MINIMUM OF 3' IN ANY DIRECTION FROM FIRE HYDRANTS, VALVE VAULTS, HOSE BIBS, MANHOLES, HYDRANTS AND FIRE DEPARTMENT CONNECTIONS.

WOULD ACHIEVE ITS INTENDED PURPOSE. PLANTED WITHIN 10' IN ANY DIRECTION OF THE CENTERLINE OF A SEWER OR WATER LINE.

SIGNAGE, WALLS, FENCES, TREES, AND SHRUBBERIES BETWEEN 3' AND 8' TALL (AS MEASURED FROM THE GUTTER PAN) ARE NOT ALLOWED WITHIN THE CLEAR SIGHT TRIANGLE 17. PER 5-6(C)(14)(a), IRRIGATION SYSTEMS SHALL

CONNECTION PREVENTION AND CONTROL ORDINANCE)


19. PER 5-6(C)(14)(c), ALL NON-RESIDENTIAL

LANDSCAPE IRRIGATION SHALL HAVE AUTOMATIC TIMERS AND/OR PROGRAMMABLE SETTINGS TO AVOID OVERWATERING.

20. PER 5-6(C)(14)(d), THE IRRIGATION SYSTEM SHALL NOT SPRAY OR IRRIGATE IMPERVIOUS SURFACES, INCLUDING SIDEWALKS, DRIVEWAYS, DRIVE AISLES



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Date: <u>04/08/2024</u> Revisions: 04/29/2024 05/02/2024

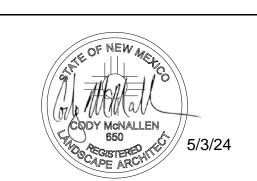Drawn by: PL

Reviewed by: <u>CM</u>

8. PER 5-3(D)(3)(a) 3, SHADE TREES ALONG REQUIRED HIGH FOR AT LEAST 5 FEET ALONG THE WALKWAY

11. PER 5-6(C)(9)(b), ANY TREES THAT OVERHANG A

SURFACE. 12. PURSUANT TO 5-6(C)(5)(e), BARK MULCH AREAS AREAS AND 5' RADIUS RINGS AROUND TREES.

14. PURSUANT TO 5-6(C)(10)(a), TREES AND SHRUBS SHALL NOT BE PLANTED IN UTILITY EASEMENTS UNLESS THERE IS NO OTHER PRACTICABLE LOCATION ON THE LOT WHERE THE LANDSCAPING

15. PURSUANT TO 5-6(C)(10)(b), TREES SHALL NOT B 16. CLEAR SIGHT TRIANGLE NOTE: LANDSCAPING,

2-3" ORGANIC MULCH

— GRAVEL OR OTHER

GROUND COVER


COMPLY WITH SECTION 8 OF THE ABCWUA LEGISLATION AND ORDINANCES (CROSS


18. PER 5-6(C)(14)(b), ALL IRRIGATION SYSTEMS SHALL

BE DESIGNED TO MINIMIZE THE USE OF WATER.

STREETS, AND PARKING AND LOADING AREAS.

0

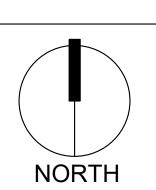


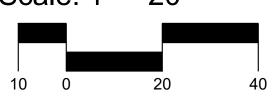

Sheet Title:

Material Plan

Sheet Number:

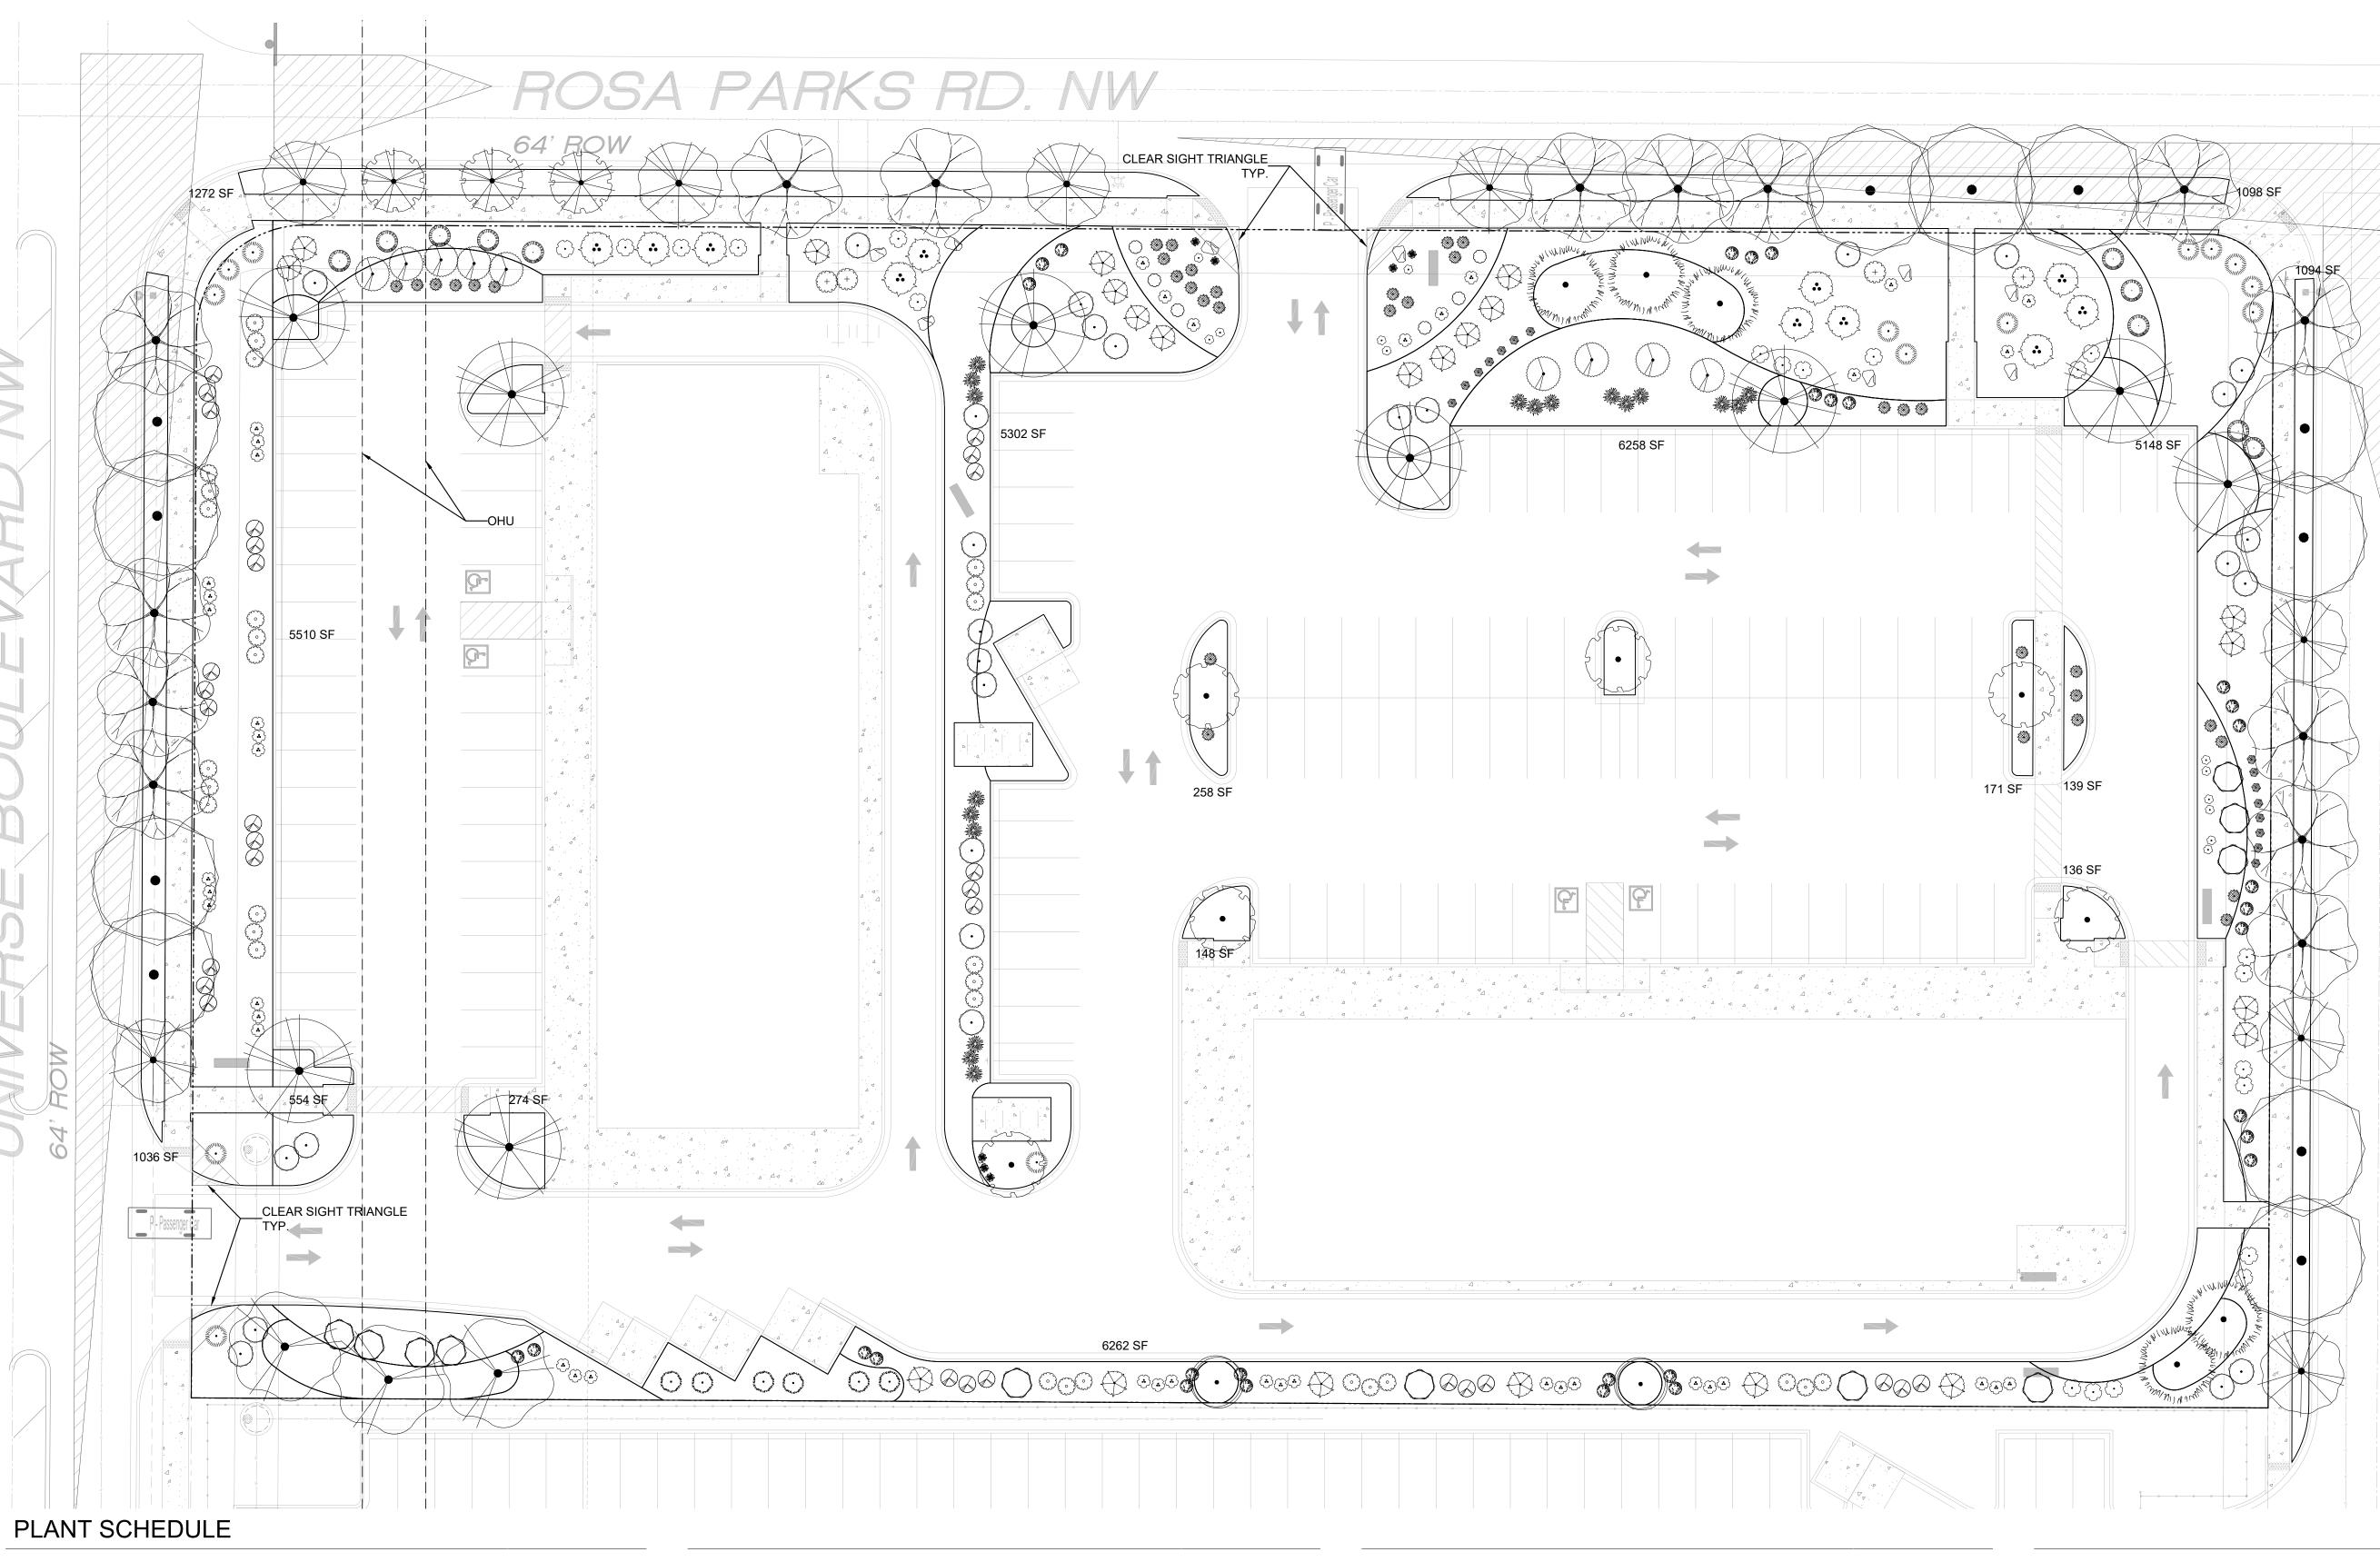


PLANT SCHEDULE											
SYMBOL	QTY	BOTANICAL / COMMON NAME	SIZE	HXW	HXW	SYMBOL	QTY	BOTANICAL / COMMON NAME	SIZE	<u>H X W</u>	<u>H X W</u>
DECIDUOUS TREE				EVERGREEN TREE							
•	11	ACER NEGUNDO `SENSATION` SENSATION BOX ELDER MAPLE	2" B&B	40` X 30`	600	MAN	6	JUNIPERUS CHINENSIS 'SPARTAN' SPARTAN JUNIPER	15 GAL	20` X 5`	20
	3	CHILOPSIS LINEARIS DESERT WILLOW	25 GAL	20` X 25`	491	William Work of the Control of the C	5	PINUS ELDARICA AFGHAN PINE	6`	40` X 18`	254
	3	CRATAEGUS AMBIGUA RUSSIAN HAWTHORN	2" B&B	20` X 15`	177		8	QUERCUS FUSIFORMIS ESCARPMENT LIVE OAK	2" B&B	20` X 20`	314
		KOELREUTERIA PANICULATA				DESERT A	DESERT ACCENT				
	9	GOLDEN RAIN TREE	1 1/2" B&E	3 25` X 25`	491		11	FOUQUIERIA SPLENDENS OCOTILLO	5 GAL	12` X 8`	50
	6	PYRUS CALLERYANA `CLEVELAND SELECT` CLEVELAND SELECT PEAR	2" B&B	25` X 15`	177		43	HESPERALOE PARVIFLORA RED YUCCA	5 GAL	3, X 3,	7
3						PERENNIA	<u>AL</u>				
(•)	2	QUERCUS ROBUR 'FASTIGIATA' SKYROCKET® ENGLISH OAK	2" B&B	50` X 15`	177		7	ACHILLEA X `MOONSHINE` MOONSHINE YARROW	1 GAL	2` X 2`	3
		ONTROONE IN LINGUISTI OAK					6	GAURA LINDHEIMERI 'WHIRLING BUTTERFLIES' WHIRLING BUTTERFLIES GAURA	1 GAL	3, X 3,	7
	14	ULMUS PROPINQUA `EMERALD SUNSHINE` EMERALD SUNSHINE ELM	2" B&B	35` X 25`	491		12	NEPETA X FAASSENII `SELECT BLUE` CATMINT	1 GAL	1` X 2`	3
*1											

SYMBOL	QTY	BOTANICAL / COMMON NAME	SIZE	<u>H X W</u>	<u>H X W</u>			
ORNAMENTAL GRASS								
	35	BOUTELOUA GRACILIS `BLONDE AMBITION` BLONDE AMBITION BLUE GRAMA	1 GAL	3, X 3,	7			
	15	CALAMAGROSTIS X ACUTIFLORA `KARL FOERSTER` FEATHER REED GRASS	1 GAL	30" X 2`	3			
DECIDUOUS SHRUBS								
	11	BUDDLEJA DAVIDII BUTTERFLY BUSH	5 GAL	5` X 7`	38			
	30	CARYOPTERIS X CLANDONENSIS `DARK KNIGHT` BLUE MIST SPIREA	5 GAL	3, X 3,	7			
\bigcirc	28	RHUS AROMATICA `GRO-LOW` GRO-LOW FRAGRANT SUMAC	5 GAL	2` X 6`	28			
	9	ROSA WOODSII MOUNTAIN ROSE	5 GAL	6, X 8,	50			
EVERGRE	EN SHI	RUBS						
	21	ARTEMISIA FILIFOLIA SAND SAGEBRUSH	5 GAL	4` X 4`	13			
	22	CYTISUS SCOPARIUS `ALL GOLD` SCOTCH BROOM	5 GAL	4` X 6`	28			
Exercise Services	30	ERICAMERIA LARICIFOLIA TURPENTINE BUSH	5 GAL	3` X 4`	13			
£ + }	4	ERICAMERIA NAUSEOSA CHAMISA	5 GAL	5` X 5`	20			

MBOL	<u>QTY</u>	BOTANICAL / COMMON NAME	SIZE	H X W	H X W
	14	JUNIPERUS SABINA 'BUFFALO' BUFFALO JUNIPER	5 GAL	2` X 5`	20
	10	PINUS MUGO MUGO PINE	5 GAL	4` X 5`	20
	30	RHAPHIOLEPIS INDICA INDIAN HAWTHORN	5 GAL	3` X 4`	13
	18	ROSMARINUS OFFICINALIS `ARP` ARP ROSEMARY	5 GAL	6` X 4`	13

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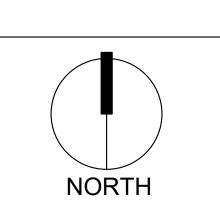
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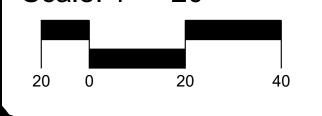
Date: <u>04/08/2024</u> Revisions: 04/29/2024 05/02/2024

Drawn by: PL

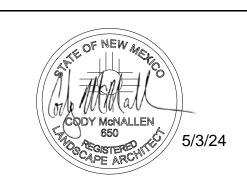Reviewed by: <u>CM</u>




Scale: 1" = 20'



Sheet Title:

Planting Plan

Sheet Number:

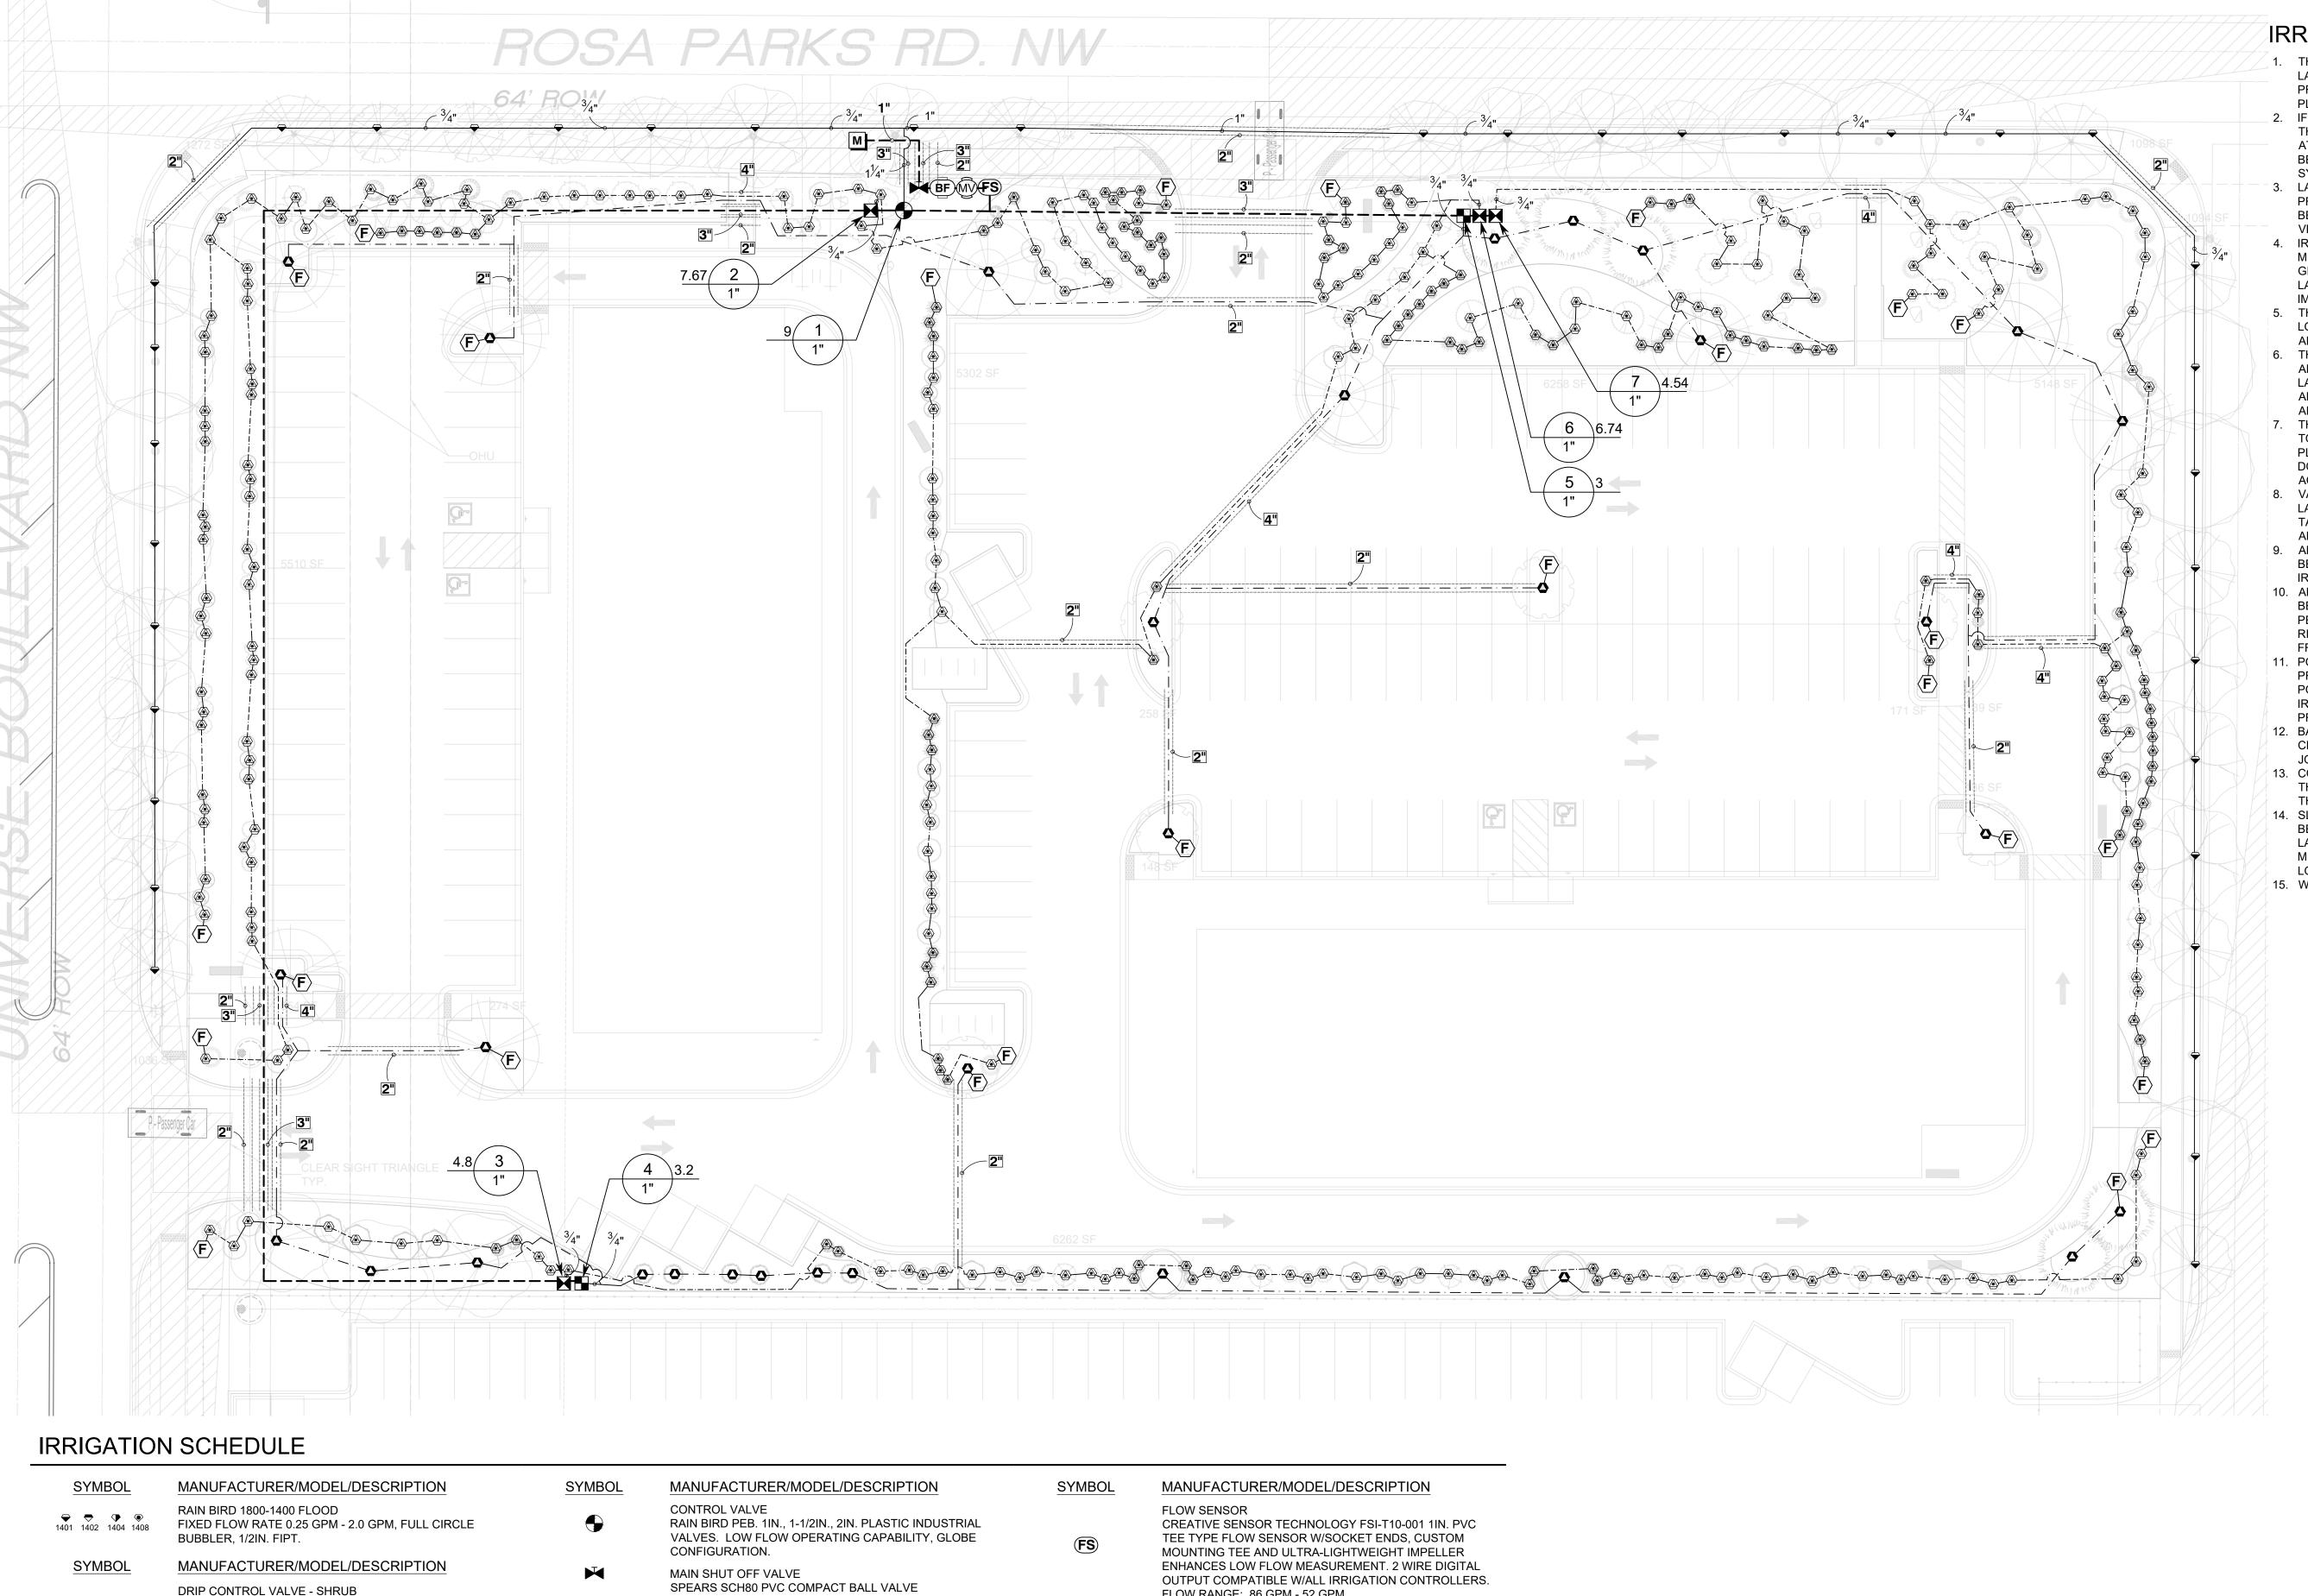

FLOW RANGE: .86 GPM - 52 GPM.

----- IRRIGATION LATERAL LINE: A940 DRIP POLYLINE - SHRUBS

IRRIGATION LATERAL LINE: PVC SCHEDULE 40

IRRIGATION LATERAL LINE: A940RDS DRIP POLYLINE -

IRRIGATION WATER METER

WATER METER 1"

---- --- IRRIGATION MAINLINE: PVC SCHEDULE 40

 Valve Number Valve Flow

_____ PIPE SLEEVE: PVC CLASS 200 SDR 21

Valve Callout

RAIN BIRD XCZ-100-PRF, MEDIUM FLOW DRIP CONTROL KIT,

1IN. DV VALVE, 1IN. PRESSURE REGULATING FILTER, 40PSI

RAIN BIRD XCZ-100-PRF. MEDIUM FLOW DRIP CONTROL KIT,

1IN. DV VALVE, 1IN. PRESSURE REGULATING FILTER, 40PSI

PRESSURE REGULATOR. 5 GPM-20 GPM.

PRESSURE REGULATOR. 3 GPM-15 GPM.

DRIP CONTROL VALVE - TREE

FLUSH CAP

NDS CEP900

DRIP EMITTER - SHRUB

DRIP EMITTER - TREE

(2) NDS TAE 20 DRIP EMITTERS

(6) NDS TAE 20 DRIP EMITTERS

MASTER VALVE 1"

FEBCO 825Y

GLOBE CONFIGURATION.

TO BE LOCATED ON SITE

CONTROLLER - RAIN BIRD ESP-LXD

RAIN BIRD PEB. 1IN., 1-1/2IN., 2IN. PLASTIC INDUSTRIAL

MASTER VALVES. LOW FLOW OPERATING CAPABILITY,

50-200 STATION, 2-WIRE DECODER BASED CONTROLLER.

ELECTRIC CABLE P7072D & RAIN BIRD WC20 DRY SPLICES

ONLY. GROUND SYSTEM W/ (X) LSP-1TURF LINE SURGE PROTECTORS IN RAIN BIRD ROUND VALVE BOXES.

INSTALL PER MANUFACTURERS RECOMMENDATIONS.

(1) ESP-LXD 50-STATION, INDOOR/OUTDOOR, PLASTIC

WALL-MOUNT ENCLOSURE. SYSTEM REQUIREMENTS:

RAIN BIRD FD-XXX-TURF FIELD DECODERS, PAIGE

REDUCED PRESSURE BACKFLOW PREVENTER 1"

IRRIGATION NOTES

- THE LANDSCAPE CONTRACTOR SHALL FURNISH LABOR, MATERIALS AND EQUIPMENT TO INSTALL PROPOSED IRRIGATION SYSTEM AS SHOWN PER PLAN AND DETAILS.
- 2. IF ANY ERRORS OR DISCREPANCIES APPEAR ON THE PLAN, THEY MUST BE BROUGHT TO THE ATTENTION OF THE LANDSCAPE ARCHITECT BEFORE CONSTRUCTION OF THE IRRIGATION SYSTEM BEGINS.
- 3. LANDSCAPE INSTALLER SHALL PERFORM PRESSURE/GPM TEST AT POINT OF CONNECTION BEFORE INSTALLING IRRIGATION SYSTEM TO VERIFY PSI AND GPM FOR THE SITE.
- IRRIGATION SYSTEM HAS BEEN DESIGNED TO A MINIMUM DYNAMIC PRESSURE OF 75 PSI AT 50 GPM. IF THE PSI/GPM ARE LOWER THAN 75/50 THE LANDSCAPE ARCHITECT MUST BE NOTIFIED IMMEDIATELY.
- 5. THE CONTRACTOR SHALL FIELD VERIFY UTILITY LOCATIONS AND MAKE ANY NECESSARY FIELD ADJUSTMENTS WITH GENERAL CONTRACTOR. 6. THE LOCATION OF IRRIGATION EQUIPMENT IS APPROXIMATE AND SHALL BE LOCATED IN THE LANDSCAPE AREAS. ANY IRRIGATION EQUIPMENT AND PIPING SHOWN OUTSIDE OF LANDSCAPE AREAS ARE FOR GRAPHIC CLARITY ONLY.
- 7. THE LANDSCAPE CONTRACTOR SHALL PROVIDE TO OWNER AN ACCURATE AS-BUILT IRRIGATION PLAN WHEN THE WORK IS COMPLETED. AS-BUILT DOCUMENTS SHOULD BE UPDATED WEEKLY FOR ACCURATE RECORDING OF IRRIGATION SYSTEM.
- 8. VALVE LOCATIONS TO BE APPROVED BY LANDSCAPE ARCHITECT. VALVE BOX LIDS TO BE TAN IN GRAVEL AREAS AND GREEN IN SOD/SEED
- 9. ALL PLANTS WITHIN THE PROPERTY LINE SHALL BE IRRIGATED BY LOW FLOW POINT-SOURCE DRIP IRRIGATION SYSTEM.
- 10. ALL PLANTS WITHIN PUBLIC RIGHT-OF-WAY SHALL BE IRRIGATED BY BUBBLER IRRIGATION SYSTEM PER COA SPEC. ALL PLANTS WITHIN THE PUBLIC RIGHT-OF-WAY SHALL BE ZONED SEPARATELY FROM THE PLANTS WITHIN THE PROPERTY LINE.
- 11. POWER FOR IRRIGATION SYSTEM TO BE PROVIDED BY THE GENERAL CONTRACTOR. 110V POWER IS REQUIRED AT THE LOCATIONS OF THE IRRIGATION CONTROLLER AND BACKFLOW 12. BACKFLOW PREVENTER MUST BE TESTED AND
- CERTIFIED BEFORE FINAL ACCEPTANCE OF THE
- 13. CONTROLLER LOCATION IS APPROXIMATE AND THE FINAL LOCATION WILL BE DETERMINED IN THE FIELD.
- 14. SLEEVES TO BE INSTALLED, AS SHOWN PER PLAN, BEFORE HARDSCAPE IS INSTALLED. THE LANDSCAPE CONTRACTOR MUST BE GIVEN A MINIMUM OF 72 HOUR NOTICE BEFORE SLEEVE LOCATIONS ARE PAVED OVER.
- 15. WATER METER TO BE PROVIDED BY OTHERS.



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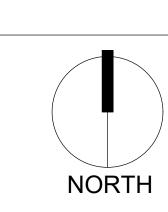


Date: <u>04/08/2024</u> Revisions:

04/29/2024

Drawn by: PL Reviewed by: CM

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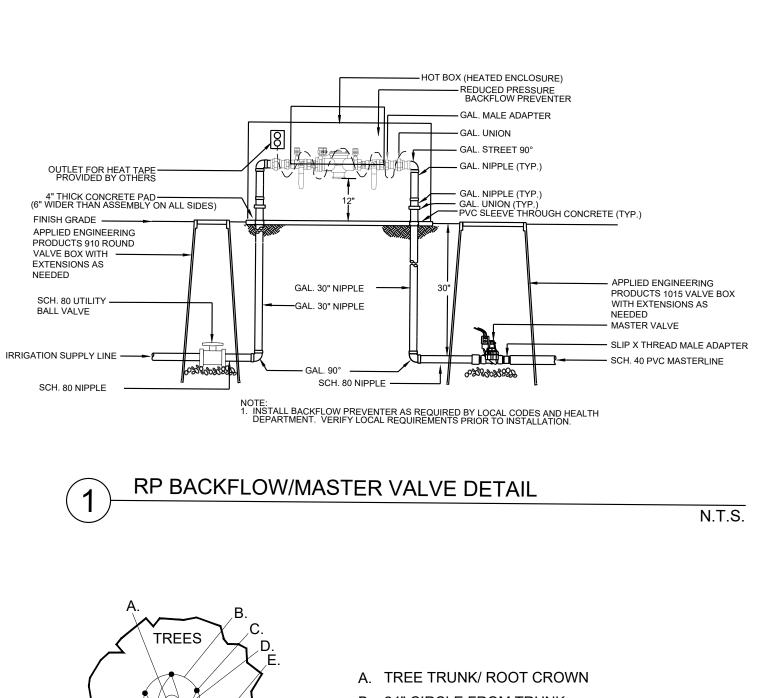
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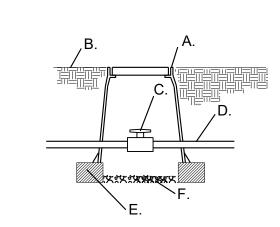


Sheet Title:

Irrigation Plan

Sheet Number:





A. APPLIED ENGINEERING

B. FINISH GRADE

C. 24" WIRE LOOP

EQUAL

D. AUTOMATIC VALVE

EXTENSIONS AS NEEDED

SEE IRRIGATION LEGEND.

E. DRY SPLICE CONNECTOR OR

PRODUCTS 1320 VALVE BOX WITH

MAINLINE ISOLATION VALVE DETAIL

- A. APPLIED ENGINEERING PRODUCTS 910 ROUND VALVE BOX WITH EXTENSIONS AS NEEDED
- B. FINISH GRADE
- C. SCH. 80 UTILITY BALL VALVE

F. "WYE" STRAINER

OF FILTER

DRIP VALVE WITH FILTER & PRESSURE REGULATOR

H. 8" X 8" X 16" CMU

STRAINER SHALL BE INSTALLED

MAINTENANCE AND REPLACEMENT

TO PROVIDE ACCESS FOR

G. LATERAL LINE/24" BURY

CONCRETE BLOCK

I. MASTERLINE/24" BURY

J. 4" LAYER OF 3/4" GRAVEL


K. PRESSURE REGULATOR

M. SCH. 40 PVC LATERAL LINE

L. SCH. 80 TRUE UNION BALL VALVE

N.T.S.

- D. MAINLINE/24" BURY
- E. 8" X 8" X 16" CMU
- CONCRETE BLOCK F. 4" LAYER OF 3/4" GRAVEL

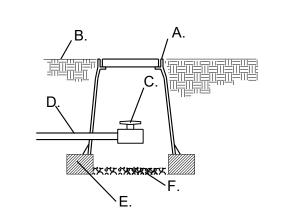

MANUAL DRAIN VALVE DETAIL

- A. APPLIED ENGINEERING PRODUCTS 910 ROUND VALVE BOX WITH EXTENSIONS AS NEEDED
- B. FINISH GRADE
- C. SCH. 80 UTILITY BALL VALVE
- D. MAINLINE/24" BURY
- E. 8" X 8" X 16" CMU
- CONCRETE BLOCK F. 3/4" GRAVEL SUMP UNDER MANUAL DRAIN TO BE A

MINIMUM OF 12" DEEP

A. FINISH GRADE


F. 90° FITTING


B. END FLUSH CAP

D. 3/4" POLY DRIP PIPE

E. 2" DEPTH OF GRAVEL

C. 6" ROUND BOX WITH LID

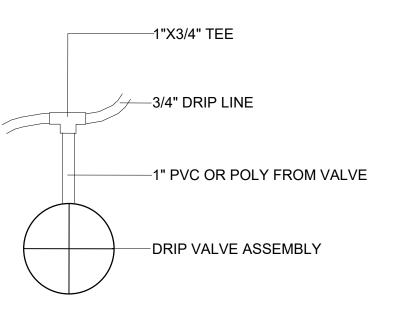

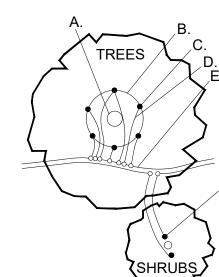

RAIN BIRD.

- B. 24" CIRCLE FROM TRUNK
- C. EMITTERS
- D. 1/4" DISTRIBUTION LINE
- E. PE DRIPLINE
- F. EMITTER PLACED WITHIN 6" OF PLANT STEM
- NOTE: INSTALL EMITTERS ABOVE THE ROOT BALL IF PLANT IS INSTALLED ON A SLOPE.






A. CONTROLLER (see plan for model)

- C. WIRES TO REMOTE CONTROL VALVES D. JUNCTION BOX
- E. 1" PVC SCH. 40 CONDUIT AND FITTINGS TO

B. 2" PVC SCH. 40 CONDUIT AND FITTINGS

POWER SUPPLY


WALL MOUNTED AUTOMATIC CONTROLLER

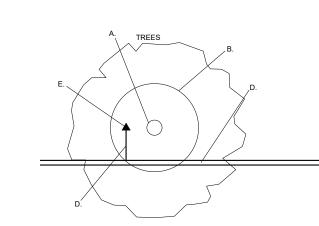

N.T.S.

- A. TREE TRUNK/ ROOT CROWN B. 36" DIA BERM AROUND TREE C. 24" DIA BERM AROUND SHRUB
- D. PVC LATERAL PIPE (SIZE VARIES) E. BUBBLER PLACED 6" INSIDE BERM
- NOTE: INSTALL BUBBLER(S) ABOVE THE ROOT BALL IF PLANT IS INSTALLED ON A SLOPE.



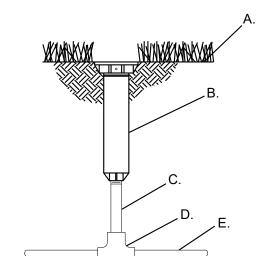

END FLUSH CAP

A. FINISH GRADE B. POP-UP SPRAY SPRINKLER: RAIN BIRD 1804-SAM-PRS BODY WITH RAINBIRD R-VAN NOZZLE

N.T.S.

N.T.S.

- C. PVC SCH.40 NIPPLE
- D. PVC SCH.40 TEE E. PVC LATERAL LINE

ROTATOR SPRINKLER

A. APPLIED ENGINEERING PRODUCTS 1320 VALVE BOX WITH EXTENSIONS AS NEEDED

- B. FINISH GRADE
- C. 24" WIRE LOOP
- D. AUTOMATIC VALVE-SEE IRRIGATION LEGEND.
- E. DRY SPLICE CONNECTOR OR
- F. LATERAL LINE/24" BURY
- G. 8" X 8" X 16" CMU CONCRETE BLOCK
- H. MASTERLINE/24" BURY
- I. 4" LAYER OF 3/4" GRAVEL
- J. SCH. 80 TRUE UNION BALL VALVE
- K. SCH. 40 PVC LATERAL LINE

N.T.S.

N.T.S.

www.yellowstonelandscape.com

Albuquerque, NM 87184

design@yellowstonelandscape.com

PO Box 10597


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Date: <u>04/08/2024</u>


Revisions:

Drawn by: PL

Reviewed by: <u>CM</u>

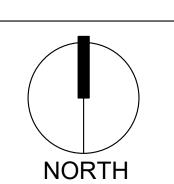

Scale: 1" = 20'

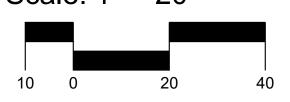

Sheet Title:

Irrigation Plan

Sheet Number:





AUTOMATIC VALVE

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- PREVENTER. 12. BACKFLOW PREVENTER MUST BE TESTED AND CERTIFIED BEFORE FINAL ACCEPTANCE OF THE JOB.
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- 15. WATER METER TO BE PROVIDED BY OTHERS.




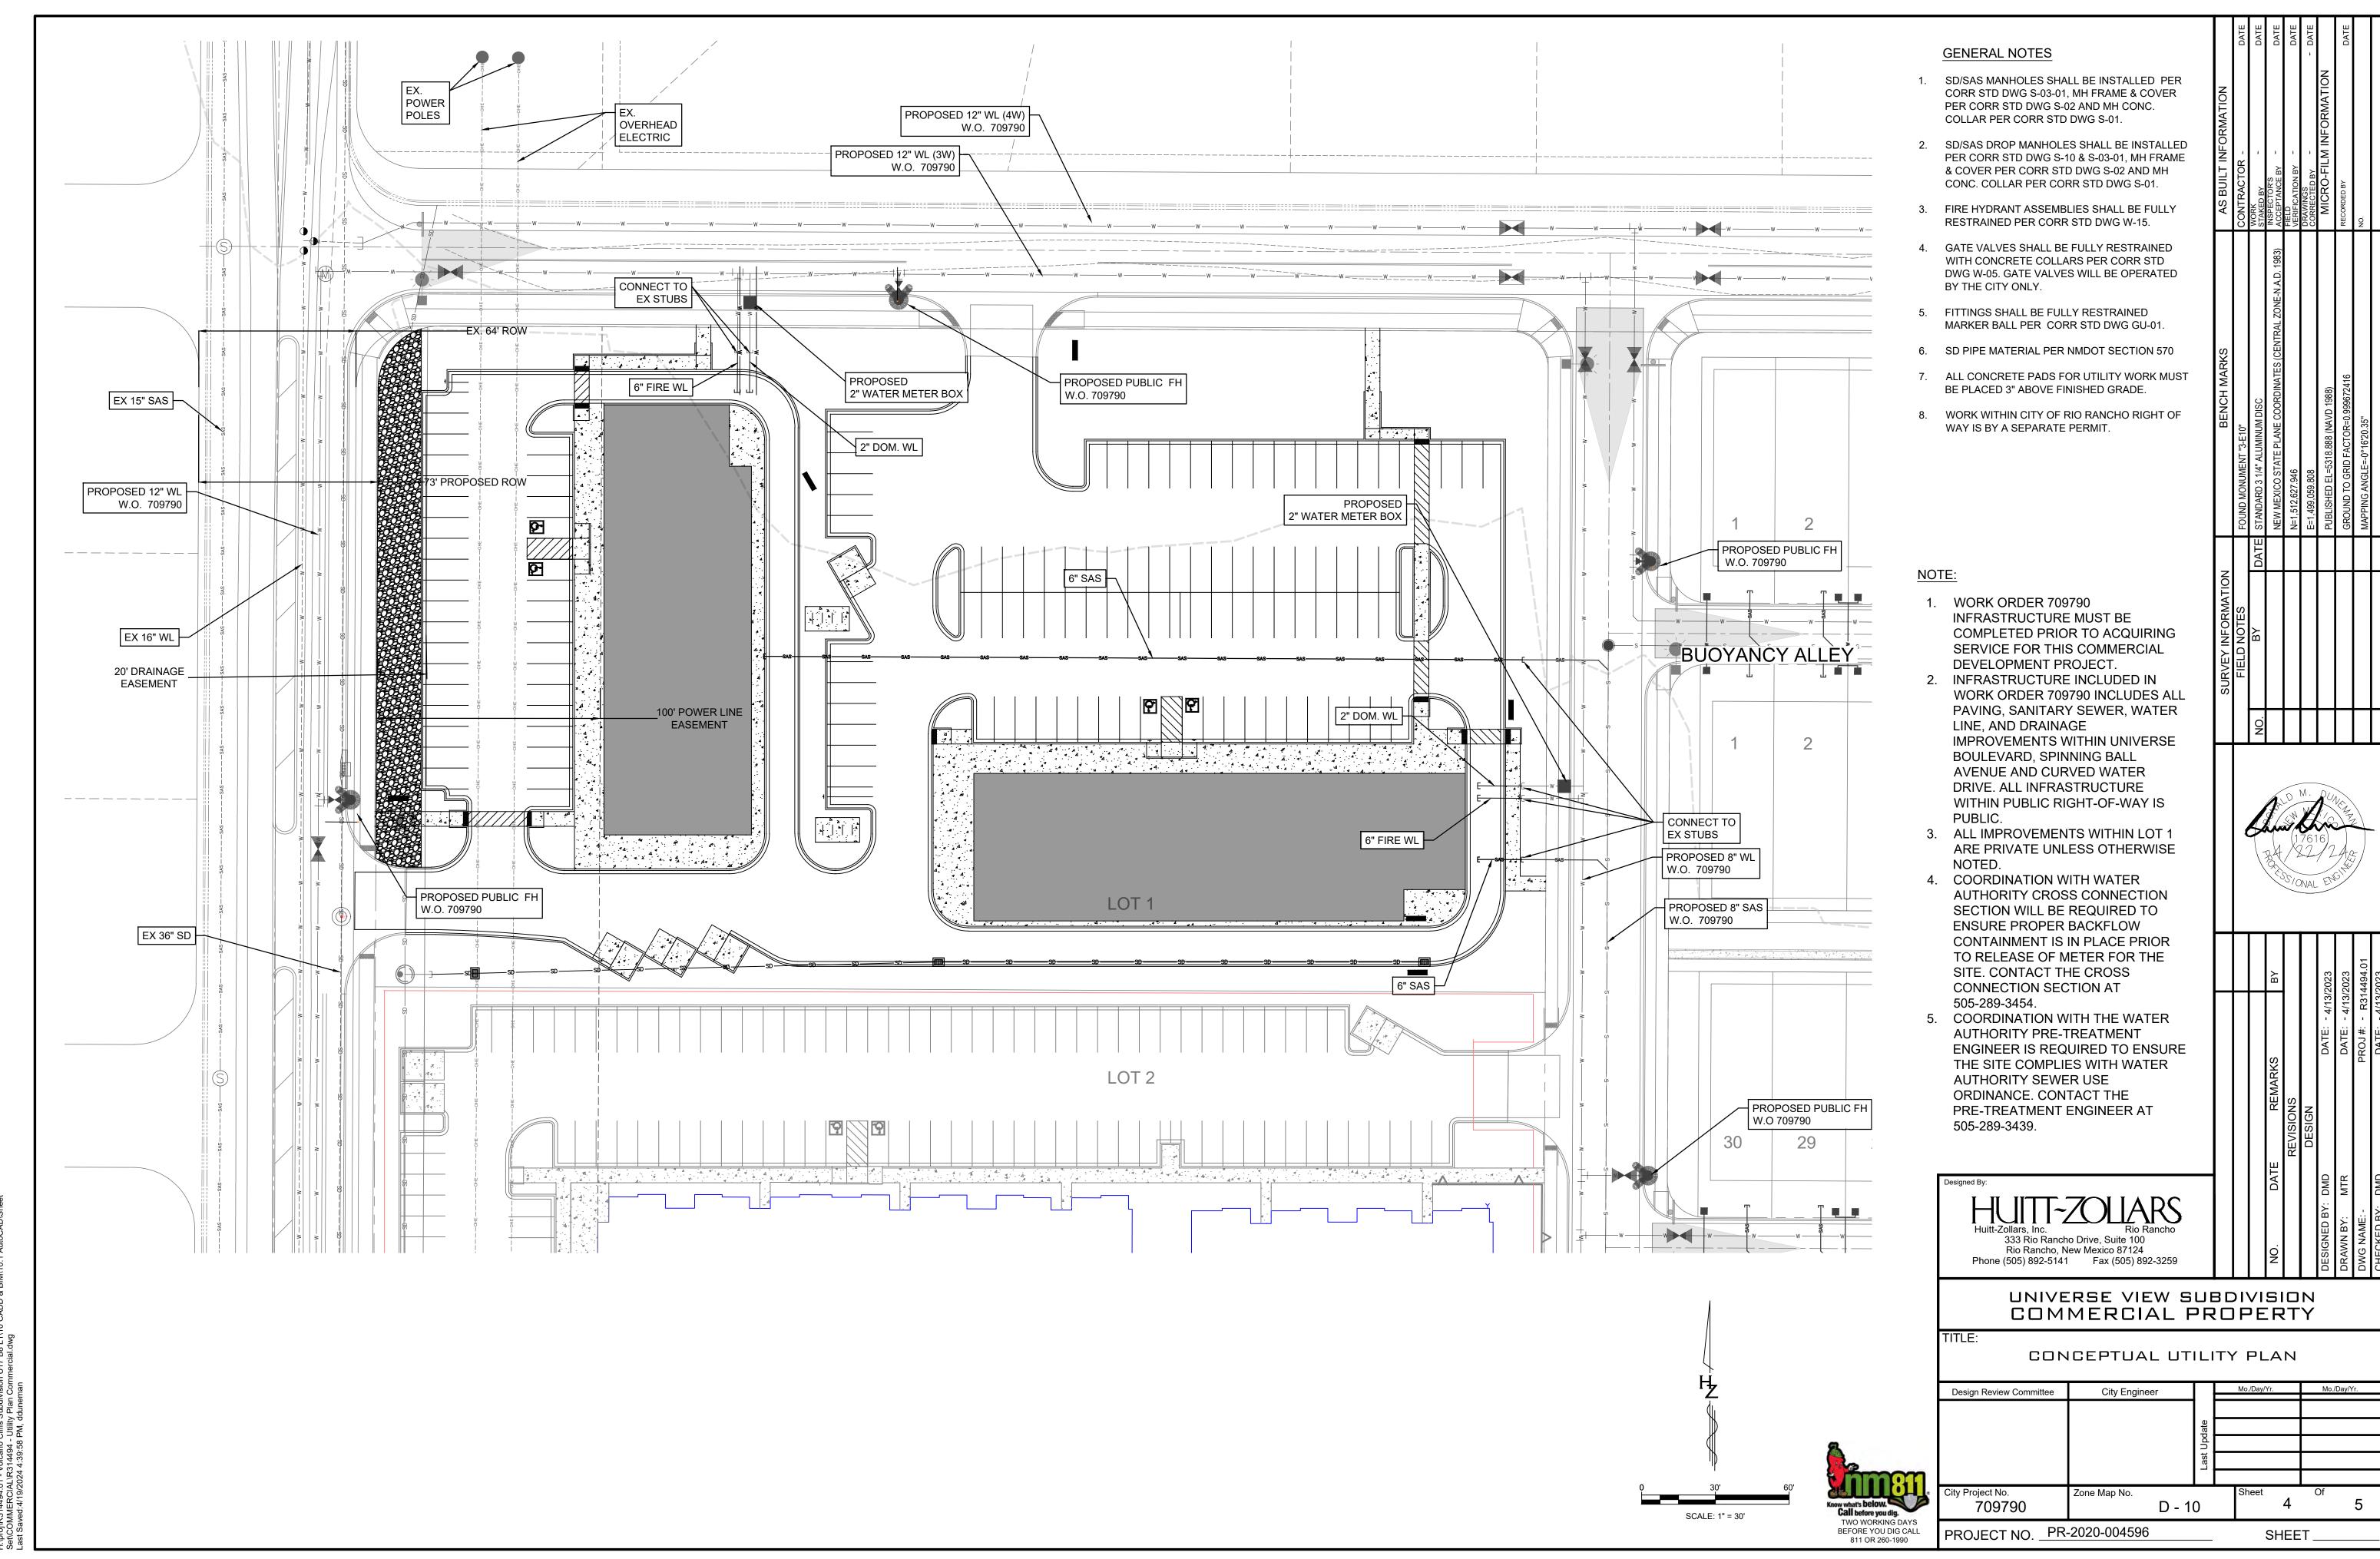

WEST BUILDING WEST ELEVATION

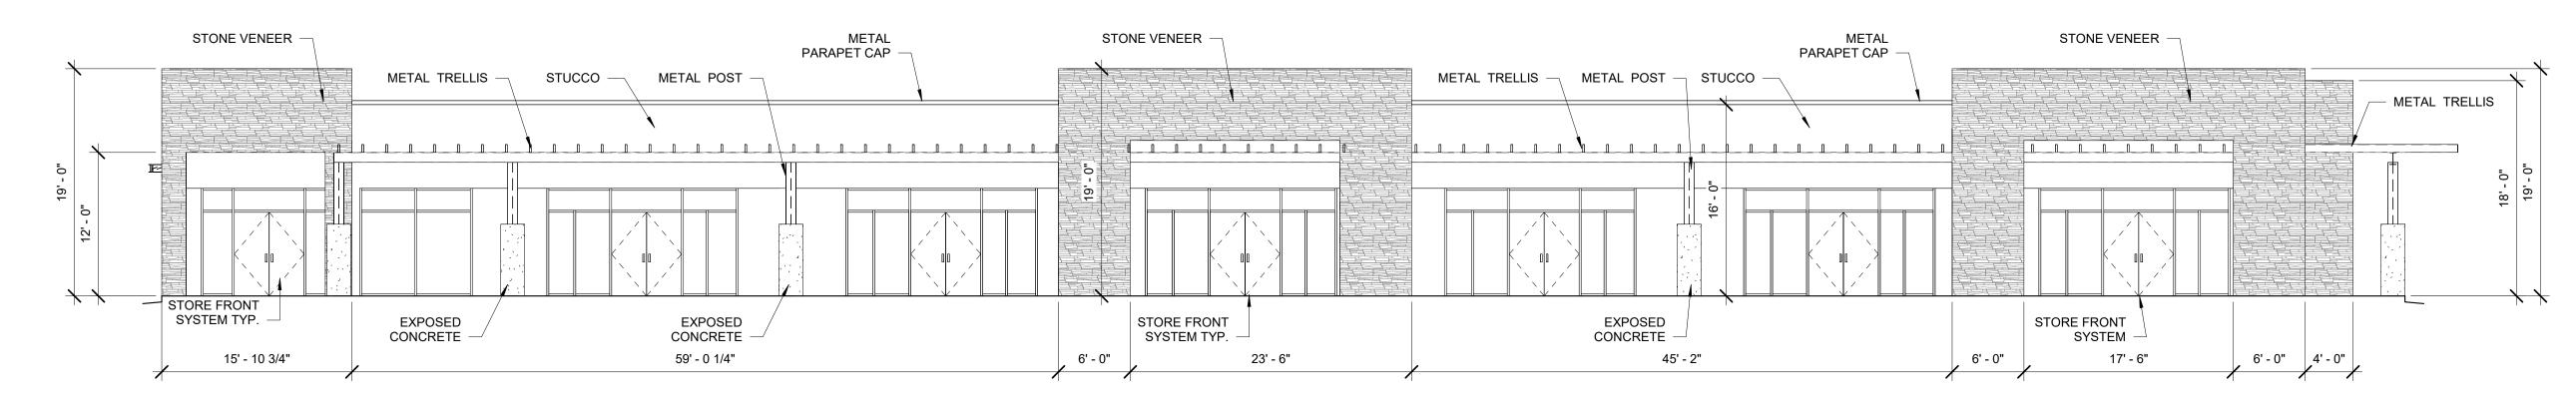1/8" = 1'-0"

TOTAL GROUND FLOOR FACADE = 2,197.10 SF
GLAZING = 1,047 SF
1047/2197.1 = 47%

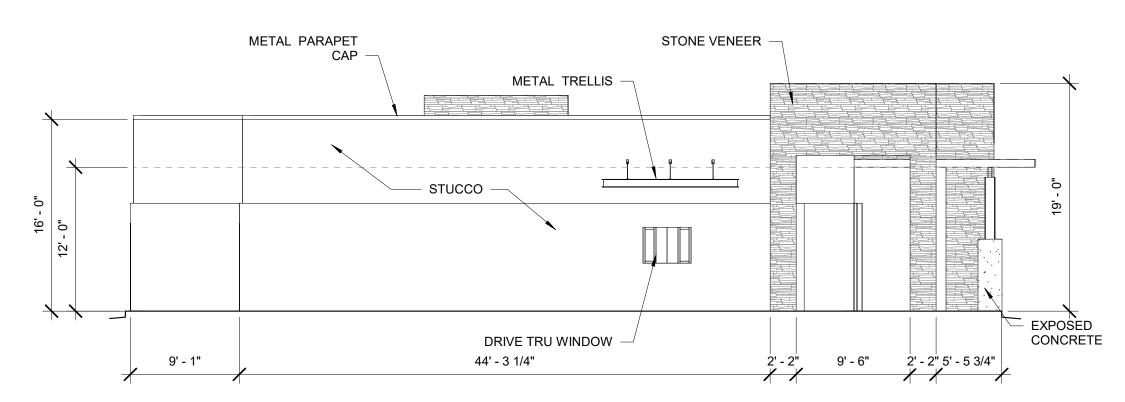

WEST BUILDING NORTH ELEVATION

1/8" = 1'-0"

TOTAL GROUND FLOOR FACADE = 861.17 SF GLAZING = 11.50 SF 11.50/861.17 = 01% WEST BUILDING SOUTH ELEVATION

1/8" = 1'-0"

STONE VENEER

METAL
PARAPET CAP

P- 9 3W

STUCCO


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WEST BUILDING EAST ELEVATION


1/8" = 1'-0

TOTAL GROUND FLOOR FACADE = 2,197.10 SF GLAZING = 0 SF 0/2197.1 = 0%

TOTAL GROUND FLOOR FACADE = 724.17 SF GLAZING = 159.75 SF 159.75/724.17 = 22 %

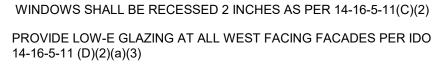



PROVIDE FULL SHEILDS AT ALL WALL MOUNTED LIGHT FIXTURES

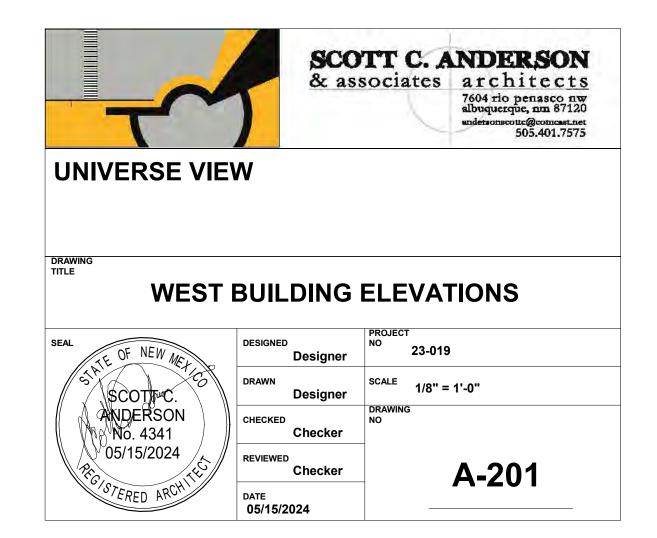




WEST BUILDING WEST COLOR ELEVATION 1/8" = 1'-0"

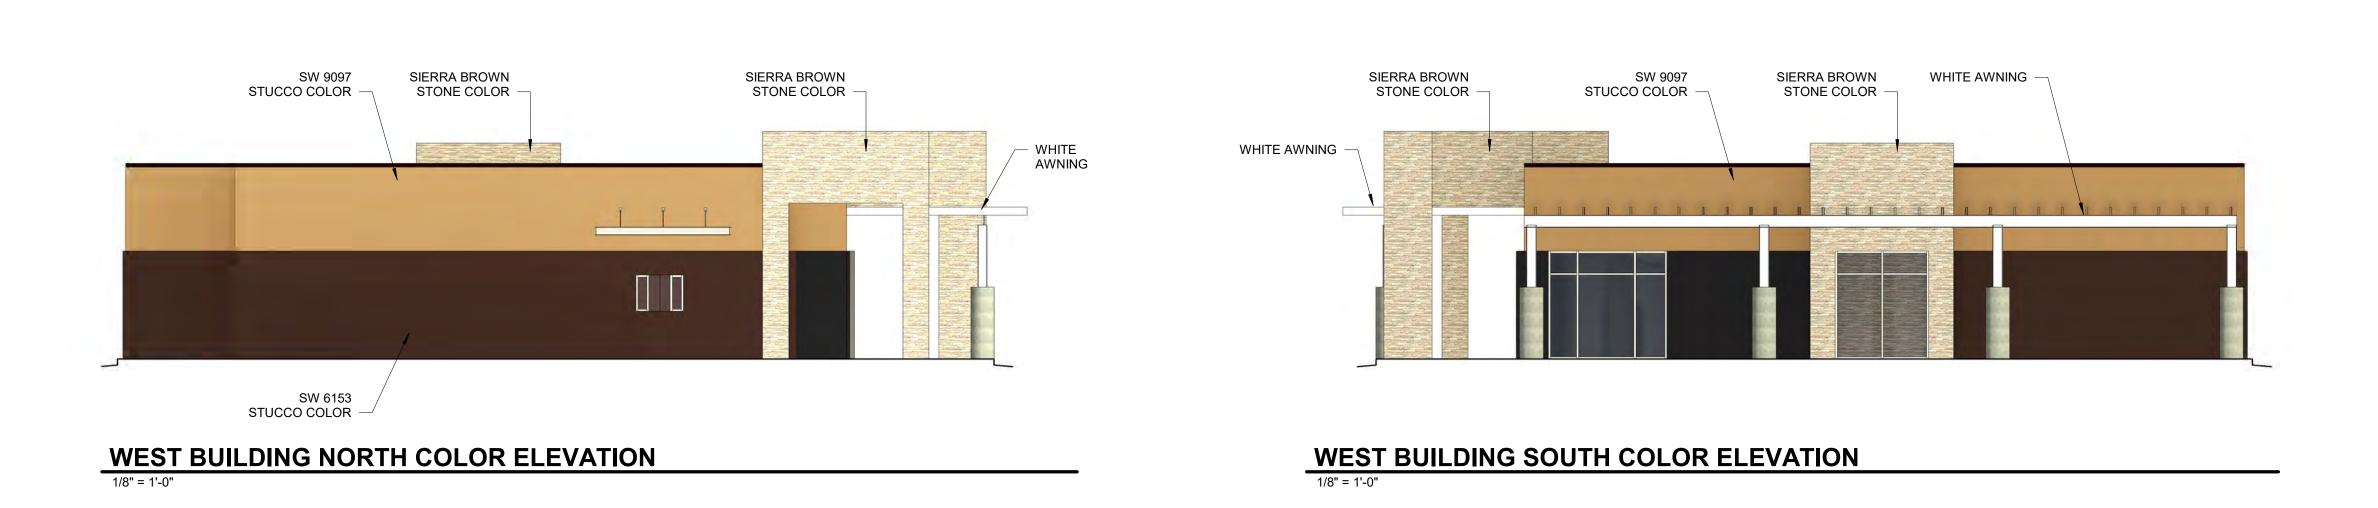


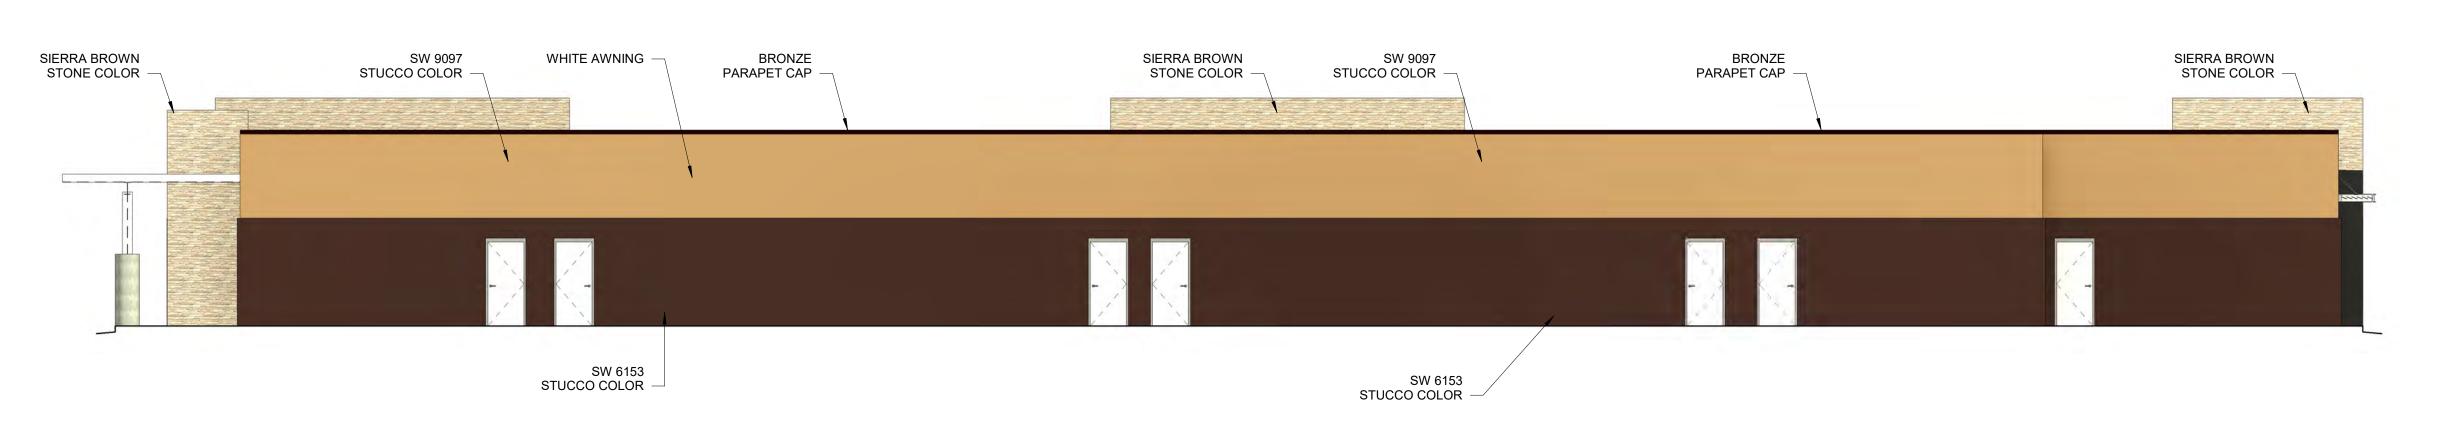

WEST BUILDING EAST COLOR ELEVATION

1/8" = 1'-0"

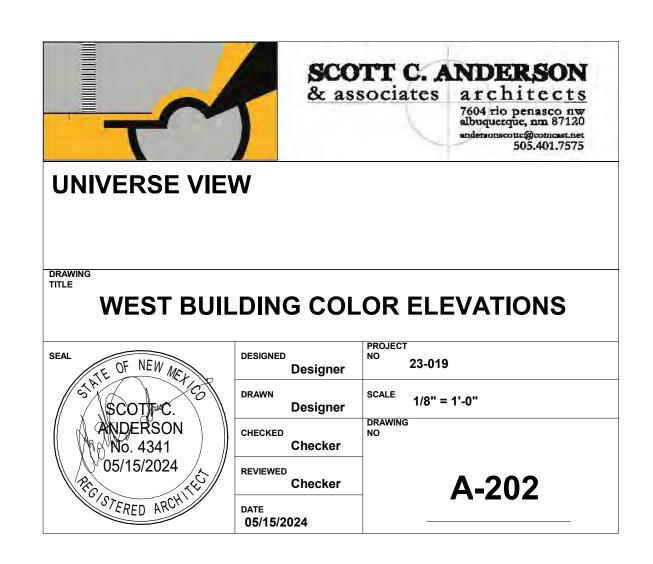

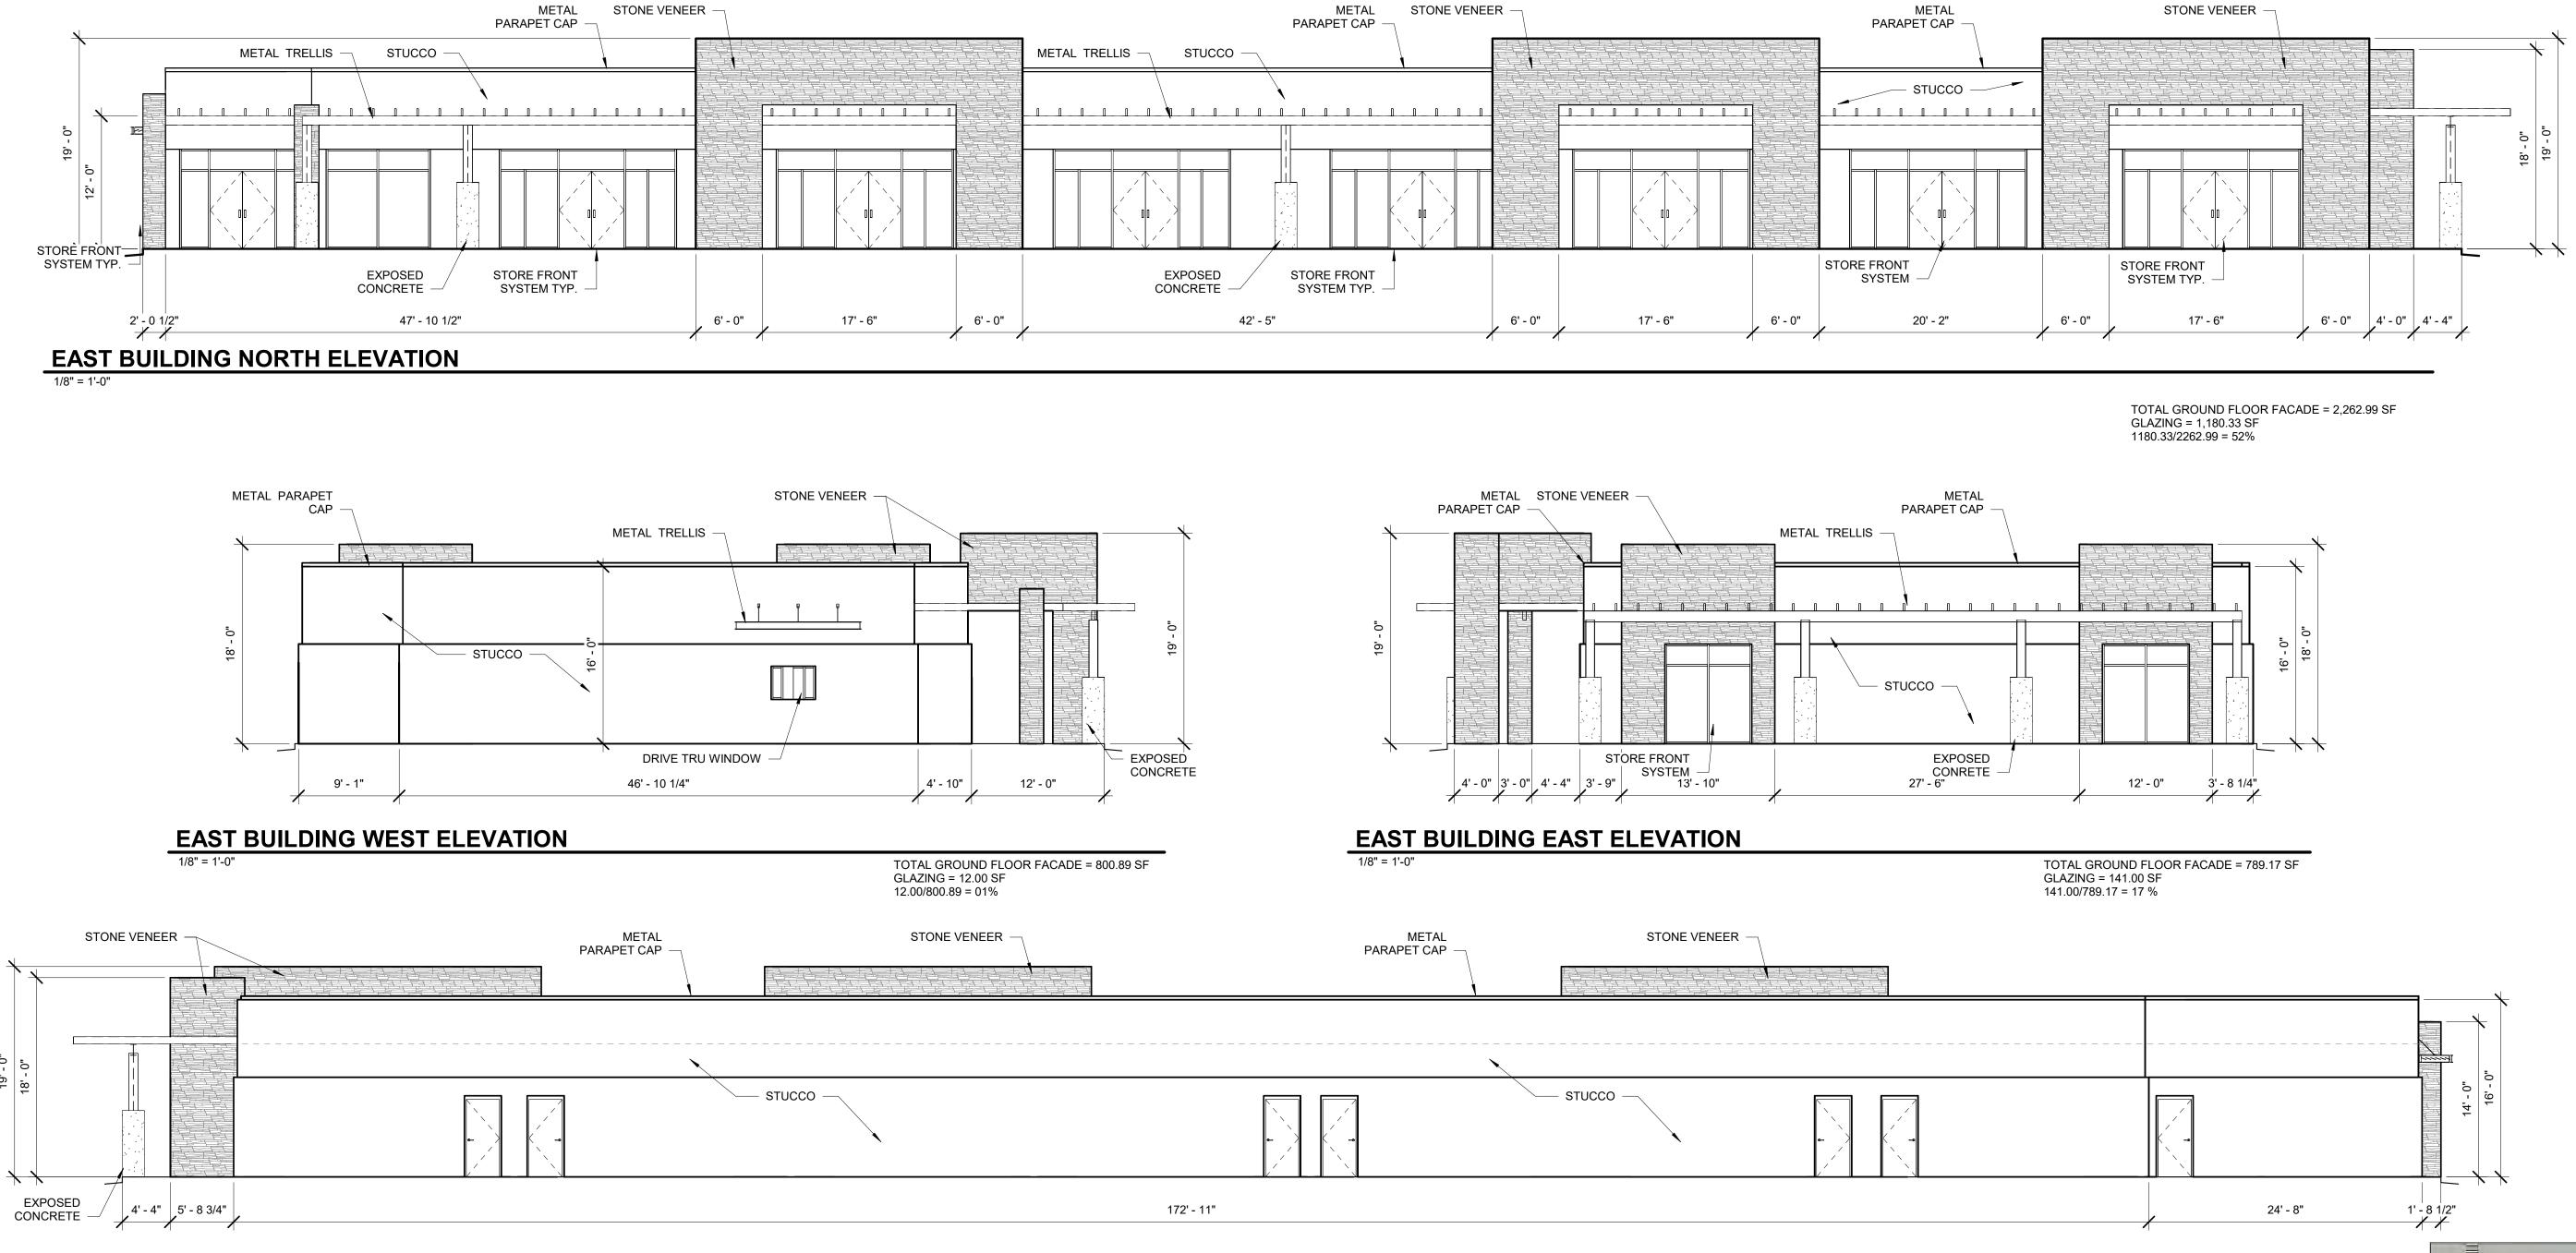


EAST BUILDING SOUH ELEVATION


1/8" = 1'-0"

TOTAL GROUND FLOOR FACADE = 2,262.99 SF GLAZING = 0.00.33 SF 0.00/2262.99 = 0%


STONE VENEER -

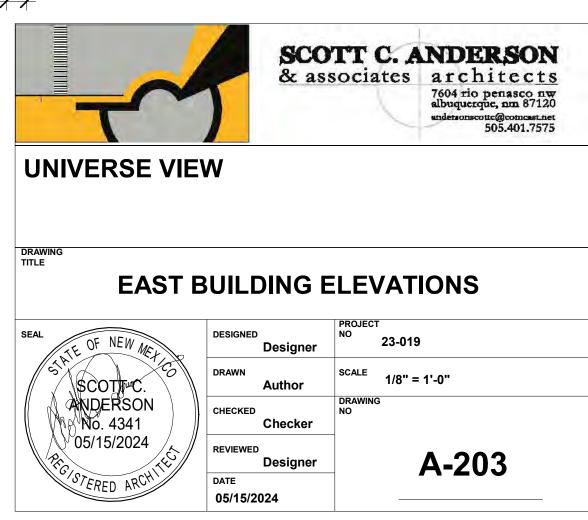




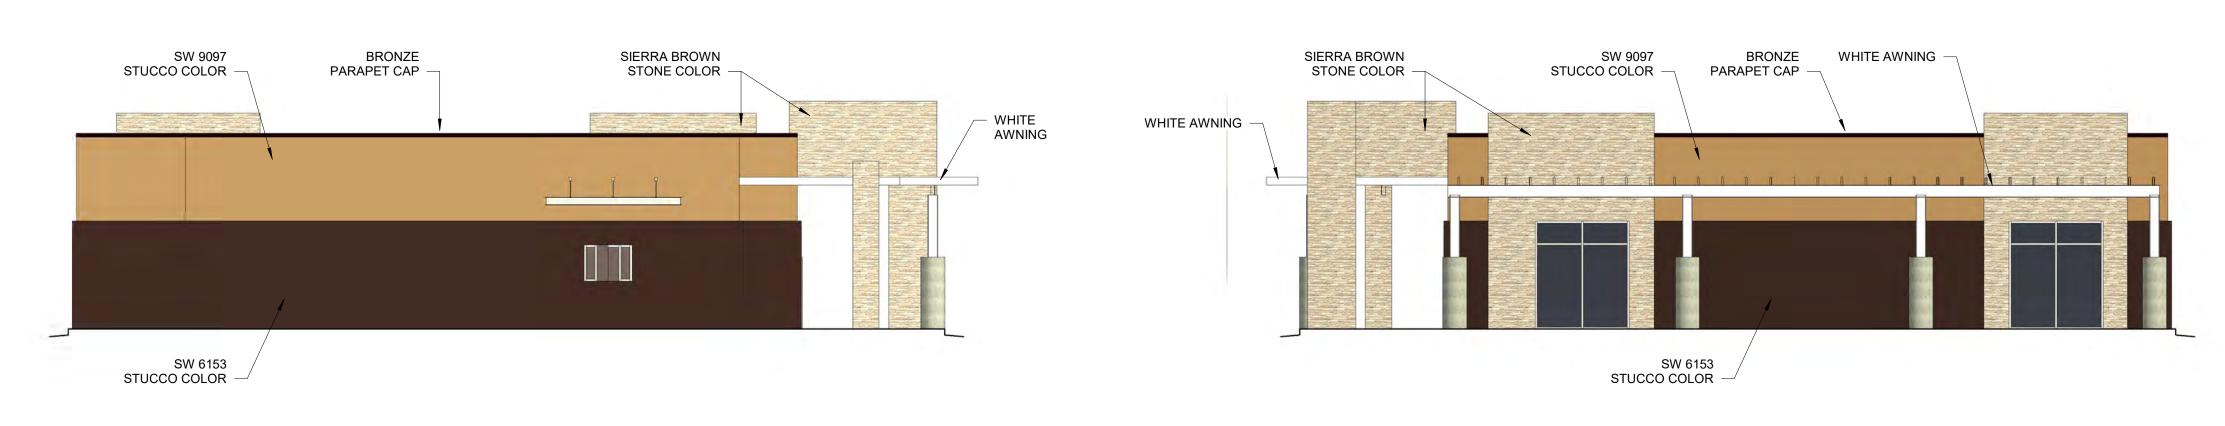

EAST BUILDING WEST COLOR ELEVATION 1/8" = 1'-0" EAST BUILDING EAST COLOR ELEVATION 1/8" = 1'-0"

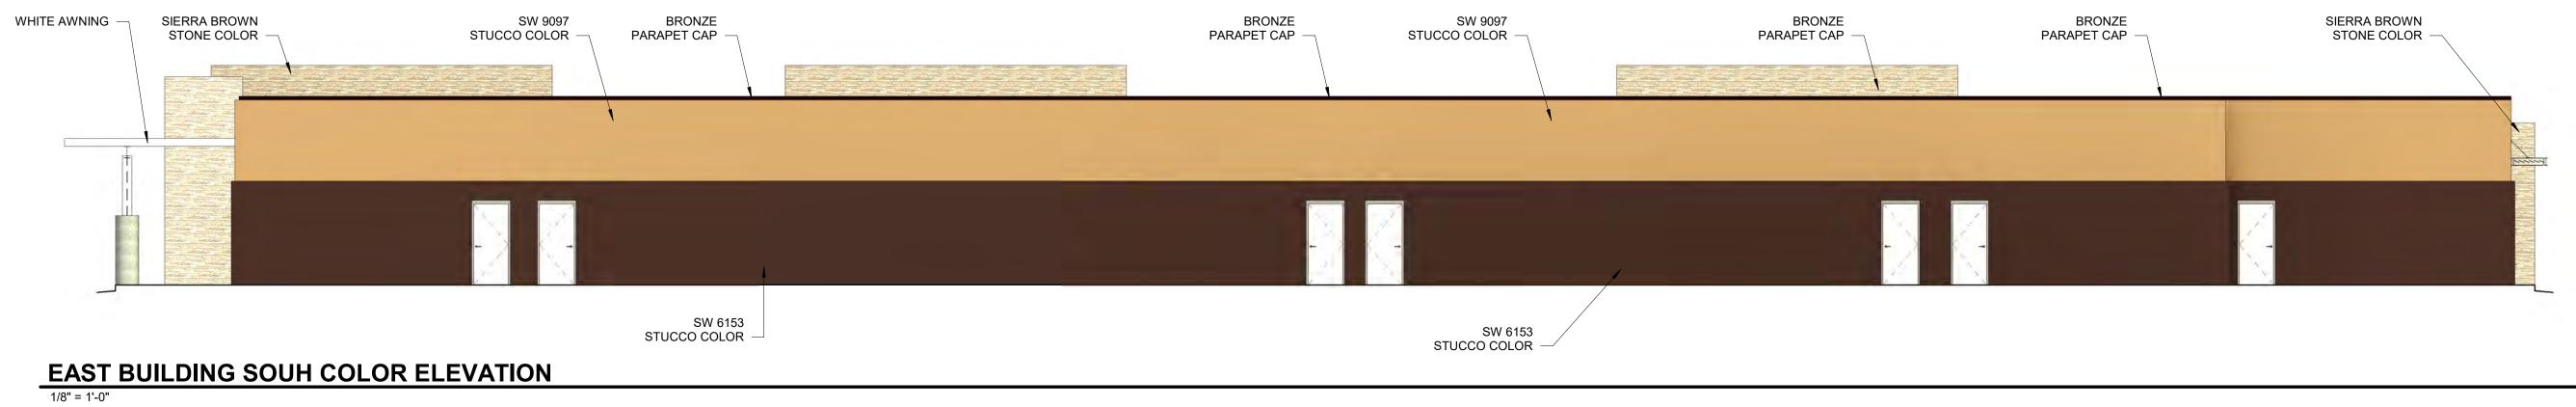

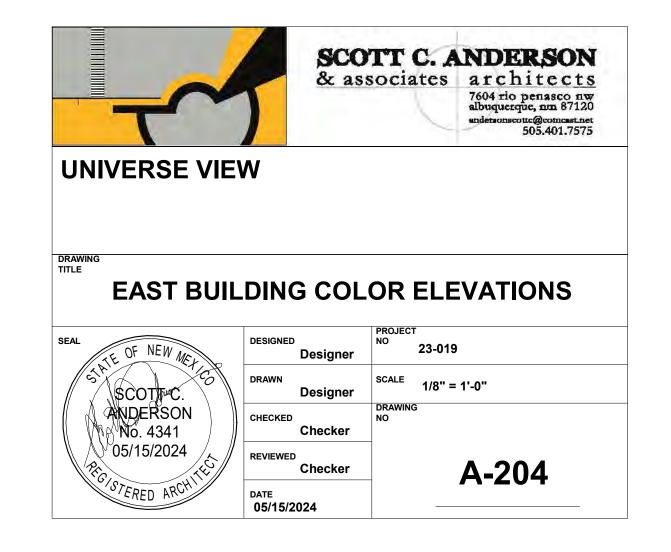











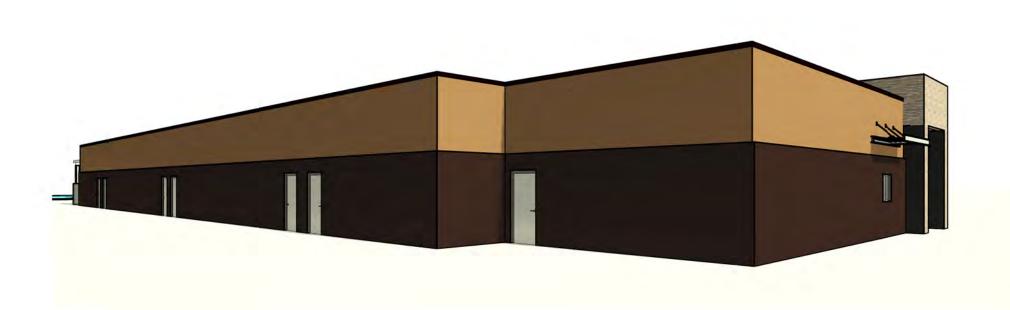


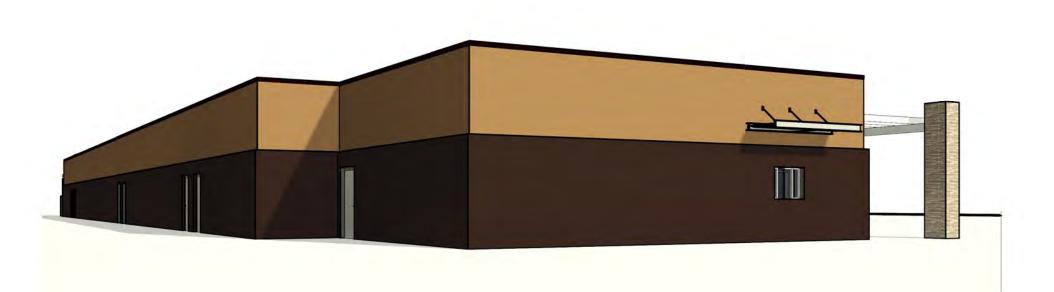









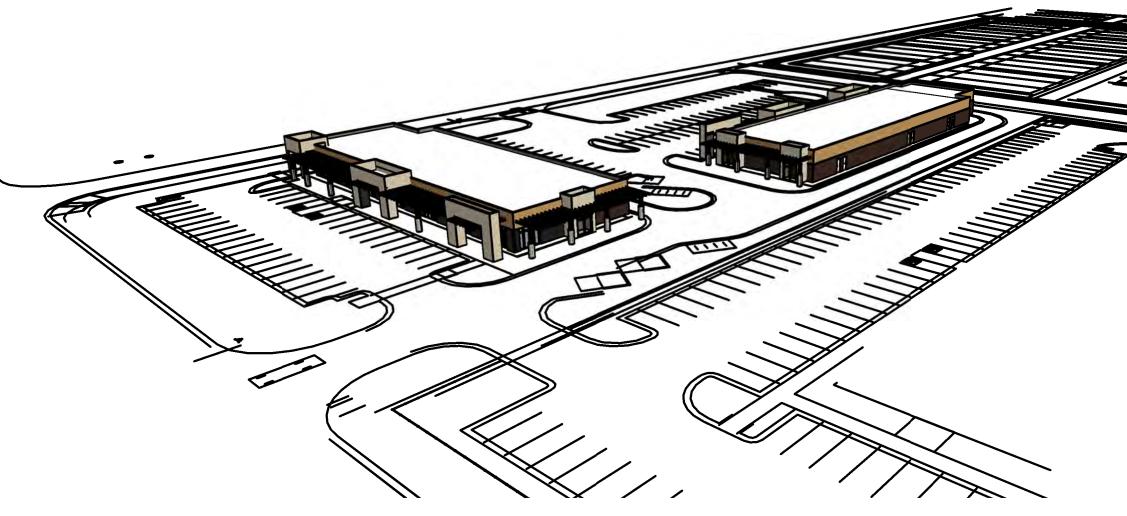

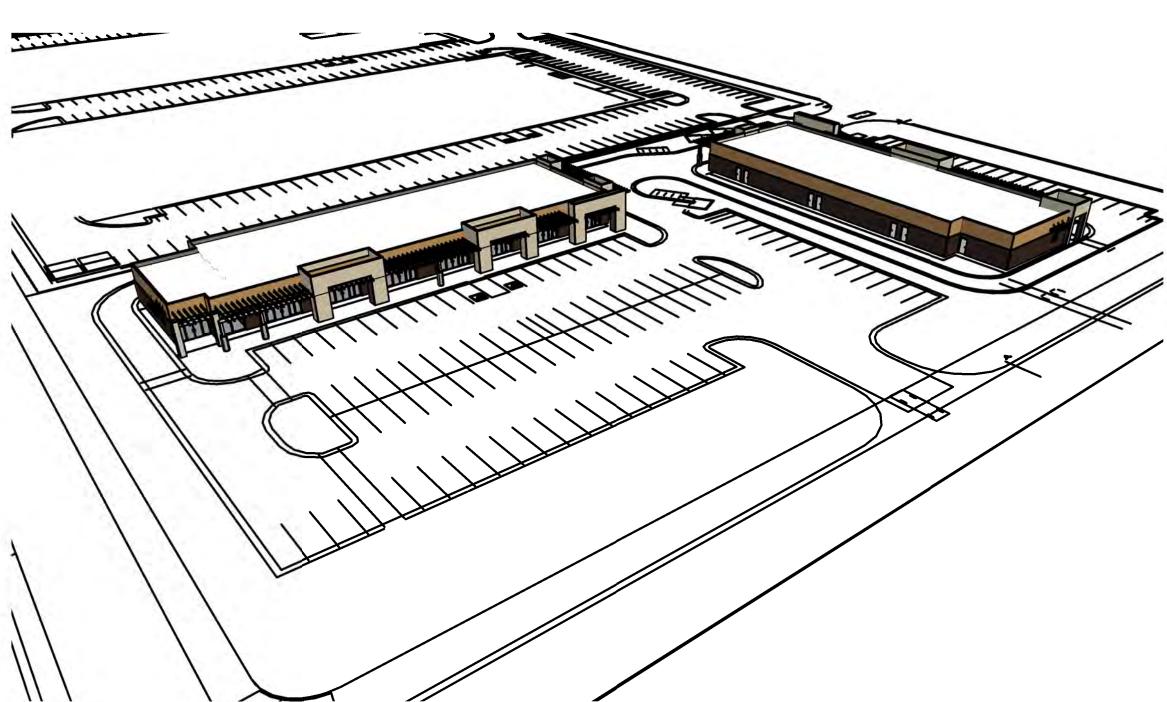


SCOTT C. ANDERSON No. 4341

05/15/2024

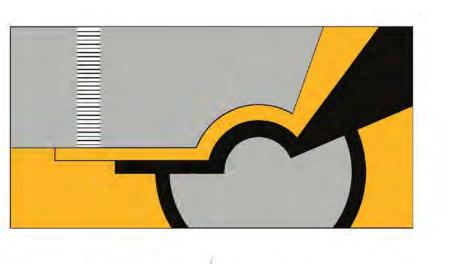


SCOTT C. ANDERSON
& associates architects
7604 rio penasco nw albuquerque, nm 87120
andersonscottc@comcast.net
505.401.7575

WEST BUILDING

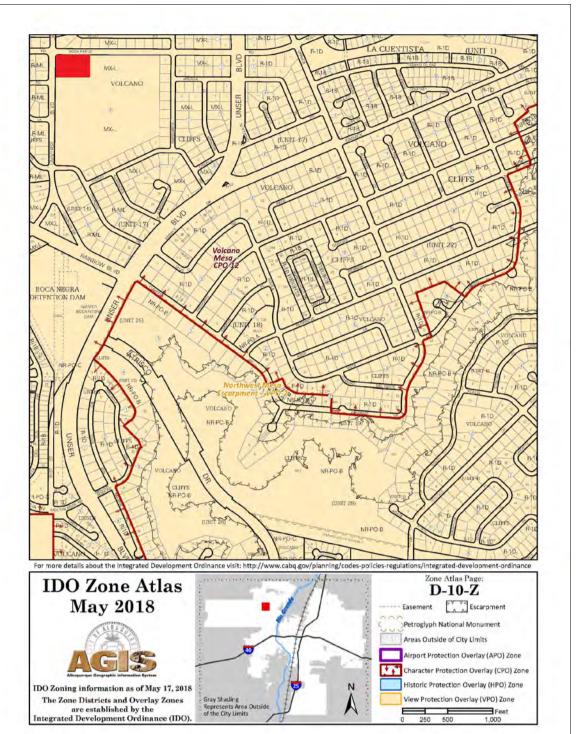




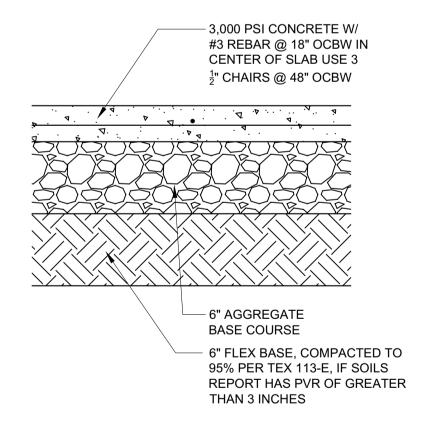


PAVING SECTION

SCALE: NTS

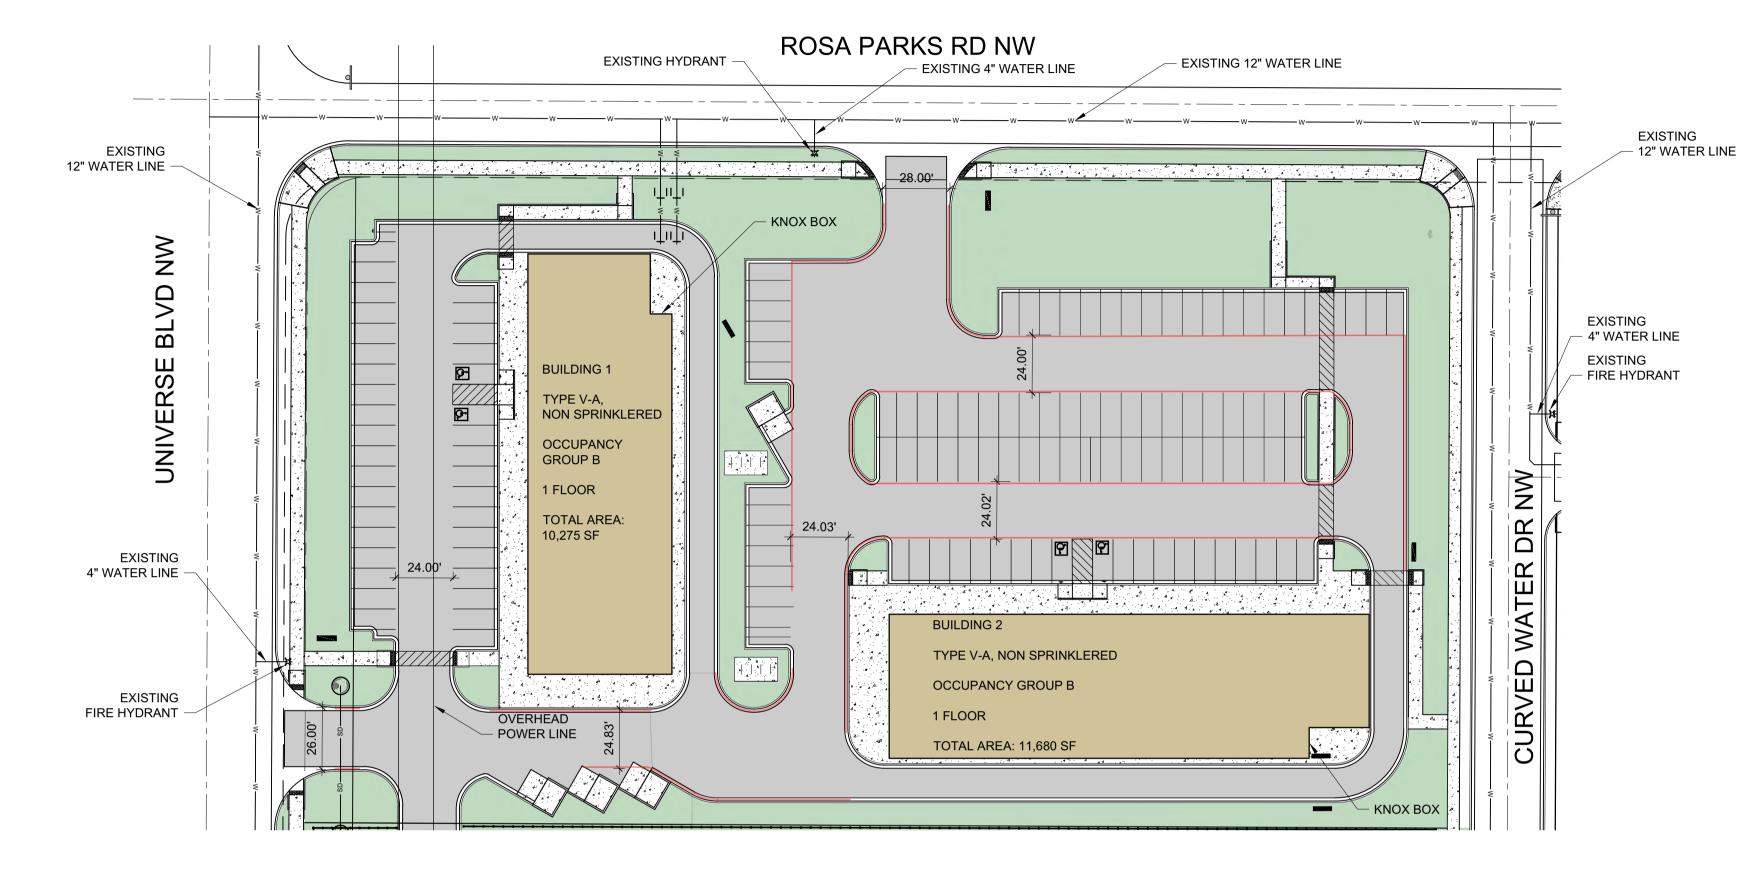

SITE PLAN

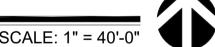

ALBUQUERQUE FIRE MARSHAL'S

DIVISION OFFICE BLANS DERE 1 P

DIVISION OFFICE BLANS OF FIRE 1 PLAN WILL BE SUBMITTED AT PERMIT CHECKING DIVISION

PER 2 PROPERTY OF THE PLAN WILL BE SUBMITTED AT PERMIT CHECKING DIVISION

PER 2 PROPERTY OF THE PLAN WILL BE SUBMITTED AT PERMIT CHECKING DIVISION

PER 2 PROPERTY OF THE PLAN WILL BE SUBMITTED AT PERMIT CHECKING DIVISION OF THE PROPERTY OF THE PROPER

PERMIT NUMBER: FIRE TO PRANT REQUIRED

THESE CONSTRUCTION DOCUMENTS WERE REVIEWED AND APPROVED BY THE LINES IDENTIFIED ON THE PLAN ALBUQUERQUE FIRE MARSHAL'S OFFICE IN ACCORDANCE WITH THE CITY ORDINACE, THE INTERNATIONAL FIRE CODE, AND NFPA STANDARDS. THIS

PERMIT IS VALID FOR 180 DAYS. FINAL INSPECTION IS REQUIRED BLIC WATER MAIN IDENTIFIED ON THE PLAN

FIRE FLOW: FF 2000GPM 2HYDRANTS VA

- 8. NO PARKING 15FT FROM THE HYDRANT
- 9. ACCESS PROVIDED TO 150FT
- 10. BUILDING HT 20FT, 2 MEANS OF APPARATUS ACCESS
- 11. TOTAL BUILDING AREA LESS THAN 62,000 SF, 2 MEANS OF APPARATUS ACCESS
- 12. THIS IS NOT MULTI-FAMILY PROJECT
- 13. THIS IS NOT A ONE OR TWO FAMILY RESIDENTIAL PROJECT
- 14. 3 MEANS OF ACCESS PROVIDED, ONLY 2 ARE REQUIRED
- 15. BUILDING LESS THAN 30 FT IN HT, 24 FT ROAD WIDTH PROVIDED
- 16. ACCESS ROAD 24 FT WIDE
- 17. ACCESS ROAD 24 FT WIDE
- 18. ACCESS ROADS ARE PUBLIC STREETS
- 19. TURNING RADIUS = 28 FT
- 20. DEAD END IS LESS THAN 150 FT
- 21. ACCESS ROAD IS CONCRETE CAPABLE OF SUPPORTING 75,000LBS
- 22. REFERENCE DETAIL THIS SHEET AND CIVIL SHEETS FOR CONCRETE PAVING DATA
- 23. ACCESS ROAD GRADE LESS THAN 10%
- 24. THERE ARE NO GATES ON THIS PROJECT
- 25. REFER TO G SHEETS FOR FIRE RATINGS, 1HR EXTERIOR WALL PROVIDED
- 26. SPRINKLER SYSTEM NOT PROVIDED
- 27. FDC NOT REQUIRED
- 28. FDC NOT REQUIRED
- 29. PIV NOT REQUIRED
- 30. STANDPIPE NOT REQUIRED
- 31. STANDPIPE NOT REQUIRED
- or. Orange in Enter Regulate
- 32. REMISE ID SHALL BE 12" BRONZE LETTERS MOUNTED TO WEST FACADES (UNIVERSE BLVD NW) AND TO NORTH FACADES (ROSA PARKS RD NW)
- 33. MULTIPLE BUILDINGS WITH SINGLE ADDRESS
- 34. KNOX BOX PROVIDED AT AT EACH BUILDING, SEE PLAN

FIRE CALCULATIONS

BUILDING HEIGHT = 20'-0", 1 STORY

TYPE V-A, SPRINKLERED CONSTRUCTION

HYDRANTS REQUIRED PER IFC TABLE C105.1 = 2 HYDRANT @ 450FT MAX

CONCRETE PAVING SHALL SUPPORT 75,000 LBS.

FIRE FLOW CALCULATION IFC 2015 APPENDIX B TABLE B105.1:

IFC B105.1 CONSTRUCTION TYPE V-A SPRINKLERED 11,680 SF: FLOW @ 2,000 GPM FOR 2 HR



SOLID WASTE NOTES:

TRASH ENCLOSURE.

THE DEVELOPMENT HAS NO GATES

THE SLOPE LEADING TO THE TRASH ENCLOSURE/DUMPSTER SHALL BE NO GREATER THAN 1/8" PER FOOT ON THE APPROACH.

THERE IS FOOD SERVICE FOR THIS PROJECT. ALL REFUSE ENCLOSURES SHALL

RECYCLING CONTAINERS LOCATED ADJACENT TO THE REFUSE ENCLOSURE, SEE

KEYED NOTE. THE REFUSE DRIVER SHALL HAVE ACCESS TO TRASH ENCLOSURE/DUMPSTER BY

THERE ARE NO OVERHANGING WIRES LEADING TO AND EXITING FROM THE


THIS PROJECT WILL NOT ALTER EXISTING TRASH SERVICE FOR THE

SURROUNDING BUSINESSES DURING CONSTRUCTION.

OWNER SHALL PURCHASE 8 CY REFUSE CONTAINER.

HAVE GREASE DRAINS AND GREASE INTERCEPTORS

Approved for access by the Solid Waste Department for 2 trash enclosures**which are required to have sanitary drains, and 1 recycle dumpster enclsoure. All containers are to be accessible between the hours of 5AM to 8PM.** Herman Gallegos 07-07-23 Herman Gallegos

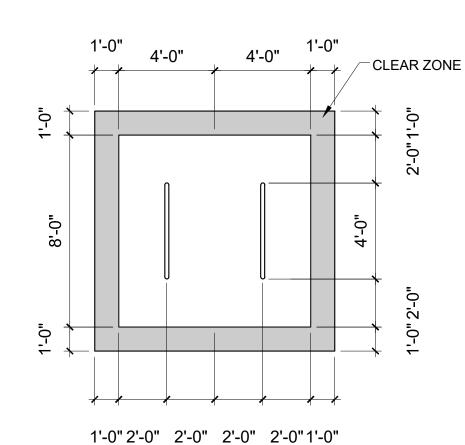

UPC: 101006305745520820 LEGAL: LOT 001 BLOCK 8 VOLCANO CLIFFS SUBDIVISION ZONING: MX-L

ZONE ATLAS PAGE: D-10

GROSS LOT AREA = 6.5656 AC = 285,999.06 SF BUILDING FOOTPRINT = 31,561 SF NET LOT AREA = 30 SF

PARKING:

BUILDING 1: 10,000 SF X 3.5 SPACES = 35 SPACES BUILDING 2: 11,680 X 3.5 SPACE = 41 SPACES

TOTAL SPACES REQUIRED = 76 SPACES

TOTAL SPACES PROVIDED = 109 SPACES

HC REQUIRED: 4 STANDARD, 3 VAN MOTORCYCLE PARKING 151-300 SPACES: 5 SPACES REQUIRED / 6 PROVIDED BIKE PARKING 10% OF 246: 25 REQUIRED, 32 SPACES PROVIDED

REQUIRED LANDSCAPE AREA @ 15% = 29,023 SF; 74,520 SF PROVIDED

ALL IMPROVEMENTS LOCATED IN THE RIGHT OF WAY MUST BE INCLUDED IN ON A PUBLIC WORK ORDER.

LANDSCAPING, FENCING AND SIGNING WILL NOT INTERFERE WITH CLEAR SIGHT REQUIREMENTS. THEREFORE, SIGNS, WALLS, TREES AND SHRUBBERY BETWEEN 3 AND 8 FEET TALL (AS MEASURED FROM THE GUTTER PAN) WILL NOT BE ACCEPTABLE IN THE CLEAR SIGHT TRIANGLE.

ALL PAVING SHALL BE SHALL BE ASPHALT UNLESS NOTED OTHERWISE, REF. DETAIL THIS SHEET.


ALL MECHANICAL EQUIPMENT SHALL BE SCREENED IN ACCORDANCE WITH IDO SECTION 5-5 (G).


ALL OUTDOOR LIGHT FIXTURES SHALL BE LED. FIXTURES 70 WATTS OR GREATER SHALL BE SHIELDED USING FULL CUTOFF LIGHT FIXTURES.

BUILDING MOUNTED SIGNS SHALL BE EXTERNALLY ILLUMINATED AND SHALL NOT EXTEND MORE THAN 2 FEET ABOVE THE EXTERIOR WALLS OF THE BUILDING.

WORK WITHIN THE PUBLIC RIGHT OF WAY REQUIRES A WORK ORDER.

BIKE PARKING

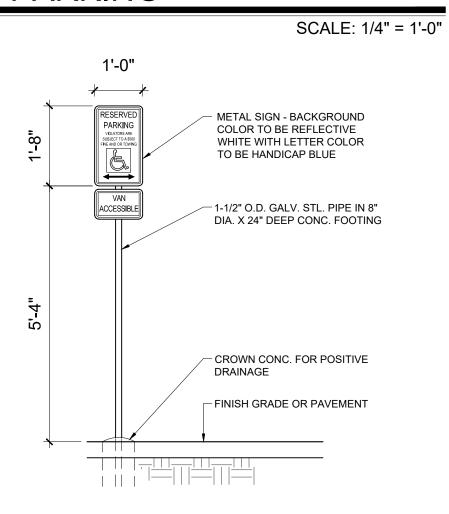

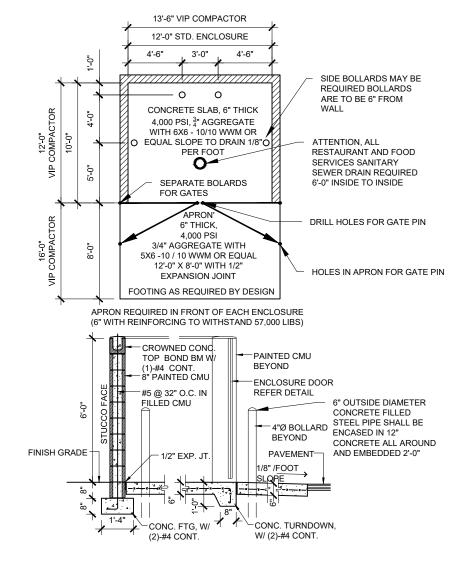

REFUSE ENCLOSURE

HC SIGN

SCALE: NTS

1'-2" METAL SIGN - BACKGROUND COLOR TO BE REFLECTIVE WHITE WITH LETTER COLOR TO BE RED **ONO** 1-1/2" O.D. GALV. STL. PIPE IN 8" CROWN CONC. FOR POSITIVE FINISH GRADE OR PAVEMENT

MOTORCYCLE SIGN

SCALE: 1/2" = 1'-0"

MIN

4" STRIPE @ 36" OC PER NMSA, THE ADA ADJACENT ACCESS AISLE SHALL BE CLEARLY MARKED BY DIAGONAL, BLUE PAVEMENT STRIPING INTERNATIONAL SYMBOL OF ACCESSIBILITY 36" PARKING

SCALE: 1/8" = 1'-0"

12" HIGH LETTERING WITHIN

ACCESS AISLE

PEDESTRIAN ROUTE

HC PARKING SIGN, REF DETAIL

-WHEEL STOP

ADA PARKING SCALE: $\frac{1}{8}$ " = 1'-0"

8'-0"

MIN

11. EXISTING POWER POLE

12. MONUMENT SIGN 13. CLEAR SIGHT TRIANGLE. LANDSCAPING, FENCING AND SIGNING WILL NOT INTERFERE WITH CLEAR SIGHT REQUIREMENTS. THEREFORE, SIGNS, WALLS,

KEYED NOTES

4. NEW FIRE HYDRANT

5. IRRIGATION BOX

10. PROPERTY LINE

GUTTER PAN) WILL NOT BE ACCEPTABLE IN THE CLEAR SIGHT TRIANGLE 14. CORNER ACCESS RAMP, REF COA STANDARD DETAIL 2441 15. 6' WROUGHT IRON FENCE

TREES AND SHRUBBERY BETWEEN 3 AND 8 FT TALL (AS MEASURED FROM THE

1. 8 SPACE BIKE RACK, REF DETAIL THIS SHEET

2. MOTORCYCLE PARKING SIGN REF DETAIL THIS SHEET 3. H.C. PARKING SIGN, REF DETAIL ON THIS SHEET

6. NEW 6' SIDEWALK, 2% MAX CROSS SLOPE, 1.5% PREFERRED CROSS SLOPE,

REFERENCE CITY OF ALBUQUERQUE STANDARD DETAIL 2430

8. PARALLEL CURB RAMP, REF DETAIL A, COA STANDARD DETAIL 2443

9. PERPENDICULAR CURB RAMP, REF DETAIL COA STANDARD DETAIL 2447

7. GREASE CONTAINER ENCLOSURE SIM TO DETAIL THIS SHEET

16. REFUSE CONTAINER, REF DETAIL THIS SHEET 17. RECYCLING CONTAINER, REF DETAIL THIS SHEET


18. FIRE DEPARTMENT CONNECTION

19. DRIVE PAD REF. COA STANDARD DETAIL 2425B 20. CURB AND GUTTER REF. COA STANDARD DETAIL 2415B

21. EXISTING POWER POLE

22. GREASE WASTE ENCLOSURE



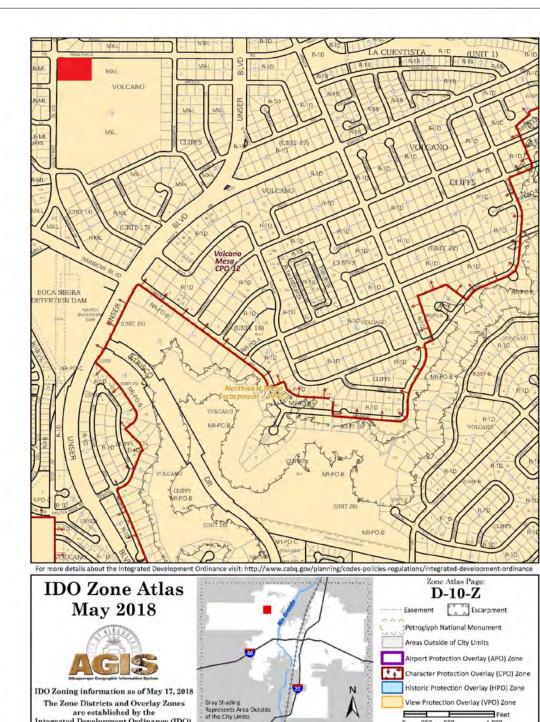






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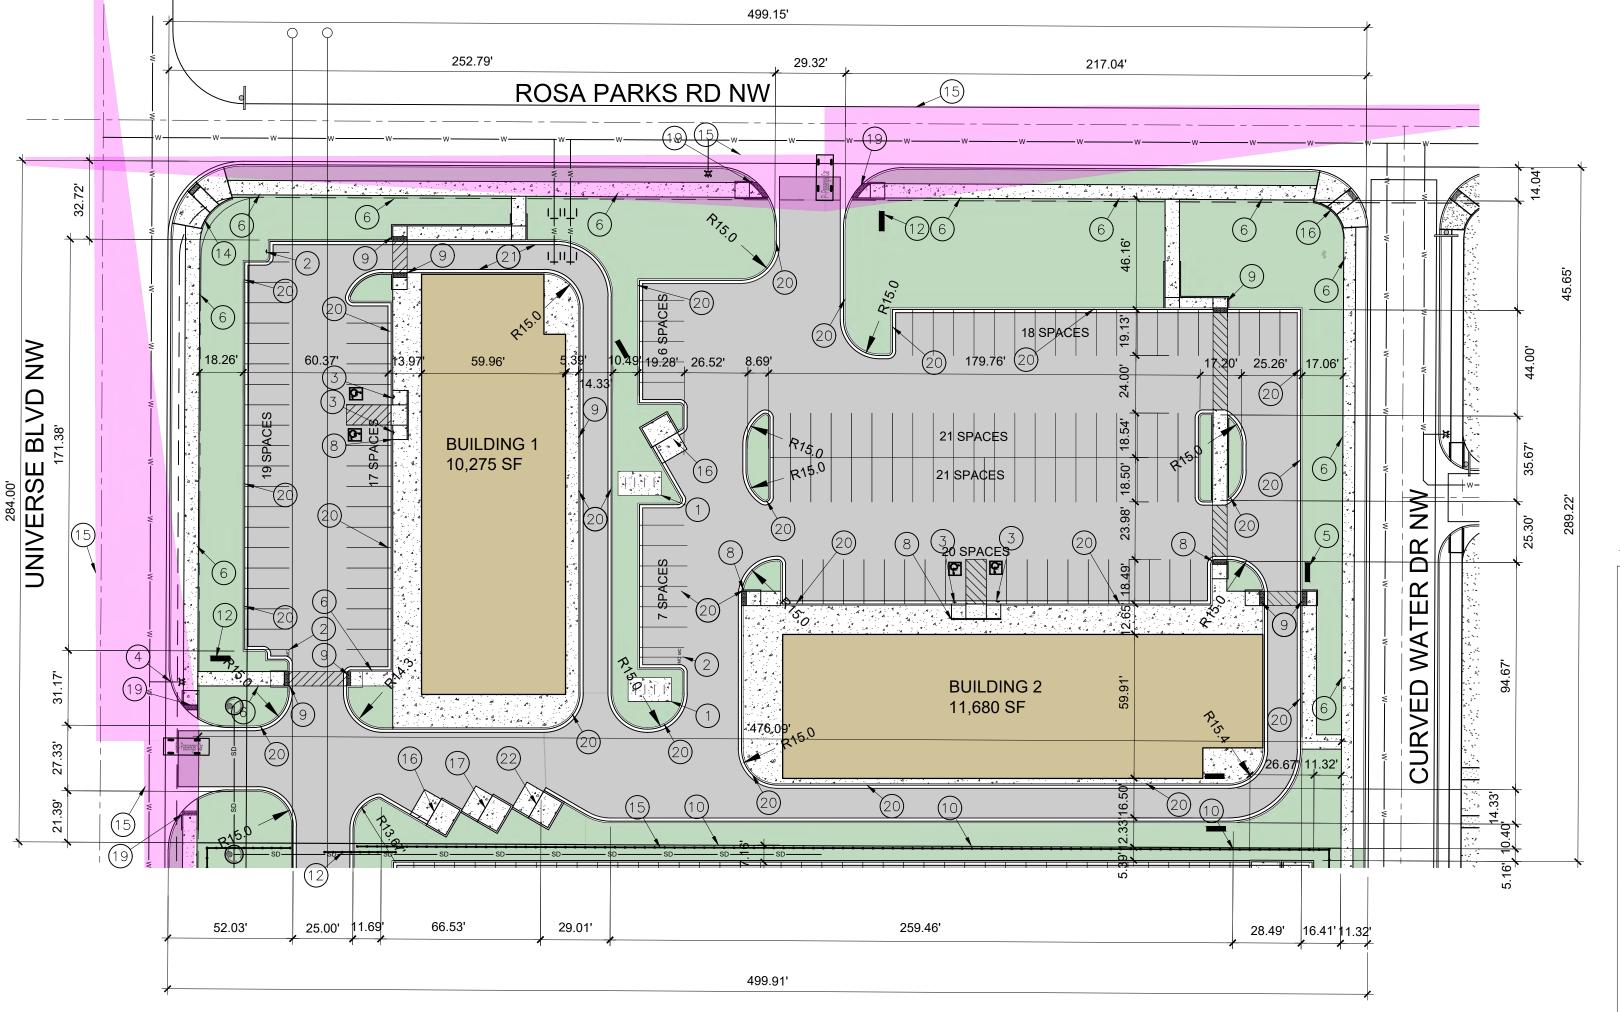
Feet 0 250 500 1,000

UNIVERSE VIEW STRIP CENTER


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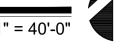
DRAWING TITLE



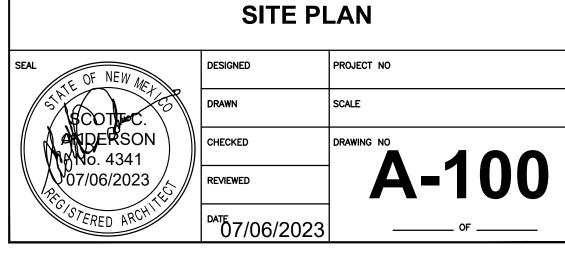


SITE PLAN



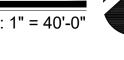






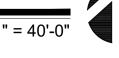



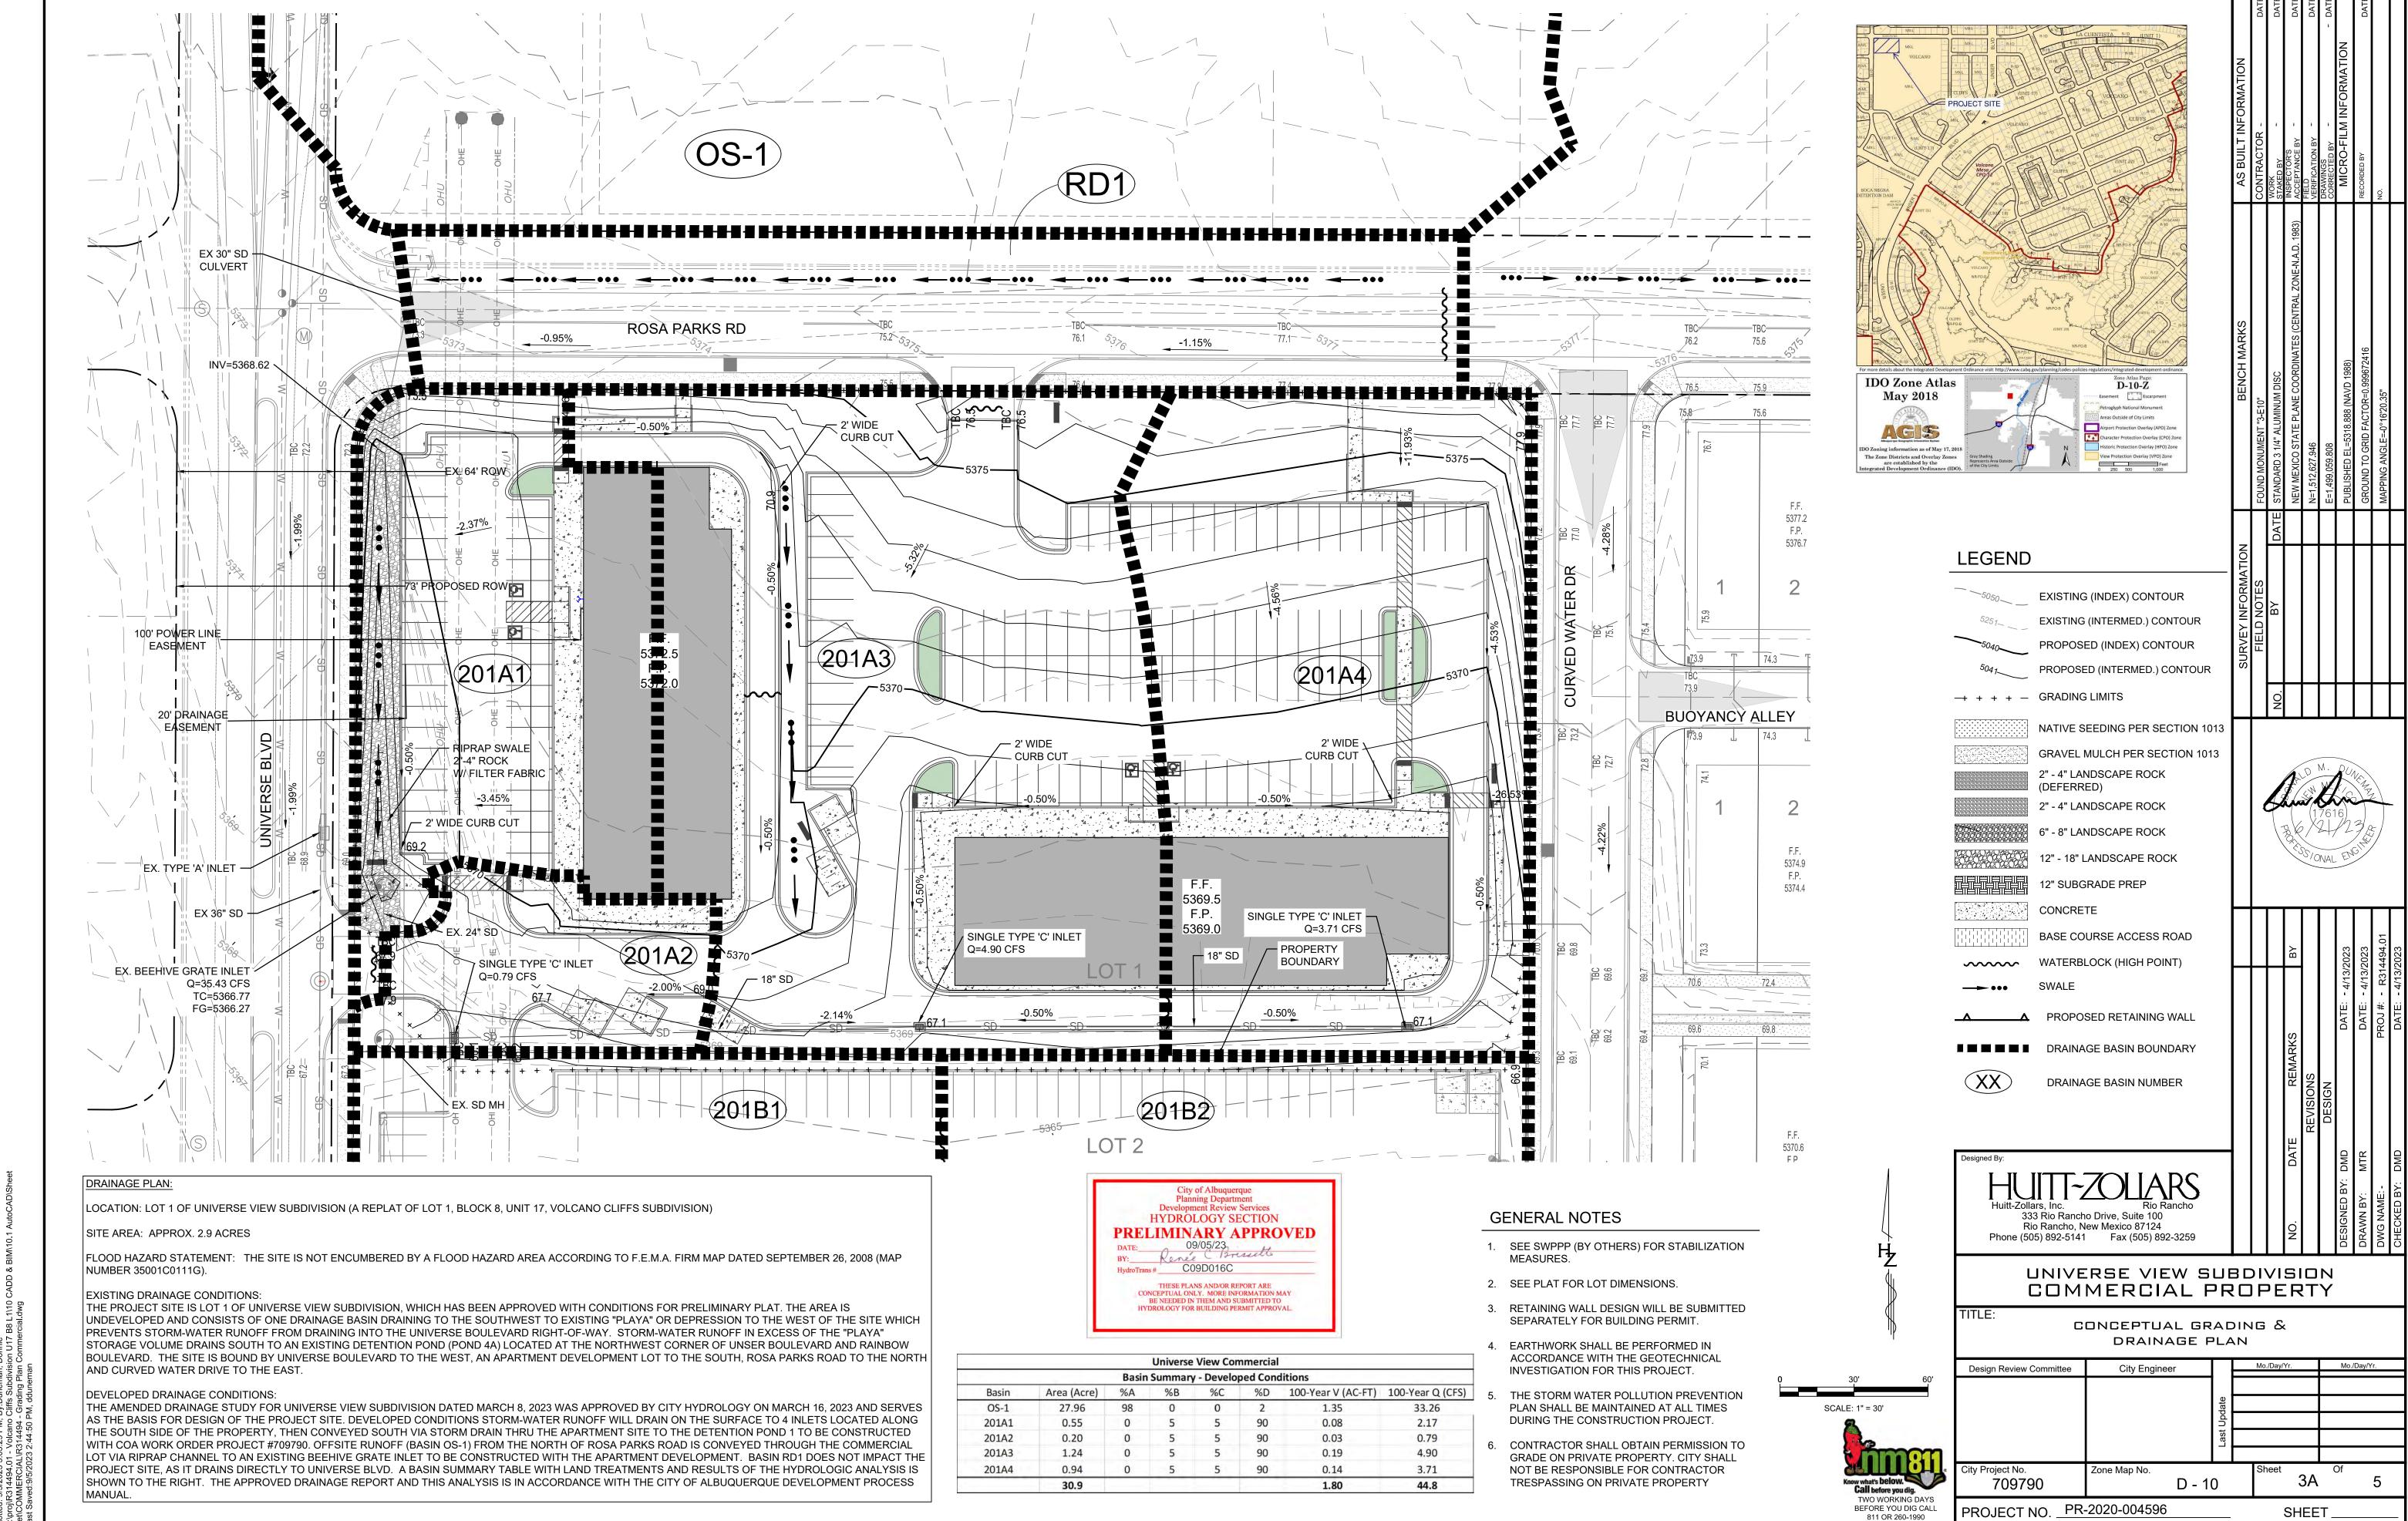

SOLID WASTE NOTES:

THE DEVELOPMENT HAS NO GATES

THE SLOPE LEADING TO THE TRASH ENCLOSURE/DUMPSTER SHALL BE NO GREATER THAN 1/8" PER FOOT ON THE APPROACH.

THERE IS FOOD SERVICE FOR THIS PROJECT. ALL REFUSE ENCLOSURES SHALL

RECYCLING CONTAINERS LOCATED ADJACENT TO THE REFUSE ENCLOSURE, SEE

KEYED NOTE. THE REFUSE DRIVER SHALL HAVE ACCESS TO TRASH ENCLOSURE/DUMPSTER BY


THERE ARE NO OVERHANGING WIRES LEADING TO AND EXITING FROM THE

TRASH ENCLOSURE.

THIS PROJECT WILL NOT ALTER EXISTING TRASH SERVICE FOR THE SURROUNDING BUSINESSES DURING CONSTRUCTION.

OWNER SHALL PURCHASE 8 CY REFUSE CONTAINER.

HAVE GREASE DRAINS AND GREASE INTERCEPTORS

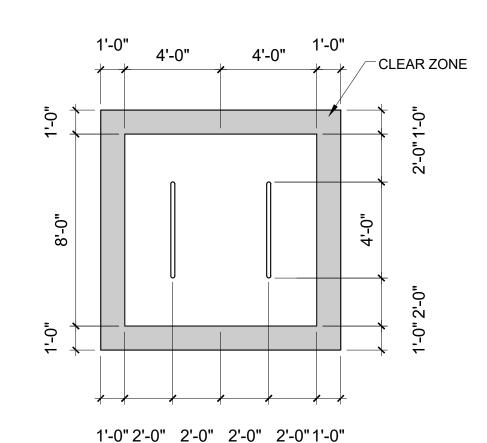

UPC: 101006305745520820 LEGAL: LOT 001 BLOCK 8 VOLCANO CLIFFS SUBDIVISION ZONING: MX-L ZONE ATLAS PAGE: D-10

GROSS LOT AREA = 6.5656 AC = 285,999.06 SF

BUILDING FOOTPRINT = 31,561 SF NET LOT AREA = 30 SF

REQUIRED LANDSCAPE AREA @ 15% = 29,023 SF; 74,520 SF PROVIDED

BUILDING 1: 10,000 SF X 3.5 SPACES = 35 SPACES BUILDING 2: 11,680 X 3.5 SPACE = 41 SPACES

TOTAL SPACES REQUIRED = 76 SPACES TOTAL SPACES PROVIDED = 109 SPACES

HC REQUIRED: 4 STANDARD, 3 VAN

MOTORCYCLE PARKING 151-300 SPACES: 5 SPACES REQUIRED / 6 PROVIDED BIKE PARKING 10% OF 246: 25 REQUIRED, 32 SPACES PROVIDED

ALL IMPROVEMENTS LOCATED IN THE RIGHT OF WAY MUST BE INCLUDED IN ON A PUBLIC WORK ORDER.

LANDSCAPING, FENCING AND SIGNING WILL NOT INTERFERE WITH CLEAR SIGHT REQUIREMENTS. THEREFORE, SIGNS, WALLS, TREES AND SHRUBBERY BETWEEN 3 AND 8 FEET TALL (AS MEASURED FROM THE GUTTER PAN) WILL NOT BE ACCEPTABLE IN THE CLEAR SIGHT TRIANGLE.

ALL PAVING SHALL BE SHALL BE ASPHALT UNLESS NOTED OTHERWISE, REF. DETAIL THIS SHEET.

ALL MECHANICAL EQUIPMENT SHALL BE SCREENED IN ACCORDANCE WITH IDO SECTION 5-5 (G).


ALL OUTDOOR LIGHT FIXTURES SHALL BE LED. FIXTURES 70 WATTS OR GREATER SHALL BE SHIELDED USING FULL CUTOFF LIGHT FIXTURES.


BUILDING MOUNTED SIGNS SHALL BE EXTERNALLY ILLUMINATED AND SHALL NOT EXTEND MORE THAN 2 FEET ABOVE THE EXTERIOR WALLS OF THE BUILDING.

WORK WITHIN THE PUBLIC RIGHT OF WAY REQUIRES A WORK ORDER.

MC" SHALL BE PAINTED ON THE PAVEMENT OF EACH MOTORCYCLE PARKING SPACE

BIKE PARKING

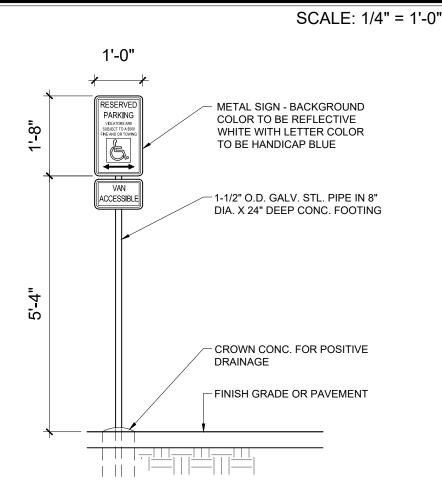

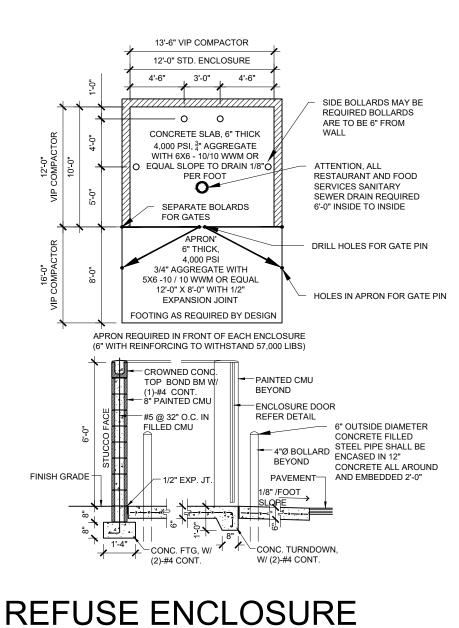

SCALE: 1/8" = 1'-0"

4" STRIPE @ 36" OC PER

ACCESS AISLE SHALL BE

NMSA, THE ADA ADJACENT

BLUE PAVEMENT STRIPING

INTERNATIONAL SYMBOL OF ACCESSIBILITY 36"

12" HIGH LETTERING WITHIN

SCALE: $\frac{1}{8}$ " = 1'-0"

ACCESS AISLE


PEDESTRIAN ROUTE

HC PARKING SIGN, REF DETAIL

-WHEEL STOP

HC SIGN

SCALE: NTS

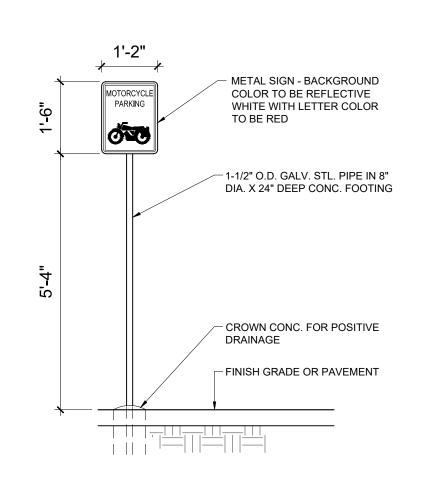

MOTORCYCLE SIGN

SCALE: 1/2" = 1'-0"

MIN

ADA PARKING

PARKING

MIN

CLEARLY MARKED BY DIAGONAL,



SITE PLAN

METAL SIGN

-1 ½" O.D. GALV.

FOOTING

POSITIVE

DRAINAGE

PAVEMENT

STEEL PIPE IN 8" Ø

-CROWN CONC. FOR

FINISH GRADE OR

X 24" DEEP CONC.

1 CHAIRS @ 48" OCBW - 6" AGGREGATE BASE COURSE - 6" FLEX BASE, COMPACTED TO 95% PER TEX 113-E, IF SOILS REPORT HAS PVR OF GREATER THAN 3 INCHES

3,000 PSI CONCRETE W/ #3 REBAR @ 18" OCBW IN

CENTER OF SLAB USE 3

499.91'

PAVING SECTION

SCALE: NTS

TRAFFIC CIRCULATION LAYOUT APPROVED 12/27/2023

499.15' 217.04' **ROSA PARKS RD NW** ROSA PARKS RD. NW 64' ROW Š VARD 86| 18.62' 26.52' 8.69' N 21 SPACES **BUILDING 1** RSE | 10,275 SF 21 SPACES BUILDING 2 11,680 SF 27.96' 259.46' 36.89' 51.86' 48.87' 28.49' 16.41'11.32'

KEYED NOTES

LEGEND

BUILDING

CONCRETE

LANDSCAPE

ASPHALT PAVING


CLEAR SIGHT TRIANGLE

- 1. 8 SPACE BIKE RACK, REF DETAIL THIS SHEET
- MOTORCYCLE PARKING SIGN REF DETAIL THIS SHEET

H.C. PARKING SIGN, REF DETAIL ON THIS SHEET

- 4. NEW FIRE HYDRANT IRRIGATION BOX
- NEW 6' SIDEWALK, 2% MAX CROSS SLOPE, 1.5% PREFERRED CROSS SLOPE, REFERENCE CITY OF ALBUQUERQUE STANDARD DETAIL 2430
- GREASE CONTAINER ENCLOSURE SIM TO DETAIL THIS SHEET
- PARALLEL CURB RAMP, REF DETAIL A, COA STANDARD DETAIL 2443 9. PERPENDICULAR CURB RAMP, REF DETAIL COA STANDARD DETAIL 2447 10. PROPERTY LINE
- 11. EXISTING POWER POLE 12. MONUMENT SIGN
- 13. CLEAR SIGHT TRIANGLE. LANDSCAPING, FENCING AND SIGNING WILL NOT INTERFERE WITH CLEAR SIGHT REQUIREMENTS. THEREFORE, SIGNS, WALLS, TREES AND SHRUBBERY BETWEEN 3 AND 8 FT TALL (AS MEASURED FROM THE GUTTER PAN) WILL NOT BE ACCEPTABLE IN THE CLEAR SIGHT TRIANGLE
- 14. CORNER ACCESS RAMP, REF COA STANDARD DETAIL 2441
- 15. 6' WROUGHT IRON FENCE
- 16. REFUSE CONTAINER, REF DETAIL THIS SHEET 17. RECYCLING CONTAINER, REF DETAIL THIS SHEET
- 18. FIRE DEPARTMENT CONNECTION 19. PARALLEL RAMP AT DRIVE REF. COA STANDARD DETAIL 2426 20. CURB AND GUTTER REF. COA STANDARD DETAIL 2415B
- 21. EXISTING POWER POLE 22. GREASE WASTE ENCLOSURE
- 23. 10' PUBLIC UTILITY EASEMENT
- 24. DO NOT ENTER SIGN, REF DETAIL THIS SHEET
- 25. "ONE WAY" SIGN

ALL IMPROVEMENTS LOCATED IN THE RIGHT OF WALL MUST BE INCLUDED ON A PUBLIC WORK ORDER

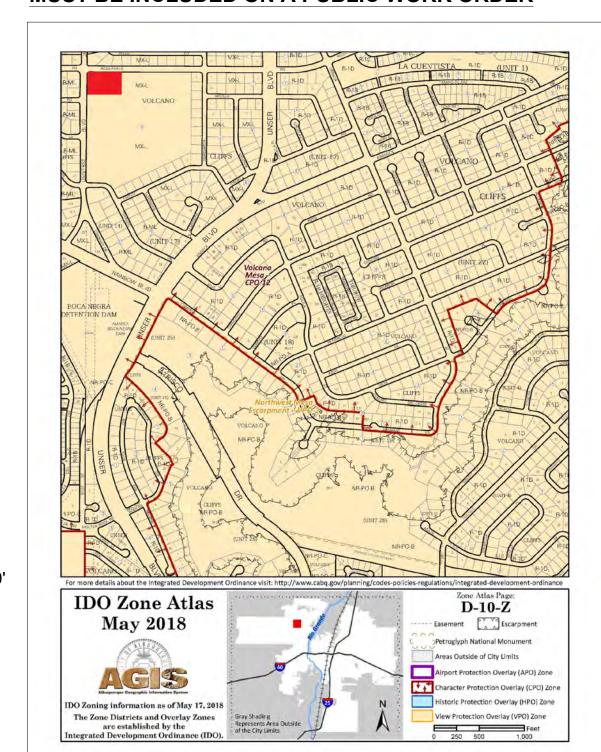

AREA MAP





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UNIVERSE VIEW STRIP CENTER UNIVERSE BLVD NW

ALBUQUERQUE, NM 87114

TRAFFIC CIRCULATION LAYOUT



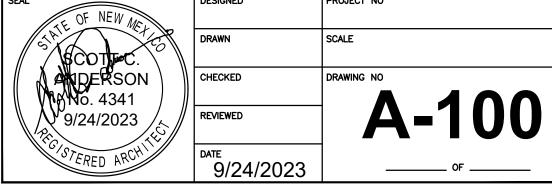

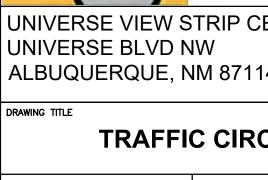PR-2020-004596_SI-2024-00390_Site_Plan_Approved_7-31-24_Updated

Final Audit Report 2024-08-26

Created: 2024-08-05

By: Jay Rodenbeck (jrodenbeck@cabq.gov)

Status: Signed

Transaction ID: CBJCHBCAABAAi8IDHCbOWn1IxtZLNelFCrrk60BjZBon

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