

## ALL IMPROVEMENTS LOCATED IN THE RIGHT OF WALL MUST BE INCLUDED ON A PUBLIC WORK ORDER

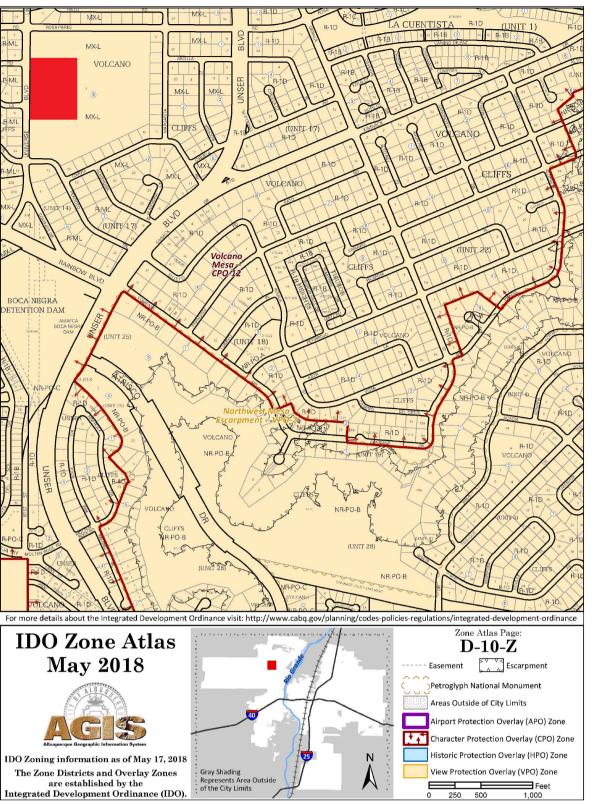


SCALE:NTS

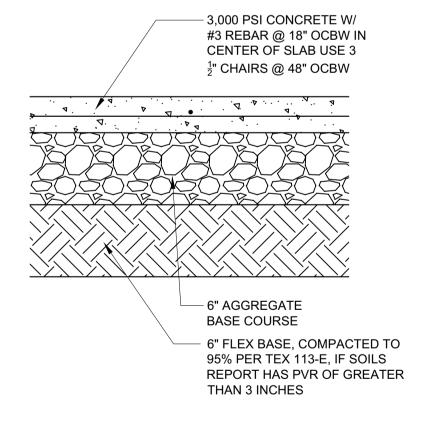


## PAVING SECTION

SCALE: NTS

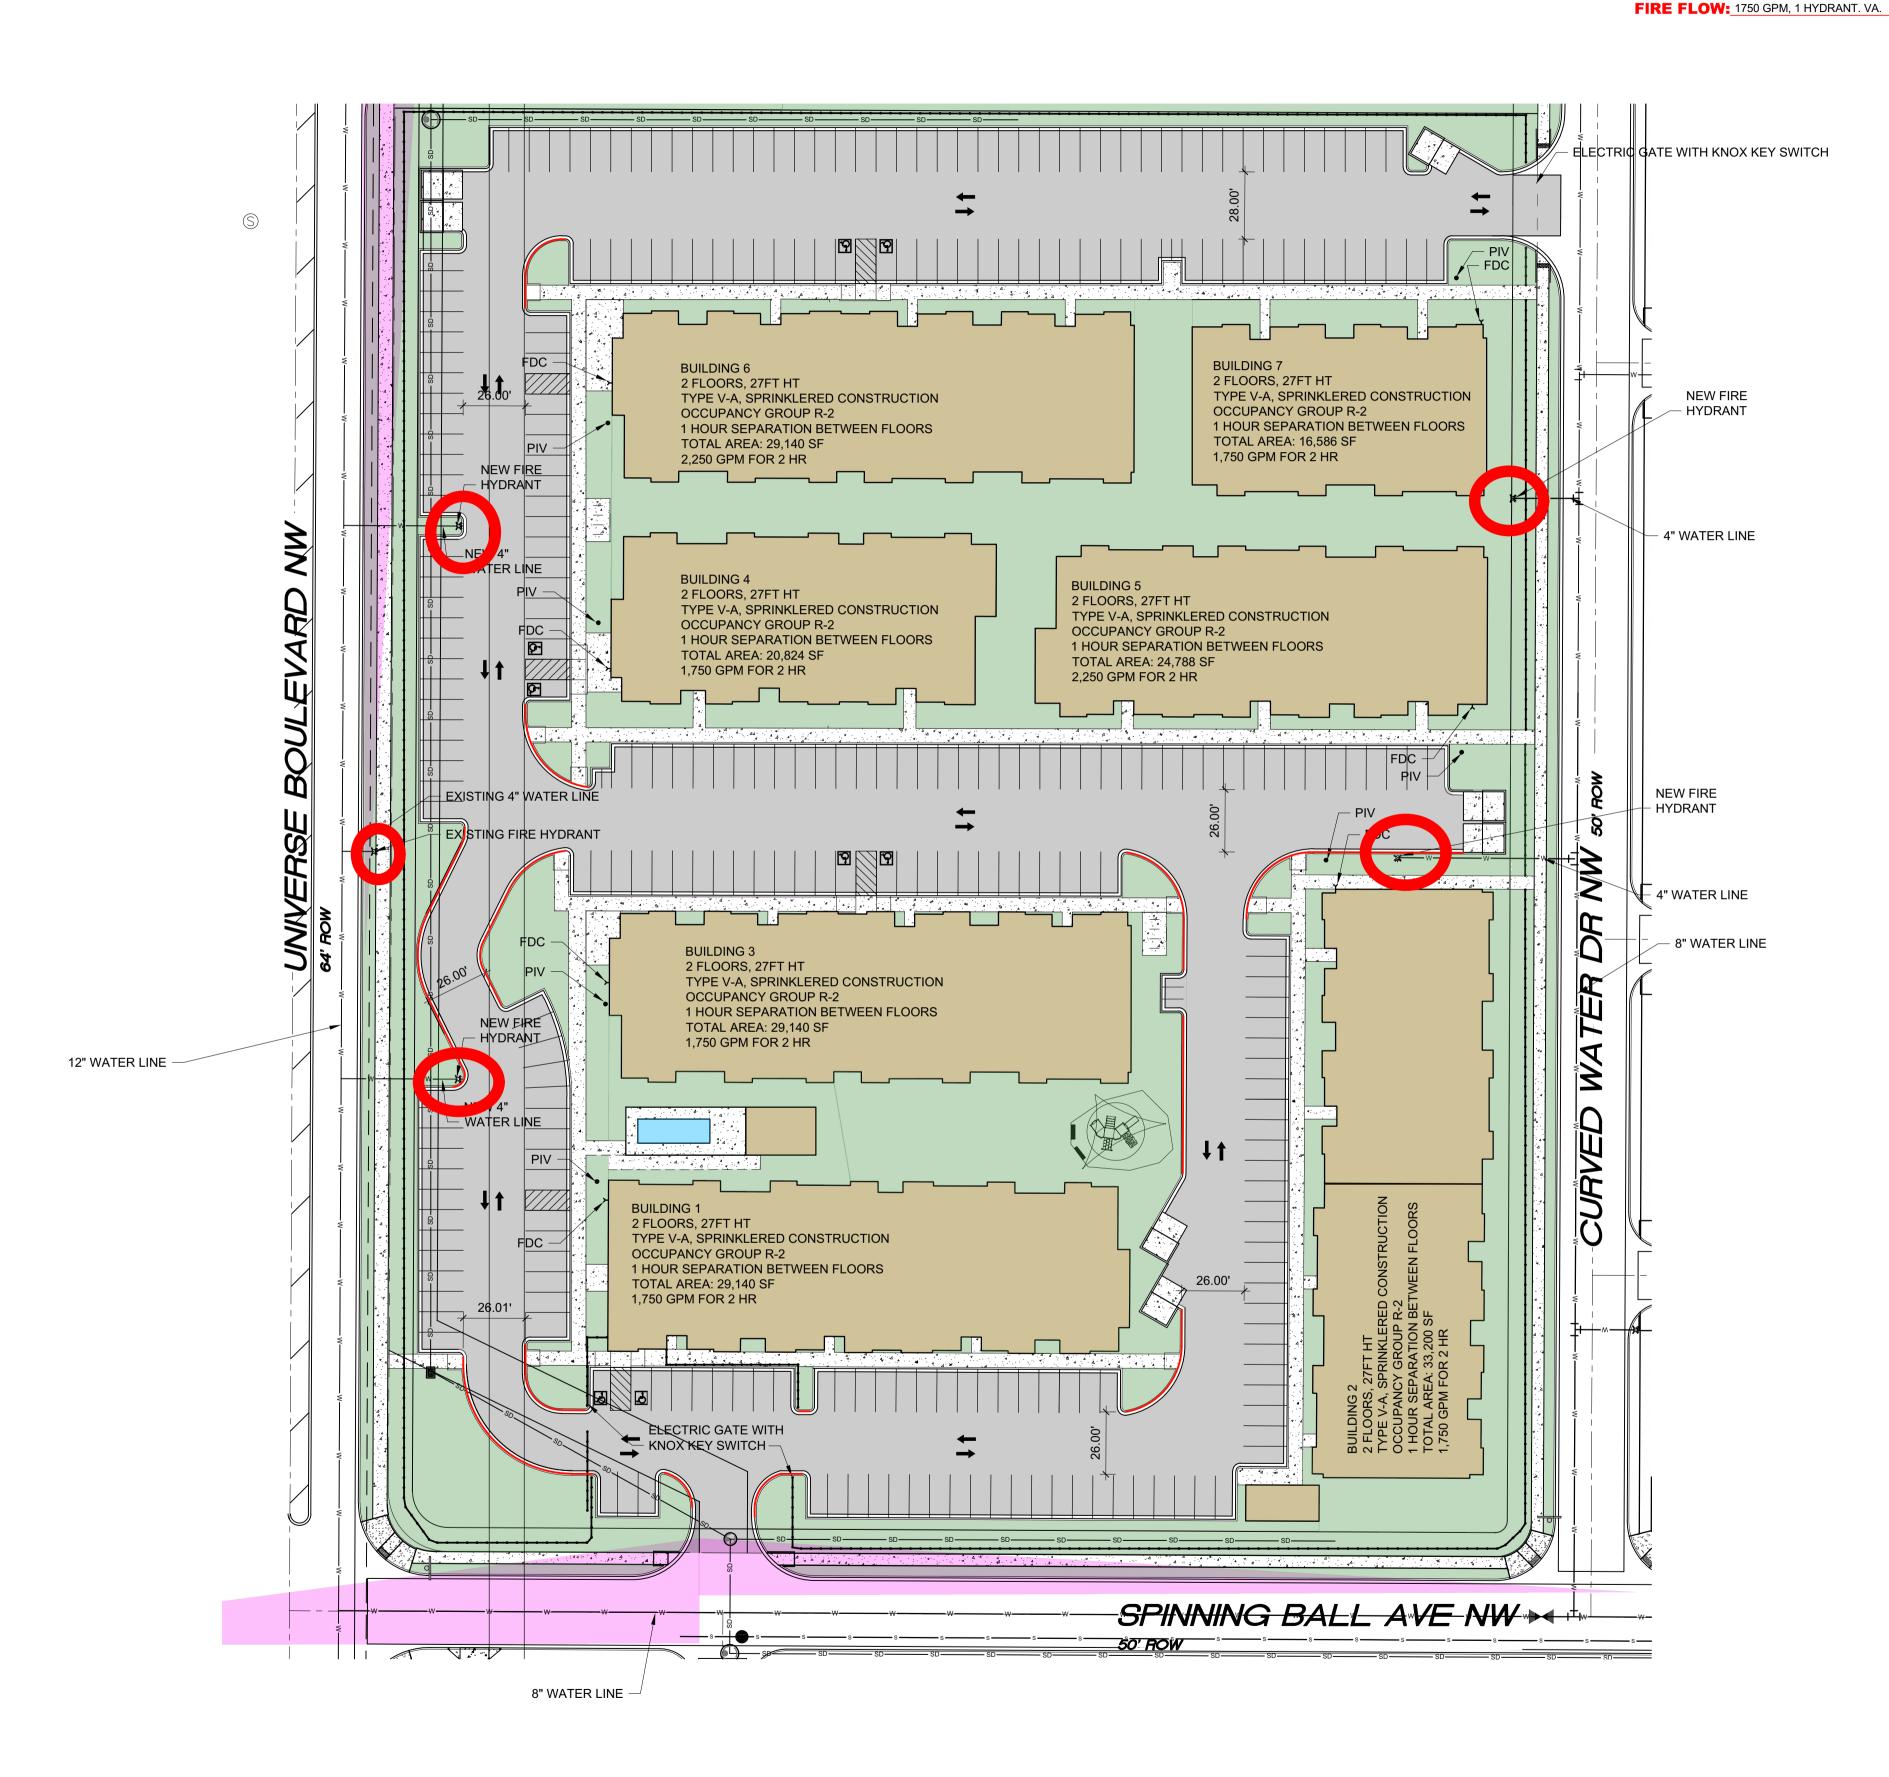

SITE PLAN

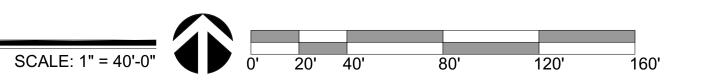

DIVISION OFFICE BLANS D FIRE 1 PLAN WILL BE SUBMITTED AT PERMIT CHECKING DIVISION PER<sup>2</sup>VFPTEQUIREMENTS: CONSTRUCTION TYPE V-A: 2,250 GPM, 2 HR (CALCS BELOW)

PERMIT NUMBER: FP- 23-01581 APPROVED DATAE: 09/25/1/23/ING HYDRANT PROVIDED, 3 NEW HYDRANT PROVIDED

YST = 1 TRANTS AND NEW HYDRANT IDENTIFIED THESE CONSTRUCTION DOCUMENTS WERE REVIEWED AND APPROVED BY THE LINES IDENTIFIED ON THE PLAN ALBUQUERQUE FIRE MARSHAL'S OFFICE IN ACCORDANCE WITH THE CITY LINES IDENTIFIED ON THE PLAN

- ORDINACE, THE INTERNATIONAL FIRE CODE, AND NFPA STANDARDS. THIS PERMIT IS VALID FOR 180 DAYS. FINAL INSPECTION IS REQUIRED BLIC WATER MAIN IDENTIFIED ON THE PLAN
  - 9. ACCESS PROVIDED TO 150FT

NO PARKING 15FT FROM THE HYDRANT

- 10. BUILDING HT 27FT, 3 MEANS OF APPARATUS ACCESS
- 11. TOTAL BUILDING AREA LESS THAN 62,000 SF, 2 MEANS OF APPARATUS ACCESS
- 12. THIS IS A 175 UNIT MULTI-FAMILY, 2 MEANS OF APPARATUS ACCESS PROVIDED
- 13. THIS IS NOT A ONE OR TWO FAMILY RESIDENTIAL PROJECT
- 14. 2 MEANS OF ACCESS PROVIDED, 2 REQUIRED
- 15. BUILDING LESS THAN 30 FT IN HT, 24 FT ROAD WIDTH PROVIDED
- 16. ACCESS ROAD 26 FT WIDE
- 17. ACCESS ROAD 26 FT WIDE
- 18. ACCESS ROADS ARE PUBLIC STREETS
- 19. TURNING RADIUS = 28 FT
- 20. DEAD END IS LESS THAN 150 FT
- 21. ACCESS ROAD IS CONCRETE CAPABLE OF SUPPORTING 75,000LBS
- 22. REFERENCE DETAIL THIS SHEET AND CIVIL SHEETS FOR CONCRETE PAVING DATA
- 23. ACCESS ROAD GRADE LESS THAN 10%
- 24. KNOX BOX PROVIDED AT EACH GATE
- 25. REFER TO G SHEETS FOR FIRE RATINGS, 1HR SEPARATION BETWEEN DWELLING UNITS, 1HOUR SEPARATION BETWEEN FLOORS
- 26. SPRINKLER SYSTEM PROVIDED
- 27. FDC LOCATED LESS THAN 100 FT FROM HYDRANT
- 28. FDC HAS 3FT CLEARANCE
- 29. PIV ON EAST SIDE OF EACH RISER ROOM
- 30. STANDPIPE NOT REQUIRED
- 31. STANDPIPE NOT REQUIRED
- 32. REMISE ID SHALL BE 12" BRONZE LETTERS MOUNTED TO WEST FACADE (UNIVERSE BLVD NW)
- 33. MULTIPLE BUILDINGS WITH SINGLE ADDRESS
- 34. KNOX BOX PROVIDED AT MAIN ENTRANCE TO THE BUILDING

FIRE LANE

## FIRE CALCULATIONS

**BUILDING HEIGHT = 27'-0", 2 STORY** 


TYPE V-A, SPRINKLERED CONSTRUCTION

HYDRANTS REQUIRED PER IFC TABLE C105.1 = 2 HYDRANT @ 450FT MAX

CONCRETE PAVING SHALL SUPPORT 75,000 LBS.

FIRE FLOW CALCULATION IFC 2015 APPENDIX B TABLE B105.1:

IFC B105.1 CONSTRUCTION TYPE V-A SPRINKLERED 29,140 SF: FLOW @ 3,000 GPM X 50% (SPRINKLERS) = : 2,250 GPM FOR 2 HR

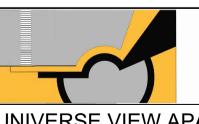

**SCOTT C. ANDERSON** & associates architects


PROJECT NO

UNIVERSE VIEW APARTMENTS UNIVERSE BLVD NW

ALBUQUERQUE, NM 87114

DRAWING TITLE

SITE PLAN

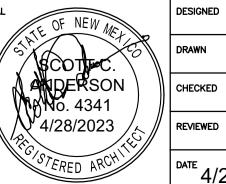

CHECKED <sup>DATE</sup> 4/28/2023